ELEVATION A (4 BEDROOM)

DOOR & WINDOWS GLASS AREA TO PERIPHERAL INSULATED WALLS RATIO--O.B.C. SB-12 ART. 3.1.1.2(1) **ELEVATION A**

		ŀ	ELEVATION A			
ROOM	QUANTITY	WIDTH(IN.)	HEIGHT(IN.)	ARCH AREA	WINDOW / DOOR R.S.O. (SQ.FT.)	WINDOW / DOOR R.S.O. (SQ.M.)
BASEMENT	5	30	16	0	16.67	1.55
	1	48	8	0	2.67	0.25
FOYER	1	8	72	0	4.00	0.37
	1	26	41	0	7.40	0.69
PWDR.	1	24	52	2.69	11.36	1.06
PWDR.	1	36	52	4.02	17.02	1.58
HOME OFFICE	1	72	52	8.01	34.01	3.16
	2	24	68	0	22.67	2.11
DINING / LIVING ROOM	2	23	56	0	17.89	1.66
	1	62	8	0	3.44	0.32
FAMILY ROOM	2	24	52	2.69	22.71	2.11
FAMILT ROOM	2	72	52	8.01	68.02	6.32
DDEALEACT	1	76	96	0	50.67	4.71
BREAKFAST	1	36	48	0	12.00	1.11
MUDROOM	1	24	40	0	6.67	0.62
MASTER BEDROOM	2	48	56	0	37.33	3.47
DRESSING ROOM	1	24	48	0	8.00	0.74
ENSUITE NO.2	1	24	48	0	8.00	0.74
BEDROOM NO.2	1	48	52	5.34	22.67	2.11
W.I.CL.	1	24	56	0	9.33	0.87
	1	36	56	4.02	18.02	1.67
DEDDOOM NO 2	1	24	56	0	9.33	0.87
BEDROOM NO.3	1	36	56	0	14.00	1.30
BEDROOM NO.2 W.I.CL. BEDROOM NO.3	1	24	56	2.69	12.02	1.12
SHARED BATH	2	24	56	2.69	24.05	2.23
BEDROOM NO.4	2	36	56	0	28.00	2.60
MACTED ENGLITE	3	24	56	2.69	36.07	3.35
MASTER ENSUITE	1	72	56	8.01	36.01	3.35
TOTAL	41	-	-	-	560.03	52.03
WALL AREA	-	-	-	-	4281.78	397.79
RATIO	-	-	-	-	13.08	13.08


ELEVATION A (5 BEDROOM)

DOOR & WINDOWS GLASS AREA TO PERIPHERAL INSULATED WALLS RATIOO.B.C. SB-12 ART. 3.1.1.2(1) ELEVATION A									
ROOM	QUANTITY	WIDTH(IN.)	HEIGHT(IN.)	ARCH AREA	WINDOW / DOOR R.S.O. (SQ.FT.)	WINDOW / DOOR R.S.O. (SQ.M.)			
BASEMENT	5	30	16	0	16.67	1.55			
	1	48	8	0	2.67	0.25			
FOYER	1	8	72	0	4.00	0.37			
	1	26	41	0	7.40	0.69			
DWDD	1	24	52	2.69	11.36	1.06			
PWDR.	1	36	52	4.02	17.02	1.58			
HOME OFFICE	1	72	52	8.01	34.01	3.16			
	2	24	68	0	22.67	2.11			
DINING / LIVING ROOM	2	23	56	0	17.89	1.66			
	1	62	8	0	3.44	0.32			
EAMILY DOOM	2	24	52	2.69	22.71	2.11			
FAMILY ROOM	2	72	52	8.01	68.02	6.32			
DDEAL/EACT	1	76	96	0	50.67	4.71			
BREAKFAST	1	36	48	0	12.00	1.11			
MUDROOM	1	24	40	0	6.67	0.62			
MASTER BEDROOM	2	48	56	0	37.33	3.47			
BEDROOM NO.2	1	48	62	0	20.67	1.92			
SHARED BATH	1	24	40	0	6.67	0.62			
BEDROOM NO.3	1	48	52	5.34	22.67	2.11			
W.I.CL.	1	24	56	0	9.33	0.87			
	1	36	56	4.02	18.02	1.67			
BEDROOM NO.4	1	24	56	0	9.33	0.87			
DEDROUM NO.4	1	36	56	0	14.00	1.30			
	1	24	56	2.69	12.02	1.12			
SHARED BATH	2	24	56	2.69	24.05	2.23			
BEDROOM NO.5	2	36	56	0	28.00	2.60			
MACTED ENGLUTE	3	24	56	2.69	36.07	3.35			
MASTER ENSUITE	1	72	56	8.01	36.01	3.35			
TOTAL	41	-	-	-	571.37	53.08			
WALL AREA	-	-	-	-	4281.78	397.79			
RATIO	-	-	-	-	13.34	13.34			

W Architect Inc. **DESIGN CONTROL REVIEW** JANUARY 21, 2022 FINAL RECERT BY: GGE

MODEL 40-4 NATASHA

3.	DEC. Ø8/21	RE-166UED FOR BUILDING PERMIT	MS
	NOV. Ø5/21 OCT. Ø5/21	199UED FOR BUILDING PERMIT 199UED TO STRUCT, ENG. /HVAC FOR REVIEW AND COMMENTS	MS MS
No:	DATE:	REVISION/ISSUED:	BY:

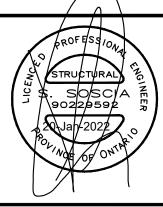



SURIANO.

SURIANO DESIGN CONSULTANTS INC. 51 Roysun Road, Unit 1 Vaughan, Ontario L4L 8P9 T. 905-264-0924

	D WALL & Area calci		
	I		
DATE PLOTTED:	DRAWN BY:	AREA:	
DEC. Ø8/21	M.H./J.LAM	3239 sq.ft.	
DATE:	TYPE:	PAGE No:	PRO
OCT. 23/2Ø			
		1	
SCALE:	PROJECT No:	Ø 1	MOD
3/16"=1'-0"	20-104		M

ROYAL PINE HOMES OJECT NAME:

10DEL 40-4 NATASHA

ELEVATION A(4 BEDROOM) WITH WOOD DECK CONDITION

DOOR & WINDOWS GLASS AREA TO PERIPHERAL INSULATED WALLS RATIO--O.B.C. SB-12 ART. 3.1.1.2(1) ELEVATION A

		E	ELEVATION A			
ROOM	QUANTITY	WIDTH(IN.)	HEIGHT(IN.)	ARCH AREA	WINDOW / DOOR R.S.O. (SQ.FT.)	WINDOW / DOOR R.S.O. (SQ.M.)
BASEMENT	4	30	16	0	13.33	1.24
DAGLINLINI	1	30	24	0	5.00	0.46
	1	48	8	0	2.67	0.25
FOYER	1	8	72	0	4.00	0.37
	1	26	41	0	7.40	0.69
PWDR.	1	24	52	2.69	11.36	1.06
FWDR.	1	36	52	4.02	17.02	1.58
HOME OFFICE	1	72	52	8.01	34.01	3.16
	2	24	68	0	22.67	2.11
DINING / LIVING ROOM	2	23	56	0	17.89	1.66
	1	62	8	0	3.44	0.32
FAMILY DOOM	2	24	52	2.69	22.71	2.11
FAMILY ROOM	2	72	52	8.01	68.02	6.32
DDEAKEACT	1	76	96	0	50.67	4.71
BREAKFAST	1	36	48	0	12.00	1.11
MUDROOM	1	24	40	0	6.67	0.62
MASTER BEDROOM	2	48	56	0	37.33	3.47
DRESSING ROOM	1	24	48	0	8.00	0.74
ENSUITE NO.2	1	24	48	0	8.00	0.74
BEDROOM NO.2	1	48	52	5.34	22.67	2.11
W.I.CL.	1	24	56	0	9.33	0.87
	1	36	56	4.02	18.02	1.67
BEDROOM NO.3	1	24	56	0	9.33	0.87
BEDROOM NO.3	1	36	56	0	14.00	1.30
	1	24	56	2.69	12.02	1.12
SHARED BATH	2	24	56	2.69	24.05	2.23
BEDROOM NO.4	2	36	56	0	28.00	2.60
MASTER ENSUITE	3	24	56	2.69	36.07	3.35
TINONI NI I CHIVI	1	72	56	8.01	36.01	3.35
TOTAL	41	-	-	-	561.70	52.18
WALL AREA	-	-	-	-	4407.29	409.45
RATIO	-	-	-	-	12.74	12.74

ELEVATION A(5 BEDROOM) WITH WOOD DECK CONDITION

DOOR & WINDOWS GLASS AREA TO PERIPHERAL INSULATED WALLS RATIO--O.B.C. SB-12 ART. 3.1.1.2(1) ELEVATION A

			LEVATIONA			
ROOM	QUANTITY	WIDTH(IN.)	HEIGHT(IN.)	ARCH AREA	WINDOW / DOOR R.S.O. (SQ.FT.)	WINDOW / DOOF R.S.O. (SQ.M.)
DACEMENT	4	30	16	0	13.33	1.24
BASEMENT	1	30	24	0	5.00	0.46
	1	48	8	0	2.67	0.25
FOYER	1	8	72	0	4.00	0.37
	1	26	41	0	7.40	0.69
DWDD	1	24	52	2.69	11.36	1.06
PWDR.	1	36	52	4.02	17.02	1.58
HOME OFFICE	1	72	52	8.01	34.01	3.16
	2	24	68	0	22.67	2.11
DINING / LIVING ROOM	2	23	56	0	17.89	1.66
	1	62	8	0	3.44	0.32
	2	24	52	2.69	22.71	2.11
FAMILY ROOM	2	72	52	8.01	68.02	6.32
DDEAKEACT	1	76	96	0	50.67	4.71
BREAKFAST	1	36	48	0	12.00	1.11
MUDROOM	1	24	40	0	6.67	0.62
MASTER BEDROOM	2	48	56	0	37.33	3.47
BEDROOM NO.2	1	48	62	0	20.67	1.92
SHARED BATH	1	24	40	0	6.67	0.62
BEDROOM NO.3	1	48	52	5.34	22.67	2.11
W.I.CL.	1	24	56	0	9.33	0.87
	1	36	56	4.02	18.02	1.67
DEDDOOM NO 4	1	24	56	0	9.33	0.87
BEDROOM NO.4	1	36	56	0	14.00	1.30
	1	24	56	2.69	12.02	1.12
SHARED BATH	2	24	56	2.69	24.05	2.23
BEDROOM NO.5	2	36	56	0	28.00	2.60
MASTER ENSUITE	3	24	56	2.69	36.07	3.35
ININO I EK ENOUTTE	1	72	56	8.01	36.01	3.35
TOTAL	41	-	-	-	573.03	53.24
WALL AREA	-	-	-	-	4407.29	409.45
RATIO	_	-	-	-	13.00	13.00

W Architect Inc.

DESIGN CONTROL REVIEW

JANUARY 21, 2022


FINAL

RECERT BY: GGE

This stamp is only for the purposes of design control and carries no other professional obligations.

MODEL 40-4 NATASHA

3.	DEC. Ø8/21	RE-16SUED FOR BUILDING PERMIT	MS	
2.	NOV. Ø5/21	ISSUED FOR BUILDING PERMIT	MS	
i.	OCT. Ø5/21	189UED TO STRUCT, ENG. /HYAC FOR REVIEW AND COMMENTS	MS	
No:	DATE:	REVISION/ISSUED:	BY:	

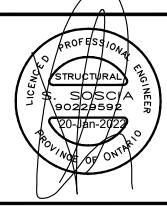



SURIANO.

ARCHITECTURAL DESIGN

SURIANO DESIGN CONSULTANTS INC. 51 Roysun Road, Unit 1 Vaughan, Ontario L4L 8P9 T. 905-264-0924

	D WALL & AREA CALCI		
DATE PLOTTED:	DRAWN BY:	AREA:	ı
DEC. Ø8/21	M.H./J.L.AM	3239 sq.ft.	
DATE:	TYPE:	PAGE No:	Γ
OCT. 23/2Ø		_	
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SCALE:	PROJECT No:		ı
3/16"=1'-0"	20-104		1

ROYAL PINE HOMES

PROJECT NAME:

ODEL NAME:

MODEL 40-4 NATASHA


ELEVATION A(4 BEDROOM) WITH WALK-UP BASEMENT CONDITION

DOOR & WINDOWS GLASS AREA TO PERIPHERAL INSULATED WALLS RATIO--O.B.C. SB-12 ART. 3.1.1.2(1) **ELEVATION A**

		Ŀ	ELEVATION A			
ROOM	QUANTITY	WIDTH(IN.)	HEIGHT(IN.)	ARCH AREA	WINDOW / DOOR R.S.O. (SQ.FT.)	WINDOW / DOOR R.S.O. (SQ.M.)
BASEMENT	5	30	16	0	16.67	1.55
DASEIVIENT	1	20	32	0	4.44	0.41
	1	48	8	0	2.67	0.25
FOYER	1	8	72	0	4.00	0.37
	1	26	41	0	7.40	0.69
PWDR.	1	24	52	2.69	11.36	1.06
FWDIN.	1	36	52	4.02	17.02	1.58
HOME OFFICE	1	72	52	8.01	34.01	3.16
	2	24	68	0	22.67	2.11
DINING / LIVING ROOM	2	23	56	0	17.89	1.66
	1	62	8	0	3.44	0.32
FAMILY ROOM	2	24	52	2.69	22.71	2.11
T AWILT ROOM	2	72	52	8.01	68.02	6.32
BREAKFAST	1	76	96	0	50.67	4.71
DREAKFAST	1	36	48	0	12.00	1.11
MUDROOM	1	24	40	0	6.67	0.62
MASTER BEDROOM	2	48	56	0	37.33	3.47
DRESSING ROOM	1	24	48	0	8.00	0.74
ENSUITE NO.2	1	24	48	0	8.00	0.74
BEDROOM NO.2	1	48	52	5.34	22.67	2.11
W.I.CL.	1	24	56	0	9.33	0.87
	1	36	56	4.02	18.02	1.67
BEDROOM NO.3	1	24	56	0	9.33	0.87
BEDITOON NO.3	1	36	56	0	14.00	1.30
	1	24	56	2.69	12.02	1.12
SHARED BATH	2	24	56	2.69	24.05	2.23
BEDROOM NO.4	2	36	56	0	28.00	2.60
MASTER ENSUITE	3	24	56	2.69	36.07	3.35
WASTER ENSUITE	1	72	56	8.01	36.01	3.35
TOTAL	42	-	-	-	564.48	52.44
WALL AREA	-	-	-	-	4377.05	406.64
RATIO	-	-	-	-	12.90	12.90

W Architect Inc. **DESIGN CONTROL REVIEW** JANUARY 21, 2022 RECERT BY: GGE

RE-199UED FOR BUILDING PERMIT 2. NOV. 05/21 ISSUED FOR BUILDING PERMIT ISSUED TO STRUCT, ENG. /HVAC FOR REVIEW AND COMMENTS OCT. Ø5/21 REVISION/ISSUED:

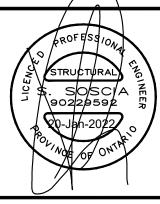



SURIANO. ARCHITECTURAL DESIGN

SURIANO DESIGN CONSULTANTS INC. 51 Roysun Road, Unit 1 Vaughan, Ontario L4L 8P9 T. 905-264-0924

INSULATED WALL & WINDOW OPENINGS AREA CALCULATIONS-A DATE PLOTTED: DEC. Ø8/21 M.H./J.LAM 3239 sq.ft. PAGE No: DATE: TYPE: OCT. 23/20

PROJECT No:

20-104

SCALE:

3/16"=1'-0"

ROYAL PINE HOMES

MODEL 40-4 NATASHA

PROJECT NAME:

Ø3

MODEL 40-4 NATASHA

DOOR & WINDOWS GLASS AREA TO PERIPHERAL INSULATED WALLS RATIO--O.B.C. SB-12 ART. 3.1.1.2(1) **ELEVATION A**

ELEVATION A(5 BEDROOM)

WITH WALK-UP BASEMENT CONDITION

			LLVATIONA			
ROOM	QUANTITY	WIDTH(IN.)	HEIGHT(IN.)	ARCH AREA	WINDOW / DOOR R.S.O. (SQ.FT.)	WINDOW / DOOF R.S.O. (SQ.M.)
BASEMENT	5	30	16	0	16.67	1.55
DASEIVIENT	1	20	32	0	4.44	0.41
	1	48	8	0	2.67	0.25
FOYER	1	8	72	0	4.00	0.37
	1	26	41	0	7.40	0.69
PWDR.	1	24	52	2.69	11.36	1.06
PWDR.	1	36	52	4.02	17.02	1.58
HOME OFFICE	1	72	52	8.01	34.01	3.16
	2	24	68	0	22.67	2.11
DINING / LIVING ROOM	2	23	56	0	17.89	1.66
	1	62	8	0	16.67 4.44 2.67 4.00 7.40 11.36 17.02 34.01 22.67 17.89 3.44 22.71 68.02 50.67 12.00 6.67 37.33 20.67 6.67 22.67 9.33 18.02 9.33 14.00 12.02 24.05 28.00 36.07 36.01 575.81	0.32
FAMILY DOOM	2	24	52	2.69	22.71	2.11
FAMILY ROOM	2	72	52	8.01	68.02	6.32
DDEAKEACT	1	76	96	0	50.67	4.71
BREAKFAST	1	36	48	0	12.00	1.11
MUDROOM	1	24	40	0	6.67	0.62
MASTER BEDROOM	2	48	56	0	37.33	3.47
BEDROOM NO.2	1	48	62	0	20.67	1.92
SHARED BATH	1	24	40	0	6.67	0.62
BEDROOM NO.3	1	48	52	5.34	22.67	2.11
W.I.CL.	1	24	56	0	9.33	0.87
	1	36	56	4.02	18.02	1.67
BEDROOM NO.4	1	24	56	0	9.33	0.87
DEDROOM NO.4	1	36	56	0	14.00	1.30
	1	24	56	2.69	12.02	1.12
SHARED BATH	2	24	56	2.69	24.05	2.23
BEDROOM NO.5	2	36	56	0	28.00	2.60
MACTED ENGLITE	3	24	56	2.69	36.07	3.35
MASTER ENSUITE	1	72	56	8.01	36.01	3.35
TOTAL	42	-	-	-	575.81	53.49
WALL AREA	-	-	-	-	4377.05	406.64
RATIO	-	-	-	-	13.16	13.16

ELEVATION B (4 BEDROOM)

DOOR & WINDOWS GLASS AREA TO PERIPHERAL INSULATED WALLS RATIO--O.B.C. SB-12 ART. 3.1.1.2(1) ELEVATION A

ELEVATION A							
ROOM	QUANTITY	WIDTH(IN.)	HEIGHT(IN.)	ARCH AREA	WINDOW / DOOR R.S.O. (SQ.FT.)	WINDOW / DOOR R.S.O. (SQ.M.)	
BASEMENT	5	30	16	0	16.67	1.55	
FOYER	1	62	8	0	3.44	0.32	
FUTER	2	11	80	0	12.22	1.14	
PWDR.	1	24	70	0	11.67	1.08	
PWDR.	1	48	70	0	23.33	2.17	
HOME OFFICE	1	60	70	0	29.17	2.71	
	1	64	8	0	3.56	0.33	
DINING / LIVING ROOM	1	24	70	0	11.67	1.08	
	2	23	55	0	17.57	1.63	
	3	24	70	0	35.00	3.25	
FAMILY ROOM	1	36	70	0	17.50	1.63	
	1	72	70	0	35.00	3.25	
BREAKFAST	1	76	96	0	50.67	4.71	
DKEAKFAST	1	48	48	0	16.00	1.49	
MUDROOM (SUNKEN)	1	24	40	0	6.67	0.62	
MASTER BEDROOM	1	72	74	0	37.00	3.44	
MASTER BEDROOM	1	48	74	0	24.67	2.29	
DRESSING ROOM	1	24	48	0	8.00	0.74	
ENSUITE NO.2	1	24	48	0	8.00	0.74	
BEDROOM NO.2	1	72	78	0	39.00	3.62	
W.I.CL.	1	30	74	0	15.42	1.43	
	1	60	92	0	38.33	3.56	
BEDROOM NO.3	1	24	74	0	12.33	1.15	
	1	48	74	0	17.50 35.00 50.67 16.00 6.67 37.00 24.67 8.00 8.00 39.00 15.42 38.33	2.29	
SHARED BATH	1	60	92	0	38.33	3.56	
BEDROOM NO.4	1	60	74	0	30.83	2.86	
BEDROOM NO.4	1	24	74	0	12.33	1.15	
	1	24	74	0	12.33	1.15	
MASTER ENSUITE	1	36	74	0	18.50	1.72	
	1	72	74	0	37.00	3.44	
TOTAL	38	-	-	-	646.88	60.10	
WALL AREA	-	-		-	4251.12	394.94	
RATIO	-	-	-	-	15.22	15.22	


ELEVATION B (5 BEDROOM)

		ALLS RATIO		ERIPHERAL II ART. 3.1.1.2(1		
ROOM	QUANTITY	WIDTH(IN.)	HEIGHT(IN.)	ARCH AREA	WINDOW / DOOR R.S.O. (SQ.FT.)	WINDOW / DOOR R.S.O. (SQ.M.)
BASEMENT	5	30	16	0	16.67	1.55
FOYER	1	62	8	0	3.44	0.32
FUTER	2	11	80	0	12.22	1.14
DWDD	1	24	70	0	11.67	1.08
PWDR.	1	48	70	0	23.33	2.17
HOME OFFICE	1	60	70	0	29.17	2.71
	1	64	8	0	3.56	0.33
DINING / LIVING ROOM	1	24	70	0	11.67	1.08
	2	23	55	0	17.57	1.63
	3	24	70	0	35.00	3.25
FAMILY ROOM	1	36	70	0	17.50	1.63
	1	72	70	0	35.00	3.25
BREAKFAST	1	76	96	0	50.67	4.71
BREAKFAST	1	48	48	0	16.00	1.49
MUDROOM (SUNKEN)	1	24	40	0	6.67	0.62
MACTED DEDDOOM	1	72	74	0	37.00	3.44
MASTER BEDROOM	1	48	74	0	24.67	2.29
BEDROOM NO.2	1	48	62	0	20.67	1.92
SHARED BATH	1	24	40	0	6.67	0.62
BEDROOM NO.3	1	72	78	0	39.00	3.62
W.I.CL.	1	30	74	0	15.42	1.43
	1	60	92	0	38.33	3.56
BEDROOM NO.4	1	24	74	0	12.33	1.15
DEDROOM NO.4	1	48	74	0	24.67	2.29
	1	60	92	0	38.33	3.56
SHARED BATH	1	60	74	0	30.83	2.86
BEDROOM NO.5	1	24	74	0	12.33	1.15
MACTED ENGLITE	1	24	74	0	12.33	1.15
MASTER ENSUITE	1	36	74	0	18.50	1.72
	1	72	74	0	37.00	3.44
TOTAL	38	-	-	-	658.21	61.15
WALL AREA	-	-	-	-	4251.12	394.94
RATIO	-	-	-	-	15.48	15.48



MODEL 40-4 NATASHA

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3.	DEC. Ø8/21	RE-199UED FOR BUILDING PERMIT	MS	
2.	NOV. Ø5/21	ISSUED FOR BUILDING PERMIT	MS	
1.	OCT. Ø5/21	186UED TO STRUCT, ENG. /HYAC FOR REVIEW AND COMMENTS	MS	
No:	DATE:	REVISION/ISSUED:	BY:	

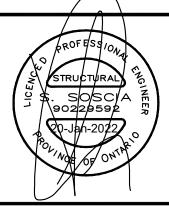



SURIANO.

ARCHITECTURAL DESIGN

SURIANO DESIGN CONSULTANTS INC. 51 Roysun Road, Unit 1 Vaughan, Ontario L4L 8P9 T. 905-264-0924

	D WALL & AREA CALCI		
DATE PLOTTED:	DRAWN BY:	AREA:	
DEC. Ø8/21	M.H./J.L.AM	3239 sq.ft.	
DATE: OCT. 23/2Ø	TYPE:	PAGE No:	
SCALE:	PROJECT No:	04	-
3/16"=1'-0"	20-104		l

ROYAL PINE HOMES

PAGE NO: PROJECT NAME:

MODEL NAME:

MODEL 40-4 NATASHA

ELEVATION B(4 BEDROOM) WITH WOOD DECK CONDITION

DOOR & WINDOWS GLASS AREA TO PERIPHERAL INSULATED WALLS RATIO-O.B.C. SB-12 ART. 3.1.1.2(1) **ELEVATION A**

			•			
ROOM	QUANTITY	WIDTH(IN.)	HEIGHT(IN.)	ARCH AREA	WINDOW / DOOR R.S.O. (SQ.FT.)	WINDOW / DOOR R.S.O. (SQ.M.)
DACEMENT	4	30	16	0	13.33	1.24
BASEMENT	1	30	24	0	5.00	0.46
FOVED	1	62	8	0	3.44	0.32
FOYER	2	11	80	0	12.22	1.14
DWDD	1	24	70	0	11.67	1.08
PWDR.	1	48	70	0	23.33	2.17
HOME OFFICE	1	60	70	0	29.17	2.71
	1	64	8	0	3.56	0.33
DINING / LIVING ROOM	1	24	70	0	11.67	1.08
	2	23	55	0	17.57	1.63
	3	24	70	0	35.00	3.25
FAMILY ROOM	1	36	70	0	17.50	1.63
	1	72	70	0	35.00	3.25
DDEAKEACT	1	76	96	0	50.67	4.71
BREAKFAST	1	48	48	0	16.00	1.49
MUDROOM (SUNKEN)	1	24	40	0	6.67	0.62
MACTED DEDDOOM	1	72	74	0	37.00	3.44
MASTER BEDROOM	1	48	74	0	24.67	2.29
DRESSING ROOM	1	24	48	0	8.00	0.74
ENSUITE NO.2	1	24	48	0	8.00	0.74
BEDROOM NO.2	1	72	78	0	39.00	3.62
W.I.CL.	1	30	74	0	15.42	1.43
	1	60	92	0	38.33	3.56
BEDROOM NO.3	1	24	74	0	12.33	1.15
	1	48	74	0	24.67	2.29
SHARED BATH	1	60	92	0	38.33	3.56
BEDROOM NO.4	1	60	74	0	30.83	2.86
DEDROOM NO.4	1	24	74	0	12.33	1.15
	1	24	74	0	12.33	1.15
MASTER ENSUITE	1	36	74	0	18.50	1.72
	1	72	74	0	37.00	3.44
TOTAL	38	-	-	-	648.54	60.25
WALL AREA	-	-	-	-	4376.63	406.60
RATIO	-	-	-	-	14.82	14.82

ELEVATION B(5 BEDROOM) WITH WOOD DECK CONDITION

DOOR & WINDOWS GLASS AREA TO PERIPHERAL INSULATED WALLS RATIO--O.B.C. SB-12 ART. 3.1.1.2(1) **ELEVATION A**


ROOM	QUANTITY	WIDTH(IN.)	HEIGHT(IN.)	ARCH AREA	WINDOW / DOOR R.S.O. (SQ.FT.)	WINDOW / DOOF R.S.O. (SQ.M.)
DACEMENT	4	30	16	0	13.33	1.24
BASEMENT	1	30	24	0	5.00	0.46
FOVED	1	62	8	0	3.44	0.32
FOYER	2	11	80	0	12.22	1.14
DWDD	1	24	70	0	11.67	1.08
PWDR.	1	48	70	0	23.33	2.17
HOME OFFICE	1	60	70	0	29.17	2.71
	1	64	8	0	3.56	0.33
DINING / LIVING ROOM	1	24	70	0	11.67	1.08
	2	23	55	0	17.57	1.63
	3	24	70	0	35.00	3.25
FAMILY ROOM	1	36	70	0	17.50	1.63
	1	72	70	0	35.00	3.25
DDEAKEACT	1	76	96	0	50.67	4.71
BREAKFAST	1	48	48	0	16.00	1.49
MUDROOM (SUNKEN)	1	24	40	0	6.67	0.62
MACTED DEDDOOM	1	72	74	0	37.00	3.44
MASTER BEDROOM	1	48	74	0	24.67	2.29
BEDROOM NO.2	1	48	62	0	20.67	1.92
SHARED BATH	1	24	40	0	6.67	0.62
BEDROOM NO.3	1	72	78	0	39.00	3.62
W.I.CL.	1	30	74	0	15.42	1.43
	1	60	92	0	38.33	3.56
DEDDOOM NO 4	1	24	74	0	12.33	1.15
BEDROOM NO.4	1	48	74	0	24.67	2.29
	1	60	92	0	38.33	3.56
SHARED BATH	1	60	74	0	30.83	2.86
BEDROOM NO.5	1	24	74	0	12.33	1.15
MACTED ENGLITE	1	24	74	0	12.33	1.15
MASTER ENSUITE	1	36	74	0	18.50	1.72
	1	72	74	0	37.00	3.44
TOTAL	38	-	-	-	659.88	61.30
WALL AREA	-	-	-	-	4376.63	406.60
RATIO	-	-	-	=	15.08	15.08

W Architect Inc. JANUARY 21, 2022 RECERT BY: GGE

DESIGN CONTROL REVIEW

MODEL 40-4 NATASHA

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3.	DEC. Ø8/21	RE-ISSUED FOR BUILDING PERMIT	MS	'
2.	NOV. Ø5/21	199UED FOR BUILDING PERMIT	MS	
1.	OCT. Ø5/21	199UED TO STRUCT, ENG. /HVAC FOR REVIEW AND COMMENTS	MS	
No:	DATE:	REVISION/ISSUED:	BY:	
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SURIANO. ARCHITECTURAL DESIGN

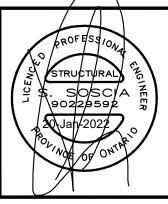SURIANO DESIGN CONSULTANTS INC. 51 Roysun Road, Unit 1 Vaughan, Ontario L4L 8P9 T. 905-264-0924

SHEET NAME:			
INSULATE	D WALL #	WINDOW .	ı
	AREA CALCU		ı
		ALA HORO-D	ı
DATE PLOTTED:	DRAWN BY:	AREA:	ı
DEC. Ø8/21	M.H./J.L.AM	3239 sq.ft.	ı
		•	
DATE:	TYPE:	PAGE No:	
OCT. 23/20			ı
		ØE	l
SCALE:	PROJECT No:	Ø5	Г
3/16"=1'-0"	20-104		l

ROYAL PINE HOMES

PROJECT NAME:

MODEL 40-4 NATASHA

ELEVATION B(4 BEDROOM) WITH WALK-UP BASEMENT CONDITION

ROOM QUANTITY WIDTH(IN.) BLEVATION A WINDOW / DOOR R.S.O. (SQ.FT.) WINDOW / DOOR R.S.O. (SQ.FT.) To be a constant of the constant of the

ROOM	QUANTITY	WIDTH(IN.)	HEIGHT(IN.)	ARCH AREA	R.S.O. (SQ.FT.)	WINDOW / DOOR R.S.O. (SQ.M.)
BASEMENT	5	30	16	0	16.67	1.55
DASEIVIENT	1	20	32	0	4.44	0.41
FOYER	1	62	8	0	3.44	0.32
FUIER	2	11	80	0	12.22	1.14
PWDR.	1	24	70	0	11.67	1.08
FWDR.	1	48	70	0	23.33	2.17
HOME OFFICE	1	60	70	0	29.17	2.71
	1	64	8	0	3.56	0.33
DINING / LIVING ROOM	1	24	70	0	11.67	1.08
	2	23	55	0	17.57	1.63
	3	24	70	0	35.00	3.25
FAMILY ROOM	1	36	70	0	17.50	1.63
	1	72	70	0	35.00	3.25
DDEALEACT	1	76	96	0	50.67	4.71
BREAKFAST	1	48	48	0	16.00	1.49
MUDROOM (SUNKEN)	1	24	40	0	6.67	0.62
MACTED DEDDOOM	1	72	74	0	37.00	3.44
MASTER BEDROOM	1	48	74	0	24.67	2.29
DRESSING ROOM	1	24	48	0	8.00	0.74
ENSUITE NO.2	1	24	48	0	8.00	0.74
BEDROOM NO.2	1	72	78	0	39.00	3.62
W.I.CL.	1	30	74	0	15.42	1.43
	1	60	92	0	38.33	3.56
BEDROOM NO.3	1	24	74	0	12.33	1.15
	1	48	74	0	24.67	2.29
SHARED BATH	1	60	92	0	38.33	3.56
DEDDOOM NO 4	1	60	74	0	30.83	2.86
BEDROOM NO.4	1	24	74	0	12.33	1.15
	1	24	74	0	12.33	1.15
MASTER ENSUITE	1	36	74	0	18.50	1.72
	1	72	74	0	37.00	3.44
TOTAL	39	-	-	-	651.32	60.51
WALL AREA	-	-	-	-	4346.39	403.79
RATIO	-	-	-	-	14.99	14.99


ELEVATION B(5 BEDROOM) WITH WALK-UP BASEMENT CONDITION

DOOR & WINDOWS GLASS AREA TO PERIPHERAL INSULATED WALLS RATIO-O.B.C. SB-12 ART. 3.1.1.2(1) ELEVATION A							
ROOM	QUANTITY	WIDTH(IN.)	HEIGHT(IN.)	ARCH AREA	WINDOW / DOOR R.S.O. (SQ.FT.)	WINDOW / DOOR R.S.O. (SQ.M.)	
DACEMENT	5	30	16	0	16.67	1.55	
BASEMENT	1	20	32	0	4.44	0.41	
FOYER	1	62	8	0	3.44	0.32	
FUTER	2	11	80	0	12.22	1.14	
PWDR.	1	24	70	0	11.67	1.08	
FWDR.	1	48	70	0	23.33	2.17	
HOME OFFICE	1	60	70	0	29.17	2.71	
	1	64	8	0	3.56	0.33	
DINING / LIVING ROOM	1	24	70	0	11.67	1.08	
	2	23	55	0	17.57	1.63	
	3	24	70	0	35.00	3.25	
FAMILY ROOM	1	36	70	0	17.50	1.63	
	1	72	70	0	35.00	3.25	
BREAKFAST	1	76	96	0	50.67	4.71	
	1	48	48	0	16.00	1.49	
MUDROOM (SUNKEN)	1	24	40	0	6.67	0.62	
MASTER BEDROOM	1	72	74	0	37.00	3.44	
INIASTER BEDROOM	1	48	74	0	24.67	2.29	
BEDROOM NO.2	1	48	62	0	20.67	1.92	
SHARED BATH	1	24	40	0	6.67	0.62	
BEDROOM NO.3	1	72	78	0	39.00	3.62	
W.I.CL.	1	30	74	0	15.42	1.43	
	1	60	92	0	38.33	3.56	
BEDROOM NO.4	1	24	74	0	12.33	1.15	
BEDROOM NO.4	1	48	74	0	24.67	2.29	
	1	60	92	0	38.33	3.56	
SHARED BATH	1	60	74	0	30.83	2.86	
BEDROOM NO.5	1	24	74	0	12.33	1.15	
MASTER ENSUITE	1	24	74	0	12.33	1.15	
WIAGTER ENGULIE	1	36	74	0	18.50	1.72	
	1	72	74	0	37.00	3.44	
TOTAL	39	-	-	=	662.65	61.56	
WALL AREA	-	-	-	-	4346.39	403.79	
RATIO	-	-	-	-	15.25	15.25	



MODEL 40-4 NATASHA

3.	DEC. Ø8/21	RE-199UED FOR BUILDING PERMIT	MS
2.	NOV. Ø5/21	166UED FOR BUILDING PERMIT	MS
1.	OCT. Ø5/21	166UED TO STRUCT, ENG. /HVAC FOR REVIEW AND COMMENTS	MS
No:	DATE:	REVISION/ISSUED:	BY:

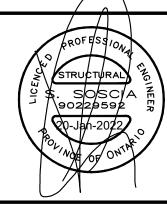






SURIANO. ARCHITECTURAL DESIGN


SURIANO DESIGN CONSULTANTS INC. 51 Roysun Road, Unit 1 Vaughan, Ontarlo L4L 8P9 T. 905-264-0924


SHEET NAME: INSULATED WALL & WINDOW OPENINGS AREA CALCULATIONS-B			ROYAL PINE
DATE PLOTTED:	DRAWN BY:	AREA:	
DEC. Ø8/21	M.H./J.L.AM	3239 sq.ft.	HOMES
DATE:	TYPE:	PAGE No:	PROJECT NAME:
OCT. 23/20	''' -	TAGE NO.	THOUSE I TOWNER
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SCALE:	PROJECT No:		MODEL NAME:
3/16"=1'-0"	20-104		MODEL 40-4 NATASHA

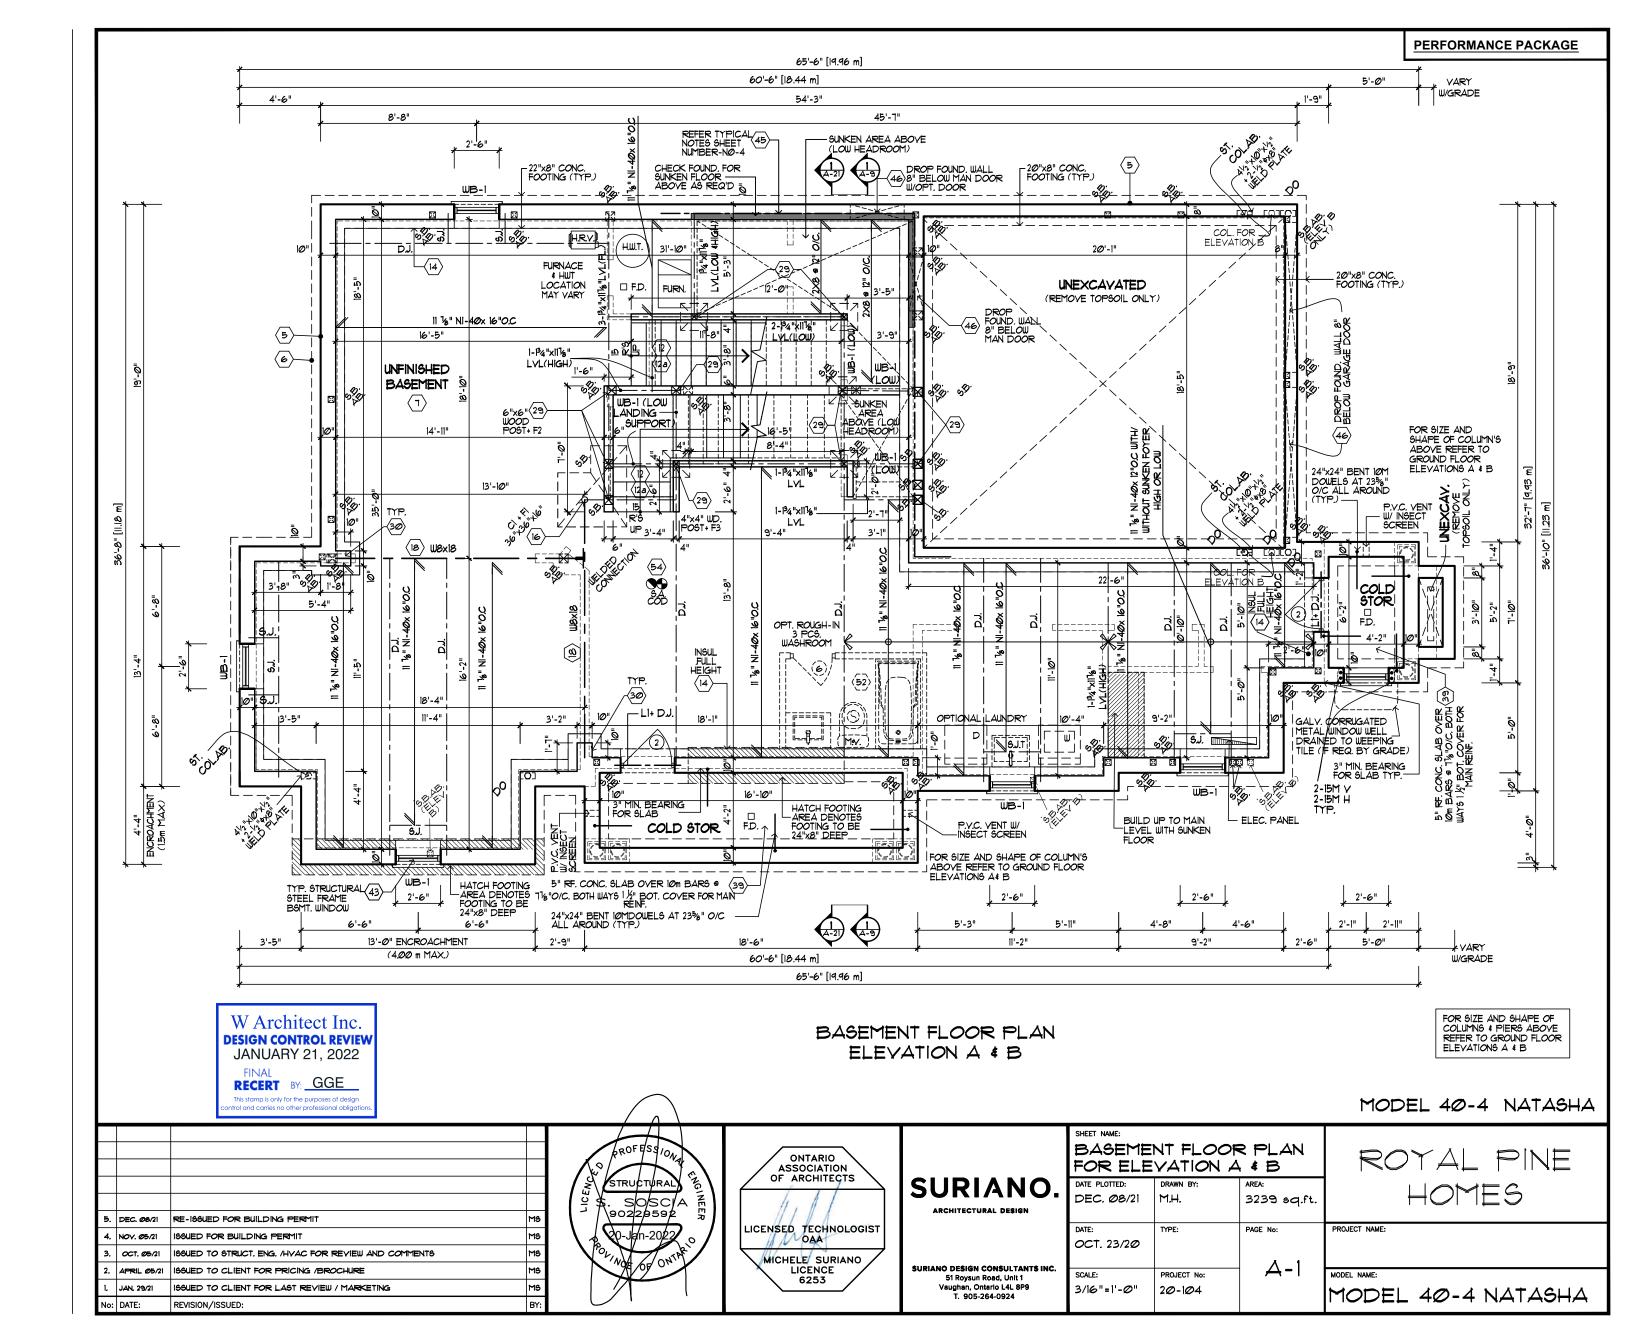


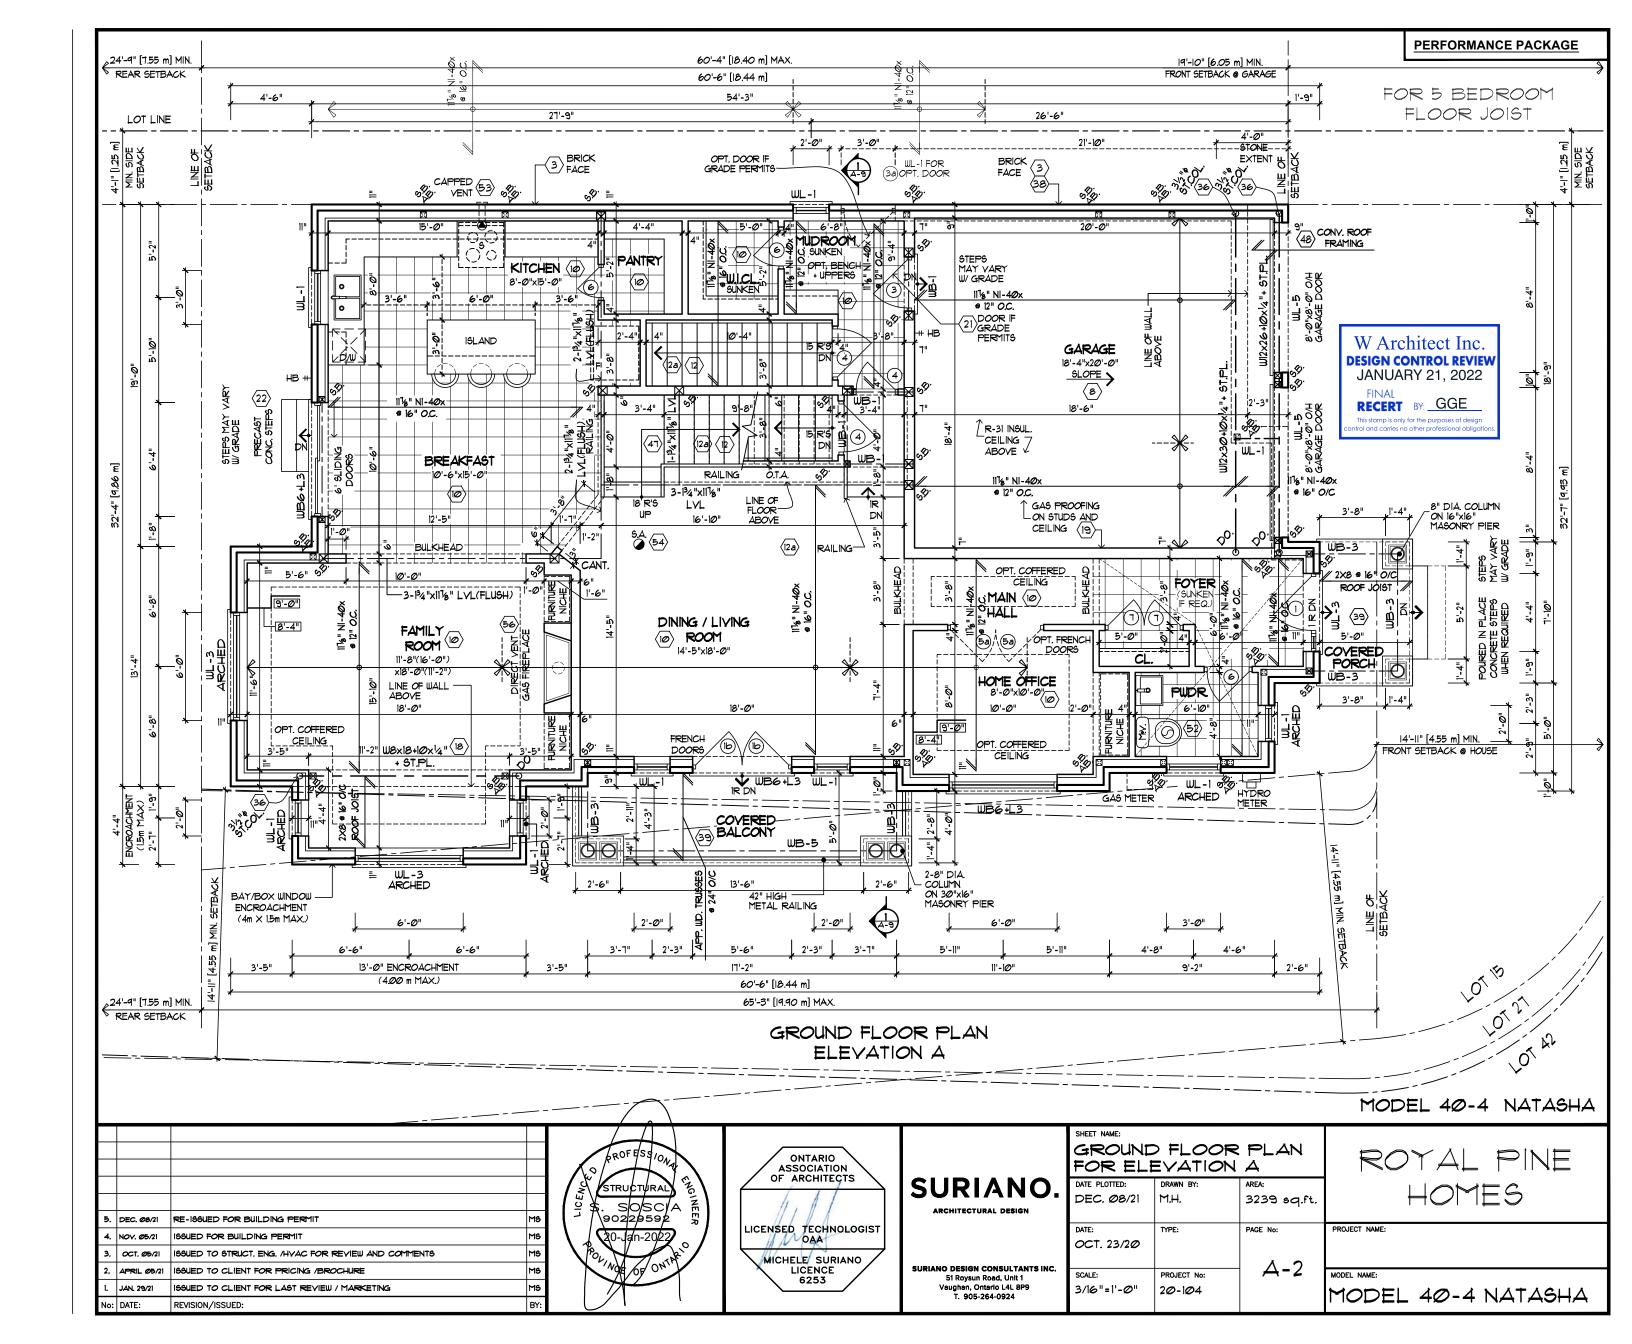


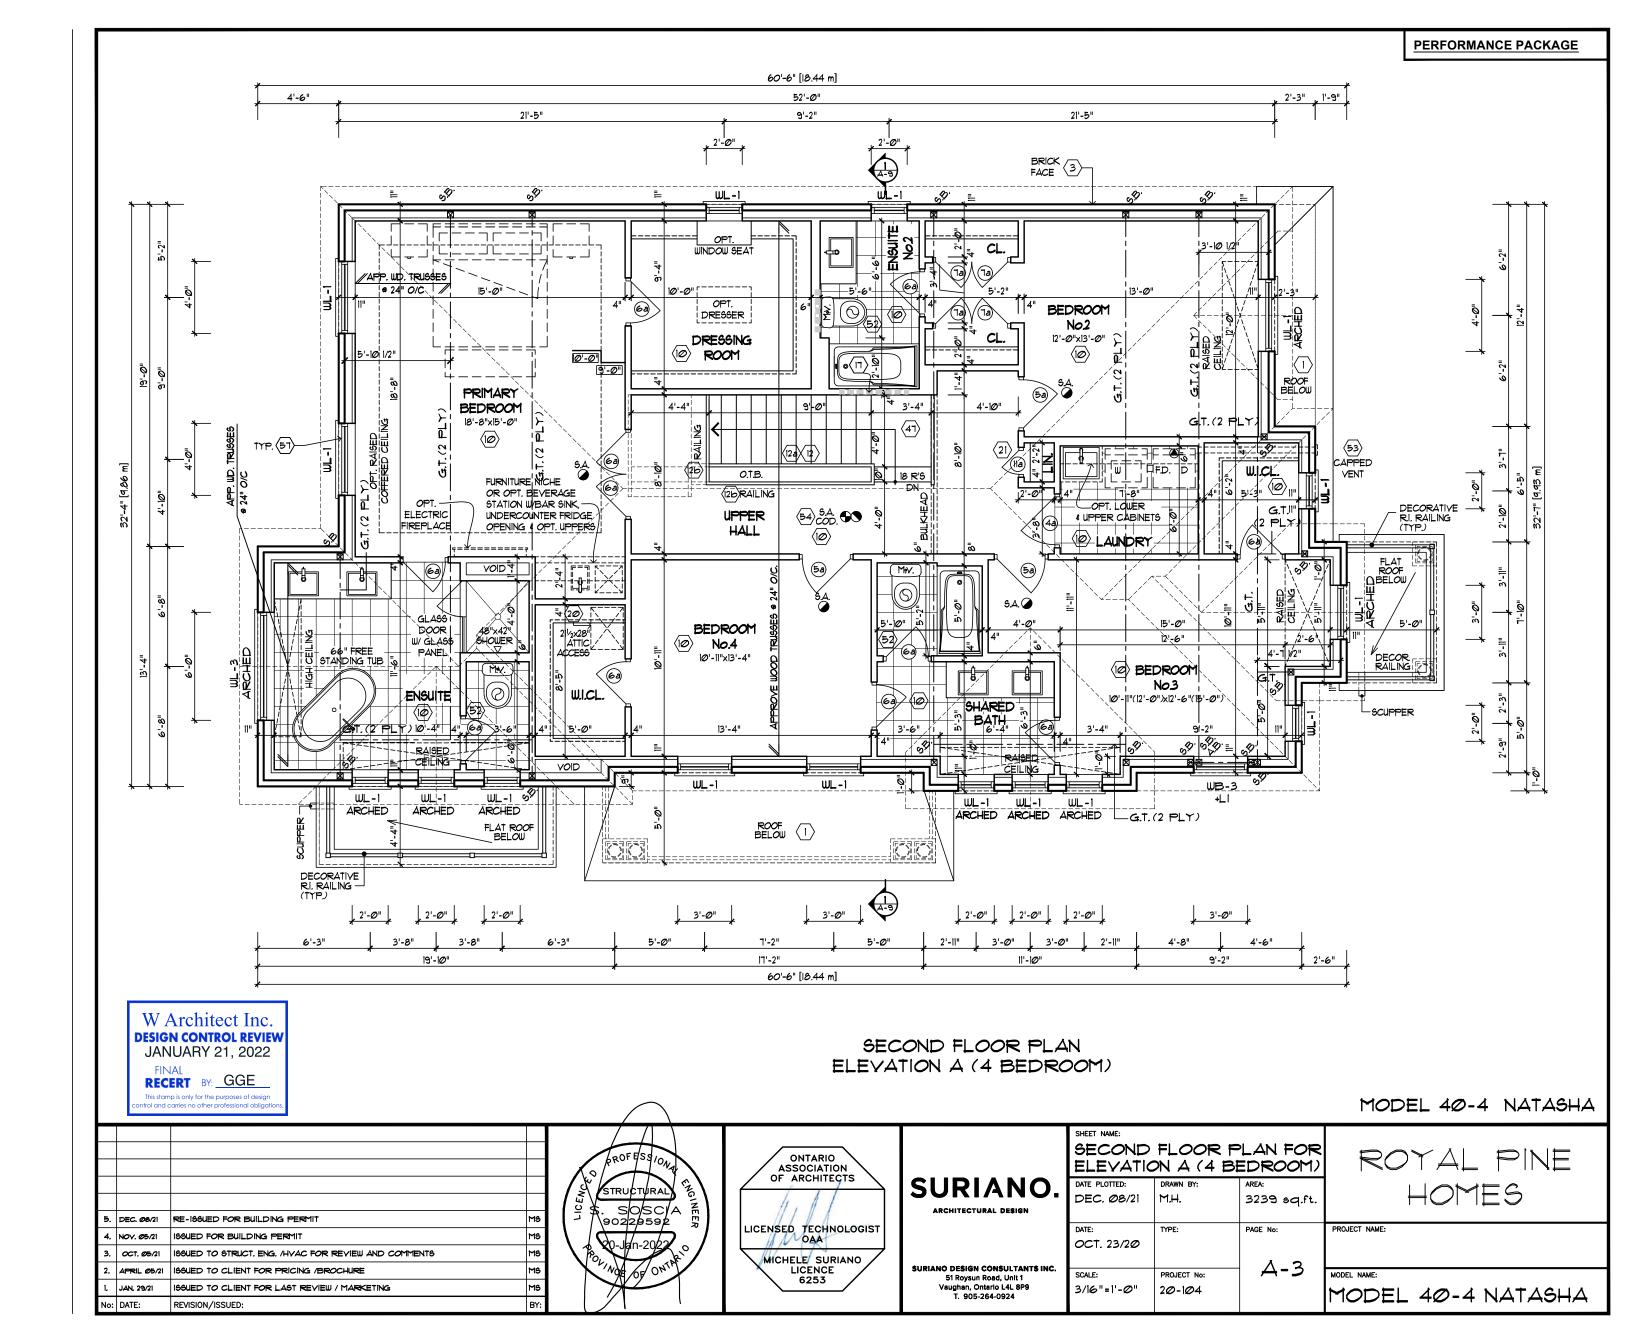


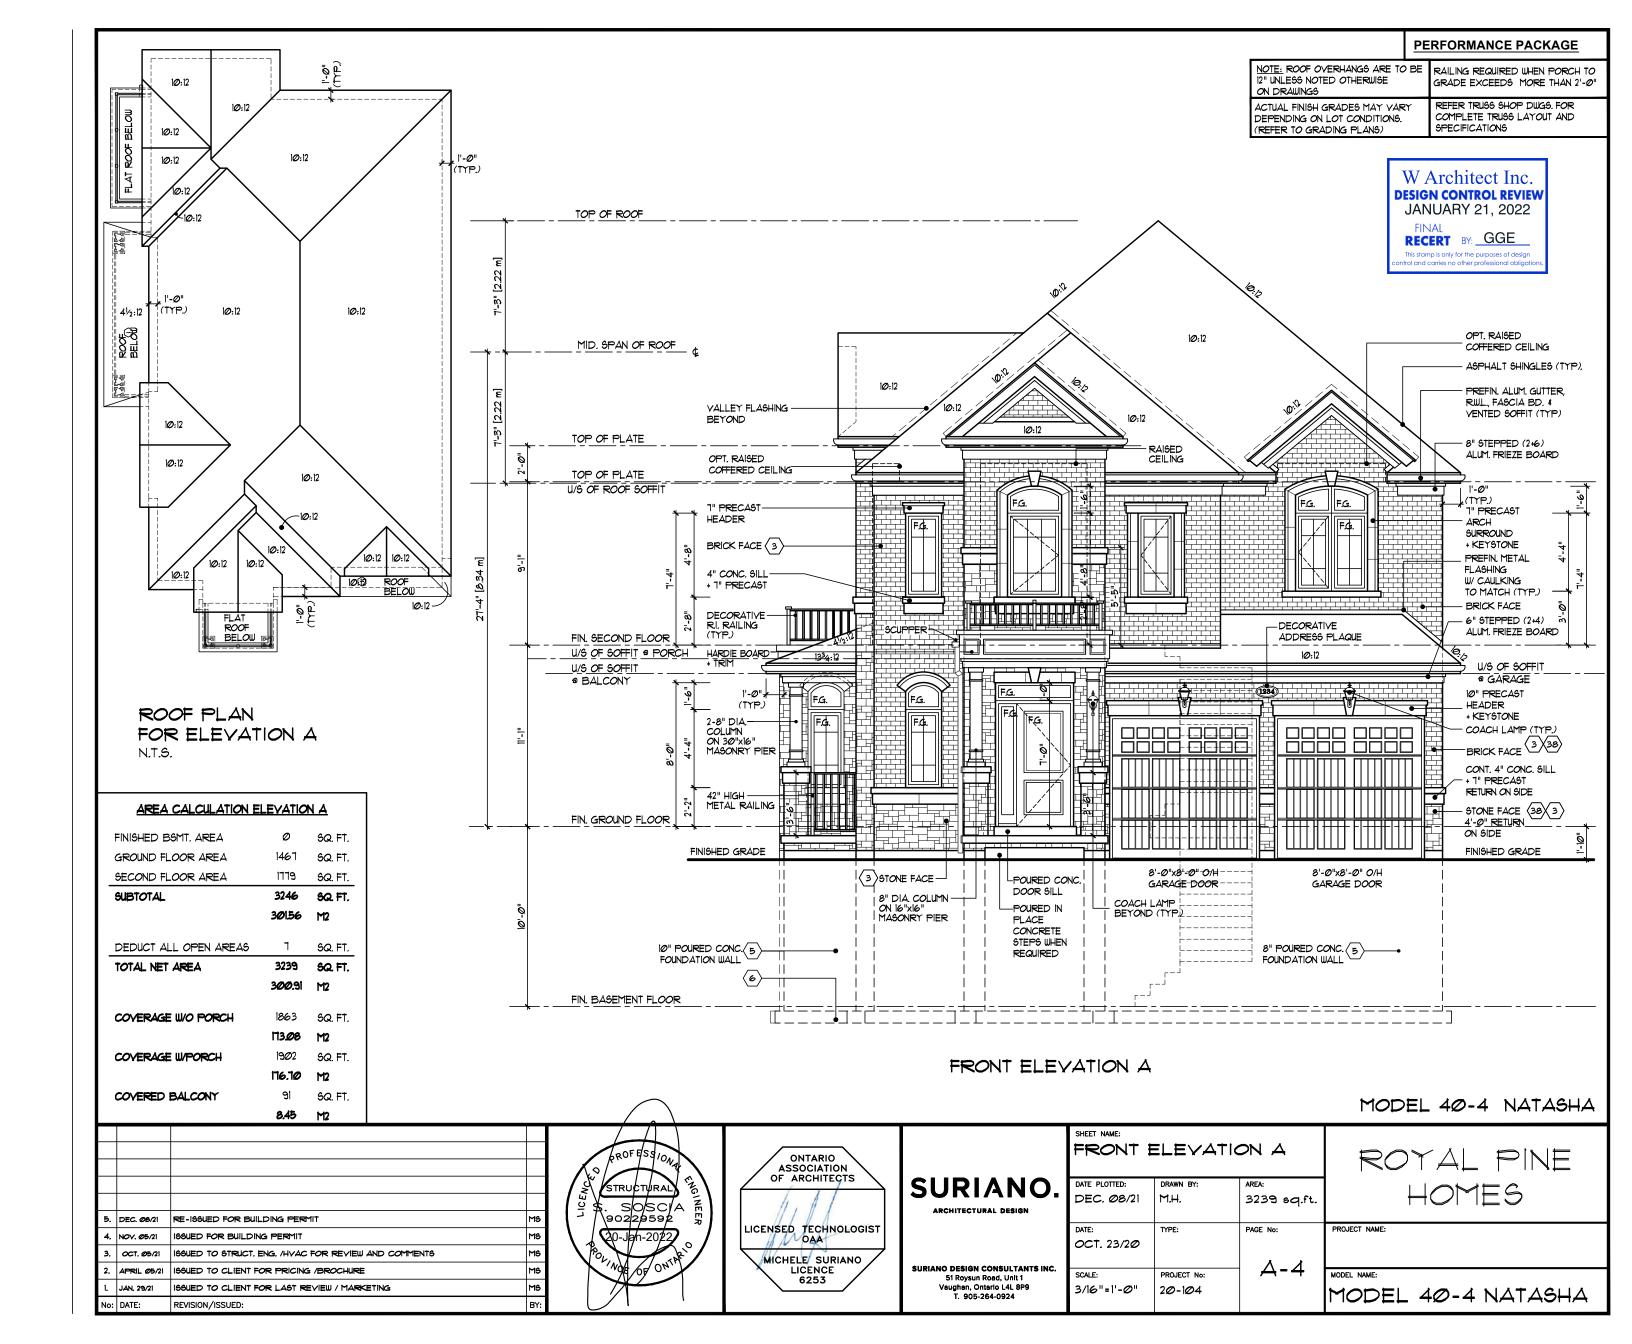


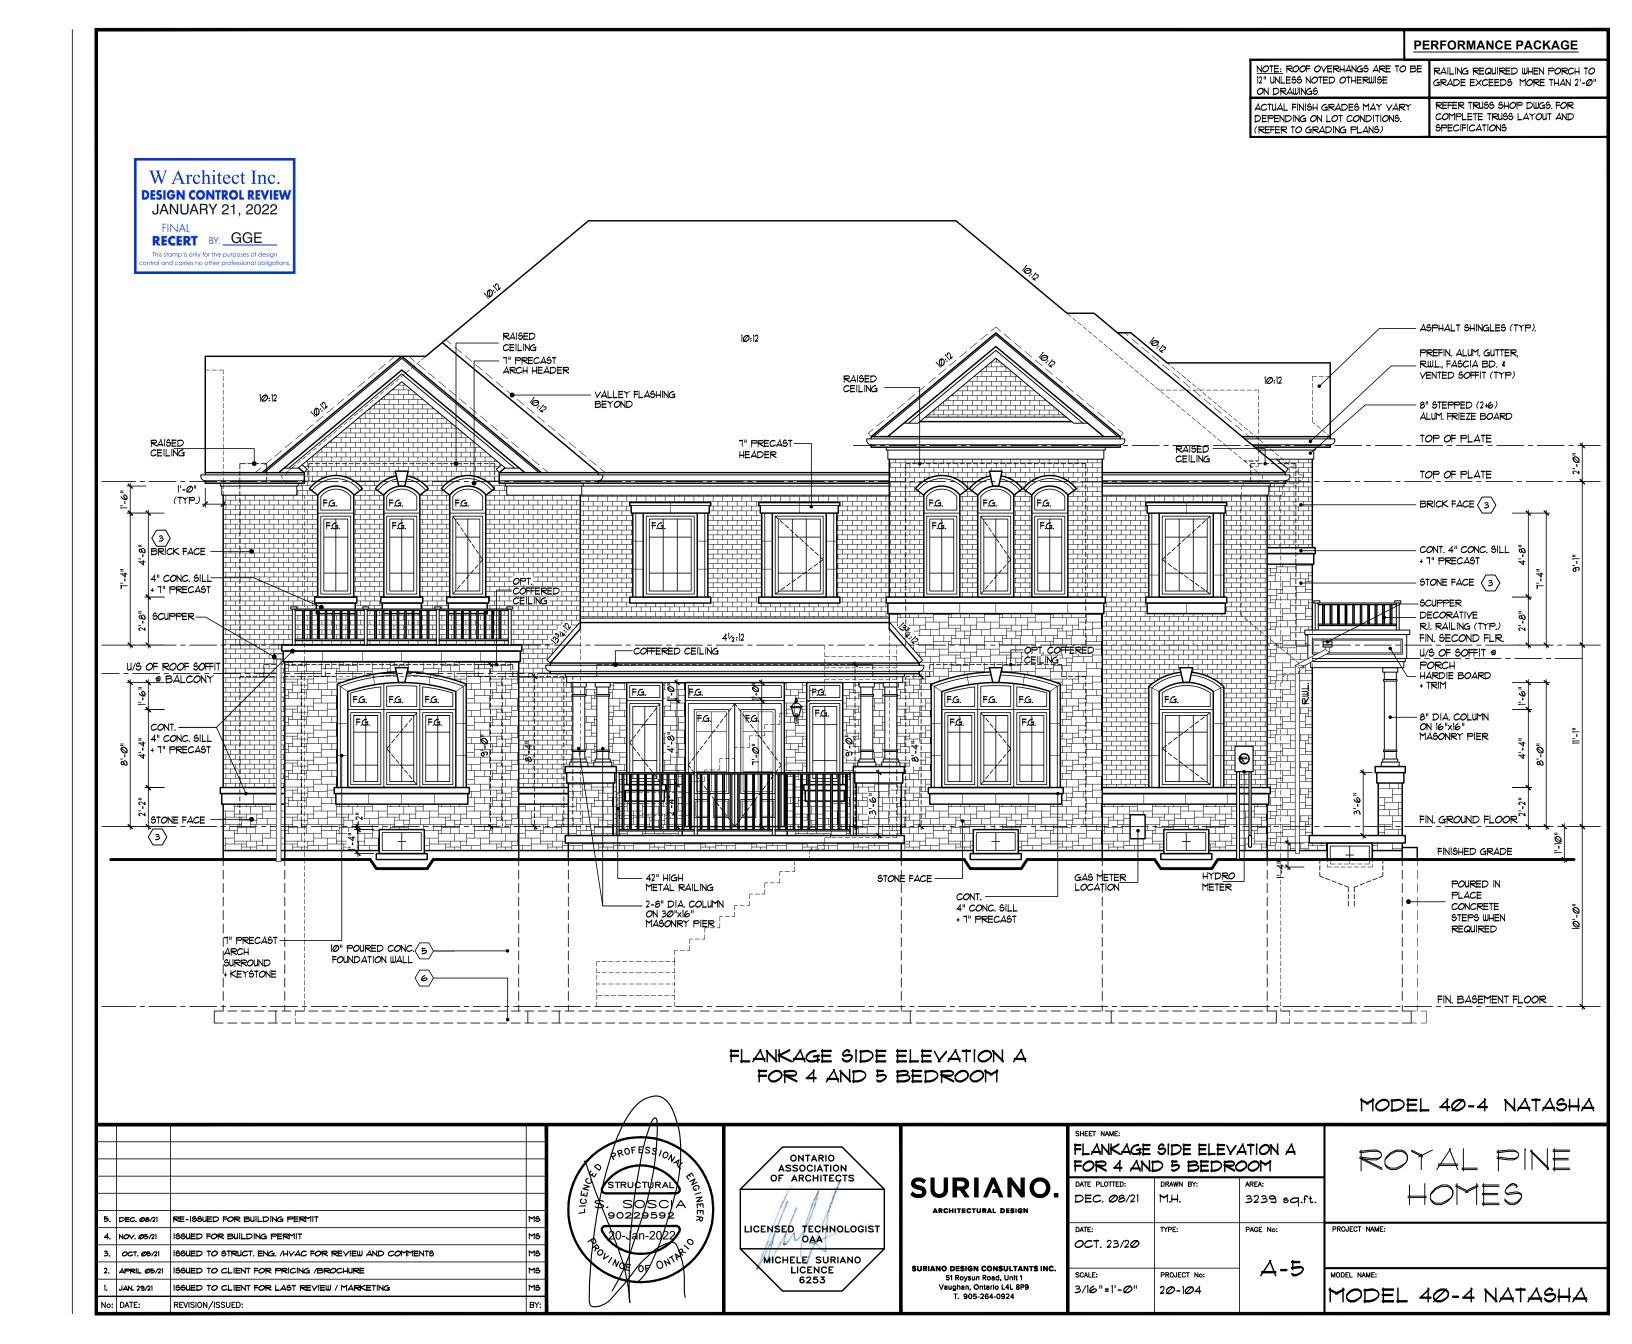


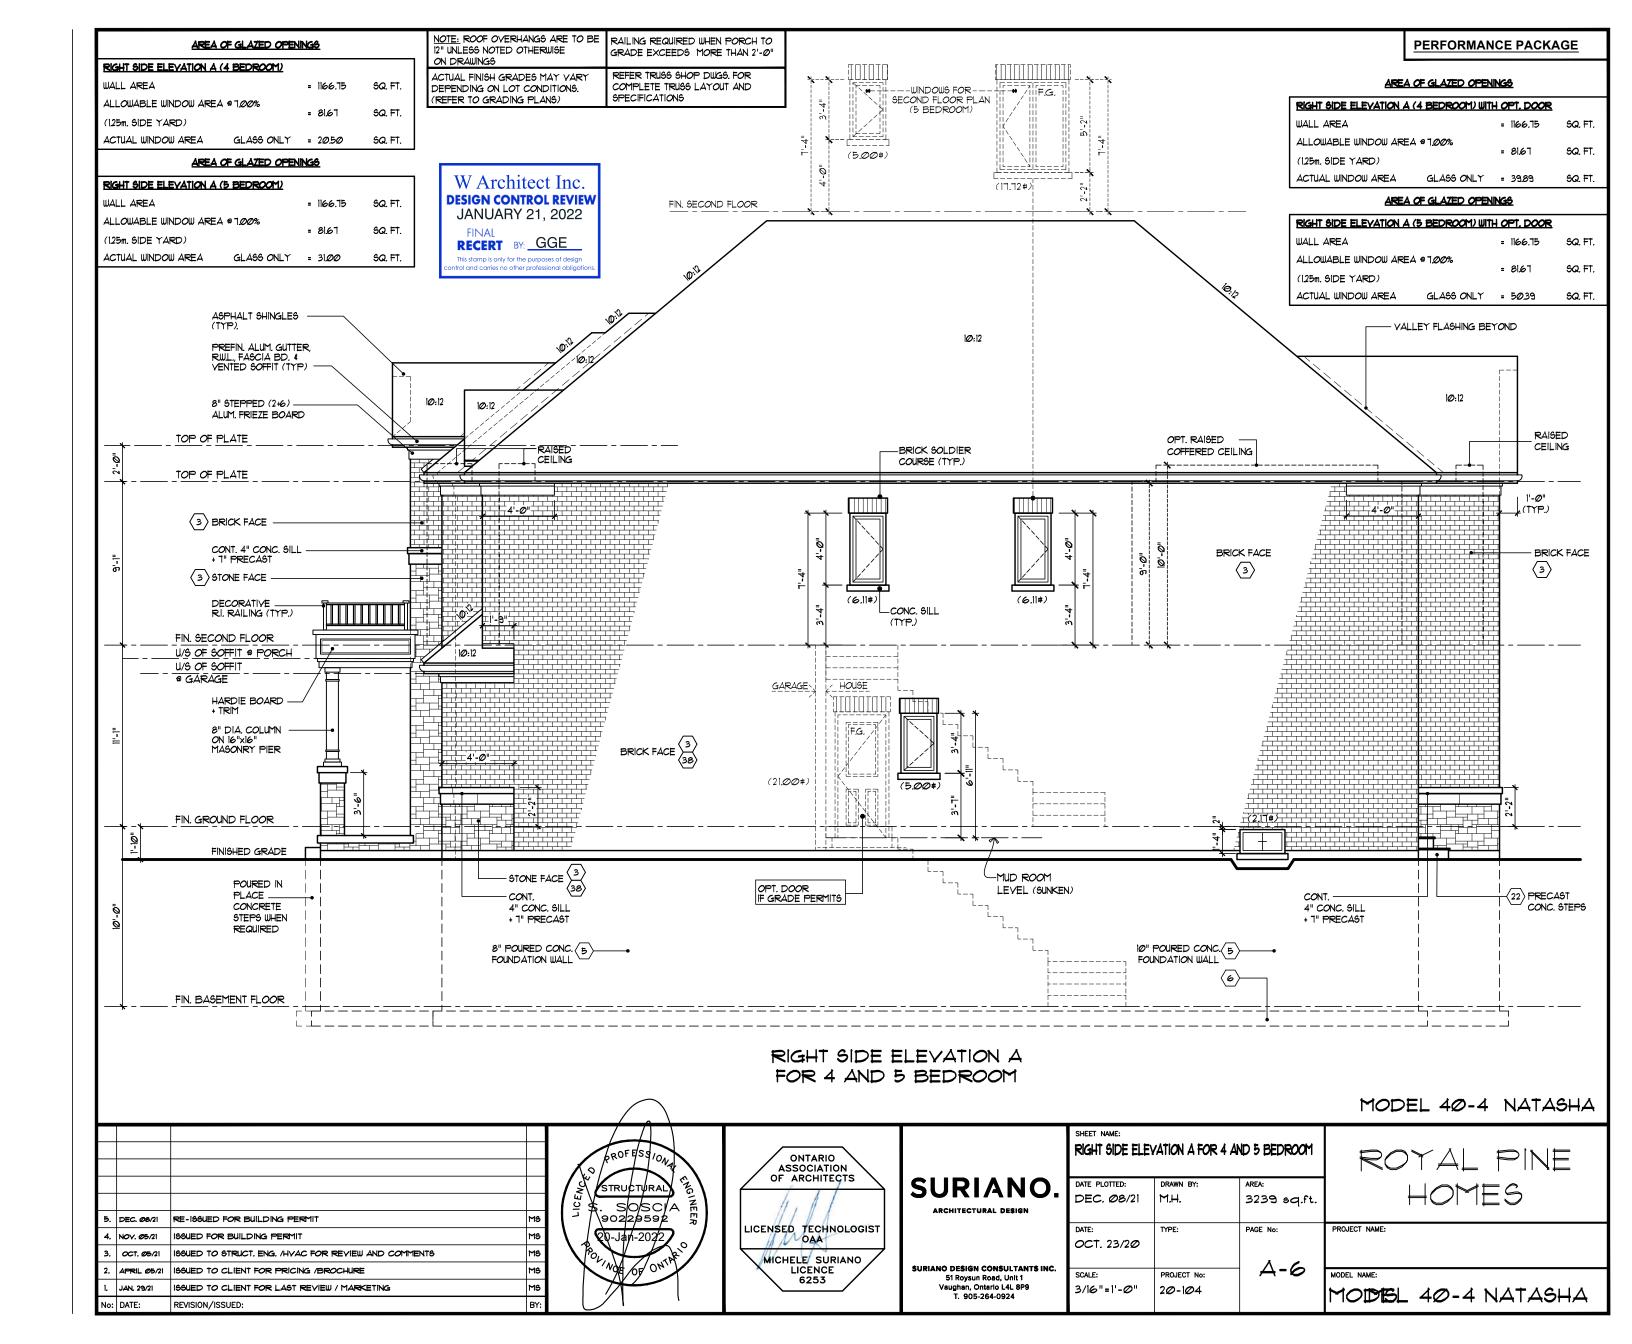


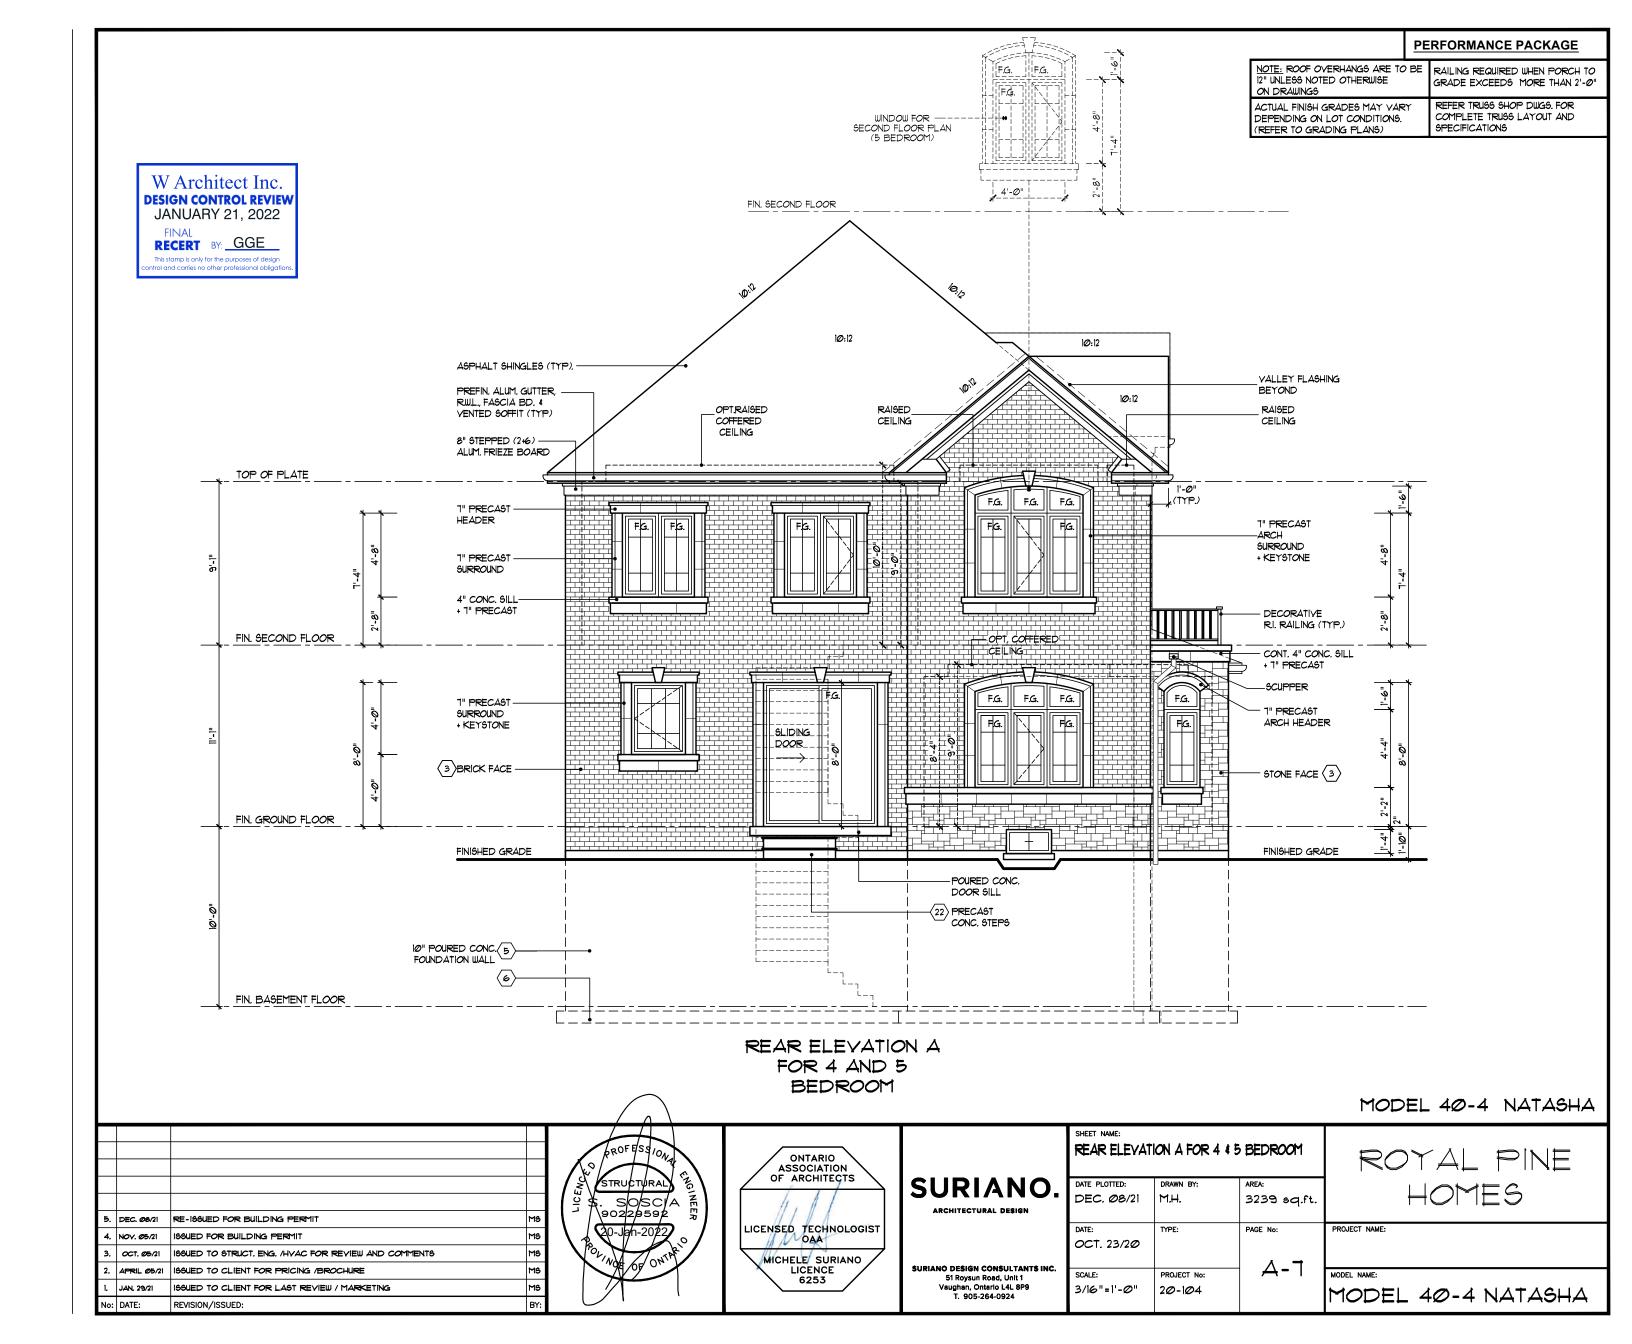


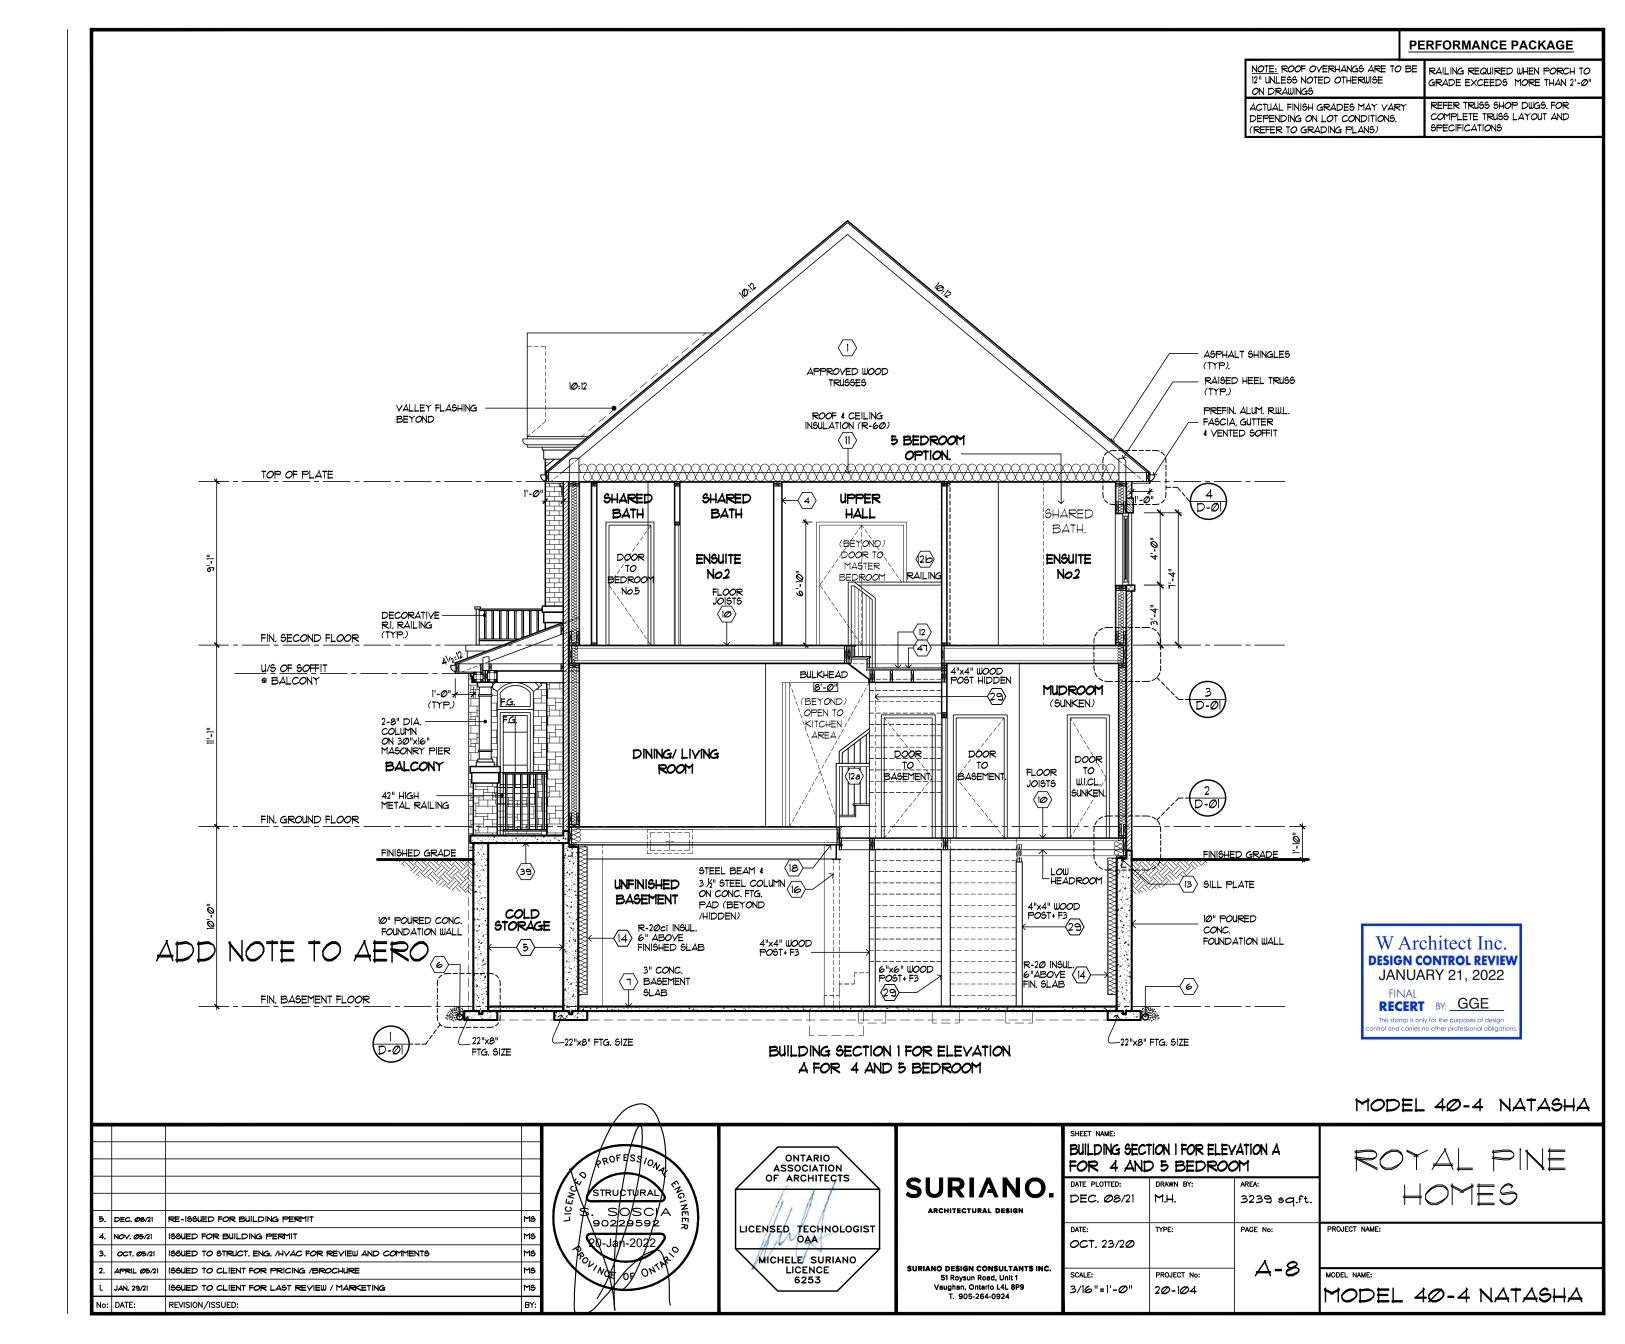


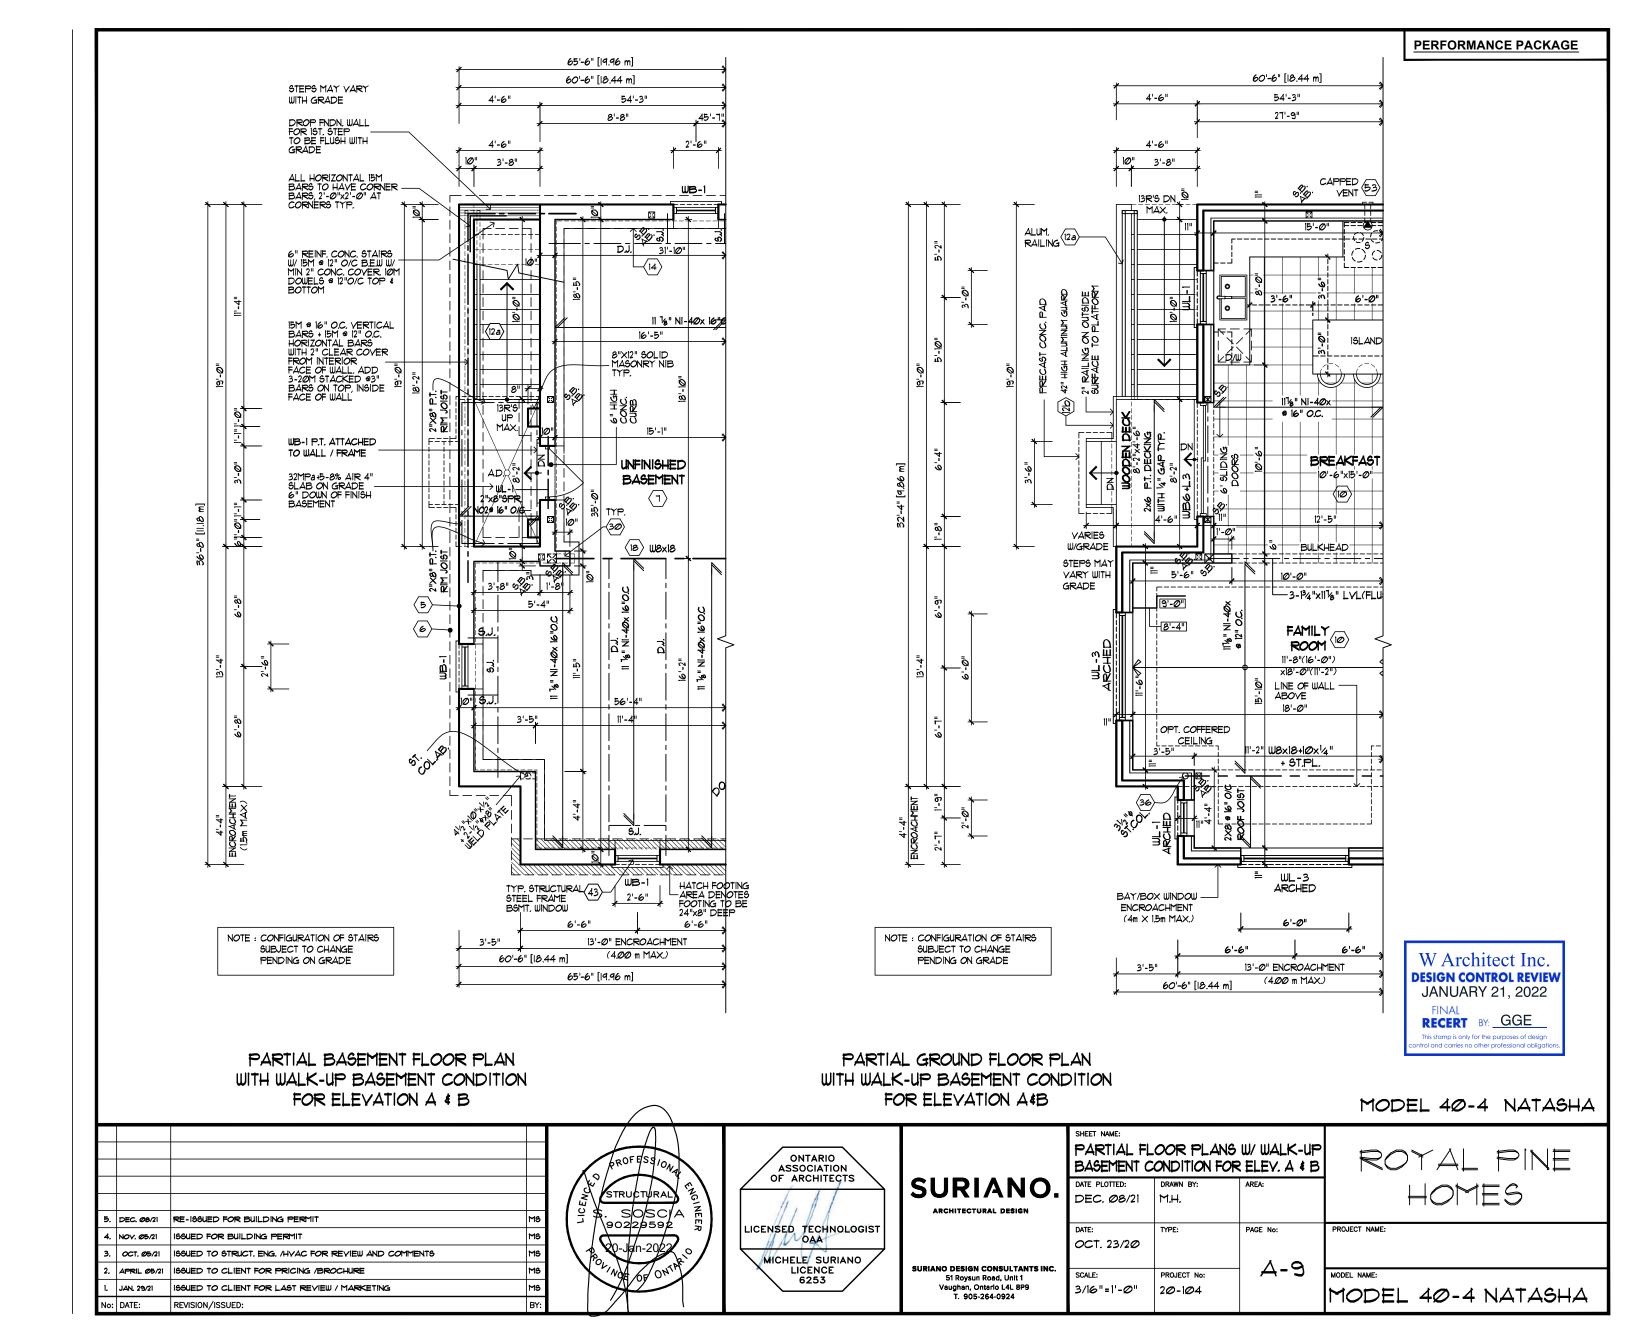


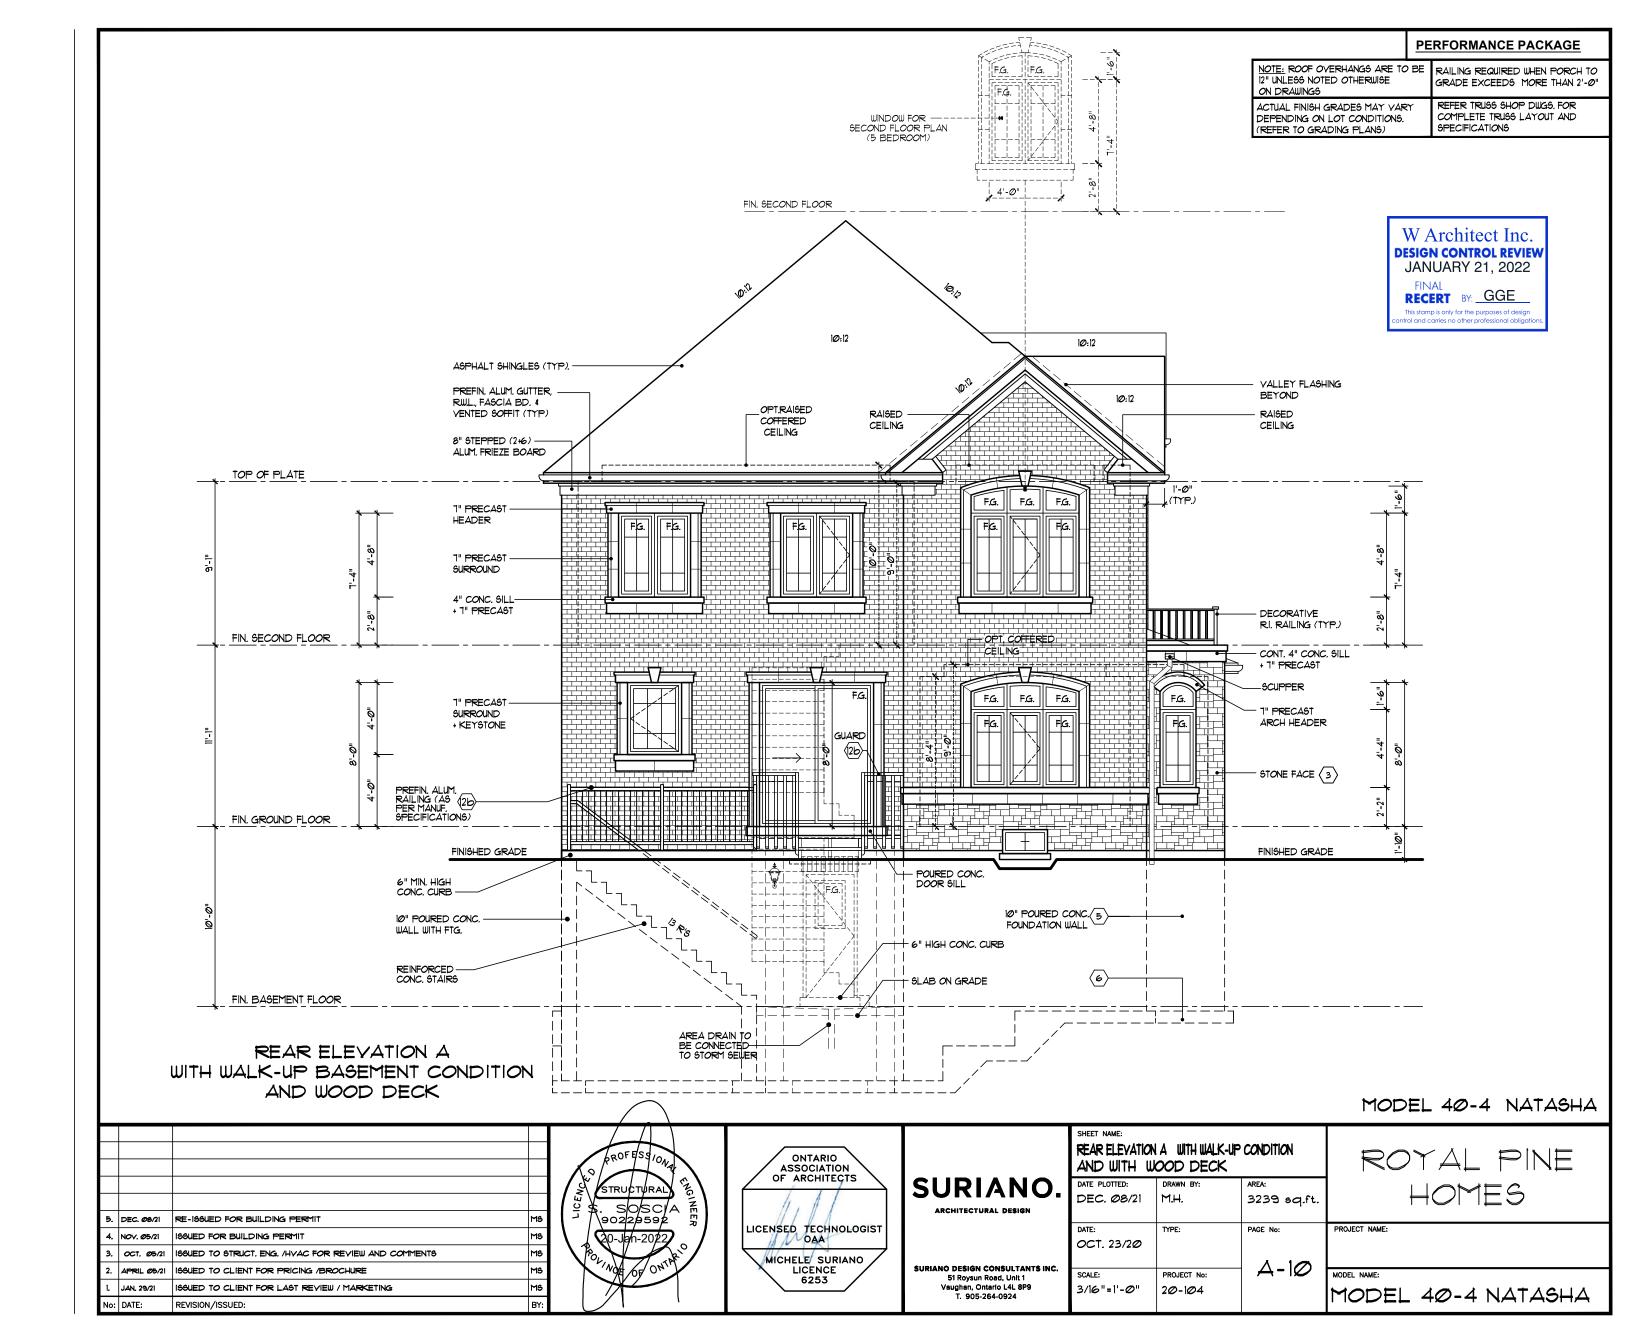


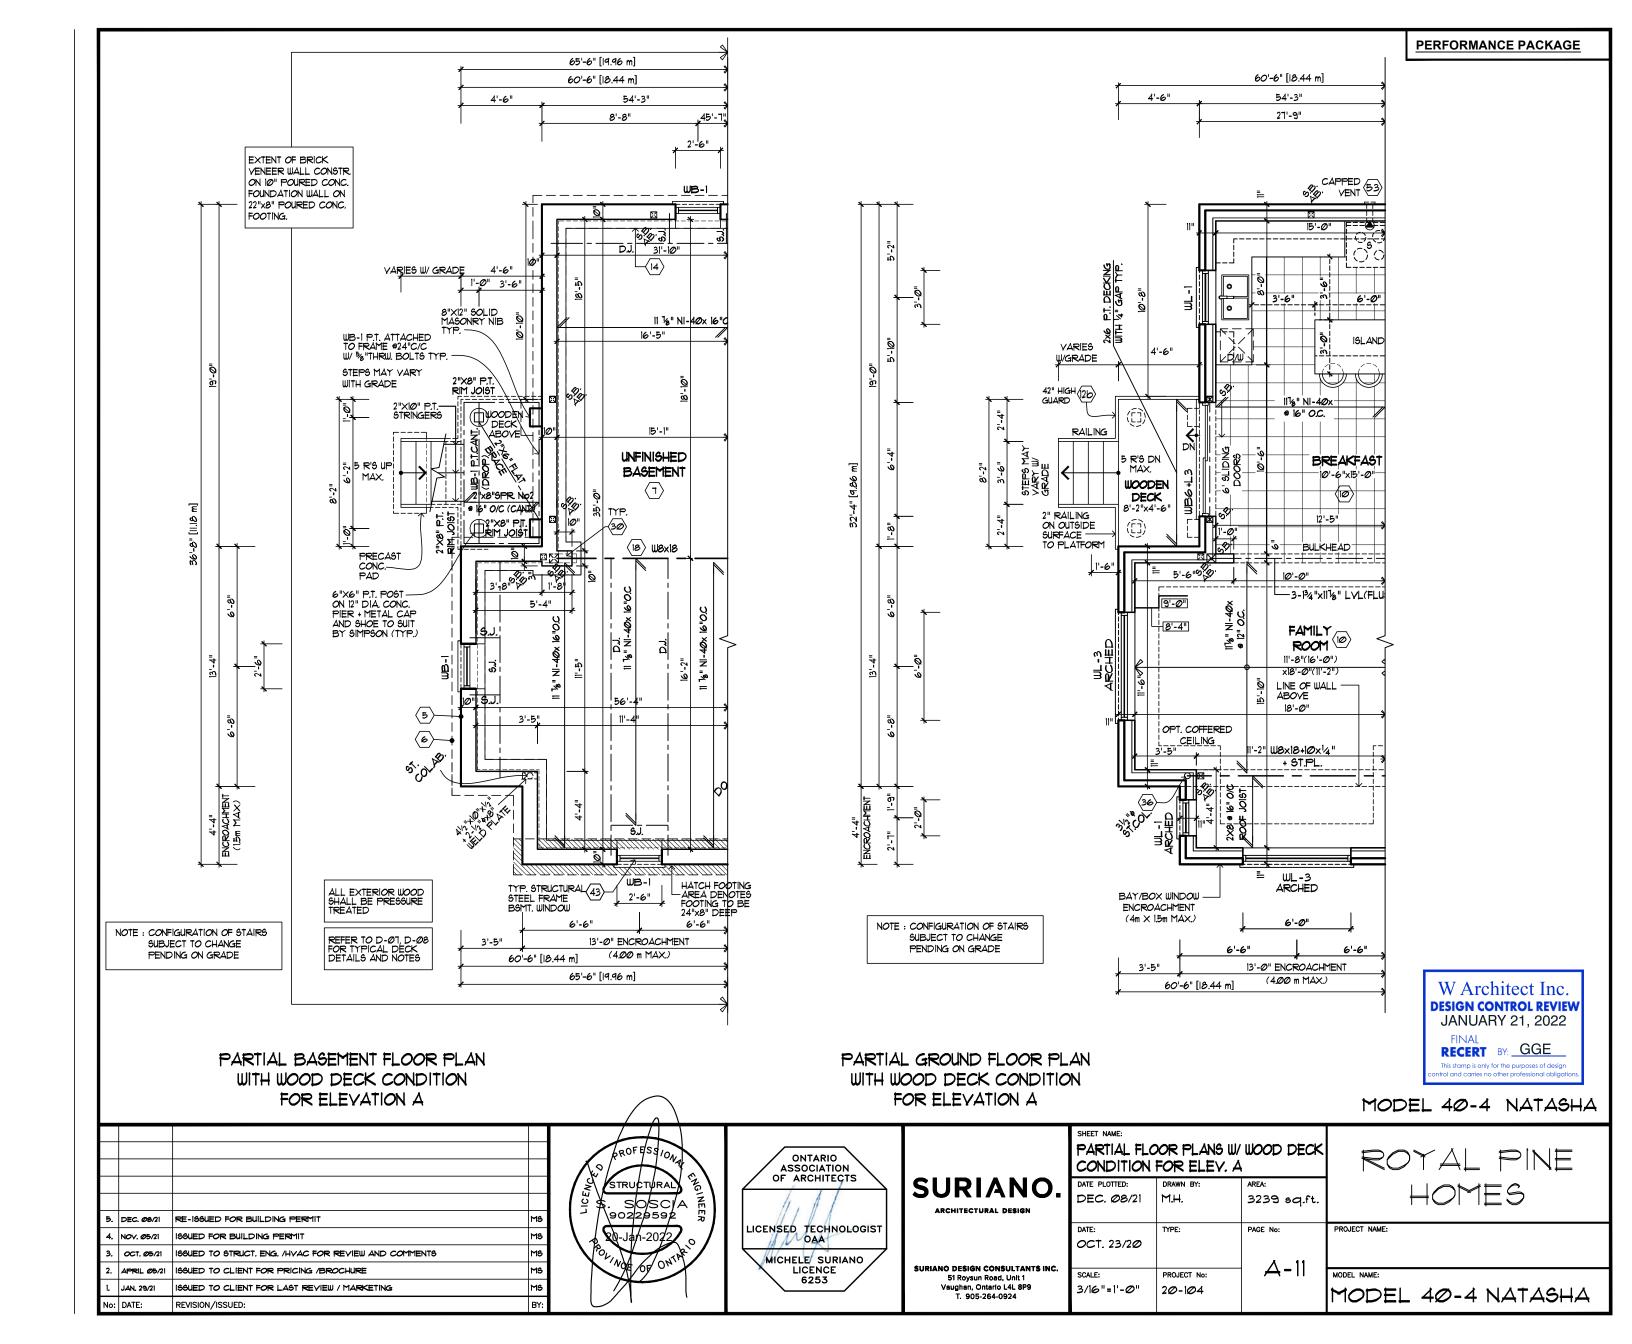


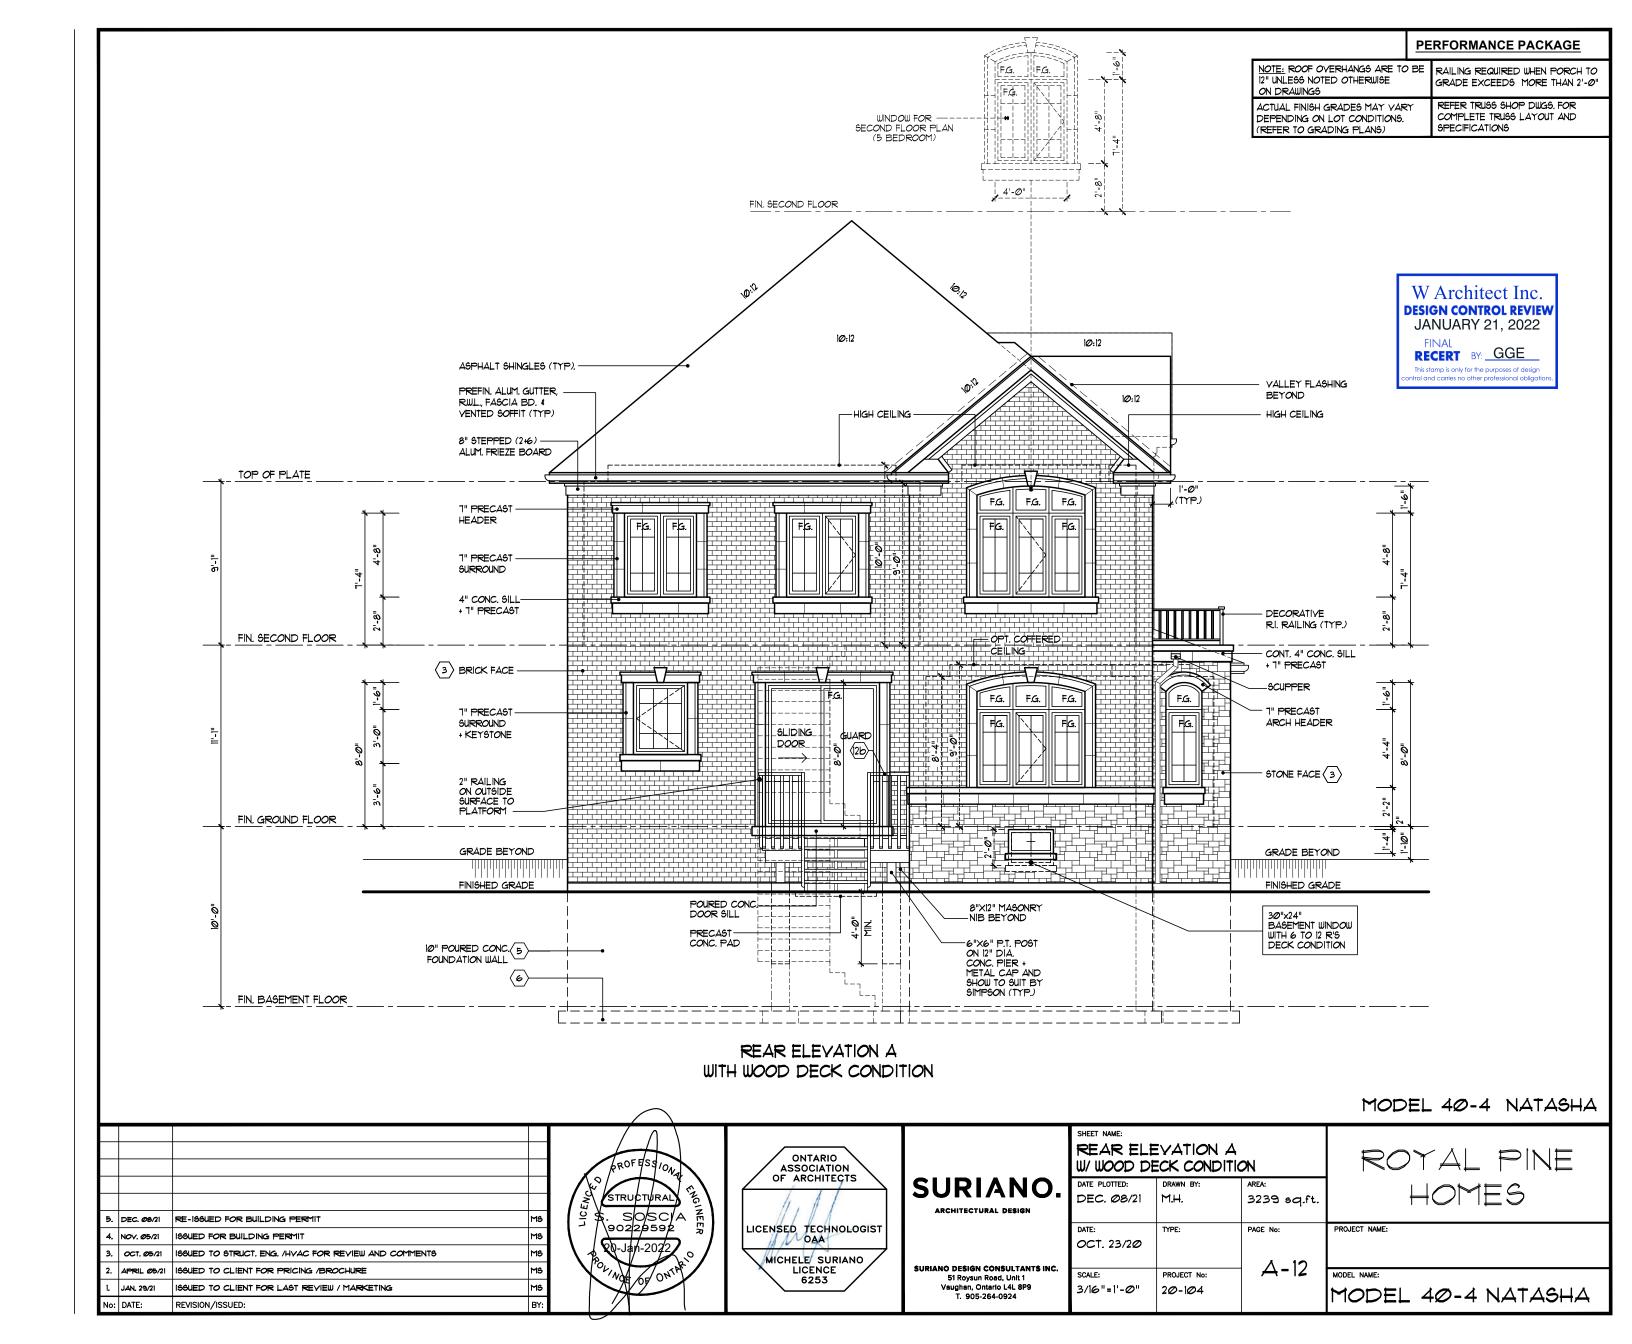


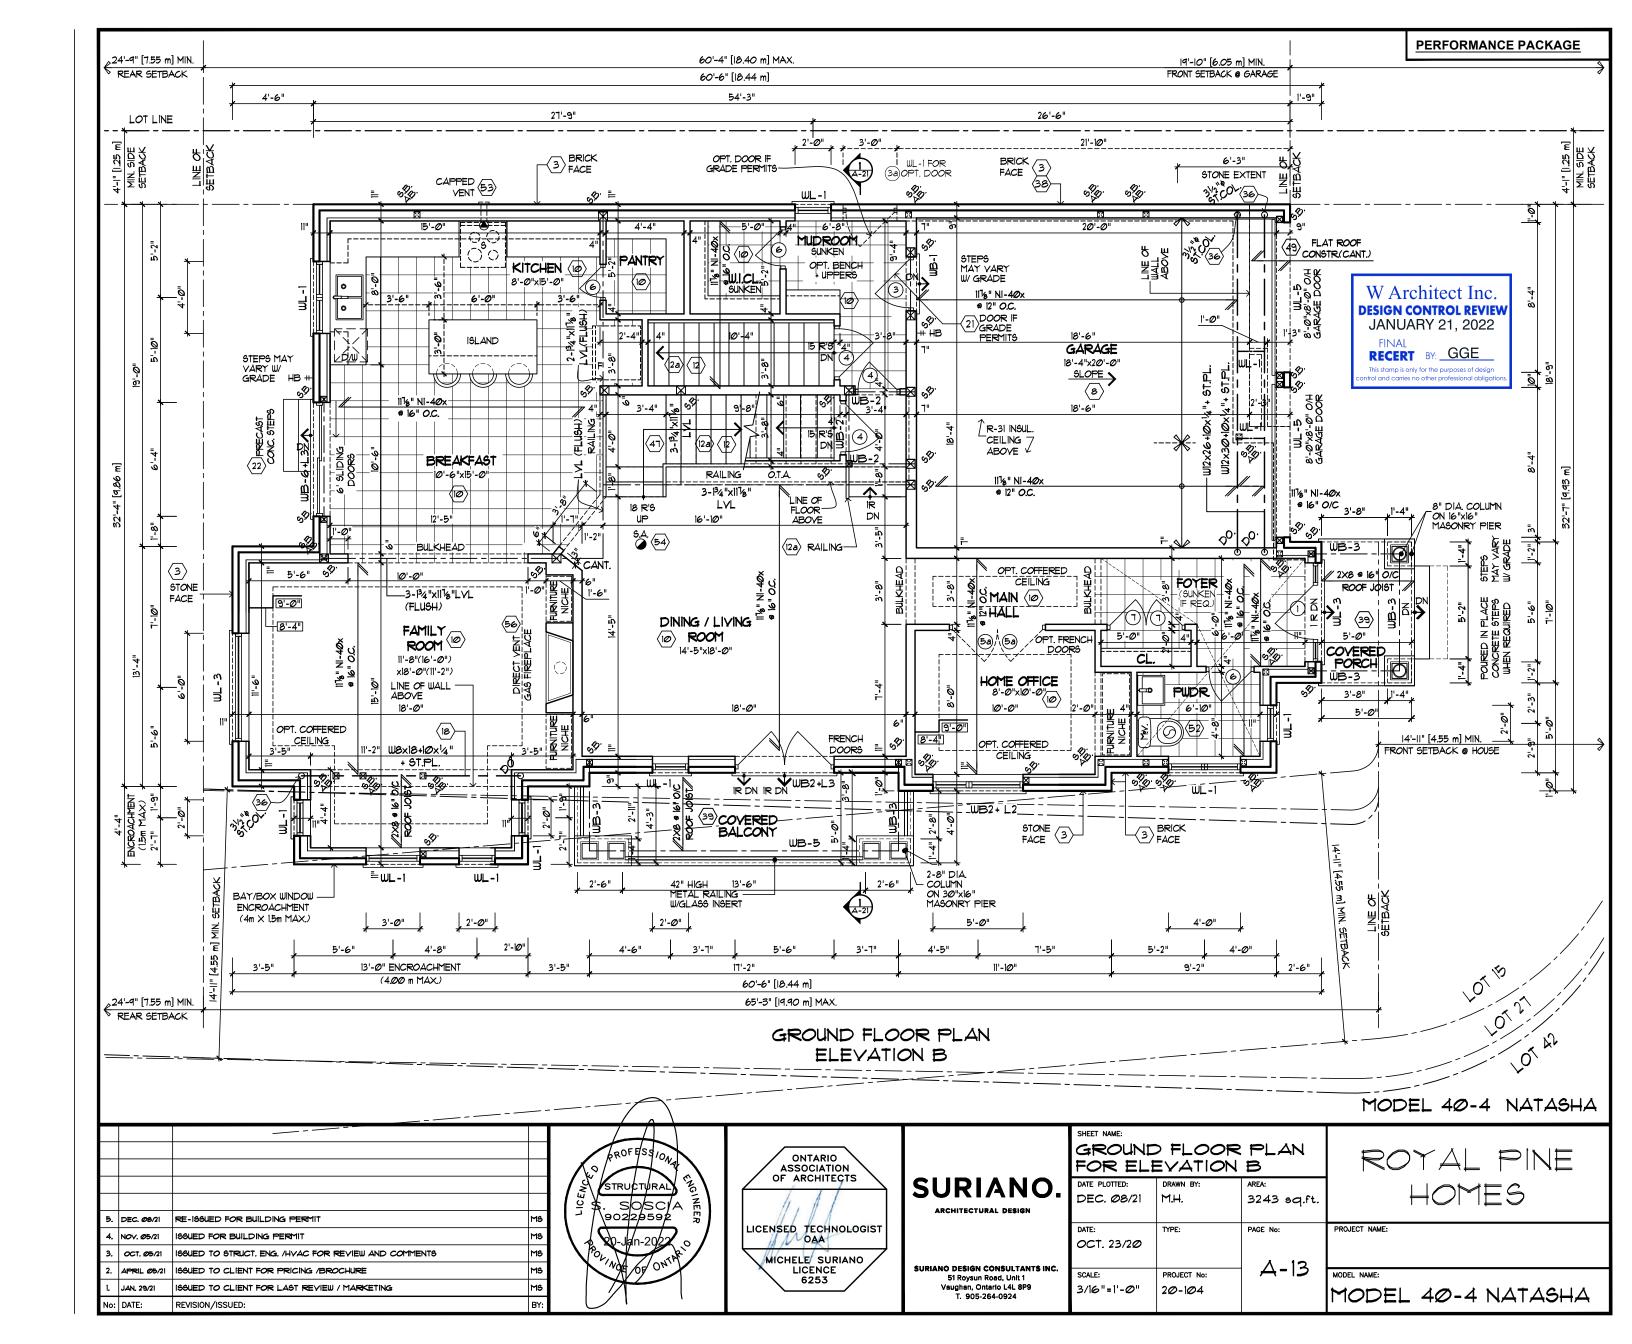


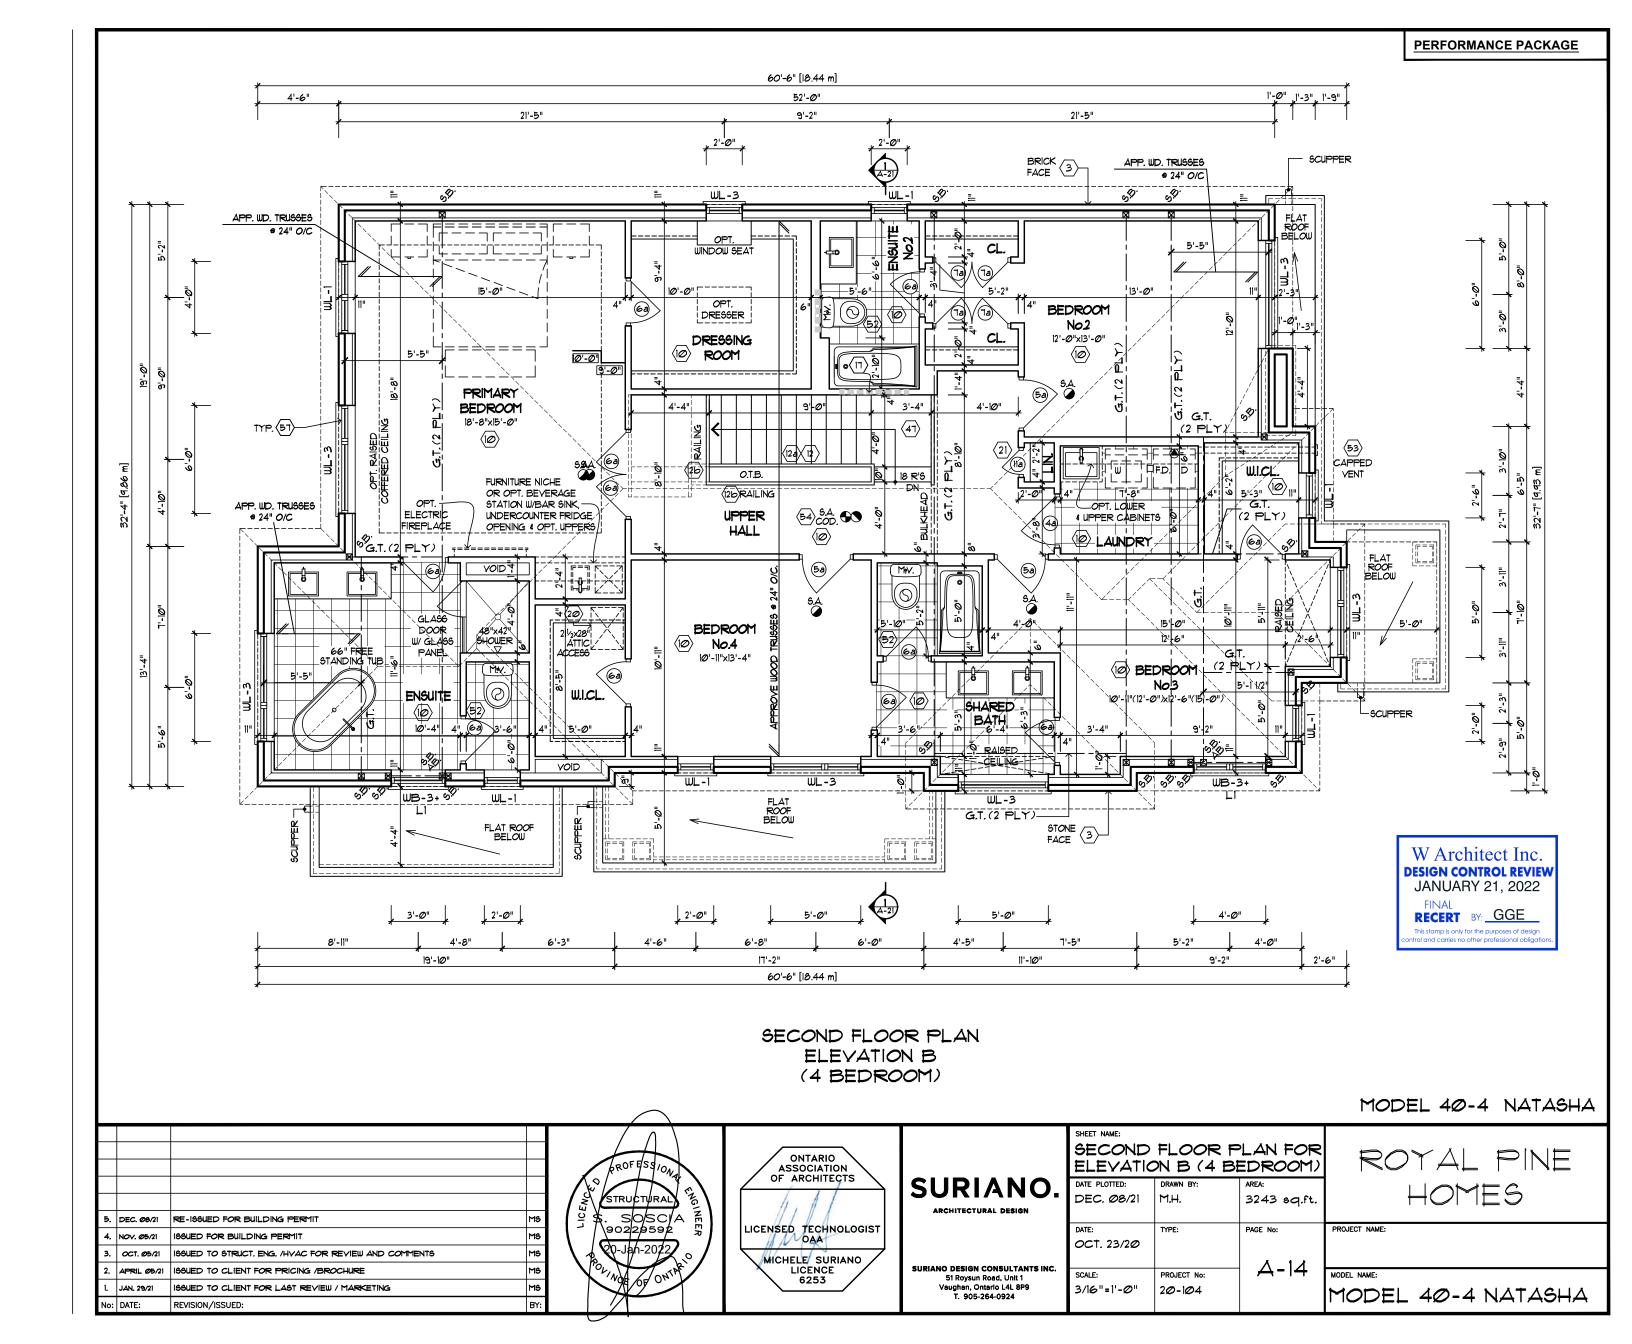


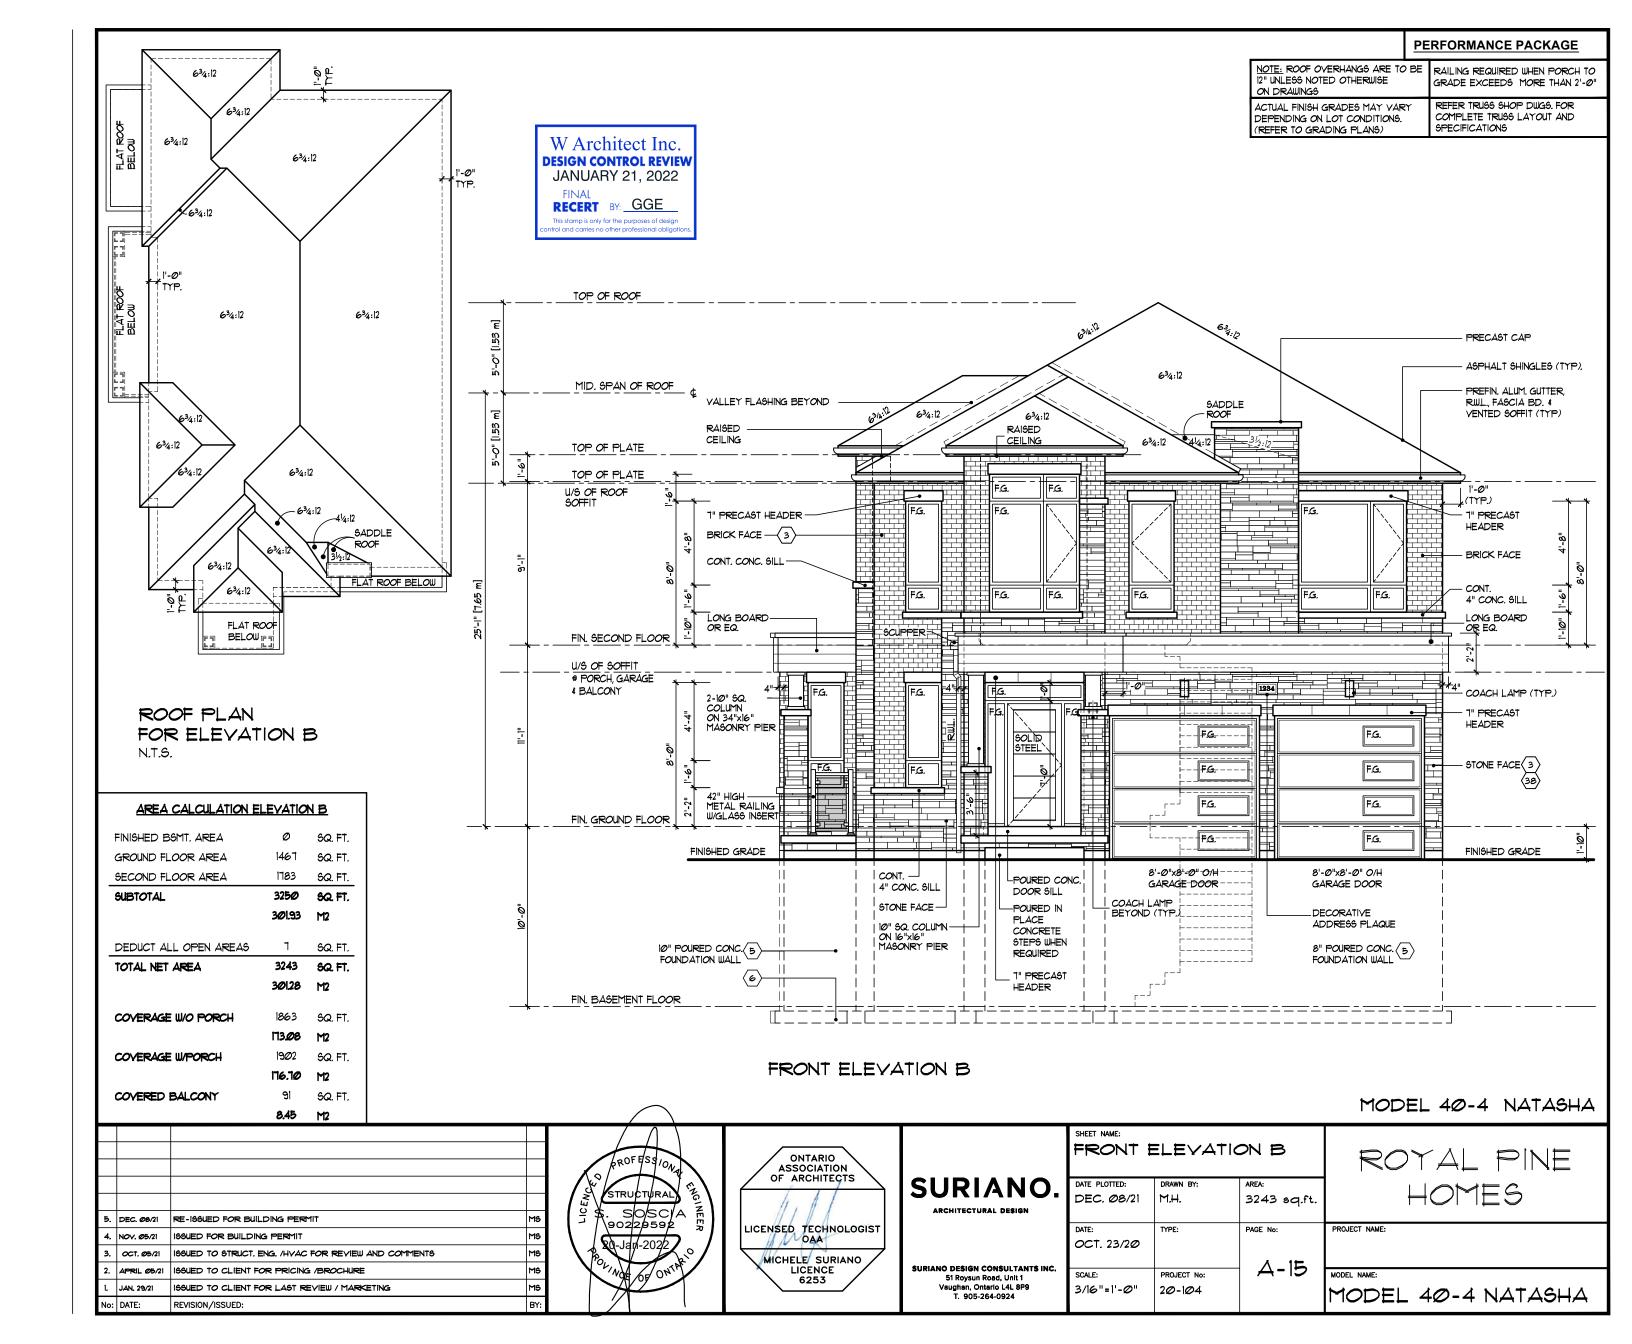


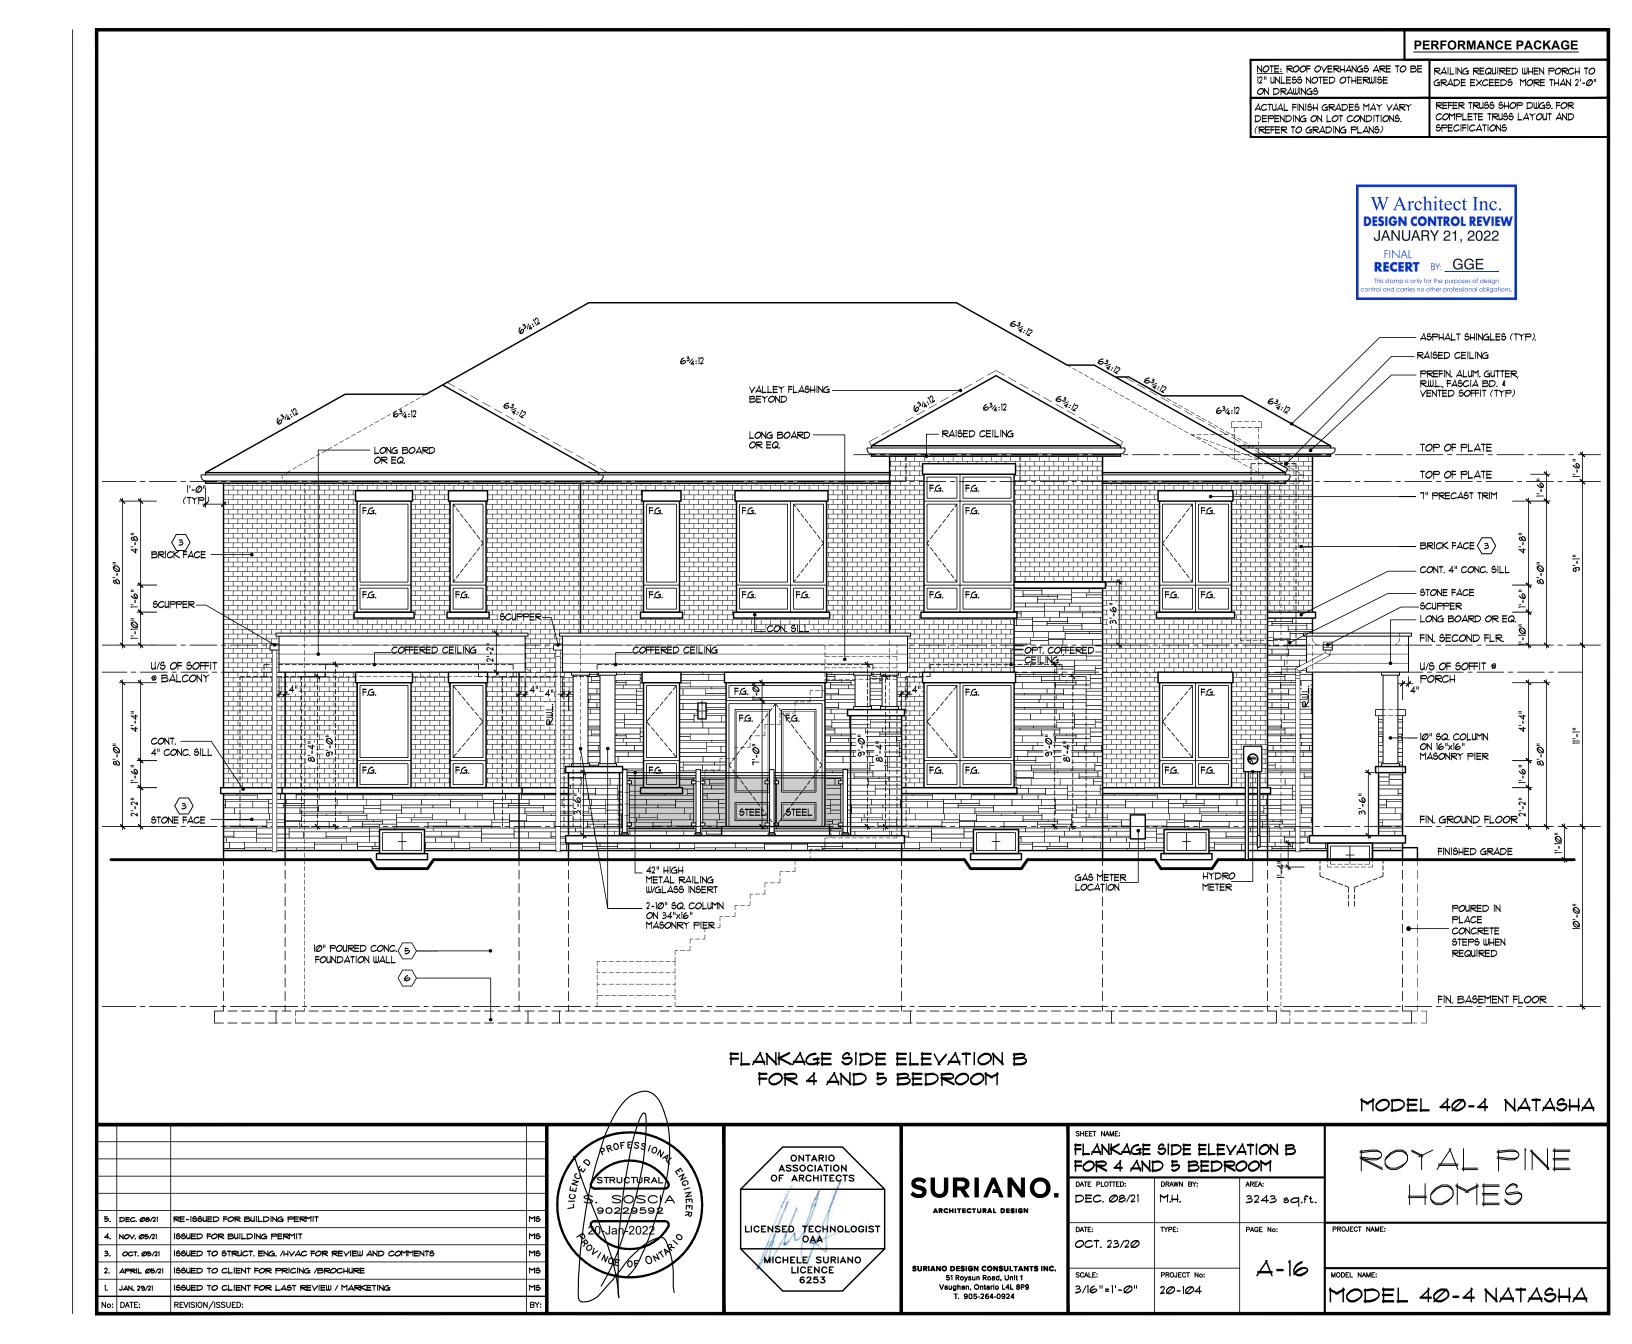


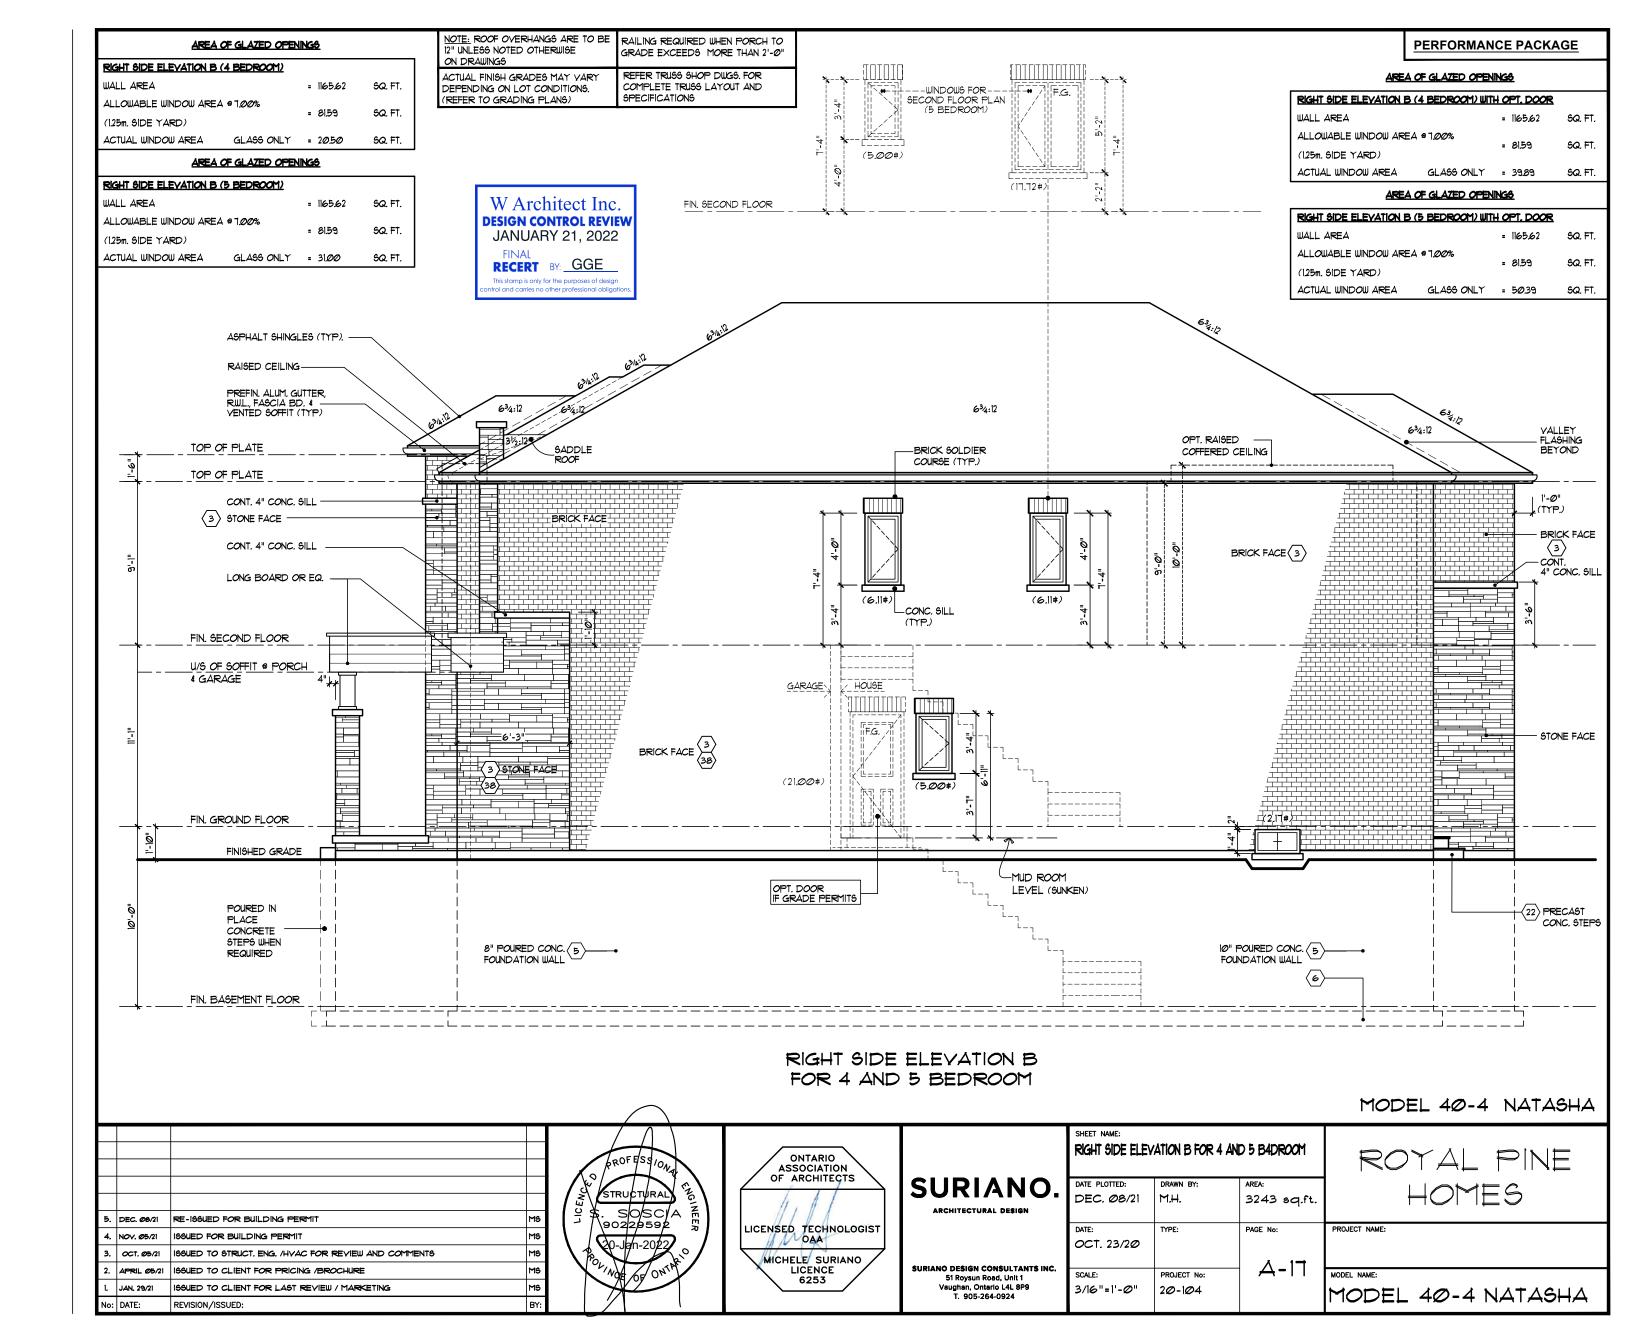

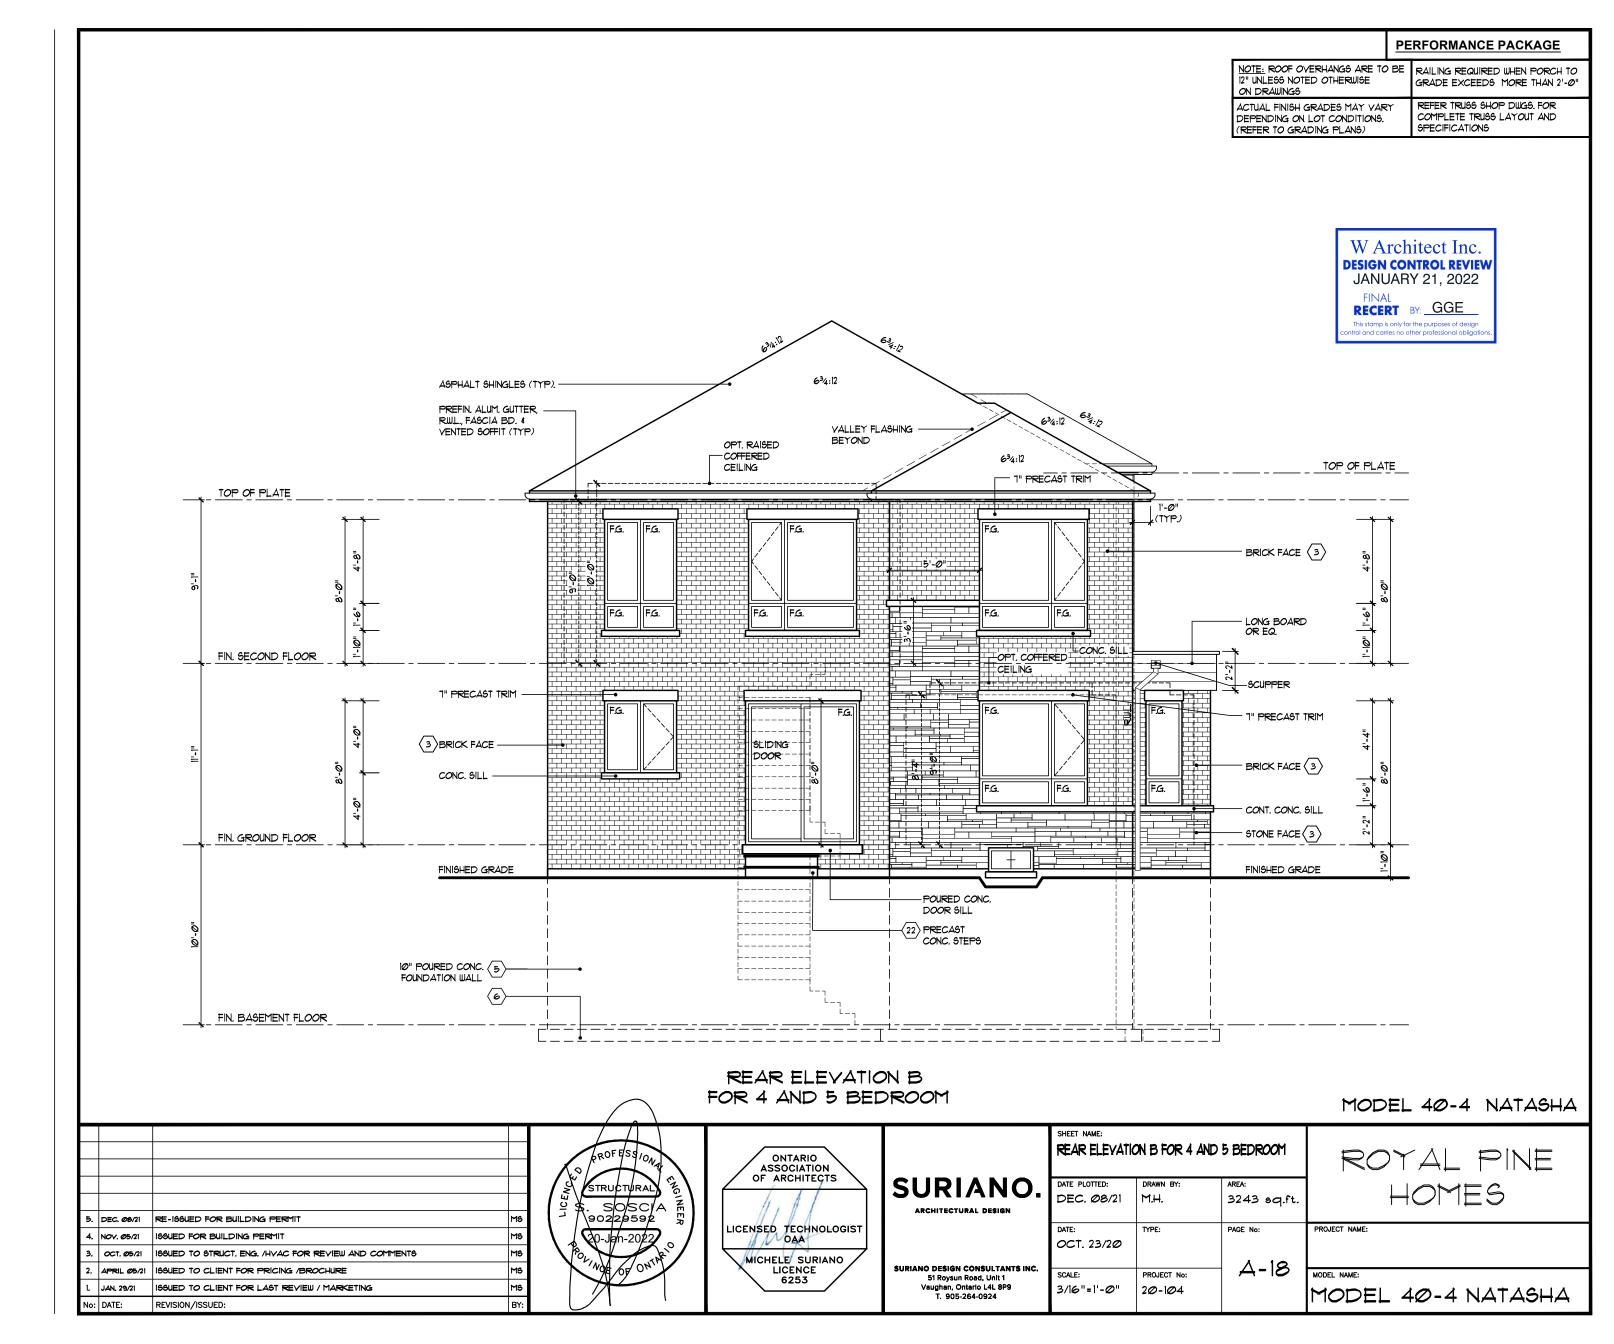

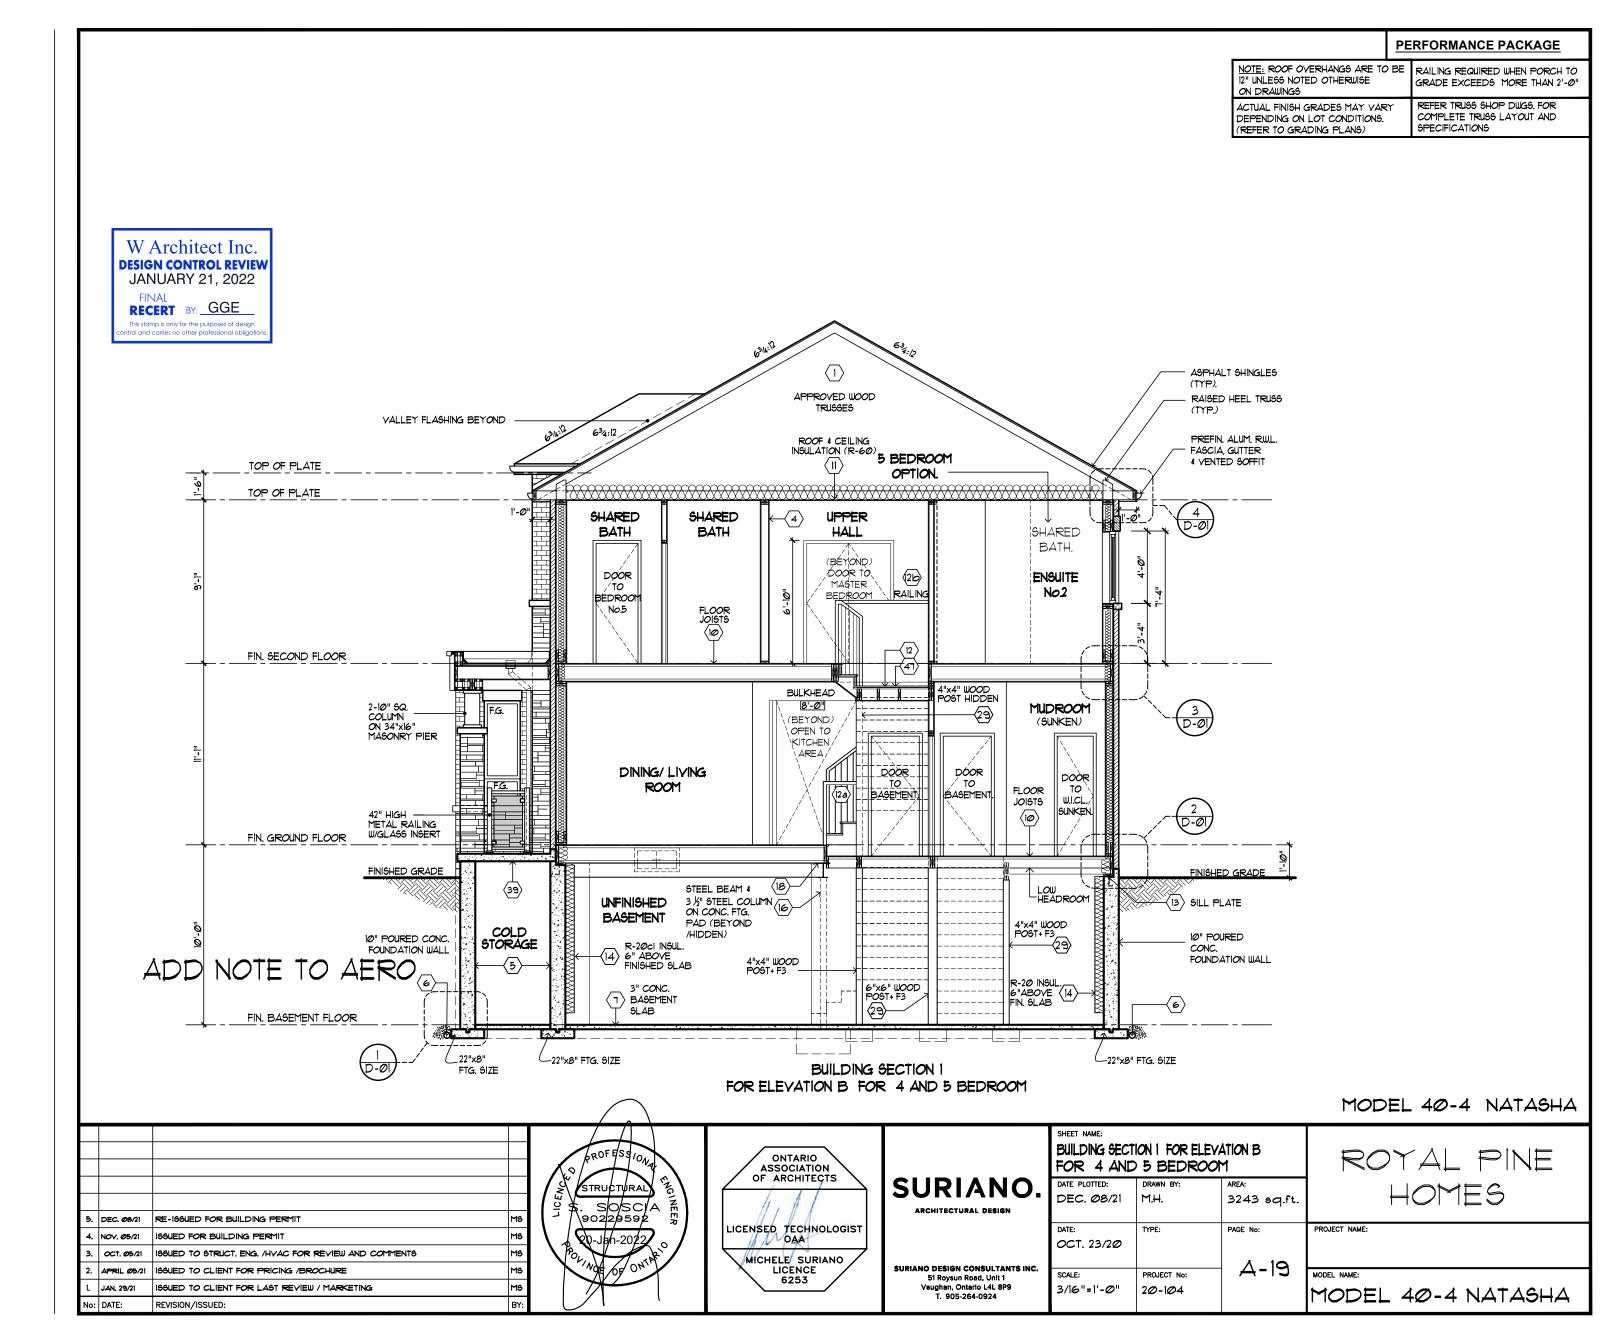

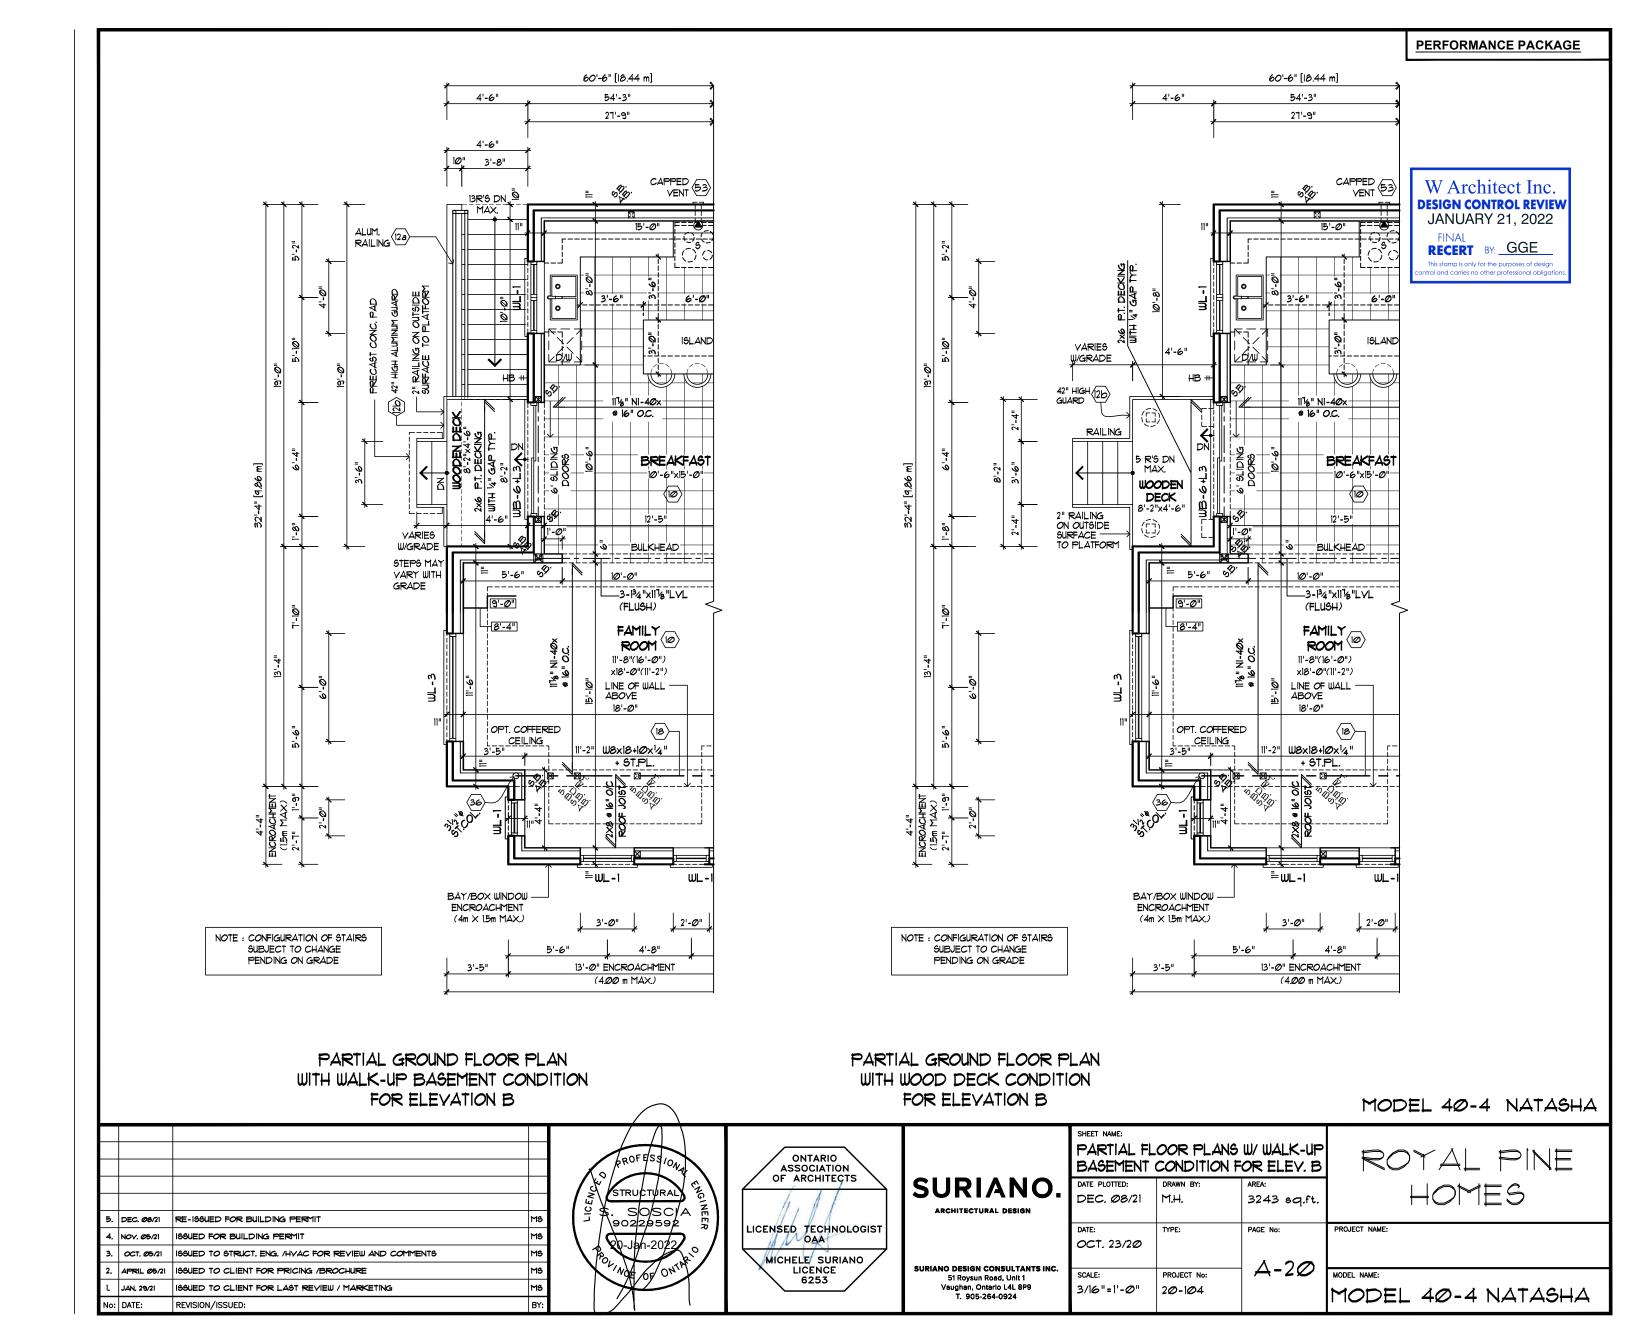

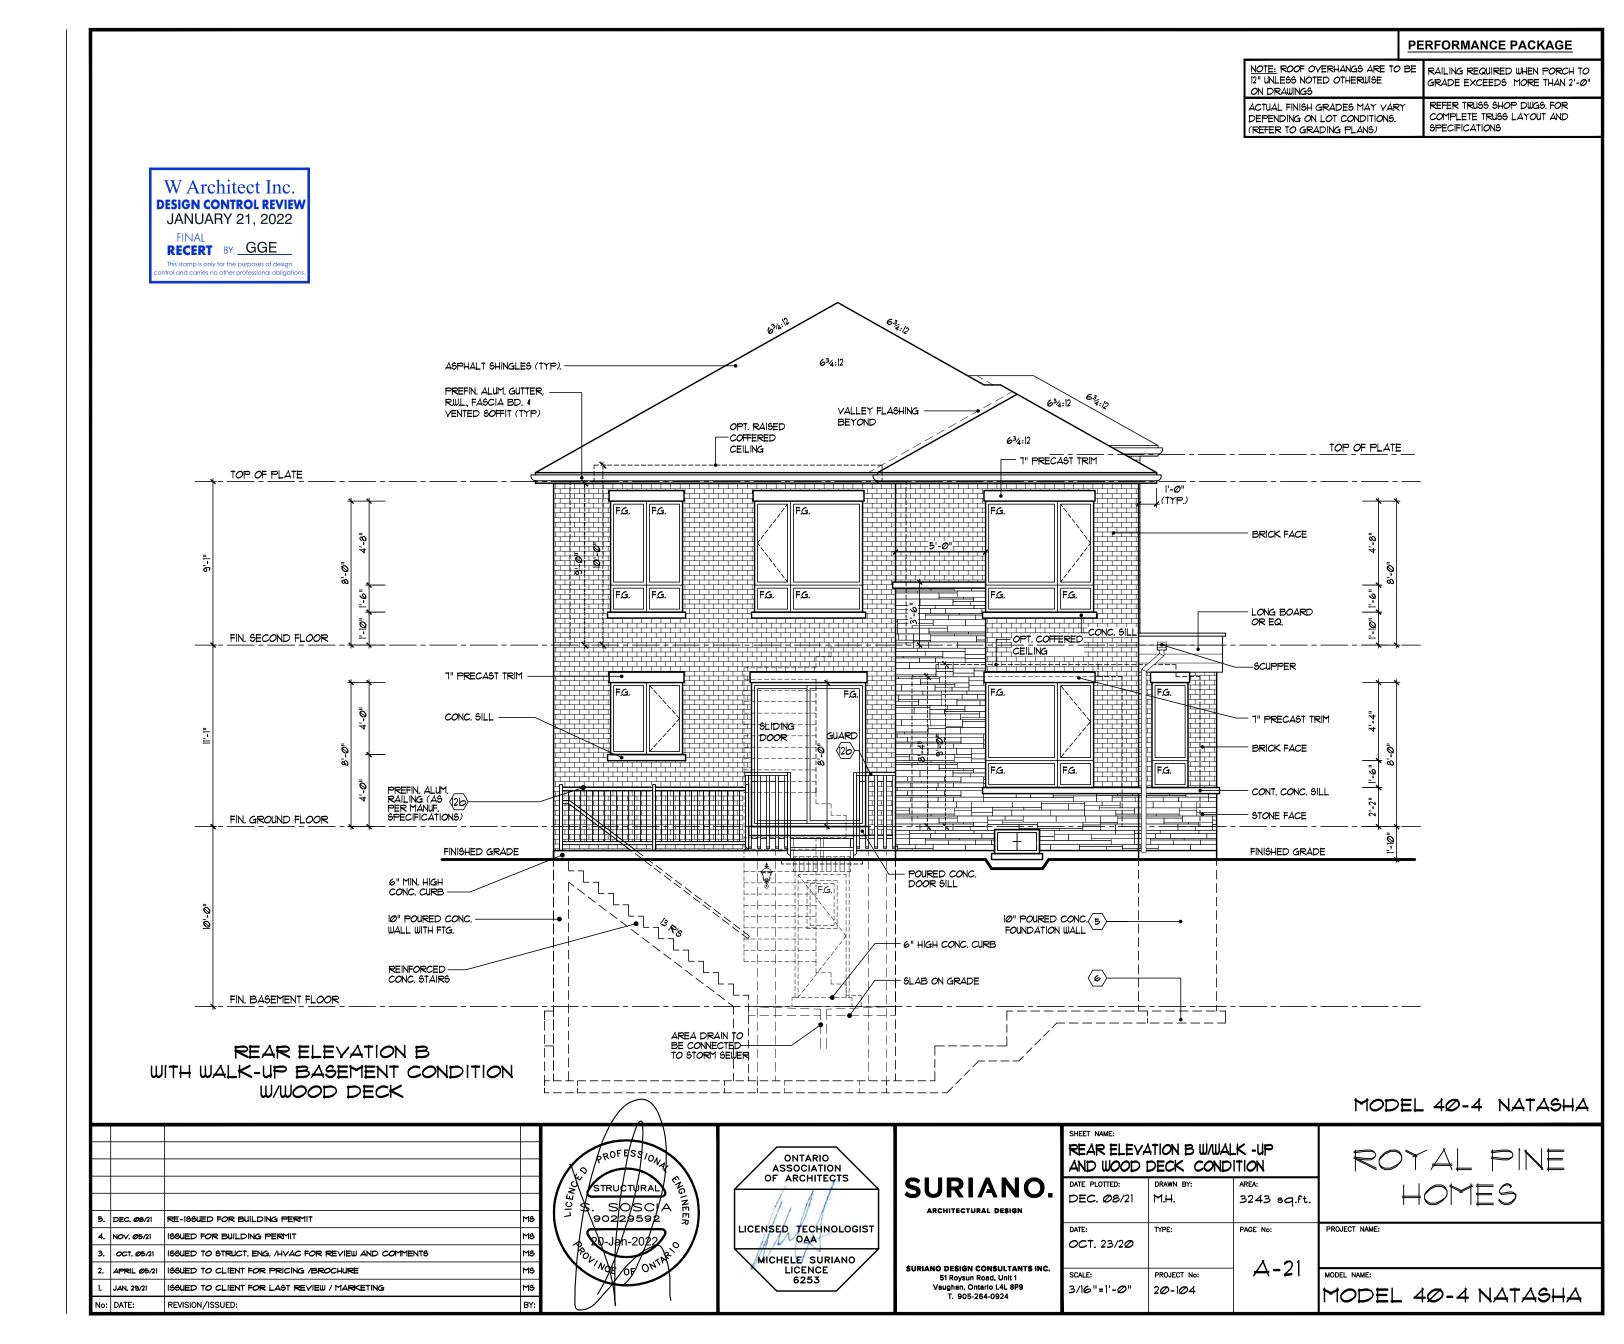

NOTE: ROOF OVERHANGS ARE TO BE 12" UNLESS NOTED OTHERWISE RAILING REQUIRED WHEN PORCH TO GRADE EXCEEDS MORE THAN 2'-0" ON DRAWINGS REFER TRUSS SHOP DIUGS. FOR COMPLETE TRUSS LAYOUT AND SPECIFICATIONS ACTUAL FINISH GRADES MAY VARY DEPENDING ON LOT CONDITIONS. (REFER TO GRADING PLANS) W Architect Inc. **DESIGN CONTROL REVIEW** JANUARY 21, 2022 RECERT BY: GGE 6³4:12 ASPHALT SHINGLES (TYP). PREFIN. ALUM. GUTTER, RWL., FASCIA BD. & VENTED SOFFIT (TYP) VALLEY FLASHING BEYOND OPT. RAISED -COFFERED CEILING 6³4:12 TOP OF PLATE T" PRECAST TRIM TOP OF PLATE 1'-Ø" (TYP.) BRICK FACE F.G. F.G. F.G. LONG BOARD OR EQ. OPT. COPERED ≖CONC. SIL FIN. SECOND FLOOR 1" PRECAST TRIM 1" PRECAST TRIM BRICK FACE SLIDING DOOR BRICK FACE 2" RAILING ON OUTSIDE SURFACE TO PLATFORM -CONT. CONC. SILL STONE FACE FIN. GROUND FLOOR GRADE BEYOND GRADE BEYOND FINISHED GRADE 8"X12" MASONRY NIB BEYOND 30"x24" BASEMENT WINDOW PRECAST — CONC. PAD WITH 6 TO 12 R'S DECK CONDITION -6"X6" P.T. POST ON 12" DIA. CONC. PIER + METAL CAP AND SHOW TO SUIT BY 10" POURED CONC. 5 FOUNDATION WALL FIN. BASEMENT FLOOR REAR ELEVATION B WITH WOOD DECK CONDITION MODEL 40-4 NATASHA REAR ELEVATION B ROYAL PINE ONTARIO ASSOCIATION OF ARCHITECTS W/ WOOD DECK CONDITION **SURIANO** STRUCTURAL DATE PLOTTED: HOMES DEC. Ø8/21 3243 sq.ft. M.H. . SOSC/A 90229592 RE-166UED FOR BUILDING PERMIT 5. DEC. Ø8/21 LICENSED TECHNOLOGIST PAGE No: PROJECT NAME: DATE: TYPE: 20-Jan-202/2 OCT. 23/2Ø OCT. Ø5/21 166UED TO STRUCT. ENG. /HVAC FOR REVIEW AND COMMENTS MICHELE SURIANO LICENCE 6253 SURIANO DESIGN CONSULTANTS INC. 51 Roysun Road, Unit 1 Vaughan, Ontario L4L 8P9 T. 905-264-0924 A-22 MS APRIL Ø5/21 ISSUED TO CLIENT FOR PRICING /BROCHURE PROJECT No: SCALE: MS ISSUED TO CLIENT FOR LAST REVIEW / MARKETING

3/16"=1'-0"

20-104

MODEL 40-4 NATASHA

JAN, 29/21

REVISION/ISSUED:

PERFORMANCE PACKAGE

TYPICAL BASEMENT FLOOR PLAN NOTES:

TYPICAL NOTES:

ALL CONCRETE FOOTING SHALL REST ON UNDISTURBED SOIL WITH A MIN. ALLOWABLE BEARING CAPACITY OF 150 Kpa (3000 PSF) AND BE FOUNDED A MIN. OF 4'-0" BELOW FINISHED GRADE.

CONCRETE STRENGTH FOR FOOTINGS SHALL BE A MIN. OF ISMPA, OR 20MPA. AS PER OBC TABLE 9.15.42.A.

CONCRETE STRENGTH FOR GARAGE SLAB, CONCRETE PORCHES AND STEPS SHALL BE A MIN. 32 MPa. WITH 5 - 8% ENTRAINMENT. UNLESS NOTED OTHERWISE.

CONCRETE STRIP FOOTING SIZE FOR 10" P. CONC. WALLS SHALL BE MIN. OF 8"X2" UNREINFORCED FOR UP TO 16"-2" LOIST SPAN

THE ABOVE FOOTING SIZE WILL BE USED FOR FOUNDATION WALLS WHICH SUPPORT 2 STOREYS OF BRICK VENEER WALL CONSTRUCTION, 2 FLOORS AND ROOF OF LIGHT WOOD FRAME CONSTRUCTION, WITH SPAN OF SUPPORTED JOIST THAT DO NOT EXCEED 4.9m (16'-1") AT A SPECIFIED LIVE LOAD OF NOT GREATER THAN 2.4 Kpa (50' PSF).

REFER TO BASEMENT PLAN FOR FOOTING SIZES IN AREAS EXCEEDING THE ABOVE CONDITIONS.

3/4" SUB FLOOR TO BE GLUED & NAILED (TYP.)

REFER JOIST MANUFACTURER'S SPECIFICATIONS FOR ALL TECHNICAL DETAILS & LAYOUT.

ALL JOISTS UNDER CERAMIC TILES TO BE INSTALLED AS PER JOIST MANUF. SHOP DRAWINGS.

ALL LVLS SHALL BE 1.8E/2.ØE GRADE MICROLLAM LVL OR BETTER U. S. O.

BRICK YENEER LINTELS

WL1	= 3 1/2" x 3 1/2" x 1/4"	(90x90x6)	+	2- 2" x 8"	SPF
WL2	= 4" x 3 1/2" x 5/16"	(100x90x8)	+	2- 2" x 8"	SPF
WL3	= 5" x 3 1/2" x 5/16"	(125×9Øx8)	+	2- 2" x 1Ø"	SPF
WL4	= 6" x 3 1/2" x 3/8"	(150x90x10)	+	2- 2" x 12"	SPF
WL5	= 6" × 4" × 3/8"	(150x100x10)	+	2- 2" x 12"	SPF
WL6	= 5" x 3 1/2" x 5/16"	(125x9Øx8)	+	2- 2" x 12"	SPF
WL٦	= 5" × 3 1/2" × 5/16"	(125×9Øx8)	+	3- 2" x 10"	SPF
WL8	= 5" x 3 1/2" x 5/16"	(125x9Øx8)	+	3- 2" x 12"	SPF
WL9	= 6" x 4" x 5/16"	(150x100x10)	+	3- 2" x 12"	SPF

CI= 3½"+x¼" STEEL COL. ON CONC. FTG. + 6"x6"x½" BASE & CAP PLATE. WELD TO BM. ANCHOR TO FTG. W/ 2- 4½"x6" AB

FI= 36"x36"x16"	F2= 24"x24"x12"		
F3= 18"x18"x8"			

ALL RETURN AIR PARTITIONS TO BE 6" - REFER TO HVAC DRAININGS

SOLID BEARING:

5B MINIMUM 3-2"x4" OR 3-2"x6" BUILT UP COLUMNS

BUILT UP COLUMNS:

- NAILED W/ I ROW FOR 2"x4" COLUMN
- NAILED W/ 2 ROW FOR 2"x6" COLUMN - NAIL LENGTH TO MATCH TOTAL BUILT UP WIDTH
- NAILS SPACED @ 8" O/C
- PROVIDE SQUASH BLOCKS TO TRANSFER POINT LOADS BETWEEN FLOORS

STEEL LINTELS

L1	=	3 1/2" x 3 1/2" x 1/4"	(89x89x6.4)
L2	=	4" x 3 1/2" x 5/16"	(1Ø2x89x7.9)
L3	=	5" x 3 1/2" x 5/16"	(127x89xT.9)
L4	=	6" x 3 1/2" x 3/8"	(152x89x9.5)
L5	=	6" x 4" x 3/8"	(152x1Ø2x9.5)
L6	=	7" x 4" x 3/8"	(178x1Ø2x9.5)
L٦	=	7" ×4" × 1/2"	(178x1Ø2x13)

WOOD LINTELS AND BEAMS

FOR APPROVED ENGINEERED FLOOR JOIST SYSTEM,

INCLUDING BEAMS AND SUPPORT, REFER TO THE APPROVED ENGINEERED FLOOR LAY OUT ENCLOSED

LVLIA	= 1-1 3/4" x 7 1/4"	(1-45xl84)
LVLI	= 2-1 3/4" x 7 1/4"	(2-45x184)
LVL2	= 3-1 3/4" x 7 1/4"	(3-45xl84)
LVL3	= 4-1 3/4" x 7 1/4"	(4-45x184)
LVL4A	= 1-1 3/4" x 9 1/2"	(1-45x235)
LVL4	= 2-1 3/4" x 9 1/2"	(2-45x235)
LVL5	= 3-1 3/4" x 9 1/2"	(3-45x235)
LVL5A	= 4-1 3/4" x 9 1/2"	(4-45x235)
LVL6A	= 1-1 3/4" x 11 7/8"	(1-45x3 <i>0</i> Ø)
LVL6	= 2-1 3/4" x 11 7/8"	(2-45x3@@)
LVLT	= 3-1 3/4" x 11 7/8"	(3-45x3@@)
LVLTA	= 4-1 3/4" x 11 7/8"	(4-45x300)

LAMINATED YENEER LUMBER

TYPICAL ELEVATION NOTES:

REFER TO TRUSS SHOP DIUGS. FOR COMPLETE TRUSS LAYOUT AND SPECIFICATIONS

NOTE: ELEVATIONS DO NOT REPRESENT ACTUAL FINISHED GRADES (REFER TO GRADING PLANS)

RAILING REQUIRED WHEN PORCH TO GRADE EXCEEDS MORE THAN 2'-0"

REFER JOIST MANUFACTURER'S SPECIFICATIONS FOR ALL TECHNICAL DETAILS & INFO.

TYPICAL GROUND FLOOR PLAN NOTES:

ALL RETURN AIR PARTITIONS TO BE 6" - REFER TO HYAC DRAWINGS

8'-4"

DENOTES CEILING HEIGHT


TYPICAL GROUND FLOOR NOTES

- REFER JOIST MANUFACTURER'S SPECIFICATIONS FOR ALL TECHNICAL DETAILS & LAYOUT
- 5/8" SUB-FLOOR TO BE GLUED & NAILED (TYP.)
- ALL JOISTS UNDER CERAMIC TILES TO BE INSTALLED AS PER JOIST MANUF. SHOP DIUG'S.
- ALL LVLS SHALL BE I.SE GRADE MICROLLAM LVL OR BETTER U. S. O.

FOR APPROVED ENGINEERED FLOOR JOIST SYSTEM, INCLUDING BEAMS AND SUPPORT, REFER TO THE APPROVED ENGINEERED FLOOR LAY OUT ENCLOSED

ALL GARAGE DOORS INTO THE HOUSE SHALL BE GAS PROOFED AND HAVE SELF-CLOSING DEVICES, EACH DOOR SHALL HAVE STAIRS CONFORMING TO O.B.C. SECTION 9.8



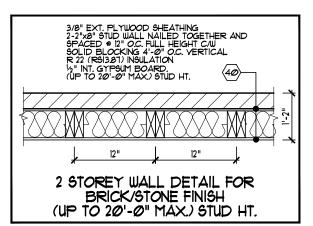

TYPICAL SECOND FLOOR PLAN NOTES:

REFER TRUSS SHOP DIGS. FOR COMPLETE TRUSS LAYOUT AND SPECIFICATIONS

ALL RETURN AIR PARTITIONS TO BE 6". REFER TO HVAC DRAWINGS

9'-0"

DENOTES CEILING HEIGHT

DENOTES STUD WALL REINFORCED FOR FUTURE GRAB BARS. REFER TO DETAIL 3/D-10

W Architect Inc.

DESIGN CONTROL REVIEW
JANUARY 21, 2022

FINAL
RECERT BY: GGE

This stamp is only for the purposes of design

MODEL 40-4 NATASHA

5. DEC. @9/21 RE-166UED FOR BUILDING PERMIT

4. NOV. @5/21 196UED FOR BUILDING PERMIT

3. OCT. @5/21 196UED TO STRUCT. ENG. /HVAC FOR REVIEW AND COMMENTS

M9

2. APRIL @5/21 196UED TO CLIENT FOR PRICING /BROCHURE

1. JAN. 29/21 196UED TO CLIENT FOR LAST REVIEW / MARKETING

M6

No: DATE: REVISION/ISSUED: BY:





SURIANO.

SURIANO DESIGN CONSULTANTS INC. 51 Roysun Road, Unit 1 Vaughan, Ontario L4L 8P9 T. 905-264-0924

	SHEET NAME: TYPICAL	NOTES		
ı	DATE PLOTTED:	DRAWN BY:	AREA:	
	DEC. Ø8/21	M.H.		
ı	DATE:	TYPE:	PAGE No:	PRO
	OCT. 23/2Ø			
ı	SCALE:	PROJECT No:	A-23	MODE
ı	3/16"=1'-0"	20-104		۰
ı	3/10 -1 0	20-10-		

ROYAL PINE HOMES

ODEL NAME: 10DEL 40-4 NATASHA