

Planning and Development Services

Building Division 8850 McLaughlin Road, Unit 1 Brampton, ON L6Y 5T1

WATER PIPE SIZING AND PLUMBING DATA SHEET CERTIFIED MODEL WITH ONE DWELLING UNIT

THIS TABLE IS APPLICABLE FOR A HOUSE AFTER DECEMBER 31, 2017

Builder Name: ROYAL PINE HOMES **Certified Model Name:** 1802 (#78926)

Optional Floor Layout:

Application No.:



The Ontario Building Code Div. B, 7.6.3 regulates size and capacity of pipes for a new house. Please enter the number of individual fixtures as listed and bathroom groups⁽⁶⁾ or powder room groups⁽⁷⁾ per floor. The fixture units and required minimum size of water service will automatically be calculated.

| Description | Basement Floor Qty. | First Floor Qty. | Second Floor Qty. | Third Floor Qty. |
|----------------------------|---------------------|---------------------|----------------------|---------------------|
| | | | | |
| Bidet | | | | |
| Extra Shower | | | | |
| Lav | | | | |
| Bar Sink | | | | |
| Powder room ⁽⁷⁾ | | 1 | 1 | |
| Kitchen Sink | | | 1 | |
| Dishwasher | | | 1 | |
| Laundry Tub | | 1 | | |
| Washing Machine | | 1 | | |
| Hose Bib | | 2 | | |

Total Fixture Units 27.2

Minimum Diametre of Water Service Pipe

Required from the Property Line to the


House (Inch)

Notes:

(1) A potable water system shall be designed, constructed and installed to conform to good engineering practice appropriate to the circumstances, such as that described in the ASHRAE Handbooks and ASPE

1

- (2) No water system between the point of connection with the water service pipe or the water meter and the first branch that supplies a water heater that serves more than one fixture shall be less than ¾ in. in size.
- (3) The minimum water pressure at the entry to the building is 200 kPa, and the total maximum length of the water system is 90 m.
- (4) In a hot water distribution system of a developed length of more than 30 m from the HWT to the farthest fixture or supplying more than 4 storeys, the water temperature shall be maintained by, (a) recirculation, or (b) a self-regulating heat tracing system.
- (5) Where piping may be exposed to freezing conditions, it shall be protected from the effects of freezing.
- (6) A bathroom group consists of 1 water closet, 1 lavatory, and 1 bathtub (with or without showerhead)
- (7) A powder room group consists of 1 water closet and 1 lavatory.

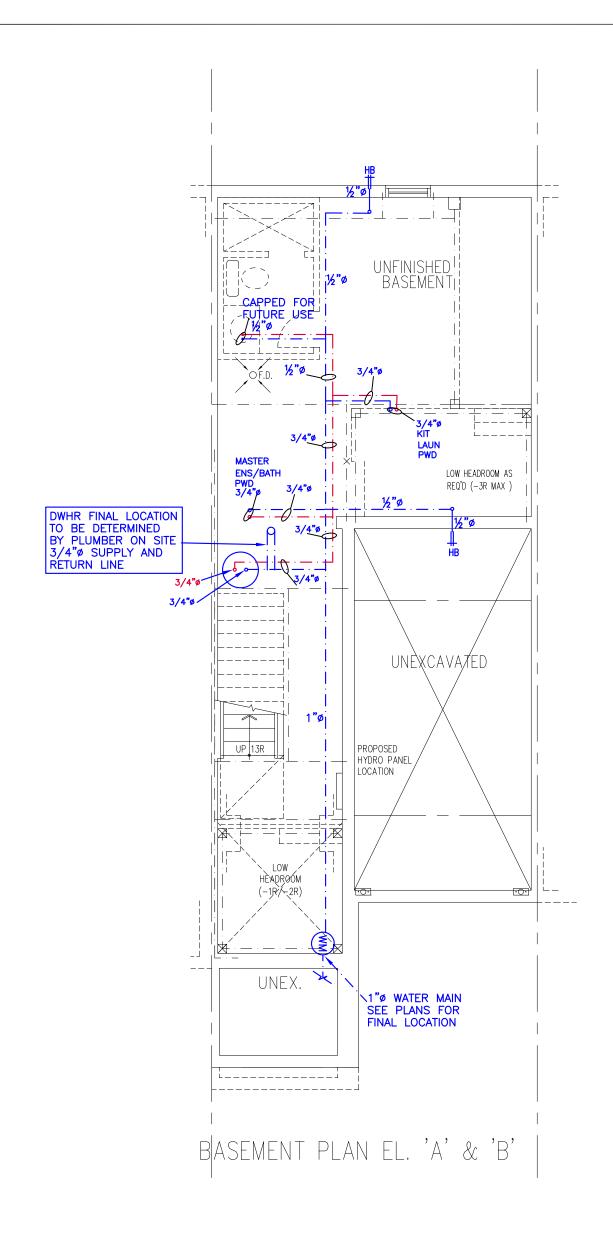

NOTES

- DRAWINGS ARE TO BE PRINTED IN COLOUR
 WHERE A 3/4"ø TUB SPOUT/ SPIGOT CONNECTION IS USED ON THE BATHTUB FAUCET THE WATER SUPPLY PIPE SHALL BE 3/4"ø TO THE BRANCH FOR THE BATHTUB
 BASEMENT BATHROOM ROUGH-IN SHALL BE USED IN SIZING
- OF WATER PIPE
 EXACT LOCATION OF ALL PLUMBING PIPING TO BE
 DETERMINED ON SITE

LEGEND

| SYMBOL | DESCRIPTION (SEE PLAN FOR PIPE SIZING) |
|----------------------|--|
| - · - WM- · - | WATER METER, PROVIDE SUPPLY PIPE SIZE/ Ø |
| нв⊭ | HOSE BIB |
| · • | PROPOSED COLD WATER LINE & RISER |
| — · —∘ | PROPOSED HOT WATER LINE & RISER |
| ⊕ FD | FLOOR DRAIN |



ROYAL PINE HOMES

Project Name

FORESTSIDE BRAMPTON, ONTARIO


<u>D</u>ESIGNS _{LTD.}

375 Finley Ave. Suite 202 - Ajax, Ontario L1S 2E2 Tel. 905.619.2300 - 905.420.5300 Fax 905.619.2375 Email: info@hvacdesigns.ca Web: www.hvacdesigns.ca Specializing in Residential Mechanical Design Services

| BASEMENT |
|----------|
| PLUMBING |
| LAYOUT |

MAY/2019 3/16" = 1'-0" Scale

78926 LO#

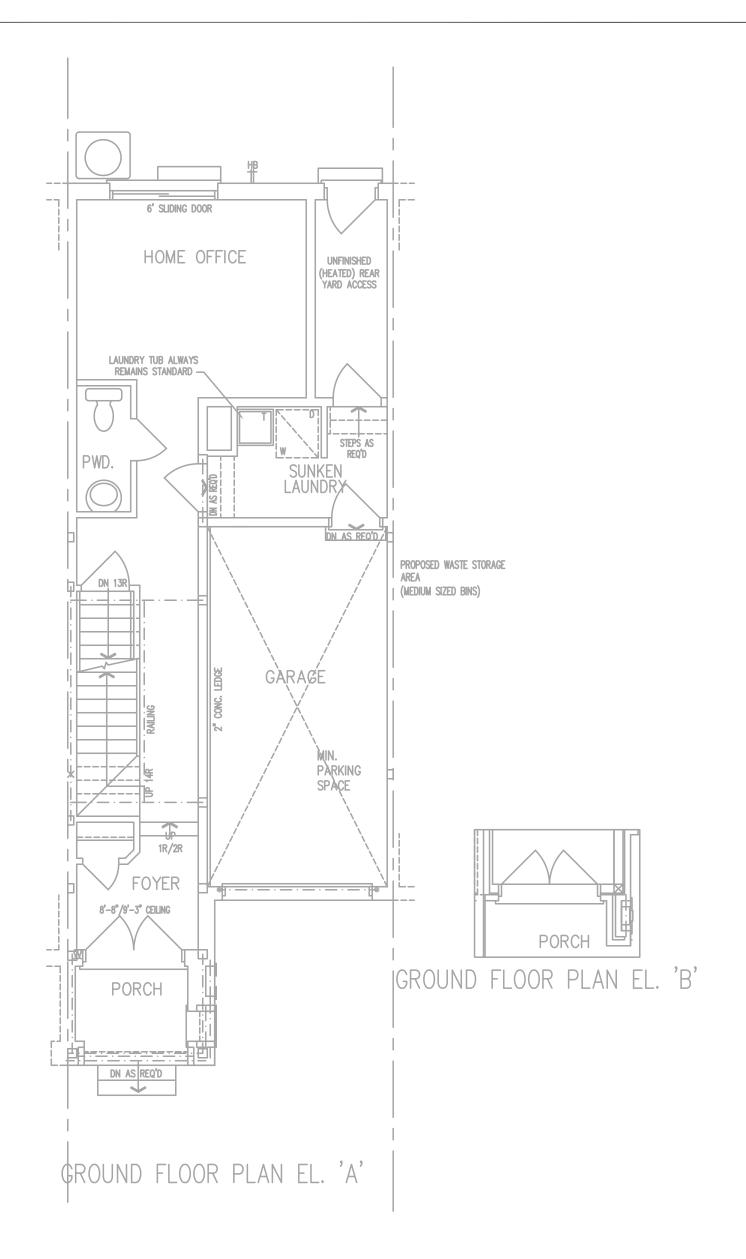



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ROYAL PINE HOMES

Project Name

1802

FORESTSIDE BRAMPTON, ONTARIO

1912 sqft

HVA DESIGNS LTD.


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Sheet Title

FIRST FLOOR PLUMBING LAYOUT

Date MAY/2019
Scale 3/16" = 1'-0"

LO# 78926



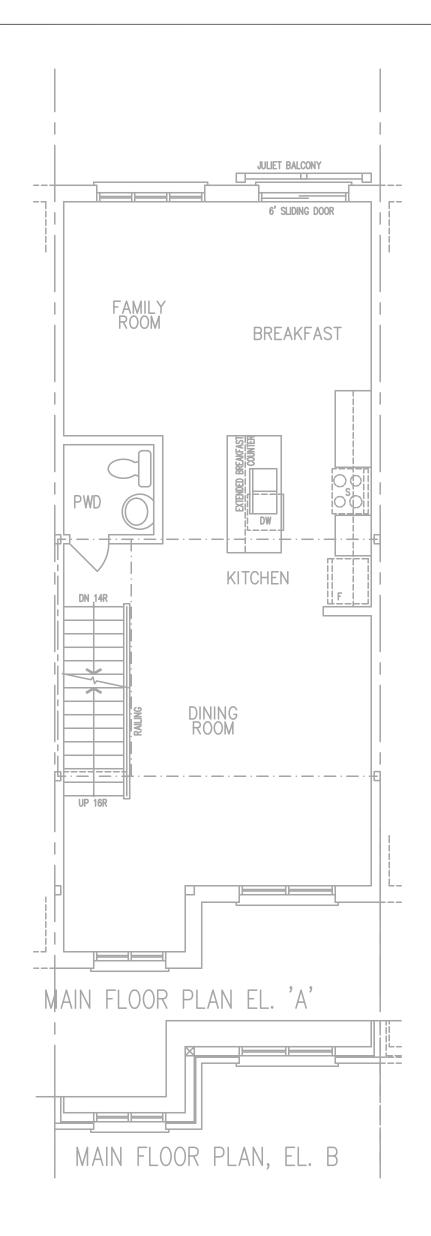

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MAY/2019 3/16" = 1'-0"

1912 sqft


LO#

78926

SECOND FLOOR

PLUMBING

LAYOUT

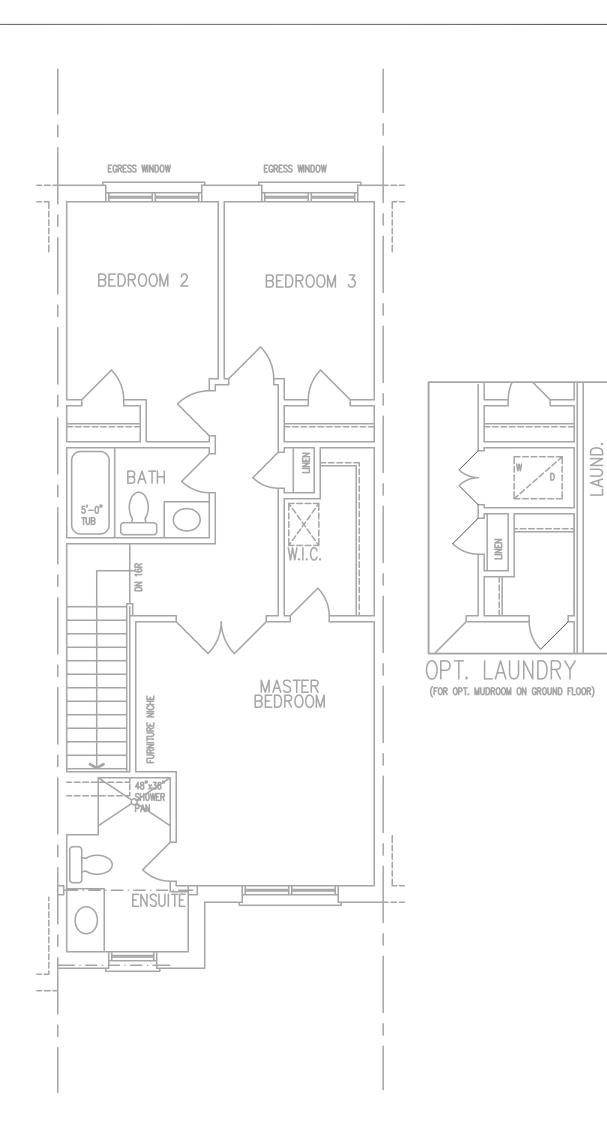

THIRD FLOOR PLAN EL. 'A' & 'B'



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THIRD FLOOR **PLUMBING LAYOUT**

MAY/2019 3/16" = 1'-0"

78926 LO#