


REVISIONS	
#	DATE

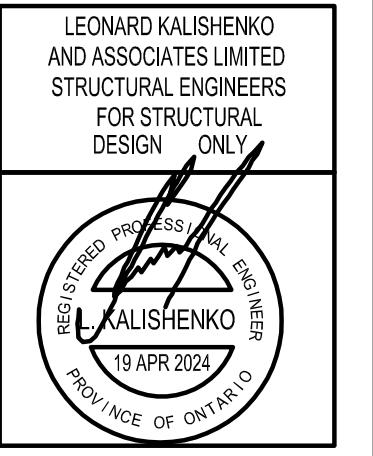

ASSUMED ROOF TRUSS BEARING
ON THE EXTERIOR WALLS ONLY
THE DESIGN OF ENTIRE STRUCTURE
SHOULD BE REVIEWED TO ACCOMMODATE
FINAL ROOF TRUSS LAYOUT

KING EAST ESTATES



ALL DRAWINGS & SPECIFICATIONS ARE THE PROPERTY
OF THE ARCHITECT AND CANNOT BE USED OR
REPRODUCED WITHOUT HIS APPROVAL.

THE CONTRACTORS SHALL CHECK AND VERIFY ALL
DIMENSIONS ON THE SITE AND REPORT ANY
DISCREPANCIES TO THE ARCHITECT.

DRAWINGS MUST NOT BE SCALED.


ARCHITECTURAL DESIGN INC.

56 PENNSYLVANIA AVE.
UNIT 1
CONCORD, ONT. L4K 3V9
TEL 905 660-9393
FAX 905 660-9419

MODEL 2890

PROJECT
PROPOSED
TWO STOREY DWELLING
FOR: KING EAST DEVELOPMENTS INC.
AT: RICHMOND HILL

DRAWING	
SECOND FLOOR PLAN 'A'	
DATE	MAY '24
DRAWN	E.B.
CHECKED	
SCALE	3/16"=1'-0"
DRAWING NO	20-23
	A-4

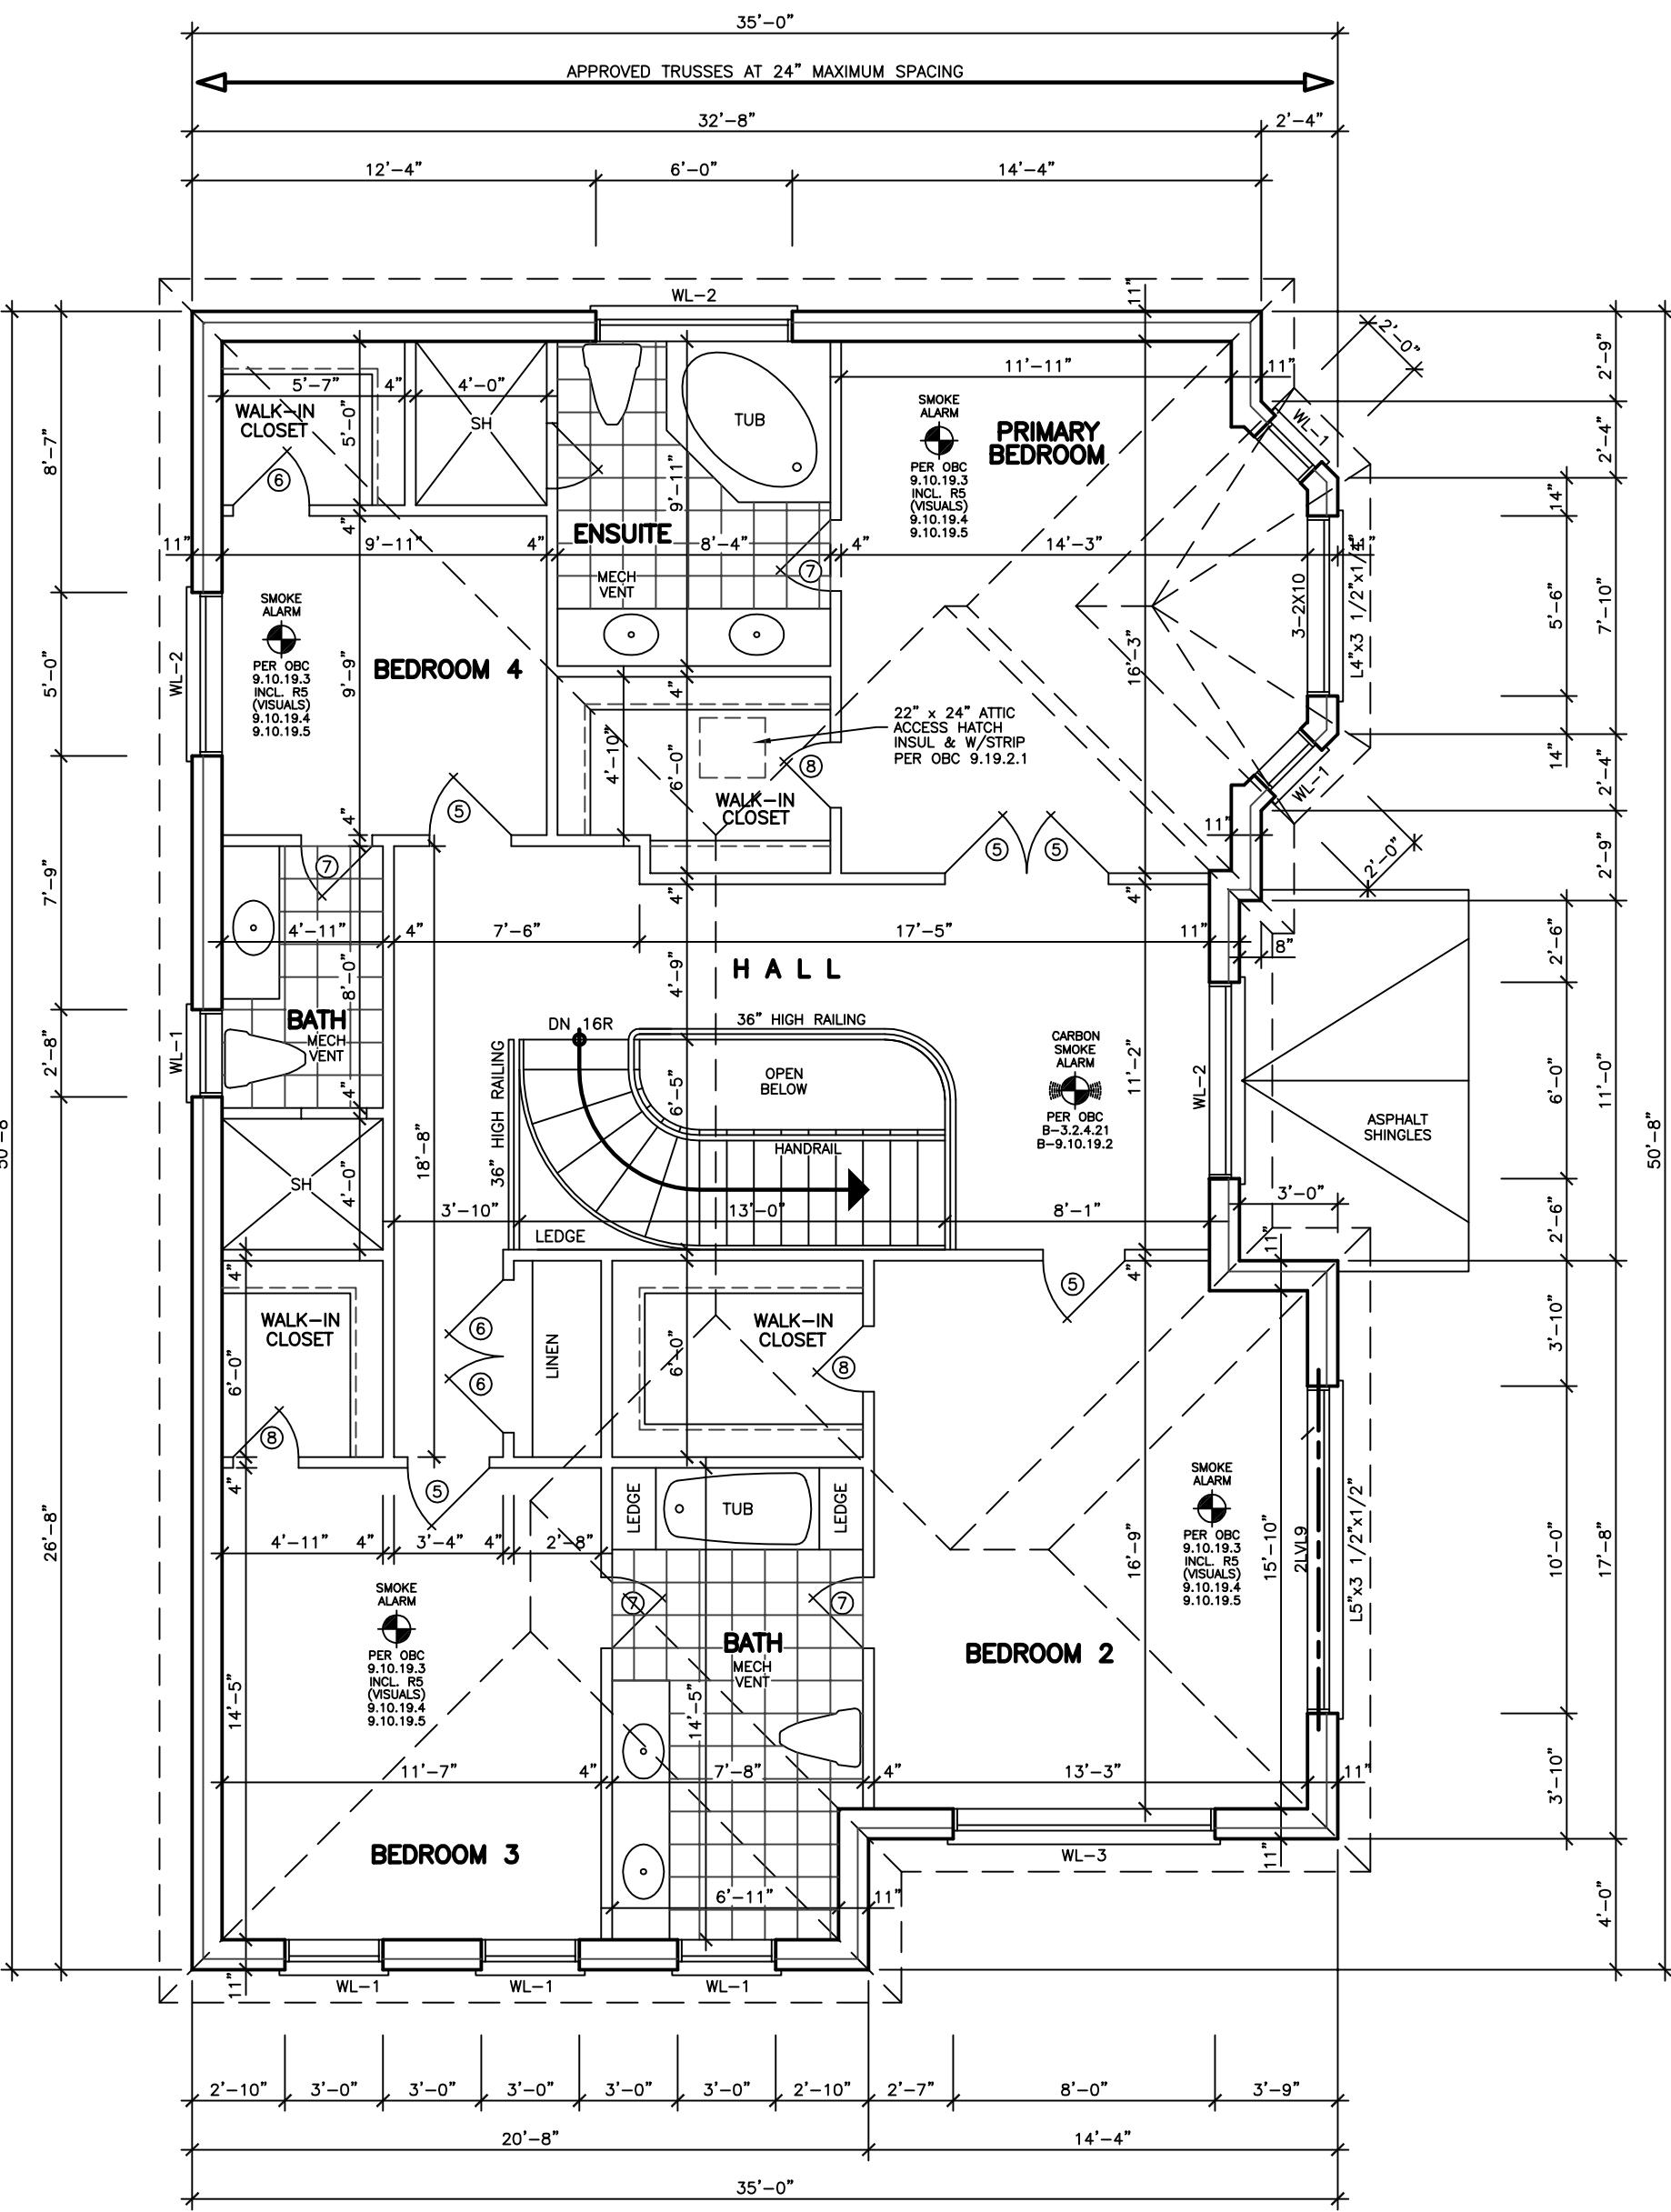



SECOND FLOOR PLAN 'A'

DOOR SCHEDULE	
1 = 2 ¹⁰ x 6 ⁸ x 1 ^{3/4} "	EXTERIOR
2 = 2 ⁸ x 6 ⁸ x 1 ^{3/4} "	EXTERIOR
3 = 2 ⁸ x 6 ⁸ x 1 ^{3/4} "	GARAGE, GASPROOF + CLOSER
4 = 2 ⁸ x 6 ⁸ x 1 ^{3/4} "	INTERIOR
5 = 2 ⁸ x 6 ⁸ x 1 ^{3/4} "	INTERIOR
6 = 2 ⁸ x 6 ⁸ x 1 ^{3/4} "	INTERIOR
7 = 2 ² x 6 ⁸ x 1 ^{3/4} "	INTERIOR
8 = 2 ² x 6 ⁸ x 1 ^{3/4} "	INTERIOR
9 = 1 ⁶ x 6 ⁸ x 1 ^{3/4} "	INTERIOR

LINTEL SCHEDULE	
L-1 = (2) LINTELS	3 ^{1/2} " x 3 ^{1/2} " x 1 ⁴ "
L-2 = W8 x 18 + 1 ⁴ " PLATE	
WL-1 = 3 ^{1/2} " x 3 ^{1/2} " x 1 ⁴ " + (2) 2" x 8" #1 SPRUCE	
WL-2 = 5" x 3 ^{1/2} " x 1 ⁴ " + (2) 2" x 10" #1 SPRUCE	
WL-3 = 5" x 3 ^{1/2} " x 1 ⁴ " + (2) 2" x 12" #1 SPRUCE	
WL-4 = 6" x 3 ^{1/2} " x 1 ⁴ " + (3) 2" x 12" #1 SPRUCE	

STRUCTURAL NOTES

1. PROVIDE 3-2x6 OR 3-2x4 POST MIN. TO MATCH WALL STUDS AT EACH LINTEL OR BEAM BEARING (TYP.) UNLESS NOTED ON PLAN.
2. ALL POSTS SHOULD BE EXTENDED DOWN TO THE FOOTINGS WITH SOLID BLOCKING UNDER POSTS WITHIN FLOORS.

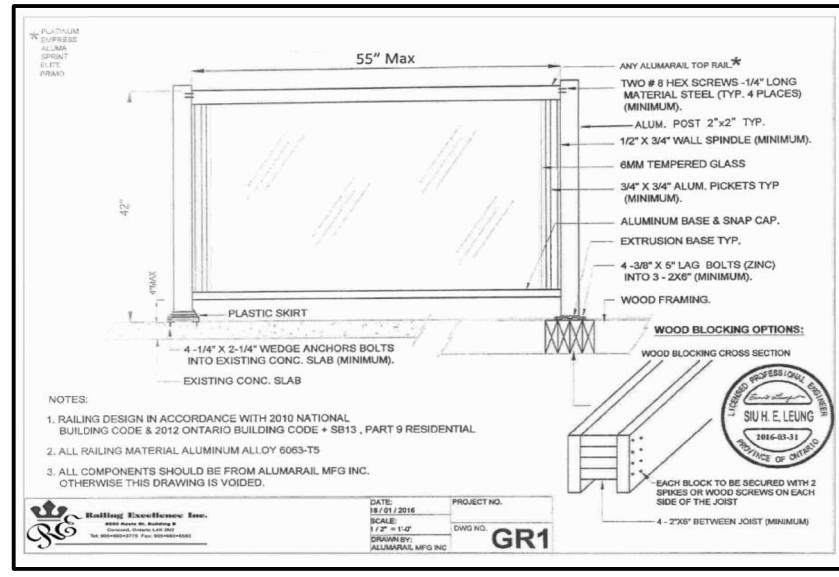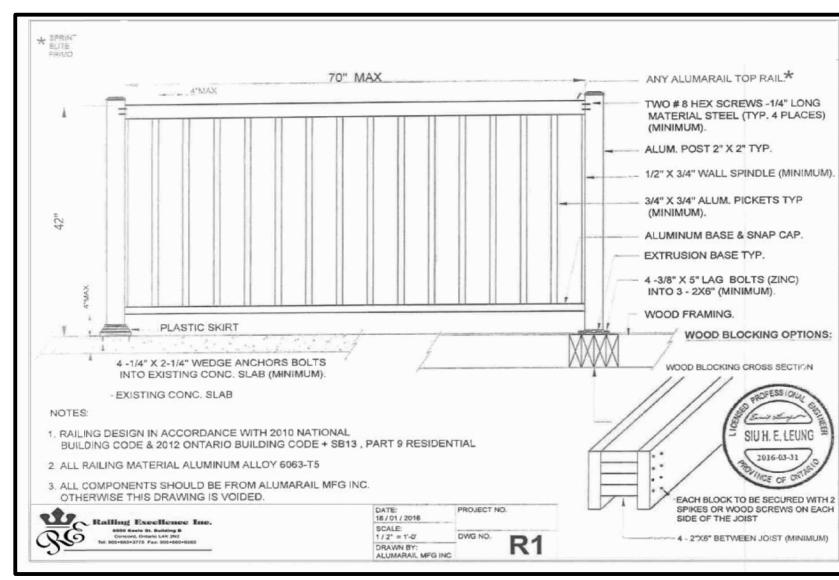


EXTERIOR TYPE LIGHTING

DOOR SCHEDULE	
1 =	$2^{10} \times 6^8 \times 1\frac{3}{4}$ " EXTERIOR
2 =	$2^8 \times 6^8 \times 1\frac{3}{4}$ " EXTERIOR
3 =	$2^8 \times 6^8 \times 1\frac{3}{4}$ " GARAGE, GASPROOF + CLOSER
4 =	$2^8 \times 6^8 \times 1\frac{3}{8}$ " INTERIOR
5 =	$2^6 \times 6^8 \times 1\frac{3}{8}$ " INTERIOR
6 =	$2^4 \times 6^8 \times 1\frac{3}{8}$ " INTERIOR
7 =	$2^2 \times 6^8 \times 1\frac{3}{8}$ " INTERIOR
8 =	$2^0 \times 6^8 \times 1\frac{3}{8}$ " INTERIOR
9 =	$1^6 \times 6^8 \times 1\frac{3}{8}$ " INTERIOR

LINTEL SCHEDULE	
L-1	= (2) LINTELS $3\frac{1}{2}'' \times 3\frac{1}{2}'' \times \frac{1}{4}''$
L-2	= W8 x 18 + $\frac{1}{4}''$ PLATE
WL-1	= $3\frac{1}{2}'' \times 3\frac{1}{2}'' \times \frac{1}{4}''$ + (2) 2" x 8" #1 SPRUCE
WL-2	= 5" x $3\frac{1}{2}'' \times \frac{5}{16}''$ + (2) 2" x 10" #1 SPRUCE
WL-3	= 5" x $3\frac{1}{2}'' \times \frac{3}{8}''$ + (2) 2" x 12" #1 SPRUCE
WL-4	= 6" x $3\frac{1}{2}'' \times \frac{5}{8}''$ + (3) 2" x 12" #1 SPRUCE

STRUCTURAL NOTES

1. PROVIDE 3-2x6 OR 3-2x4 POST MIN. TO MATCH WALL STUDS AT EACH LINTERL OR BEAM BEARING (TYP.) UNLESS NOTED ON PLAN.
 2. ALL POSTS SHOULD BE EXTENDED DOWN TO THE FOOTINGS WITH SOLID BLOCKING UNDER POSTS WITHIN FLOORS.
 3. PROVIDE 2X6 PLATE CONNECTED TO TOP FLANGE BY MEAN OF TWO ROWS OF 1/2" THRU BOLTS @4'-0" O/C AT EACH ROW STAGGERED.

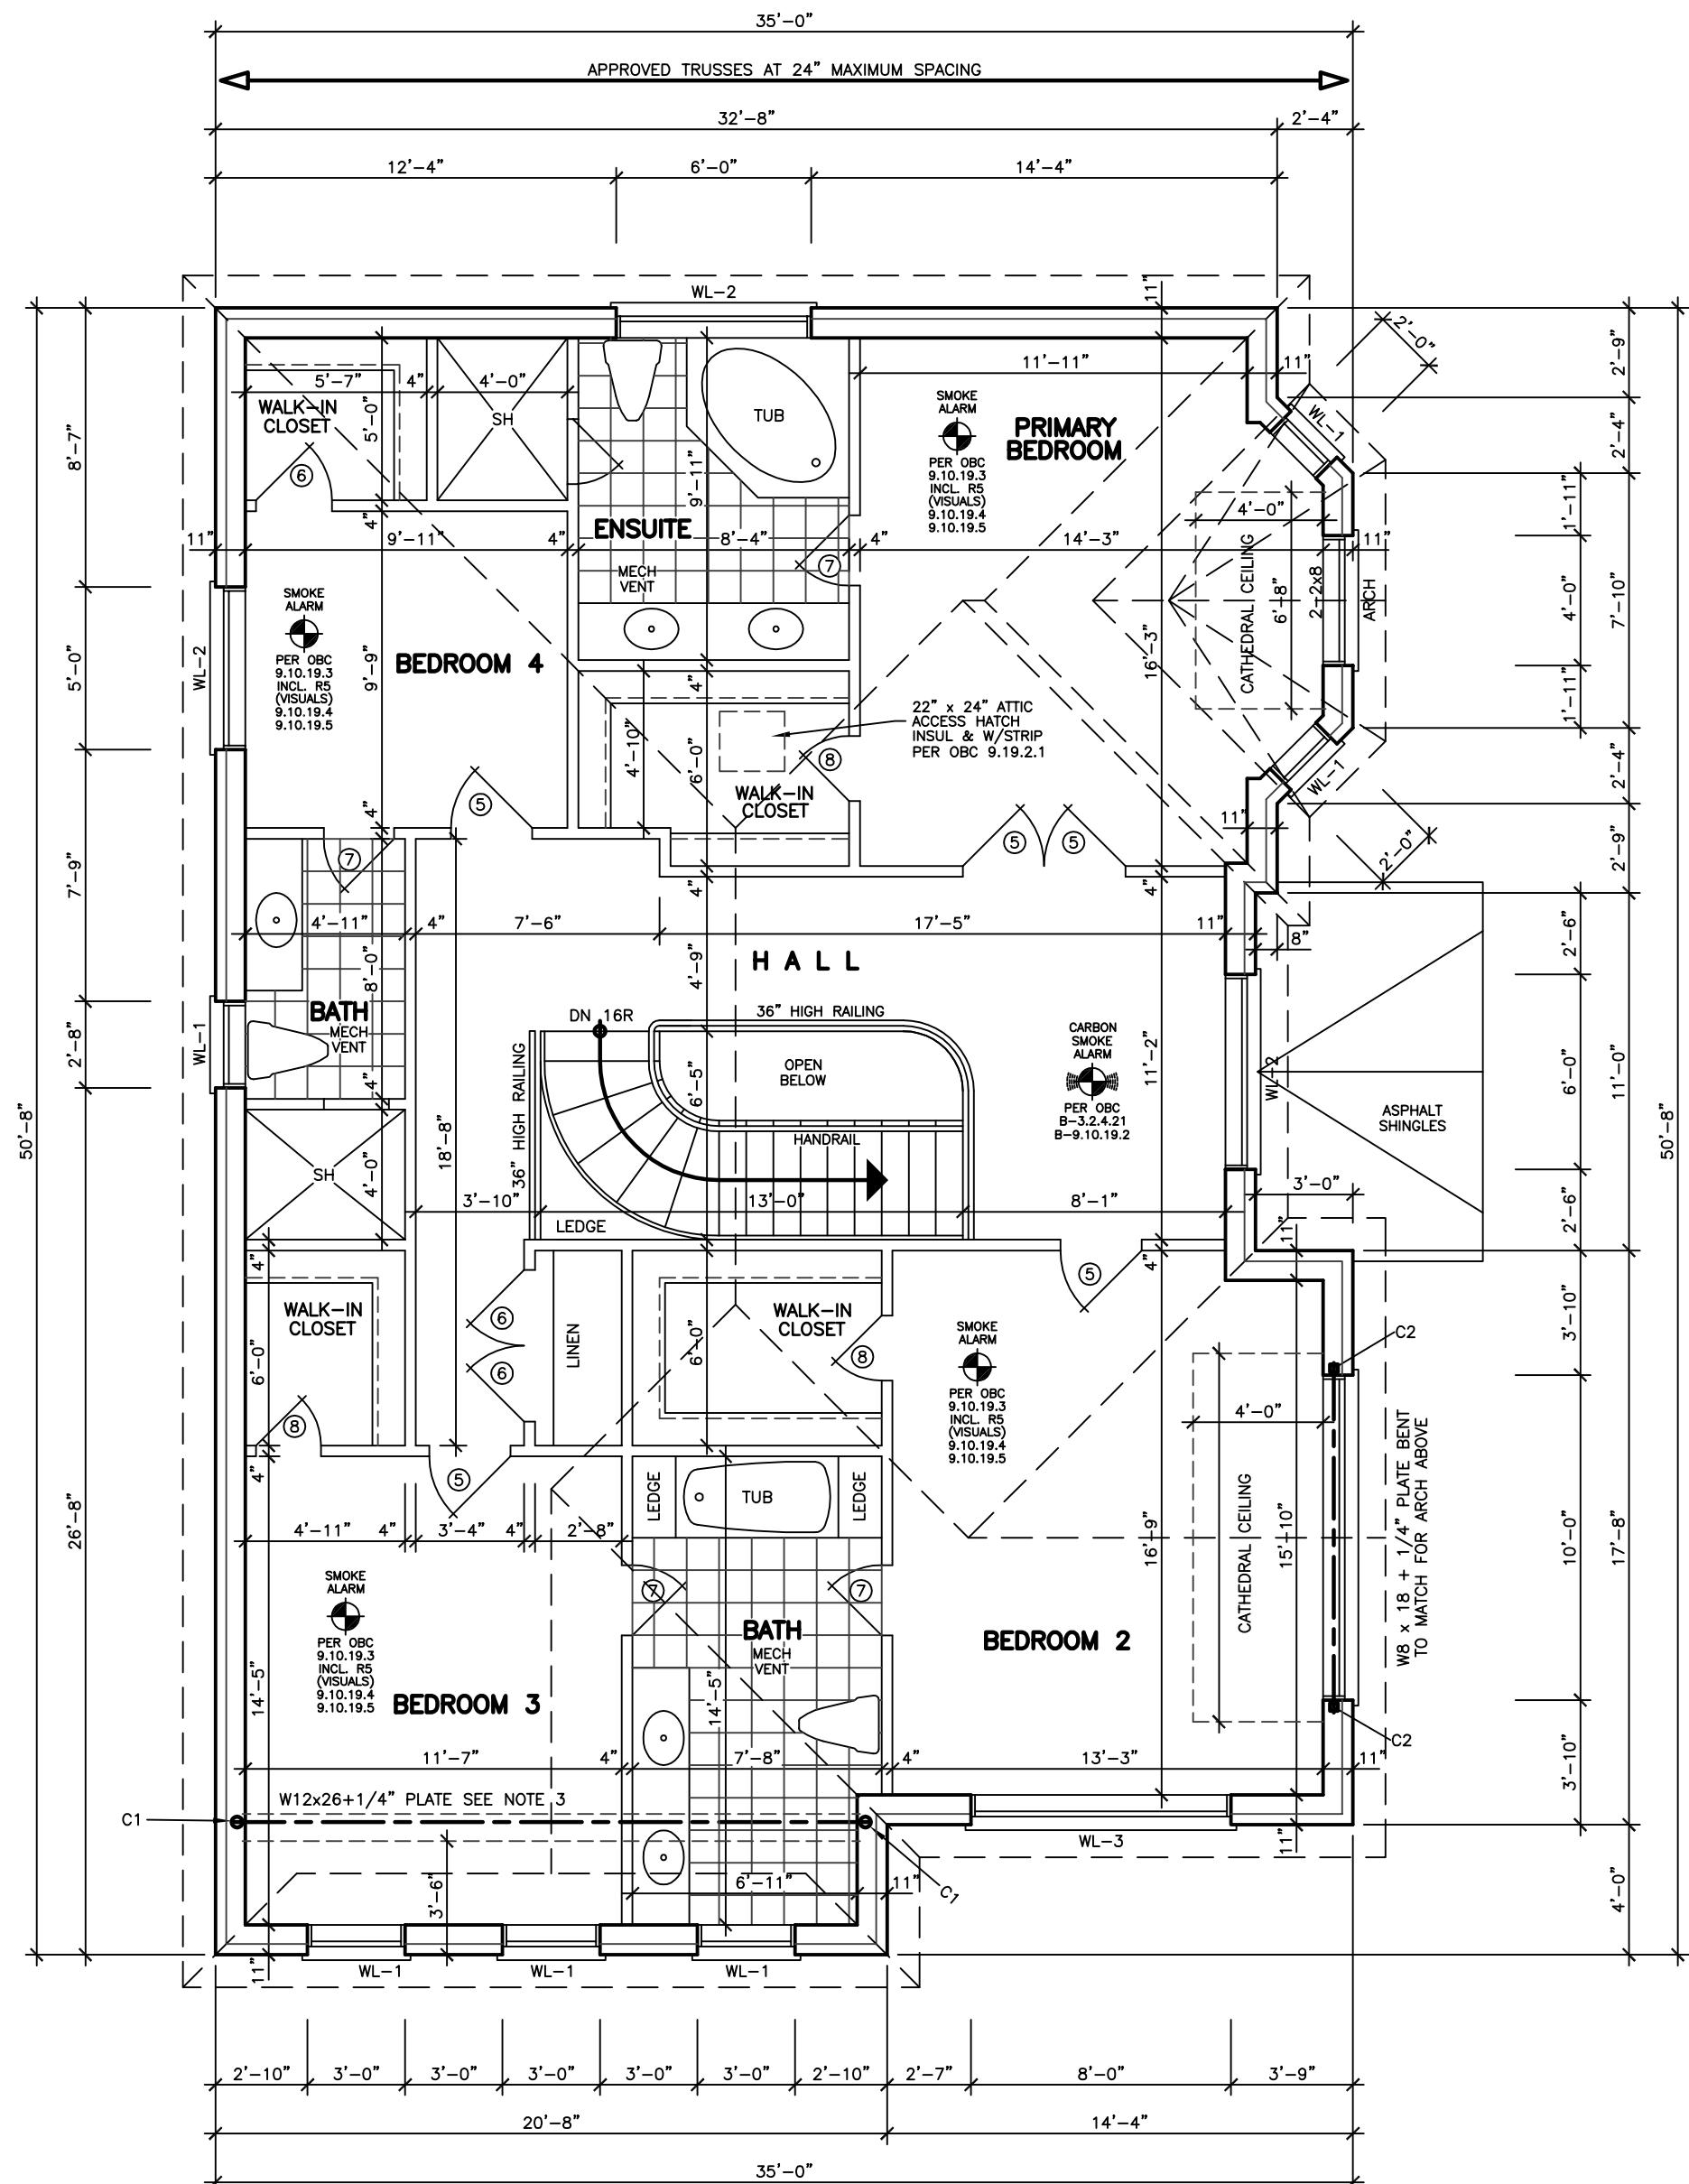

SECOND FLOOR PLAN 'B'

A circular registration stamp. The outer ring contains the text "REGISTERED PROFESSIONAL ENGINEER" at the top and "PROVINCE OF ONTARIO" at the bottom. The inner circle contains the name "L. KALISHENKO" in the center, with a wavy line above it. At the bottom of the inner circle, the date "19 APR 2024" is printed.

ASSUMED ROOF TRUSS BEARING
ON THE EXRERIOR WALLS ONLY
THE DESIGN OF ENTIRE STRUCTURE
SHOULD BE REVIEWED TO ACCOMODATE
FINAL ROOF TRUSS LAYOUT

KING EAST ESTATES



ALL DRAWINGS & SPECIFICATIONS ARE THE PROPERTY
OF THE ARCHITECT AND CANNOT BE USED OR
REPRODUCED WITHOUT HIS APPROVAL.

THE CONTRACTORS SHALL CHECK AND VERIFY ALL DIMENSIONS ON THE SITE AND REPORT ANY DISCREPANCIES TO THE ARCHITECT.

DRAWINGS MUST NOT BE SCALED.

DRAWINGS MUST NOT BE SCALED.

**ARCHITECTURAL
DESIGN INC.**

MODEL 2890

PROJECT



PROPOSED

TWO STOREY DWELLING

FOR: KING EAST DEVELOPMENTS INC.

AT: RICHMOND HILL

DRAWING		SECOND FLOOR PLAN 'B'	
DATE	MAY '24	PROJECT NO	20-23
DRAWN	E.B.	DRAWING NO	A-7
CHECKED			
SCALE	3/16"=1'-0"		

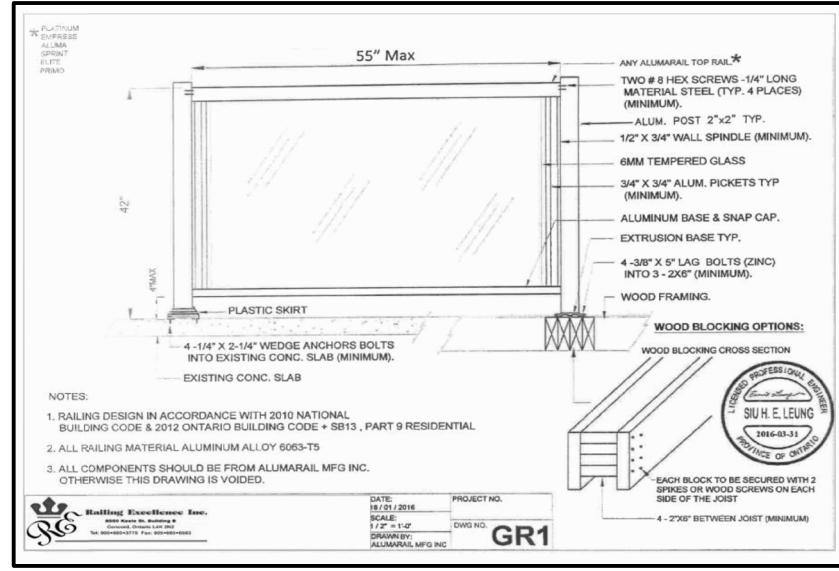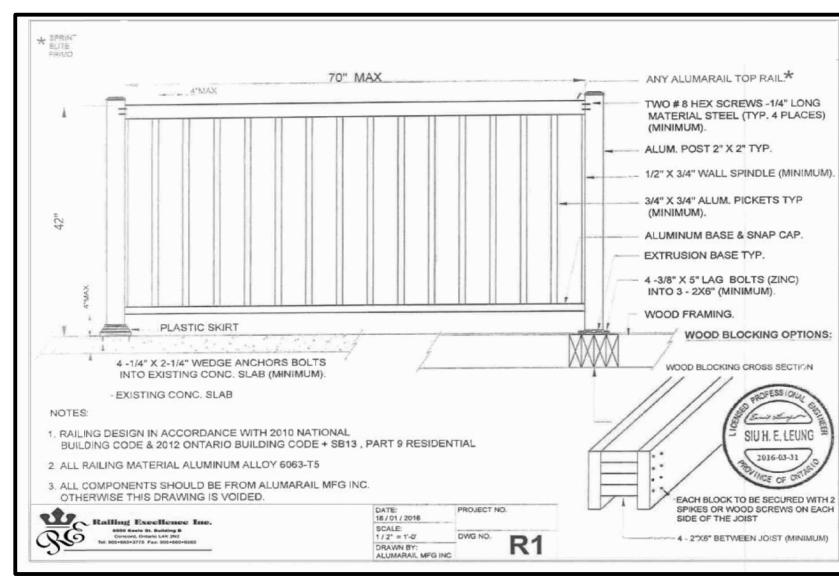

EXTERIOR TYPE LIGHTING

DOOR SCHEDULE	
1 =	2 ¹⁰ x 6 ⁸ x 1 ^{3/4} " EXTERIOR
2 =	2 ⁸ x 6 ⁸ x 1 ^{3/4} " EXTERIOR
3 =	2 ⁸ x 6 ⁸ x 1 ^{3/4} " GARAGE, GASPROOF + CLOSER
4 =	2 ⁸ x 6 ⁸ x 1 ^{3/8} " INTERIOR
5 =	2 ⁶ x 6 ⁸ x 1 ^{3/8} " INTERIOR
6 =	2 ⁴ x 6 ⁸ x 1 ^{3/8} " INTERIOR
7 =	2 ² x 6 ⁸ x 1 ^{3/8} " INTERIOR
8 =	2 ⁰ x 6 ⁸ x 1 ^{3/8} " INTERIOR
9 =	1 ⁶ x 6 ⁸ x 1 ^{3/8} " INTERIOR


LINTEL SCHEDULE	
L-1	= (2) LINTELS 3½" x 3½" x ¼"
L-2	= W8 x 18 + ¼" PLATE
WL-1	= 3½" x 3½" x ¼" + (2) 2" x 8" #1 SPRUCE
WL-2	= 5" x 3½" x 5/16" + (2) 2" x 10" #1 SPRUCE
WL-3	= 5" x 3½" x 3/8" + (2) 2" x 12" #1 SPRUCE
WL-4	= 6" x 3½" x 5/8" + (3) 2" x 12" #1 SPRUCE

STRUCTURAL NOTE

1. PROVIDE 3-2x6 OR 3-2x4 POST MIN. TO MATCH WALL STUDS AT EACH LINTEL OR BEAM BEARING (TYP.) UNLESS NOTED ON PLAN.
 2. ALL POSTS SHOULD BE EXTENDED DOWN TO THE FOOTINGS WITH SOLID BLOCKING UNDER POSTS WITHIN FLOORS.

STRUCTURAL LEGEN

W1 DENOTES CONTINUOUS 2-2X6@12" O/C STUD WALL FROM SECOND FLOOR CONNECTED TO ROOF STRUCTURE
PROVIDE CONTINUOUS 4-2X6 FROM SECOND FLOOR CONNECTED TO ROOF STRUCTURE AT WINDOW LINTEL SUPPORTS.
USE HANGERS WITH CONCEALED FLANGES FOR WINDOW LINTEL SUPPORTS.

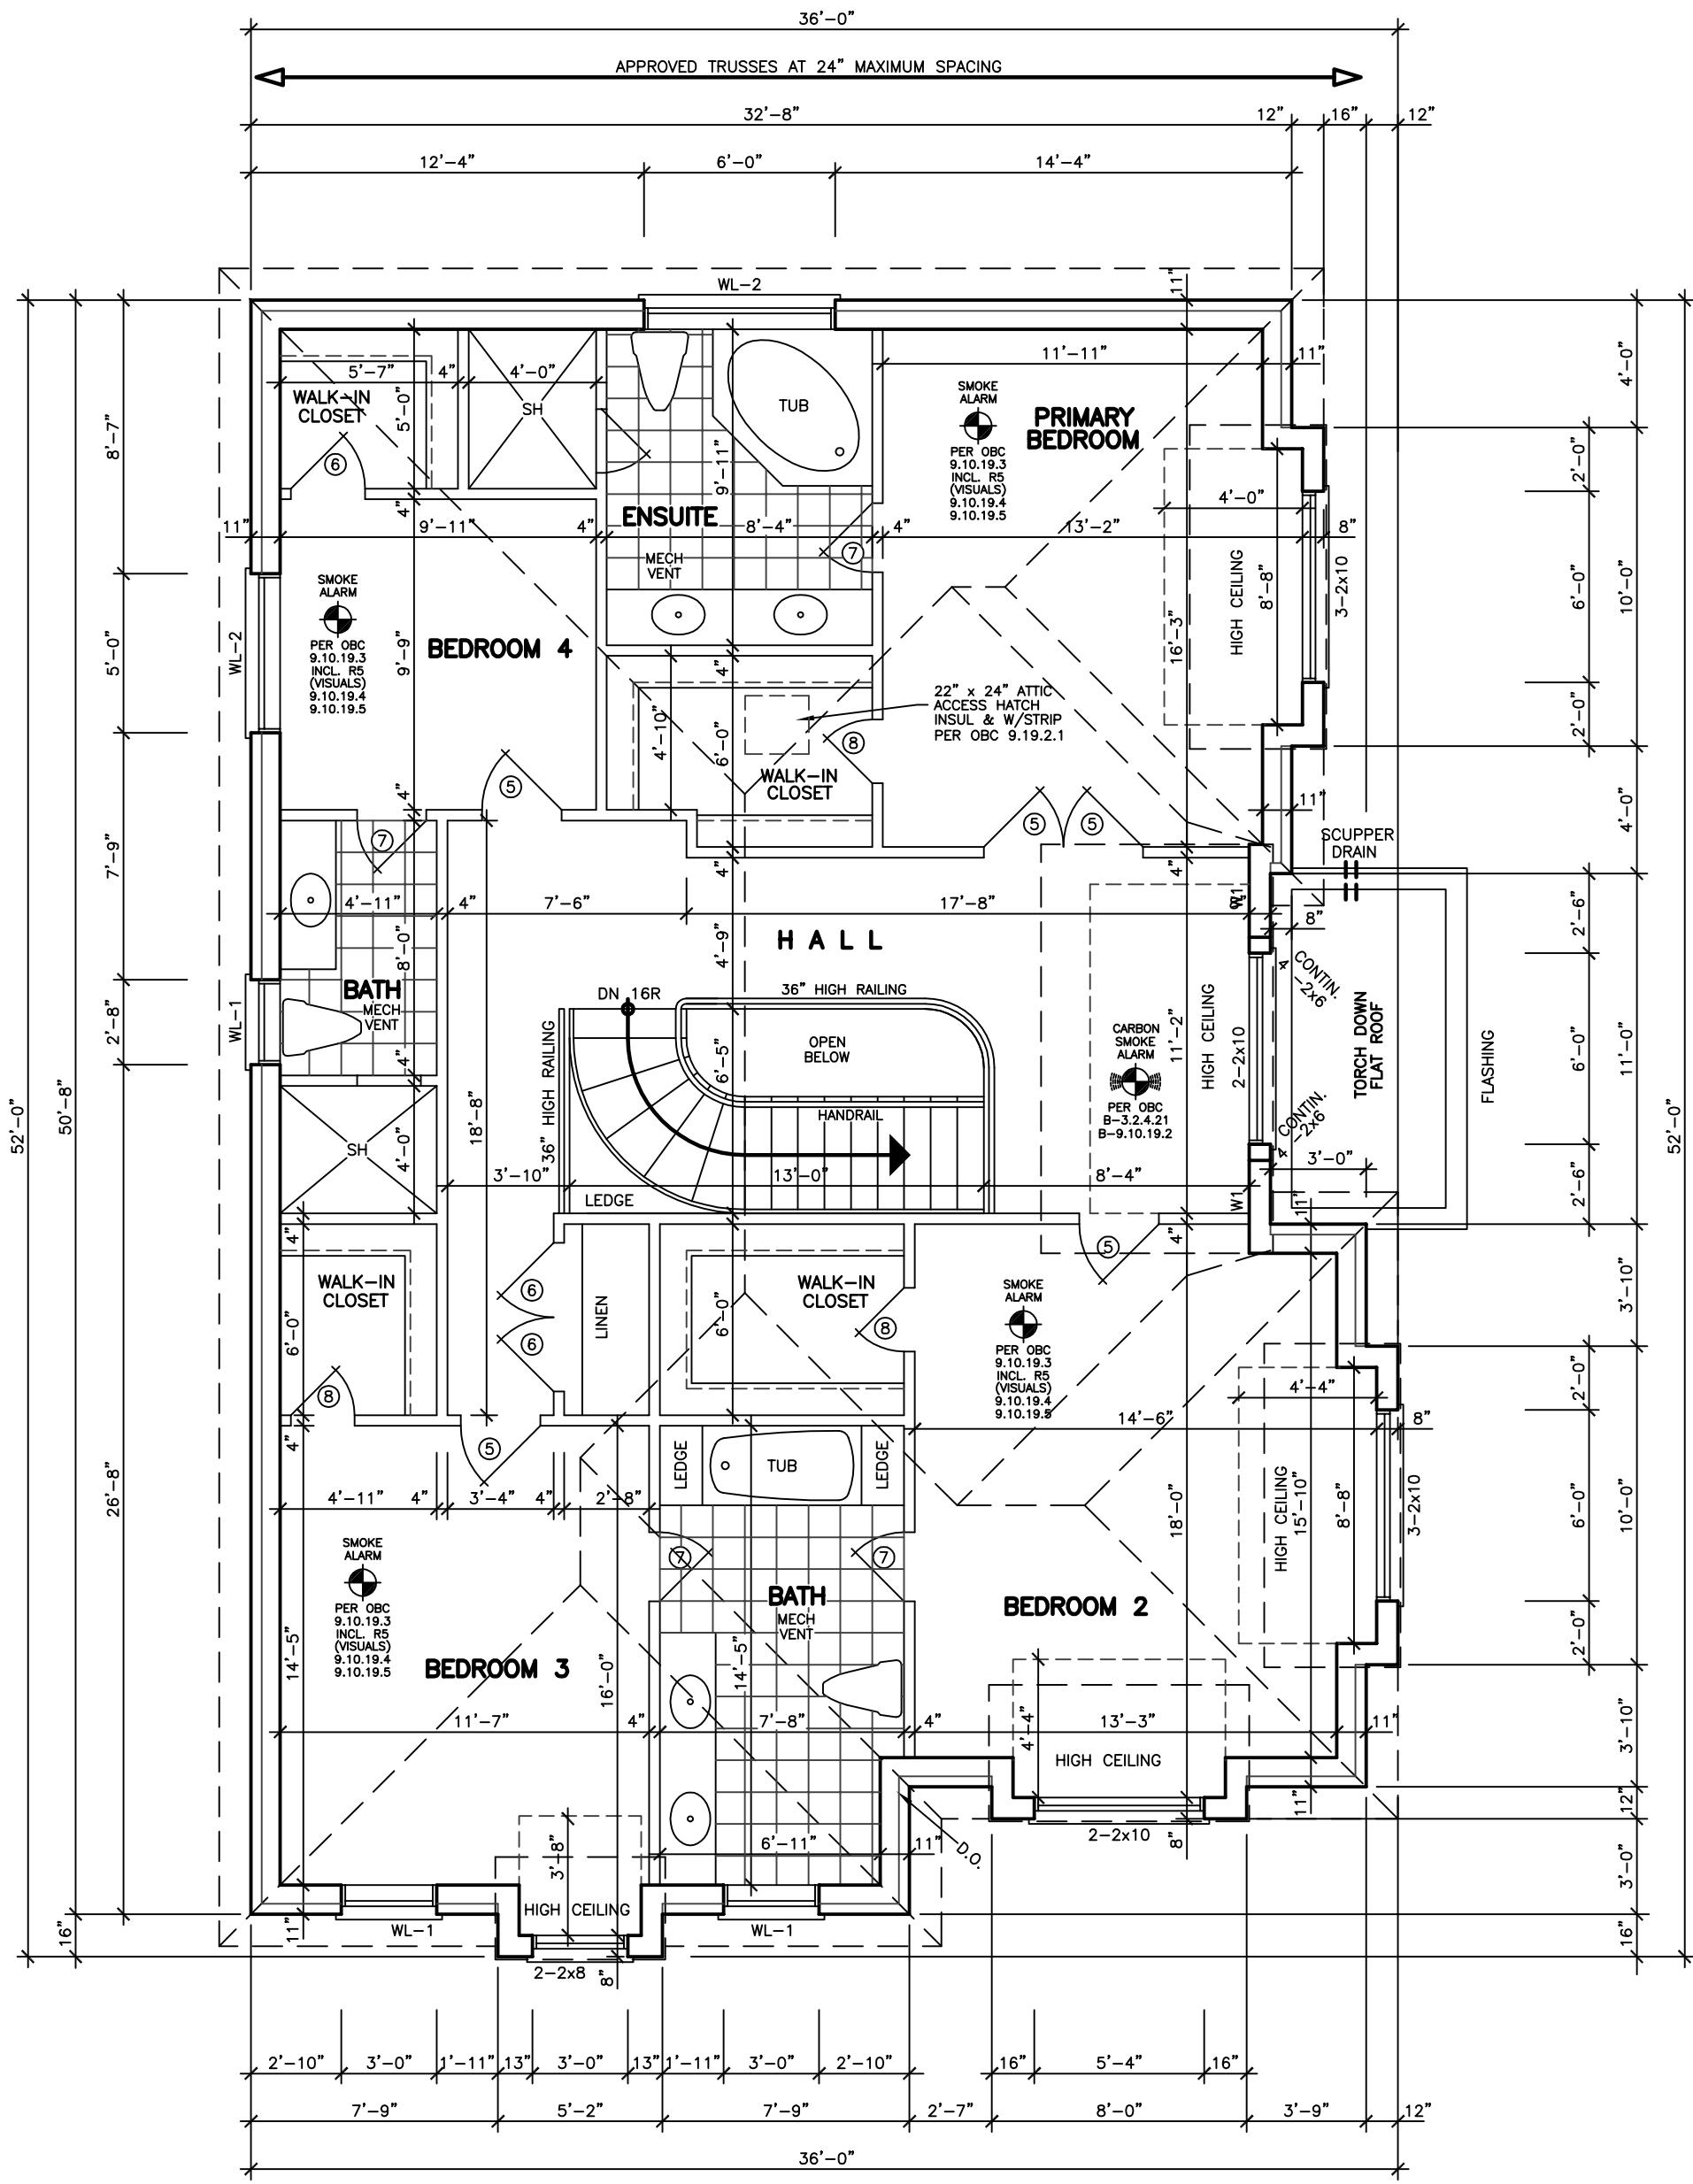

SECOND FLOOR PLAN 'C'

A circular registration stamp with a double-lined border. The outer ring contains the text "REGISTERED PROFESSIONAL ENGINEER" at the top and "PROVINCE OF ONTARIO" at the bottom. The inner circle contains "L. KALISHENKO" at the top and "19 APR 2024" at the bottom. A large, dark, handwritten signature of "LEONARD KALISHENKO" is written across the center of the stamp.

ASSUMED ROOF TRUSS BEARING
ON THE EXRERIOR WALLS ONLY
THE DESIGN OF ENTIRE STRUCTURE
SHOULD BE REVIEWED TO ACCOMODATE
FINAL ROOF TRUSS LAYOUT

KING EAST ESTATES



ALL DRAWINGS & SPECIFICATIONS ARE THE PROPERTY
OF THE ARCHITECT AND CANNOT BE USED OR
REPRODUCED WITHOUT HIS APPROVAL.

THE CONTRACTORS SHALL CHECK AND VERIFY ALL DIMENSIONS ON THE SITE AND REPORT ANY DISCREPANCIES TO THE ARCHITECT.

DRAWINGS MUST NOT BE SCALED.

DRAWINGS MUST NOT BE SCALED.

ARCHITECTURAL DESIGN INC.

MODEL 2890

PROJECT


PROPOSED

TWO STOREY DWELLING


FOR: KING EAST DEVELOPMENTS INC.

AT: RICHMOND HILL


DRAWING	
SECOND FLOOR PLAN 'C'	
DATE	MAY '24
DRAWN	E.B.
CHECKED	
SCALE	3/16"=1'-0"
PROJECT NO 20-23	
DRAWING NO A-10	

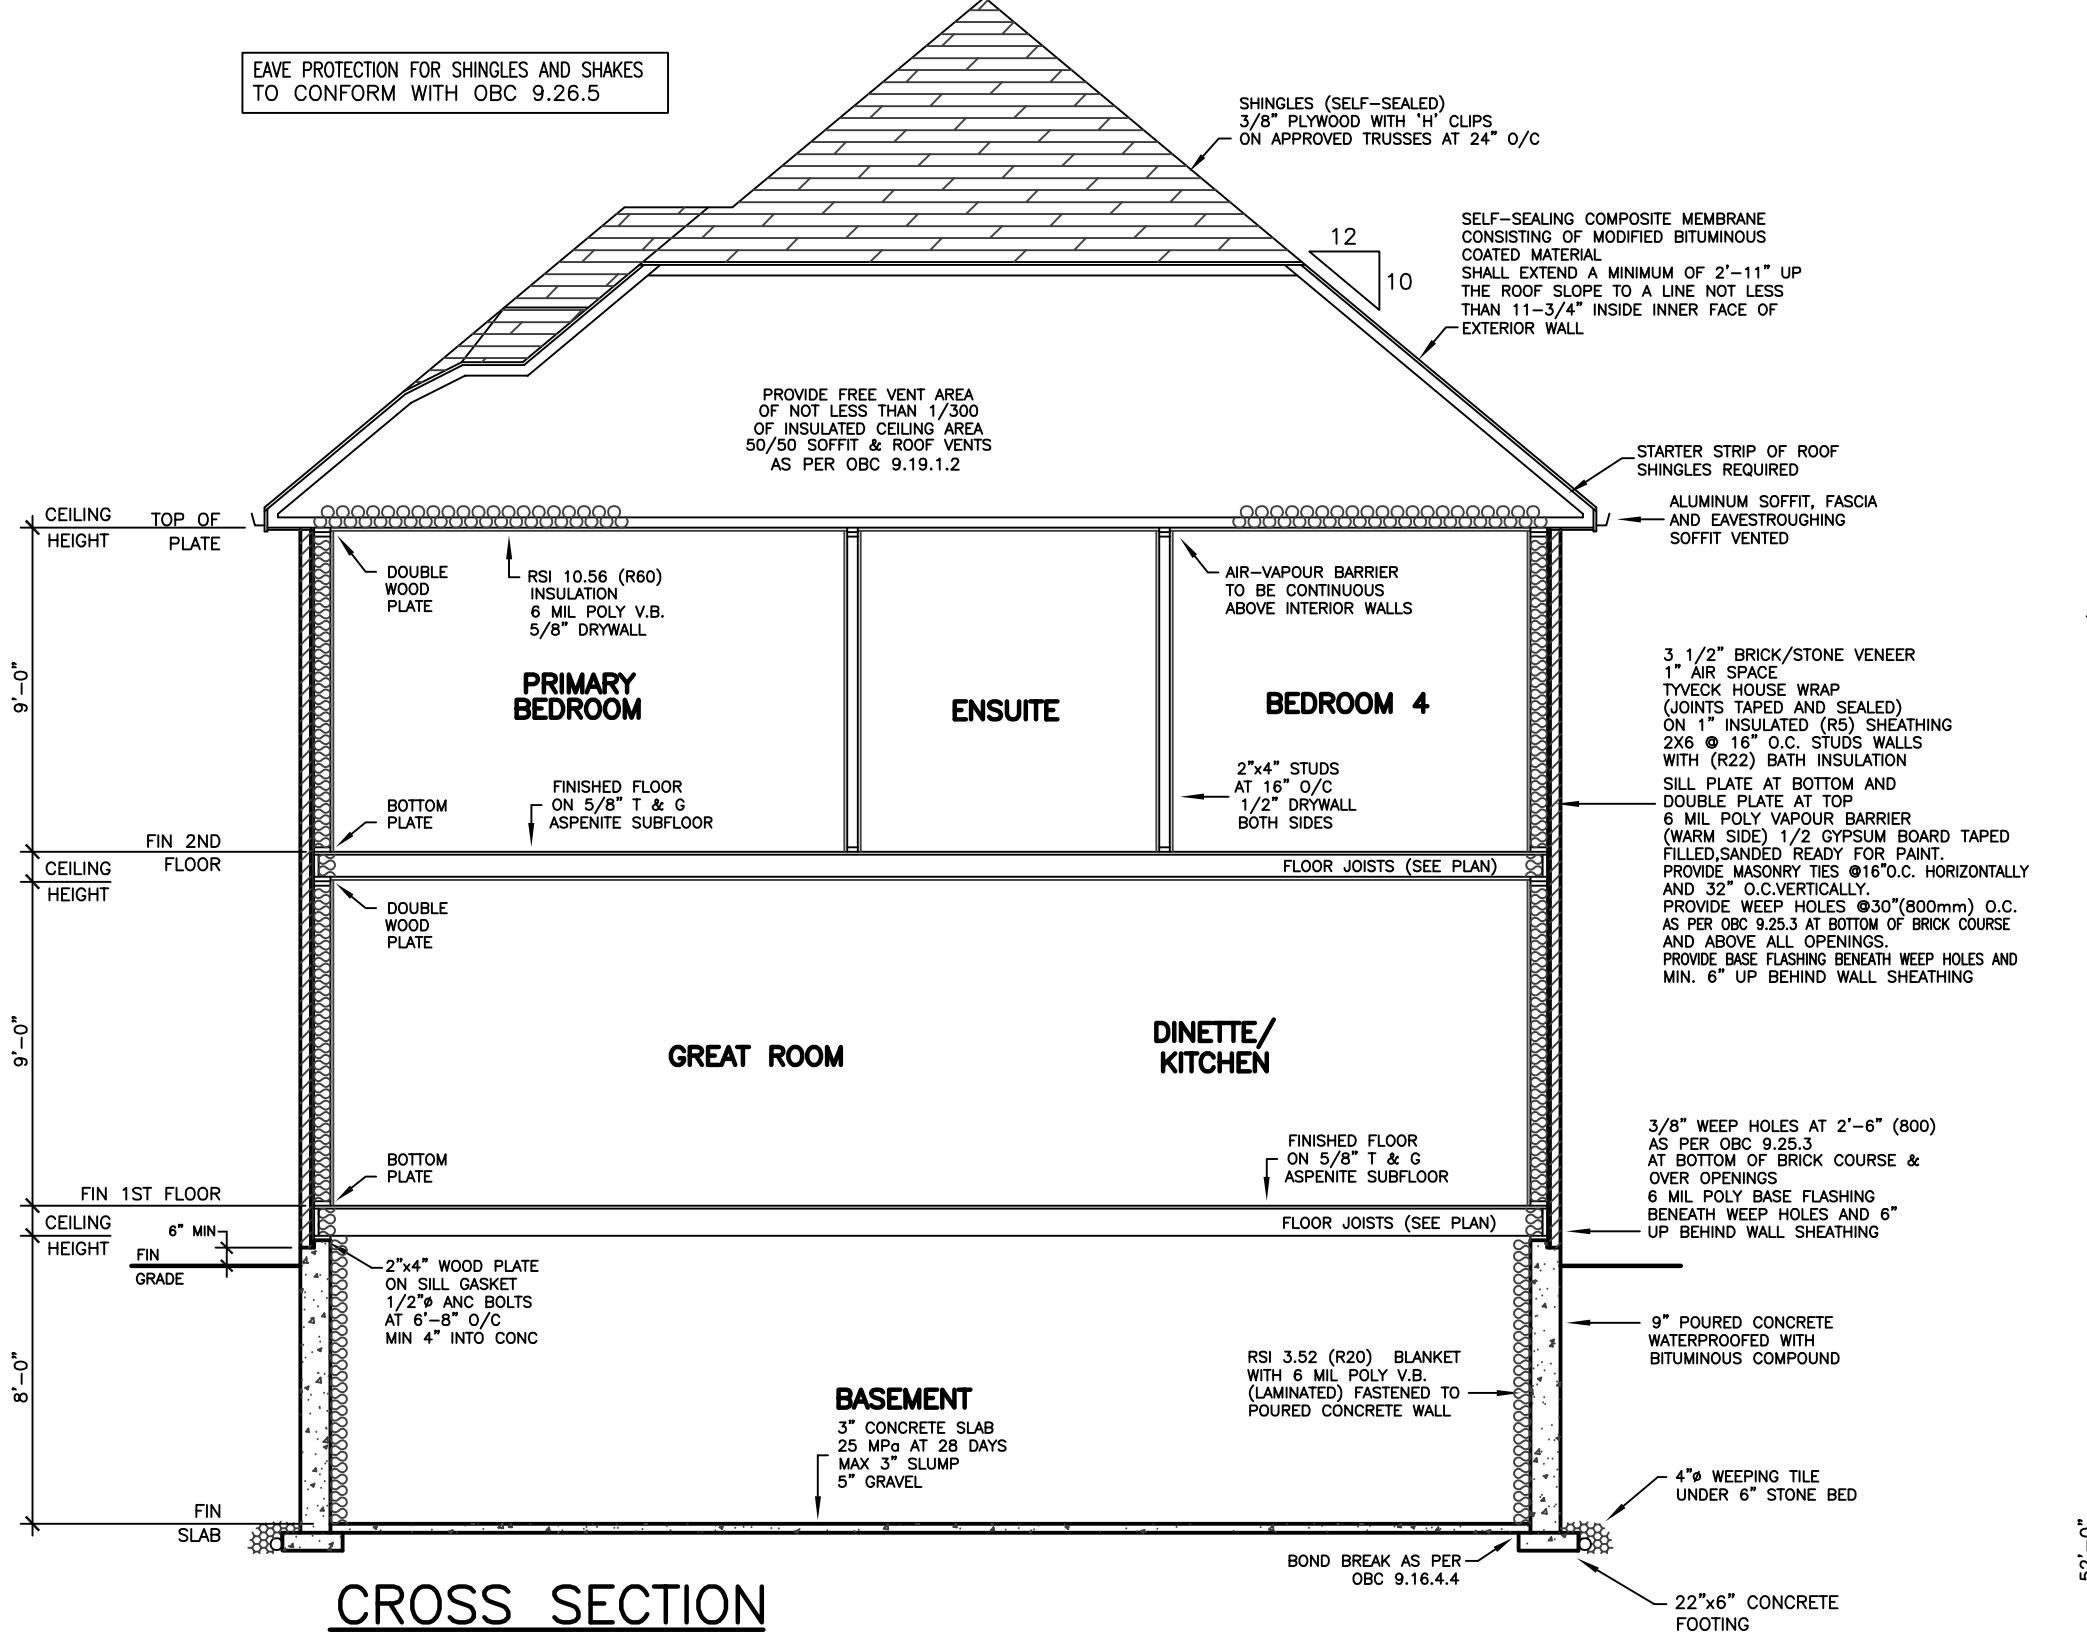

CROSS SECTION

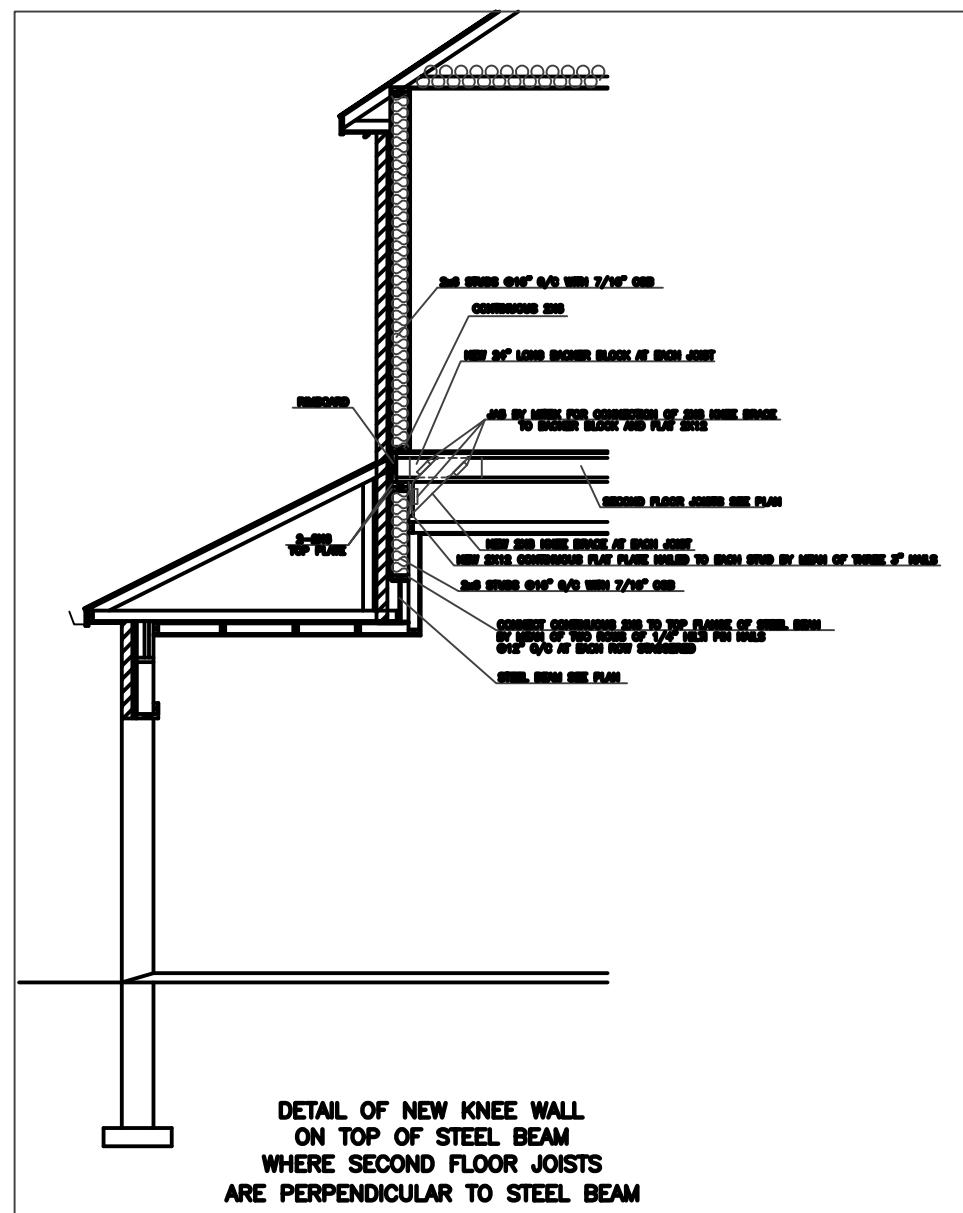

DETAIL OF NEW KNEE WALL
ON TOP OF STEEL BEAM
WHERE SECOND FLOOR JOISTS
ARE PERPENDICULAR TO STEEL BEAM

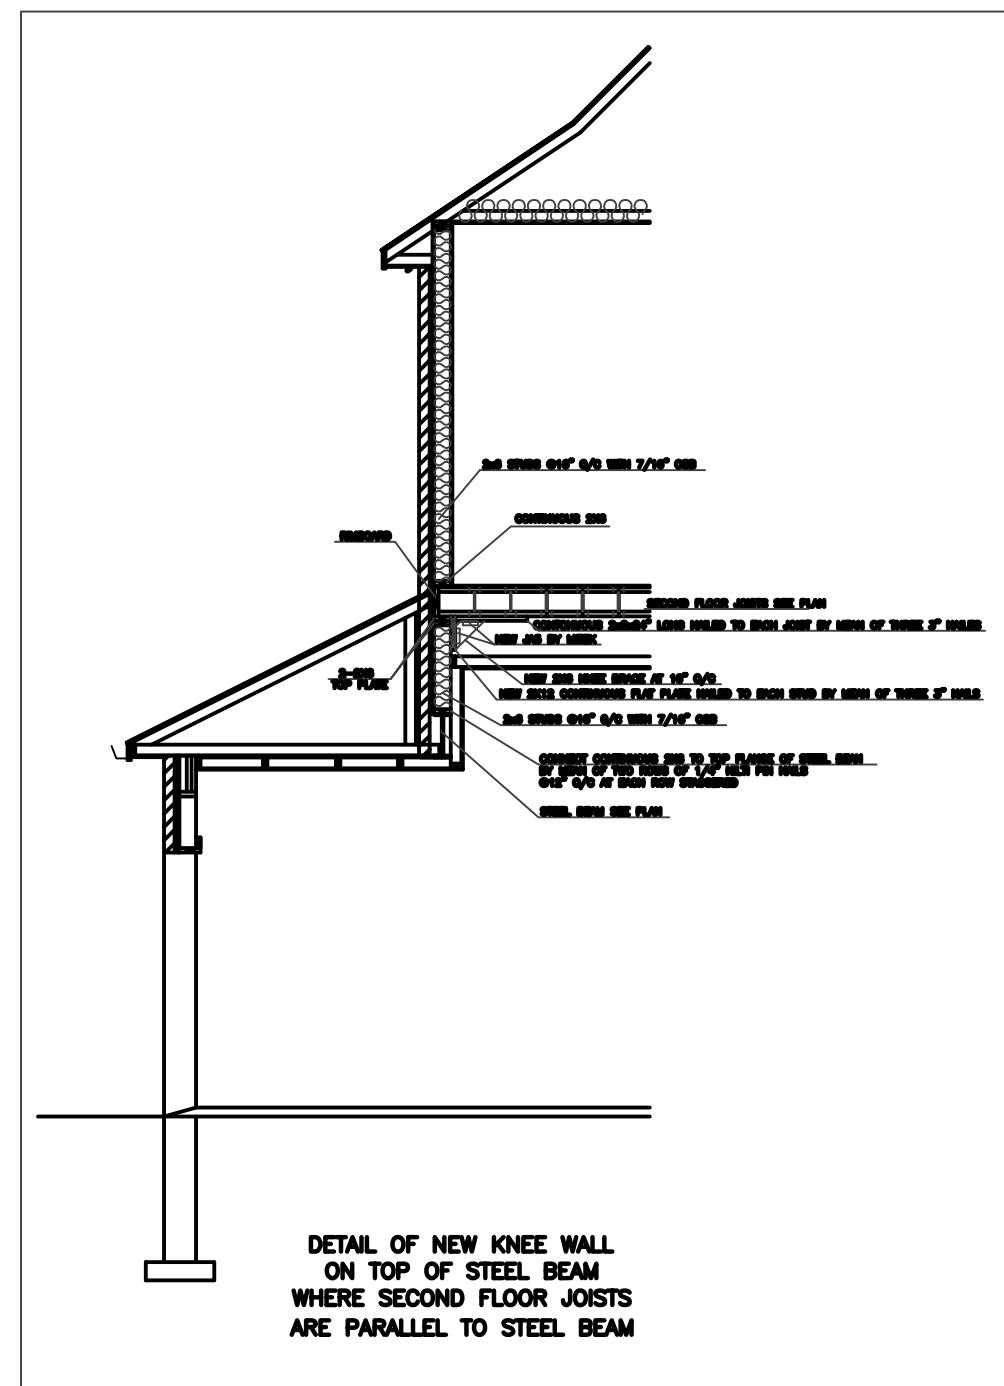

**DETAIL OF NEW KNEE WALL
ON TOP OF STEEL BEAM
WHERE SECOND FLOOR JOISTS
ARE PARALLEL TO STEEL BEAM**

CEILING HEIGHTS OF ROOMS OR SPACES IN RESIDENTIAL OCCUPANCIES AND LIVE/WORK UNITS SHALL CONFORM TO TABLE 9.5.3.1. AREAS IN ROOMS OR SPACES OVER WHICH CEILING HEIGHT IS NOT LESS THAN THE MINIMUM SPECIFIED IN TABLE 9.5.3.1 SHALL BE CONTIGUOUS WITH THE ENTRY OR ENTRIES TO THOSE ROOMS OR SPACES. [OBC 9.5.3.1]

CLOSED SPACES IN INTERIOR WALLS,
CEILINGS AND CRAWL SPACES SHALL BE
SEPARATED BY FIRE BLOCKS FROM CONCEALED
SPACES IN EXTERIOR WALLS AND ATTIC OR
ROOF SPACES. [OBC 9.10.16.1.(1)]


SMOKE ALARMS CONFORMING TO
CAN/ULC-S351, "SMOKE ALARMS", SHALL
BE INSTALLED IN EACH DWELLING UNIT IN
CONFORMANCE WITH OBC 9.10.19.1

THE MINIMUM DEPTH OF FOUNDATIONS BELOW
FINISHED GROUND LEVEL SHALL BE
IN ACCORDANCE WITH TABLE 9.12.2.2.

DRAIN TILE AND DRAIN PIPE FOR FOUNDATION DRAINAGE SHALL CONFORM TO THE ENTIRE SUBSECTION OBC B.9.14.3
FOOTINGS SHALL REST ON UNDISTURBED SOIL, ROCK OR COMPAKTED GRANULAR FILL. OBC 9.15.3.2]

BE PROVIDED WITH THERMAL INSULATION CONFORMING TO SUBSECTIONS 9.25.2, AN AIR BARRIER SYSTEM CONFORMING TO SUBSECTION 9.25.3., AND A VAPOUR BARRIER CONFORMING TO SUBSECTION 9.25.4, AND CONSTRUCTED IN SUCH A WAY THAT THE PROPERTIES AND RELATIVE POSITION OF ALL THE MATERIALS CONFORM TO SUBSECTION 9.25.5

STUCCO SHALL BE NOT LESS THAN 200 mm ABOVE FINISHED GROUND LEVEL EXCEPT WHEN IT IS APPLIED OVER CONCRETE OR MASONRY. [OBC 9.28.1.4]

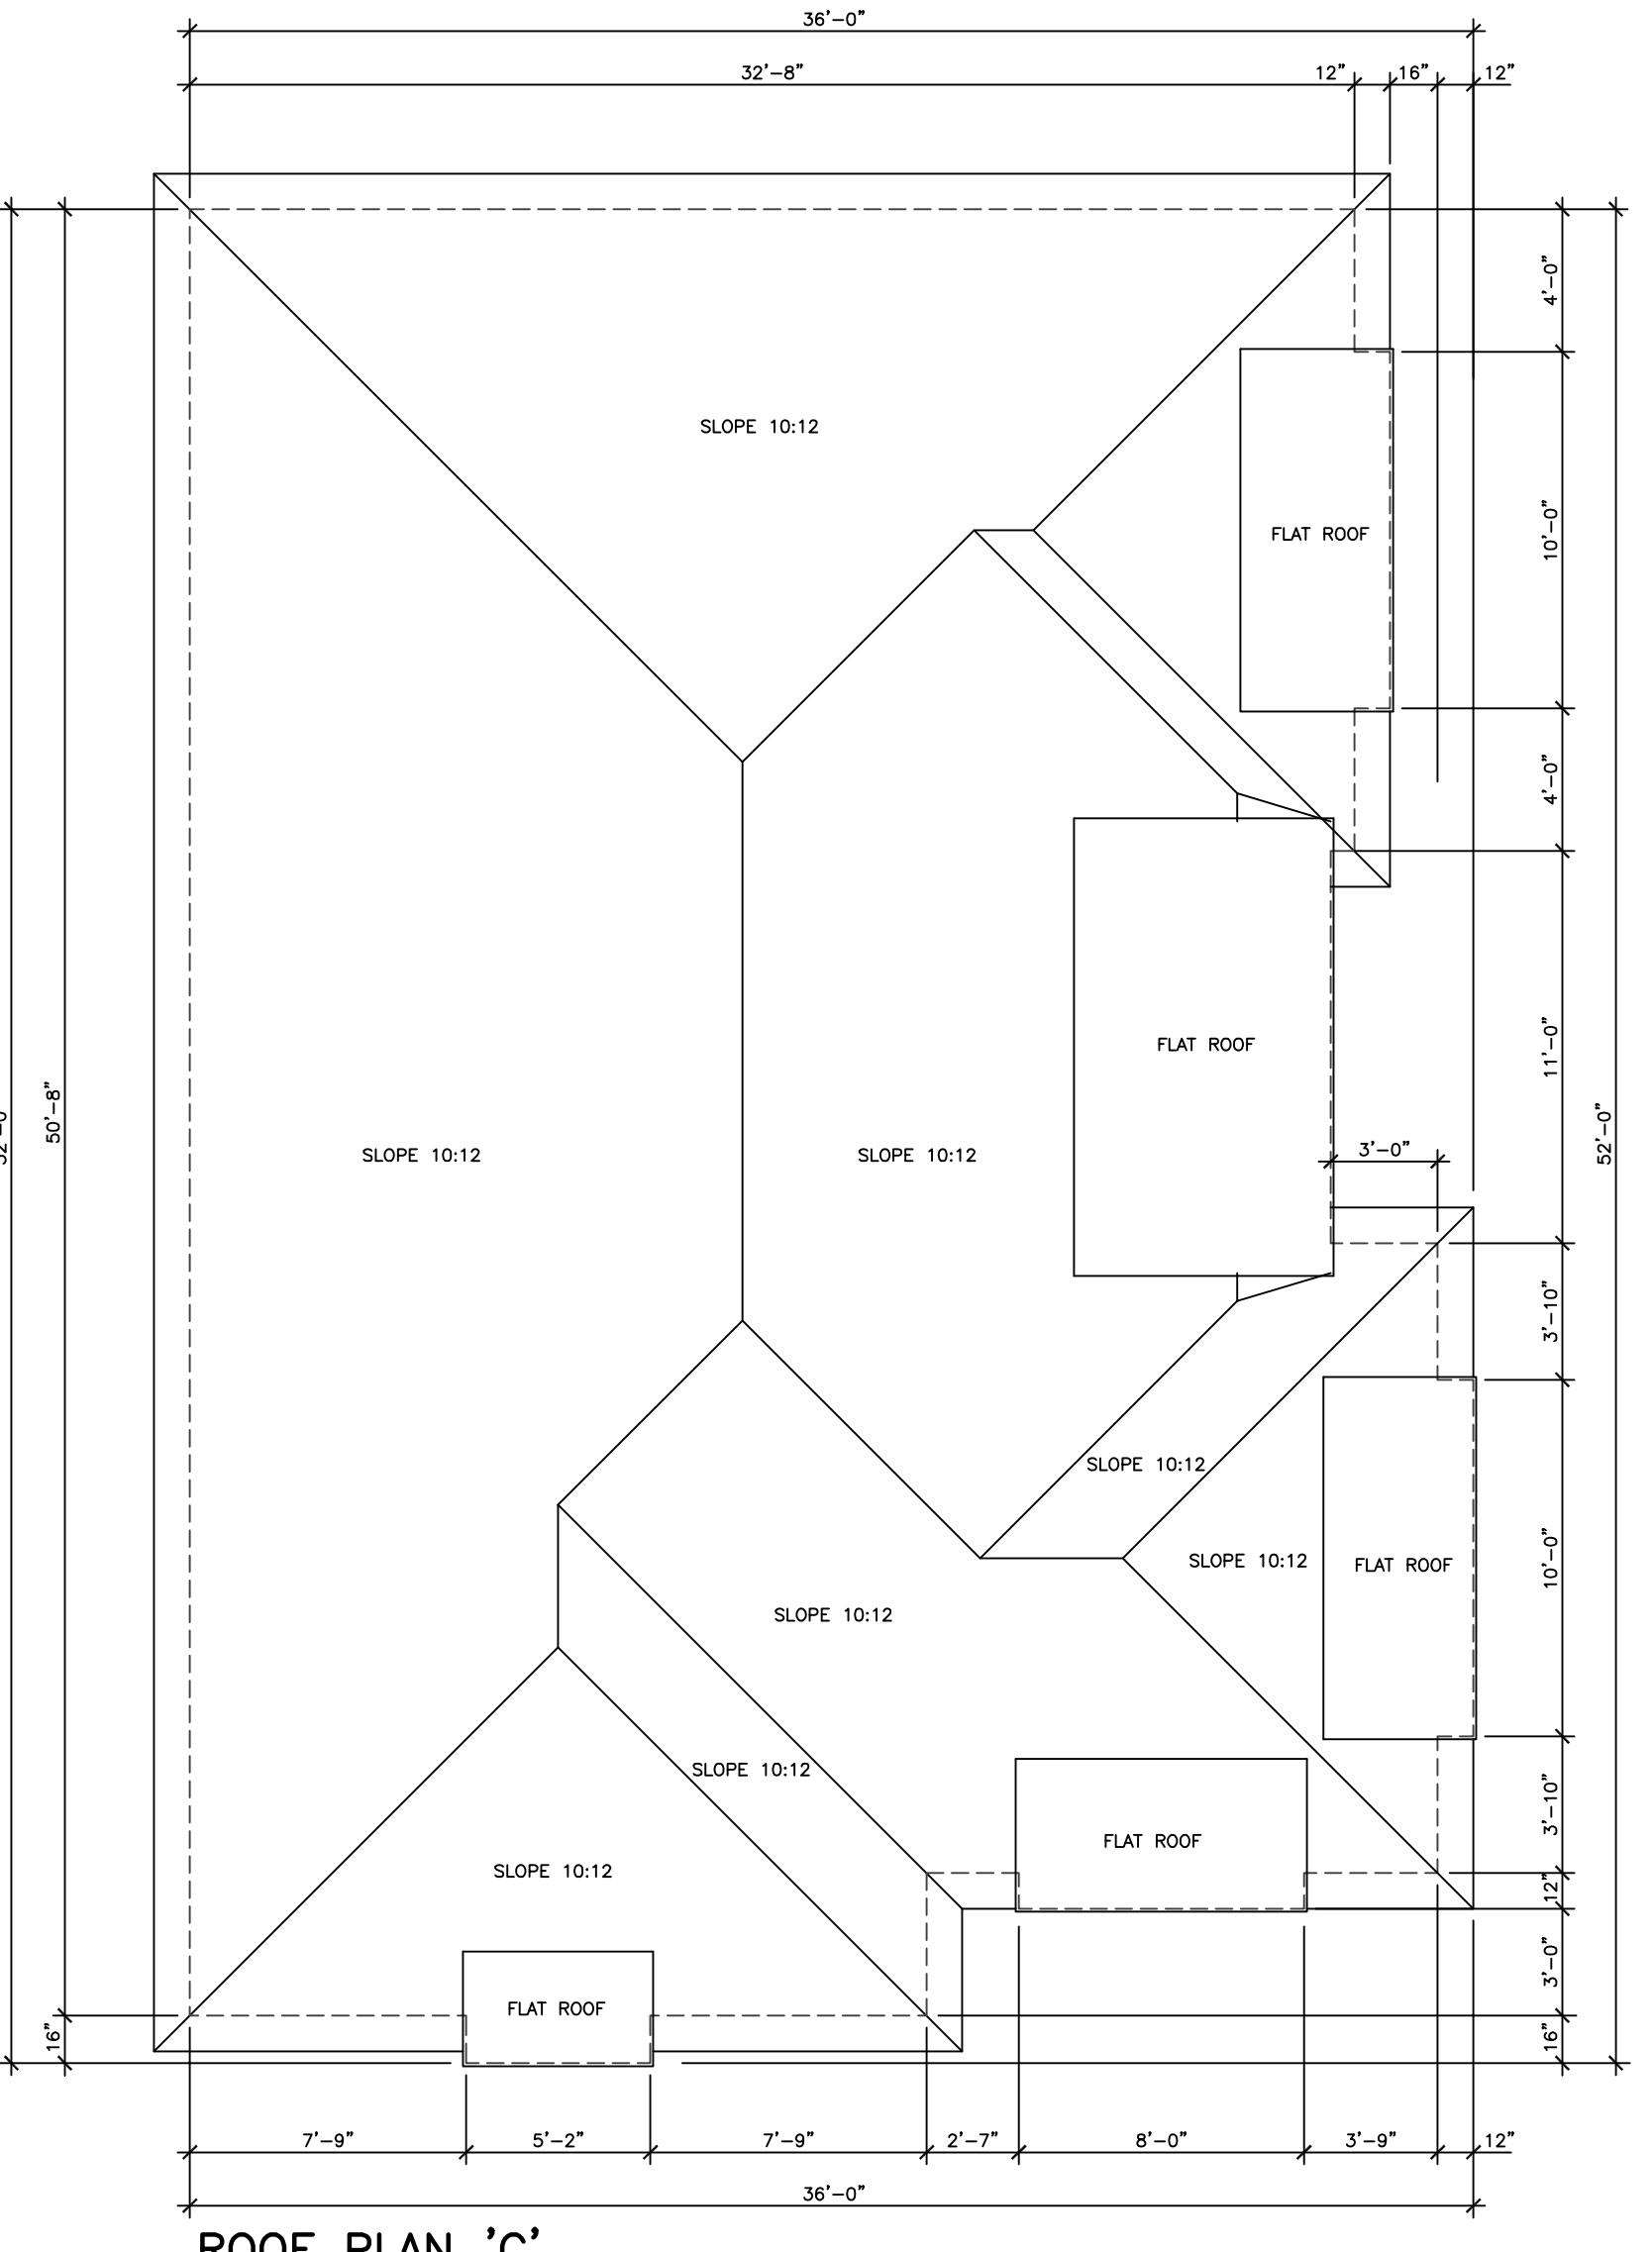

ROOF PLAN 'C'

DOOR SCHEDULE	
1 =	$2^{10} \times 6^8 \times 1\frac{3}{4}$ " EXTERIOR
2 =	$2^8 \times 6^8 \times 1\frac{3}{4}$ " EXTERIOR
3 =	$2^8 \times 6^8 \times 1\frac{3}{4}$ " GARAGE, GASPROOF + CLOSER
4 =	$2^8 \times 6^8 \times 1\frac{3}{8}$ " INTERIOR
5 =	$2^6 \times 6^8 \times 1\frac{3}{8}$ " INTERIOR
6 =	$2^4 \times 6^8 \times 1\frac{3}{8}$ " INTERIOR
7 =	$2^2 \times 6^8 \times 1\frac{3}{8}$ " INTERIOR
8 =	$2^0 \times 6^8 \times 1\frac{3}{8}$ " INTERIOR
9 =	$1^6 \times 6^8 \times 1\frac{3}{8}$ " INTERIOR

LINTEL SCHEDULE	
L-1	= (2) LINTELS 3½" x 3½" x ¼"
L-2	= W8 x 18 + ¼" PLATE
WL-1	= 3½" x 3½" x ¼" + (2) 2" x 8" #1 SPRUCE
WL-2	= 5" x 3½" x 5/16" + (2) 2" x 10" #1 SPRUCE
WL-3	= 5" x 3½" x 3/8" + (2) 2" x 12" #1 SPRUCE
WL-4	= 6" x 3½" x 5/8" + (3) 2" x 12" #1 SPRUCE

The logo consists of a rectangular frame containing a circular seal. The seal's border contains the text "REGISTERED PROFESSIONAL ENGINEER" at the top and "PROVINCE OF ONTARIO" at the bottom. Inside the circle, the name "L. KALISHENKO" is written vertically along the left side. At the bottom of the circle, the date "19 APR 2024" is printed. A large, stylized signature of "L. KALISHENKO" is overlaid across the center of the seal.

ASSUMED ROOF TRUSS BEARING
ON THE EXTERIOR WALLS ONLY
THE DESIGN OF ENTIRE STRUCTURE
SHOULD BE REVIEWED TO ACCOMODATE
FINAL ROOF TRUSS LAYOUT

KING EAST ESTATES



DRAWINGS & SPECIFICATIONS ARE THE PROPERTY
OF THE ARCHITECT AND CANNOT BE USED OR
REPRODUCED WITHOUT HIS APPROVAL.

CONTRACTORS SHALL CHECK AND VERIFY ALL
DIMENSIONS ON THE SITE AND REPORT ANY
DISCREPANCIES TO THE ARCHITECT.

WINGS MUST NOT BE SCALED.

THIS MUST NOT BE COPIED.

ARCHITECTURAL DESIGN INC.

**56 PENNSYLVANIA AVE.
UNIT 1
CONCORD, ONT. L4K 3V9
TEL 905 660-9393
FAX 905 660-9419**

MODEL 2890



**JECT
ROPOSED
TWO STOREY DWELLING**

R: KING EAST DEVELOPMENTS INC.
AT: RICHMOND HILL


WING

DOF PLAN 'C'
ROSS SECTION


E.B.	DRAWING NO
ED	
3/16"=1'-0"	A-11

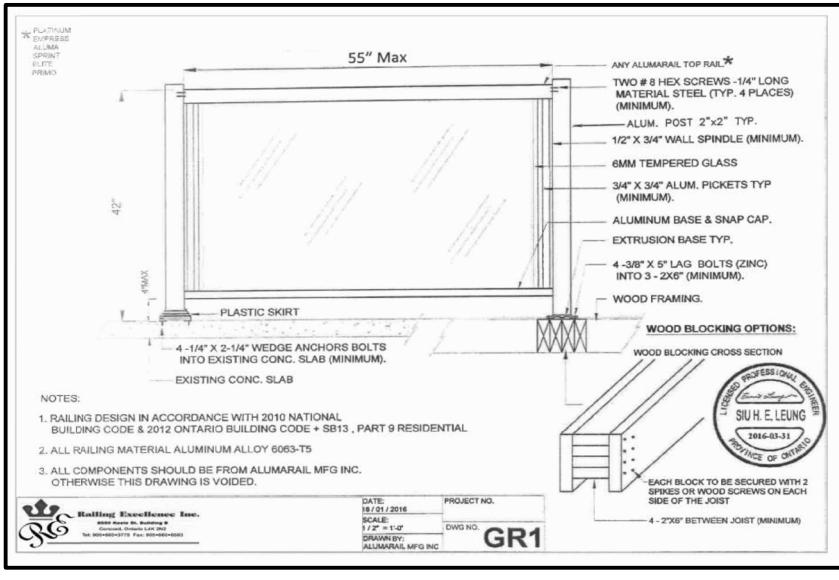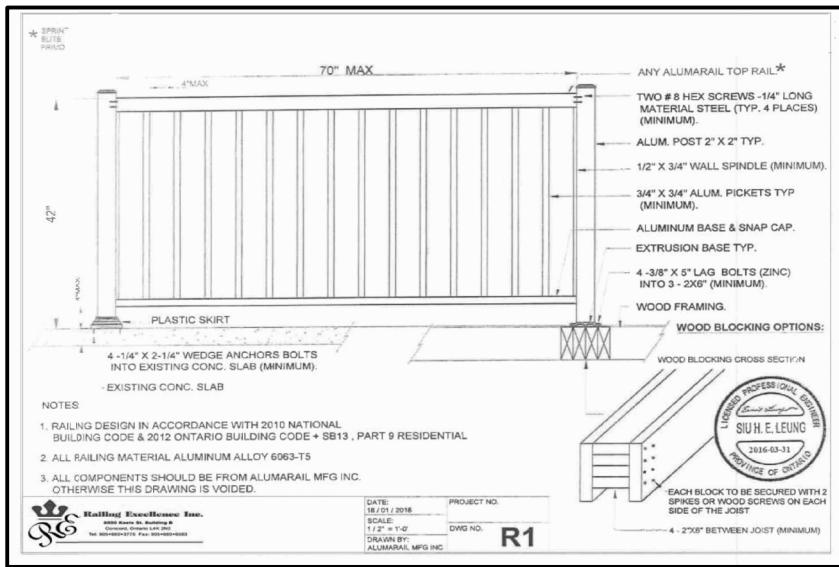

 EXTERIOR TYPE LIGHTING

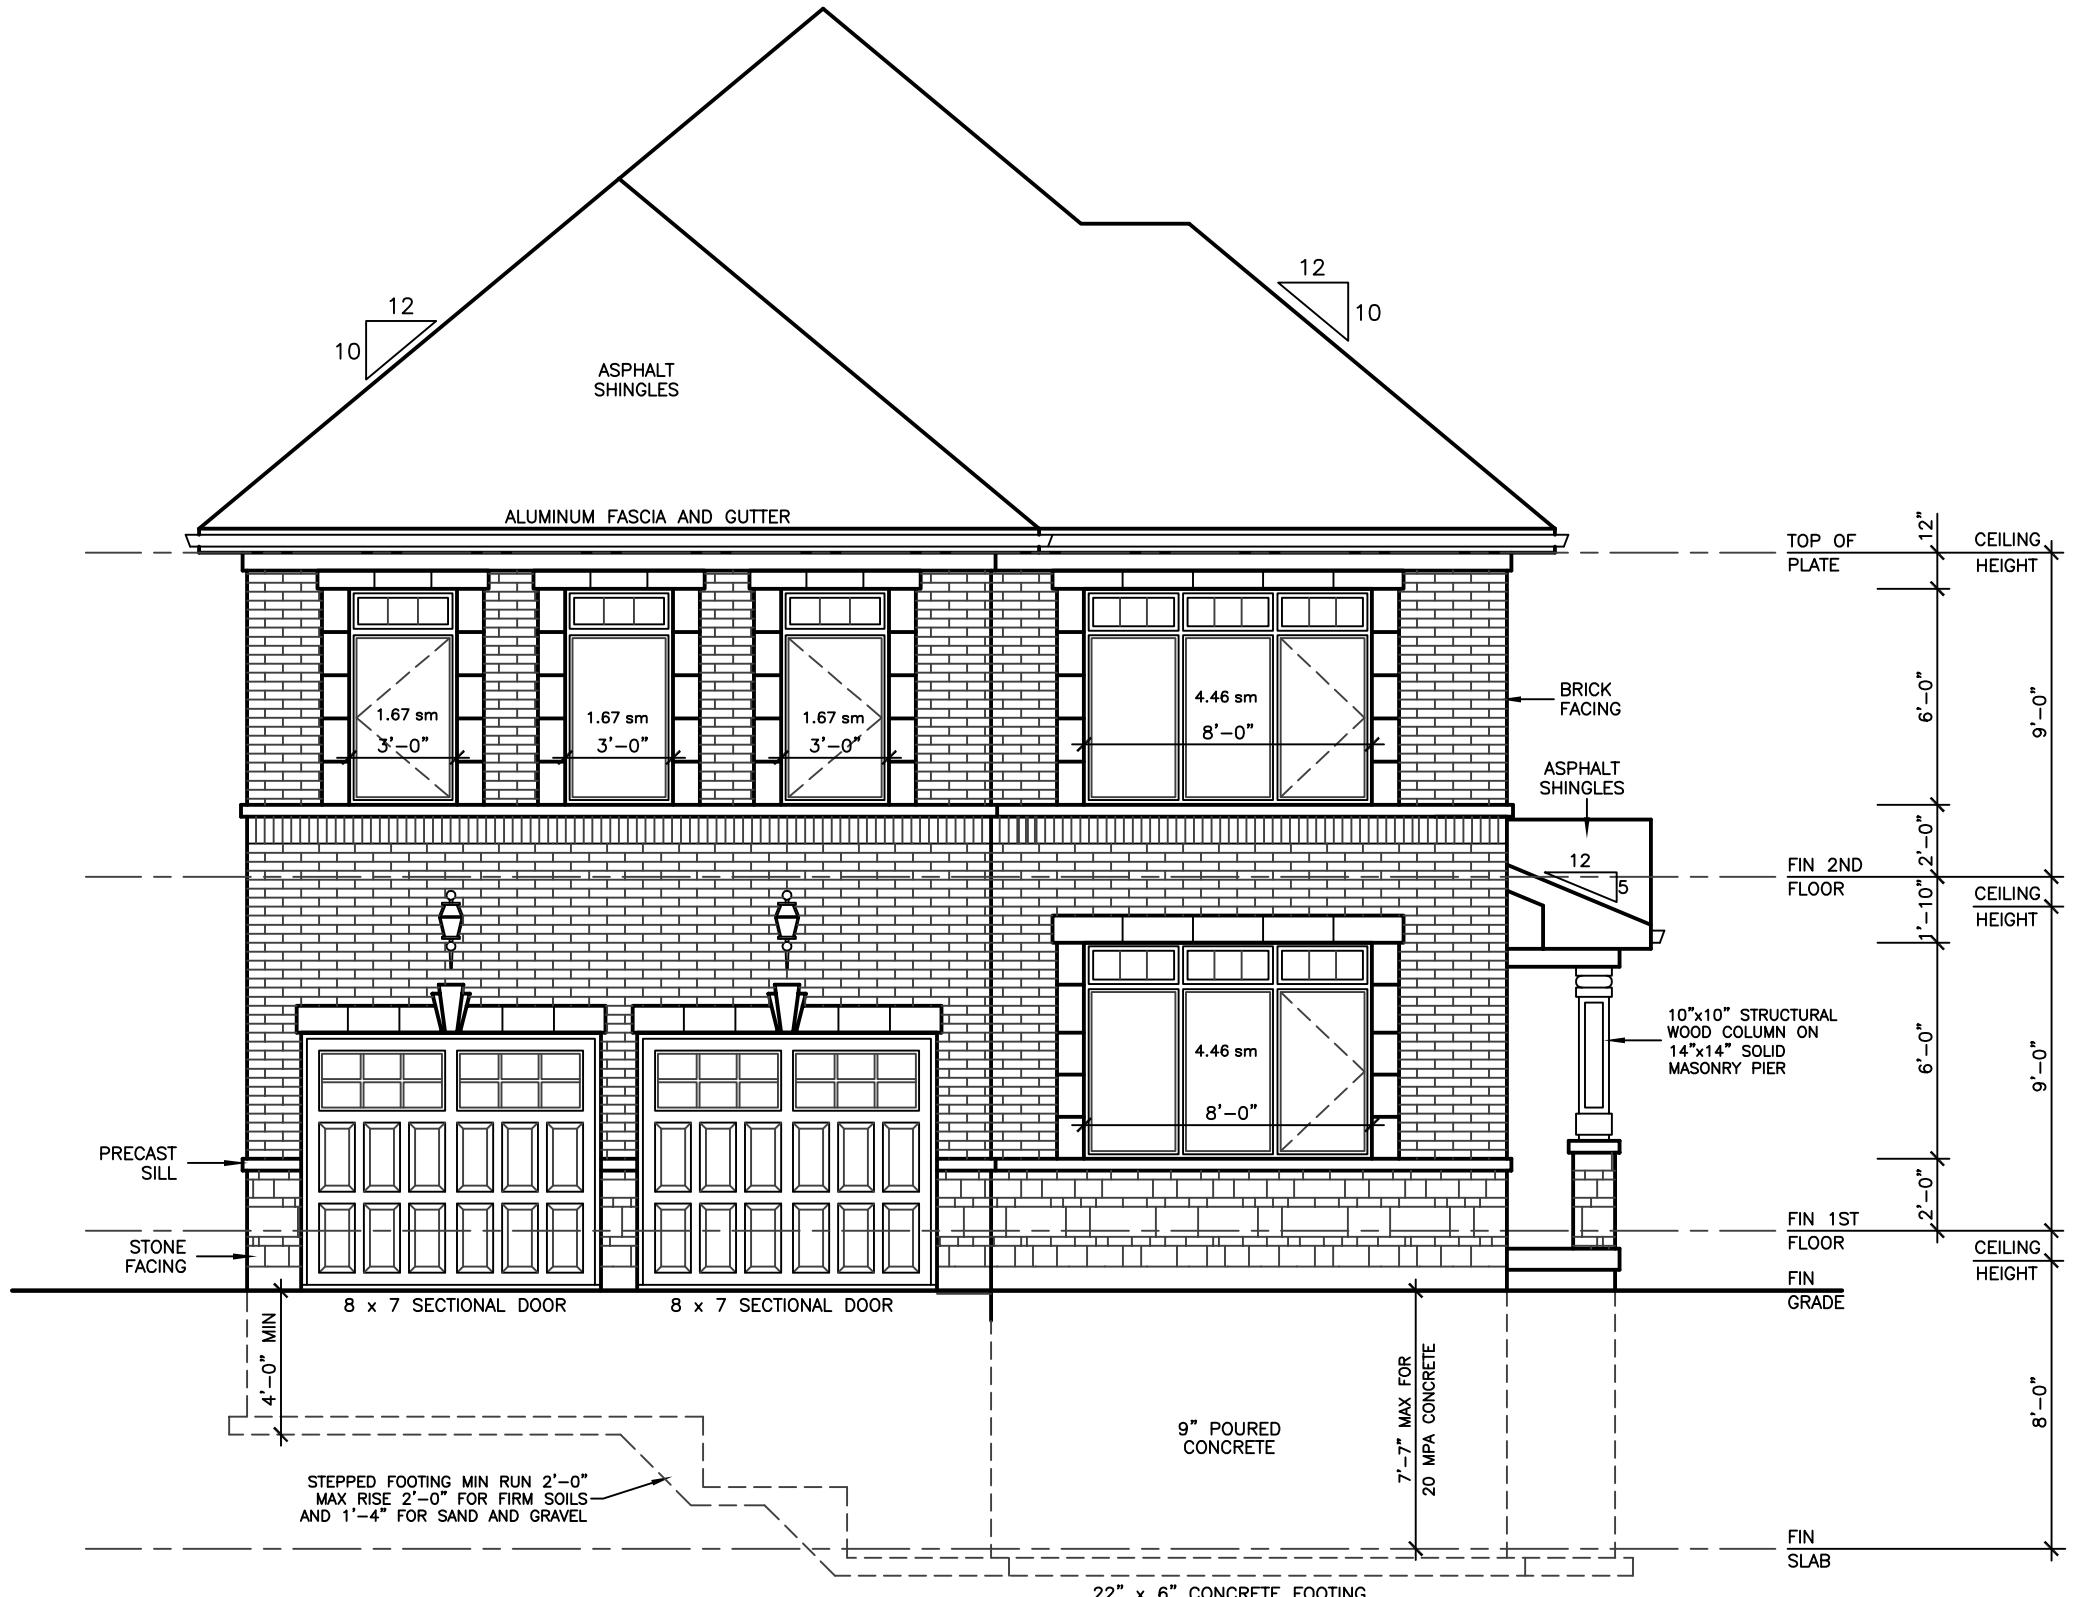

LEFT SIDE ELEVATION 'A'

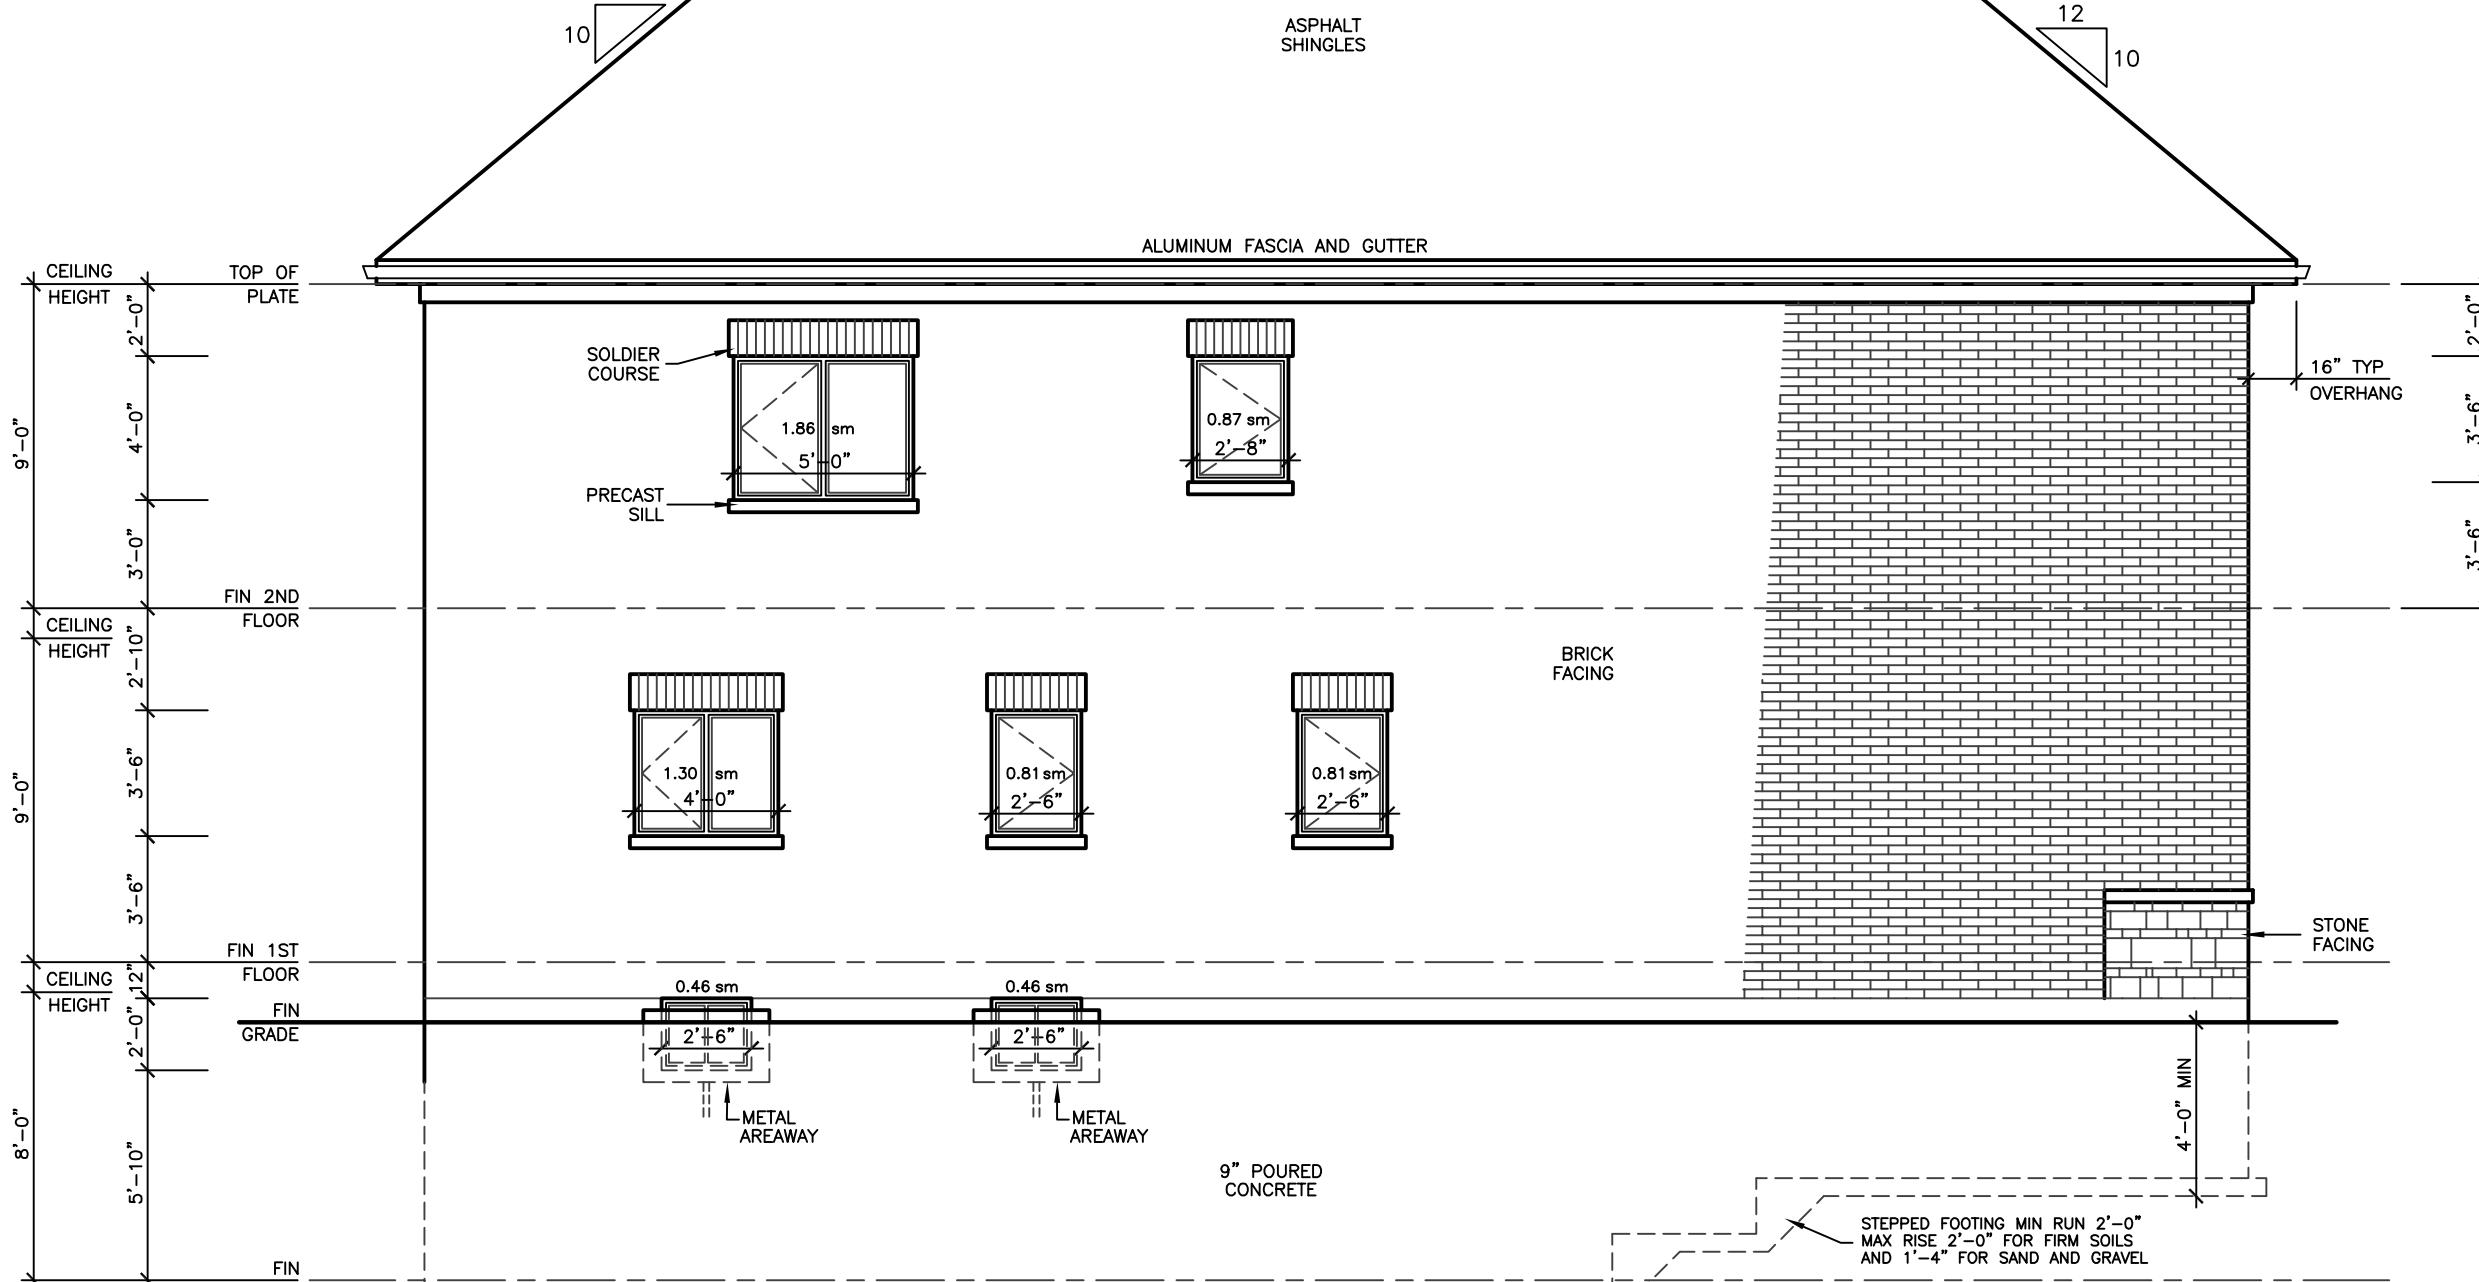

REAR ELEVATION 'A'

ALLOWABLE UNPROTECTED OPENINGS			
LIMITING DISTANCE	3.94 FT	1.20 M	
MAXIMUM PERCENTAGE	7.00 %		
TOTAL WALL AREA	1038.67 SF	96.50 SM	
ALLOWABLE OPENINGS	72.71 SF	6.75 SM	
ACTUAL OPENINGS	70.83 SF	6.58 SM	

A circular registration stamp with a double-lined border. The outer ring contains the text "REGISTERED PROFESSIONAL ENGINEER" at the top and "PROVINCE OF ONTARIO" at the bottom. The inner circle contains "L. KALISHENKO" in the center, with "19 APR 2024" written below it.

UMED ROOF TRUSS BEARING
THE EXRERIOR WALLS ONLY
DESIGN OF ENTIRE STRUCTURE
ULD BE REVIEWED TO ACCOMODATE
AL ROOF TRUSS LAYOUT

KING EAST ESTATES



ALL DRAWINGS & SPECIFICATIONS ARE THE PROPERTY OF THE ARCHITECT AND CANNOT BE USED OR REPRODUCED WITHOUT HIS APPROVAL.

THE CONTRACTORS SHALL CHECK AND VERIFY ALL DIMENSIONS ON THE SITE AND REPORT ANY DISCREPANCIES TO THE ARCHITECT.

ARCHITECTURAL DESIGN INC.

**56 PENNSYLVANIA AVE.
UNIT 1
CONCORD, ONT. L4K 3V9
TEL 905 660-9393
FAX 905 660-9419**

MODEL 2890

PROJECT
PROPOSED
TWO STOREY DWELLING


FOR: KING EAST DEVELOPMENTS INC.
AT: RICHMOND HILL

DRAWING		
REAR AND LEFT SIDE ELEVATIONS 'A'		
DATE	MAY '24	PROJECT NO
RAWN	E.B.	20-23
HECKED		DRAWING NO
CALE	3/16"=1'-0"	A-13

REVISIONS	
#	DATE



ASSUMED ROOF TRUSS BEARING
ON THE EXTERIOR WALLS ONLY
THE DESIGN OF ENTIRE STRUCTURE
SHOULD BE REVIEWED TO ACCOMMODATE
FINAL ROOF TRUSS LAYOUT

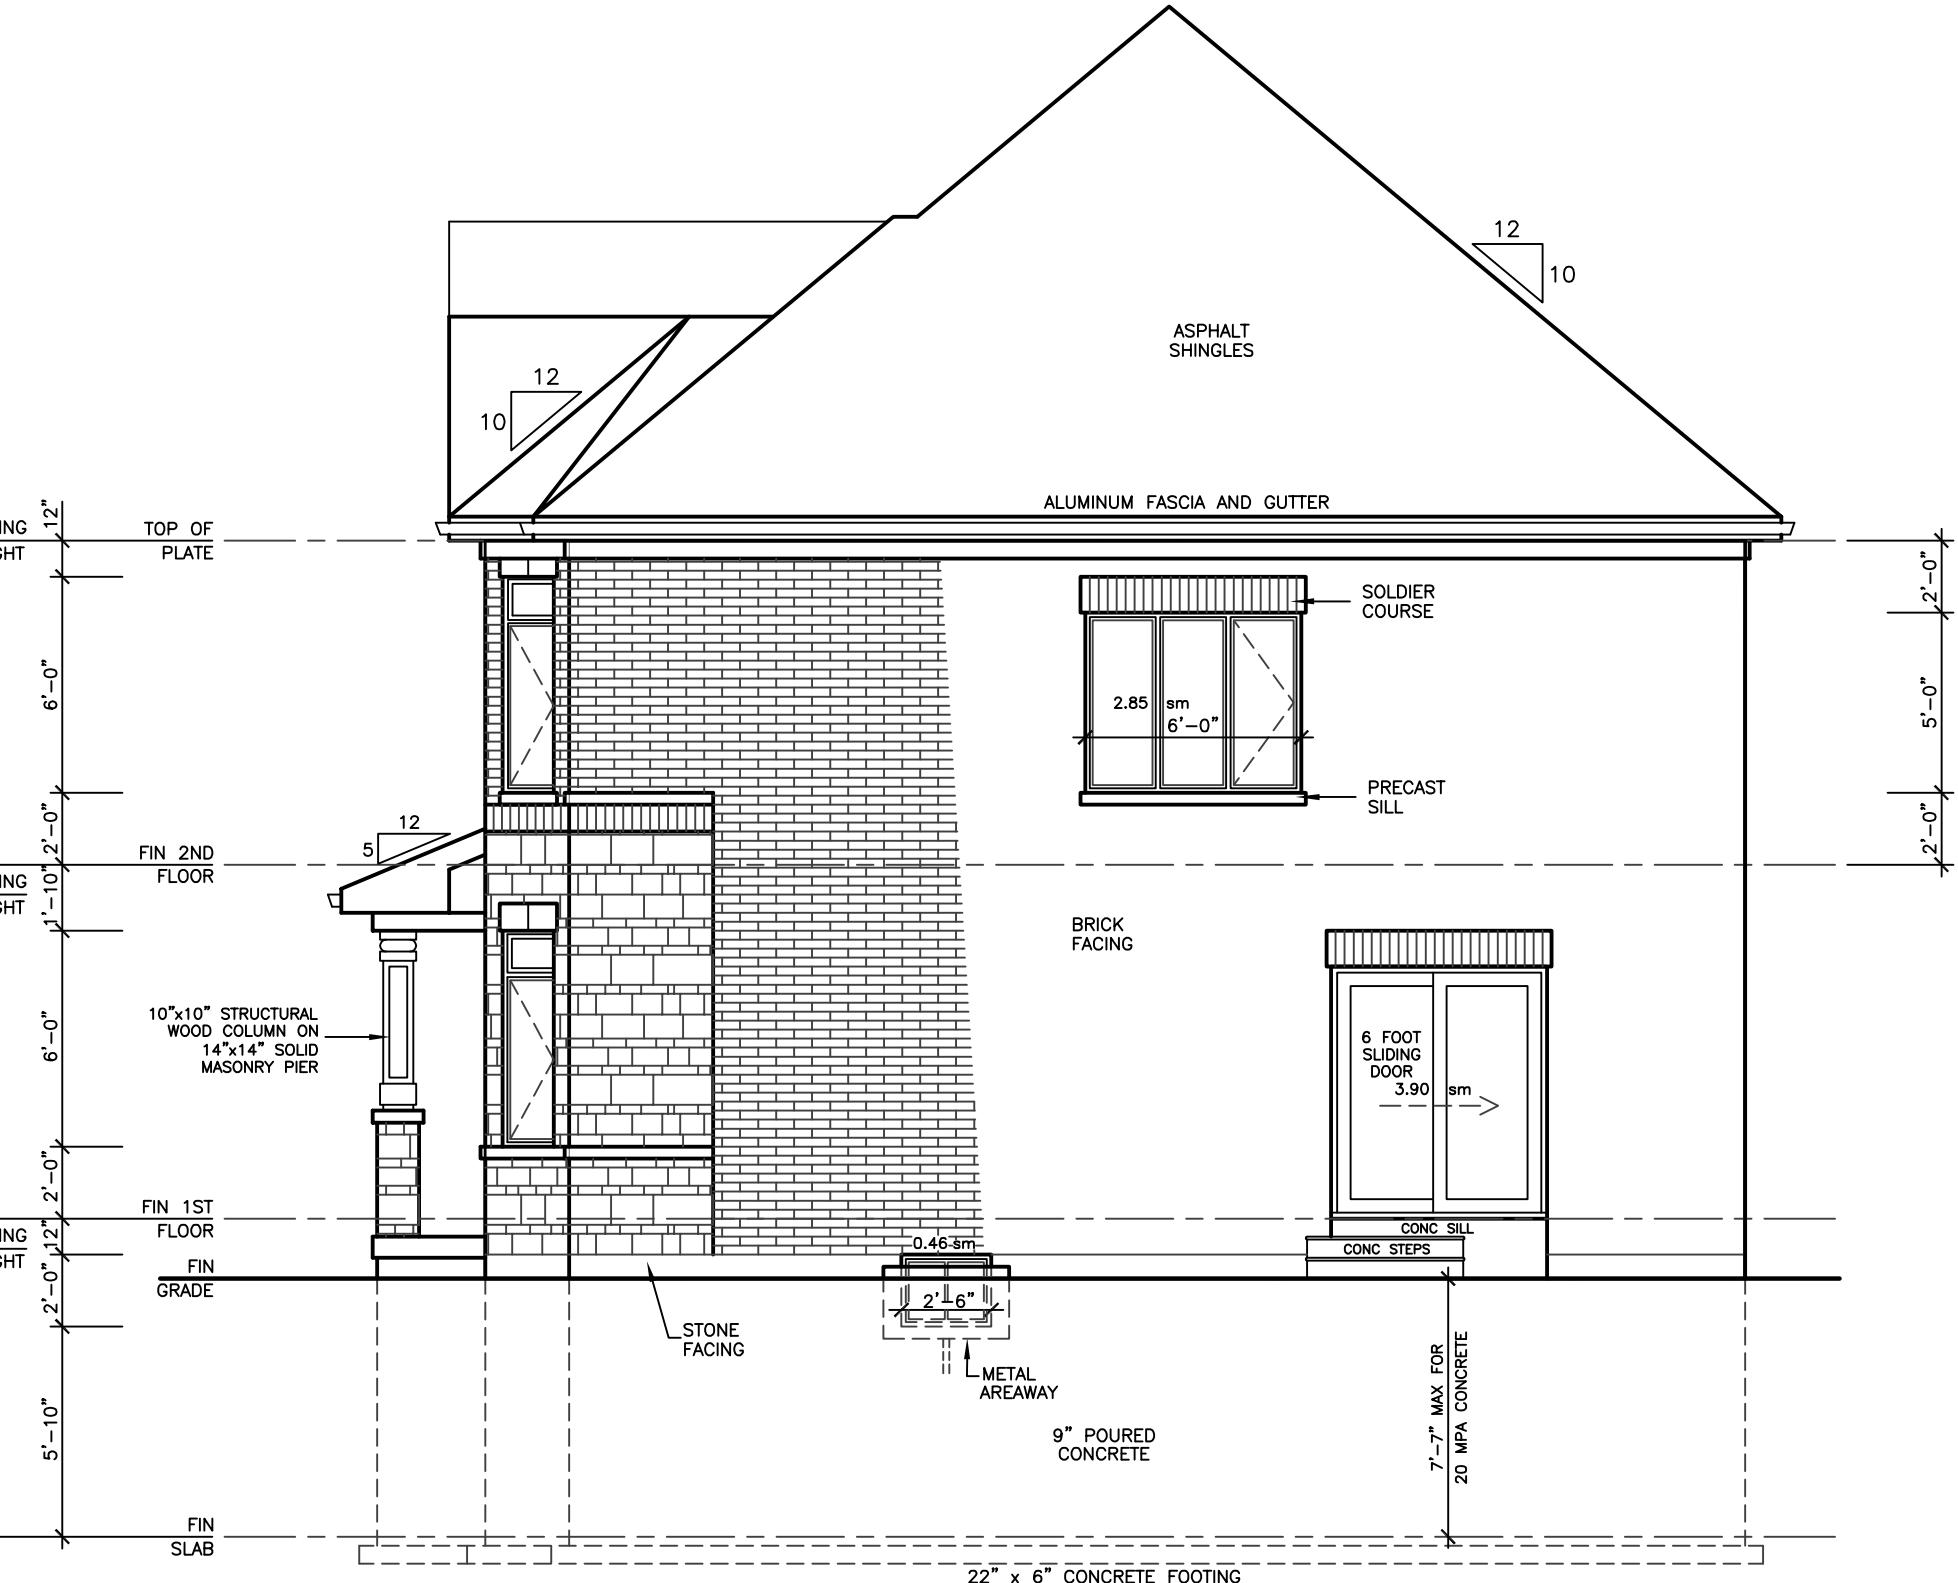

RIGHT SIDE ELEVATION 'B'

KING EAST
ESTATES




ALL DRAWINGS & SPECIFICATIONS ARE THE PROPERTY
OF THE ARCHITECT AND CANNOT BE USED OR
REPRODUCED WITHOUT HIS APPROVAL.

THE CONTRACTORS SHALL CHECK AND VERIFY ALL
DIMENSIONS ON THE SITE AND REPORT ANY
DISCREPANCIES TO THE ARCHITECT.

DRAWINGS MUST NOT BE SCALED.


ARCHITECTURAL
DESIGN INC.

56 PENNSYLVANIA AVE.
UNIT 1
CONCORD, ONT. L4K 3V9
TEL 905 660-9393
FAX 905 660-9419

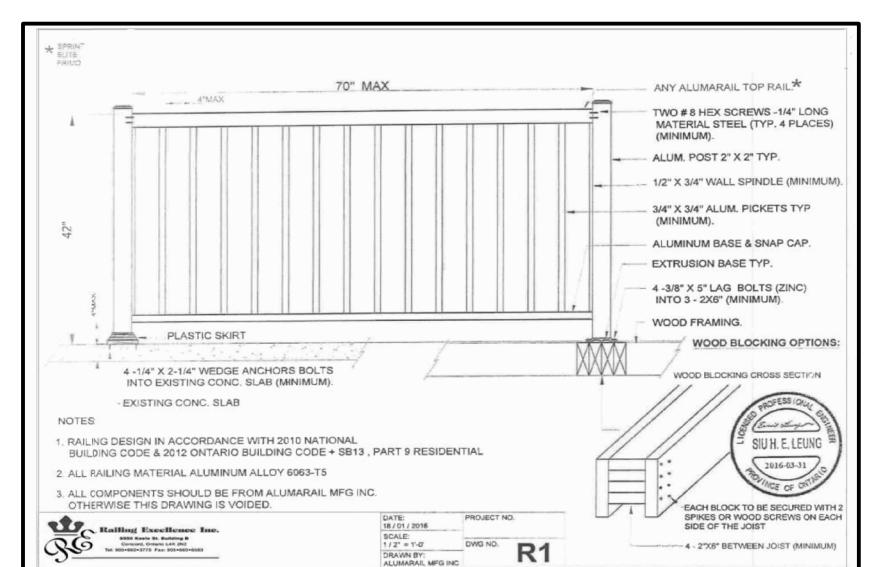

MODEL 2890

PROJECT
PROPOSED
TWO STOREY DWELLING
FOR: KING EAST DEVELOPMENTS INC.
AT: RICHMOND HILL

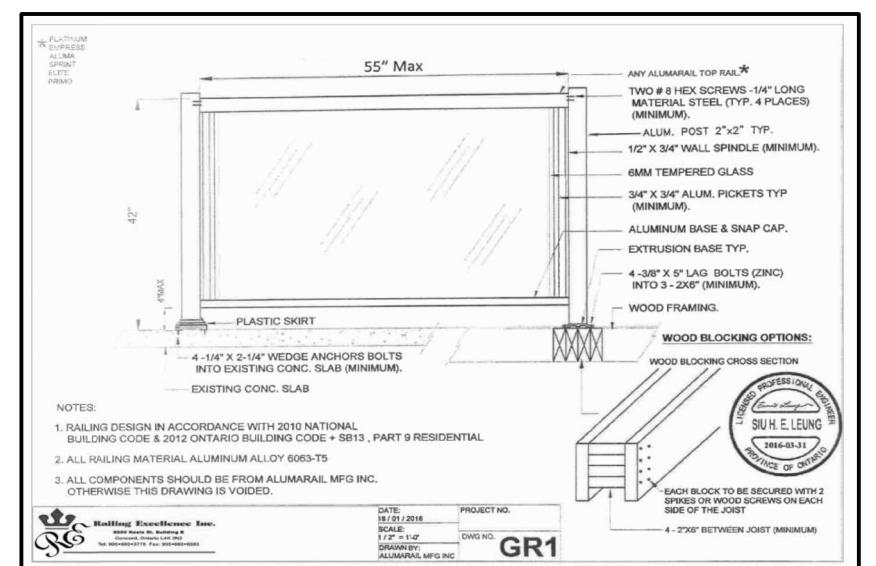

DRAWING
FRONT AND RIGHT
SIDE ELEVATIONS 'B'
DATE MAY '24 PROJECT NO 20-23
DRAWN E.B.
CHECKED
SCALE 3/16"=1'-0"
DRAWING NO A-14



FRONT ELEVATION B

FINISHED GRADE'S PROFILE LINE IS GENERIC
AND DOES NOT REFLECT EXACT ELEVATION.
TYPES OF GLASS AND PROTECTION OF GLASS
SHALL BE IN ACCORDANCE WITH
OBC 9.8.1.4.

RESISTANCE TO FORCED ENTRY SHALL BE
PROVIDED FOR DOORS IN ACCORDANCE WITH
OBC 9.7.5.2 AND FOR WINDOWS IN
ACCORDANCE WITH OBC 9.7.5.3.

GUARDS SHALL CONFORM TO OBC 9.8.8.1
AND SHALL RESIST LOADS IN CONFORMANCE
WITH TABLE 9.8.8.2.

GLASS IN GUARDS CONFORM TO OBC
SECTION 9.8.8.1.

THE MAXIMUM AGGREGATE AREA OF
UNPROTECTED OPENINGS IN AN EXPOSING
BUILDING FACE SHALL CONFORM TO
TABLE 9.10.14.4.

FOR BUILDINGS CONTAINING ONLY DWELLING
UNITS, CONSTRUCTION OF EXPOSING BUILDING
FACES SHALL CONFORM TO OBC 9.10.15.3.

EVERY WINDOW WELL SHALL BE DRAINED TO
THE FOOTING LEVEL OR OTHER SUITABLE
LOCATION. [OBC 9.14.6.3]

WHERE STEP FOOTINGS ARE USED, THE
VERTICAL RISE BETWEEN THE HORIZONTAL
PORTIONS SHALL NOT EXCEED 600 mm,
AND THE TOTAL DIAMETRAL DISTANCE
BETWEEN RISERS SHALL BE NOT LESS THAN 600 mm.
[OBC 9.15.3.9]

THE THICKNESS AND HEIGHT OF FOUNDATION
WALLS MADE OF UNINFORCED CONCRETE
BLOCKS OR SOLID CONCRETE AND SUBJECT
TO LATERAL EARTH PRESSURE SHALL
CONFORM TO TABLE 9.15.4.2.A. FOR WALLS
NOT EXCEEDING 2.5 m IN UNSUPPORTED
HEIGHT. [OBC 9.15.4.2]

EXTERIOR FOUNDATION WALLS SHALL EXTEND
NOT LESS THAN 150 mm ABOVE FINISHED
GROUND LEVEL. [OBC 9.15.4.6]

VENTING FOR ROOF SPACES SHALL CONFORM
TO OBC 9.19.1.2.

THE UNOBSTRUCTED ROOF VENT AREA SHALL
BE NOT LESS THAN 1,100 SF OF INSULATED
CEILING AREA WHERE THE ROOF SLOPE IS
LESS THAN 1 IN 6, OR IN ROOFS THAT ARE
CONSTRUCTED WITH ROOF JOISTS, THE
UNOBSTRUCTED VENT AREA SHALL BE NOT
LESS THAN 1/150 OF THE INSULATED
CEILING AREA. [OBC 9.19.1.2]

FLASHING SHALL BE INSTALLED IN MASONRY
AND MASONRY VENEER WALLS CONFORMING
WITH OBC 9.20.13.3.(1).

THROUGHWALL FLASHING SHALL BE PROVIDED
IN A MASONRY VENEER WALL SUCH THAT ANY
MOISTURE WHICH ACCUMULATES IN THE AIR
SPACE WILL BE DIRECTED TO THE EXTERIOR
OF THE BUILDING. [OBC 9.20.13.3.(2)]

WEPP HOLES THAT ARE SPACED NOT MORE
THAN 800 mm APART SHALL BE PROVIDED
AT THE BOTTOM OF CAVITIES OR AIR SPACES
IN MASONRY VENEER WALLS AND ABOVE
LINTELS OVER WINDOW AND DOOR OPENINGS.
[OBC 9.20.13.8]

A CHIMNEY FLUE SHALL EXTEND NOT LESS
THAN 900 mm ABOVE THE HIGHEST POINT
AT WHICH THE CHIMNEY COMES IN CONTACT
WITH THE ROOF, AND SHALL NOT BE
LESS THAN 600 mm ABOVE THE HIGHEST
ROOF SURFACE OR STRUCTURE WITHIN 3 m
OF THE CHIMNEY. [OBC 9.21.4.4]

THE SLOPE OF ROOF SURFACES, ON WHICH
ROOF COVERINGS MAY BE APPLIED, SHALL
CONFORM TO OBC 9.26.3.1.

FLASHING SHALL BE INSTALLED AT ALL
INTERSECTIONS LISTED OBC 9.26.4.

WHERE SLOPING SURFACES OF SHINGLED
ROOFS INTERSECT TO FORM A VALLEY, THE
VALLEY SHALL BE FLASHED IN CONFORMANCE
WITH OBC 9.26.4.3.

AN EXTERIOR LIGHTING OUTLET WITH FIXTURE
CONTROLLED BY A WALL SWITCH LOCATED
WITHIN THE BUILDING SHALL BE PROVIDED
AT EVERY ENTRANCE TO BUILDINGS OF
RESIDENTIAL OCCUPANCY. [OBC 9.34.2.1]

REFER TO LOT GRADING / SITE PLAN
FOR REQUIRED NUMBER OF EXTERIOR STEPS,
DOOR BETWEEN GARAGE AND DWELLING,
DECK OR BASEMENT CONDITION.

EVERY SURFACE TO WHICH ACCESS IS
PROVIDED, FOR OTHER THAN MAINTENANCE
PURPOSES, SHALL BE PROVIDED WITH A
GUARD, IN CONFORMANCE WITH OBC 9.8.8,
ON EACH SIDE THAT IS NOT PROTECTED BY
A WALL FOR THE LENGTH WHERE,

(A) THERE IS A DIFFERENCE IN ELEVATION
OF MORE THAN 12 IN. OR
(B) THE ADJACENT SURFACE WITHIN 1.2 m
OF THE WALKING SURFACE HAS A SLOPE
OF MORE THAN 1 IN 2. [OBC 9.8.8.1.(1)]

FOR BUILDINGS CONTAINING ONLY DWELLING
UNITS, EACH EXPOSING BUILDING FACE AND
ANY EXTERIOR WALL LOCATED ABOVE AN
EXPOSING BUILDING FACE THAT ENCLOSES
AN ATTIC OR ROOF SPACE, SHALL

(A) HAVE A FIRE RESISTANCE RATING OF NOT
LESS THAN 45 MIN. WHERE THE LIMITING
DISTANCE IS LESS THAN 1.2 m, BUT NOT
LESS THAN 0.3 m, OR

(B) HAVE A FIRE RESISTANCE RATING OF NOT
LESS THAN 45 MIN. AND ALSO BE CLAD
WITH NONCOMBUSTIBLE MATERIAL WHERE
THE LIMITING DISTANCE IS LESS THAN
0.6 m. [OBC 9.10.15.5.(2)]

FLASHING SHALL BE INSTALLED IN MASONRY
AND MASONRY VENEER WALLS CONFORMING
WITH OBC 9.20.13.3.(1).

THROUGHWALL FLASHING SHALL BE PROVIDED
IN A MASONRY VENEER WALL SUCH THAT ANY
MOISTURE WHICH ACCUMULATES IN THE AIR
SPACE WILL BE DIRECTED TO THE EXTERIOR
OF THE BUILDING. [OBC 9.20.13.3.(2)]

REVISIONS	
#	DATE

LEONARD KALISHENKO
AND ASSOCIATES LIMITED
STRUCTURAL ENGINEERS
FOR STRUCTURAL
DESIGN ONLY

REGISTERED PROFESSIONAL ENGG. ING.
KALISHENKO
PROVINCE OF ONTARIO
19 APR 2024

ASSUMED ROOF TRUSS BEARING
ON THE EXTERIOR WALLS ONLY
THE DESIGN OF ENTIRE STRUCTURE
SHOULD BE REVIEWED TO ACCOMMODATE
FINAL ROOF TRUSS LAYOUT

KING EAST
ESTATES



ALL DRAWINGS & SPECIFICATIONS ARE THE PROPERTY
OF THE ARCHITECT AND CANNOT BE USED OR
REPRODUCED WITHOUT HIS APPROVAL.

THE CONTRACTORS SHALL CHECK AND VERIFY ALL
DIMENSIONS ON THE SITE, AND REPORT ANY
DISCREPANCIES TO THE ARCHITECT.

DRAWINGS MUST NOT BE SCALED.





ARCHITECTURAL
DESIGN INC.

56 PENNSYLVANIA AVE.
UNIT 1
CONCORD, ONT. L4K 3V9
TEL 905 660-9393
FAX 905 660-9419

MODEL 2890


PROJECT
PROPOSED
TWO STOREY DWELLING
FOR: KING EAST DEVELOPMENTS INC.
AT: RICHMOND HILL

DRAWING
REAR AND LEFT
SIDE ELEVATIONS 'B'
DATE MAY '24 PROJECT NO 20-23
DRAWN E.B.
CHECKED
SCALE 3/16"=1'-0"
DRAWING NO A-15

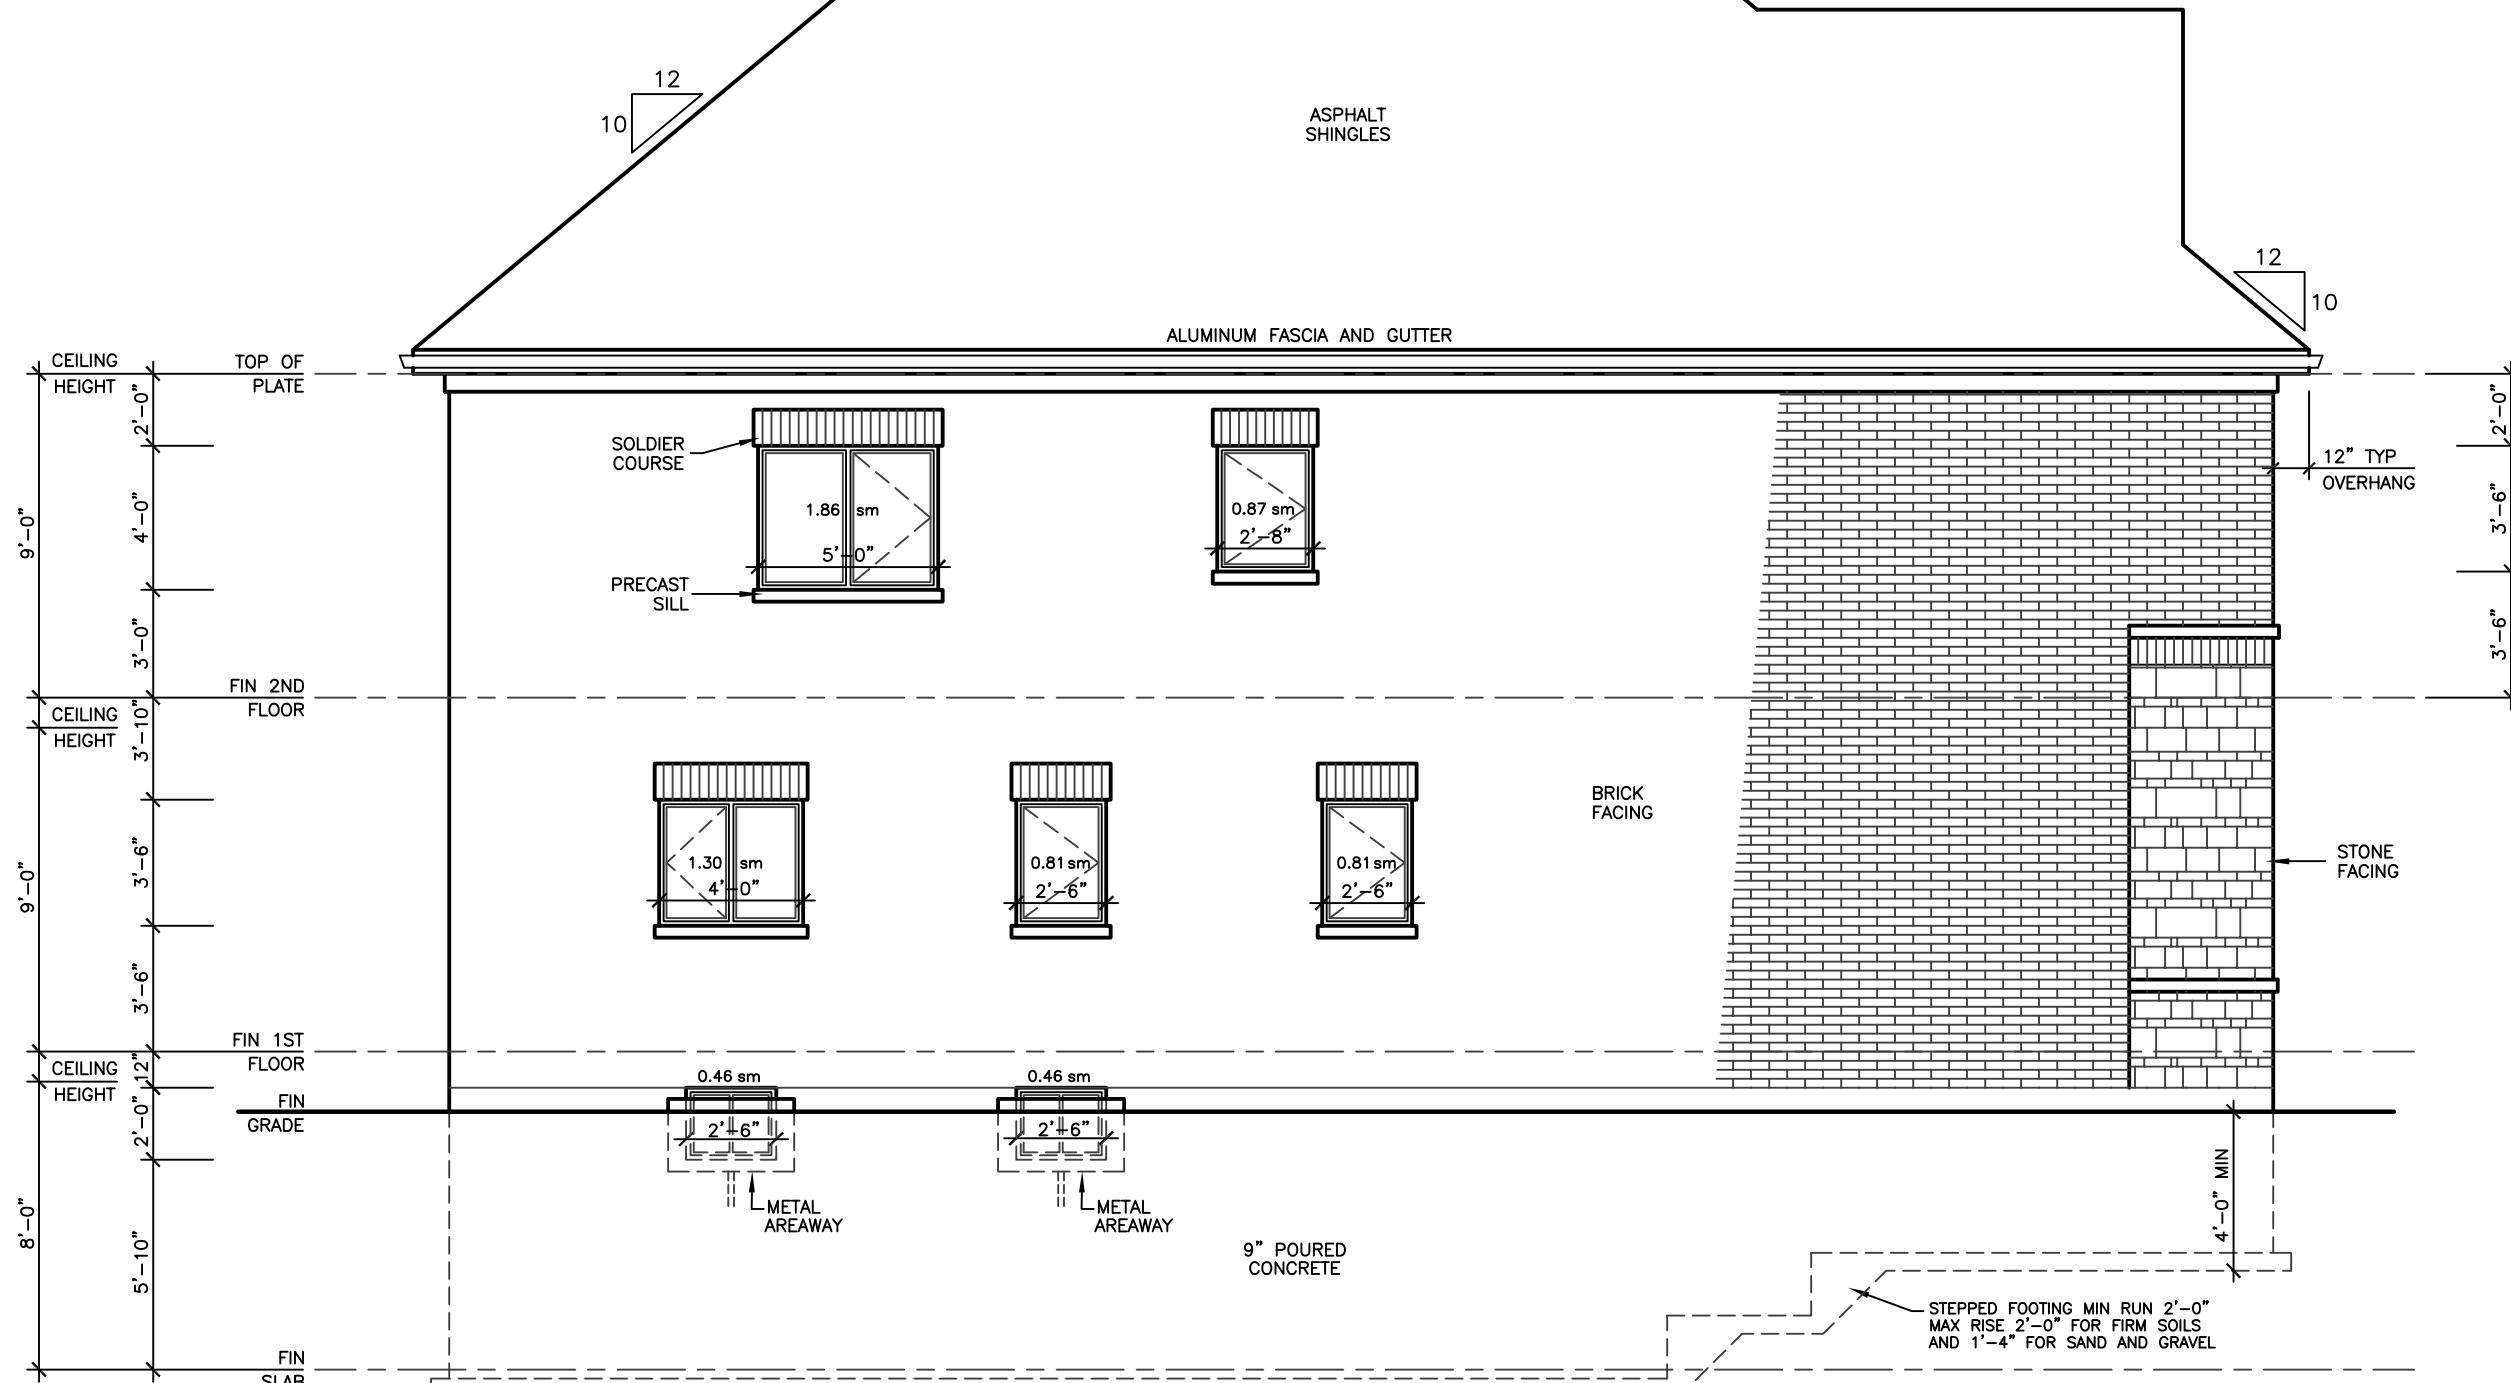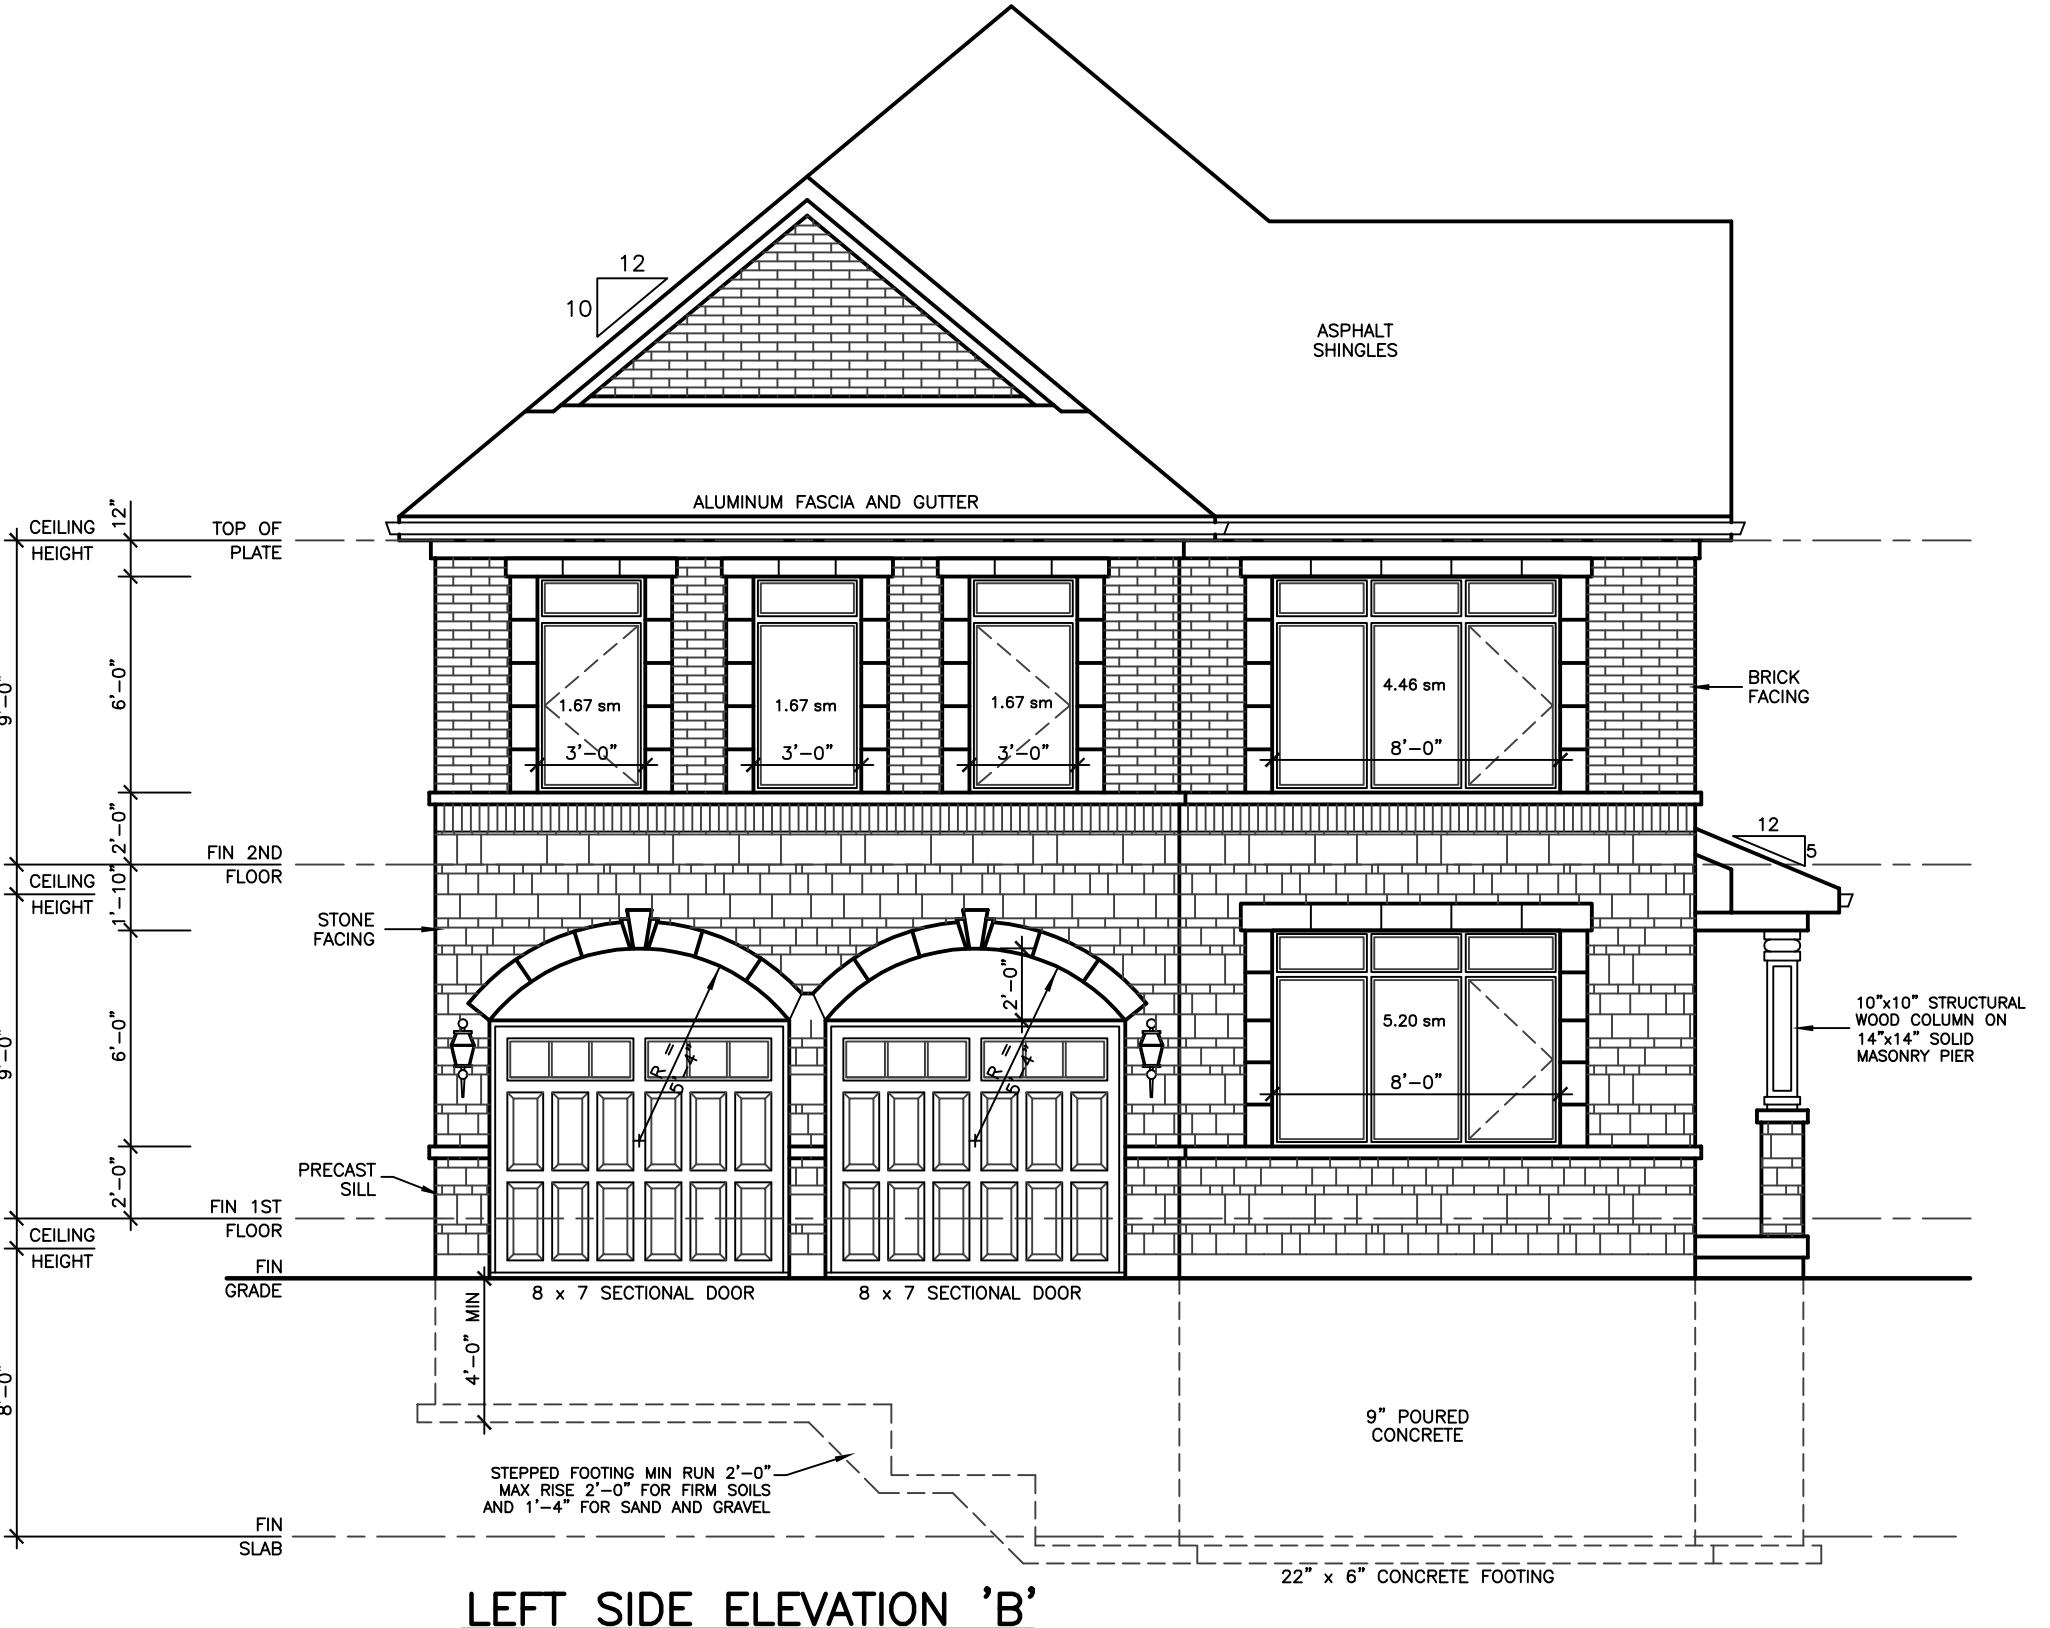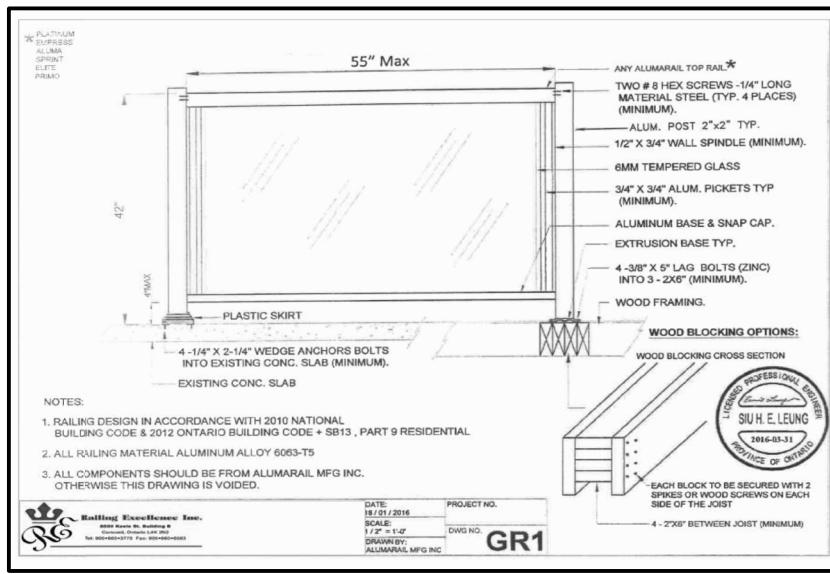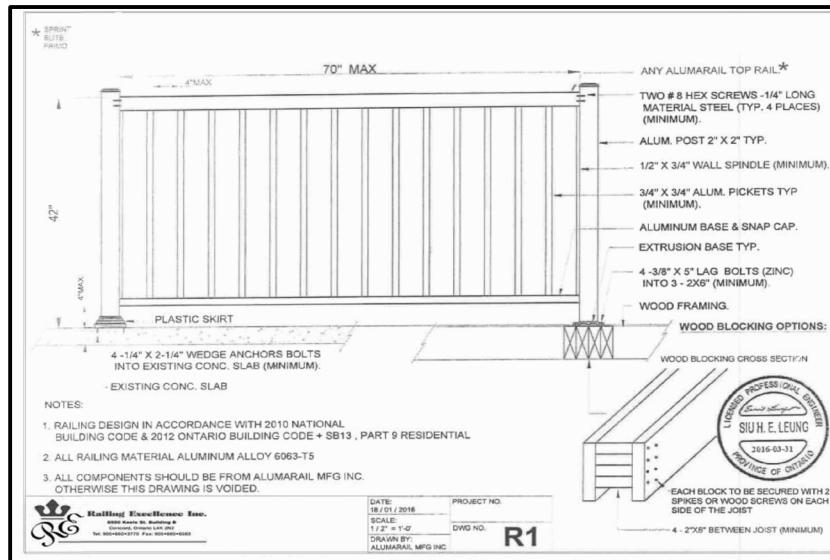


ALLOWABLE UNPROTECTED OPENINGS		
LIMITING DISTANCE	3.94 FT	1.20 M
MAXIMUM PERCENTAGE	7.00 %	
TOTAL WALL AREA	1038.67 SF	96.50 SM
ALLOWABLE OPENINGS	72.71 SF	6.75 SM
ACTUAL OPENINGS	70.83 SF	6.58 SM

REVISIONS	
#	DATE

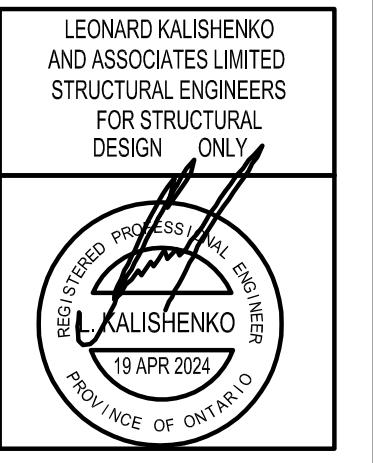

ASSUMED ROOF TRUSS BEARING
ON THE EXTERIOR WALLS ONLY
THE DESIGN OF ENTIRE STRUCTURE
SHOULD BE REVIEWED TO ACCOMMODATE
FINAL ROOF TRUSS LAYOUT

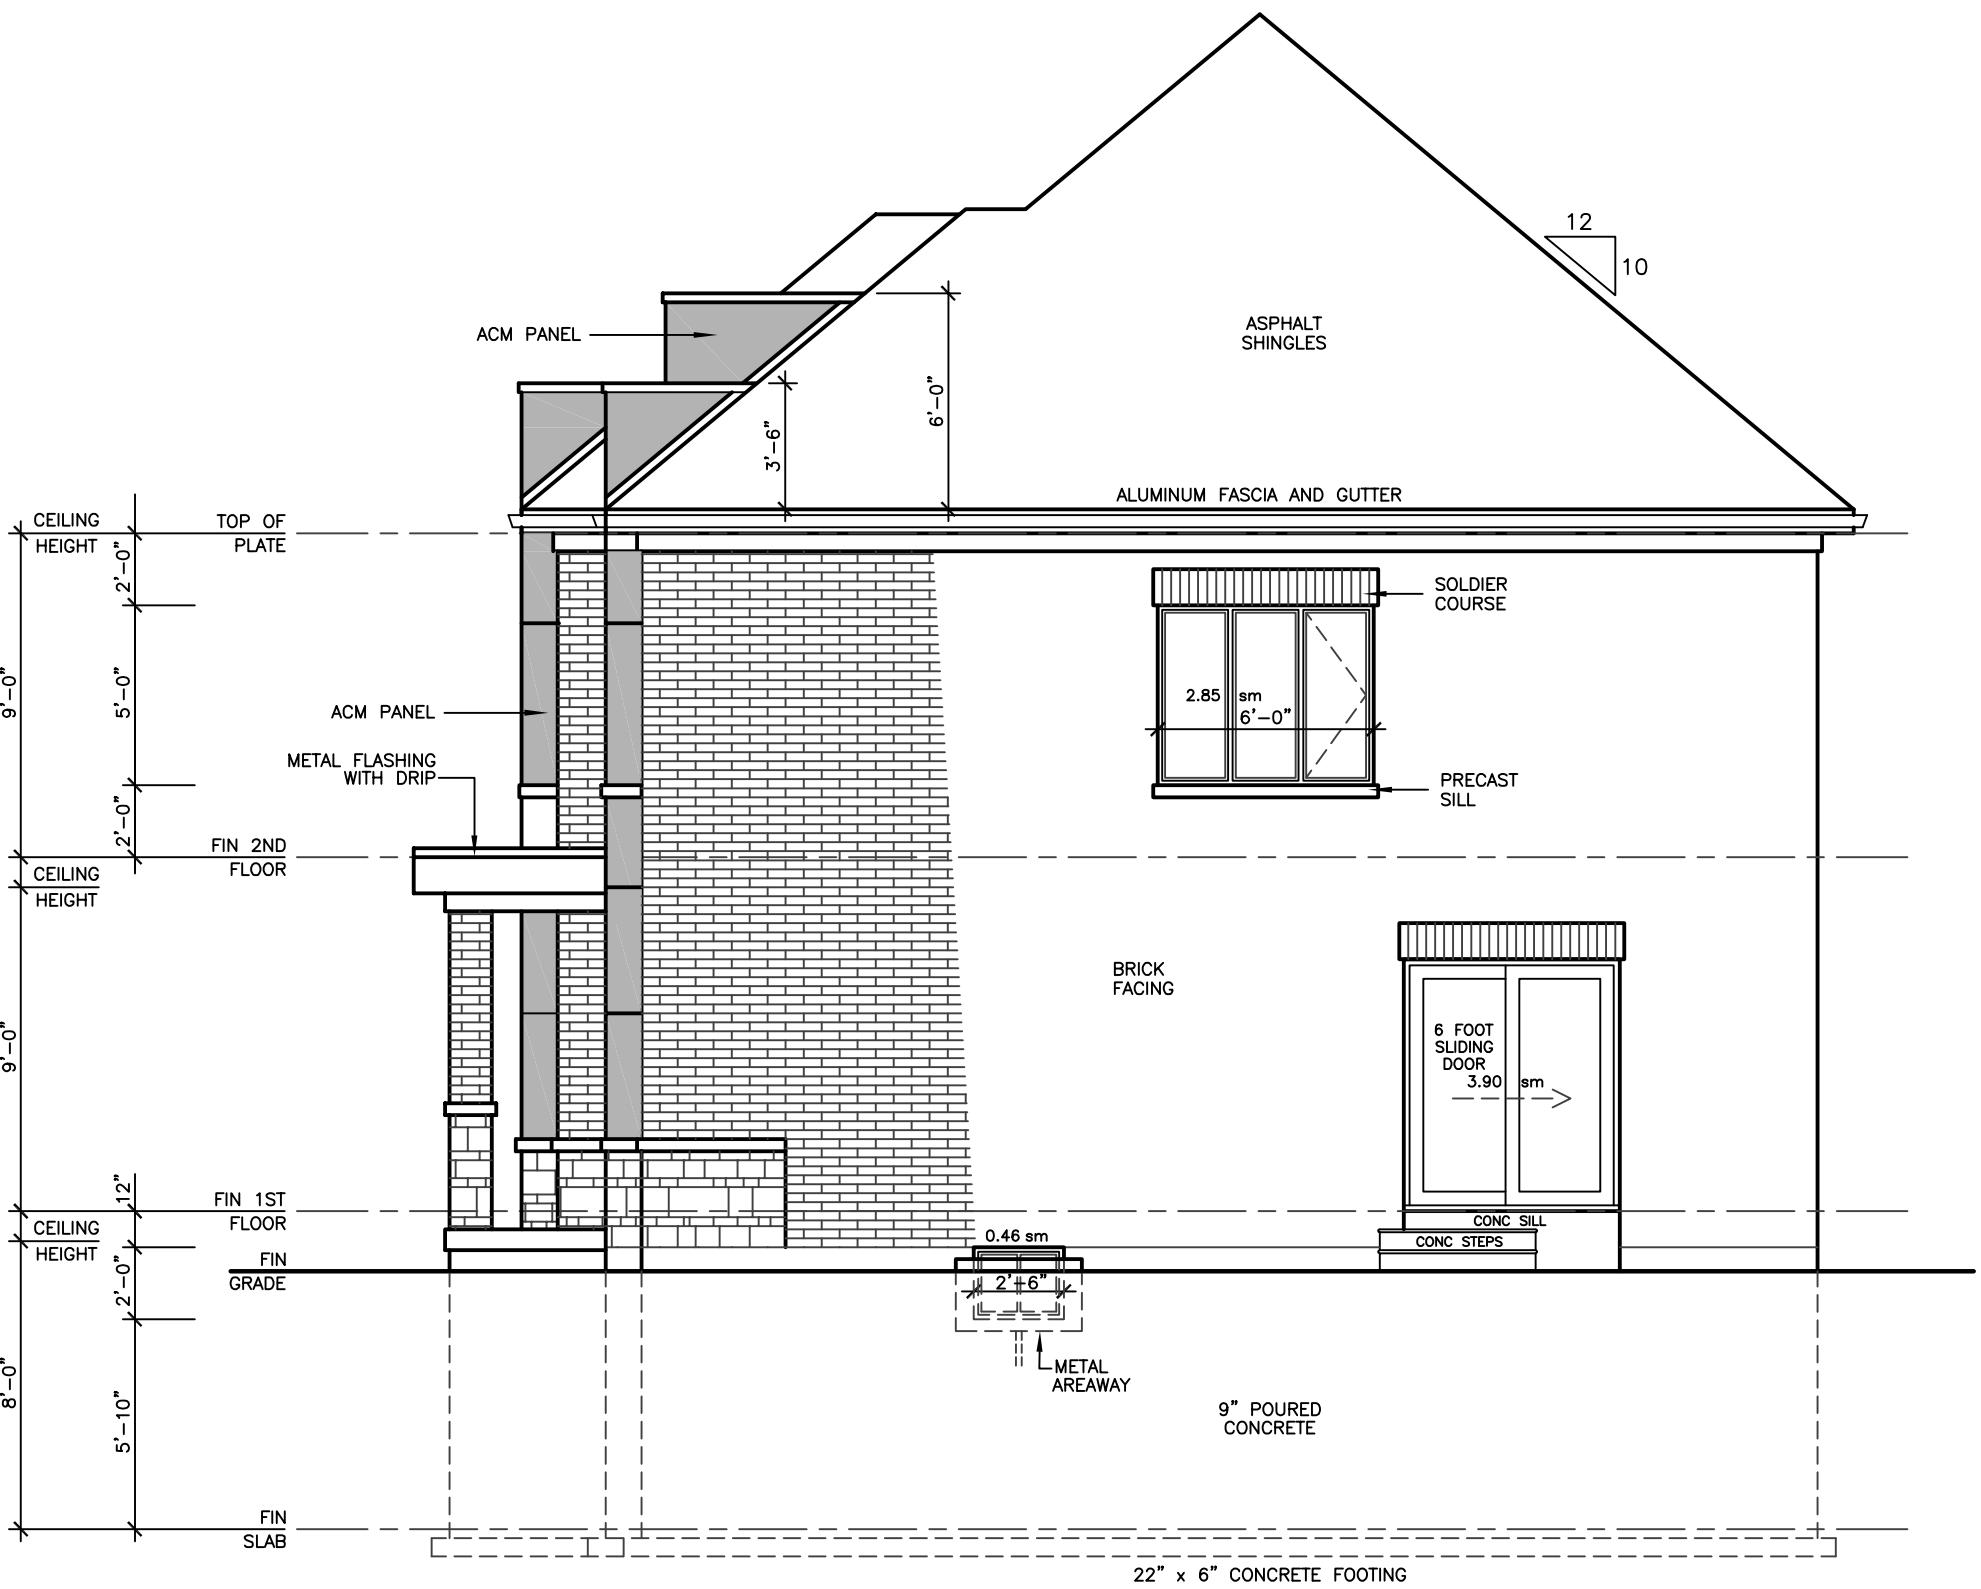

KING EAST
ESTATES



ALL DRAWINGS & SPECIFICATIONS ARE THE PROPERTY
OF THE ARCHITECT AND MAY NOT BE USED OR
REPRODUCED WITHOUT HIS APPROVAL.

THE CONTRACTORS SHALL CHECK AND VERIFY ALL
DIMENSIONS ON THE SITE AND REPORT ANY
DISCREPANCIES TO THE ARCHITECT.

DRAWINGS MUST NOT BE SCALED.


ARCHITECTURAL
DESIGN INC.

56 PENNSYLVANIA AVE.
UNIT 1
CONCORD, ONT. L4K 3V9
TEL 905 660-9393
FAX 905 660-9419

MODEL 2890

PROJECT
PROPOSED
TWO STOREY DWELLING
FOR: KING EAST DEVELOPMENTS INC.
AT: RICHMOND HILL


DRAWING
FRONT AND RIGHT
SIDE ELEVATIONS 'C'
DATE MAY '24 PROJECT NO
20-23
DRAWN E.B.
CHECKED
SCALE 3/16"=1'-0"
A-16

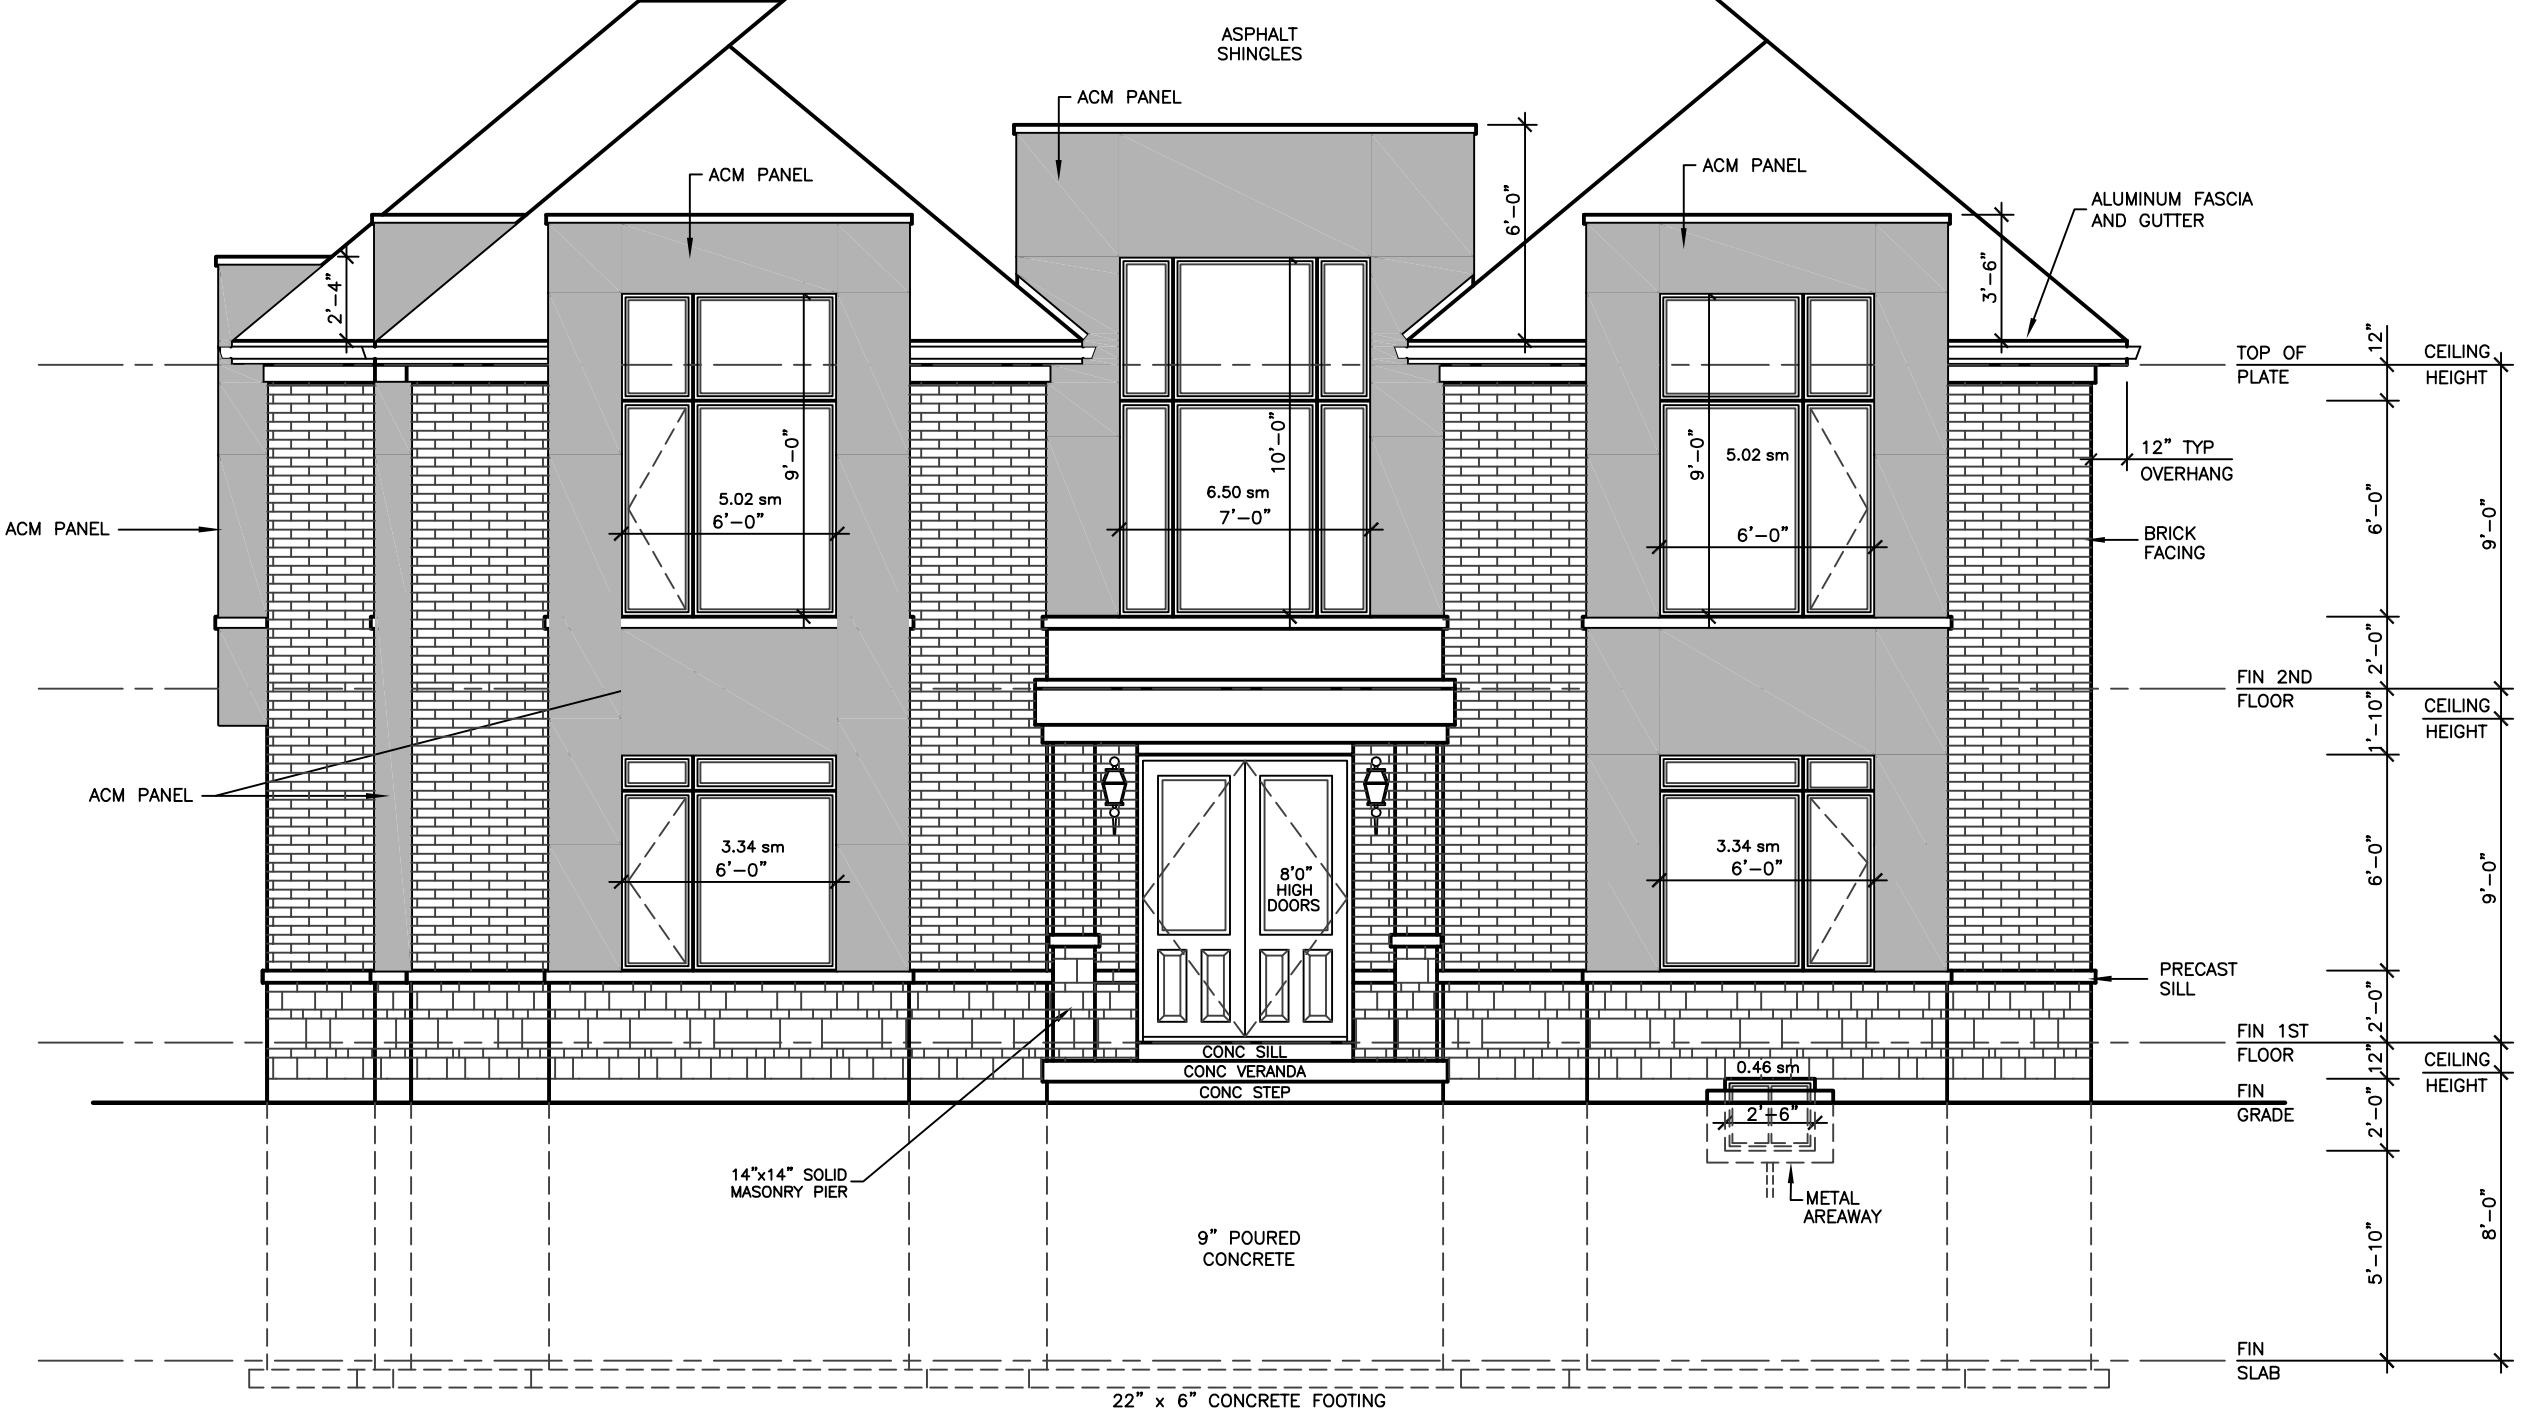

WALLS AND WINDOWS AREA			
ELEVATION	WALL AREA	WINDOWS AREA	%
FRONT ELEVATION	106.78 SM	23.68 SM	
RIGHT SIDE ELEVATION	65.56 SM	7.15 SM	
LEFT SIDE ELEVATION	71.50 SM	12.15 SM	
REAR ELEVATION	98.50 SM	6.58 SM	
TOTAL AREA	342.85 SM	49.91 SM	14.56



REVISIONS	
#	DATE

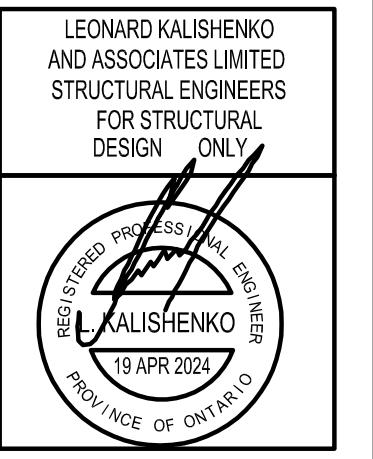

ASSUMED ROOF TRUSS BEARING
ON THE EXTERIOR WALLS ONLY
THE DESIGN OF ENTIRE STRUCTURE
SHOULD BE REVIEWED TO ACCOMMODATE
FINAL ROOF TRUSS LAYOUT

KING EAST ESTATES



ALL DRAWINGS & SPECIFICATIONS ARE THE PROPERTY
OF THE ARCHITECT AND CANNOT BE USED OR
REPRODUCED WITHOUT HIS APPROVAL.

THE CONTRACTORS SHALL CHECK AND VERIFY ALL
DIMENSIONS ON THE SITE AND REPORT ANY
DISCREPANCIES TO THE ARCHITECT.

DRAWINGS MUST NOT BE SCALED.


ARCHITECTURAL DESIGN INC.

56 PENNSYLVANIA AVE.
UNIT 1
CONCORD, ONT. L4K 3V9
TEL 905 660-9393
FAX 905 660-9419

MODEL 2890

PROJECT
PROPOSED
TWO STOREY DWELLING
FOR: KING EAST DEVELOPMENTS INC.
AT: RICHMOND HILL

DRAWING
REAR AND LEFT
SIDE ELEVATIONS 'C'
DATE MAY '24 PROJECT NO 20-23
DRAWN E.B.
CHECKED
SCALE 3/16"=1'-0"
A-17

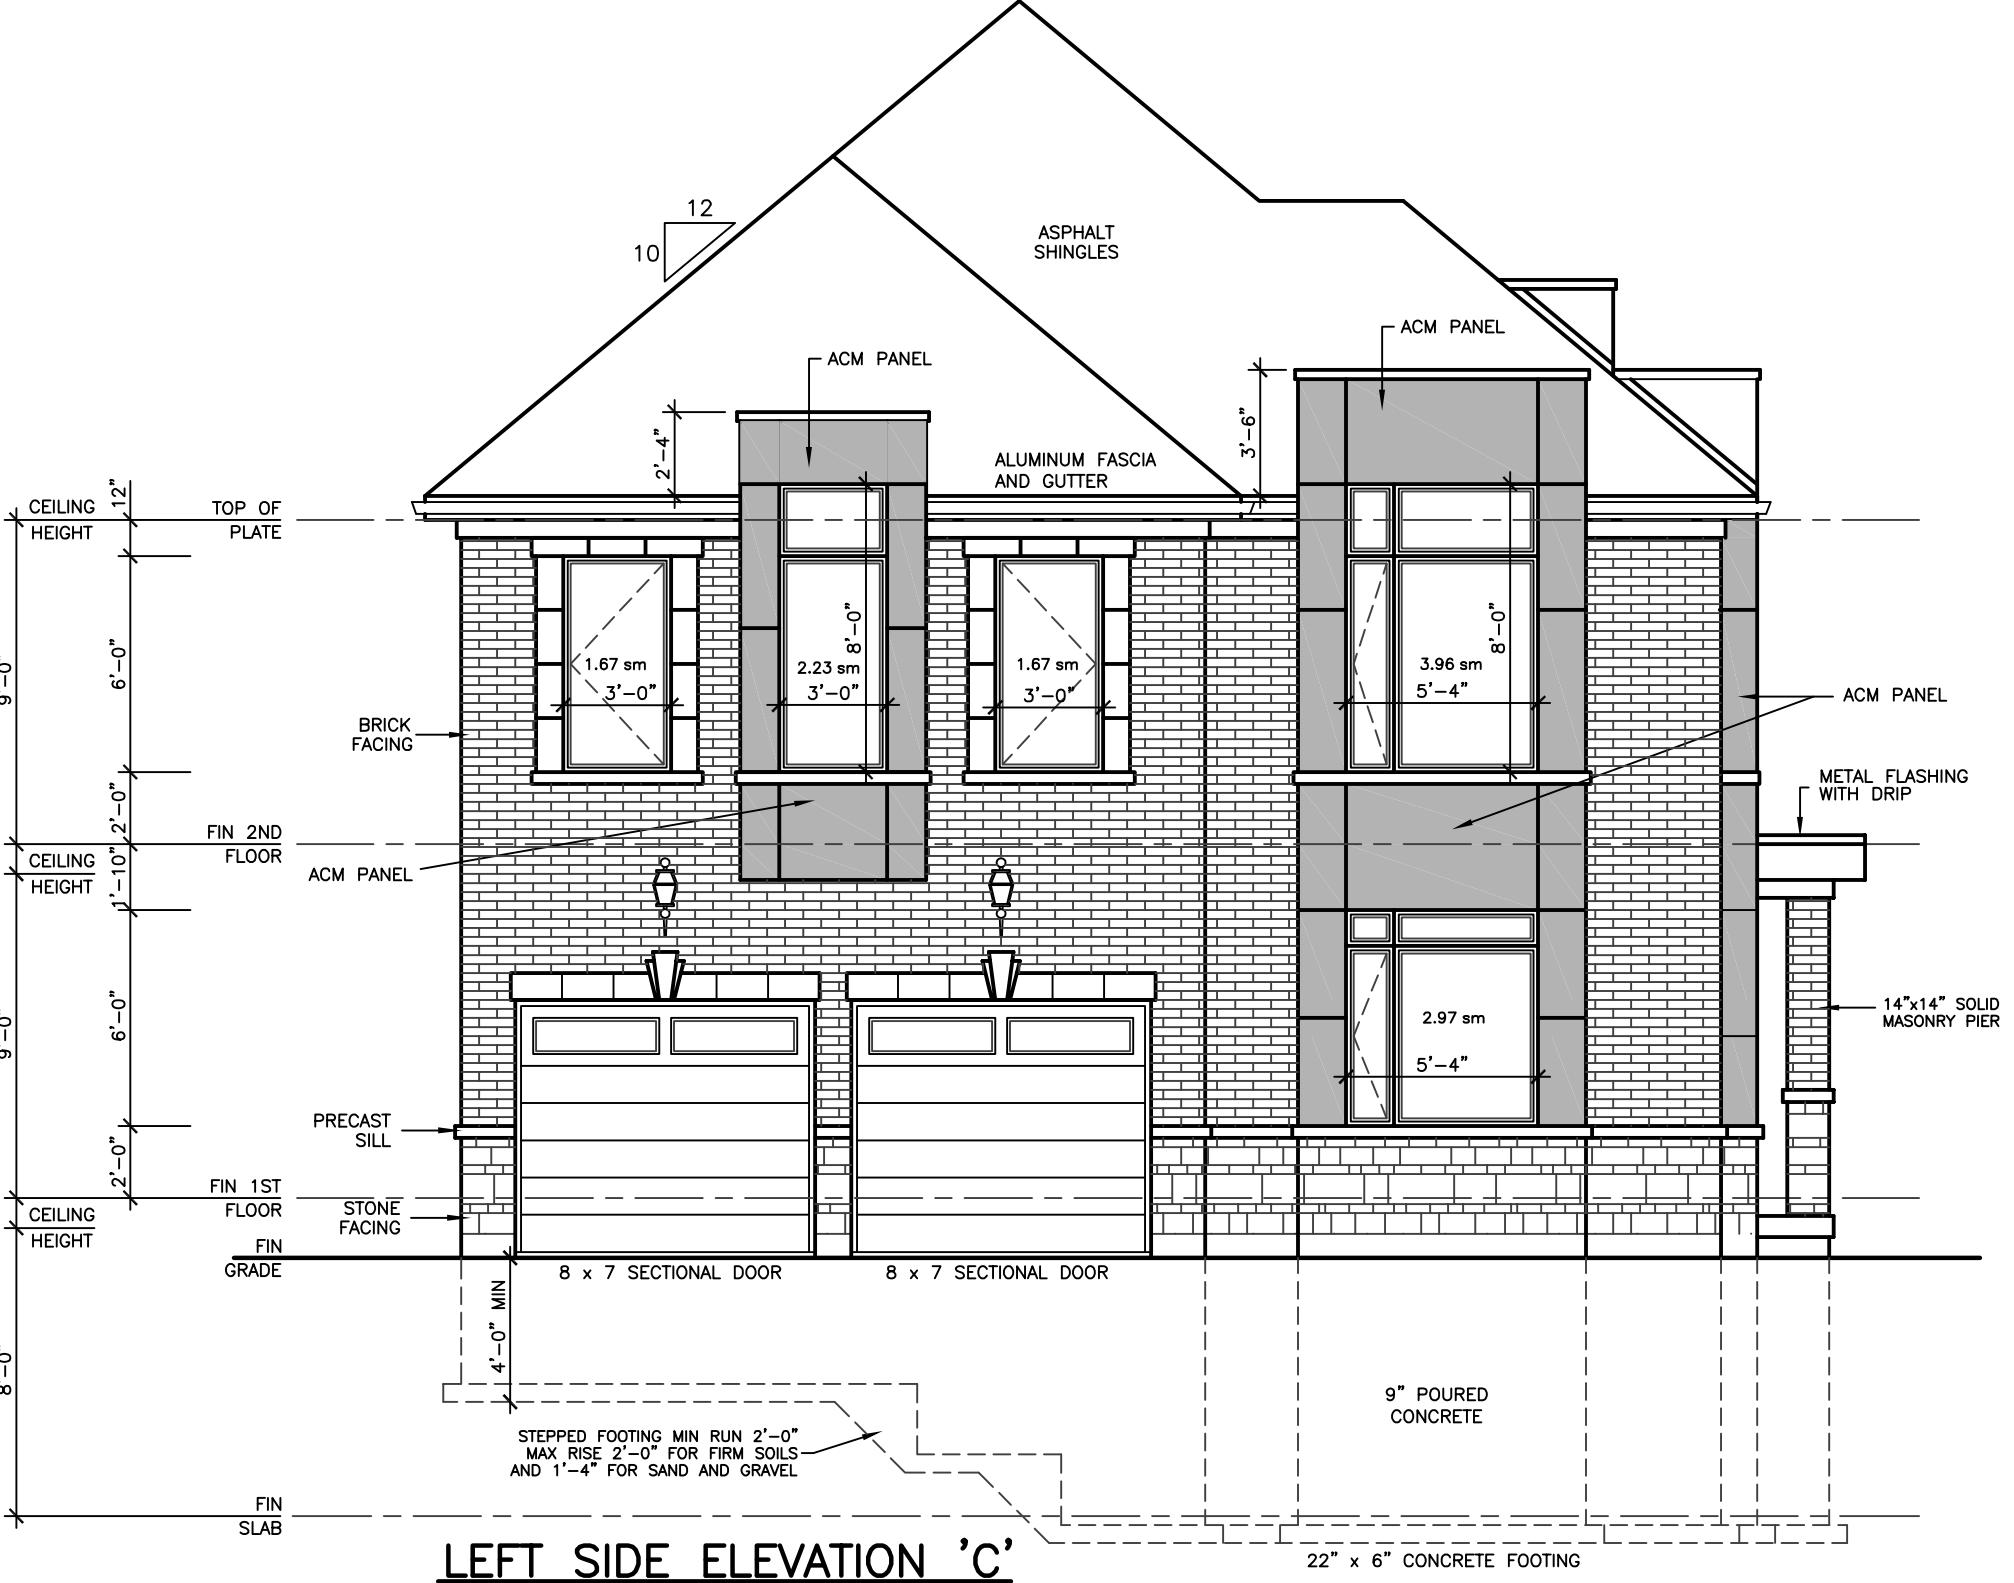

LEFT SIDE ELEVATION 'C'

