LIANA 2 (MODEL 2252 S.F.)

PRESCIPTIVE PACKAGE (GLASS,	/WALL AREA RAT	10
_		ELEV.	WALL AREA	304.2 m ²
Λ	4	1	GLASS AREA	30.5 m ²
		'	% GLASS	10.03 %
	\	ELEV.	WALL AREA	0.0 m ²
		2	GLASS AREA	0.0 m ²
SPACE HEATING	G FUEL		% GLASS	0.0 %
■ GAS	□ OIL	ELEV.	WALL AREA	000.00 m ²
□ ELECTRIC	□ PROPANE	3	GLASS AREA	00.00 m ²
□ EARTH	□ SOLID FUEL	J	% GLASS	0.00 %
BUILDING COMF	PONENTS		PROPO	OSED (A1)
NSULATION (RS	GI)			
CEILING W/A	TTIC SPACE		10.5	57 (R60)
CEILING W/C	ATTIC SPACE		5.46	6 (R31)
EXPOSED FL	00R			6 (R31)
WALLS ABOVE GRADE		4.22 (R24)		
BASEMENT WALLS		3.52	2 (R20)	
BELOW GRADE SLAB ENTIRE SURFACE >600mm BELOW GRADE			•	
EDGE OF BELOW GRADE SLAB <600mm BELOW GRADE		1.76	6 (R10)	
HEATED SLAB <600mm BELOW GRADE		1.76	6 (R10)	
CONC. SLAB <600mm) BELOW GRADE		1.76	6 (R10)	
VINDOWS & DC	ORS (U-VALUE)			
WINDOWS/SLIDING GLASS DOORS (MAX. U-VALUE)		1.6 (0.28)	
SKYLIGHTS (MAX. U-VALUE)		2.8 (0.49)	
APPLIANCE EFF	ICIENCY			
SPACE HEATING EQPT. (MIN. AFUE %)		!	96%	
HRV EFFICIENCY (%) (MIN. SRE)			75%	
DHW HEATER (MIN. EF)				0.8



FRONT ELEVATION 1

AREA CALCULAT	IONS	S - EL.1
TOTAL GROUND FLOOR AREA	=	1015 SQ. FT.
TOTAL SECOND FLOOR AREA	=	1245 SQ. FT.
TOTAL GROSS FLOOR AREA	=	2260 SQ. FT.
		209.96 m ²
SUBTRACT OPEN AREAS	=	8 SQ. FT.
		0.74 m ²
TOTAL NET FLOOR AREA	=	2252 SQ. FT.
		209.22 m ²

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TYPICAL BASEMENT **FLOOR PLAN NOTES**

ALL CONCRETE FOOTINGS SHALL REST ON UNDISTURBED SOIL WITH A MIN. ALLOWABLE BEARING CAPACITY OF 75Kpa (1500 PSF), AND BE FOUNDED A MIN. OF 4'-0" BELOW FINISHED GRADE.

CONCRETE STRENGTH FOR WALLS AND FOOTINGS SHALL BE A MINIMUM OF 15Mpa.

CONCRETE STRENGTH FOR GARAGE SLABS, CONC. PORCHES, AND STEPS SHALL BE A MINIMUM OF 32Mpa, WITH 5-8% AIR ENTRAINMENT.

CONCRETE STRIP FOOTING SIZE FOR 8" POURED CONC. WALLS SHALL BE A MINIMUM OF 6"x20" UNREINFORCED.

THE ABOVE FOOTING SIZE WILL BE USED FOR FOUNDATION WALLS WHICH SUPPORT 2 STOREYS OF BRICK VENEER WALL CONSTRUCTION, 2 FLOORS AND A ROOF OF LIGHT WOOD FRAME CONSTRUCTION, WITH THE SPAN OF SUPPORTED JOISTS THAT DO NOT EXCEED 4.9m (16'-1") AT A SPECIFIED LIVE LOAD OF NOT GREATER THAN 2.4 Kpa (50 PSF)

REFER TO BASEMENT PLAN FOR FOOTING SIZES IN AREAS EXCEEDING THE ABOVE CONDITIONS.

3/4" SUB-FLOOR TO BE GLUED & NAILED (TYP.)

REFER TO APPROVED FLOOR JOIST LAYOUT DRAWINGS, DETAILS AND SPECIFICATIONS FOR ALL FLOOR FRAMING AND DETAILS.

ALL JOISTS UNDER CERAMIC TILES TO BE INSTALLED AS PER JOIST MANUF. SHOP DWG'S

CONC. PAD FOOTING LEGEND (75 KPa)

(UNLESS OTHERWISE SPECIFIED)

F1 = 42"x42"x18" CONCRETE PAD F2 = 36"x36"x16" CONCRETE PAD

F3 = 34"x34"x14" CONCRETE PAD F4 = 30"x30"x12" CONCRETE PAD

F5 = 24"x24"x12" CONCRETE PAD F6 = 18"x18"x10" CONCRETE PADF7 = 16"x16"x8" CONCRETE PAD

BRICK VENEER LINTELS:

 $WL1 = 3 \frac{1}{2} \times 3 \frac{1}{2} \times 1 \frac{4}{90} \times 90 \times 6 + 2 \cdot 2 \times 8 \times SPR. \text{ No. 2}$ WL2 = 4" x 3 1\2" x 5\16" (100x90x8) + 2-2" x 8" SPR. No. 2 $WL3 = 5" \times 3 \times 1/2" \times 5/16" (125x90x8) + 2-2" \times 10" SPR. No. 2$ WL4 = 6" x 3 1\2" x 3\8" (150x90x10) + 2-2" x 12" SPR. No. 2 WL5 = 6" x 4" x 3\8" (150x100x10) + 2-2" x 12" SPR. No. 2 WL6 = 5" x 3 1\2" x 5\16" (125x90x8) + 2-2" x 12" SPR. No. 2 WL7 = 5" x 3 1\2" x 5\16" (125x90x8) + 3-2" x 10" SPR. No. 2 $WL8 = 5'' \times 3 \times 12'' \times 5 \times 16'' \times 125 \times 90 \times 8) + 3 - 2'' \times 12'' \text{ SPR. No. 2}$ $WL9 = 6" \times 4" \times 3\8" (150\times100\times10) + 3 - 2" \times 12" SPR. No. 2$

DOOR SHEDULE:

1 = 2'-10" x 6'-8" (865x2033) INSULATED ENTRANCE DOOR 1A = 2'-8" x 6'-8" (815x2033) INSULATED ENTRANCE DOOR 2 = 2'-8" x 6'-8" (815x2033) EXTERIOR WOOD & GLAZED DOOF $3 = 2'-8" \times 6'-8" \times 1 3/4" (815 \times 2033 \times 45)$ EXTERIOR SLAB DOOR $4 = 2'-8" \times 6'-8" \times 1 3/8" (815 \times 2033 \times 35)$ INTERIOR SLAB DOOR $5 = 2'-6" \times 6'-8" \times 1 3/8" (760 \times 2033 \times 35)$ INTERIOR SLAB DOOR $6 = 2'-2'' \times 6'-8'' \times 1 3/8'' (660 \times 2033 \times 35)$ INTERIOR SLAB DOOR $7 = 1'-6" \times 6'-8" \times 1 3/8" (460 \times 2033 \times 35)$ INTERIOR SLAB DOOR

WOOD LINTELS:

WB1 = 2-2" x 8" (2-38X184) SPR. No. 2 WB2 = 3-2" x 8" (3-38x184) SPR. No. 2 WB3 = 2-2" x 10" (2-38x235) SPR. No. 2 WB4 = 3-2" x 10" (3-38x235) SPR. No. 2 WB5 = 2-2" x 12" (2-38x286) SPR. No. 2 WB6 = 3-2" x 12" (3-38x286) SPR. No. 2 WB7 = 5-2" x 12" (5-38x286) SPR. No. 2 WB10 = 4-2" x 8" (4-38x184) SPR. No. 2 WB11 = 4-2" x 10" (4-38x235) SPR. No. 2 WB12 = 4-2" x 12" (4-38x286) SPR. No. 2 LSL = TIMBERSTRAND BOARD

STEEL LINTELS:

 $L1 = 3 \frac{1}{2} \times 3 \frac{1}{2} \times \frac{1}{4} (90 \times 90 \times 6)$ L2 = 4" x 3 1\2" x 5\16" (100 x 90 x 8) L3 = 5" x 3 1\2" x 5\16" (125 x 90 x 8) L4 = 6" x 3 1\2" x 3\8" (150 x 90 x 10) L5 = 6" x 4" x 3\8" (150 x 100 x 10) L6 = 7" x 4" x 3\8" (180 x 100 x 10)

LVL1A = 1-1 3/4" x 7" 1/4" (1-45x184) LVL1 = 2-1 3/4" x 7" 1/4" (2-45x184)

(LVL) BEAMS

LVL2 = 3-1 3/4" x 7" 1/4" (3-45x184) $LVL3 = 4-1 3/4" \times 7" 1/4" (4-45x184)$ LVL4A = 1-1 3/4" x 9" 1/2" (1-45x235) LVL4 = 2-1 3/4" x 9" 1/2" (2-45x235) LVL5 = 3-1 3/4" x 9" 1/2" (3-45x235) LVL5A = 4-1 3/4" x 9" 1/2" (4-45x235) LVL6A = 1-1 3/4" x 11" 7/8" (1-45x300) LVL6 = 2-1 3/4" x 11" 7/8" (2-45x300)

LAMINATED VENEER LUMBER

NOTE: LVL BEAMS

ALL LVL BEAMS SUPPORTING FLOOR LOADS ARE TO BE SPECIFIED BY THE FLOOR TRUSS MANUFACTURER.

STRUDET INC.



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2252 11.0m LOTS

LIANA 2-11 ELEVATION 1 (GR)

PACKAGE 'A1'

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4	DEC. 21, 2018	ISSUED FOR BUILDING PERM
3	AUG. 15, 2018	COORDINATED AS PER ENGINEE COMMENTS
2	JULY 26, 2018	ISSUED FOR STRUCTURAL REVIEW
1	MAY 22, 2018	ISSUED FOR FLOOR & ROOF TRUSSES

WORK DESCRIPTION:

64 JARDIN DR. SUITE 3A VAUGHAN ONT, L4K 3P3 TEL: 905 660-3377 FAX: 905 660-3713 EMAIL: info@jardindesian.ca

The undersigned has reviewed and takes responsibility for this design and has the qualifications and meets the equirements set out in the Ontario Building Code to b

QUALIFICATION_INFORMATION

NAME

REGISTRATION INFORMATION

3.2.4 of the building code jardin design group inc.

FIRM NAME TITLE SHEET

GRANELLI HOMES BRAMPTON





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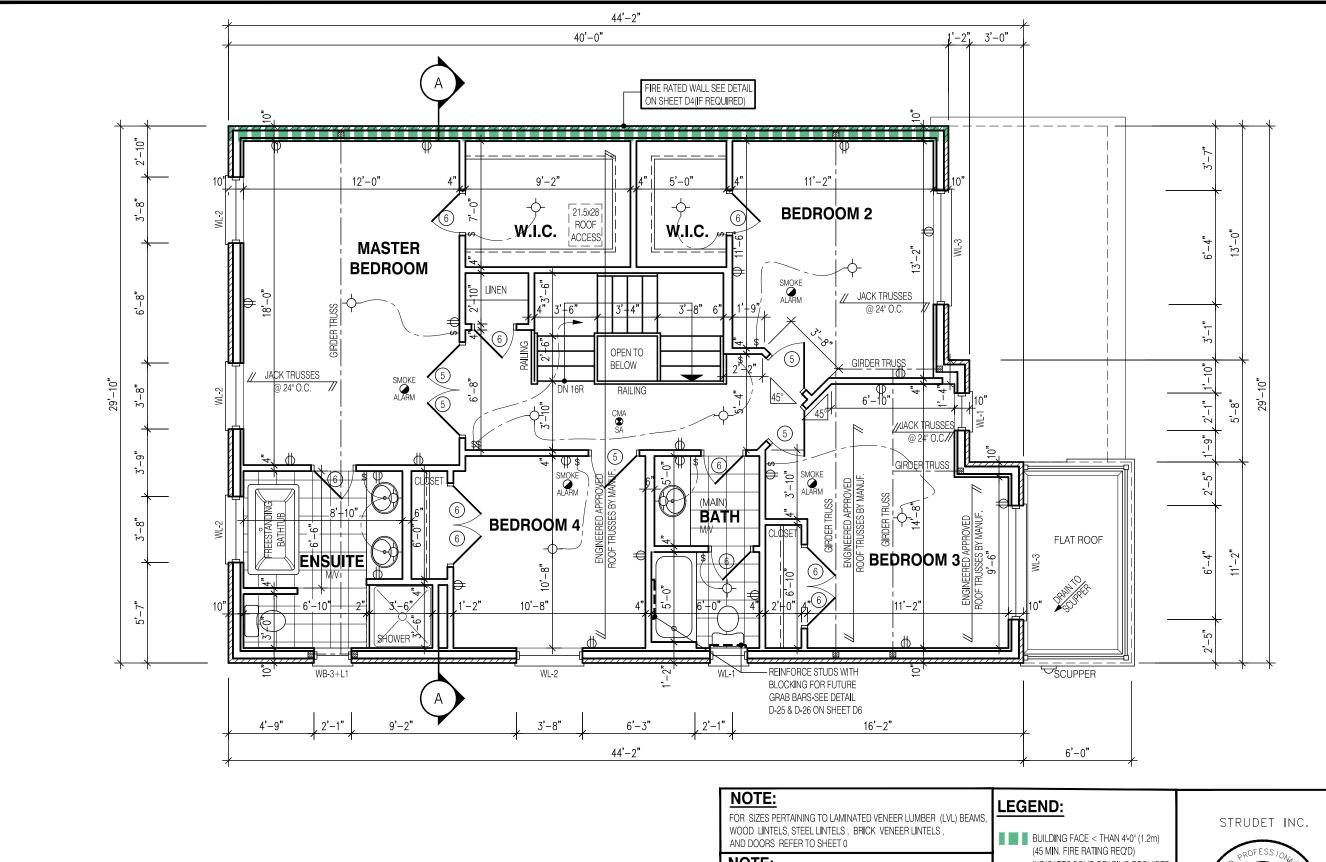
3/16"=1'-0" ROJ. No. 17-55

27763

DRAWING NAME: -



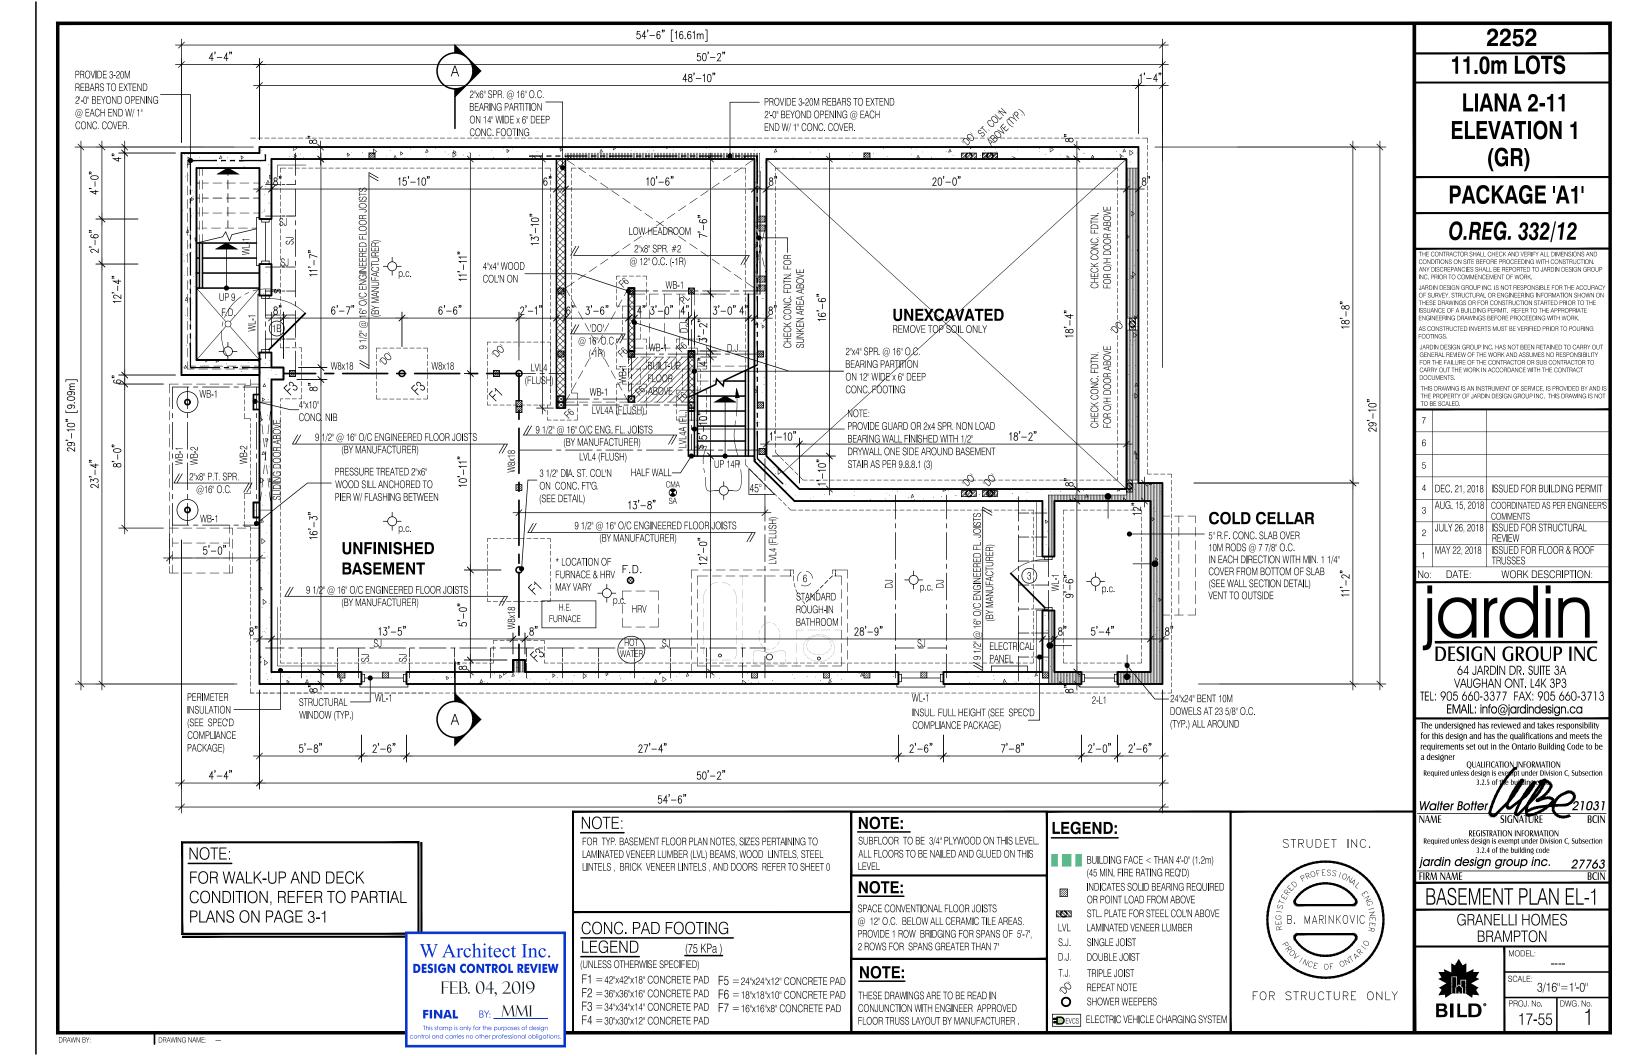

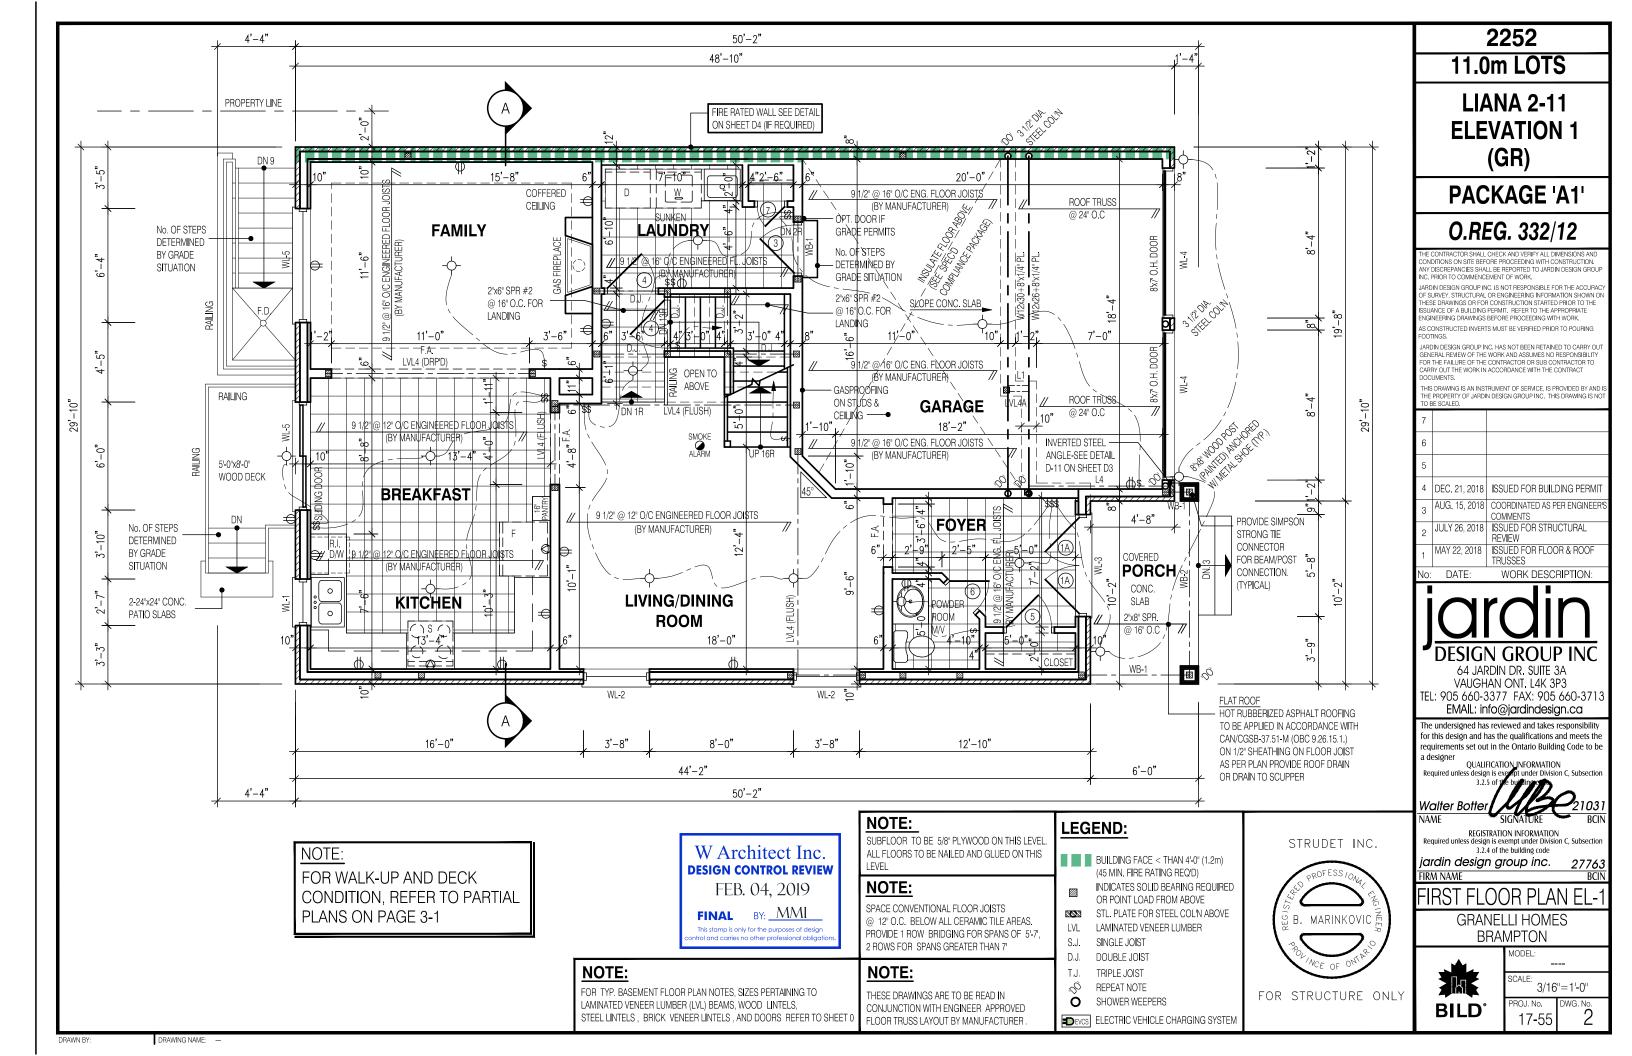

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NOTE:

THESE DRAWINGS ARE TO BE READ IN CONJUNCTION WITH ENGINEER APPROVED ROOF TRUSS DRAWINGS BY MANUFACTURER

NOTE:

ALL CONVENTIONAL ROOF FRAMING TO CONFORM TO PART 9 OF THE OBC. ROOF RAFTERS THAT MEET OR CROSS OVER TRUSSES ARE TO BE 2"x4" SPF. @ 24" O.C. WITH A 2"x4" SPF VERTICAL POST TO THE TRUSS UNDER, AT EACH CROSS POINT. POSTS LONGER THAN 6' TO BE LATERALLY BRACED SO THAT THE DISTANCE BETWEEN END POINTS & BETWEEN ROWS OF BRACING DOES NOT EXCEED 6'.

INDICATES SOLID BEARING REQUIRED OR POINT LOAD FROM ABOVE STL. PLATE FOR STEEL COL'N ABOVE

LAMINATED VENEER LUMBER

S.J. SINGLE JOIST

DOUBLE JOIST T.J. TRIPLE JOIST

REPEAT NOTE SHOWER WEEPERS 0

DEVCS ELECTRIC VEHICLE CHARGING SYSTEM



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2252 11.0m LOTS

LIANA 2-11 ELEVATION 1 (GR)

PACKAGE 'A1'

O.REG. 332/12

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WORK DESCRIPTION:

64 JARDIN DR. SUITE 3A VAUGHAN ONT, L4K 3P3 TEL: 905 660-3377 FAX: 905 660-3713 EMAIL: info@jardindesign.ca

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NAME

REGISTRATION INFORMATION Required unless design is exempt under Division C, Subsectio

3.2.4 of the building code jardin design group inc.

FIRM NAME


SECOND FL. PLAN EL-1


GRANELLI HOMES BRAMPTON



SCALE: 3/16"=1'-0" ROJ. No. 17-55

MODEL:

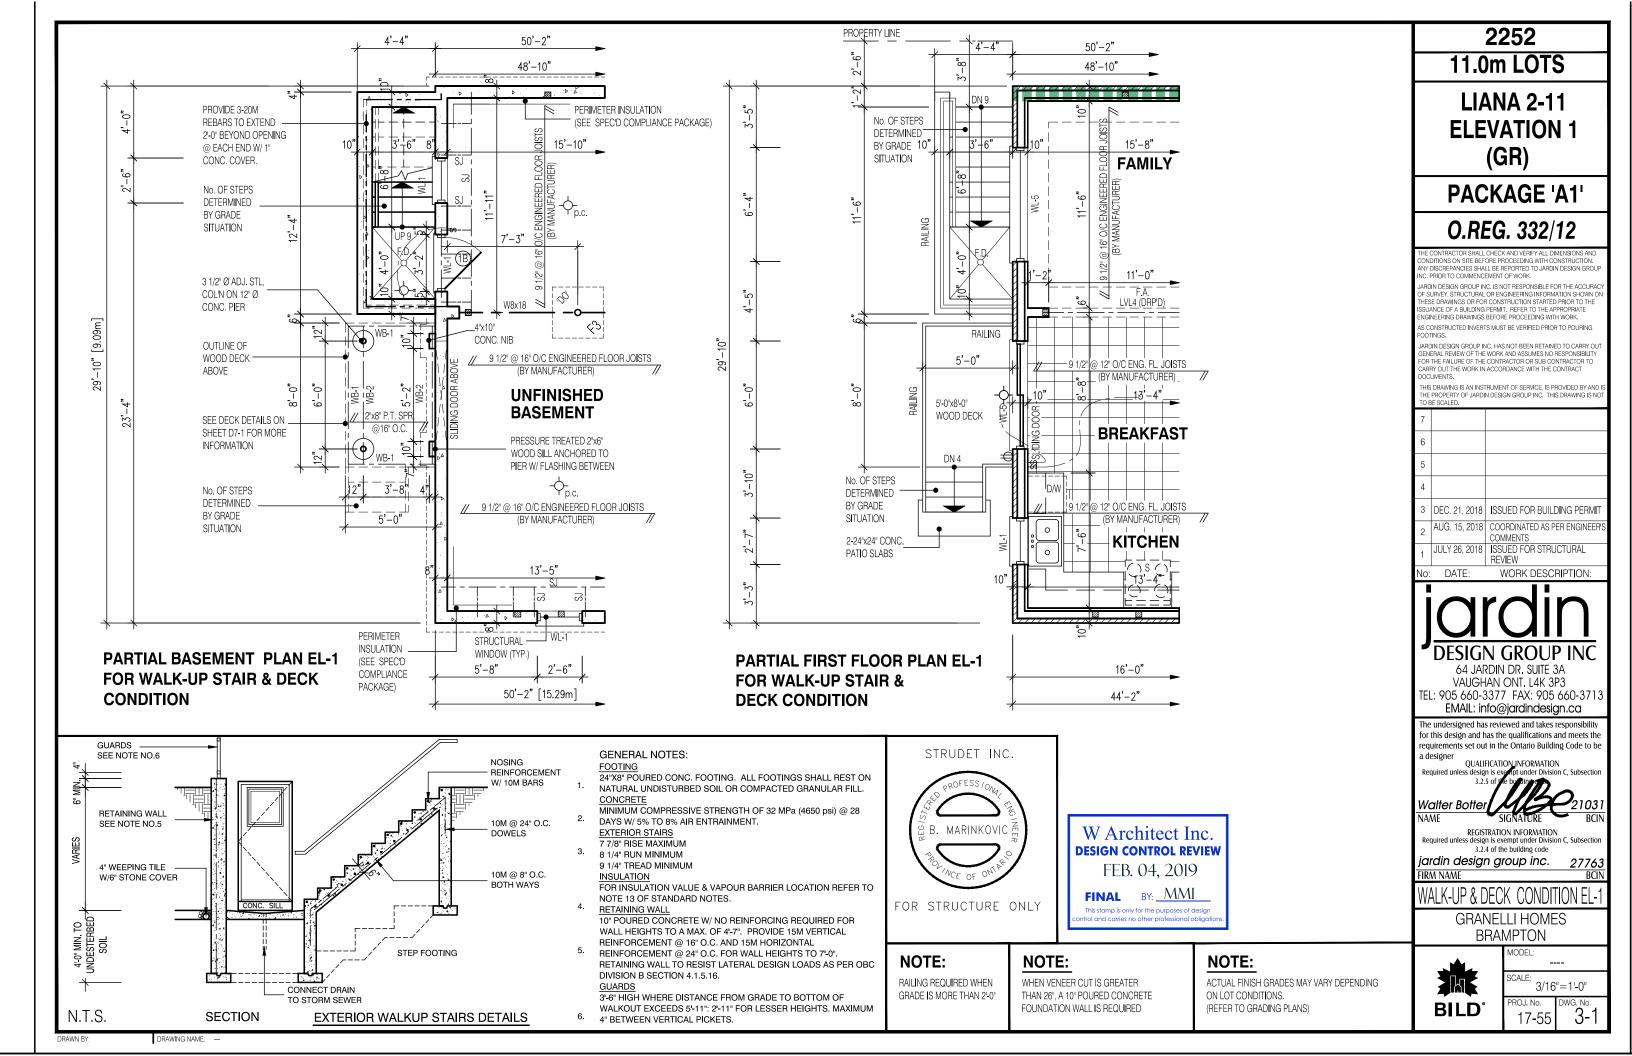

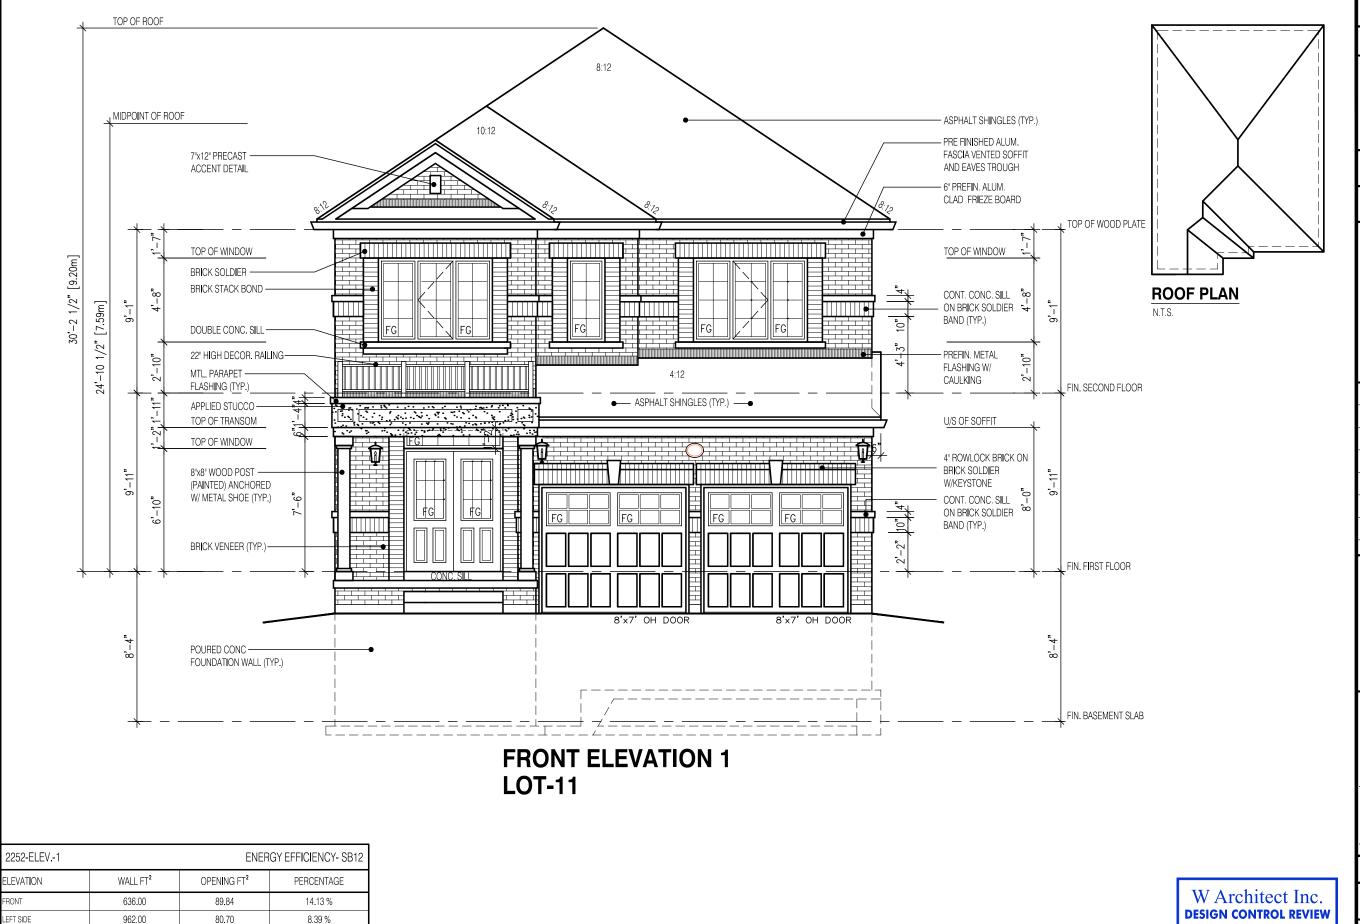

2252

11.0m LOTS

LIANA 2-11 ELEVATION 1 (GR)

PACKAGE 'A1'

O.REG. 332/12

HE CONTRACTOR SHALL CHECK AND VERIFY ALL DIMENSIONS AND ONDITIONS ON SITE BEFORE PROCEEDING WITH CONSTRUCTION. NY DISCREPANCIES SHALL BE REPORTED TO JARDIN DESIGN GROU INC. PRIOR TO COMMENCEMENT OF WORK.

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The undersigned has reviewed and takes responsibility for this design and has the qualifications and meets the requirements set out in the Ontario Building Code to be a designer

QUALIFICATION_INFORMATION Required unless design is e

Walter Botte NAME

REGISTRATION INFORMATION Required unless design is exempt under Division C, Subsectio 3.2.4 of the building code

jardin design group inc.

FIRM NAME

FRONT ELEVATION 1

GRANELLI HOMES BRAMPTON



FEB. 04, 2019

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MODEL: SCALE: 3/16"=1'-0" ROJ. No. 17-55

971.00

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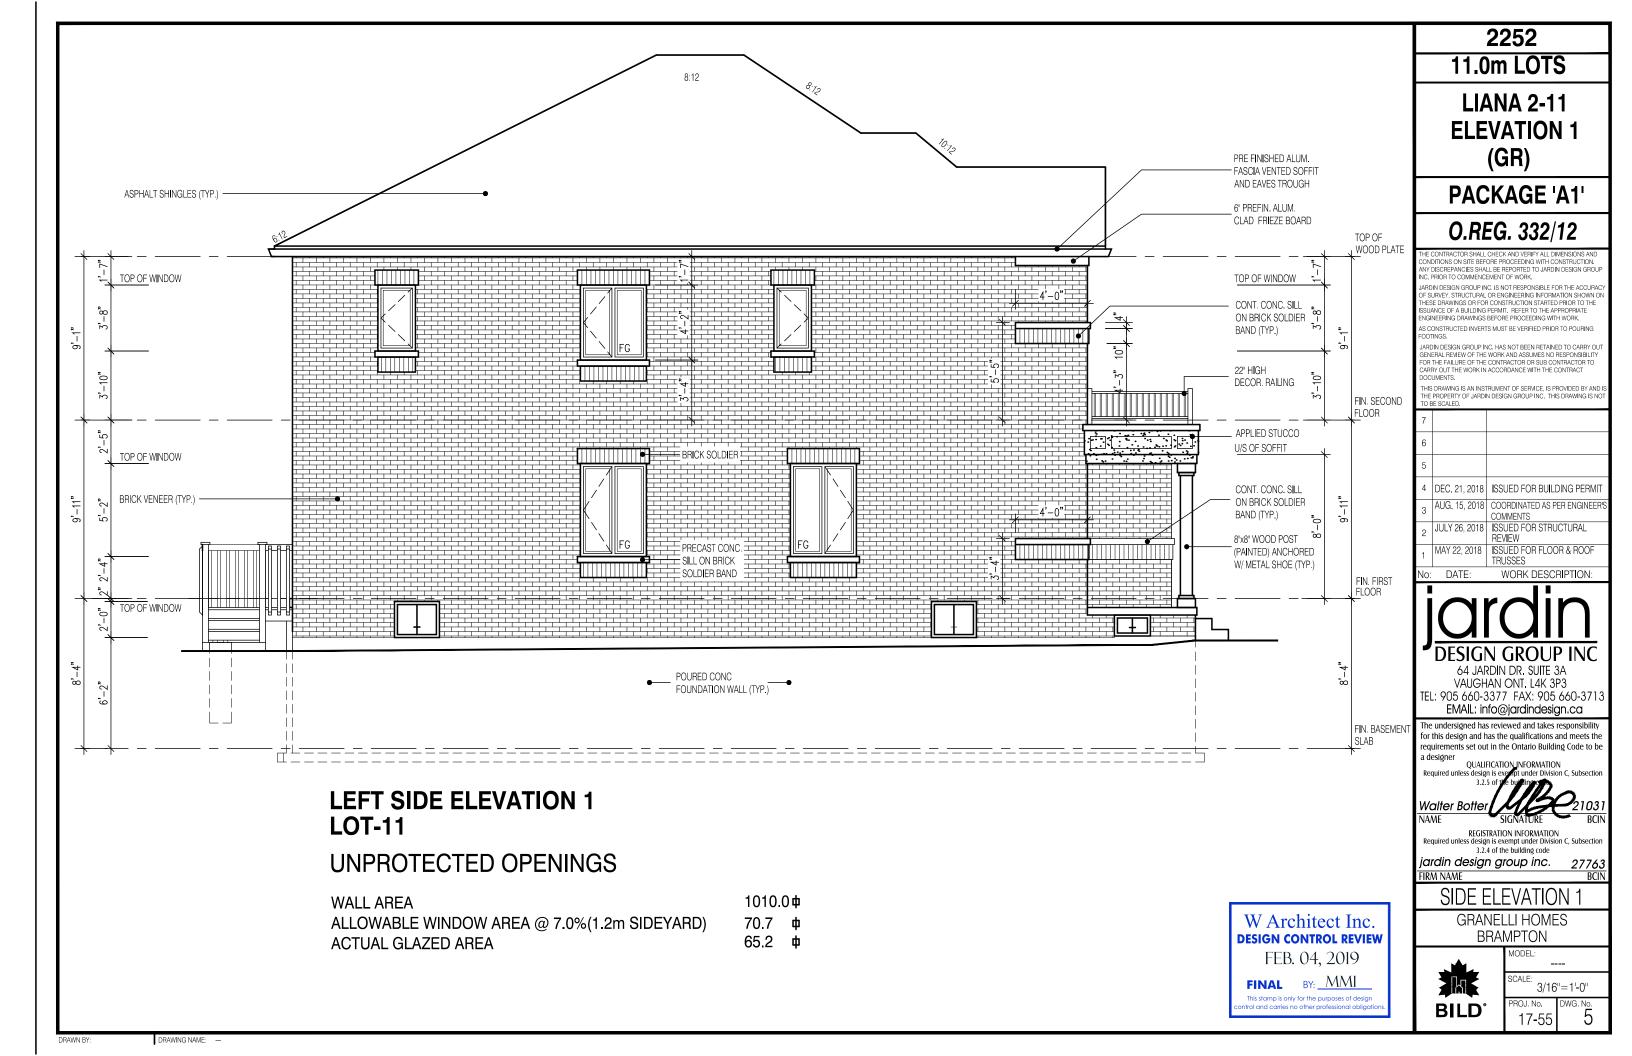
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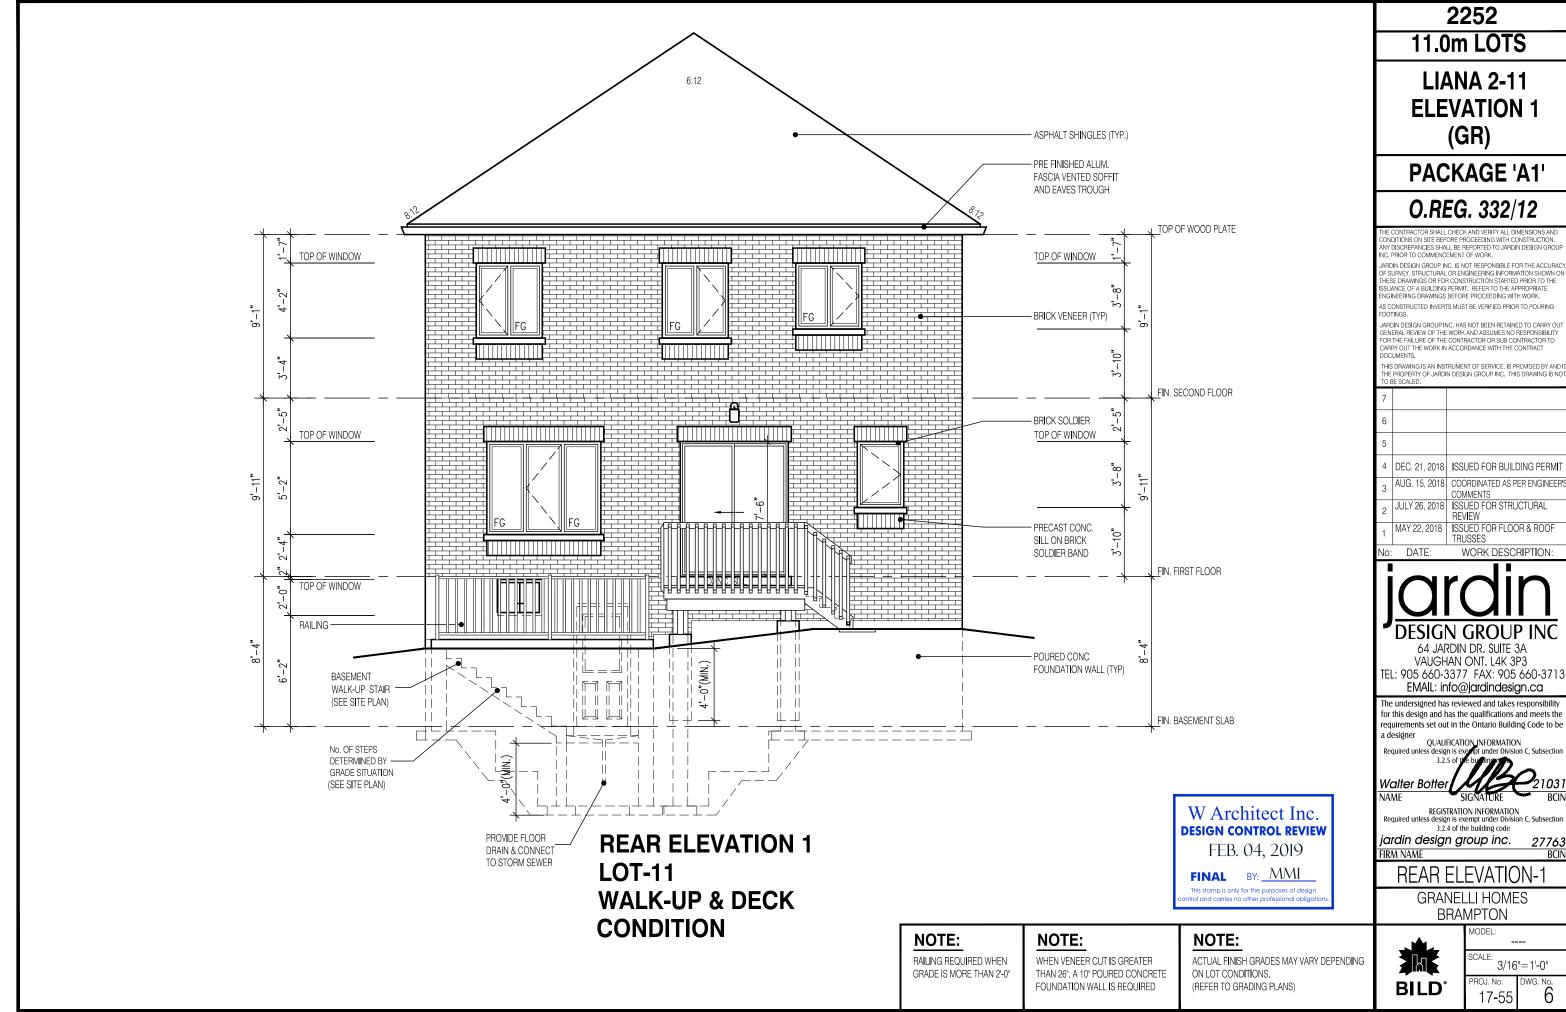
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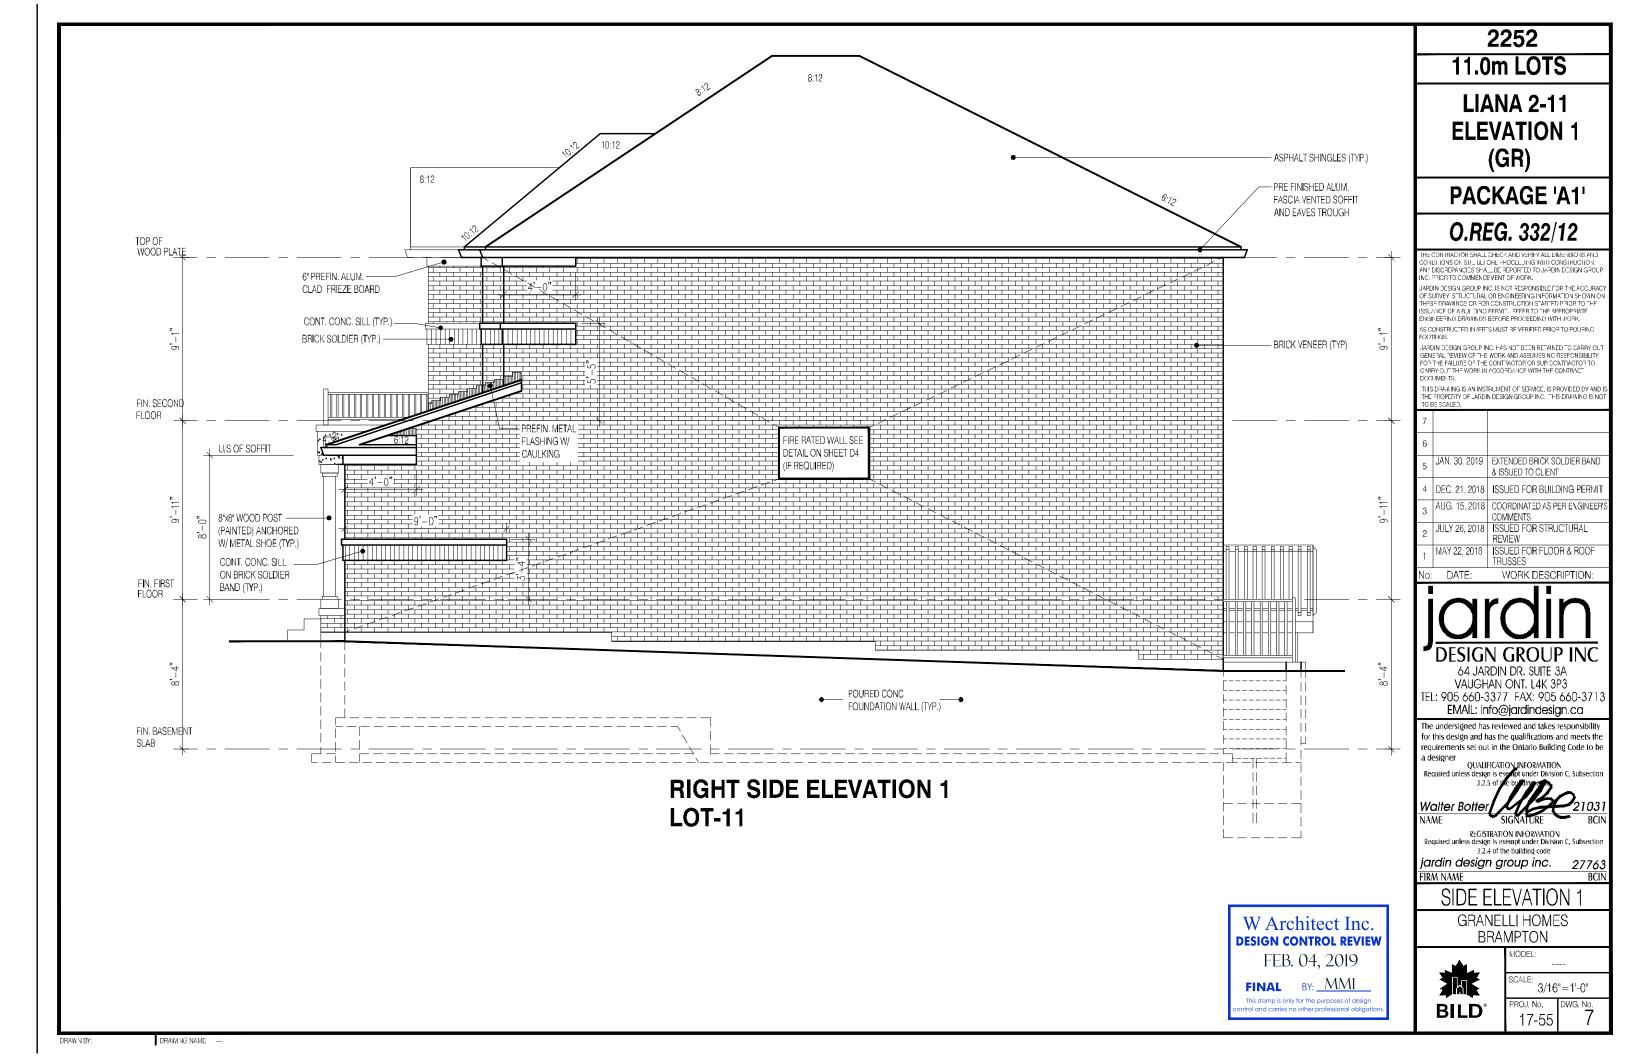
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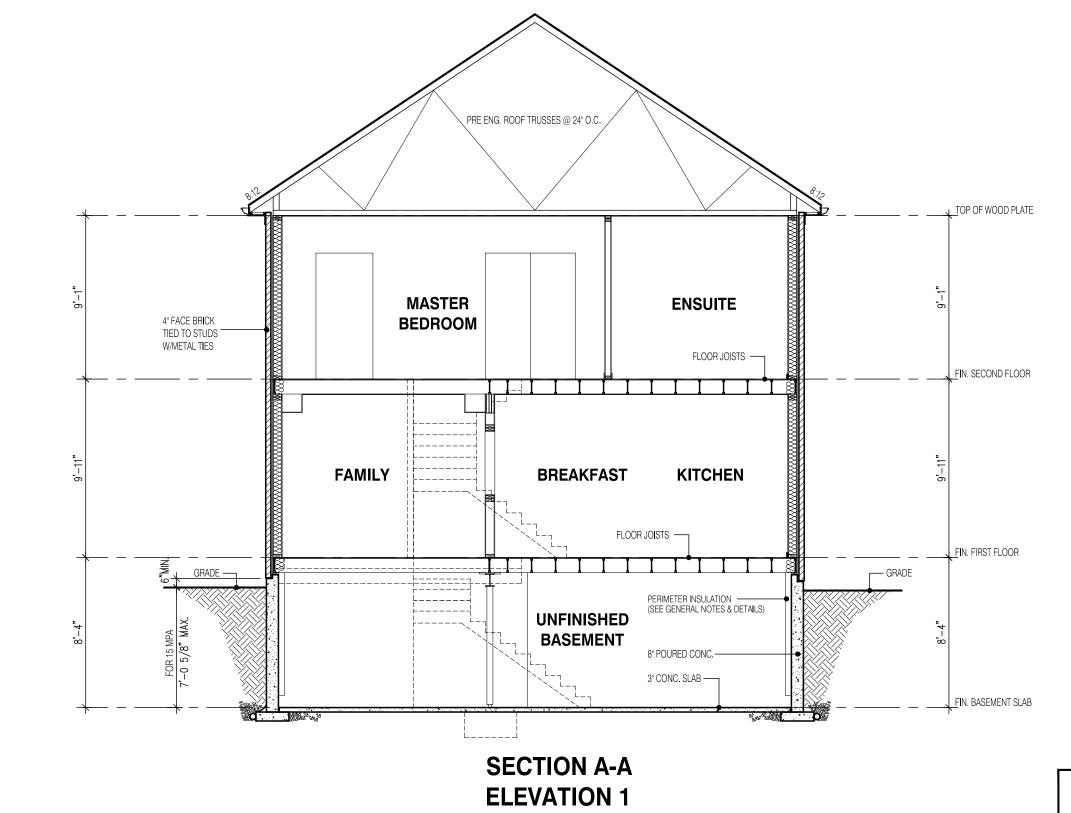
RIGHT SIDE





DRAWING NAME: --





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STRUDET INC. B. MARINKOVIC FOR STRUCTURE ONLY 2252

11.0m LOTS

LIANA 2-11 ELEVATION 1 (GR)

PACKAGE 'A1'

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1	JULY 26, 2018	ISSUED FOR STRUCTURAL REVIEW	

DATE: WORK DESCRIPTION:



64 JARDIN DR. SUITE 3A VAUGHAN ONT, L4K 3P3 TEL: 905 660-3377 FAX: 905 660-3713 EMAIL: info@jardindesign.ca

The undersigned has reviewed and takes responsibility for this design and has the qualifications and meets the requirements set out in the Ontario Building Code to be a designer

QUALIFICATION_INFORMATION Required unless design is e

NAME

REGISTRATION INFORMATION Required unless design is exempt under Division C, Subsection 3.2.4 of the building code

27763

3/16"=1'-0"

jardin design group inc.

FIRM NAME

SECTION EL-1

GRANELLI HOMES BRAMPTON



MODEL: SCALE: PROJ. No. 17-55