

Building Services Division (905) 771-8810 Fax. (905) 771-5445

City of Richmond Hill

225 East Beaver Creek Road Richmond Hill, Ontario Canada, L4B 3P4

GENERAL NOTES (PART 9 - RESIDENTIAL)

PERMIT NO. **RM#24-00030**

All construction must comply with the Ontario Building Code (OBC) 2012 as amended, including but not limited to the following. As a minimum, the following requirements **shall** be incorporated in the final construction:

- All footings shall rest on natural undisturbed soil or compacted granular fill with a minimum bearing capacity of 75 KPa (1570 psf) unless known capacity is less and provided for in the foundation design.
- 2. Step footings shall have a maximum rise of 600 mm (23 5/8") for firm soils, 400 mm (15 3/4") for sand or gravel and a minimum horizontal run of 600 mm (23 5/8").
- 3. Concrete for exterior steps, garage and carport floors and all exterior flat work shall have a minimum compressive strength of 32 MPa (4650 psi) at 28 days, with air entrainment of 5 to 8%. Concrete floors with no damp proofing shall have a minimum compressive strength of 25 MPa (3000 psi). All other concrete to be 15MPa (2200 psi).
- 4. Foundations and the soil beneath them shall be protected against freezing during winter construction. Where foundation walls require permanent lateral support, the wall shall be braced or laterally supported before backfilling.
- When the unsupported height of a foundation wall exceeds 3.0 m (9'-10"), the wall shall be designed by an engineer in accordance with OBC Part 4
- Exterior concrete stairs with more than 2 steps shall be supported on unit masonry, concrete walls or piers not less than 150x150 (6"x6") with footings at 1.2 m (4') below grade.
- 7. Where the top of a foundation wall is reduced in thickness to permit the installation of masonry exterior facing, the reduced section shall be not less than 90 mm (3 ½") thick and tied to the facing material with metal ties conforming to Sentence 9.20.9.4. (3), spaced not more than 200 mm (7 7/8") o.c. vertically and 900 mm (2'-11") o.c. horizontally. The space between the wall and masonry veneer shall be filled with mortar.
- 8. Provide continuous lateral support to top flange of all steel beams. Steel beams shall have minimum 90 mm (3 1/2") bearing length. Connections to other steel beams shall have a minimum of 2-M20 (3/4" dia.) A325 steel bolts or a full welded connection (with full shear capacity of beam). Steel beams supported on wood shall be designed by an Engineer.
- Provide solid blocking support under all point loads and continue down to the foundation. Built-up columns shall comply with OBC 9.23.10.7.
 For engineered systems, follow manufacturer's specifications for correct blocking and bearing requirements.
- 10. Refer to the approved engineered layout drawings for engineered floor joist and roof truss systems, including beams and supports. Follow manufacturers specifications for bridging, bracing, bearing and connection requirements for built up beams or joists.
- Tie the lower ends of roof rafters with continuous horizontal ties to the opposing rafters unless lateral thrust is otherwise specifically designed for.
- 12. Guards shall be constructed in accordance with Supplementary Standard 7 of the OBC or in conformance with OBC Part 4 (including design loads on guards). Min. guard height to comply with OBC 9.8.8. All guards to be non-climbable.
- All masonry veneer ties shall be corrosion-resistant, minimum of 0.76 mm (0.03") thick, 22 mm (7/8") wide and be spaced in accordance with Table 9.20.9.5 of the OBC
- 14. Ceramic floor tile and its supporting floor shall be constructed in accordance to OBC 9.30.6.
- 15. For insulation values, window and door U-values and efficiency of appliances refer to SB-12 requirements: Prescriptive or Performance design or values specified by Energy Star requirements.
- 16. Foundation walls enclosing heated spaces shall be insulated to not more than 8" above the basement slab and an approved drainage layer is required on the exterior.
- 17. Exterior Insulated Finished System (EIFS) over wood framed wall and other moisture sensitive substrates shall consist of dual barrier with drained joints (DB/DJ). They shall be constructed in accordance to OBC 9.27.13 and shall conform to CAN/ULC-S716.1. All other exterior applied stucco finishes shall be constructed in accordance with OBC 9.28.
- 18. Stairs serving a house or dwelling unit shall have min. headroom of 1950 mm (6'-5"), min. width of 860 mm (2'-10"), max. rise of 200 mm (7 7/8") & min. 125 mm (4 7/8") and a min. run of 255 mm (10"). Tapered stairs shall have a min. average run of 255 mm (10") at the point of 300mm measured from the center of the handrail. The tolerance of stair dimensions shall conform to OBC 9.8.4.4. Secure stair stringers at top and bottom.

- 19. Basement ceiling height shall be min. 2.1 m. (6'-11") over at least 75% of the area and 1.95 m. (6'-5") under beams and ducts.
- 20. Every floor level containing a bedroom shall be provided with at least 1 outside window with an operable unobstructed opening having a minimum area of 0.35 sq. m. (3.8 sq. ft.), with no dimension less than 380 mm (15"). Every floor level, requiring travel of more than 1 storey to an exit door, shall be provided with an unobstructed escape window opening of not less than 1 m. (3'-3") in height and 0.55 m (21 5/8") in width with the sill not more than 1 m (3'-3") above the floor and 7 m. (23') above adjacent ground level or that floor shall be provided with a balcony. Except for basement locations, all windows shall have a maximum sill height of 1 m. (3'-3") above the floor.
- Provide window protection to minimize the hazard to children in accordance with OBC 9.7.1.6.
- 22. Exterior walls, which are less than 1.2 m (4'-0") from the lot line, shall have no unprotected opening and be constructed with a ¾ hr. fire resistance rating. These walls shall be rated from the interior. Exterior walls, which are less than 0.6 m (2'-0") from the lot line, shall in addition have non-combustible cladding.
- 23. All entrance doors, doors between the dwelling unit and the attached garage, patio doors and windows within 2m (6'-7") of adjacent ground level shall conform to OBC Subsections 9.6.8 & 9.7.6 'Resistance to Forced Entry'.
- 24. Roof vents shall be provided on the basis of 1 sq. ft./300 sq. ft. of insulated ceiling area. Where the roof slope is less than 1 in 6 or in cathedral ceilings, roof vents shall be provided on the basis of 1 sq. ft./150 sq. ft. of insulated ceiling area. Roof vents shall be uniformly distributed to ventilate each roof space with a minimum of 25% of the required vent space to be located at the top and the bottom of the roof.
- 25. Eave protection is required, beneath the start strip, from the edge of the roof to a minimum distance of 900 mm (3'-0") up the roof slope to not less than 300 mm (12") inside the inner face of the exterior wall on shingled, shake or tile roofs except as provided by 9.26.5.1.(2).
- 26. Foamed plastic insulation shall be protected with interior finishes according to OBC 9.10.17.10.
- 27. The wall and ceiling between an attached garage and the dwelling unit shall be constructed and sealed so as to provide an effective barrier to exhaust fumes. Door between the garage and the dwelling unit shall be tight fitting, weather-stripped and equipped with a self closing device.
- 28. Smoke alarms shall be provided on each floor level and be located within each bedroom. Smoke alarms shall be interconnected and hard wired with no disconnect switch. Smoke alarms are required to have a visual signaling component conforming to NFPA 72.
- 29. A carbon monoxide detector conforming to CAN/CGA-6.19 or UL 2034 shall be installed on every building containing a fuel burning appliance or an attached garage in conformance with the OBC 9.33.4.
- 30. In addition to the above carbon monoxide detectors, Town of Richmond Hill By-law No. 245-99 requires that a carbon monoxide detector, equipped with an alarm that is audible within bedrooms when the intervening doors are closed and conforming to CAN/CGA-6.19 or UL 2034, be installed in accordance with the manufacturer's instructions in every dwelling unit. Where the carbon monoxide detector is electrically powered, it must be approved by the Canadian Standards Association and be equipped with a visual indicator indicating that it is in operating condition and have NO switch between the carbon monoxide alarm and the power distribution panel.
- 31. A mechanical ventilation system is required in every dwelling. An exhaust only' ventilation system is permitted only where forced air heating is used, there is no electric heating or fireplace (other than a direct vent gas fireplace), and where a mechanically vented induced draft or direct vented furnace and hot water tank are used. A ventilation system with a heat recovery ventilator or Part 6 design is required in all other cases.
- 32. All exterior doors greater than 600mm above grade which do not exit onto a deck shall be permanently adjusted to prevent opening as per 9.6.4.1(2) of the OBC or be guarded as per 9.8.8 of the OBC
- 33. The main bathroom shall have stud reinforcement to accommodate future installation of grab bars adjacent to water closets and shower or bathtub as per OBC 9.5.2.3.
- 34. Slopes on roof surfaces shall comply with OBC 9.26.3.1.
- 35. Windows shall comply with OBC 9.7
- 36. Exhaust ducts connected to laundry drying equipment shall comply with OBC 6.2.3.8. (7)

STRIP FOOTINGS -

FOR SINGLES & SEMIS UP TO 2 STOREY

8" OR 10" FOUNDATION WALLS WITH 2"X8" / 2"X10" FLOOR JOISTS 20"x6" CONCRETE STRIP FOOTINGS BELOW FOUNDATION WALLS. 24"x8" CONCRETE STRIP FOOTINGS BELOW PARTY WALLS.

FOUNDATION WALLS WITH ENGINEEED JOISTS OVER 16' SPANS 24"x8" CONCRETE STRIP FOOTINGS BELOW FOUNDATION WALLS.

FOOTINGS ON ENGINEERED FILL

24"x8" CONCRETE STRIP FOOTINGS WITH REINFORCING BELOW EXTERIOR WALLS.

30"x8" CONCRETE STRIP FOOTINGS WITH REINFORCING BELOW PARTY WALLS.

(REFER TO FOOTING DETAILS ON ENGINEERED FILL)

ASSUME THE LARGER FOOTING SIZE

WHEN TWO CONDITIONS APPLY
ASSUMED 120 KPa (10 p.s.) SOIL BEARING CAPACITY OR 90 KPa

ENGINEERED SOIL FILL['], TO BE VERIFIED ON SITE, <mark>by a soil engineer rep</mark>

PAD FOOTINGS

120 KPa NATIVE SOIL

90 KPa ENGINEERED FILL SOIL FI = 42"x42"x20" CONCRETE PAD FI = 48"x48"x20" CONCRETE PAD

F3 = 30"x30"x13" CONCRETE PAD F3 = 34"x34"x14" CONCRETE PAD F4 = 24"x24"x12" CONCRETE PAD F4 = 28"x28"x12" CONCRETE PAD F5 = 16"x16"x8" CONCRETE PAD F5 = 18"x18"x8" CONCRETE PAD (REFER TO FLOOR PLAN FOR UNUSUAL SIZE PADS NOT ON CHART)

WHEN VENEER CUT IS GREATER THAN 26" A 10" POURED CONC. FDTN. WALL IS REQUIRED.

ALL GARAGE SLABS, PORCH SLABS, STAIRS (EXPOSED CONC. FLAT WORK) TO BE 32 MPa WITH 5-8% AIR ENTRAITMENT

BRICK VENEER LINTELS

 $\overline{\text{ML1}}$ = 3-1/2"x3-1/2"x1/4"L (90x90x6.0L) + 2-2"x8" SPR. No.2 WL2 = 4"x3-1/2"x5/16"L (100x90x8.0L) + 2-2"x8" SPR. No.2 WL3 = 5"x3-1/2"x5/16"L (125x90x8.0L) + 2-2"x10" SPR. No.2NL4 = 6"x3-1/2"x3/8"L (150x90x10.0L) + 2-2"x12" SPR, No.2 NL5 = 6"x4"x3/8"L (150x100x10.0L) + 2-2"x12" SPR, No.2WL6 = 5"x3-1/2"x5/16"L (125x90x8.0L) + 2-2"x12" SPR. No.2WL7 = 5"x3-1/2"x5/16"L (125x90x8,0L) + 3-2"x10" SPR. No.2WL8 = 5"x3-1/2"x5/16"L (125x90x8.0L) + 3-2"x12" SPR. No.2

WL9 = 6"x4"x3/8"L (150x100x10.0L) + 3-2"x12" SPR. No.2

WOOD LINTELS AND BEAMS WBI = 2-2"x8" SPR. No.2 (2-38x184 SPR. No.2) WB2 = 3-2"x8" SPR. No.2 (3-38x184 SPR. No.2) = 2-2"xIO" SPR. No.2 (2-38x235 SPR. No.2) WB4 = 3-2"x10" SPR. No.2 (3-38x235 SPR. No.2) WB5 = 2-2"x12" SPR. No.2 (2-38x286 SPR. No.2) WB6 = 3-2"x12" SPR. No.2 (3-38x286 SPR. No.2) WB7 = 5-2"x12" SPR. No.2 ($5-38\times286$ SPR. No.2)

WBII = 4-2"xIO" SPR. No.2 (4-38x235 SPR. No.2) WBI2 = 4-2"x12" SPR. No.2 (4-38x286 SPR. No.2)

LAMINATED VENEER LUMBER (LVL) BEAMS

LVLI = 2-1 3/4" x 7 1/4" (2-45x184) LVL2 = 3-1 3/4" x 7 1/4" (3-45x184) LVL3 = 4-1 3/4" x 7 1/4" (4-45x184) LVL4A = I-I 3/4" x 9 I/2" (I-45x240) LVL4 = 2-I 3/4" x 9 I/2" (2-45x240) LVL5 = 3-I 3/4" x 9 I/2" (3-45x240) LVL5A = 4-1 3/4" x 9 1/2" (4-45x240) LVL6A = 1-1 3/4" x 11 7/8" (1-45x300) LVL6 = 2-1 3/4" x 11 7/8" (2-45x300) $LVL7 = 3-13/4" \times 117/8" (3-45\times300)$ LVL7A = 4-1 3/4" x 11 7/8" (4-45x300)

LVLIA = I-I 3/4" x 7 I/4" (I-45xI84)

LVL8 = 2-1 3/4" x 14" (2-45x356) LVL9 = 3-1 3/4" x 14" (3-45x356) LVLIO = 2-1 3/4" x 18" (3-45x456)

LOOSE STEEL LINTELS

LI = 3-1/2"x3-1/2"x1/4"L (90x90x6.0L) L2 = 4"x3-1/2"x5/16"L (100x90x8.0L)

L3 = 5"x3-1/2"x5/16"L (125x90x8.0L) L4 = 6"x3-1/2"x3/8"L (150x90x10.0L)

L5 = 6"x4"x3/8"L (150x100x10.0L) L6 = 7"x4"x3/8"L (175x100x10.0L)

DOOR SCHEDULE

I = 2'-10" x 6'-8" (865x2033) - INSULATED ENTRANCE DOOR la = 2'-8" x 6'-8" (815x2033) - INSULATED FRONT DOORS 2 = 2'-8" x 6'-8" (815x2033) - WOOD & GLASS DOOR

3 = 2'-8" x 6'-8 x 1-3/4" (815x2033x45) - EXTERIOR SLAB DOOR 4 = 2'-8" x 6'-8" x 1-3/8" (815x2033x35) - INTERIOR SLAB DOOR 5 = 2'-6" x 6'-8" x 1-3/8" (760x2033x35) - INTERIOR SLAB DOOR

6 = 2'-2" x 6'-8" x I-3/8" (660x2033x35) - INTERIOR SLAB DOOR

7 = |'-6" \times 6'-8" \times |-3/8" (460 \times 2033 \times 35) - INTERIOR SLAB DOOR

SPACE CONVENTIONAL FLOOR JOISTS @ 12" O.C. BELOW ALL CERAMIC TILE AREAS. PROVIDE I ROW BRIDGING FOR SPANS OF 5'-7', 2 ROWS FOR SPANS GREATER THAN 7

REFER TO ROOF TRUSS SHOP DRAWINGS FOR ALL ROOF FRAMING INFORMATION

PLANS NOT DRAWN TO ACTUAL GRADE. REFER TO FINAL GRADING PLAN.

REFER TO FLOOR FRAMING SHOP DRAWINGS FOR ENGINEERED FRAMING LAYOUTS

2 - 1 1/2" x 5 1/2" TIMBERSTRAND (LSL) 1.5E STUD WALL GLUED AND NAILED TOGETHER AND SPACED MAX. @10"O.C. FULL HT C/W SOLID BLOCKING MAX. 8'-0"O.C. VERTICAL AND 7/16" EXT. OSB SHEATHING.

> 10" | 10"

MAXIMUM HEIGHT OF WALL FOR THIS DETAIL IS $20^{\circ}-2^{\circ}$ AND MAXIMUM SUPPORTED LENGTH OF TRUSS IS $40^{\circ}-0^{\circ}$


TWO STORY HEIGHT WALL DETAIL

2 - 1 1/2" x 5 1/2" TIMBERSTRAND (LSL) 1.5E STUD WALL GLUED AND NAILED TOGETHER AND SPACED MAX, @9"O.C. FULL HT C/W SOLID BLOCKING MAX. 8'-0"O.C. VERTICAL AND 7/16" EXT. OSB SHEATHING.

q"

MAXIMUM HEIGHT OF WALL FOR THIS DETAIL IS 21'-5" AND AND MAXIMUM SUPPORTED LENGTH OF TRUSS IS 40'-0"

TWO STORY HEIGHT WALL DETAIL

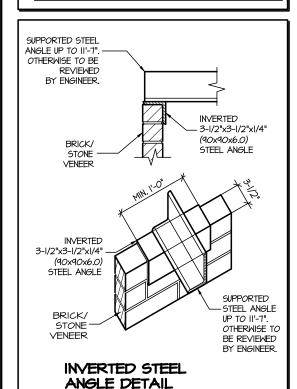

THE MINIMUM THERMAL PERFORMANCE OF BUILDING ENVELOPE AND EQUIPMENT SHALL CONFORM TO THE

- BASEMENT FLOOR TO FLOOR HEIGHT

OPTIONAL 8'-6" FOUNDATION POUR HEIGHT 10" THICK CONCRETE FOUNDATION WALLS (15 MPa)

• 91/2" FLOOR JOISTS = 9'-2" (2.79m) HEIGHT • 11 %" FLOOR JOISTS = 9'-4" (2.84m) HEIGHT

• 15 RISERS (EXTRA RISER ADDED TO BASE OF STAIR)

| COMPLIANCE PACKAGE "AI" | | | | | | | |
|------------------------------------|--|--|--|--|--|--|--|
| NOTE | | | | | | | |
| 10.57 (R60) | | | | | | | |
| 5.46 (R31) | | | | | | | |
| 5.46 (R31) | | | | | | | |
| 3.87 (R22) | | | | | | | |
| 3.52 (R20 BLANKET) | | | | | | | |
| 1.76 (RIO) | | | | | | | |
| ENERGY RATING = 25, MAX. U=0.28 | | | | | | | |
| 96% | | | | | | | |
| 75% | | | | | | | |
| MIN. EF 0.80 | | | | | | | |
| | | | | | | | |
| | | | | | | | |

| VILLA 10 - EL | EV. I | | | | SB-12 |
|---------------|-------------------------|-------------|-------------------------|--------------|------------|
| ELEVATION | WALL FT ² | (WALL M²) | OPENING FT ² | (OPENING M²) | PERCENTAGE |
| FRONT | 675.97 | (62.80) | 90.60 | (8.42) | 13.40 % |
| LEFT SIDE | 1101.61 | (102.34) | 195.33 | (18.15) | 17.73 % |
| RIGHT SIDE | 1097.22 | (101.94) | 53.83 | (5.00) | 4.91 % |
| REAR | 667.59 | (62.02) | 135.61 | (12.60) | 20.31 % |
| TOTAL | 3542.39 FT ² | (329.10 M²) | 475.31 FT ² | (44.16M²) | 13.42 % |

| VILLA 10 - EL | LY. Z | | | | 5B -12 |
|------------------|-------------------------|-------------|-------------------------|--------------|-------------------|
| ELEVATION | WALL FT ² | (WALL M²) | OPENING FT ² | (OPENING M²) | PERCENTAGE |
| FRONT | 675.97 | (62.80) | 114.55 | (10.64) | 16.45 % |
| LEFT SIDE | 1101.61 | (102.34) | 228.93 | (21.27) | 20.78 % |
| RIGHT SIDE | 1097.22 | (101.94) | 48.83 | (4.54) | 4.45 % |
| REAR | 667.59 | (62.02) | 135.61 | (12.60) | 20.31 % |
| | | | | | |
| TOTAL | 3542.34 FT ² | (329.10 M²) | 527.92 FT ² | (49.05M²) | 14.90 % |

| VILLA 10 - ELE | EV. 3 | | | | SB-12 |
|----------------|-------------------------|-------------|-------------------------|--------------|------------|
| ELEVATION | WALL FT ² | (WALL M²) | OPENING FT ² | (OPENING M²) | PERCENTAGE |
| FRONT | 685.56 | (63.69) | 142.58 | (13.25) | 20.80 % |
| LEFT SIDE | 1101.61 | (102.34) | 210.33 | (19.54) | 19.09 % |
| RIGHT SIDE | 1097.22 | (101.94) | 48.83 | (4.54) | 4.45 % |
| REAR | 688.50 | (63.96) | 135.61 | (12.60) | 19.70 % |
| | | | | | |
| TOTAL | 3512.64 FT ² | (331.93 M²) | 537.35 FT ² | (49.92M²) | 15.04 % |

It is the builder's complete responsibility to ensure that all plans submitted for approval fully comply with the Architectural Guidelines and all applicable regulations and requirements including zoning provisions and any provisions in the subdivision agreement. The Control Architect is not responsible in any way for examining or approving site (lotting) plans or working drawings with respect to any zoning or working drawings with respect to any zoning or building code or permit matter or that any uilding code or permit matter or that an ouse can be properly built or located on its lo


W Architect Inc. **DESIGN CONTROL REVIEW** NOV. 01, 2023 FINAL BY: All:

| AREA CALCULATIONS | | | | ELEV | <u>/. l</u> |
|-------------------------|---|---|---|---------|-------------|
| GROUND FLOOR AREA | | | = | | Sq. Ft. |
| SECOND FLOOR AREA | | | = | 1556 | Sq. Ft. |
| TOTAL FLOOR AREA | | | = | 2725 | Sq. Ft. |
| | | | | 253.16 | Sq. M. |
| Ist FLOOR OPEN AREA | = | 0 | | Sq. Ft. | |
| 2nd FLOOR OPEN AREA | = | 0 | | Sq. Ft. | |
| ADD TOTAL OPEN AREAS | | | = | 0 | Sq. Ft. |
| ADD FIN. BASEMENT AREA | | | = | 0 | Sq. Ft. |
| GROSS FLOOR AREA | | | = | 2725 | Sq. Ft. |
| | | | | 253.16 | Sq. M. |
| GROUND FLOOR COVERAGE | | | = | 1169 | Sq. Ft. |
| GARAGE COVERAGE / AREA | | | = | 396 | Sq. Ft. |
| PORCH COVERAGE / AREA | | | = | 57 | Sq. Ft. |
| TOTAL COVERAGE W/ PORCH | | | = | 1622 | Sq. Ft. |
| | | | = | 150.69 | Sq. m. |
| TOTAL COVERAGE WO PORCH | | | = | 1565 | Sq. Ft. |
| | | | = | 145.39 | Sq. m. |

| AREA CALCULATIONS | | | | ELEV | / . 2 |
|---|---|---|---|--------------------------|--------------------|
| GROUND FLOOR AREA | | | = | 1204 | Sq. Ft. |
| SECOND FLOOR AREA | | | = | 1525 | Sq. Ft. |
| TOTAL FLOOR AREA | | | = | 2729 | Sq. Ft. |
| | | | | 253.53 | Sq. M. |
| Ist FLOOR OPEN AREA | = | 0 | | Sq. Ft. | |
| 2nd FLOOR OPEN AREA | = | 0 | | Sq. Ft. | |
| ADD TOTAL OPEN AREAS | | | = | 0 | Sq. Ft. |
| ADD FIN. BASEMENT AREA | | | = | 0 | Sq. Ft. |
| GROSS FLOOR AREA | | | = | 2729 | Sq. Ft. |
| | | | | 253.53 | Sq. M. |
| | | | | | |
| GROUND FLOOR COVERAGE | | | = | 1204 | Sq. Ft. |
| GROUND FLOOR COVERAGE GARAGE COVERAGE / AREA | | | = | 1204 396 | - |
| | | | | | |
| GARAGE COVERAGE / AREA | | | = | 396 | Sq. Ft. |
| GARAGE COVERAGE / AREA PORCH COVERAGE / AREA | | | = | 396 57 | Sq. Ft. Sq. Ft. |
| GARAGE COVERAGE / AREA PORCH COVERAGE / AREA | | | = | 396 57 1657 | Sq. Ft. Sq. Ft. |

| AREA CALCULATIONS | | | | ELEV | 4.3 |
|-------------------------|---|---|---|---------|------------|
| GROUND FLOOR AREA | | | = | 1182 | Sq. Ft. |
| SECOND FLOOR AREA | | | = | 1530 | Sq. Ft. |
| TOTAL FLOOR AREA | | | = | 2712 | Sq. Ft. |
| | | | | 251.95 | Sq. M. |
| Ist FLOOR OPEN AREA | = | 0 | | Sq. Ft. | |
| 2nd FLOOR OPEN AREA | = | 0 | | Sq. Ft. | |
| ADD TOTAL OPEN AREAS | | | = | 0 | Sq. Ft. |
| ADD FIN. BASEMENT AREA | | | = | 0 | Sq. Ft. |
| GROSS FLOOR AREA | | | = | 2712 | Sq. Ft. |
| | | | | 251.95 | Sq. M. |
| GROUND FLOOR COVERAGE | | | = | 1182 | Sq. Ft. |
| GARAGE COVERAGE / AREA | | | = | 396 | Sq. Ft. |
| PORCH COVERAGE / AREA | | | = | 57 | Sq. Ft. |
| TOTAL COVERAGE W/ PORCH | | | = | 1635 | Sq. Ft. |
| | | | = | 151.90 | 5q. m. |
| TOTAL COVERAGE WO PORCH | | | = | 1578 | Sq. Ft. |
| IDIAL COVERAGE NO PORCH | | | 1 | | |
| TOTAL COVERAGE NO FORCH | | | = | 146.60 | Sq. m. |

COMPLIANCE PACKAGE "A1"

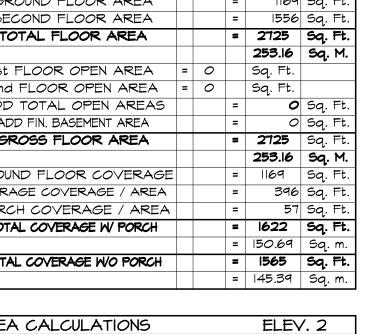

| PEN AREA | = | 0 | | Sq. Ft. | | |
|------------|---|---|---|---------|-----|------|
| PEN AREAS | | | = | 0 | Sq. | Ft. |
| MENT AREA | | | = | 0 | Sq. | Ft. |
| OR AREA | | | = | 2729 | Sq. | Ft. |
| | | | | 253.53 | Sq. | М. |
| COVERAGE | | | = | 1204 | Sq. | ⊨t. |
| AGE / AREA | | | = | 396 | Sq. | Ft. |
| AGE / AREA | | | = | 57 | Sq. | Ft. |
| E W PORCH | | | = | 1657 | Sq. | Ft. |
| | | | = | 153.94 | Sq. | |
| E WO PORCH | | | = | 1600 | Sq. | Ft. |
| | | | = | 148.65 | Sq. | . m. |
| • | | | | - | | |
| _ATIONS | | | | ELEV | 1.3 | |
| OR AREA | | | = | | Sq. | |
| OR AREA | | | = | 1530 | Sq. | Ft. |
| | | | | | | |

UPDTATED FROM VALLEYCREEK 11 MAR 2023 **REVISIONS** The undersigned has reviewed and takes responsibility for this design, and has the qualifications and meets the requirements set out in the Ontario Building Code to be a designer. QUALIFICATION INFORMATION

28770 VIKAS GAJJAR SIGNATURE NAME **BCIN**

SHEET TITLE **GENERAL NOTES**

2,725 SQ.FT. V.G. ROJECT NAME **TRINIGROUP**

Region Design Inc. **EGION** 8700 Dufferin St. Concord, Ontario **ESIGN** (416) 736-4096


fax (905) 660-0746 Contractor shall check all dimensions and elevations before commencing with work and report any discrepancies to the designer. Prints are not to be scaled.



MAR 2023 3/16"=1'-0" PROJECT NO.

CITY OF RICHMOND HILL **BUILDING DIVISION** 08/21/2024 **REVISED**

Per:___KER__

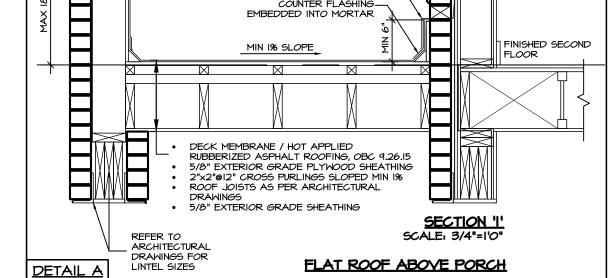

THROUGH WALL FLASHING

WEEP HOLES-

Richmond Hill

INSPECTION NOTICES - HOUSING You are required to notify the Inspection Section of the

readiness to inspect at the following construction stages: - Footings (prior to concrete placement)

Building sewers (laterals) - Water service pipe (lateral)
- Foundation (prior to backfill)

Building drains (under slab) - Plumbing rough-in - HVAC rough-in Air barrier (prior to exterior cladding)
 Structural Framing (exterior cladding completed)
 Insulation (include vapour barrier)

· Solid fuel burning appliances Occupancy Permit

Inspection fax line: 905-771-2528 Inspection Request Line: 905-771-5465

Please contact the Inspection Section by one of the following methods:
- E-mail: buildinginspections@richmondhill.ca

A minimum of 2 business days is required. An inspection may be refused if permit documents and a copy of the permit are not present on site. of the permit card.

Richmond Hill

City of Richmond Hill **Building Division**

REVIEWED Date: 10/24/2024

Building Permit #: RM#24-00030

All construction shall comply with the Ontario Building Code and all other applicable statutory regulations. The reviewed documents must be kept on site at all times. Building inspection line: 905-771-5465 (24 hr) buildinginspections@richmondhill.ca Building inquiry line 905-771-8810 building @richmondhill.ca

This review does not exempt the owner, designer and the builder from complying with all applicable regulations and by-laws of the City of Richmond Hill and the Ontario Building Code.

Refer to attached general notes and drawings.

Windows, sliding glass doors and skylights shall comply with OBC 2012, SB-12, 3.1.1.9 for maximum U-Value.


These drawings have been reviewed under Compliance Option:_ of the OBC 2012, SB-12.

It is the builder's complete responsibility to ensure that all plans submitted for approval fully comply with the Architectural Guidelines and all applicable regulations and requirements including zoning provisions and any provisions in the subdivision agreement. The Control Architect is not responsible in any way for examining or approving site (lotting) plans or working drawings with respect to any zoning or building code or permit matter or that any house can be properly built or located on its lot.

This is to certify that these plans comply with the applicable Architectural Design Guidelines approved by the City of HAMILTON.

VILLA 10

COMPLIANCE PACKAGE "A1"

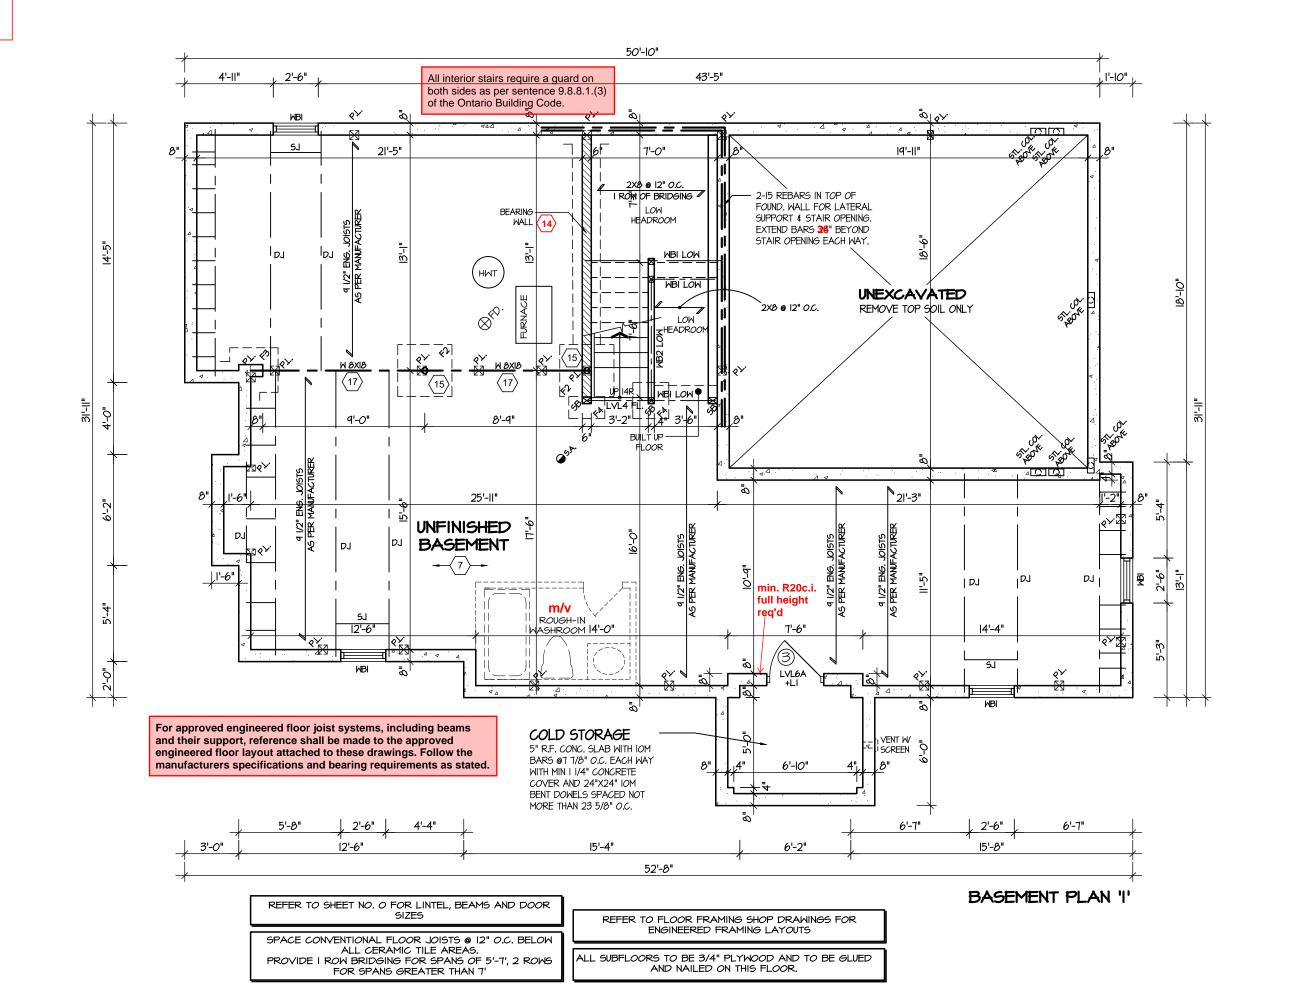

THE ENGINEER OF RECORD SHALL PROVIDE THE BUILDING INSPECTOR WITH A FIELD REVIEW REPORT

> STRUDET INC. B. MARINKOVIC 魚 FOR STRUCTURE ONLY

CITY OF RICHMOND HILL **BUILDING DIVISION** 08/21/2024

REVISED

Per:___KER_

2,725 SQ.FT. V.G. PROJECT NAME TRINIGROUP Region Design Inc. **EGION** 8700 Dufferin St. Concord, Ontario L4K 4S6 (416) 736-4096 fax (905) 660-0746

. UPDTATED FROM VALLEYCREEK 11

VIKAS GAJJAR

NAME

SHEET TITLE

REVISIONS

The undersigned has reviewed and takes responsibility for this

design, and has the qualifications and meets the requirements set

out in the Ontario Building Code to be a designer.

QUALIFICATION INFORMATION

BASEMENT PLAN


ELEVATION 1


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MAR 2023 3/16"=1'-0" PROJECT NO.

MAR 2023

28770




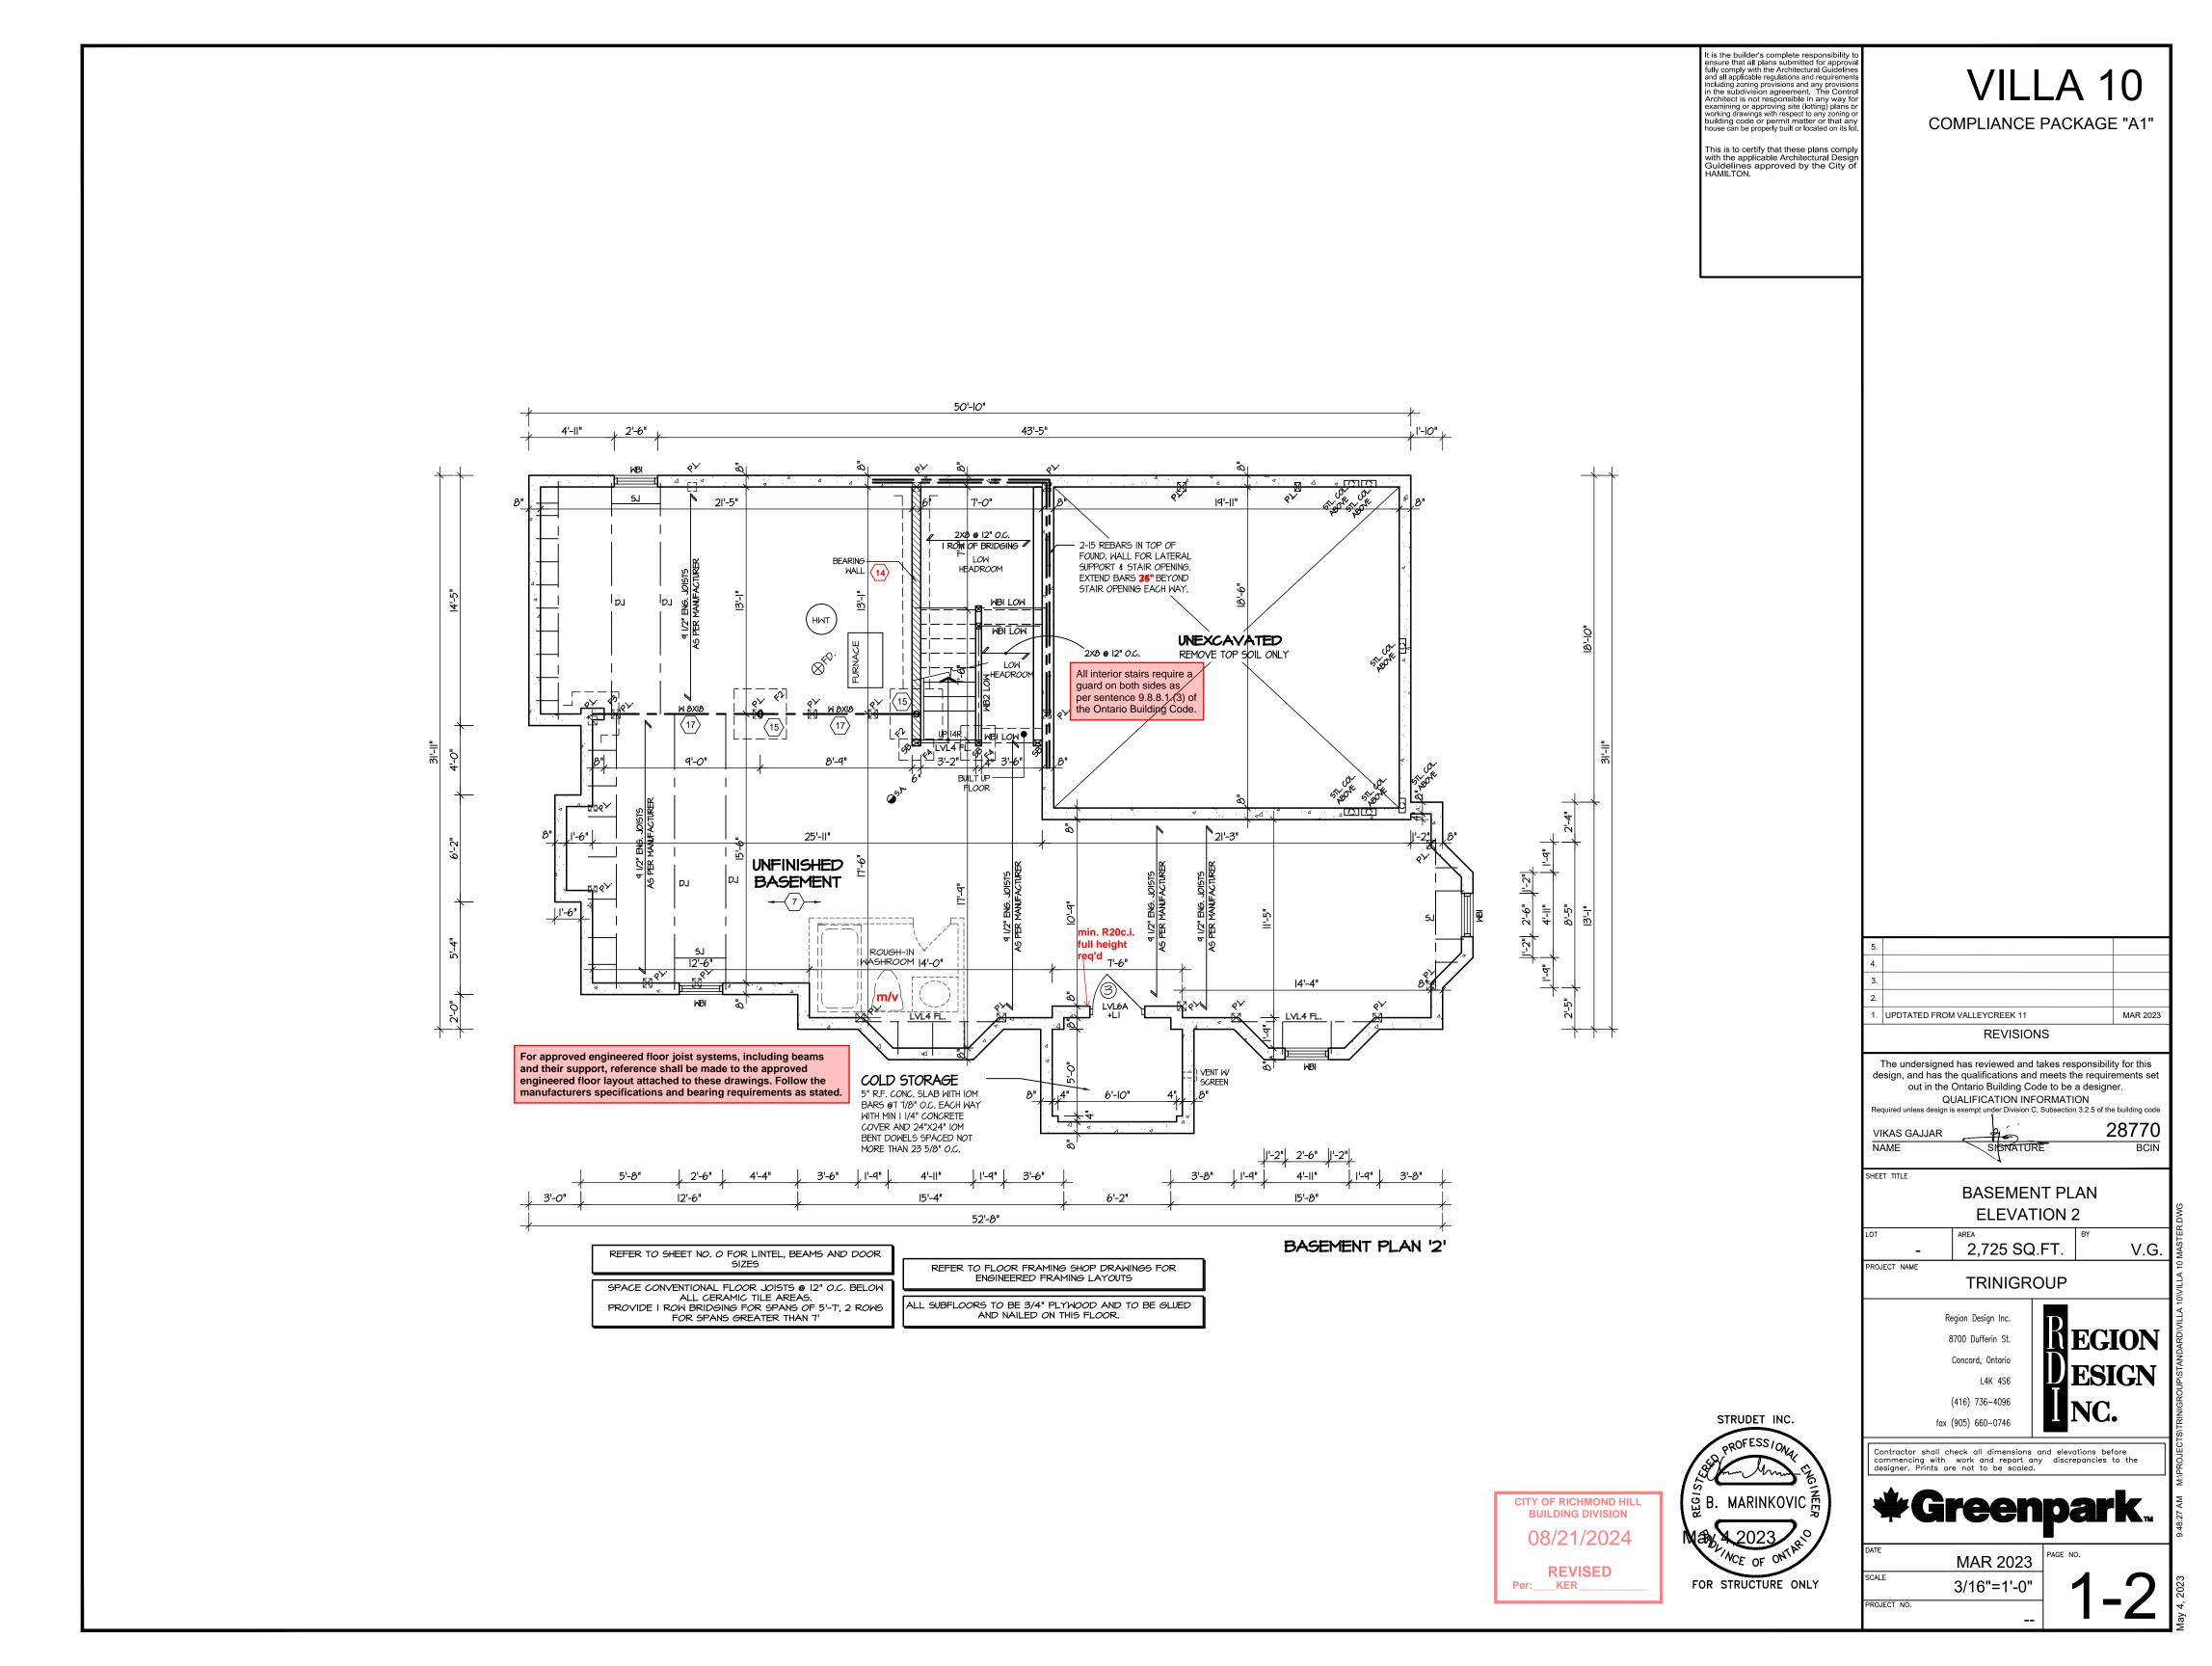

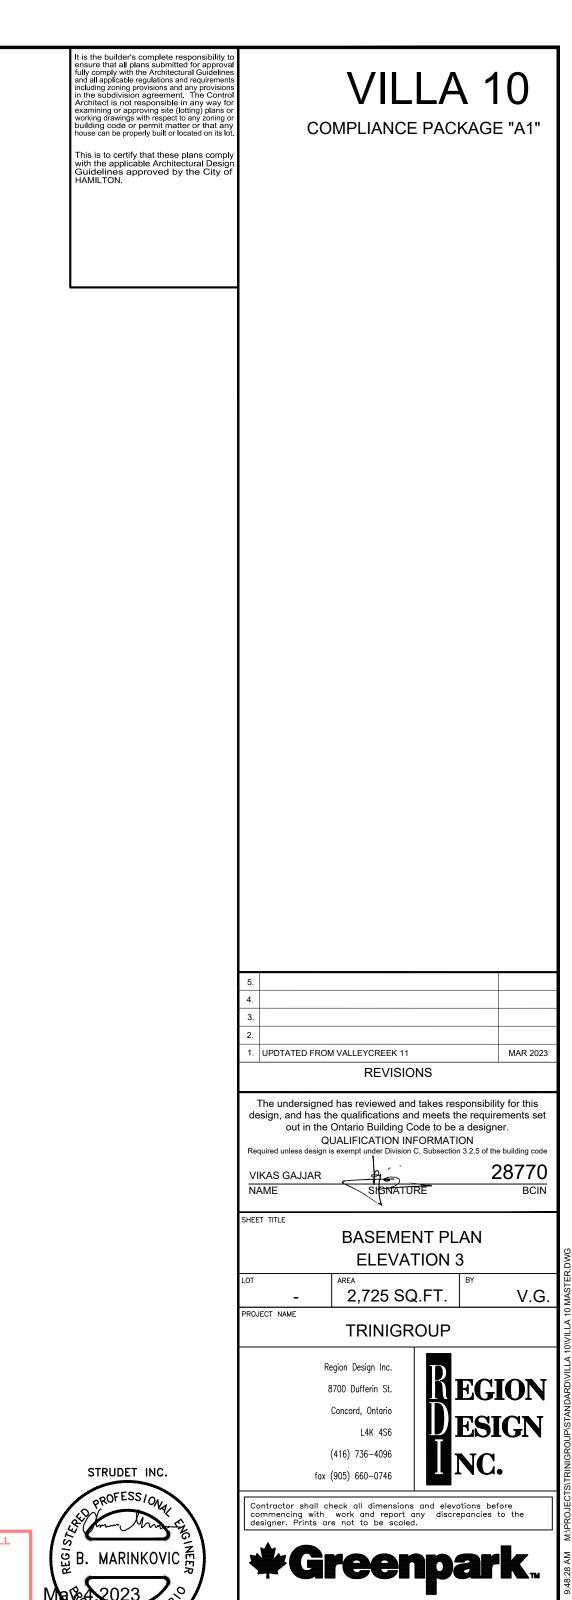MAR 2023

3/16"=1'-0"

PROJECT NO.

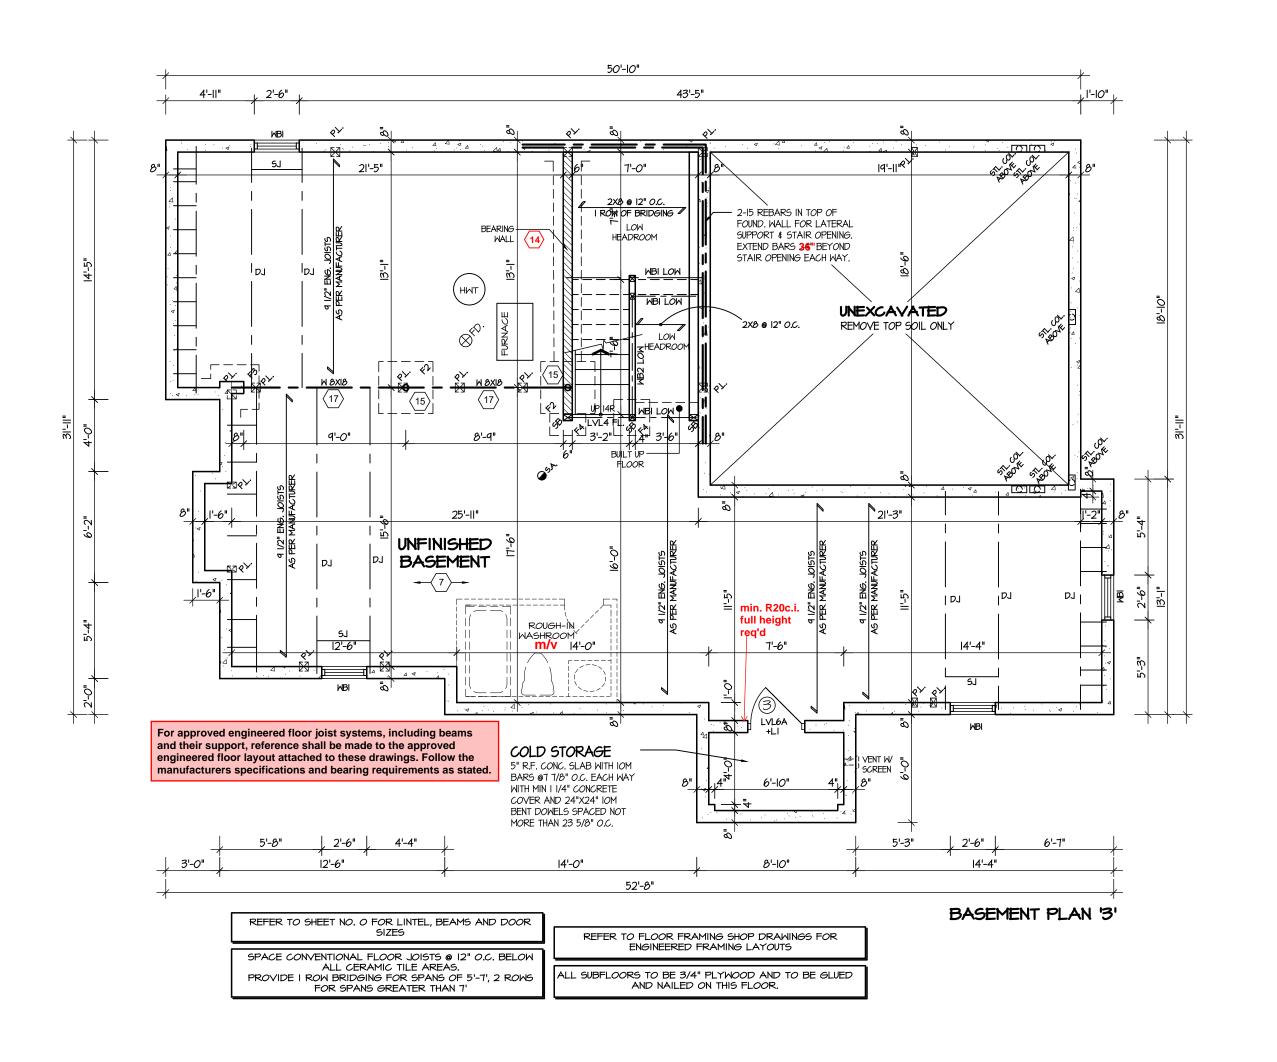


CITY OF RICHMOND HILL **BUILDING DIVISION** 08/21/2024

REVISED


Per:___KER__

FOR STRUCTURE ONLY

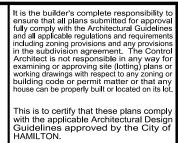

VILLA 10

COMPLIANCE PACKAGE "A1"

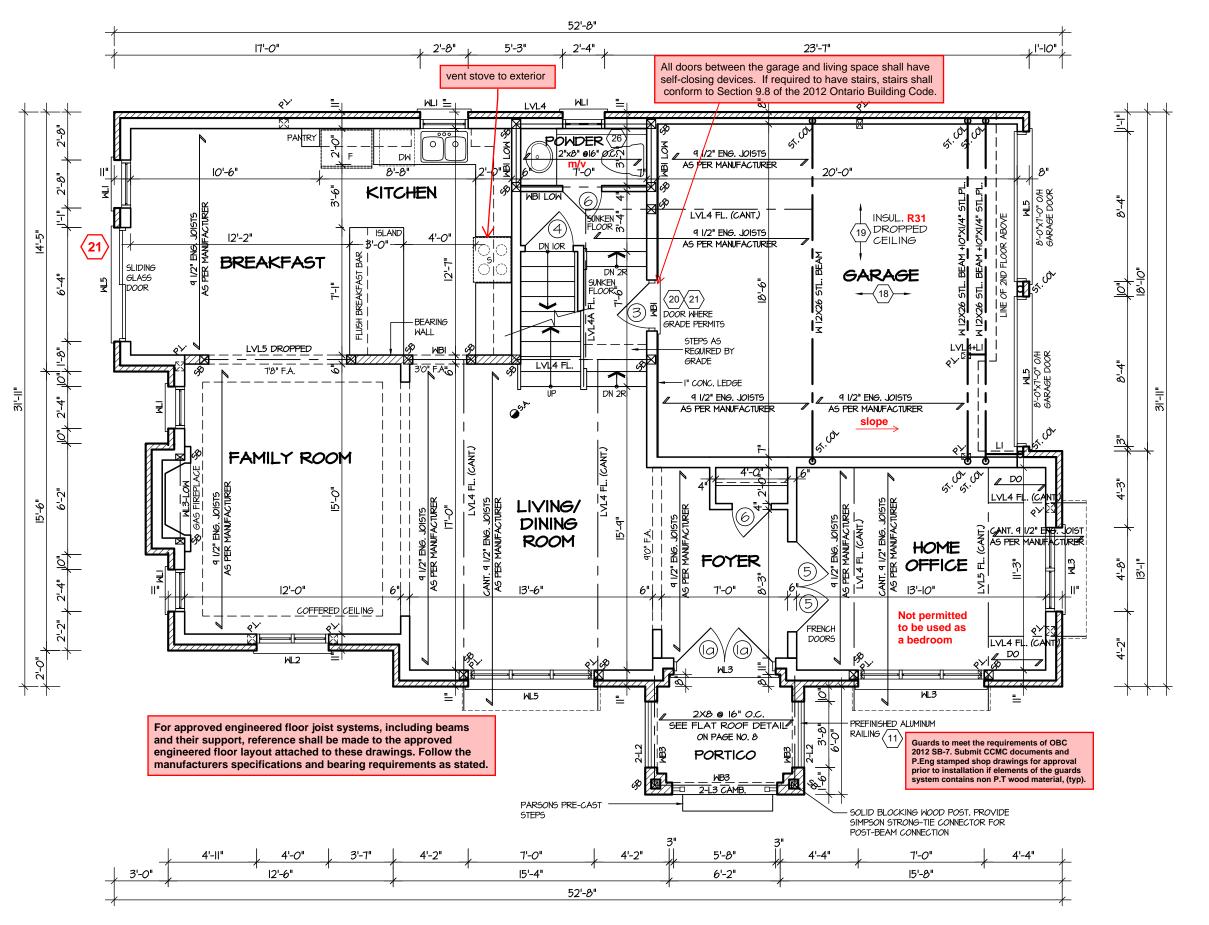


FIRST FLOOR PLAN I

STRUDET INC. B. MARINKOVIC A FOR STRUCTURE ONLY

BUILDING DIVISION 08/21/2024

REVISED

Per:___KER__

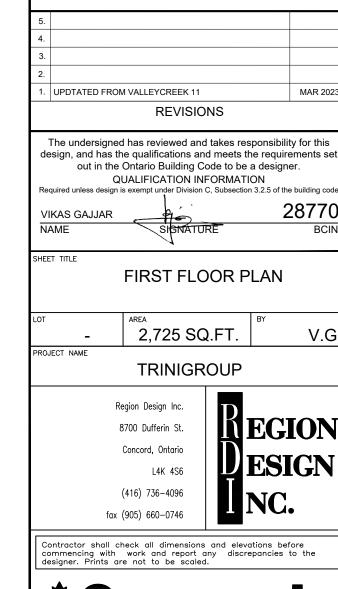

MAR 2023

3/16"=1'-0"

PROJECT NO.

MAR 2023


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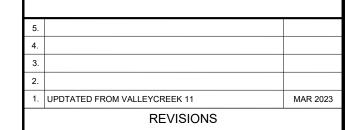
V.G.



VILLA 10 **COMPLIANCE PACKAGE "A1"**

This is to certify that these plans comply with the applicable Architectural Desigr Guidelines approved by the City of HAMILTON.



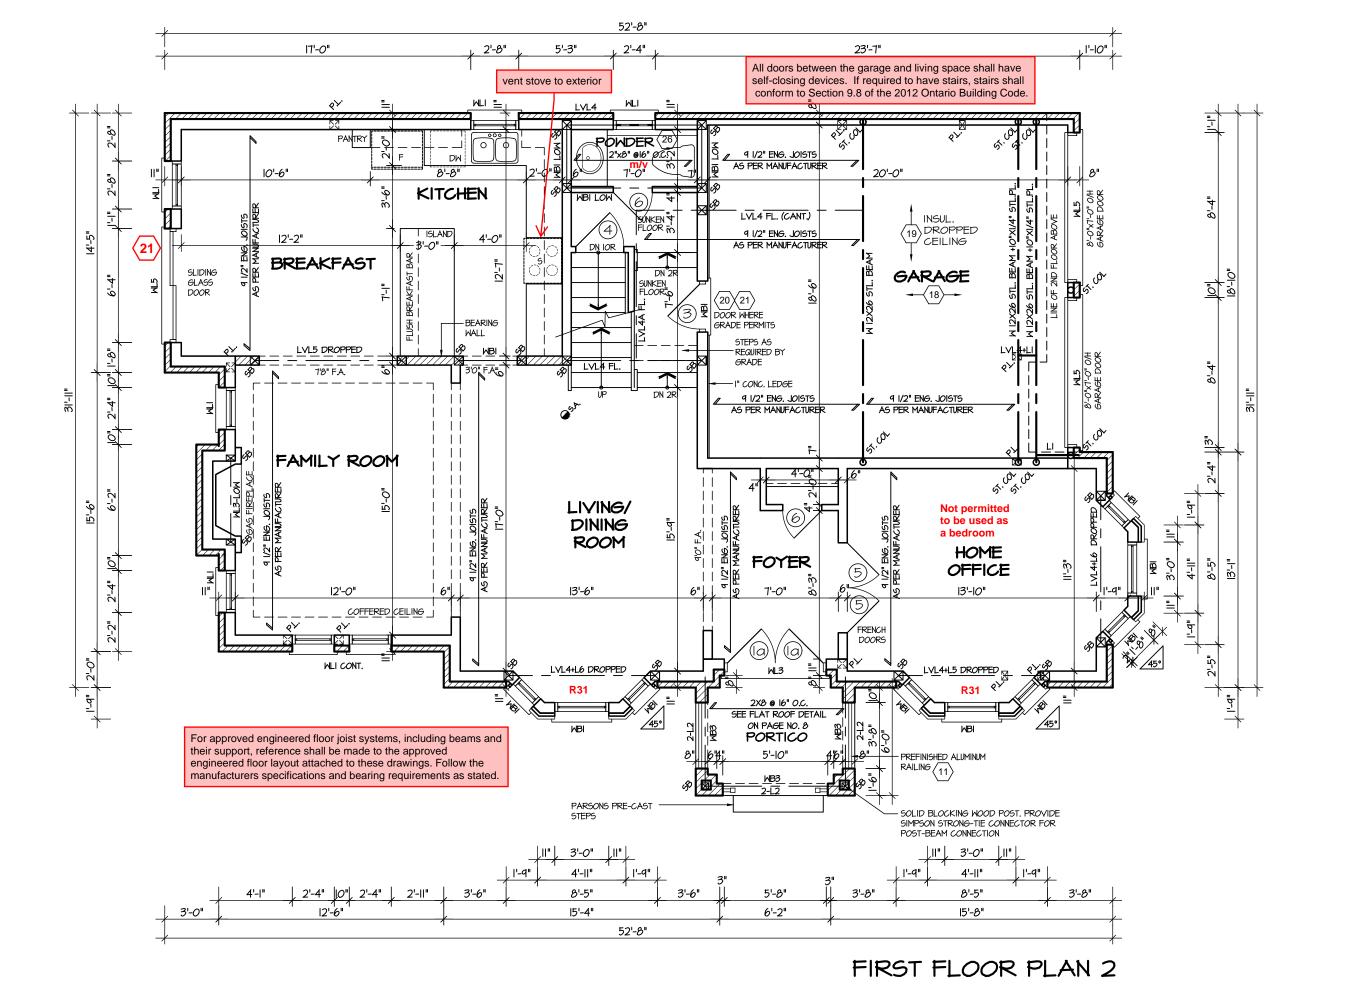

The undersigned has reviewed and takes responsibility for this design, and has the qualifications and meets the requirements set out in the Ontario Building Code to be a designer. QUALIFICATION INFORMATION 28770 VIKAS GAJJAR NAME

SHEET TITLE FIRST FLOOR PLAN **ELEVATION 2** 2,725 SQ.FT. V.G. PROJECT NAME

TRINIGROUP

Region Design Inc. 8700 Dufferin St. Concord, Ontario (416) 736-4096

MEGION ESIGN fax (905) 660-0746

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MAR 2023 3/16"=1'-0" PROJECT NO.


STRUDET INC.


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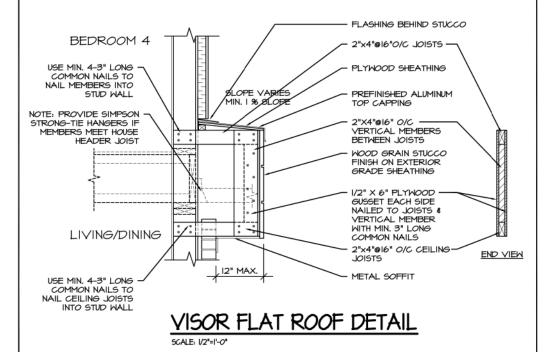
일 B. MARINKOVIC 흙

FOR STRUCTURE ONLY

CITY OF RICHMOND HILL **BUILDING DIVISION** 08/21/2024 **REVISED**



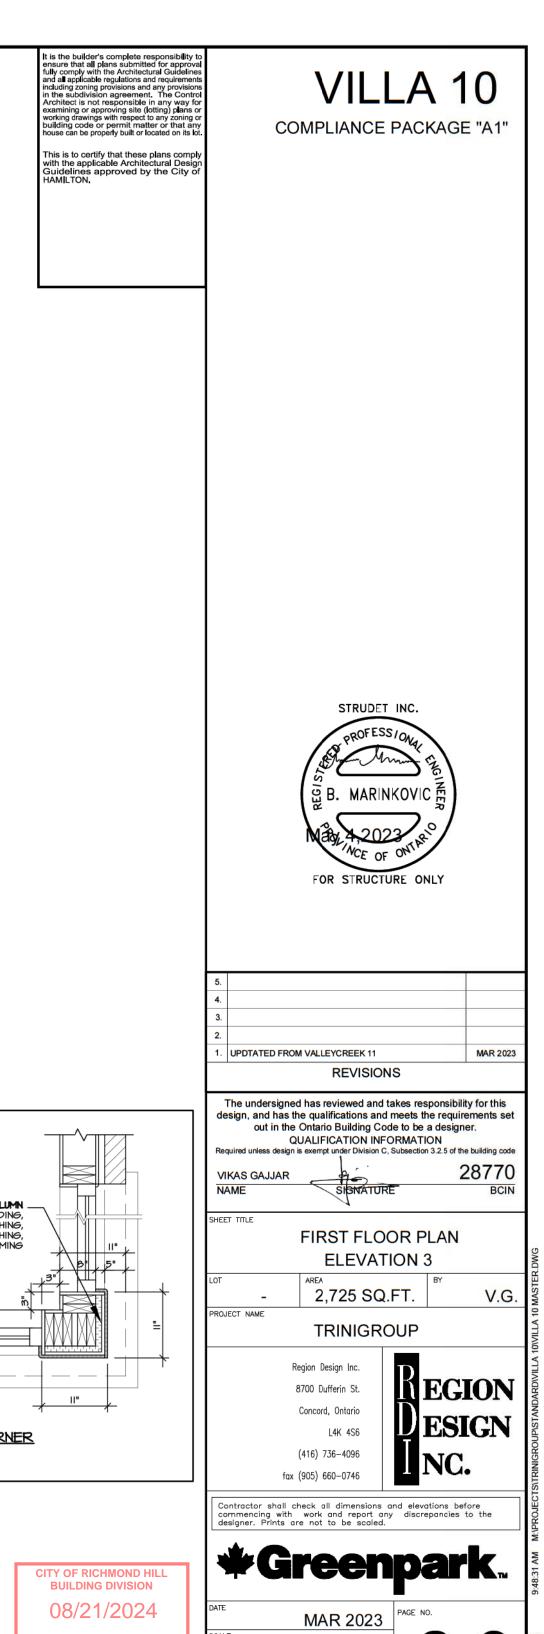

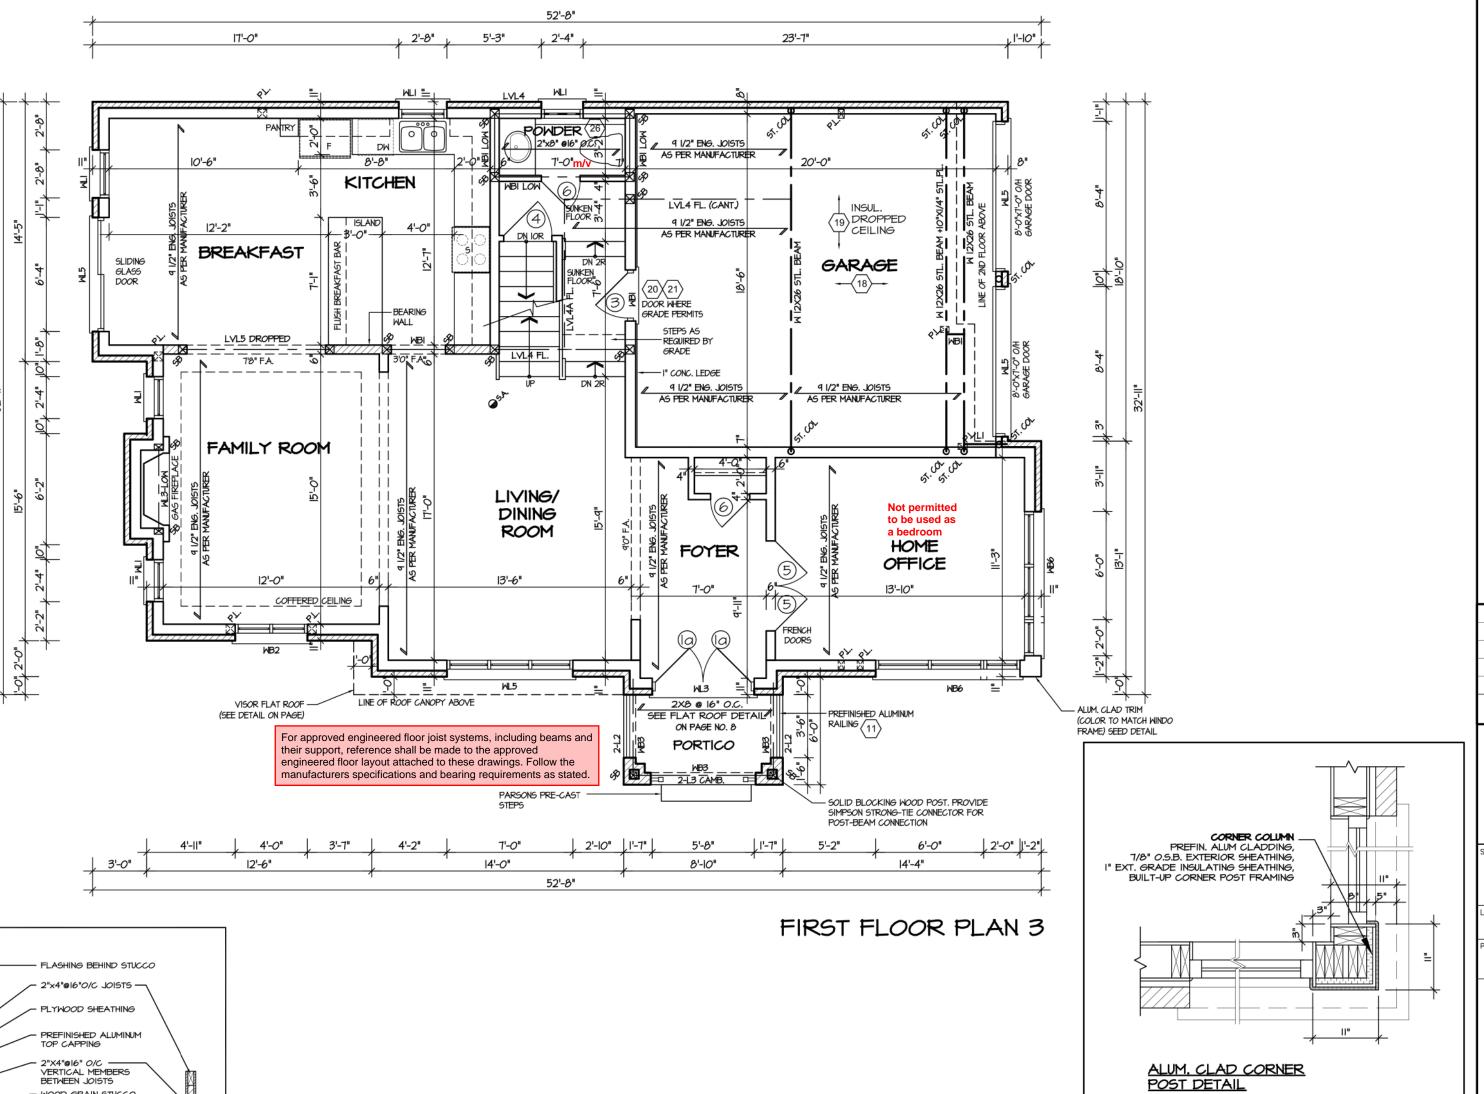

REVISED

Per:___KER__


SCALE 3/16"=1'-0" PROJECT NO.


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VILLA 10

COMPLIANCE PACKAGE "A1"



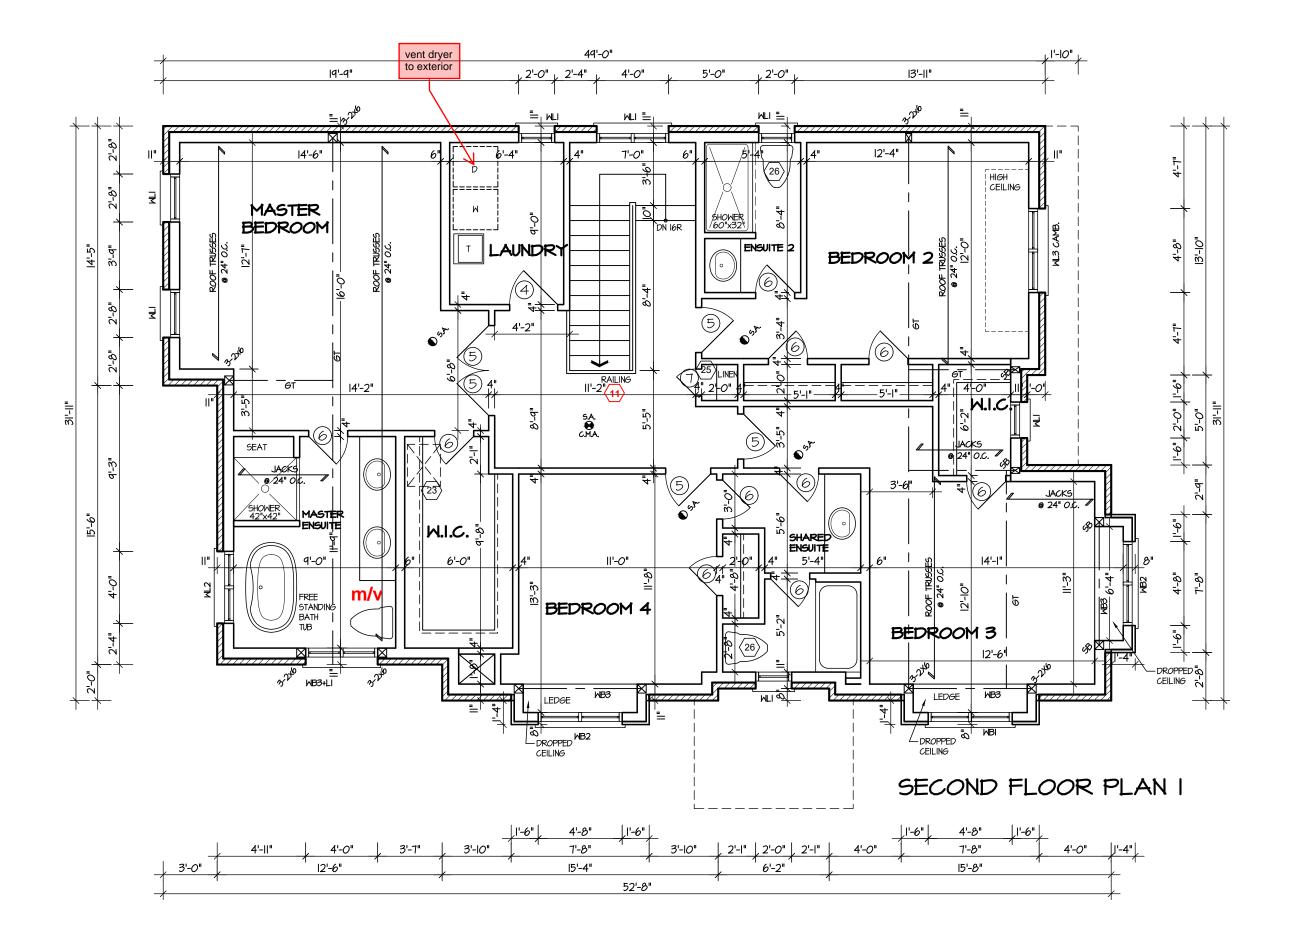

SECOND FLOOR PLAN STANDARD - ELEV 1 2,725 SQ.FT. V.G. TRINIGROUP Region Design Inc.

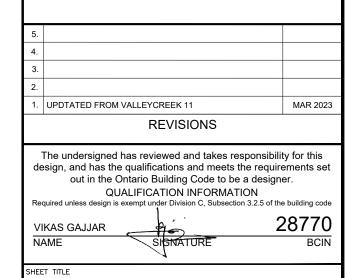MEGION 8700 Dufferin St. Concord, Ontario L4K 4S6 (416) 736-4096 fax (905) 660-0746

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MAR 2023 3/16"=1'-0" PROJECT NO.

STRUDET INC.


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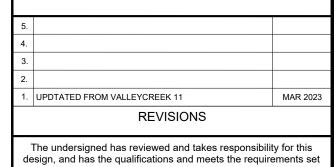
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VILLA 10

COMPLIANCE PACKAGE "A1"





out in the Ontario Building Code to be a designer. QUALIFICATION INFORMATION
sign is exempt under Division C, Subsection 3.2.5 of the building cod-28770 VIKAS GAJJAR NAME

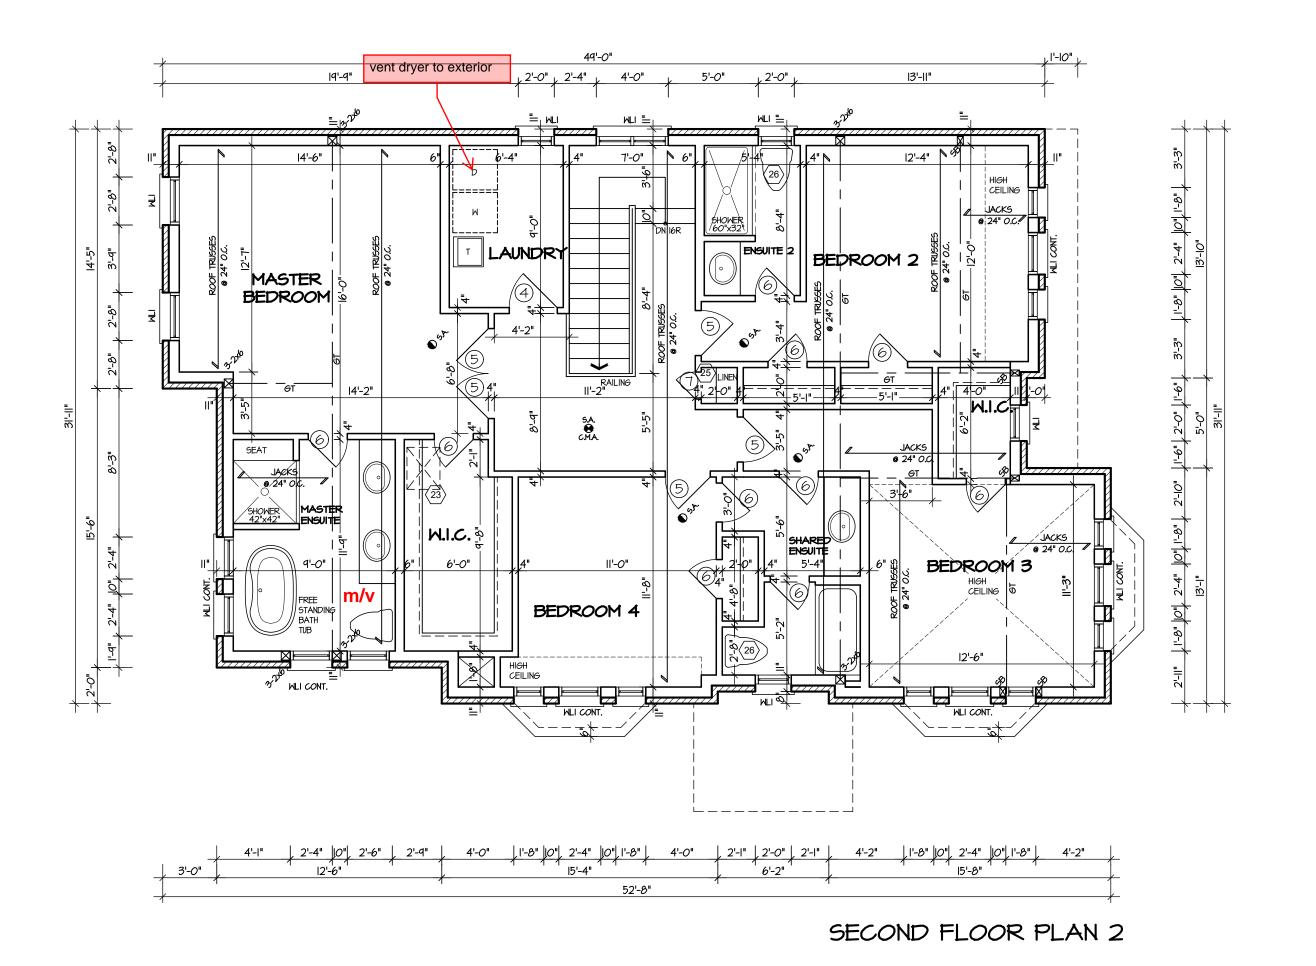SHEET TITLE SECOND FLOOR PLAN ELEV 2 - STANDARD

V.G. 2,725 SQ.FT. PROJECT NAME TRINIGROUP

> Region Design Inc. **MEGION** 8700 Dufferin St. Concord, Ontario (416) 736-4096

fax (905) 660-0746 Contractor shall check all dimensions and elevations before commencing with work and report any discrepancies to the designer. Prints are not to be scaled.

***Greenpark**...


MAR 2023 3/16"=1'-0" PROJECT NO.

STRUDET INC.

B. MARINKOVIC

FOR STRUCTURE DONLY

ESIGN

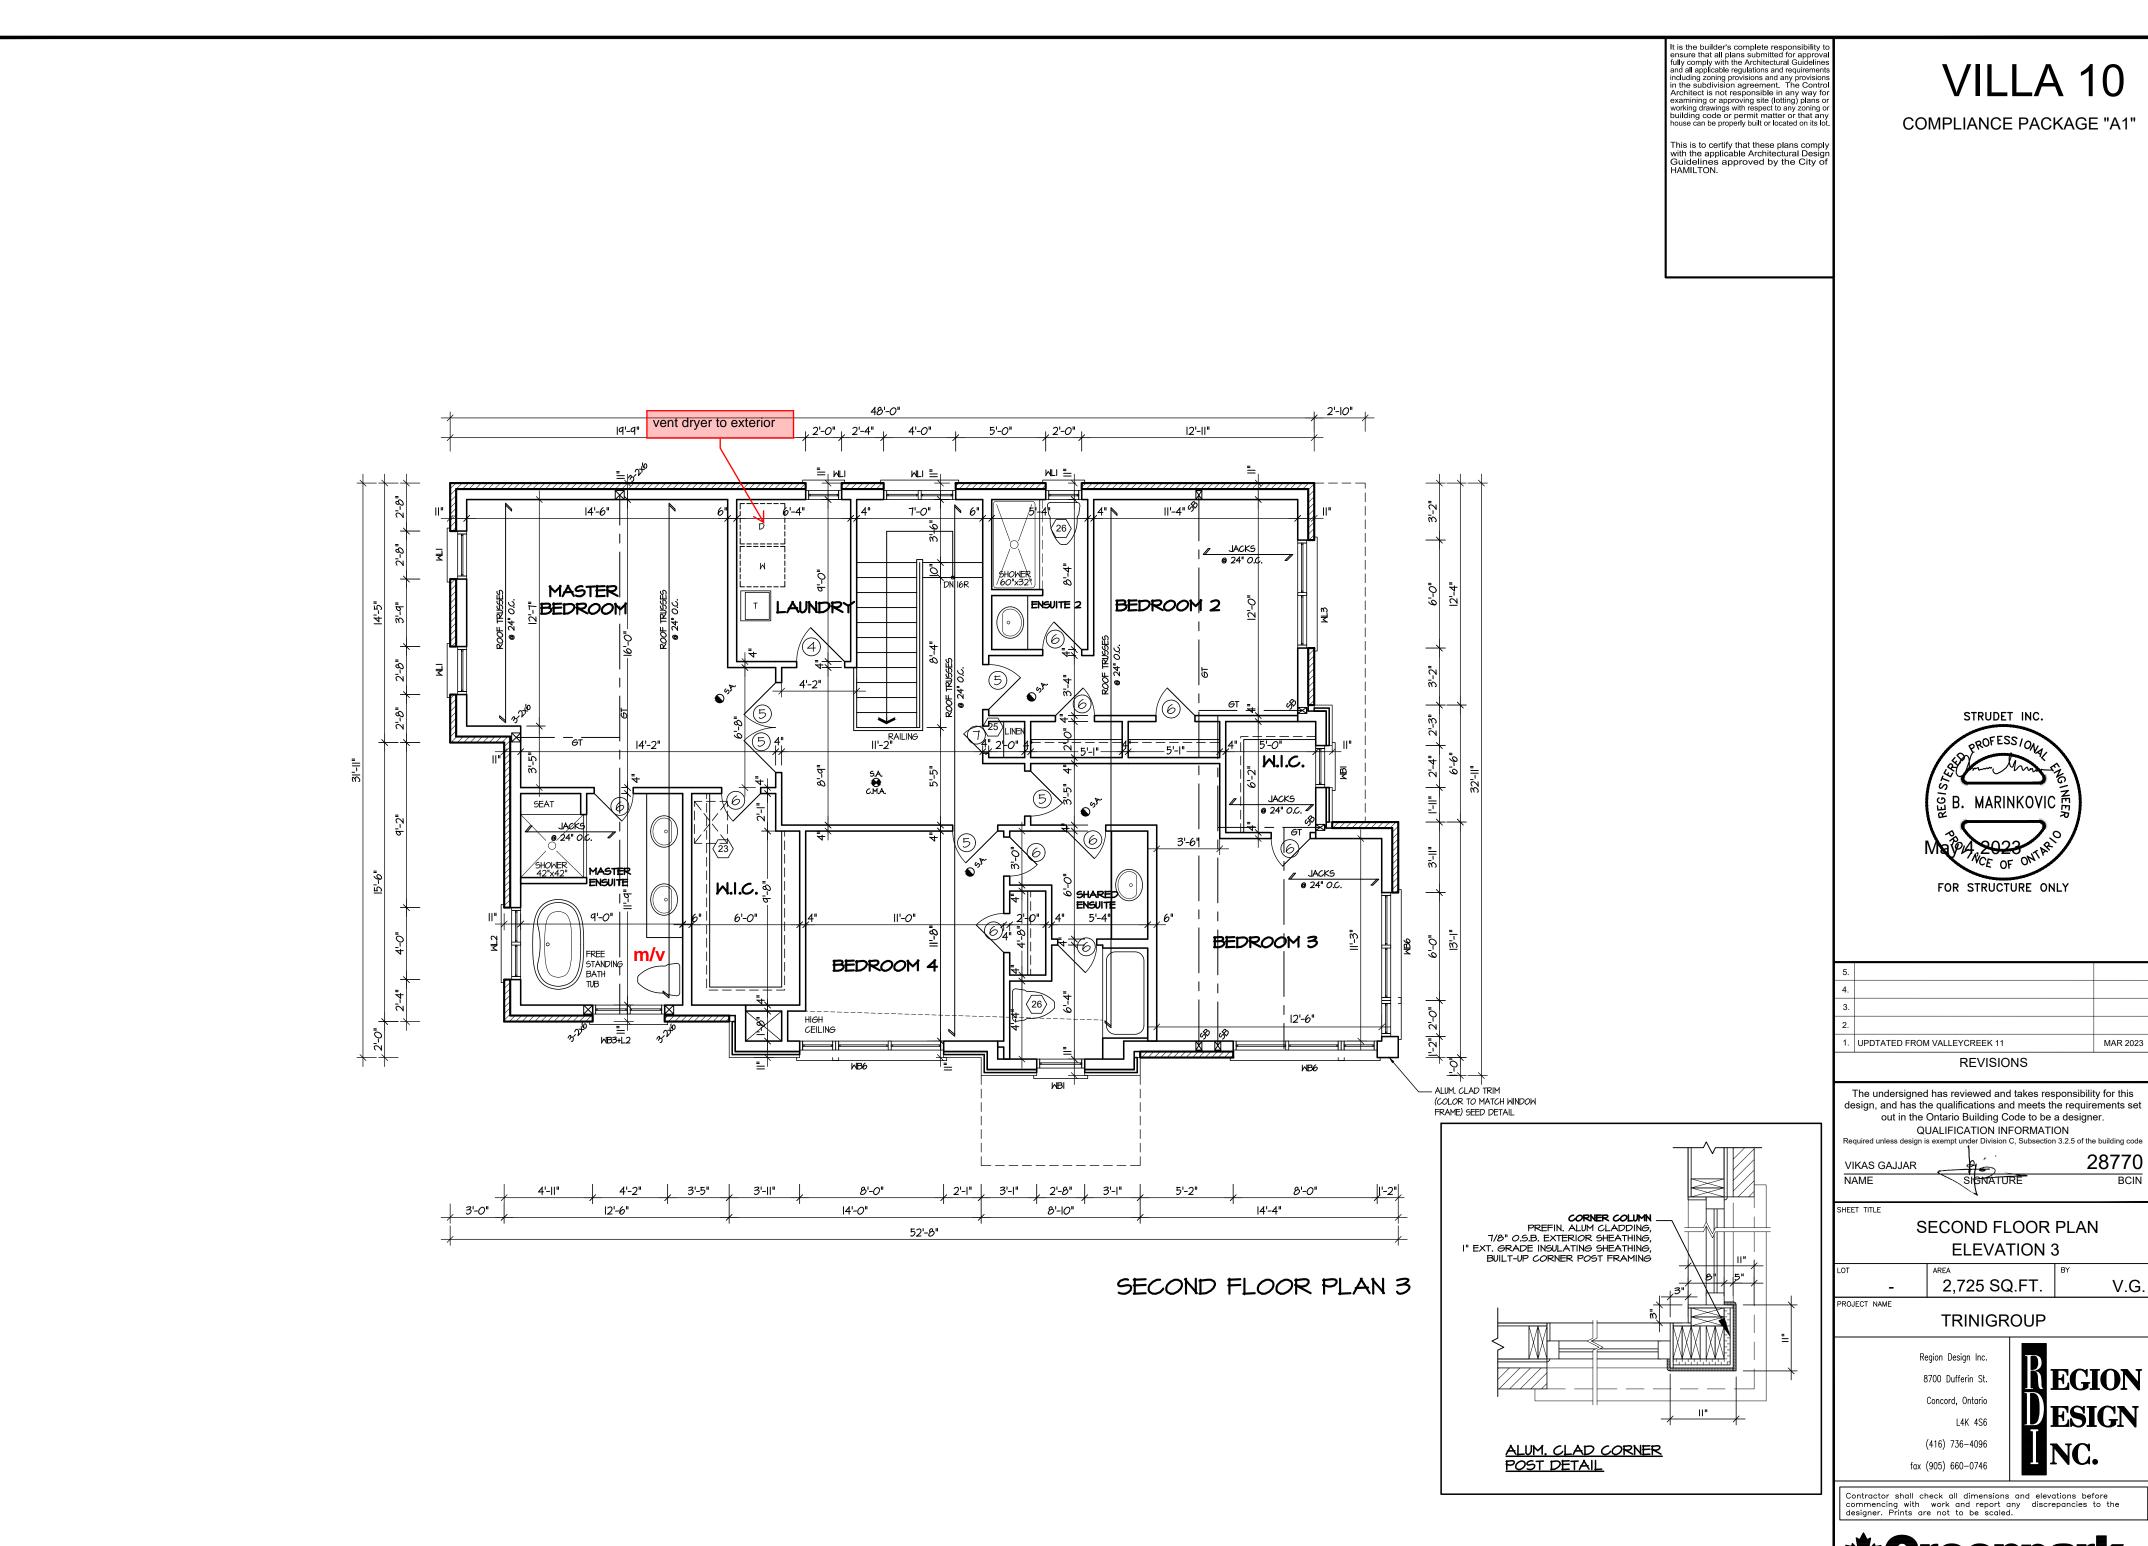

CITY OF RICHMOND HILL BUILDING DIVISION

08/21/2024

REVISED

Per:___KER__

#Greenpark...


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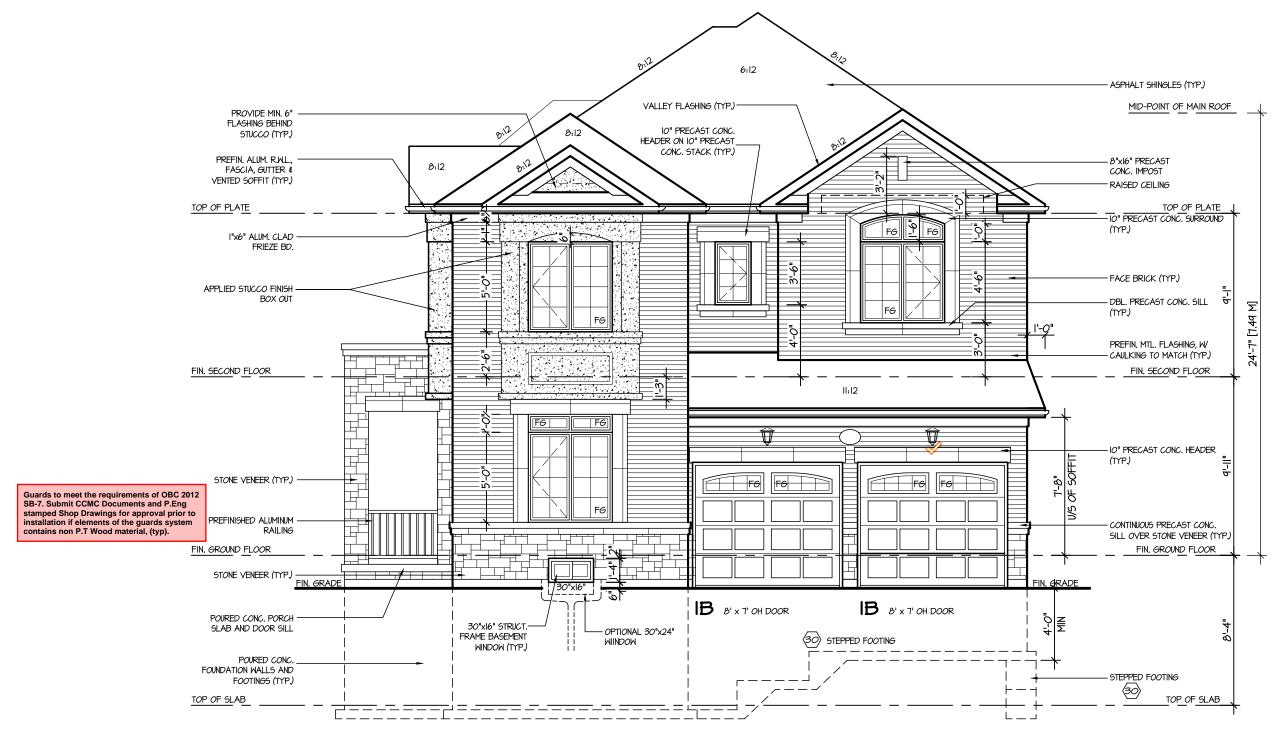
MAR 2023

SCALE 3/16"=1'-0"

PROJECT NO.

3-3



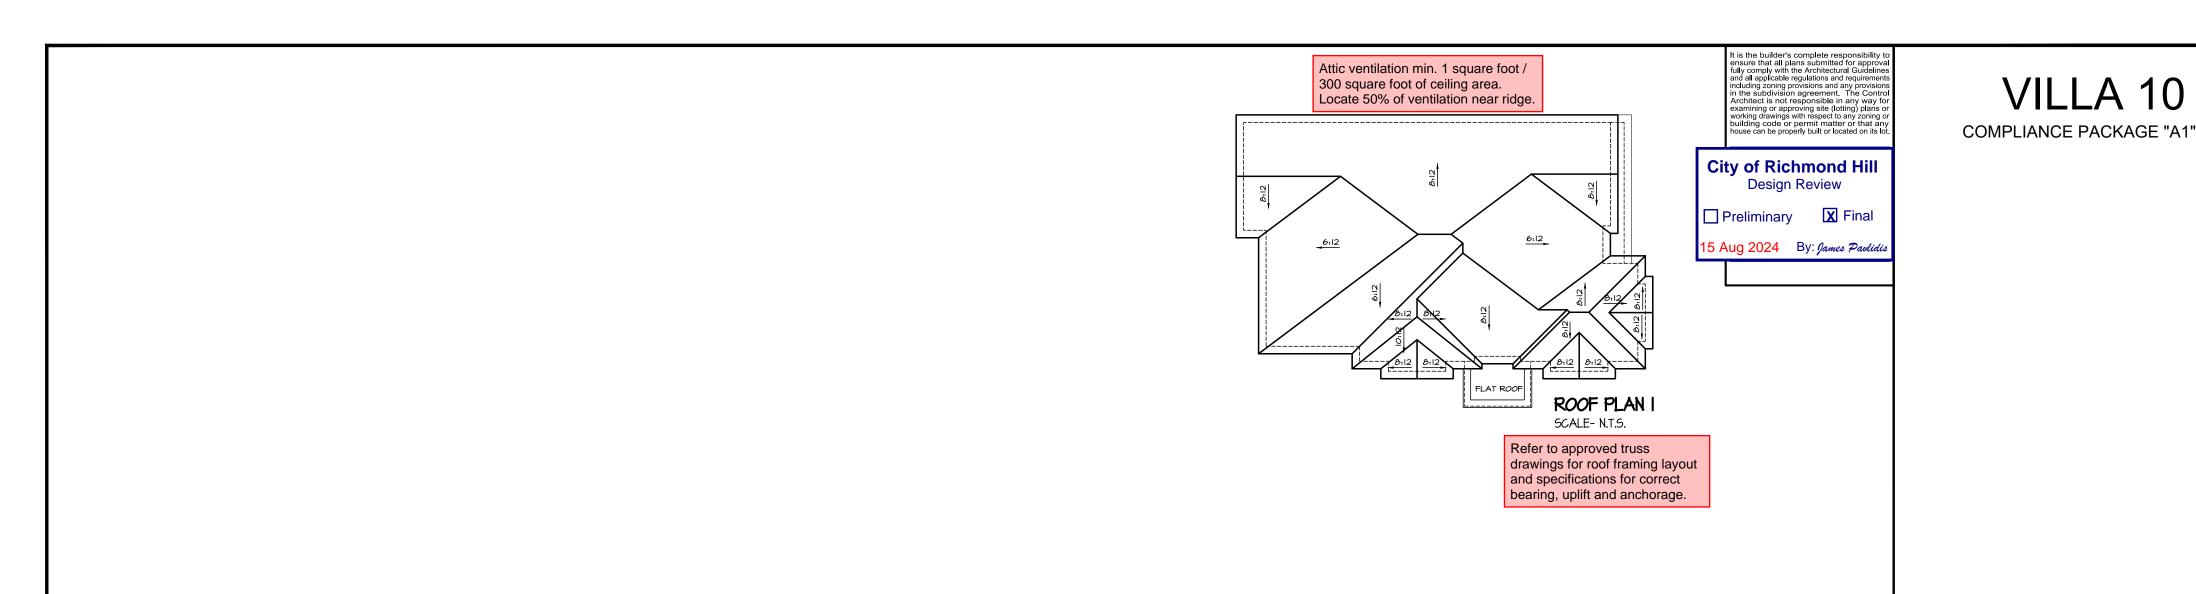

FRONT ELEVATION I

design, and has the qualifications and meets the requirements set out in the Ontario Building Code to be a designer. QUALIFICATION INFORMATION 28770 VIKAS GAJJAR NAME BCIN SHEET TITLE FRONT ELEVATION 1 2,725 SQ.FT. V.G. PROJECT NAME **TRINIGROUP** Region Design Inc. MEGION 8700 Dufferin St. Concord, Ontario L4K 4S6 (416) 736-4096 fax (905) 660-0746 Contractor shall check all dimensions and elevations before commencing with work and report any discrepancies to the designer. Prints are not to be scaled.

REVISIONS

The undersigned has reviewed and takes responsibility for this

MAR 2023

1. UPDTATED FROM VALLEYCREEK 11


CITY OF RICHMOND HILL BUILDING DIVISION 08/21/2024


REVISED
Per:___KER___

DATE MAR 2023

SCALE 3/16"=1'-0"

PROJECT NO. --

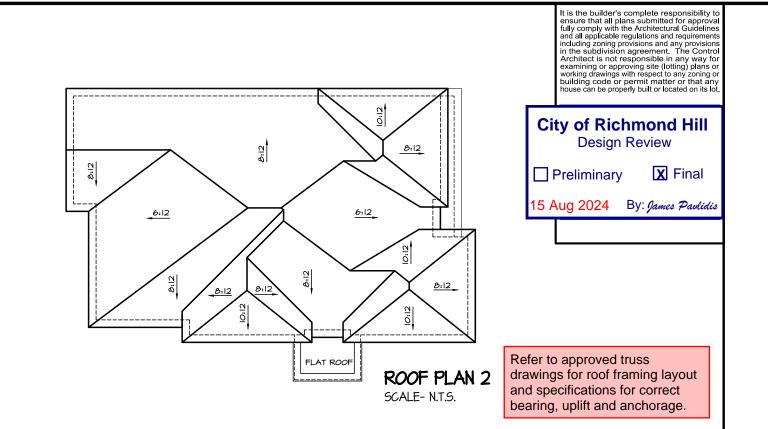

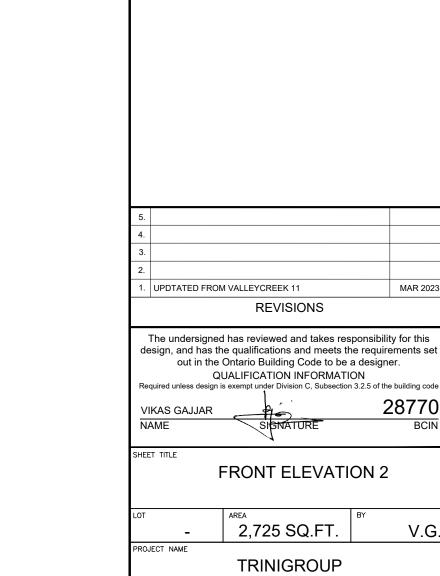



FRONT ELEVATION 2

CITY OF RICHMOND HILL BUILDING DIVISION 08/21/2024

REVISED Per:___KER__

MAR 2023

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Region Design Inc.

8700 Dufferin St.

Concord, Ontario L4K 4S6

(416) 736-4096 fax (905) 660-0746

3/16"=1'-0" PROJECT NO.

MAR 2023


28770

V.G.


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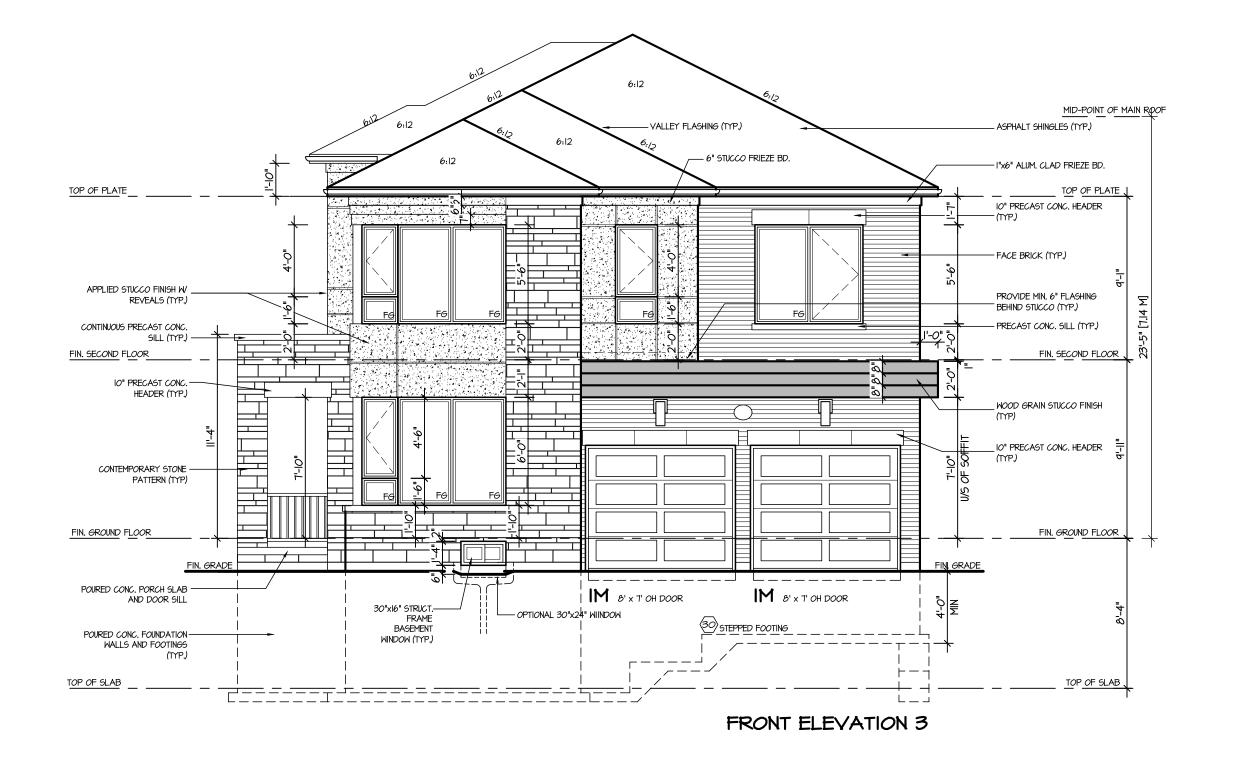
VILLA 10

COMPLIANCE PACKAGE "A1"



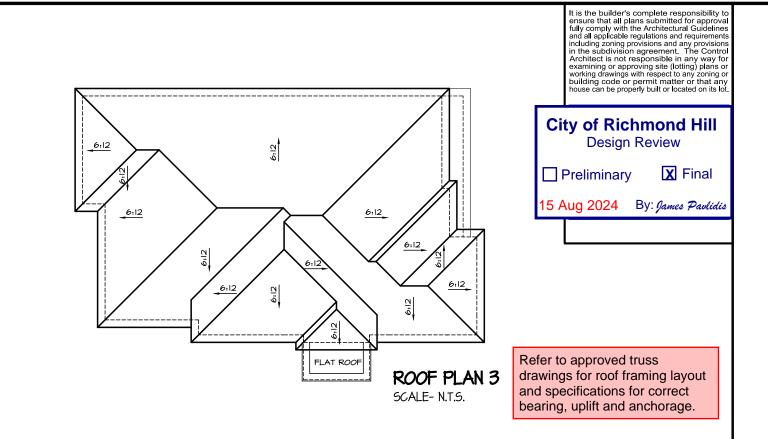



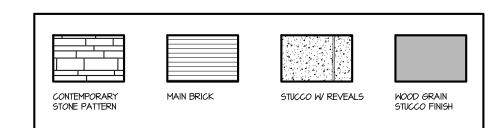

1. UPDTATED FROM VALLEYCREEK 11 MAR 2023 REVISIONS

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SHEET TITLE FRONT ELEVATION 3

2,725 SQ.FT. PROJECT NAME TRINIGROUP

Region Design Inc. MEGION 8700 Dufferin St. Concord, Ontario L4K 4S6 (416) 736-4096 fax (905) 660-0746

V.G.

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MAR 2023 3/16"=1'-0" PROJECT NO.


CITY OF RICHMOND HILL BUILDING DIVISION


08/21/2024

REVISED

Per:___KER__




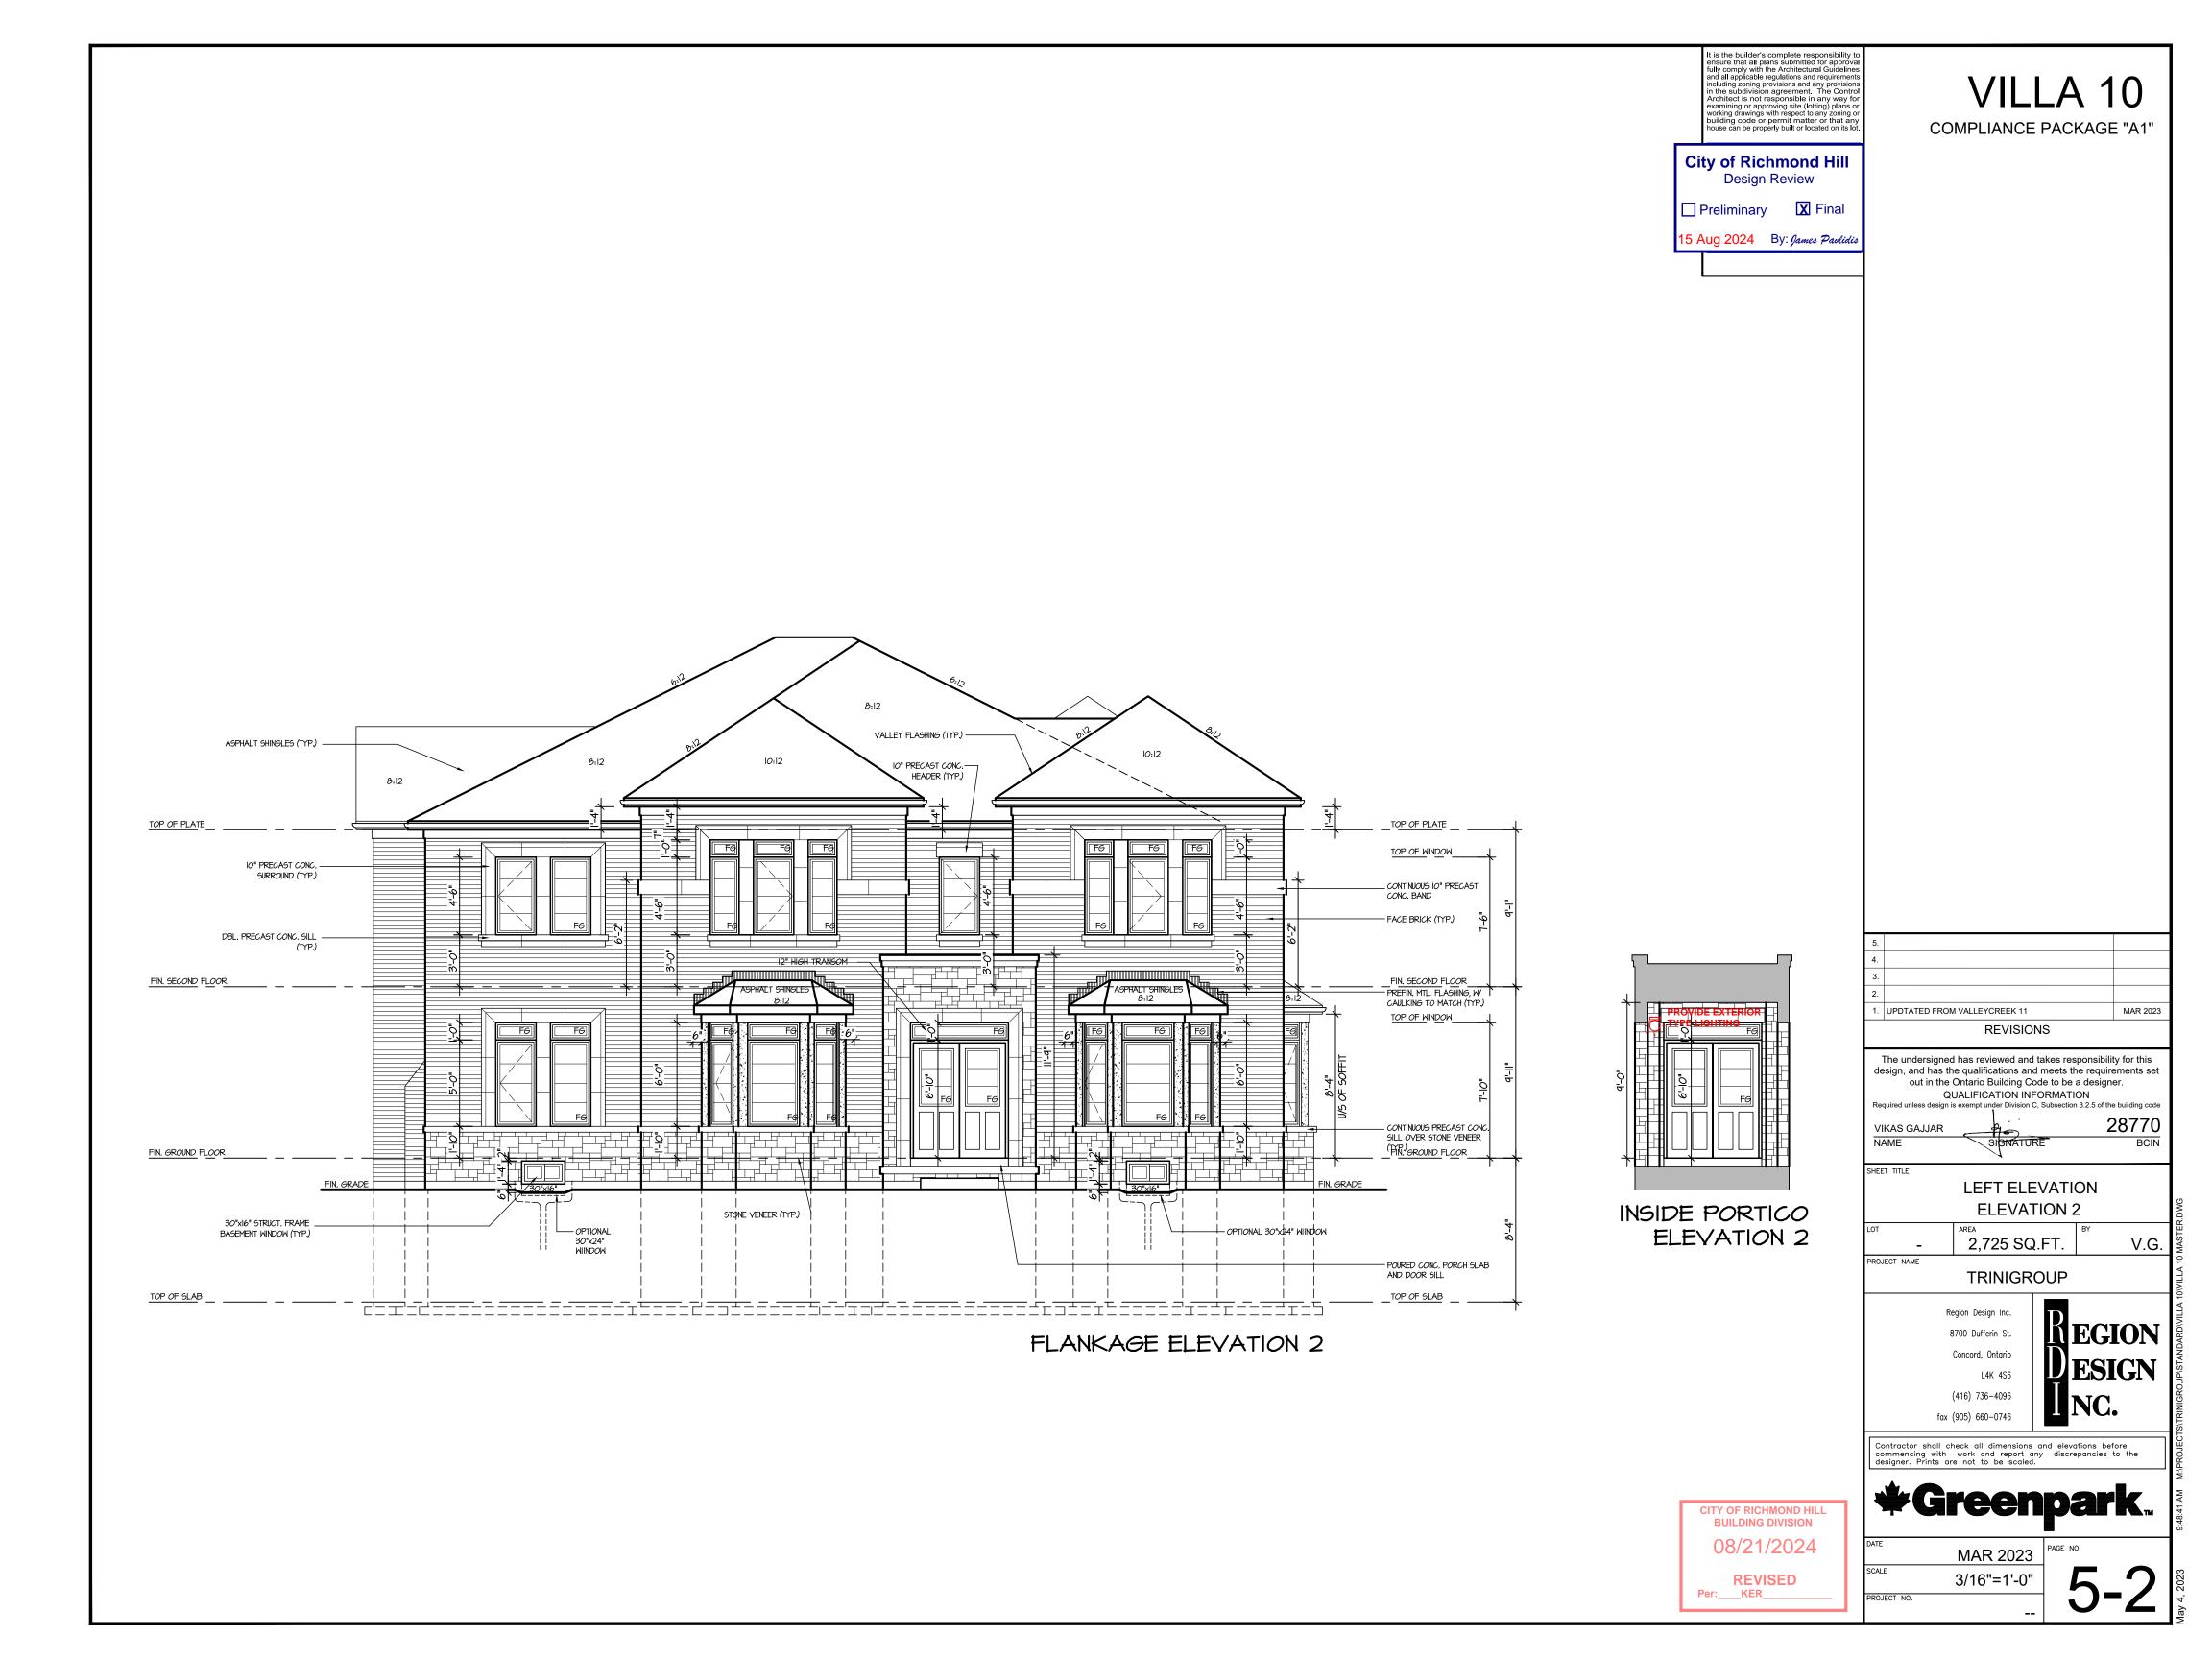

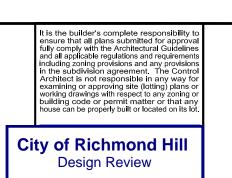


VILLA 10
COMPLIANCE PACKAGE "A1"

15 Aug 2024 By: James Pavlidis

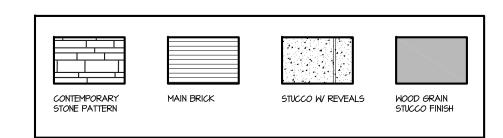



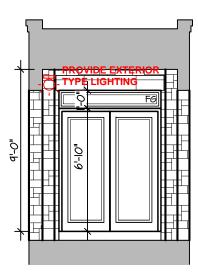

INSIDE PORTICO ELEVATION 3 5. 4. 3. 2. In the undersigned has reviewed and takes responsibility for this

design, and has the qualifications and meets the requirements set out in the Ontario Building Code to be a designer.

QUALIFICATION INFORMATION

Required unless design is exempt under Division C, Subsection 3.2.5 of the building code

VIKAS GAJJAR

NAME

SIGNATURE

BCIN

LEFT ELEVATION
ELEVATION 2

LOT AREA BY 2,725 SQ.FT. V.G.
PROJECT NAME
TRINIGROUP

Region Design Inc.

8700 Dufferin St.
Concord, Ontario
L4K 4S6
(416) 736–4096
fax (905) 660–0746

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#Greenpark...

MAR 2023


SCALE 3/16"=1'-0"


PROJECT NO.


REVISED KER____

CITY OF RICHMOND HILL BUILDING DIVISION

08/21/2024

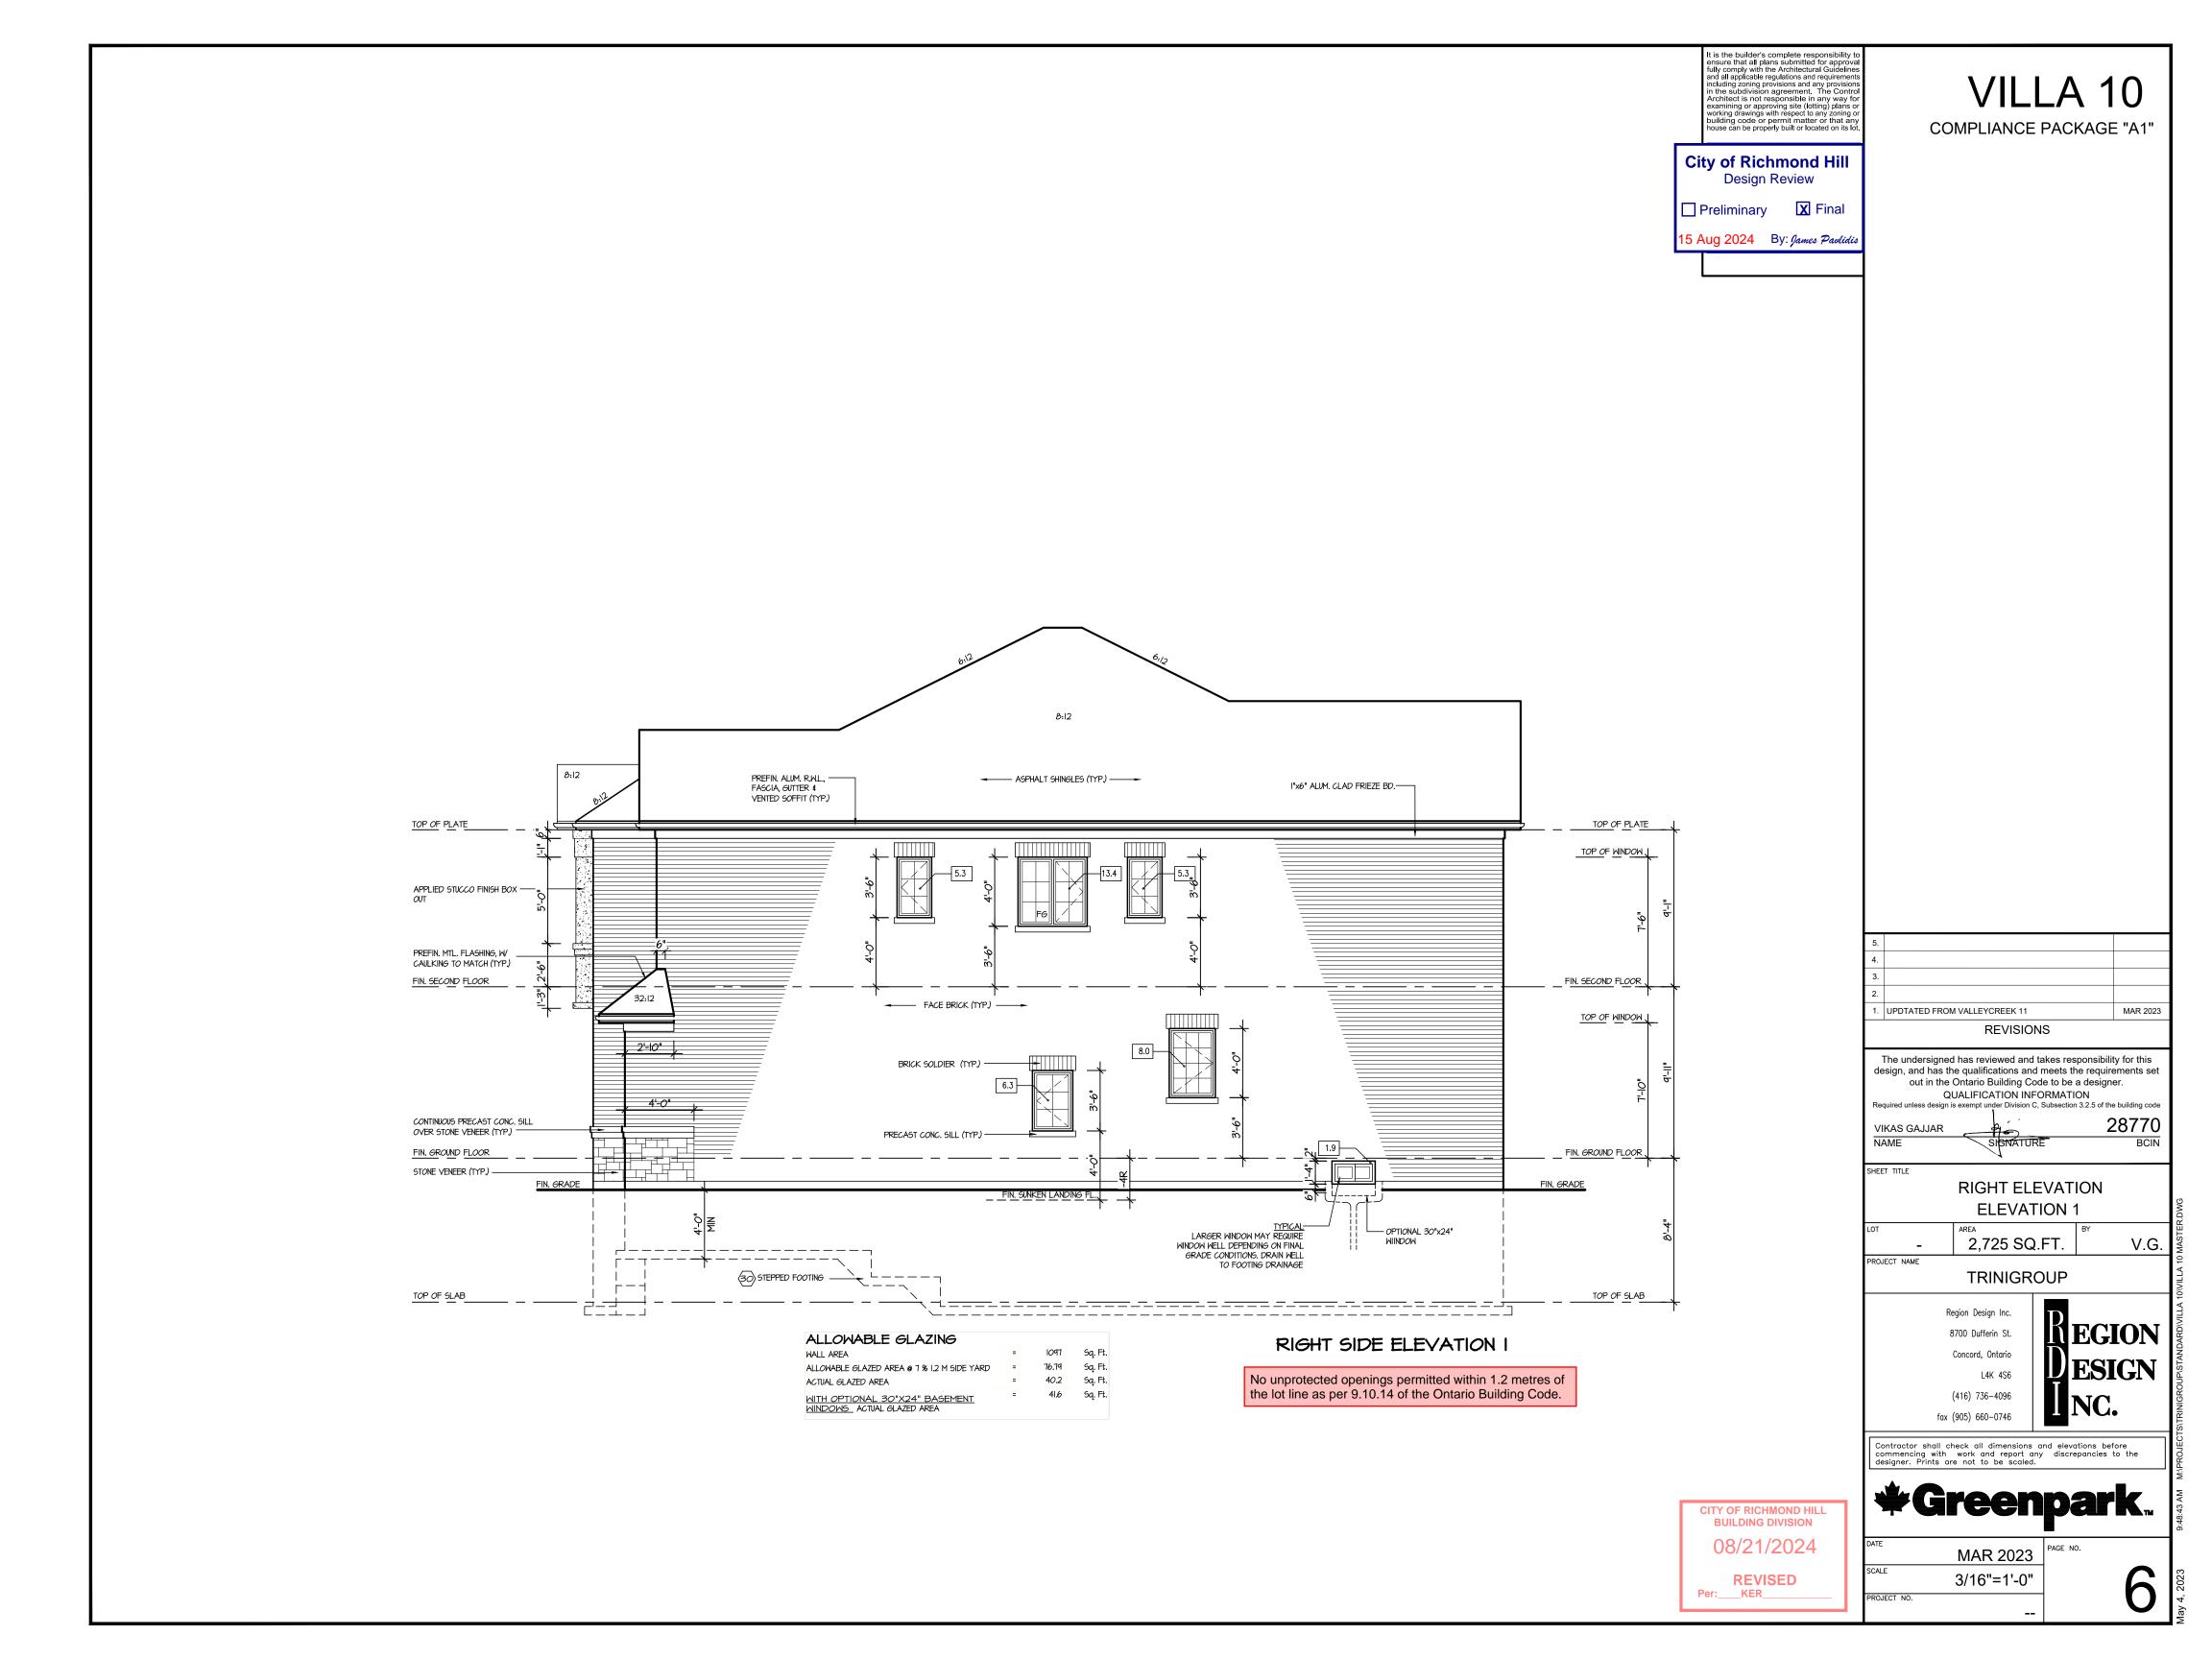

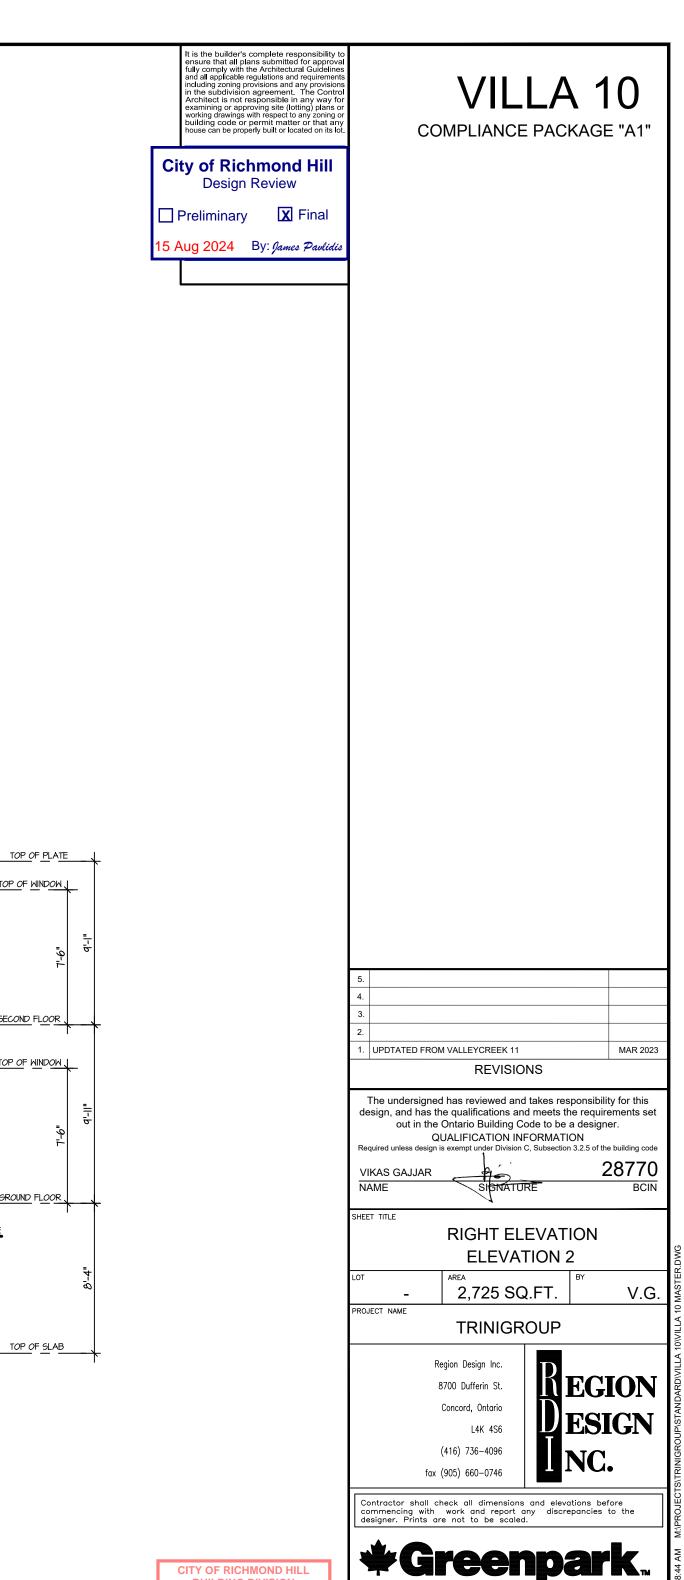


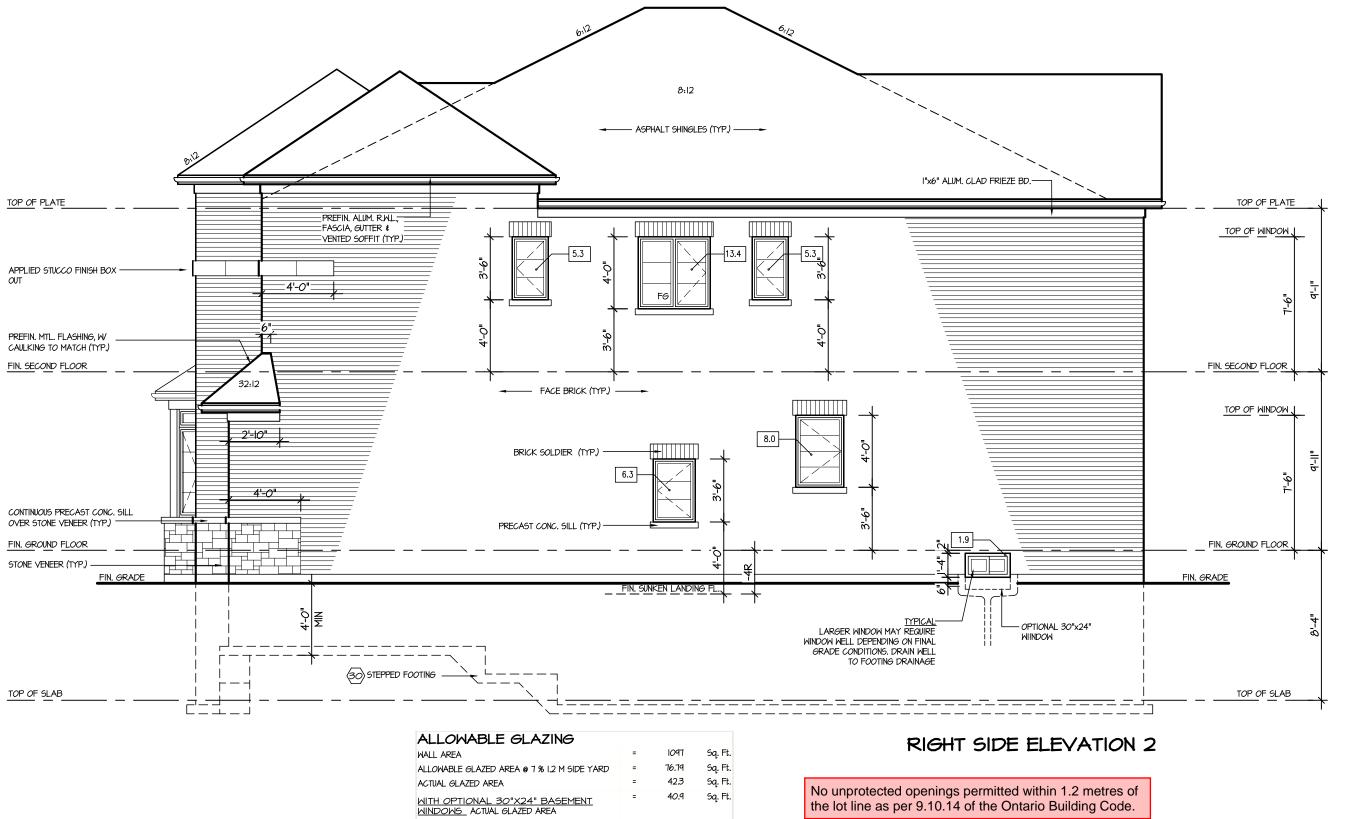

CITY OF RICHMOND HILL BUILDING DIVISION 08/21/2024

REVISED Per:___KER__

MAR 2023 3/16"=1'-0" PROJECT NO.

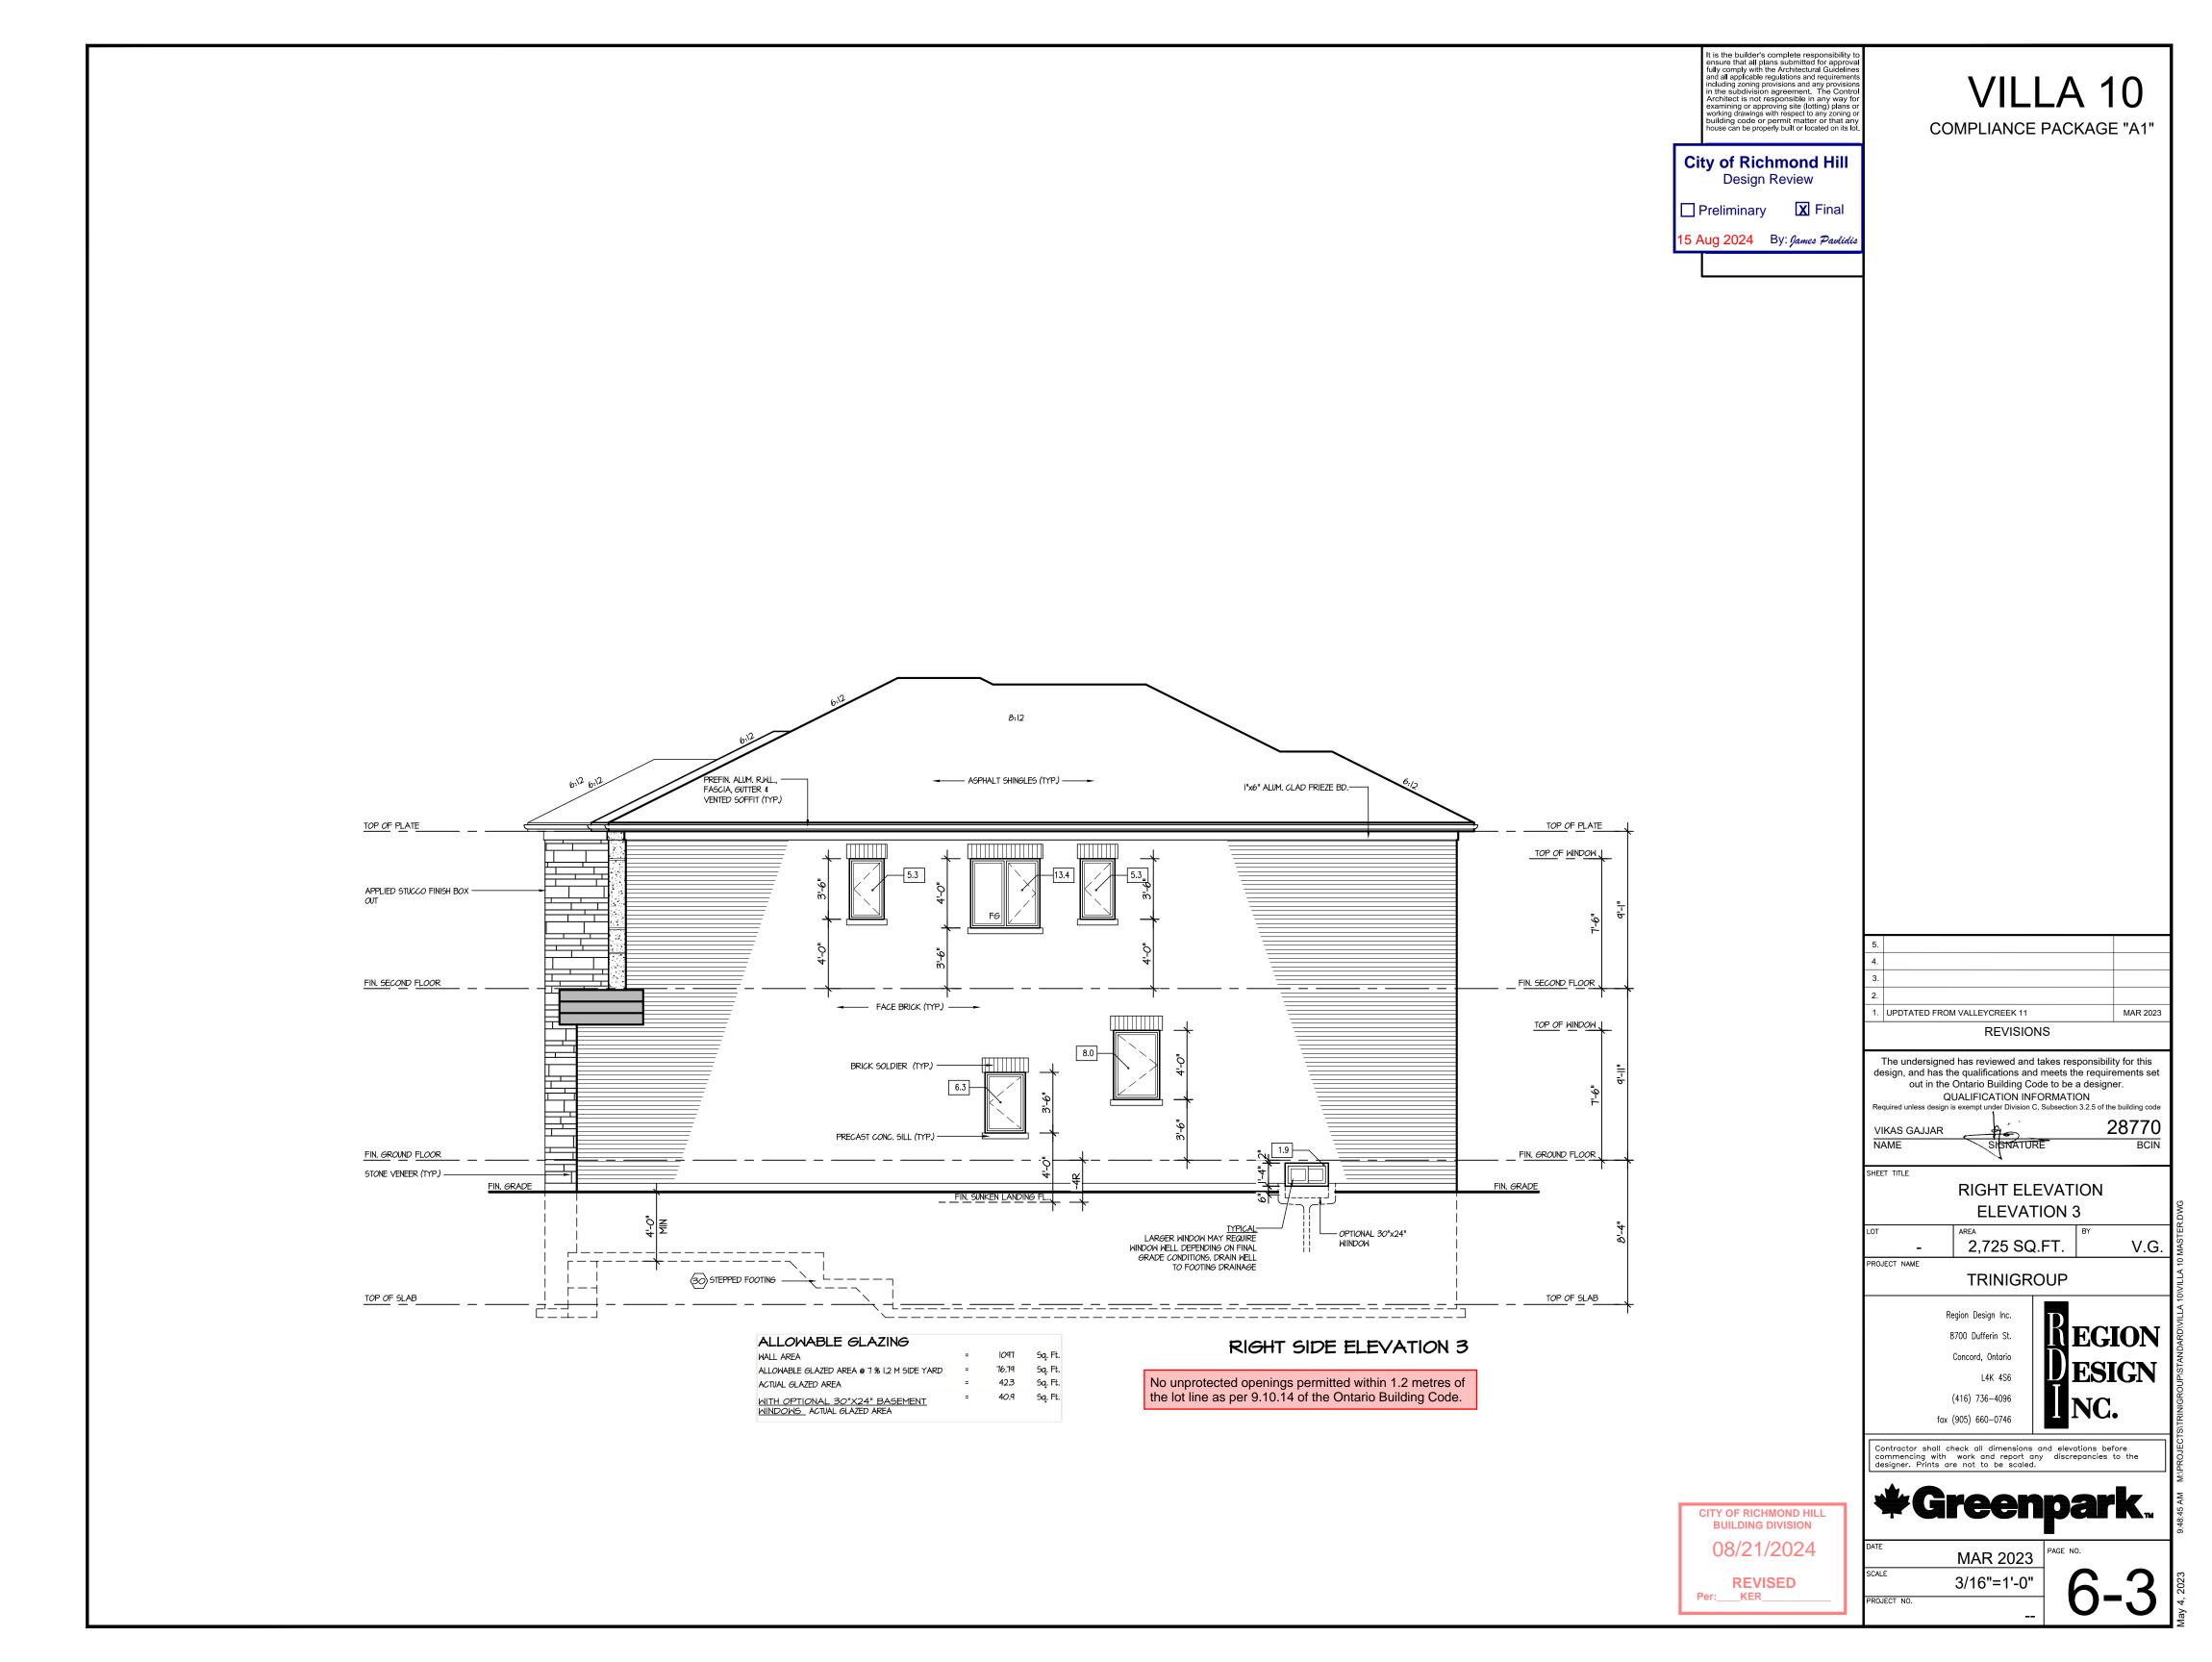

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ON IO" PRECAST CONC. STACK 10" PRECAST CONC. SURROUND — - APPLIED STUCCO FINISH BOX = DBL. PRECAST CONC. SILL -FIN. SECOND FLOOR FIN. SECOND FLOOR 1. UPDTATED FROM VALLEYCREEK 11 MAR 2023 FACE BRICK CAP

W FLASHING

FULL DEPTH IO" PRECAST CONC. HEADER — REVISIONS The undersigned has reviewed and takes responsibility for this design, and has the qualifications and meets the requirements set out in the Ontario Building Code to be a designer. QUALIFICATION INFORMATION
Required unless design is exempt under Division C, Subsection 3.2.5 of the building code FACE BRICK (TYP.) 28770 6'0" SLIDING DOOR CONTINUOUS PRECAST CONC.
SILL OVER STONE VENEER

(TYPIN, GROUND FLOOR VIKAS GAJJAR NAME BCIN SHEET TITLE **REAR ELEVATION 1** STONE VENEER— PRECAST CONC. STEP (TYP.) V.G. 2,725 SQ.FT. PROJECT NAME TRINIGROUP TOP OF SLAB TOP OF SLAB Region Design Inc. **MEGION** 8700 Dufferin St. REAR ELEVATION I Concord, Ontario L4K 4S6 (416) 736-4096 fax (905) 660-0746 Contractor shall check all dimensions and elevations before commencing with work and report any discrepancies to the designer. Prints are not to be scaled.

> CITY OF RICHMOND HILL BUILDING DIVISION 08/21/2024

REVISED
Per:___KER___

MAR 2023
SCALE 3/16"=1'-0"
PROJECT NO.

7

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VILLA 10 COMPLIANCE PACKAGE "A1"

Design Review

15 Aug 2024 By: James Pavlidis



REAR ELEVATION 2

1. UPDTATED FROM VALLEYCREEK 11 MAR 2023 REVISIONS The undersigned has reviewed and takes responsibility for this design, and has the qualifications and meets the requirements set out in the Ontario Building Code to be a designer. QUALIFICATION INFORMATION
asign is exempt under Division C, Subsection 3.2.5 of the building cod-28770 VIKAS GAJJAR NAME SHEET TITLE **REAR ELEVATION 2** 2,725 SQ.FT. V.G. PROJECT NAME TRINIGROUP Region Design Inc. **MEGION** 8700 Dufferin St. Concord, Ontario (416) 736-4096 fax (905) 660-0746 Contractor shall check all dimensions and elevations before commencing with work and report any discrepancies to the designer. Prints are not to be scaled.

CITY OF RICHMOND HILL BUILDING DIVISION 08/21/2024


REVISED Per:___KER__

MAR 2023 3/16"=1'-0" PROJECT NO.

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VILLA 10 COMPLIANCE PACKAGE "A1"

15 Aug 2024 By: James Pavlidis

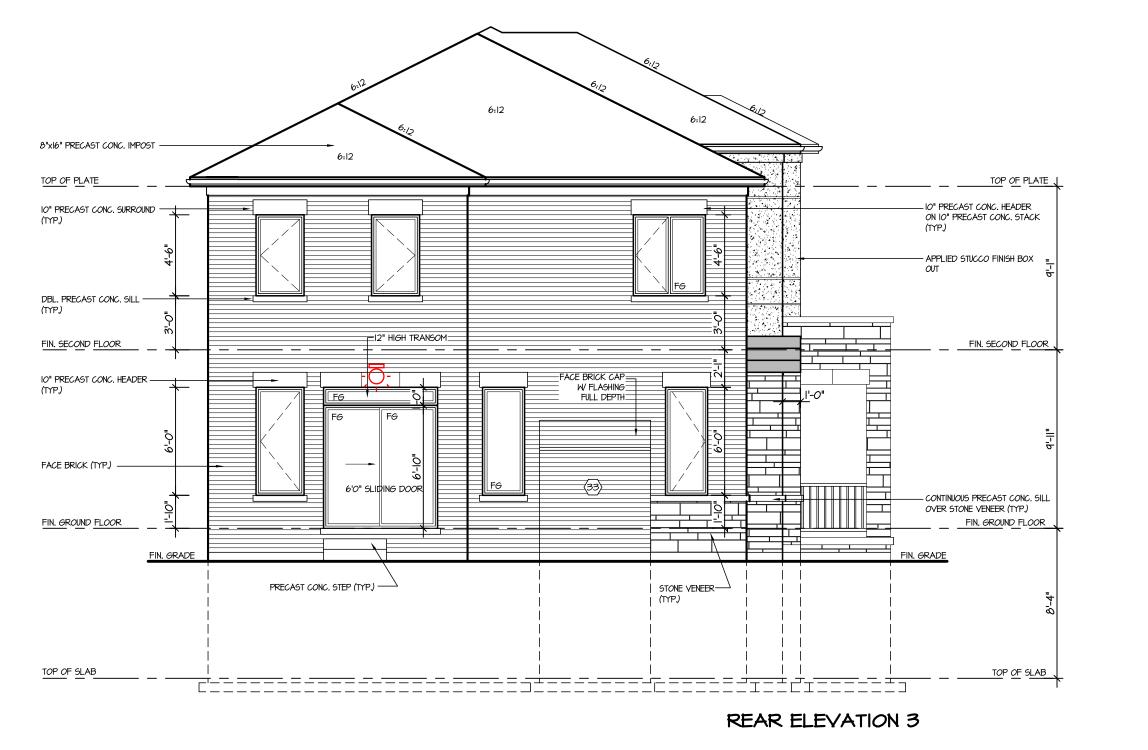

CITY OF RICHMOND HILL BUILDING DIVISION 08/21/2024

REVISED

Per:___KER__

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L4K 4S6 (416) 736-4096 fax (905) 660-0746


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VILLA 10 COMPLIANCE PACKAGE "A1"





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sign is exempt under Division C, Subsection 3.2.5 of the building code 28770 VIKAS GAJJAR NAME

SHEET TITLE **CROSS SECTION**

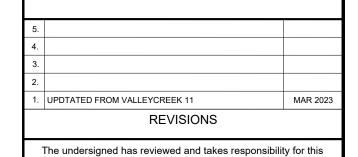2,725 SQ.FT. V.G. PROJECT NAME TRINIGROUP

Region Design Inc. 8700 Dufferin St. Concord, Ontario

MEGION ESIGN L4K 4S6 (416) 736-4096 fax (905) 660-0746

8

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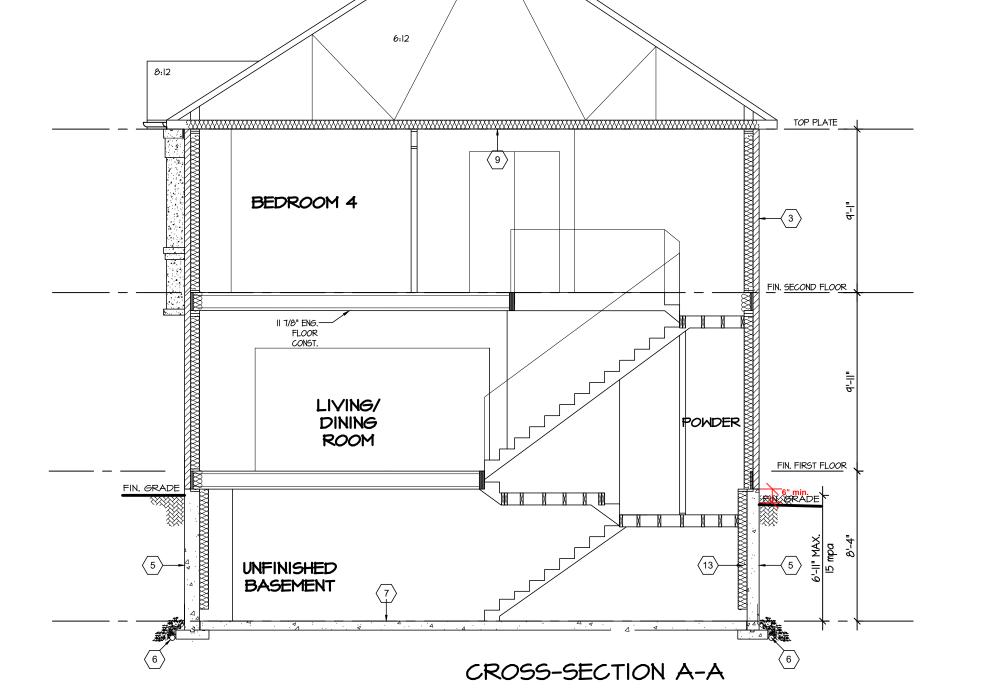
***Greenpark**...

MAR 2023 3/16"=1'-0" PROJECT NO.

CITY OF RICHMOND HILL BUILDING DIVISION

08/21/2024


REVISED
Per:___KER___




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VILLA 10 COMPLIANCE PACKAGE "A1"




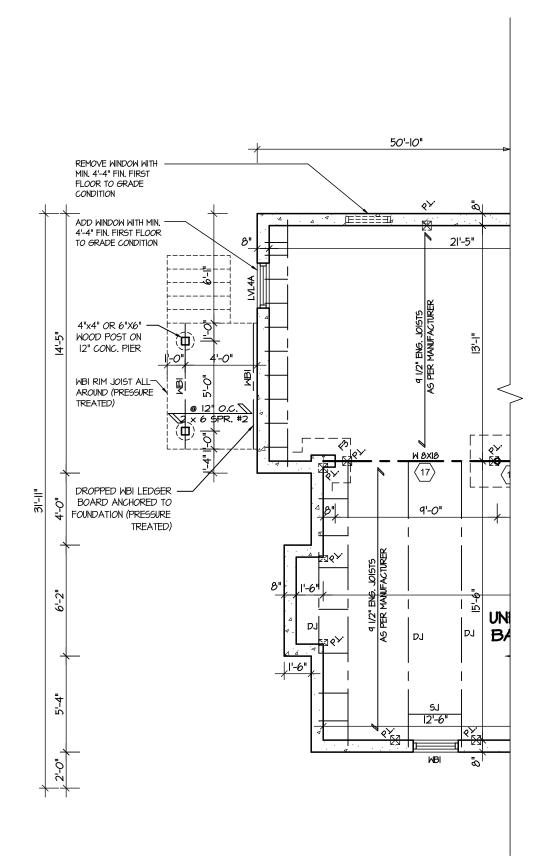

PARTIAL BASEMENT PLAN DECK CONDITION

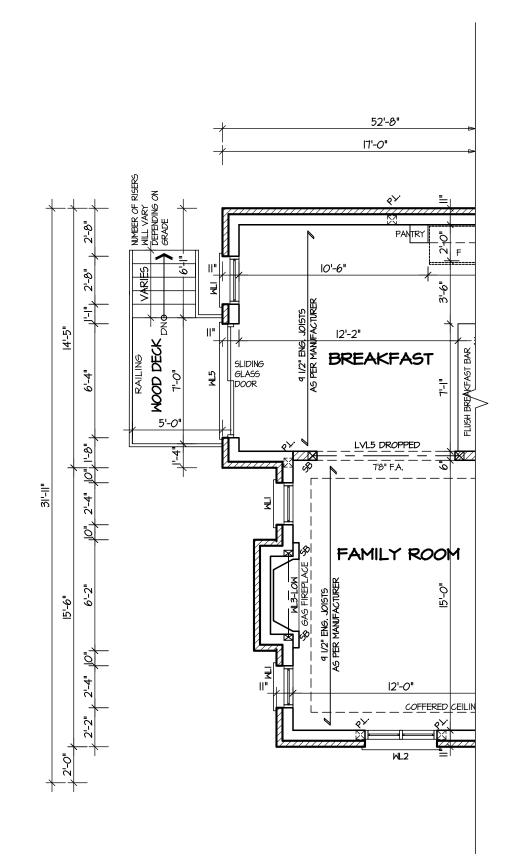Deck and guard construction shall comply with attached details.

PARTIAL FIRST FLOOR PLAN DECK CONDITION

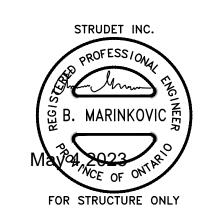

| 5. | | |
|----|------------------------------|----------|
| 4. | | |
| 3. | | |
| 2. | | |
| 1. | UPDTATED FROM VALLEYCREEK 11 | MAR 2023 |
| | REVISIONS | |

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NAME SHEET TITLE DECK PLANS

2,725 SQ.FT. V.G. PROJECT NAME TRINIGROUP

Region Design Inc. MEGION 8700 Dufferin St. Concord, Ontario **ESIGN** (416) 736-4096 fax (905) 660-0746

Contractor shall check all dimensions and elevations before commencing with work and report any discrepancies to the designer. Prints are not to be scaled.

*Greenpark...

MAR 2023 3/16"=1'-0" PROJECT NO.

CITY OF RICHMOND HILL BUILDING DIVISION

08/21/2024


REVISED

It is the builder's complete responsibility to ensure that all plans submitted for approval fully comply with the Architectural Guidelines and all applicable regulations and requirements including zoning provisions and any provisions in the subdivision agreement. The Control Architect is not responsible in any way for examining or approving site (lotting) plans or working drawings with respect to any zoning or building code or permit matter or that any house can be properly built or located on its lot. **City of Richmond Hill** Design Review

VILLA 10 **COMPLIANCE PACKAGE "A1"**

☐ Preliminary **X** Final

15 Aug 2024 By: James Pavlidis

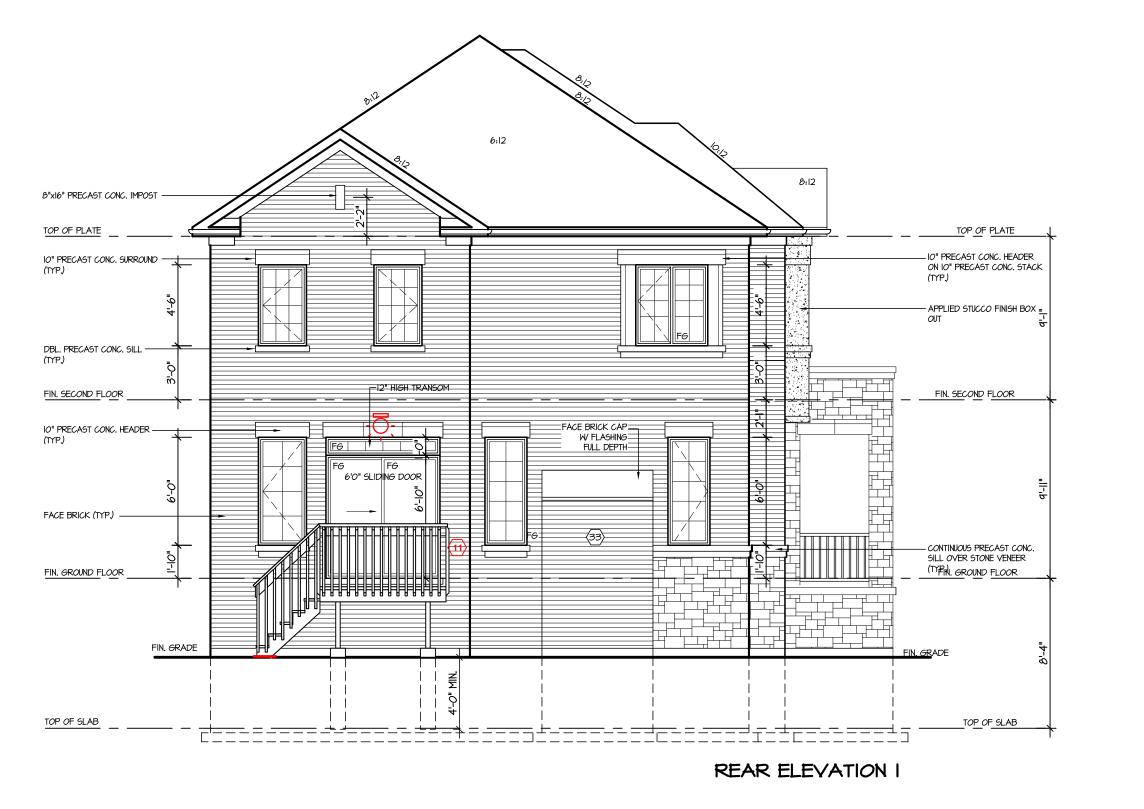

1. UPDTATED FROM VALLEYCREEK 11 MAR 2023 REVISIONS

The undersigned has reviewed and takes responsibility for this design, and has the qualifications and meets the requirements set out in the Ontario Building Code to be a designer. QUALIFICATION INFORMATION 28770 VIKAS GAJJAR NAME BCIN

SHEET TITLE **REAR ELEVATION 1** DECK CONDITION V.G.

2,725 SQ.FT. PROJECT NAME TRINIGROUP

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W FLASHING

FULL DEPTH 1. UPDTATED FROM VALLEYCREEK 11 MAR 2023 IO" PRECAST CONC. HEADER (TYP.) REVISIONS The undersigned has reviewed and takes responsibility for this design, and has the qualifications and meets the requirements set out in the Ontario Building Code to be a designer. QUALIFICATION INFORMATION FACE BRICK (TYP.) — 28770 — CONTINUOUS PRECAST CONC. SILL OVER STONE VENEER (TYP.) VIKAS GAJJAR NAME SHEET TITLE **REAR ELEVATION 2** DECK CONDITION 2,725 SQ.FT. V.G. PROJECT NAME TRINIGROUP TOP OF SLAB TOP OF SLAB Region Design Inc. **MEGION** 8700 Dufferin St. REAR ELEVATION 2 Concord, Ontario L4K 4S6 (416) 736-4096 fax (905) 660-0746

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CITY OF RICHMOND HILL BUILDING DIVISION 08/21/2024

REVISED Per:___KER__

MAR 2023 3/16"=1'-0"

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ON IO" PRECAST CONC. STACK IO" PRECAST CONC. SURROUND (TYP.) - APPLIED STUCCO FINISH BOX DBL. PRECAST CONC. SILL -_12" HIGH TRANSOM_ FIN. SECOND FLOOR . FIN. SECOND FLOOR 1. UPDTATED FROM VALLEYCREEK 11 MAR 2023 IO" PRECAST CONC. HEADER ______ FACE BRICK CAP

W FLASHING

FULL DEPTH REVISIONS The undersigned has reviewed and takes responsibility for this design, and has the qualifications and meets the requirements set out in the Ontario Building Code to be a designer. QUALIFICATION INFORMATION FACE BRICK (TYP.) -28770 VIKAS GAJJAR - CONTINUOUS PRECAST CONC. SILL OVER STONE VENEER (TYP.) NAME BCIN SHEET TITLE **REAR ELEVATION 3 DECK CONDITION** FIN, GRADE FIN. GRADE 2,725 SQ.FT. V.G. PROJECT NAME TRINIGROUP TOP OF SLAB TOP OF SLAB Region Design Inc. **MEGION** 8700 Dufferin St. REAR ELEVATION 3 Concord, Ontario L4K 4S6 (416) 736-4096 fax (905) 660-0746 Contractor shall check all dimensions and elevations before commencing with work and report any discrepancies to the designer. Prints are not to be scaled. ***Greenpark**... CITY OF RICHMOND HILL BUILDING DIVISION 08/21/2024 MAR 2023

3/16"=1'-0" PROJECT NO.

REVISED