

BUILDING PERMIT COVER PAGE

MHP 23038

Development Services Department Building Permit and Inspection Services

SOIL CONDITIONS

SOIL CONDITIONS SHALL BE VERIFIED BY A PROFESSIONAL ENGINEER COMPETENT IN THE FIELD OF SOIL ENGINEERING, PRIOR TO PLACING ANY FOUNDATION.

THE PERMIT PLANS HAVE BEEN **ANY FUTURE CHANGES WILL REQUIRE A SEPARATE BUILDING PERMIT**

BUILDING ACCEPTED AS NOTED PERMIT PLANS **REVIEWED BY** DATE REVIEW **ZONING** PLANNING **ARCHITECTURA** CMDec 6, 2023 STRUCTURAL FIRE CARD PLUMBING MECHANICAL PLANS REVIEW CMDec 6, 2023 COMPLETED

PLUMBING INSTALLATIONS

ALL PLUMBING INSTALLATIONS ARE TO BE DONE BY A PLUMBING CONTRACTOR POSSESSING AN ONTARIO COLLEGE OF TRADES MEMBERSHIP, NO PLUMBING IS TO BE COVERED UNTIL INSPECTED AND APPROVED BY A PLUMBING INSPECTOR. TELEPHONE 905-436-5658 WHEN READY FOR AN INSPECTION AND TESTING.

ALL STANDARDS REFERRED TO IN THESE BUILDING PERMIT DOCUMENTS SHALL BE THE **EDITION** DESIGNATED IN OBC 2012 AS AMENDED.

NOTE:

IT IS RECOMMENDED THAT CRUSHED CONCRETE OR SLAG AGGREGATE **NOT** TO BE USED FOR BACKFILL UNDER CONCRETE SLABS, AROUND SEWER LATERALS OR WEEPERS.

RAIN WATER DOWNSPOUTS ARE TO BE DISCHARGED AT GRADE AND NOT CONNECTED TO WEEPING TILES

FUTURE ALTERATIONS

A SEPARATE BUILDING PERMIT IS REQUIRED FOR ANY PROPOSED INTERIOR PARTITIONS AND/OR ALTERATIONS.

COPY OF THE STAMPED/REVIEWED

DRAWINGS MUST REMAIN ON SITE

MHP CERTIFICATION

ALL MARKUPS AND STAMPS APPLIED TO BASE MODEL AND BASE ELEVATION SHALL APPLY AS APPLICABLE TO THE ENTIRE MODEL HOUSE

AS BUILT SURVEY

UPON COMPLETION OF THE FOUNDATION, A SURVEY PREPARED BY AN ONTARIO LAND SURVEYOR INDICATING THE LOCATION OF THE **BUILDING TO ALL PROPERTY LINES IS** REQUIRED TO BE SUBMITTED TO THE BUILDING **DEPARTMENT**

IMPORTANT NOTE

DURING CONSTRUCTION.

NEITHER THE ISSUANCE OF A PERMIT NOR THE CARRYING OUT OF INSPECTIONS BY THE CITY RELIEVE THE APPLICANT FROM FULL RESPONSIBILITY FOR COMPLIANCE WITH THE PROVISIONS OF THE BUILDING CODE ACT AND THE ONTARIO BUILDING CODE, BOTH AS AMENDED, AS WELL AS OTHER APPLICABLE STATUES AND REGULATIONS OF THE PROVINCE OF ONTARIO AND ALL RELEVANT BY-LAWS OF THE CITY OF OSHAWA AND THE REGIONAL MUNICIPALITY OF DURHAM.

ALL ELECTRICAL WIRING MUST BE INSPECTED BY THE ELECTRICAL SAFETY AUTHORITY. SEPARATE INSPECTION APPLICATIONS (PERMITS) MUST BE FILED. WE RECOMMEND YOU USE A QUALIFIED **ELECTRICAL CONTRACTOR. FOR MORE** INFORMATION PLEASE CALL:



1-877-ESA-SAFE OR VISIT WWW.ESASAFE.COM

OBC 9.10.14.5 - CLADDING

CLADDING ON THE EXPOSING BUILDING FACE IS PERMITTED TO BE VINYL WHEN WITHIN 600mm OF PROPERTY LINE, PROVIDED THAT THE VINYL CONFORMS TO OBC DIV. B. 9.27.13, IS INSTALLED OVER SHEATHING PAPER AND12.7mm DRYWALL, HAS A FLAME SPREAD RATING NOT GREATER THAN 25, AND IS NOT MORE THAN 2mm THICK AND THE ENTIRE EXTERIOR WALL HAS A MINIMUM FIRE RESISTANCE RATING OF 3/2 HOURS

RETURN AIR INLET FROM ANYROOM
PROVISIONS SHALL BE MADE FOR THE RETURN OF AIR FROM ANY ROOM OR
SPACE WITHOUT A RETURN AIR INLET, BY LEAVING GAPS BENEATH DOORS,
USING LOUVERED DOORS, OR INSTALLING RETURN AIR DUCT INLETS.

(3.8 SQ.FT.) WITH NO DIMENSION LESS THAN 380 MM (15 IN).

BEDROOM WINDOWS (1) EVERY FLOOR LEVEL CONTAINING BEDROOMS IN A SUITE SHALL BE PROVIDED WITH AT LEAST 1 OUTSIDE WINDOW THAT CAN BE OPENED FROM THE INSIDE WITHOUT THE USE OF TOOLS, AND EACH SUCH WINDOW SHALL PROVIDE AN

(2) EXCEPT FOR BASEMENT AREAS. THE WINDOW DESCRIBED IN SENTENCE (1) SHALL HAVE A MAXIMUM SILL HEIGHT OF 1M (3 FT 3 IN) ABOVE THE FLOOR. (3) WHEN SLIDING WINDOWS ARE USED, THE MINIMUM DIMENSION DESCRIBED IN

INDIVIDUAL, UNOBSTRUCTED OPEN PORTION HAVING A MINIMUM AREA OF 0.35M2

PREFABRICATED WOOD TRUSSES

FABRICATION AND ERECTION DRAWINGS WITH DESIGN DATA, PREPARED AND SEALED BY A PROFESSIONAL ENGINEER, MUST BE AVAILABLE ON SITE FOR REVIEW BY THE BUILDING INSPECTOR

ROOF CEILING INSULATION

ROOF FRAMING OR TRUSS HEEL JOINT MUST PERMIT SUFFICIENT SPACE FOR THE EXTENSION OF THE ROOF-CELLING INSULATION OVER EXTERIOR WALLS MINIMIZE THERMAL BRIDGES. AN UNOBSTRUCTED VENTILATION SPACE MUST BE PROVIDED OVER EXTERIOR WALLS TO ALLOW UNIMPEDED AIR FLOW FORM SOFFIT

SENTENCE (1) SHALL APPLY TO THE OPENABLE PORTION OF THE WINDOW.

ATTIC HATCHES SHALL NOT BE LESS THAN 550mm (21 5") BY 900mm (35")

OBC 9.26.4.1.

FLASHING REQUIRED AT ALL **ROOF-WALL JUNCTIONS**

INTERIOR FINISH OF EXITS

THE FLAME SPREAD RATING OF WALL OR CEILING FINISH IN AN **EXIT MUST NOT EXCEED 25.**

INTERIOR FINISH (EXCEPT EXITS)

FLAME SPREAD RATING OF INTERIOR FINISH MATERIALS SHALL NOT EXCEED $\underline{150}$ ON WALLS AND $\underline{150}$ ON CEILINGS. COMBUSTIBLE WALL AND CEILING FINISHES SUCH AS WOOD, PLYWOOD, PLASTIC, FABRIC, CARPET, ETC. MUST BE APPROVED BY THE INSPECTOR PRIOR TO THE INSTALLATION.

DIV.B. 9.10.14.1 EXPOSING BUILDING FACE OF HOUSES

UNPROTECTED OPENINGS IN THE EXPOSING BUILDING FACE SHALL NOT BE PERMITTED IF THE LIMITING DISTANCE IS LESS THAN 1.2m (3'11") AND SHALL BE LIMITED IN CONFORMANCE WITH THE REQUIREMENTS FOR UNPROTECTED OPENINGS IN DIV. B ARTICLE 9.10.15.1. WHERE THE LIMITING DISTANCE IS 1.2m (3'11") OR GREATER.

THE EXPOSING BUILDING FACE SHALL HAVE A FIRE RESISTANCE RATING OF NOT LESS THAN 45 MINUTES WHERE THE LIMITING DISTANCE IS LESS THAN

ATTACHED OR BUILT-IN GARAGE

THE SEPARATION BETWEEN THE GARAGE AND DWELLING UNIT SHALL BE CONSTRUCTED AS AN EFFECTIVE BARRIER TO GAS AND EXHAUST FUMES. THE DOOR BETWEEN THE GARAGE AND DWELLING UNIT SHALL BE EXTERIOR TYPE, TIGHT FITTING AND WEATHER-STRIPPED TO PROVIDE AN EFFECTIVE BARRIER AGAINST THE PASSAGE OF GAS AND EXHAUST FUMES AND SHALL BE FITTED WITH AN APPROVED SELF CLOSING DEVICE

2012 OBC DIV. B, 9.8.2.1. to 9.8.4.7. STAIR DIME

STAIR TYPE	MAX. RISE, mm, ALL STEPS	MINL RISE, mm, ALL STEPS	MAX, RUN, mm RECTANGULAR TREADS	MIN. RUN, mm RECTANGULAR TREADS	STAIR WIDTH, mm	HEADROOM, mm
PRIVATE STAIRS	200	125	355	255	860	1950
PUBLIC STAIRS	180	125	NO LIMIT	280	900	2050
SERVICE STAIRS	NO LIMIT	125	355	NO LIMIT	900	2050
STAIR TO UNOCCUPIED ATTIC SPACE	NO LIMIT	125	355	NO LIMIT	860	1950
STAIRS TO CRAWL SPACE	NO LIMIT	125	355	NO LIMIT	860	1950
STAIRS THAT SERVE MEZZANINES NOT EXCEEDING 20 m2 WITHIN LIVE/WORK UNITS	NO LIMIT	125	355	NO LÍMÍT	WIDTH AS PER DIV B 9.8.2.1.(3)	
NOTE: THE CURVED EDGES OF TREADS SHALL NOT REDUCE THE REQUIRED TREAD DEPTH BY MORE THAN 15mm AND SHALL NOT EXCEED 25mm HORIZONTALLY.			DEPTH			

STRUCTURAL ALTERATIONS

ALL STRUCTURAL ALTERATIONS MUST BE FIELD REVIEWED BY A PROFESSIONAL ENGINEER IF REQUIRED BY THE BUILDING INSPECTOR

FINISHED SITE GRADING

THE BUILDING SHALL BE LOCATED AND THE BUILDING SITE GRADED SO THAT WATER WILL NOT ACCUMULATE AT OR NEAR THE BUILDING AND WILL NOT ADVERSELY AFFECT ANY ADJACENT PROPERTIES.

> **A CURSORY REVIEW OF THE** STRUCTURAL ELEMENTS HAS **BEEN COMPLETED AND IS RELIANT ON ENGINEER'S CERTIFICATION OF**

RESISTANCE TO FORCED ENTRY 2012 O.B.C. DIV B. 9.7.5.2. & 9.7.5.3. A return air inlet shall be located in any room where at least 1/2 of the floor area is located over an unconditioned space (e.g. room over a garage)

- 1. SWINGING DOORS PROVIDING ACCESS TO DWELLING UNITS SHALL SATISFY THE REQUIREMENTS FOR RESISTANCE TO FORCED ENTRY AS DESCRIBED IN SUBSECTION 9.7.5.2.
- 2. WINDOWS IN DWELLING UNITS THAT ARE LOCATED WITHIN 2M OF ADJACENT GROUND LEVEL SHALL CONFORM TO THE REQUIREMENTS FOR RESISTANCE TO FORCED ENTRY AS DESCRIBED IN CLAUSE 5.3.5.OF AAMA/WDMA/CSA 101/I.S.2/A440.

2012 Code

9.8.8.1.(8)(a)(b) Windows over Stairs, Ramps and Landings

(2) In dwelling units, glazing installed over stairs, ramps and landings that extend to less than 900 mm (2 ft 11 in) above the surface to the treads, ramp or landing shall be,

- (a) protected by guards, in accordance with this Subsection, or
- (b) non-openable and designed to withstand the specified lateral loads for guards as provided in Article 4.1.5.14.

9.5.2.3. STUD WALL REINFORCEMENT

- (1) IF WOOD WALL STUDS OR SHEET STEEL WALL STUDS ENCLOSE THE MAIN BATHROOM IN A DWELLING UNIT, REINFORCEMENT SHALL BE INSTALLED TO PERMIT THE FUTURE INSTALLATION OF A GRAB BAR ON A WALL ADJACENT TO,
 - (a) A WATER CLOSET IN THE LOCATION REQUIRED BY CLAUSE 3.8.3.8.(1)(d), AND
 - (b) A SHOWER OR BATHTUB IN THE LOCATION BY CLAUSE 3.8.3.13.(1)(f).

(SEE APPENDIX A.)

The Corporation of the City of Oshawa, 50 Centre Street South, Oshawa, Ontario L1H 3Z7 Phone 905.436.5658 1.800.667.4292 Fax 905.436.5623

For 8" or 10" toundation walls with 2x8 / 2x10 floor joists ' wide x 6" thick concrete strip footings below foundation walls

24" wide x 8" thick concrete strip footings below party walls.

Foundation walls with engineered joists over 16' spans

24" wide x 8" thick concrete strip footings below party walls.

24" wide x 8" thick concrete strip footings with reinforcing below exterior walls. 30" wide x 8" thick concrete strip footings with reinforcing below party walls. refer to the footings details on engineered fill)

Assume the larger footing size when two conditions apply.

Assumed 120 kPa (18 psi) soil bearing capacity or 90 kPa engineered soil fill. Bearing capacity to be verified on site.

Concrete Pad Footing Sizes

120 kPa Native Soil	90 kPa Engineered Fill
F1 = 42" x 42" x 18"	F1 = 48" x 48" x 20"
F2 = 36" x 36" x 16"	F2 = 40" × 40" × 16"
F3 = 30" x 30" x 12"	$F3 = 34" \times 34" \times 14"$
F4 = 24" x 24" x 12"	F4 = 28" x 28" x 12"
F5 = 16" x 16" x 8"	F5 = 18" x 18" x 8"

Refer to the floor plans for non-standard footing sizes

Brick Veneer Cuts

When the brick veneer cut is greater than 26" a 10" thick poured concrete foundation wall is required.

Exterior Concrete Slabs

All garage slabs, porch slabs, poured concrete stairs and exposed concrete flat work to be 32 MPa with 5-8% air entrainment.

Ceramic Tile over Joists

Space conventional floor ioists @ 12" o/c below all ceramic tile areas. Provide 1 row of bridging for spans of 5'-7" and 2 rows for spans greater than 7'-0".

Engineered Roof Trusses

fer to the roof truss shop drawings for all roof framing information.

Engineered Floor Joists

lefer to the floor framing shop drawings for engineered framing layouts, hardware

Steel Column Notes

C1 = 4" x 4" x $\frac{1}{4}$ " HSS w/ 10" x 8" x $\frac{1}{2}$ " base plate and 2 - $\frac{3}{4}$ " dia. anchor bolts.

C2 = $5" \times 5" \times \frac{1}{4}"$ HSS w/ 12" x 12" x $\frac{1}{2}"$ base plate and $4 - \frac{3}{4}"$ dia. anchor bolts.

Use 4 bolts for moment connection

"M" = Moment connection at beam and column = 35 kN-m

Grading

Plans and elevations are not drawn to accurate grade elevations. Refer to final grading plan.

Door Schedule

No.	lo. Width		Ceiling Heights		Type		
			8' to 9'	10' or more			
1	2'-10'	' (34'')	6'-8"	8'-0"	Insulated entrance door		
1A	2'-8"	(32'')	6'-8"	8'-0"	Insulated entrance door		
2	2'-8"	(32'')	6'-8"	8'-0"	Wood and glass door		
3	2'-8"	(32")	6'-8"	8'-0"	Exterior slab door		
4	2'-8"	(32'')	6'-8"	8'-0"	Interior slab door		
5	2'-6"	(30'')	6'-8"	8'-0"	Interior slab door		
6	2'-2"	(26'')	6'-8"	8'-0"	Interior slab door		
7	1'-6"	(18")	6'-8"	8'-0"	Interior slab door		

Garage Wall - 2x4 Stud Design

Studs	Spacing	Maxim	num Height
2x4	16" o/c	8'-0	(2.44m)
2x4	12" o/c	8'-10"	(2.69m)
2-2x4	16" o/c	10'-1"	(3.07m)
2-2x4	12" o/c	10'-9"	(3.28m)
3-2x4	16" o/c	11'-2"	(3.40m)
3-2x4	12" o/c	12'-4"	(3.76m)
l			


For roof design snow loads of 2.6kPa Supported roof truss length of 6.0m

Supported floor joist length of 2.5m

Studs exceeding 3.0m in height shall be installed per OBC 9.23.10.1.(2)


Iwo Storey Height Wall Details - max. 18'-0" tall

and Semi-Detached Houses up White 230 38 stud wall nailed together and spaced at 12" o/c full height c/w solid ng @ 48" o/c vertical and $rac{7}{16}$ " OSB exterior wall sheathing.

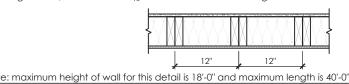


Two Storey Height Wall Detail - max. 20'-2" tall

2 - 1 ½" x 5 ½" Laminated strand lumber (LSL) 1.5E stud wall alued and nailed togethe and spaced at 10" o/c full height c/w solid blocking @ 8'-0" o/c vertical and $\frac{7}{6}$ " OSB exterior wall sheathing.

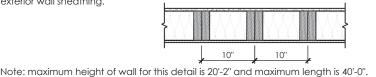

Two Storey Height Wall Detail - max. 21'-5" tall

2 - 1 ½" x 5 ½" Laminated strand lumber (LSL) 1.5E stud wall glued and nailed togethe and spaced at 9" o/c full height c/w solid blocking @ 8'-0" o/c vertical and $\%_6$ " OSB

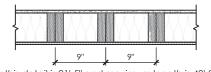

ote: maximum height of wall for this detail is 21'-5" and maximum length is 40'-0".

Steel Angles and Wood Beam Schedules

Brick Veneer Steel Lintels + Wood Lintels and Beams


Label	Steel Angle Size $(v \times h \times t)$		Wood Size	(members +	w + h)
WL1 =	3½" x 3½" x½" (89 x 89 x 6.4) [2]	+	2 - 2 x 8	(2 - 38 x 184)	S.P.F. No. 2
WL2 =	4" x 3½" x ¾" (102 x 89 x 7.9) [?]	+	2 - 2 x 8	(2 - 38 x 184)	S.P.F. No. 2
WL3 =	5" x 3½" x ¾" (127 x 89 x 7.9) [4]	+	2 - 2 x 10	(2 - 38 x 235)	S.P.F. No. 2
WL4 =	6" x 3½" x ¾" (152 x 89 x 9.5) [?]	+	2 - 2 x 12	(2 - 38 x 286)	S.P.F. No. 2
WL5 =	6" x 4" x 3/8" (152 x 102 x 9.5) [?]	+	2 - 2 x 12	(2 - 38 x 286)	S.P.F. No. 2
WL6 =	5" x 3 ½" x 5/6" (127 x 89 x 7.9) [4]	+	2 - 2 x 12	(2 - 38 x 286)	S.P.F. No. 2
WL7 =	5" x 3½" x ¾" (127 x 89 x 7.9) [4]	+	3 - 2 x 10	(3 - 38 x 235)	S.P.F. No. 2
WL8 =	5" x 3½" x ¾" (127 x 89 x 7.9) [4]	+	3 - 2 x 12	(3 - 38 x 286)	S.P.F. No. 2
WL9 =	6" x 4" x 3/8" (152 x 102 x 9.5) [?]	+	3 - 2 x 12	(3 - 38 x 286)	S.P.F. No. 2

Wood Lintels and Beams

Label		Beam Size	(members +	w + h
WB1	=	2 - 2 x 8	(2 - 38 x 184)	S.P.F. No. 2
WB2	=	3 - 2 x 8	(3 - 38 x 184)	S.P.F. No. 2
WB3	=	2 - 2 x 10	(2 - 38 x 235)	S.P.F. No. 2
WB4	=	3 - 2 x 10	(3 - 38 x 235)	S.P.F. No. 2
WB5	=	2 - 2 x 12	(2 - 38 x 286)	S.P.F. No. 2
WB6	=	3 - 2 x 12	(3 - 38 x 286)	S.P.F. No. 2
WB7	=	5 - 2 x 12	(5 - 38 x 286)	S.P.F. No. 2
WB11	=	4 - 2 x 10	(4 - 38 x 235)	S.P.F. No. 2
WB12	=	4 - 2 x 12	(4 - 38 x 286)	S.P.F. No. 2

aminated Veneer Lumber (LVL) Beams

Lami	nai	ed veneer L	ningei (rai
Label		Beam Size (mer	nbers + w + h
LVL1A	=	1 - 1 ¾" x 7 ½"	(1 - 45 x 184)
L VL1	=	2 - 1 3/4" x 7 1/2"	(2 - 45 x 184)
LVL2	=	3 - 1 ¾" x 7 ½"	(3 - 45 x 184)
LVL3	=	4 - 1 ¾" x 7 ½"	(4 - 45 x 184)
LVL4A	=	1 - 1 ¾" x 9 ½"	(1 - 45 x 240)
LVL4	=	2 - 1 ¾" x 9 ½"	(2 - 45 x 240)
LVL5	=	3 - 1 ¾" x 9 ½"	(3 - 45 x 240)
LVL5A	=	4 - 1 ¾" x 9 ½"	(4 - 45 x 240)
LVL6A	=	1 - 1 ¾" x 11 ½"	(1 - 45 x 300)
LVL6	=	2 - 1 3/4" x 11 7/8"	(2 - 45 x 300)
LVL7	=	3 - 1 ¾" x 11 ¾"	(3 - 45 x 300)
LVL7A	=	4 - 1 3/4" x 11 7/8"	(4 - 45 x 300)
LVL8	=	2 - 1 ¾" x 14"	(2 - 45 x 356)
LVL9	=	3 - 1 ¾" x 14"	$(3 - 45 \times 356)$
LVL9A	=	2 - 1 ¾" x 16"	(2 - 45 x 406)
LVL9B	=	3 - 1 ¾" x 16"	(3 - 45 x 406)
LVL10	=	2 - 1 ¾" x 18"	(2 - 45 x 456)

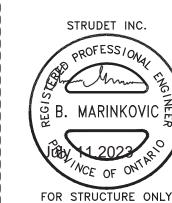

Loose Steel Lintels

Label		Steel Size (v x h	x t)
L1	=	3½" x 3½" x½"	(89 x 89 x 6.4) [2]
L2	=	4" x 3 ½" x 5/16"	(102 x 89 x 7.9) [?]
L3	=	5" x 3 ½" x ¾;"	(127 x 89 x 7.9) [4]
L4	=	6" x 3 ½" x ¾"	(152 x 89x 9.5) [?]
L5	=	6" x 4" x 3/8"	(152 x 102 x 9.5) [?]
L6	=	7" x 4" x ¾"	(178 x 102 x 9.5) [?]

Glue-Laminated Floor Beams

bel		Beam Size $(w \times h)$
.U1	=	3 ½" x 11 ½" (80 x 300)
.U2	=	5 ½" x 11 ½" (130 x 300)

Minimum Thermal Performance

The minimum thermal performance of building envelope and equipment shall conform to the following

Prescriptive Package A1 Space Heating Fuel

	R	Max. U	R
Component	Max. Nominal		Min. Effective
Ceiling with Attic Space	60	0.017	59.22
Ceiling without Attic Space	31	0.036	27.65
Exposed Floor	31	0.034	29.80
Walls Above Grade	22	0.059	17.03
Basement Walls	20 ci	0.047	21.12
Below Grade Slab Entire Surface > 600 mm Below Grade	-	-	-
Heated Slab or Slab <= 600 mm Below Grade	10	0.090	11.13
Edge of Below Grade Slab <= 600 mm Below Grade	10		

Energy rating: 25

96%

75%

0.80

Max. U: Min. AFAU:

Min SRF

Min. EF:

Area Calculations Villa 11-1

Windows and Sliding Glass Doors

Space Heating Equipment

Domestic Water Heater

Skylights

HRV

1372 sa ft, 127,46 sa m Ground Floor 1562 sq ft, 145.11 sq m 2934 sq ft, 272.58 sq m Second Floor Total floor area

Total open to below 18 sa ft. 1.67 sa m 0 sq ft, 0.00 sq m Finished basement Total gross floor area 2952 sq ft, 274.25 sq m

Coverage Areas Ground floor 1372 sq ft, 127.46 sq m Garage 327 sq ft, 30.38 sq m 73 sq ft, 6.78 sq m Porch 0 sq ft, 0.00 sq m 1699 sq ft, 157.84 sq m Other structures Coverage w/o porch Coverage w/ porch 1772 sq ft, 164.62 sq m

Area Calculations

Villa 11-2 1372 sa ft. 127.46 sa m Ground Floor Second Floor 1548 sq ft, 143.81 sq m 2920 sq ft, 271.28 sq m Total floor area

18 sa ft. 1 67 sa m Total open to below 0 sq ft, 0.00 sq m Finished basement Total gross floor area 2938 sq ft, 272.95 sq m

Coverage Areas Ground floor 1372 sq ft, 127.46 sq m Garage Porch 327 sq ft, 30.38 sq m 73 sq ft, 6.78 sq m 0 sq ft, 0.00 sq m 1699 sq ft, 157.84 sq m Other structures Coverage w/o porch Coverage w/ porch 1772 sq ft, 164.62 sq m

Total

Wall Area

SB-12 Calculations

Villa 11-1

Elevation

Left side

Right side

749.5 sa ft (69.6 sa m) 82.7 sa ft (7.7 sa m) 11.04% 1128.5 sq ft (104.8 sq m) 7.58% 1112.5 sq ft (103.4 sq m) 29.5 sq ft (2.7 sq m) 2 65% 3715.6 sq ft (345.2 sq m) 293.1 sq ft (27.2 sq m) 7.89%

Window Area

Percentage

SB-12 Calculations

Villa 11-2 Elevation

Wall Area Window Area **Percentage** 83.1 sq ft (7.7 sq m) 83.5 sq ft (7.8 sq m) 744.7 sq ft (69.2 sq m) 11.15% Left side 7.49% Right side 1112.5 sq ft (103.4 sq m) 29.5 sq ft (2.7 sq m) 2 65% Total 3696.2 sq ft (343.4 sq m) 283.9 sq ft (26.4 sq m) 7.68%

Area Calculations

Villa 11-3 1352 sa ft. 125.60 sa m Second Floor 1556 sq ft, 144.56 sq m 2908 sq ft, 270.16 sq m Total floor area

Total open to below 18 sq ft, 1.67 sq m 0 sq ft, 0.00 sq m Finished basement 2926 sq ft, 271.83 sa m Total gross floor area

Coverage Areas 1352 sq ft, 125.60 sq m Ground floor

326 sq ft, 30.29 sq m 88 sq ft, 8.18 sq m Garage Porch Other structures 0 sa ft, 0.00 sa m 1678 sq ft, 155.89 sq m Coverage w/o porch Coverage w/ porch 1766 sq ft, 164.07 sq m

2023-07-11

SB-12 Calculations Villa 11-3

Elevation **Wall Area** Window Area **Percentage** 774.9 sq ft (72.0 sq m) 1145.9 sq ft (106.5 sq m) 93.7 sq ft (8.7 sq m) 89.9 sq ft (8.4 sq m) Front 12 09% Left side 7.85% Riaht side 1112.5 sq ft (103.4 sq m) 29.5 sa ft (2.7 sa m) 2 65% Total 3775.5 sq ft (350.8 sq m) 306.8 sq ft (28.5 sq m) 8.13%

> Villa 11 Compliance Package A1

ĸe	visions		
#	Description	Date	Ву
1.	Issued for client review	2023-06-01	JM
2.	Revised to match brochure	2023-06-02	JM
3.	Issued for p. eng. review	2023-06-21	JM
4.	Issued for permit	2023-07-11	LM
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ontractor shall check all dimensions and elevations before commencing with work and report any discrepancies to the Designer. Prints are not to

he undersigned has reviewed and takes responsibility for this design, as well as having the qualifications and requirements mandated by th Ontario Building Code (O.B.C.) to be a Designer.

Qualification Information

amie Mack	35923	· Wad
ame	BCIN	Signature
eaistration Information	Mackitecture	103532



Tel: 416-735-8190 Email: info@mackitecture.ca

General Notes and Charts Elevation 1				
	by	area	sheet no	
	JW	-		
			l	

22-012

36' Sinale

Greenpark

www.greenparkgroup.ca

Zadorra Estates Inc.


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It is the builder's complete responsibility to ensure that all plans submitted for approval fully comply with the Architectural Guidelines and all applicable regulations and requirements including zoning provisions and any provisions in the subdivision agreement. The Control Architect is not responsible in any way for examining or approving site (lotting) plans or working drawings with respect to any zoning or building code or permit matter or that any house can be properly built or located on its lot. **MHP 23038** 45 minute fire rated wall assembly This is to certify that these plans comply with the applicable Architectural Design Guidelines approved by the City of OSHAWA. JOHN G. WILLIAMS LTD., ARCHITECT 32'-10" 21'-4" DATE: JUL 31, 2023 2-20M rebar in top of the foundation wall for lateral support at the sunken floor. Proposed electrical Provide 6" widened footing -Extend bars 24" beyond opening each side (5A) breaker panel location around wood post 30" x 16" structural steel frame basement window (typ.) Rough-in Unexcavated
Remove top soil only Recess the foundation for 31 the sunken mudroom floor refer to approved siting. WB1 low F4 (16) vary F3] screen Full height at provide solid blocking cold cellar @ 24" o.c. where floor Cold ioists are parallel to \$.A. 5.M.A. 5. Storage foundation wall (typ.) (36)/ 13'-6" eng. Parsons precast steps above Unfinished Basement $\langle 14 \rangle$ Load bearing wall 2-20M rebar in top of the foundation wall for lateral support at the stair opening. Extend bars 24" beyond opening each side 2 STRUDET INC. PROFESS/ON 12" thick foundation for LVL7 bearing B. MARINKOVIC E 19'-0" VOA 2023 ONTER 57'-2" Basement Plan '1' FOR STRUCTURE ONLY Villa 11 Compliance Package A1 The undersigned has reviewed and takes responsibility for this design, as well as having the qualifications and requirements mandated by the Ontario Building Code (O.B.C.) to be a Designer. **Greenpark Basement Floor Plan Elevation 1 Qualification Information** www.greenparkgroup.ca www.mackitecture.ca 3/16" = 1'-0" 2952 sq ft Contractor shall check all dimensions and elevations before commencing with work and report any discrepancies to the Designer. Prints are not to 975A Elain Street West, Suite 353 BCIN 1-1 Cobourg, ON K9A 5J3 Zadorra Estates Inc. 36' Single 2023-07-11 22-012 Tel: 416-735-8190 Email: info@mackitecture.ca Mackitecture



It is the builder's complete responsibility to ensure that all plans submitted for approval fully comply with the Architectural Guidelines and all applicable regulations and requirements including zoning provisions and any provisions in the subdivision agreement. The Control Architect is not responsible in any way for examining or approving site (lotting) plans or working drawings with respect to any zoning or building code or permit matter or that any house can be properly built or located on its lot. This is to certify that these plans comply with the applicable Architectural Design Guidelines approved by the City of OSHAWA. JOHN G. WILLIAMS LTD., ARCHITECT 21'-4" DATE: JUL 31, 2023 (5A) (5A) screen PLA Full height at cold cellar Cold Storage/ (36) Parsons precast steps above fl. LVL6A STRUDET INC. PROFESSION B. MARINKOVIC E NCE OF ONTAR! 2023 FOR STRUCTURE ONLY Villa 11 Compliance Package A1 **Greenpark Basement Floor Plan Elevation 2** www.greenparkgroup.ca 2938 sq ft 1-2 Zadorra Estates Inc. 22-012



The undersigned has reviewed and takes responsibility for this design, as well as having the qualifications and requirements mandated by the Ontario Building Code (O.B.C.) to be a Designer. **Qualification Information**

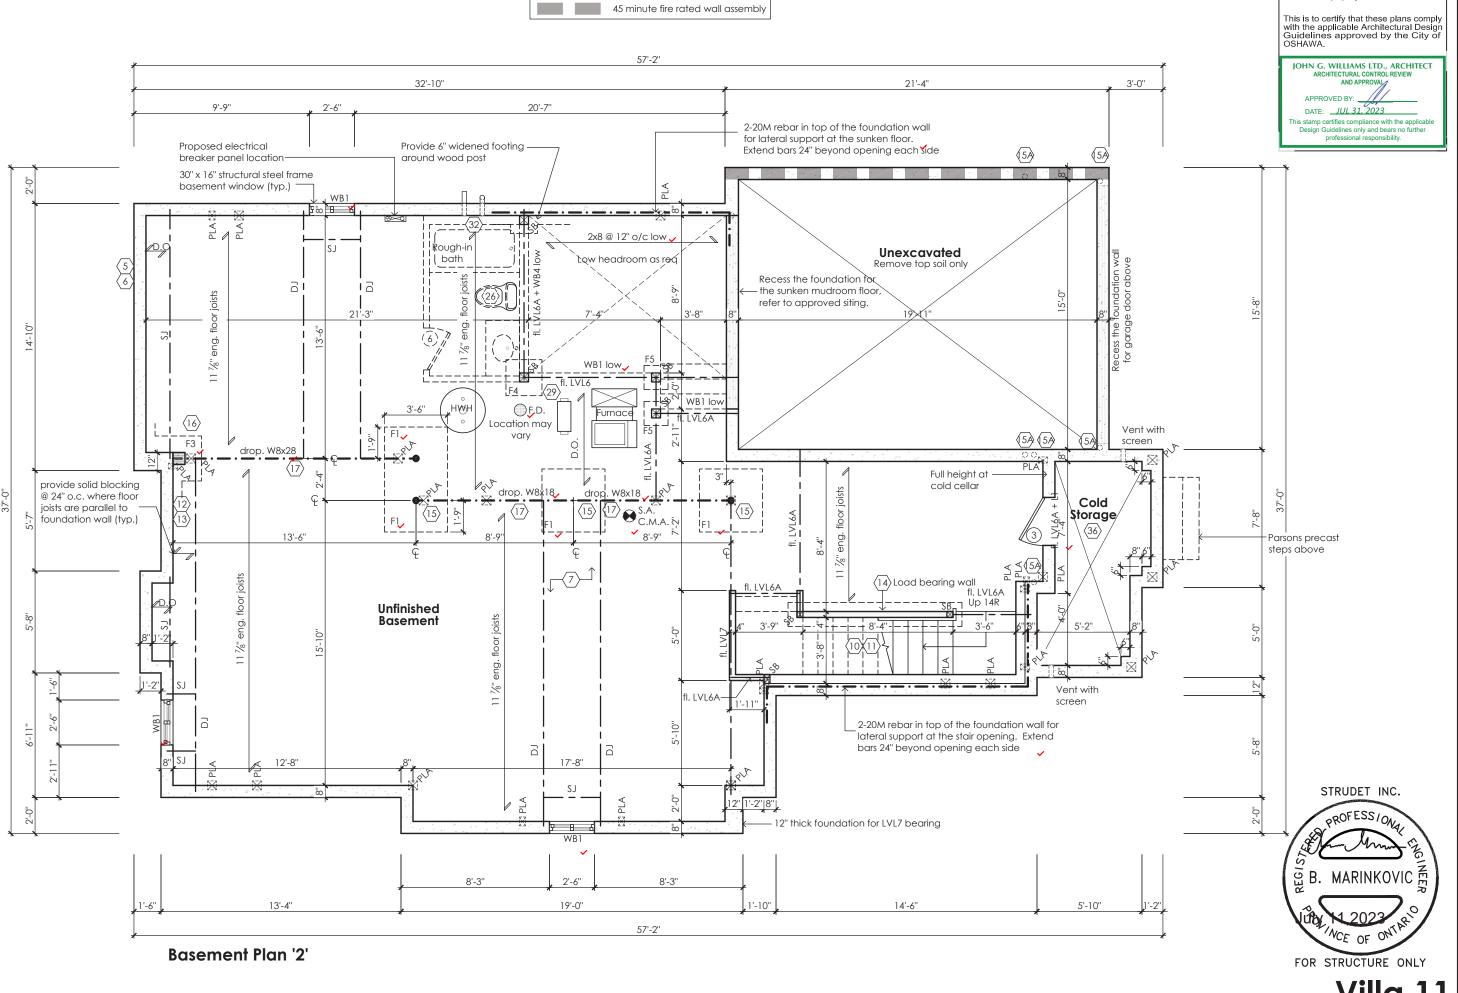
BCIN

Mackitecture


www.mackitecture.ca 975A Elgin Street West, Suite 353 Cobourg, ON K9A 5J3 Tel: 416-735-8190 Email: info@mackitecture.ca

3/16" = 1'-0" 36' Single 2023-07-11



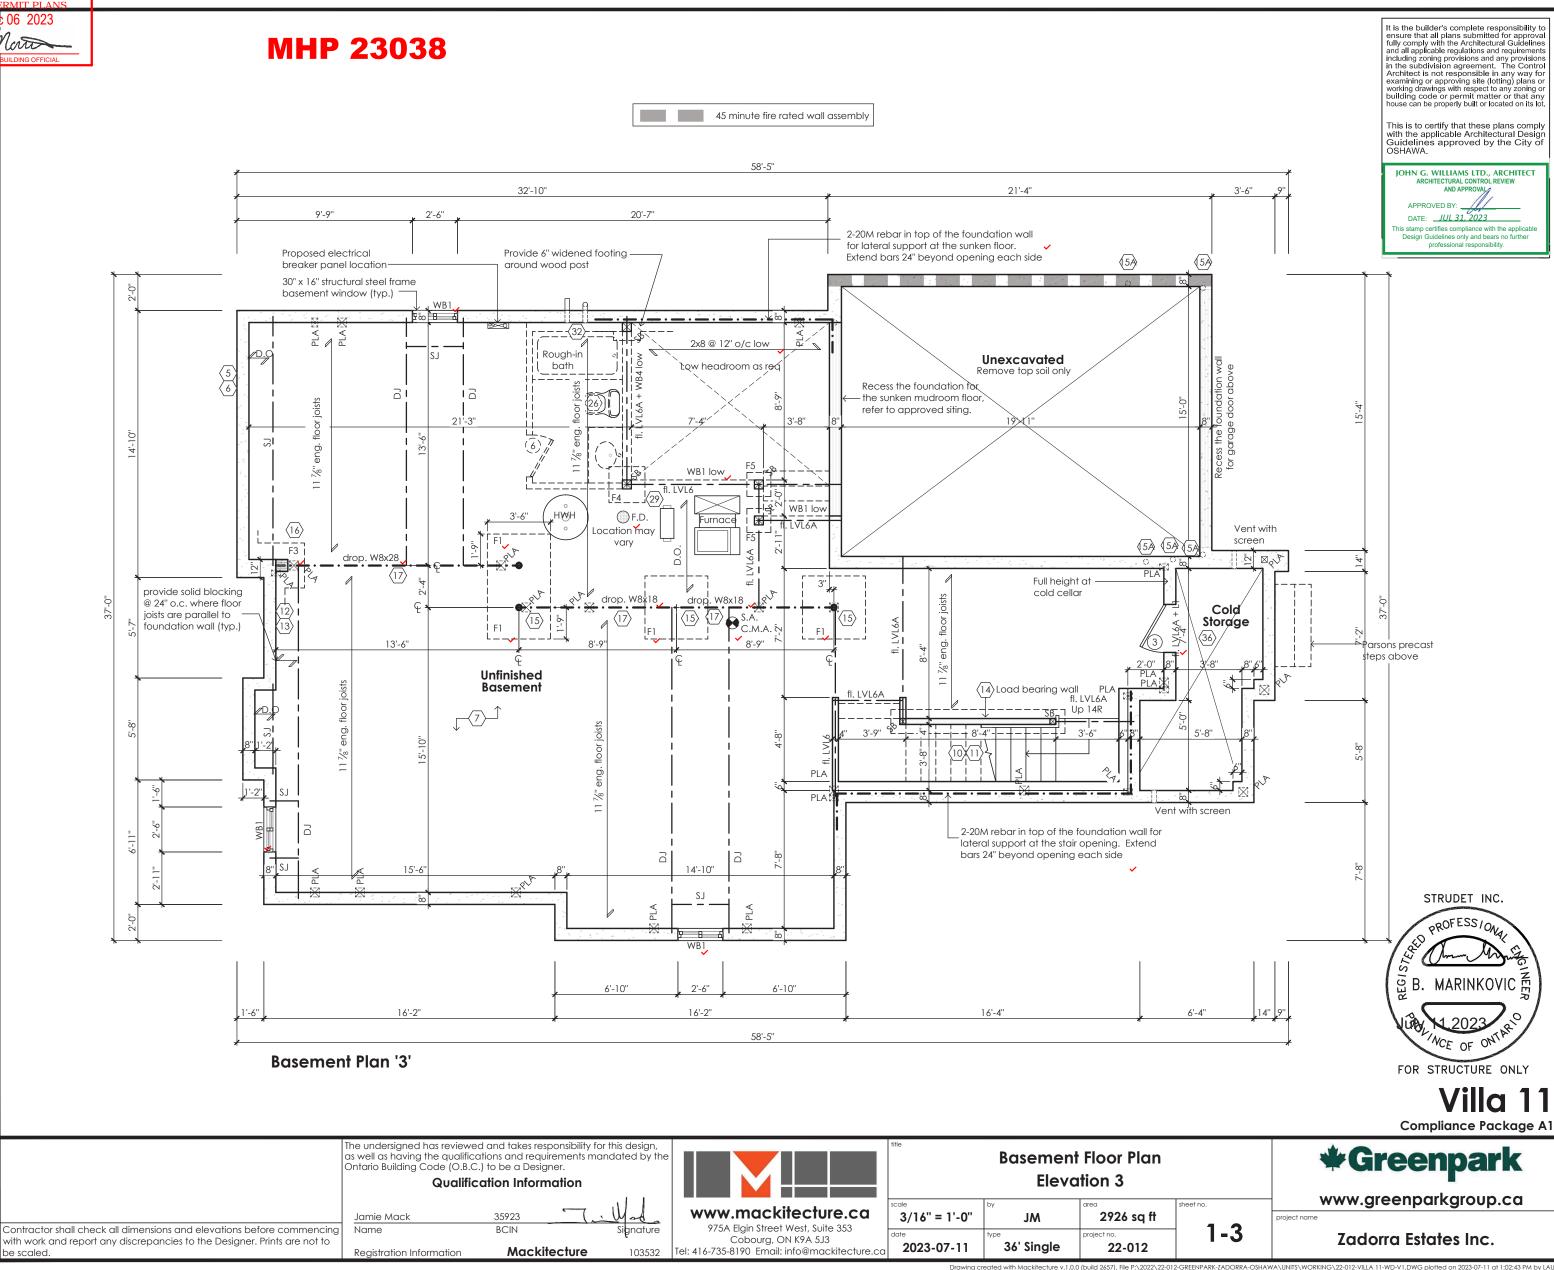



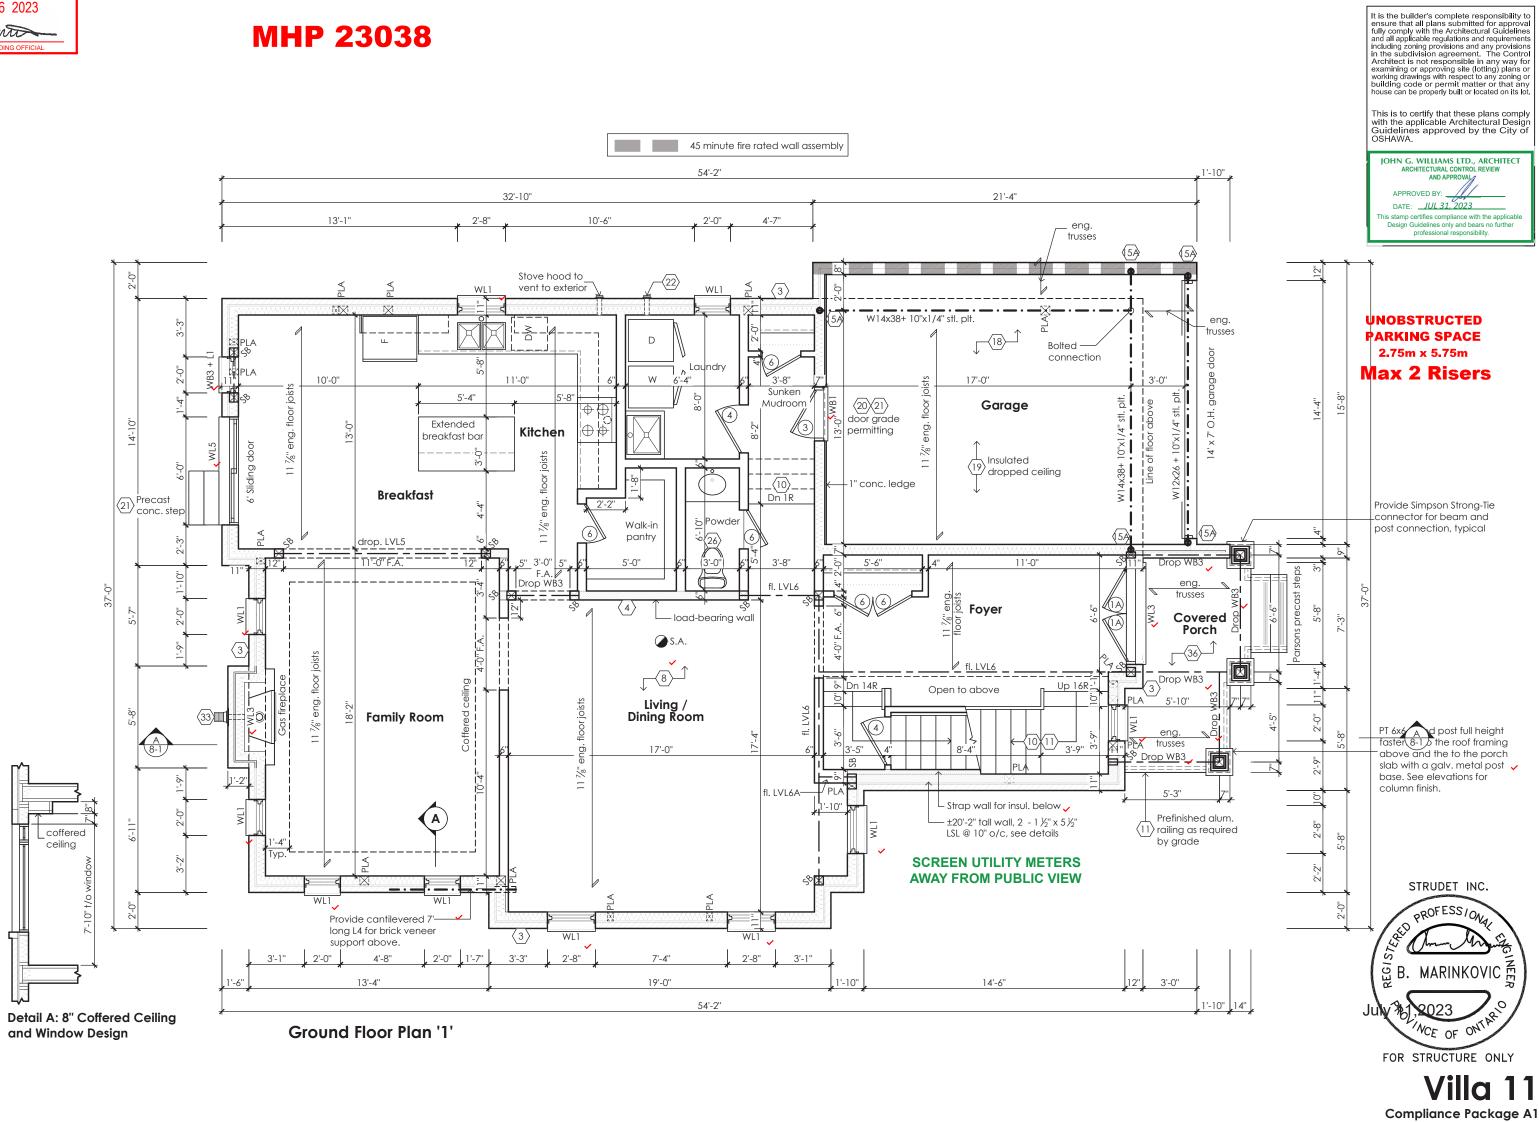

The undersigned has reviewed and takes responsibility for this design, as well as having the qualifications and requirements mandated by the **Ground Floor Plan**


Ontario Building Code (O.B.C.) to be a Designer. **Qualification Information** Contractor shall check all dimensions and elevations before commencing with work and report any discrepancies to the Designer. Prints are not to BCIN Mackitecture


www.mackitecture.ca 975A Elain Street West, Suite 353 Cobourg, ON K9A 5J3
Tel: 416-735-8190 Email: info@mackitecture.ca

Elevation 1 2952 sq ft 3/16" = 1'-0" 36' Single 2023-07-11 22-012

Greenpark

www.greenparkgroup.ca

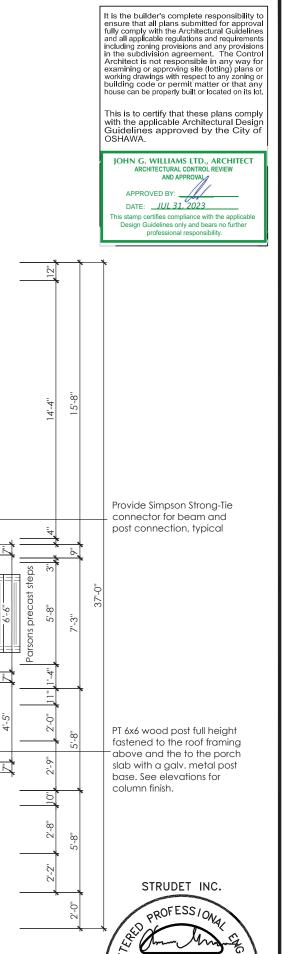

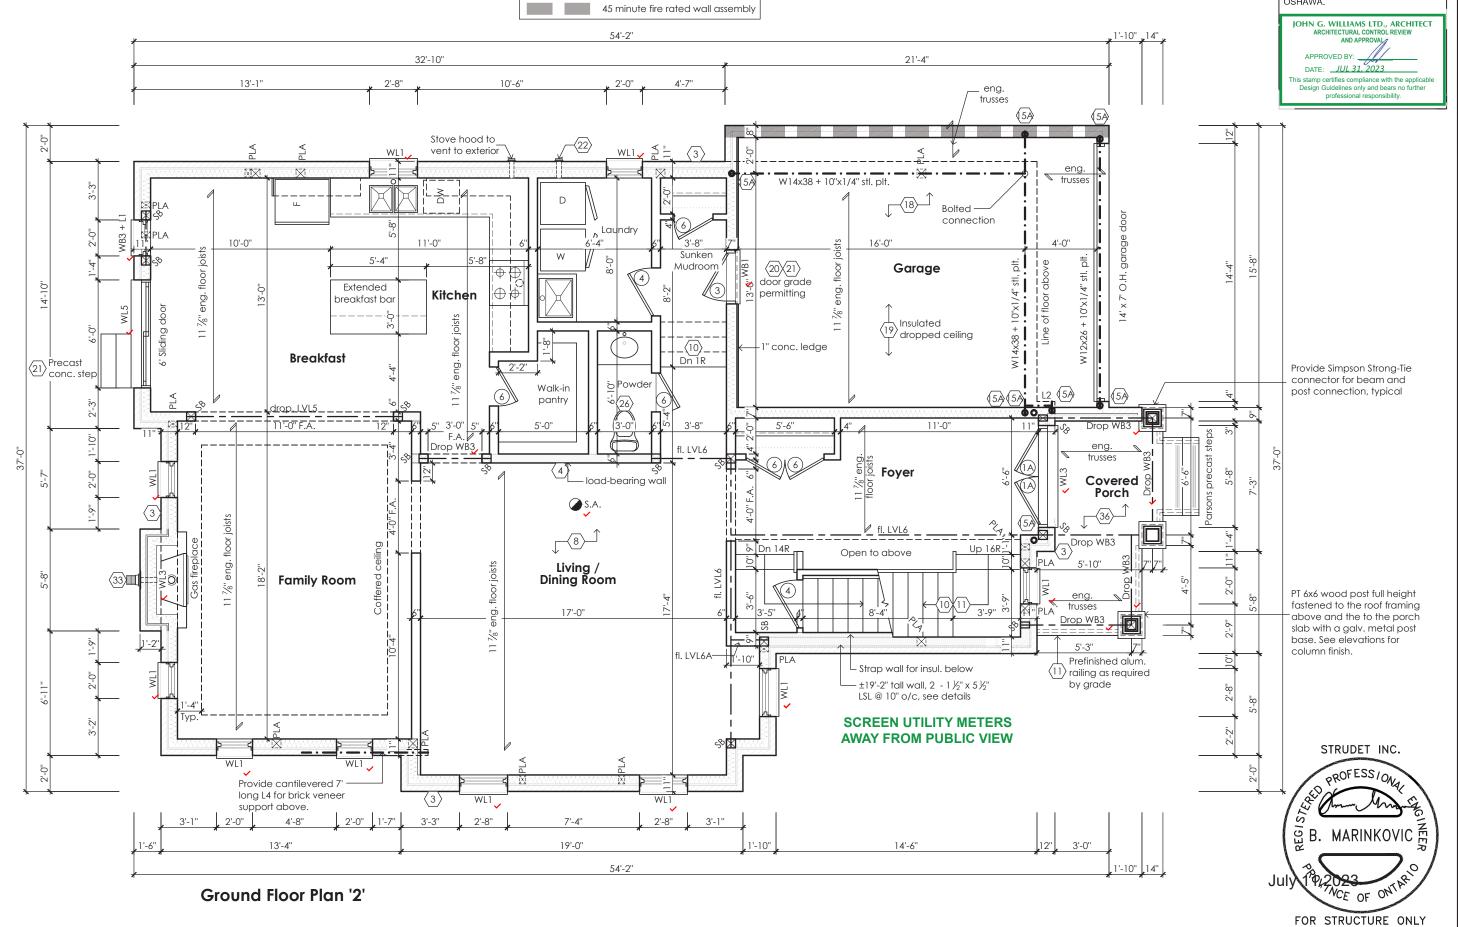

The undersigned has reviewed and takes responsibility for this design, as well as having the qualifications and requirements mandated by the Ontario Building Code (O.B.C.) to be a Designer. **Qualification Information**

Name BCIN Mackitecture

Contractor shall check all dimensions and elevations before commencing with work and report any discrepancies to the Designer. Prints are not to




Ground Floor Plan Elevation 2					
3/16" = 1'-0"	JM	2938 sq ft	sheet no.		
2023-07-11	36' Single	project no. 22-012	2-2		


Compliance Package A1 **Greenpark**

Villa 11

www.greenparkgroup.ca



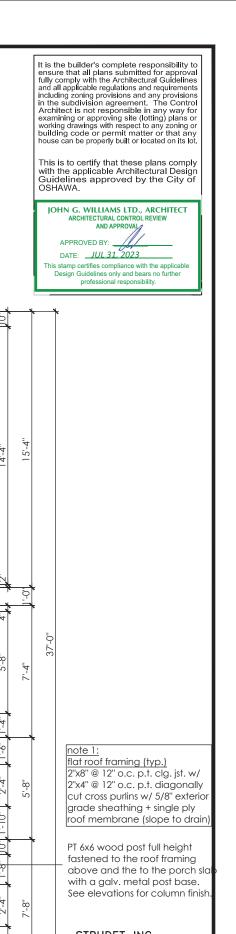

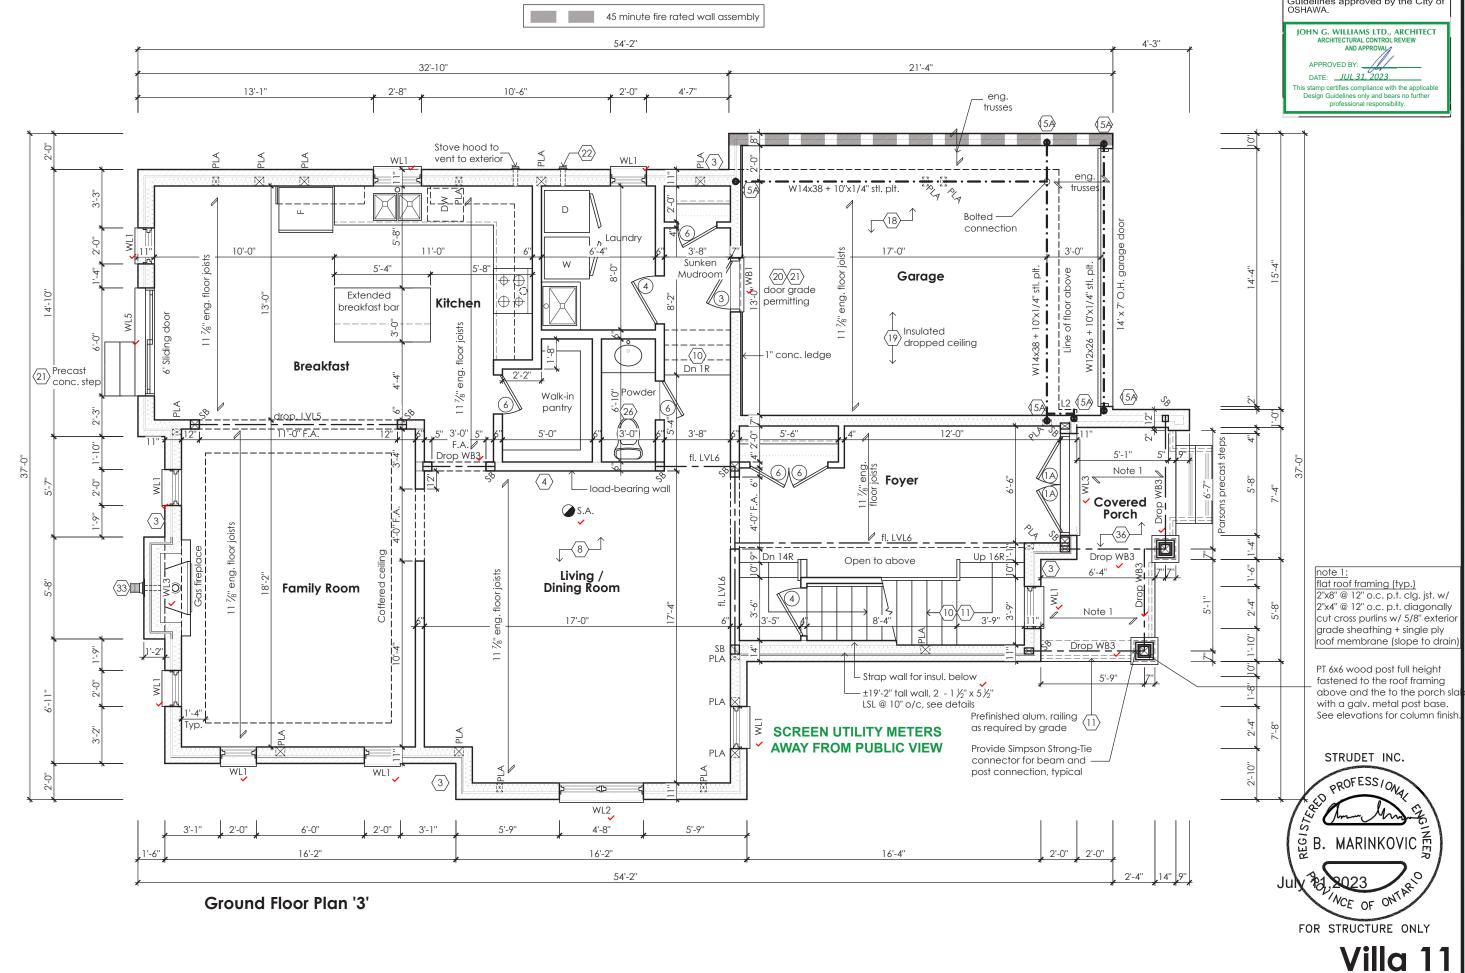

The undersigned has reviewed and takes responsibility for this design, as well as having the qualifications and requirements mandated by the **Ground Floor Plan**

Ontario Building Code (O.B.C.) to be a Designer. **Qualification Information** Contractor shall check all dimensions and elevations before commencing with work and report any discrepancies to the Designer. Prints are not to BCIN Mackitecture

www.mackitecture.ca 3/16" = 1'-0" 975A Elain Street West, Suite 353 Cobourg, ON K9A 5J3
Tel: 416-735-8190 Email: info@mackitecture.ca 2023-07-11

Elevation 3 2926 sq ft 2-3 36' Single 22-012

Greenpark


www.greenparkgroup.ca

Compliance Package A1

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The undersigned has reviewed and takes responsibility for this design, as well as having the qualifications and requirements mandated by the Ontario Building Code (O.B.C.) to be a Designer.

Second Floor Plan '1'

ode (O.B.C.) to be a Designer. Qualification Information

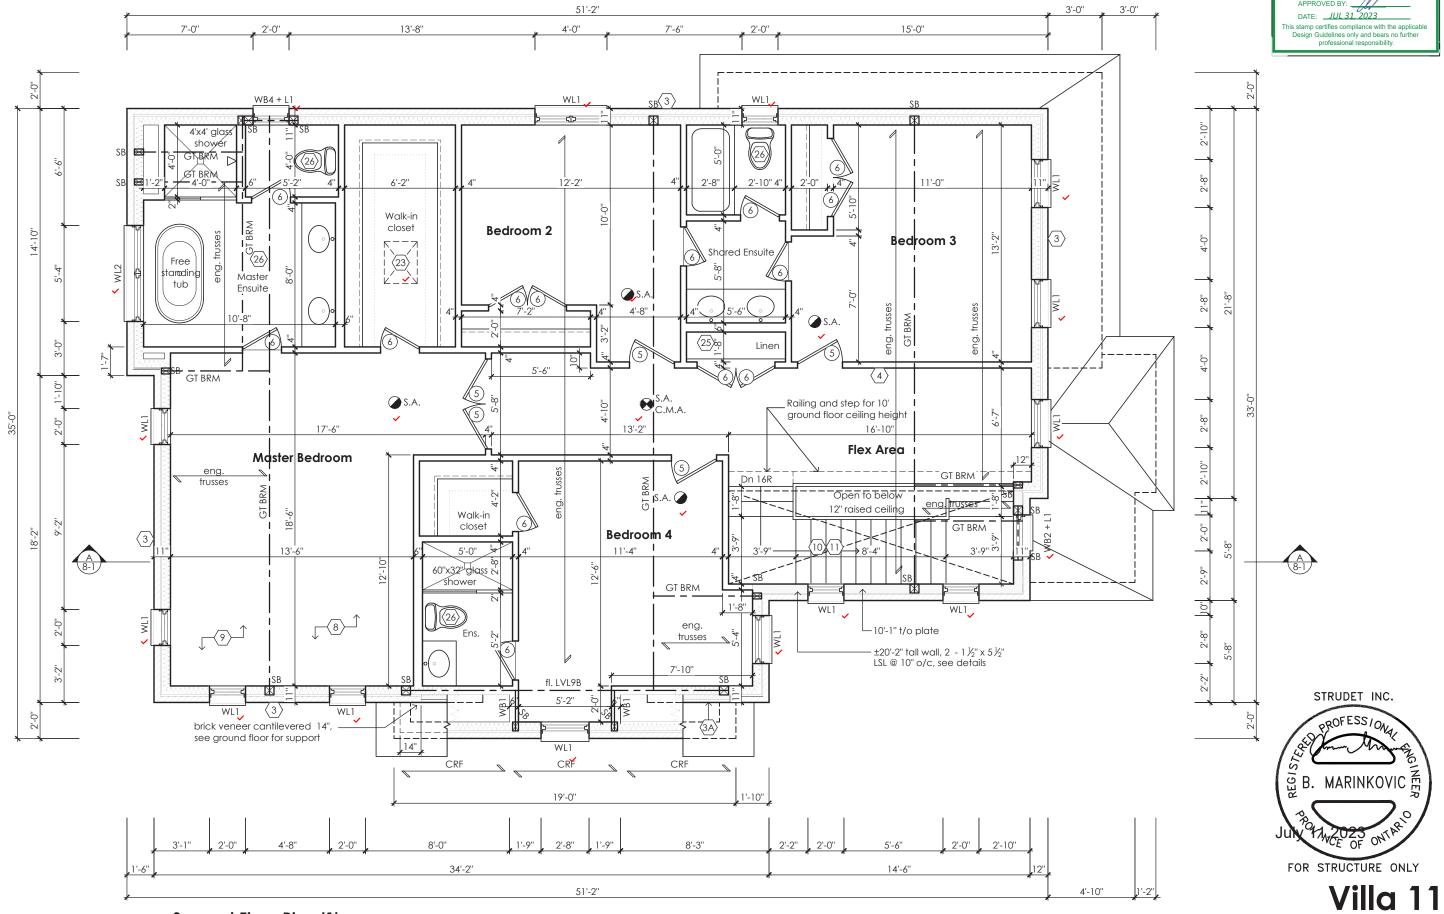Contractor shall check all dimensions and elevations before commencing with work and report any discrepancies to the Designer. Prints are not to be scaled.

Jamie Mack
Name
BCIN
Signature
Registration Information
Mackitecture
103532



Second Floor Plan Elevation 1						
3/16" = 1'-0"	J M	2952 sq ft	sheet no.			
2023-07-11	36' Single	project no. 22-012	3-1			

Greenpark

Compliance Package A1


www.greenparkgroup.ca

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DATE: JUL 31, 2023



Second Floor Plan '2'


Villa 11 Compliance Package A1

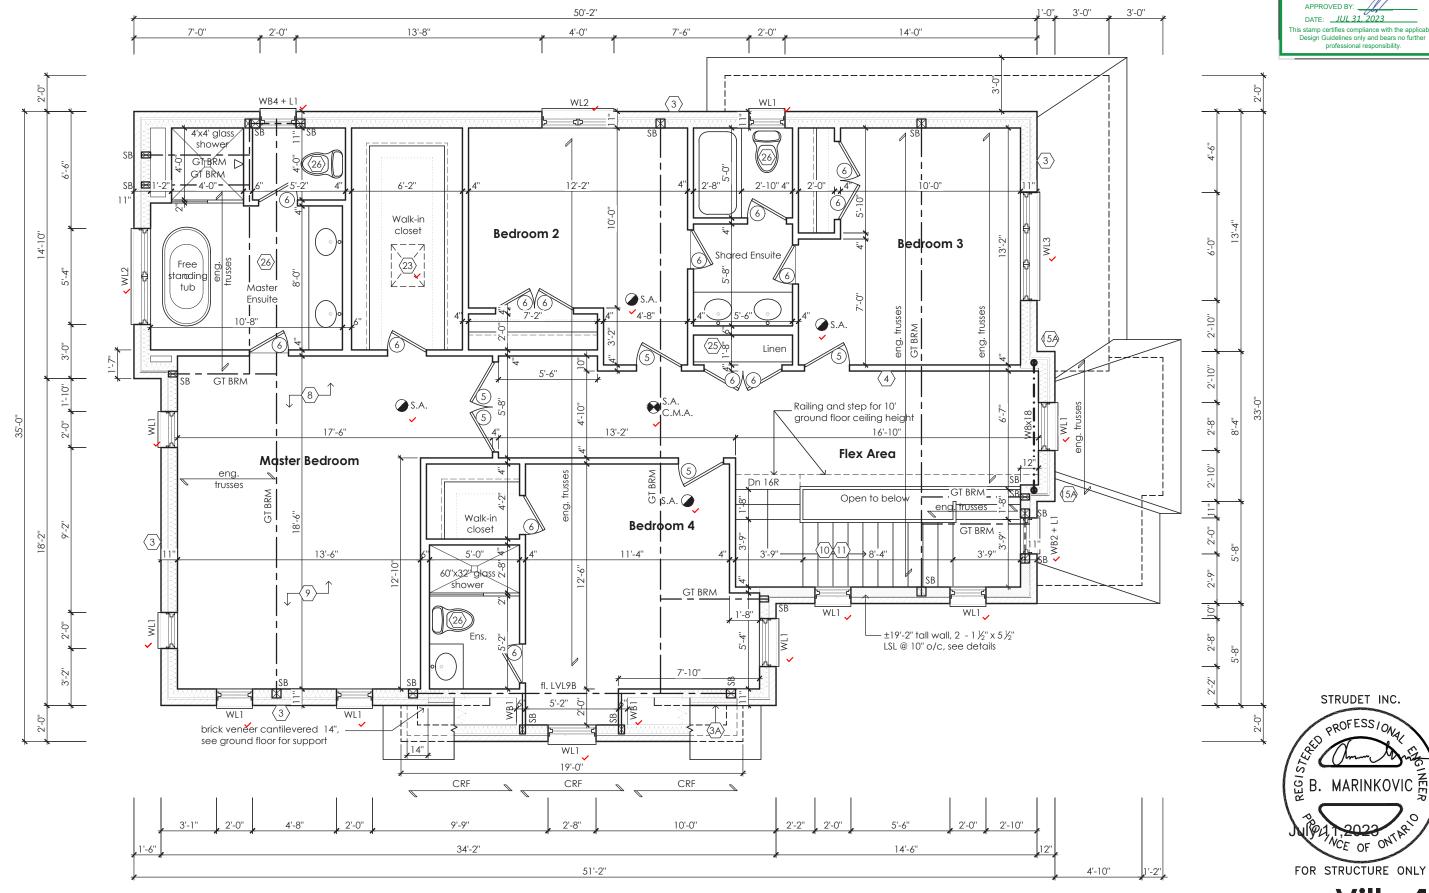STRUDET INC.

PROFESS/ON

1941,2023 NA

The undersigned has reviewed and takes responsibility for this design, as well as having the qualifications and requirements mandated by the Ontario Building Code (O.B.C.) to be a Designer. **Qualification Information**

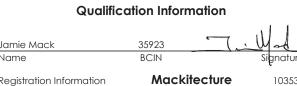




	Second I	Floor Plan				
Elevation 2						
3/16" = 1'-0"	JM	2938 sq ft	sheet no.			
date 2023-07-11	36' Single	project no. 22-012	3-2			

Greenpark

www.greenparkgroup.ca

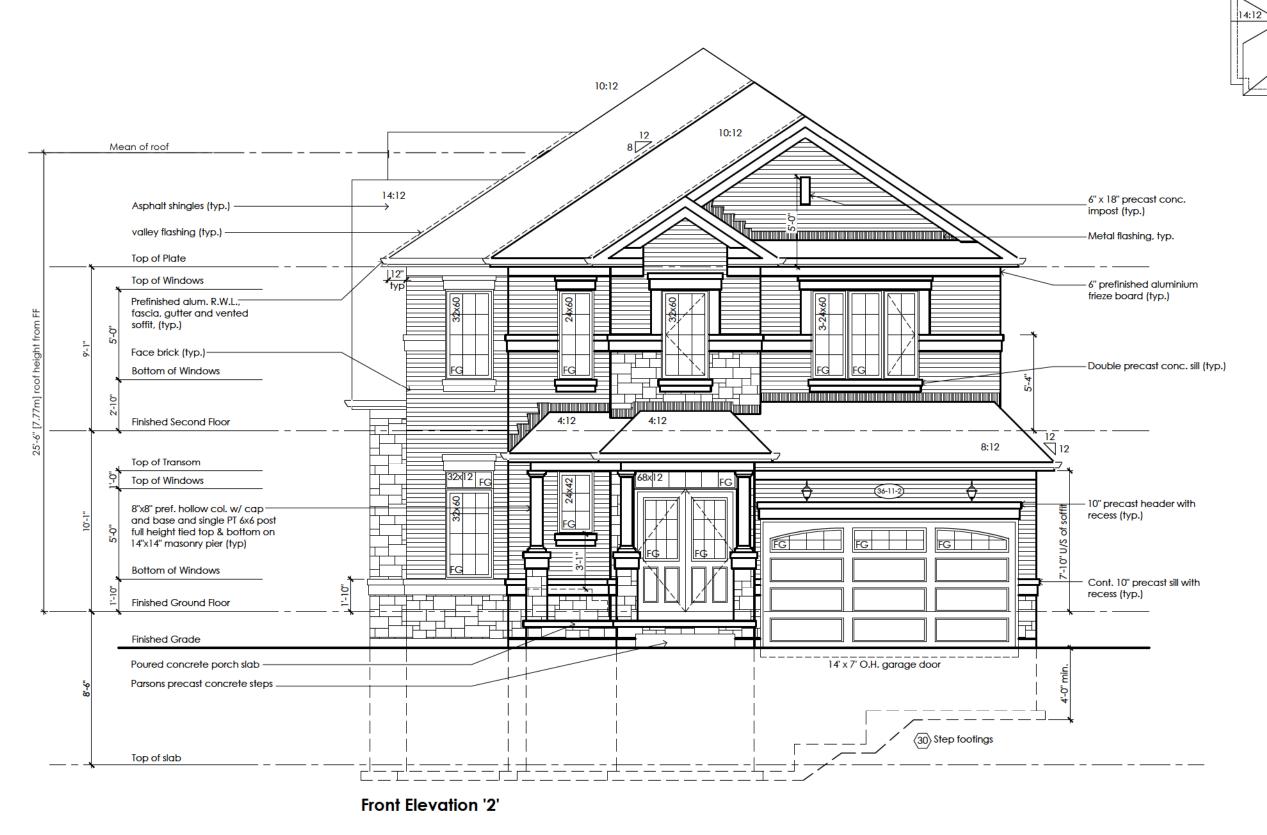

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10:12

8:12

Roof Plan '2'

10:12,

8:12

8:12

This is to certify that these plans comply with the applicable Architectural Design Guidelines approved by the City of Oshawa

Villa 11

Compliance Package A1

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Qualification Information Jamie Mack 35923 Signature Registration Information Mackitecture 103532

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	SC
www.mackitecture.ca	
975A Elgin Street West, Suite 353	dia
Cobourg, ON K9A 5J3	u
Tel: 416-735-8190 Email: info@mackitecture.ca	

	Front Elevation Elevation 2					
	3/16" = 1'-0"	J M	2938 sq ft	sheet no.		
ca	2023-07-11	36' Single	project no. 22-012	4-2		


◆Greenpark


www.greenparkgroup.ca

Zadorra Estates Inc.


Drawing created with Mackitecture v.1.0.0 (build 2657), File P:\2022\22-012-GREENPARK-ZADORRA-OSHAWA\UNITS\WORKING\22-012-VILLA 11-WD-V1.DWG plotted on 2023-07-11 at 1:02:51 PM by LAURA



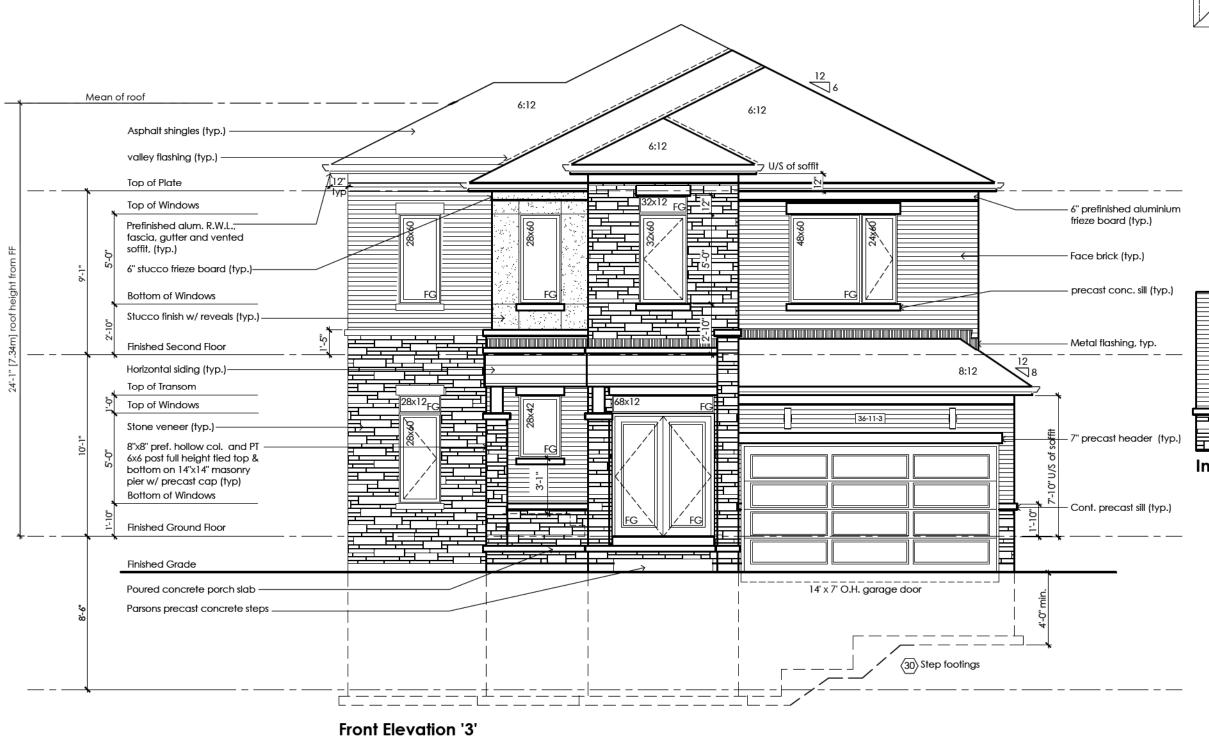

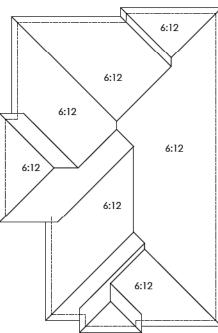

Roof Plan '3'

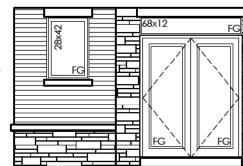

Inside Portico Elev. '3'

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Villa 11

Compliance Package A1

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Contractor shall check all dimensions and elevations before commencing

rith work and report any discrepancies to the Designer. Prints are not to

Qualification Information Jamie Mack 35923 Name BCIN Signature Registration Information Mackitecture 103532



Front Elevation Elevation 3					
	scale	by	area	sheet no.	
	3/16" = 1'-0"	JM	2926 sq ft	4-3	
.ca	2023-07-11	36' Single	22-012	4-3	

Greenpark


www.greenparkgroup.ca

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DATE: JUL 31, 2023



Second Floor Plan '3'

Contractor shall check all dimensions and elevations before commencing with work and report any discrepancies to the Designer. Prints are not to

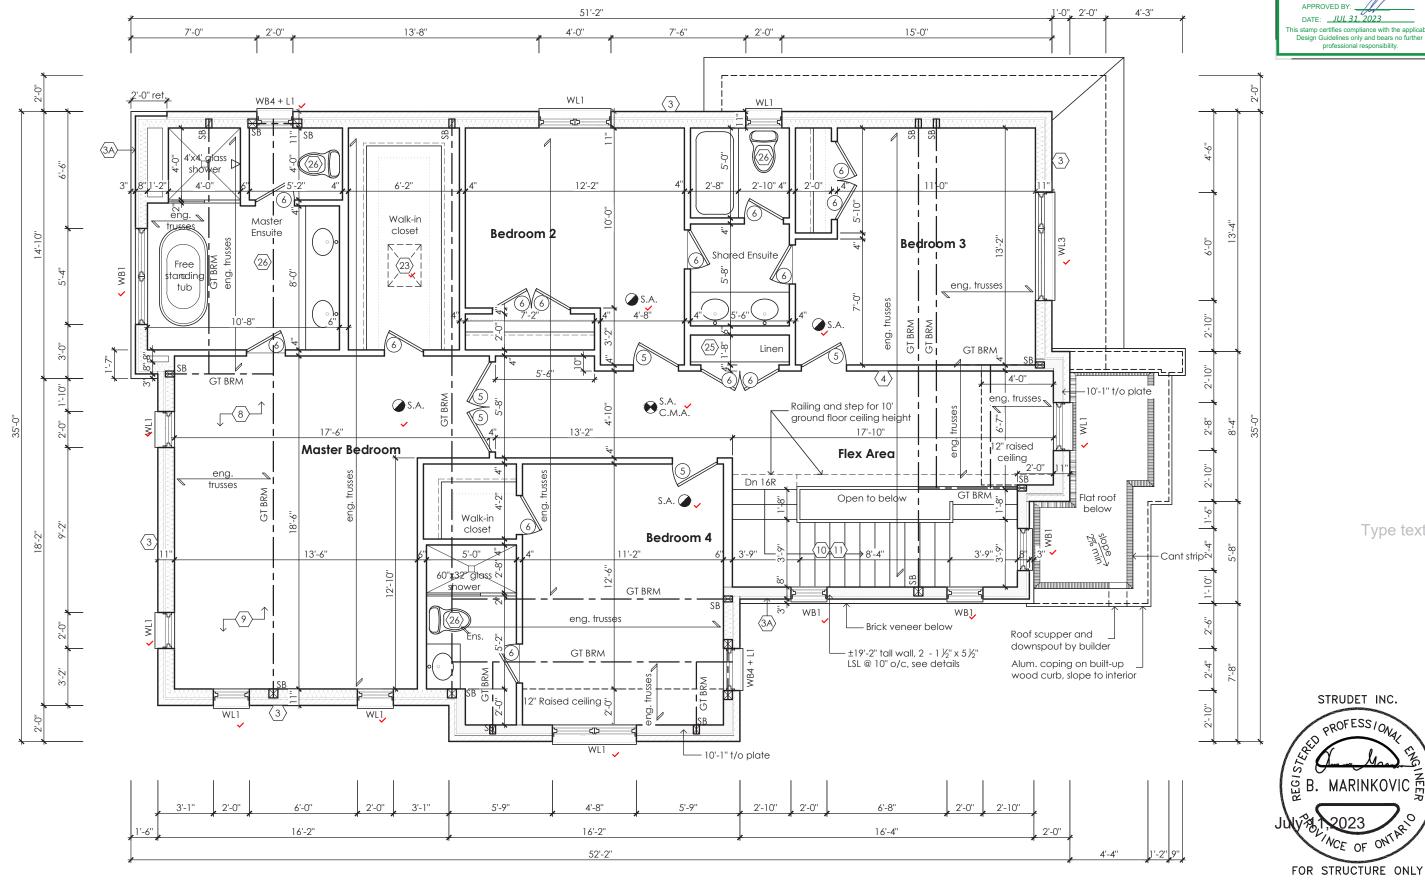Villa 11 Compliance Package A1

NCE OF ONTAR!

STRUDET INC.

PROFESS/ON

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The undersigned has reviewed and takes responsibility for this design, as well as having the qualifications and requirements mandated by the Ontario Building Code (O.B.C.) to be a Designer.

Qualification Information


Name BCIN Mackitecture



Second Floor Plan Elevation 3					
3/16" = 1'-0"	J M	2926 sq ft	sheet no.		
2023-07-11	36' Single	project no. 22-012	3-3		

Greenpark

www.greenparkgroup.ca

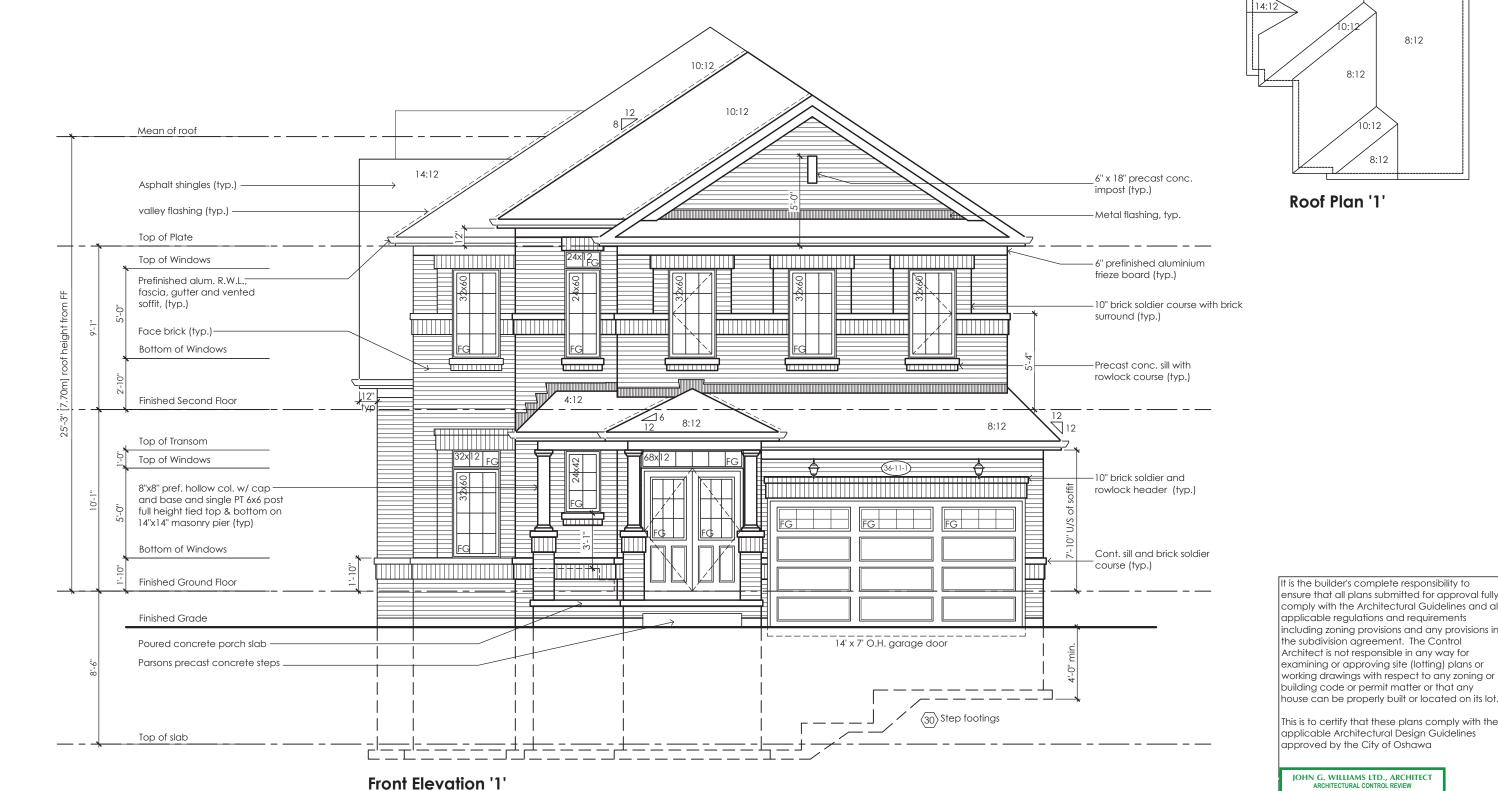

Villa 11 Compliance Package A1

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Qualification Information

BCIN Mackitecture

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Front Elevation Elevation 1 3/16" = 1'-0" 2952 sq ft 4-1 36' Single 2023-07-11 22-012



DATE: JUL 31, 2023

10:12

8:12


8:12

8:12

8:12

www.greenparkgroup.ca



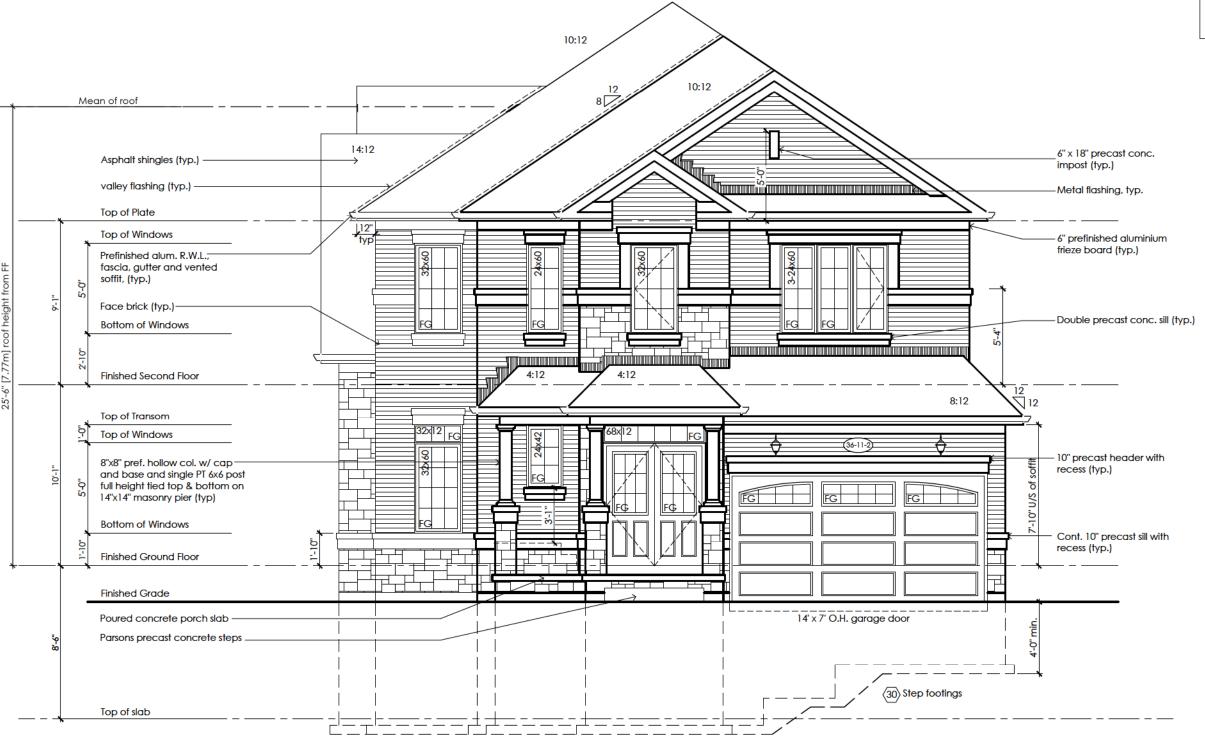

10:12 10:12 8:12 8:12 Roof Plan '2'

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Villa 11

Compliance Package A1

The undersigned has reviewed and takes responsibility for this design, as well as having the qualifications and requirements mandated by the Ontario Building Code (O.B.C.) to be a Designer.

Front Elevation '2'

Qualification Information

Jamie Mack 35923 Signature

Registration Information Mackitecture 103532

Contractor shall check all dimensions and elevations before commencing with work and report any discrepancies to the Designer. Prints are not to be scaled.




	Front Elevation Elevation 2				
	3/16" = 1'-0"	J M	2938 sq ft	sheet no.	
.ca	2023-07-11	36' Single	project no. 22-012	4-2	

Greenpark

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6:12

Roof Plan '3'

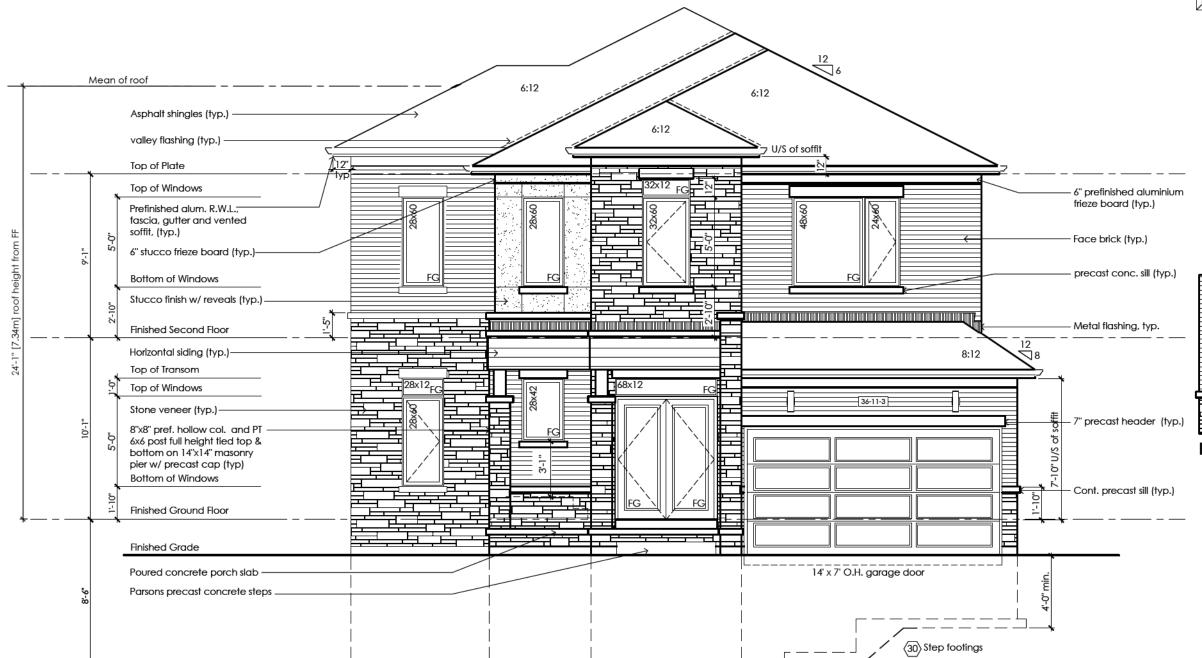

Inside Portico Elev. '3'

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Villa 11

Compliance Package A1

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Front Elevation '3'

Qualification Information

Jamie Mack 35923 July 1

Name BCIN Signature

Registration Information Mackitecture 103532

Contractor shall check all dimensions and elevations before commencing


rith work and report any discrepancies to the Designer. Prints are not to





	Front Elevation Elevation 3					
	3/16" = 1'-0"	JM	2926 sq ft	sheet no.		
.ca	2023-07-11	36' Single	project no. 22-012	4-3		


◆Greenpark


www.greenparkgroup.ca

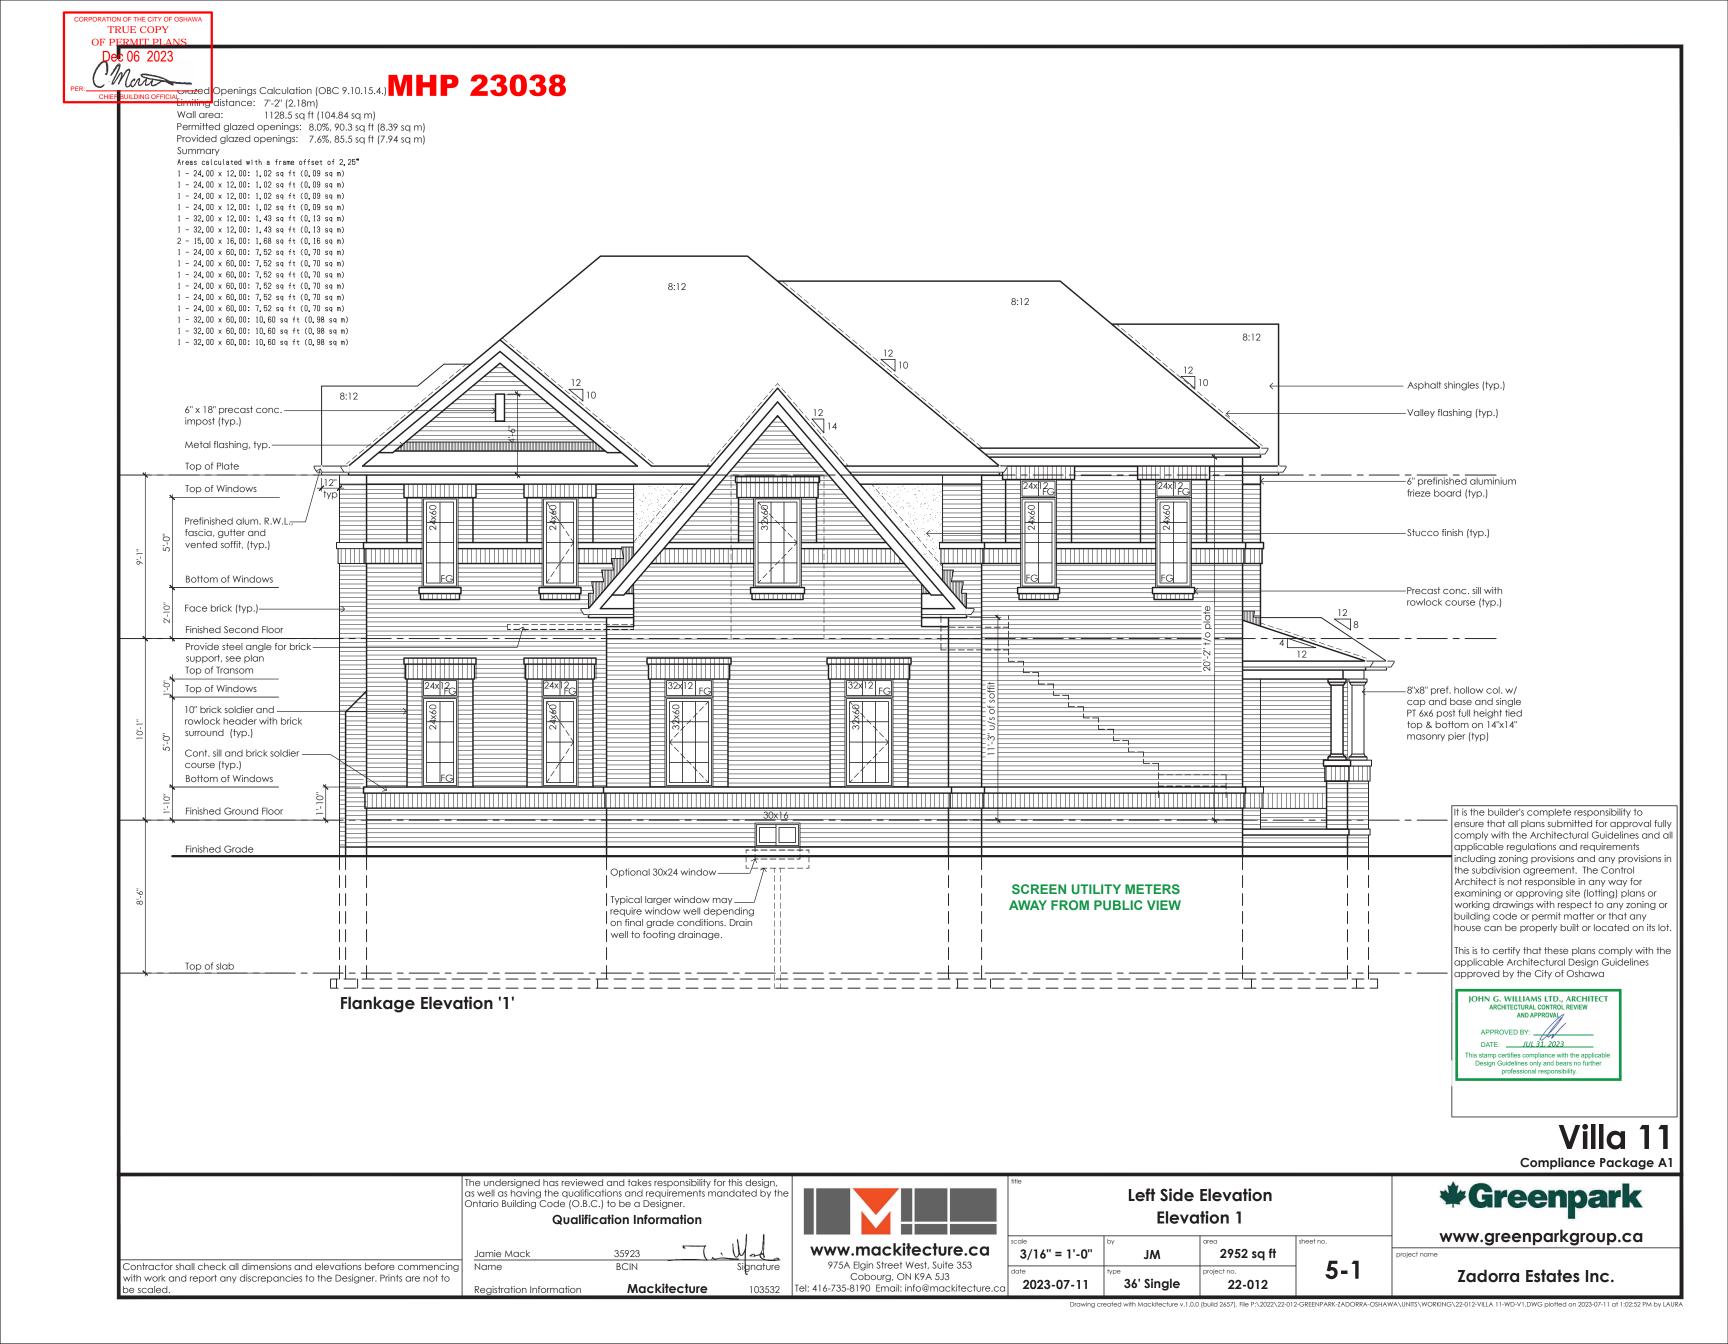


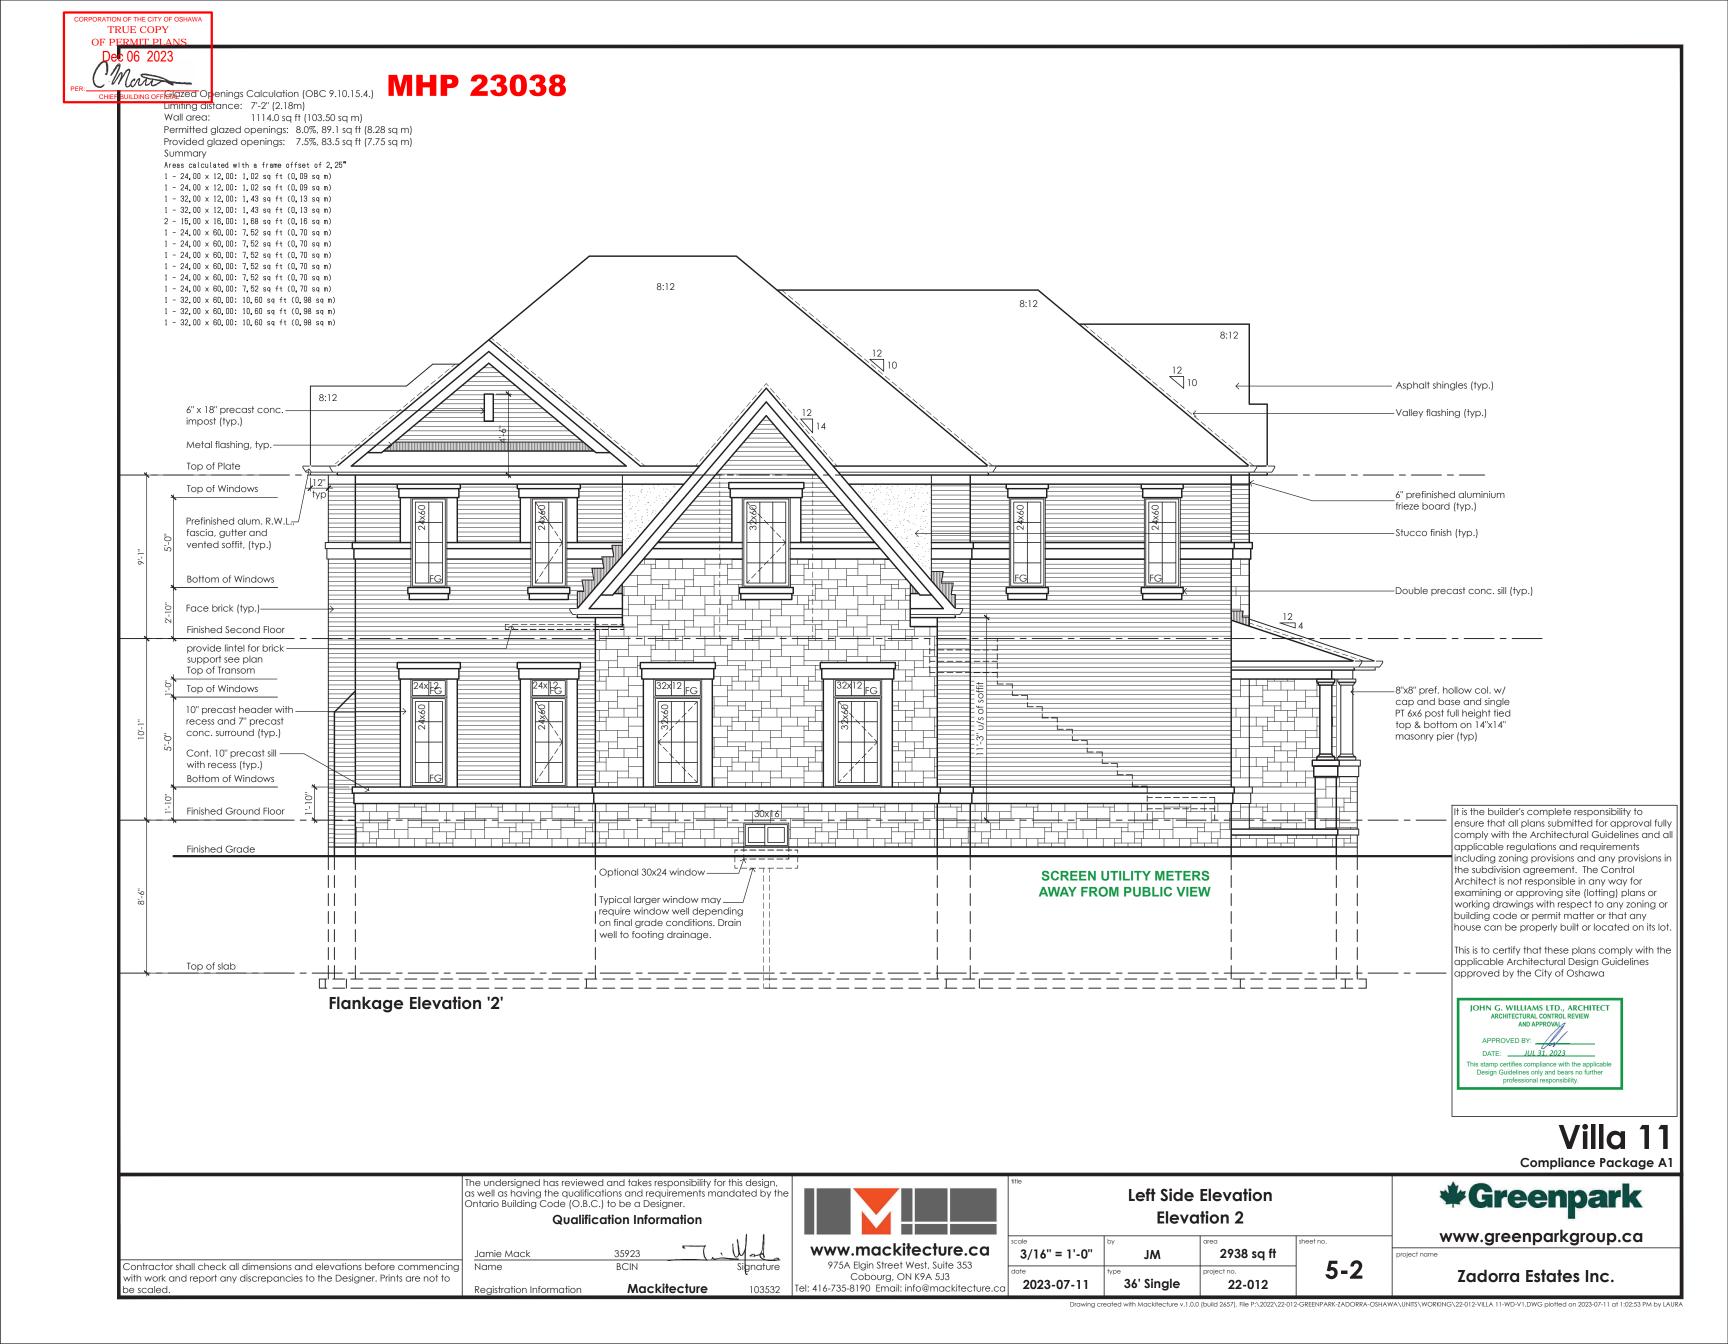


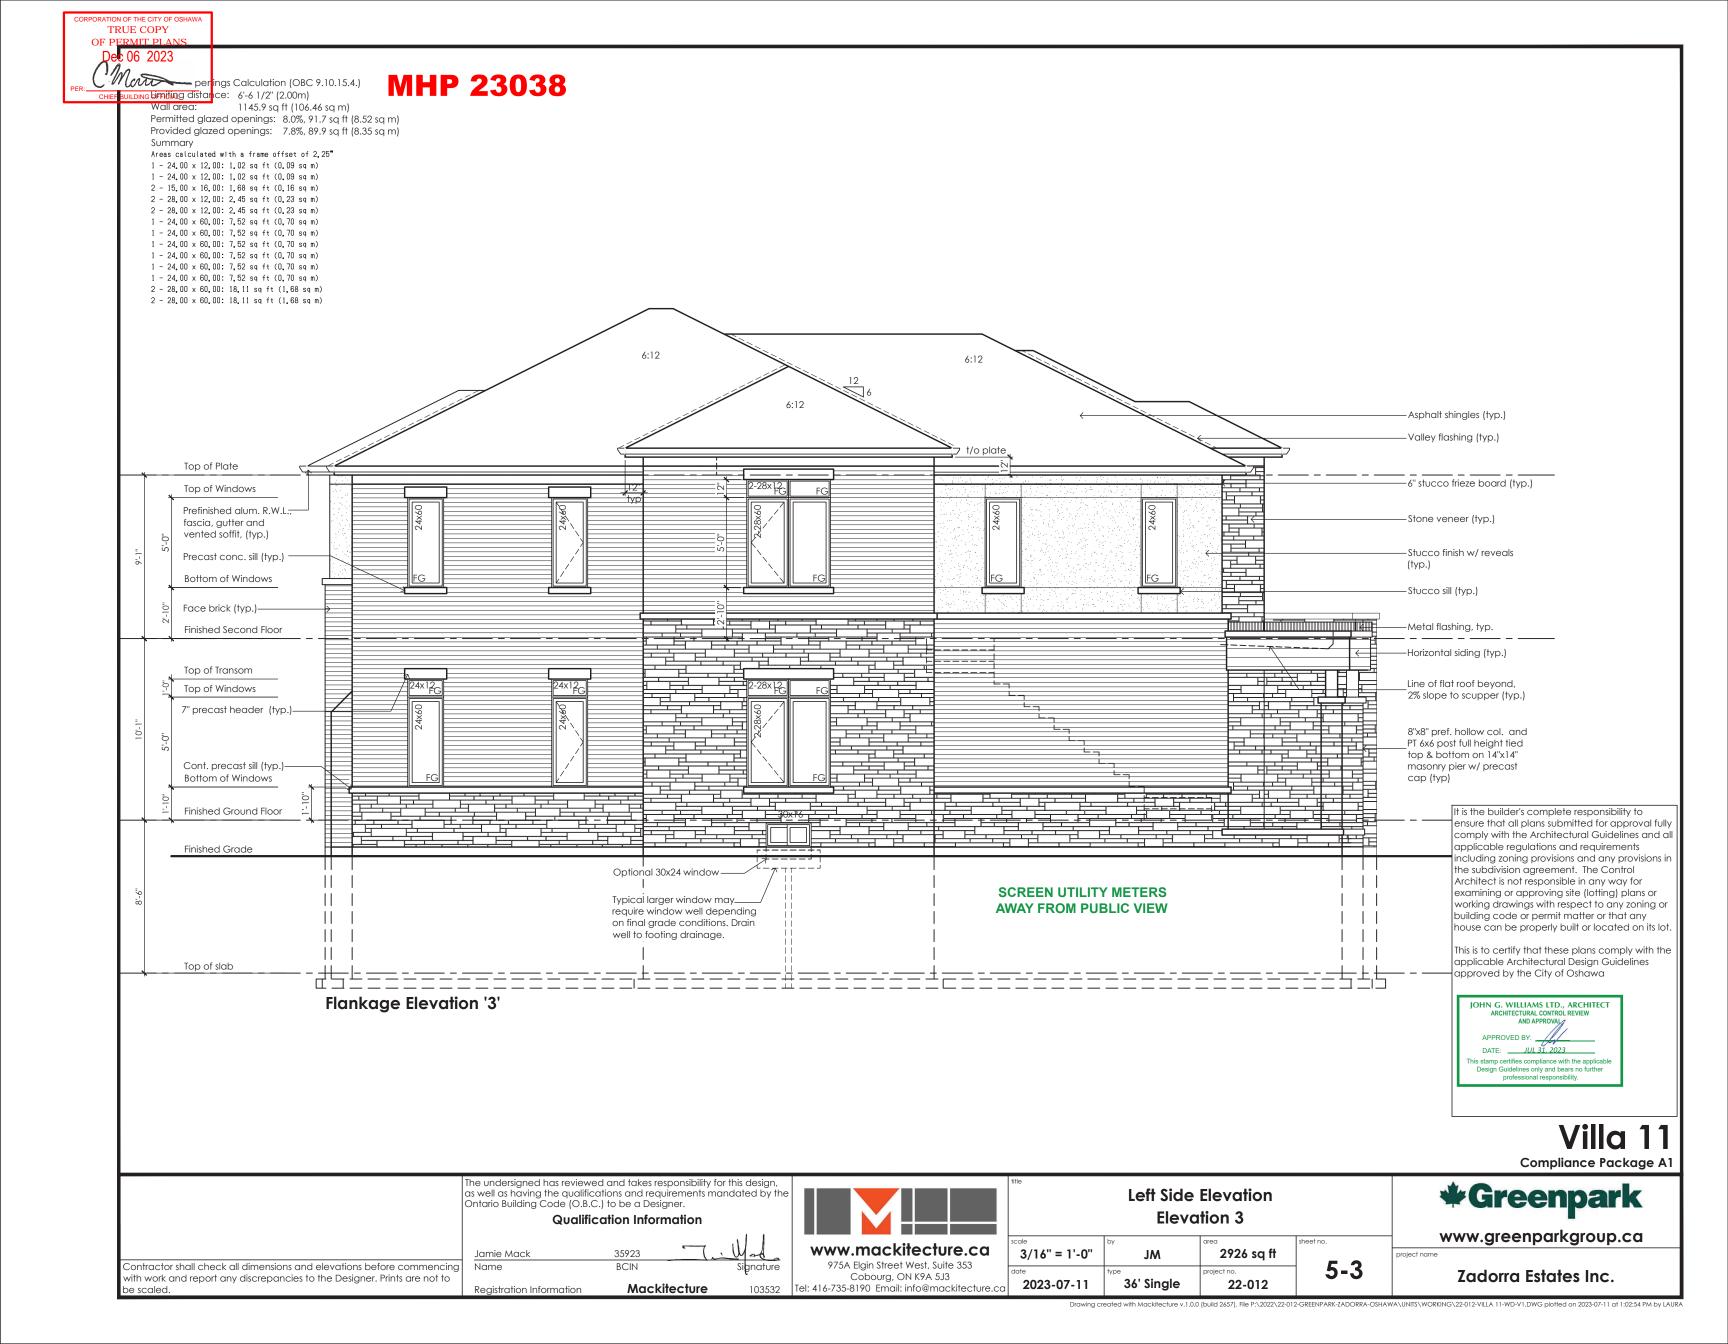

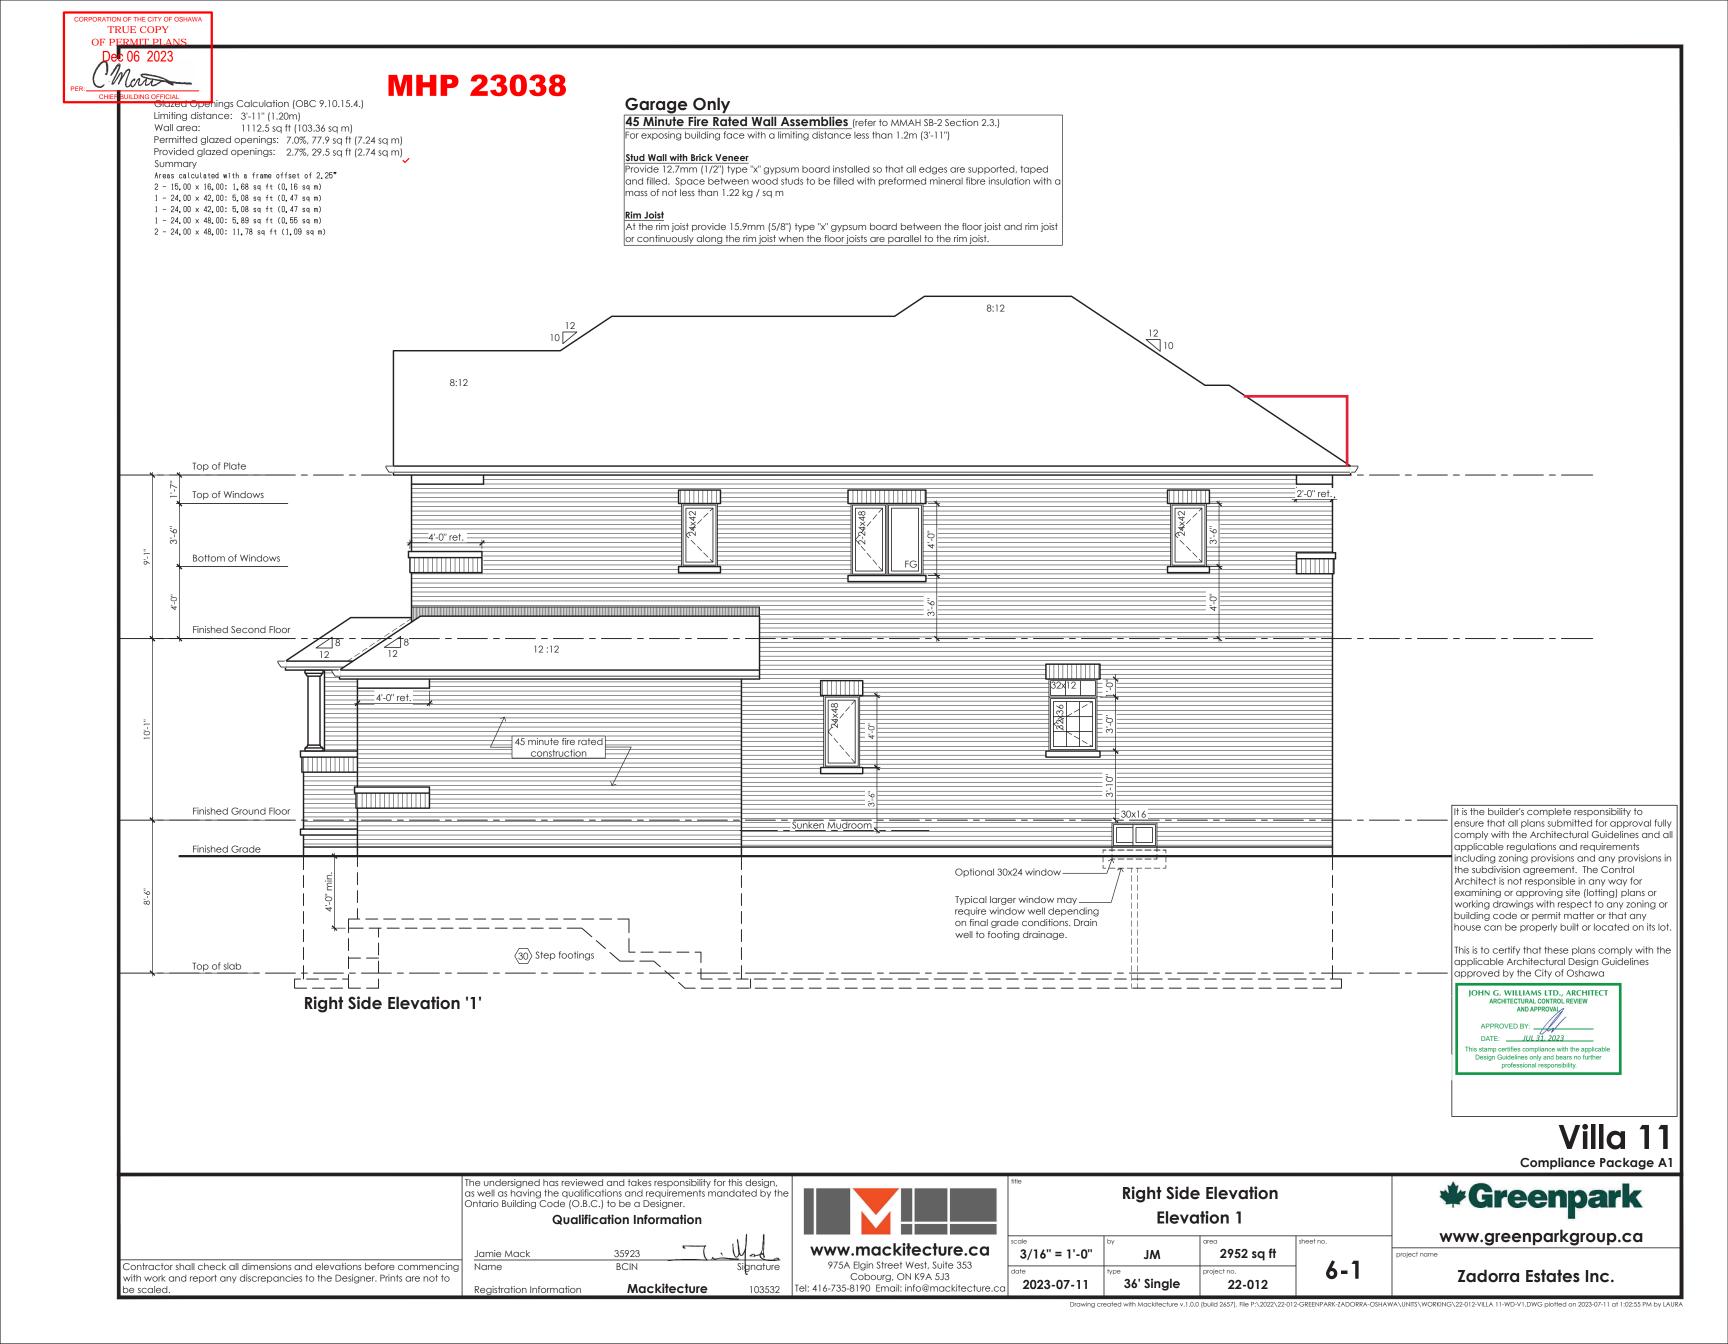

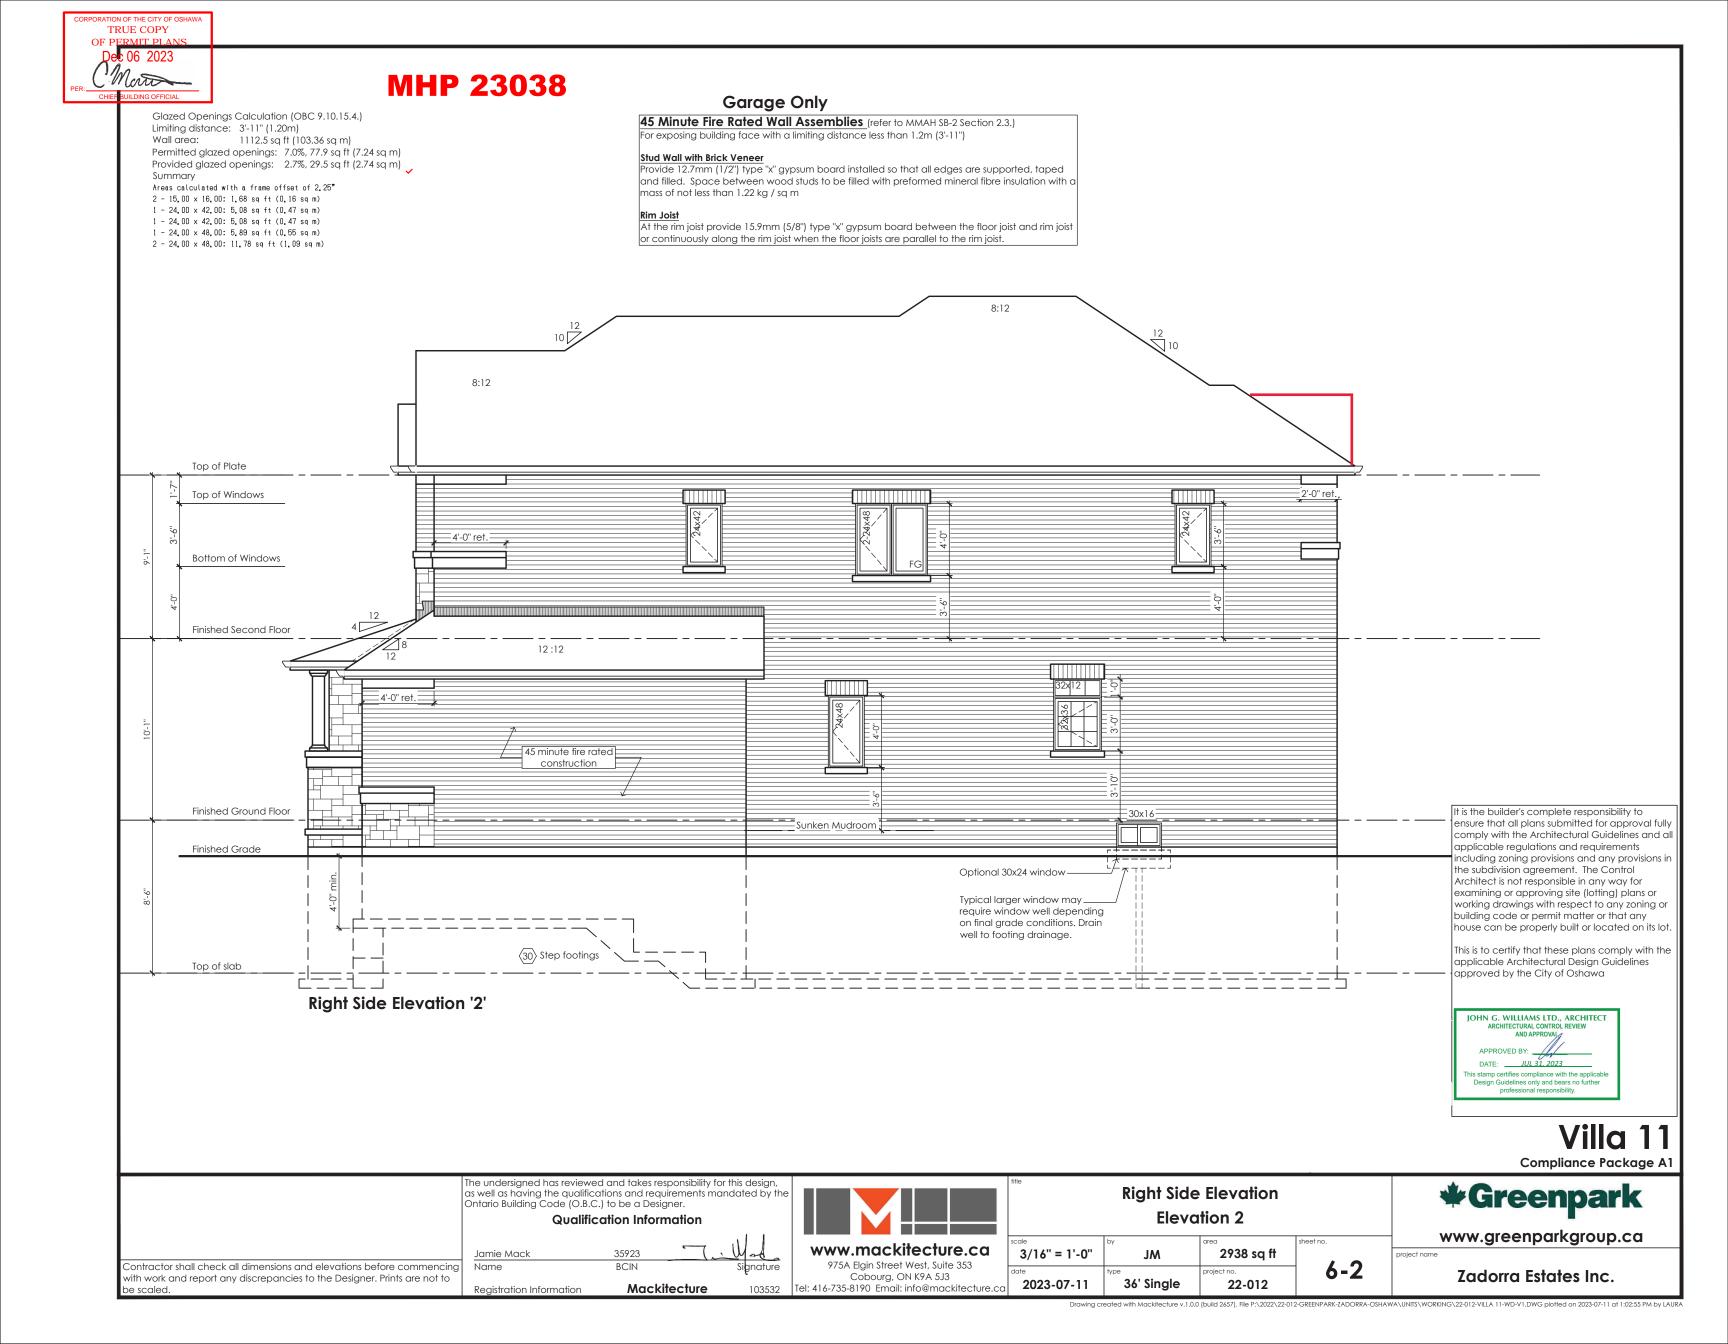

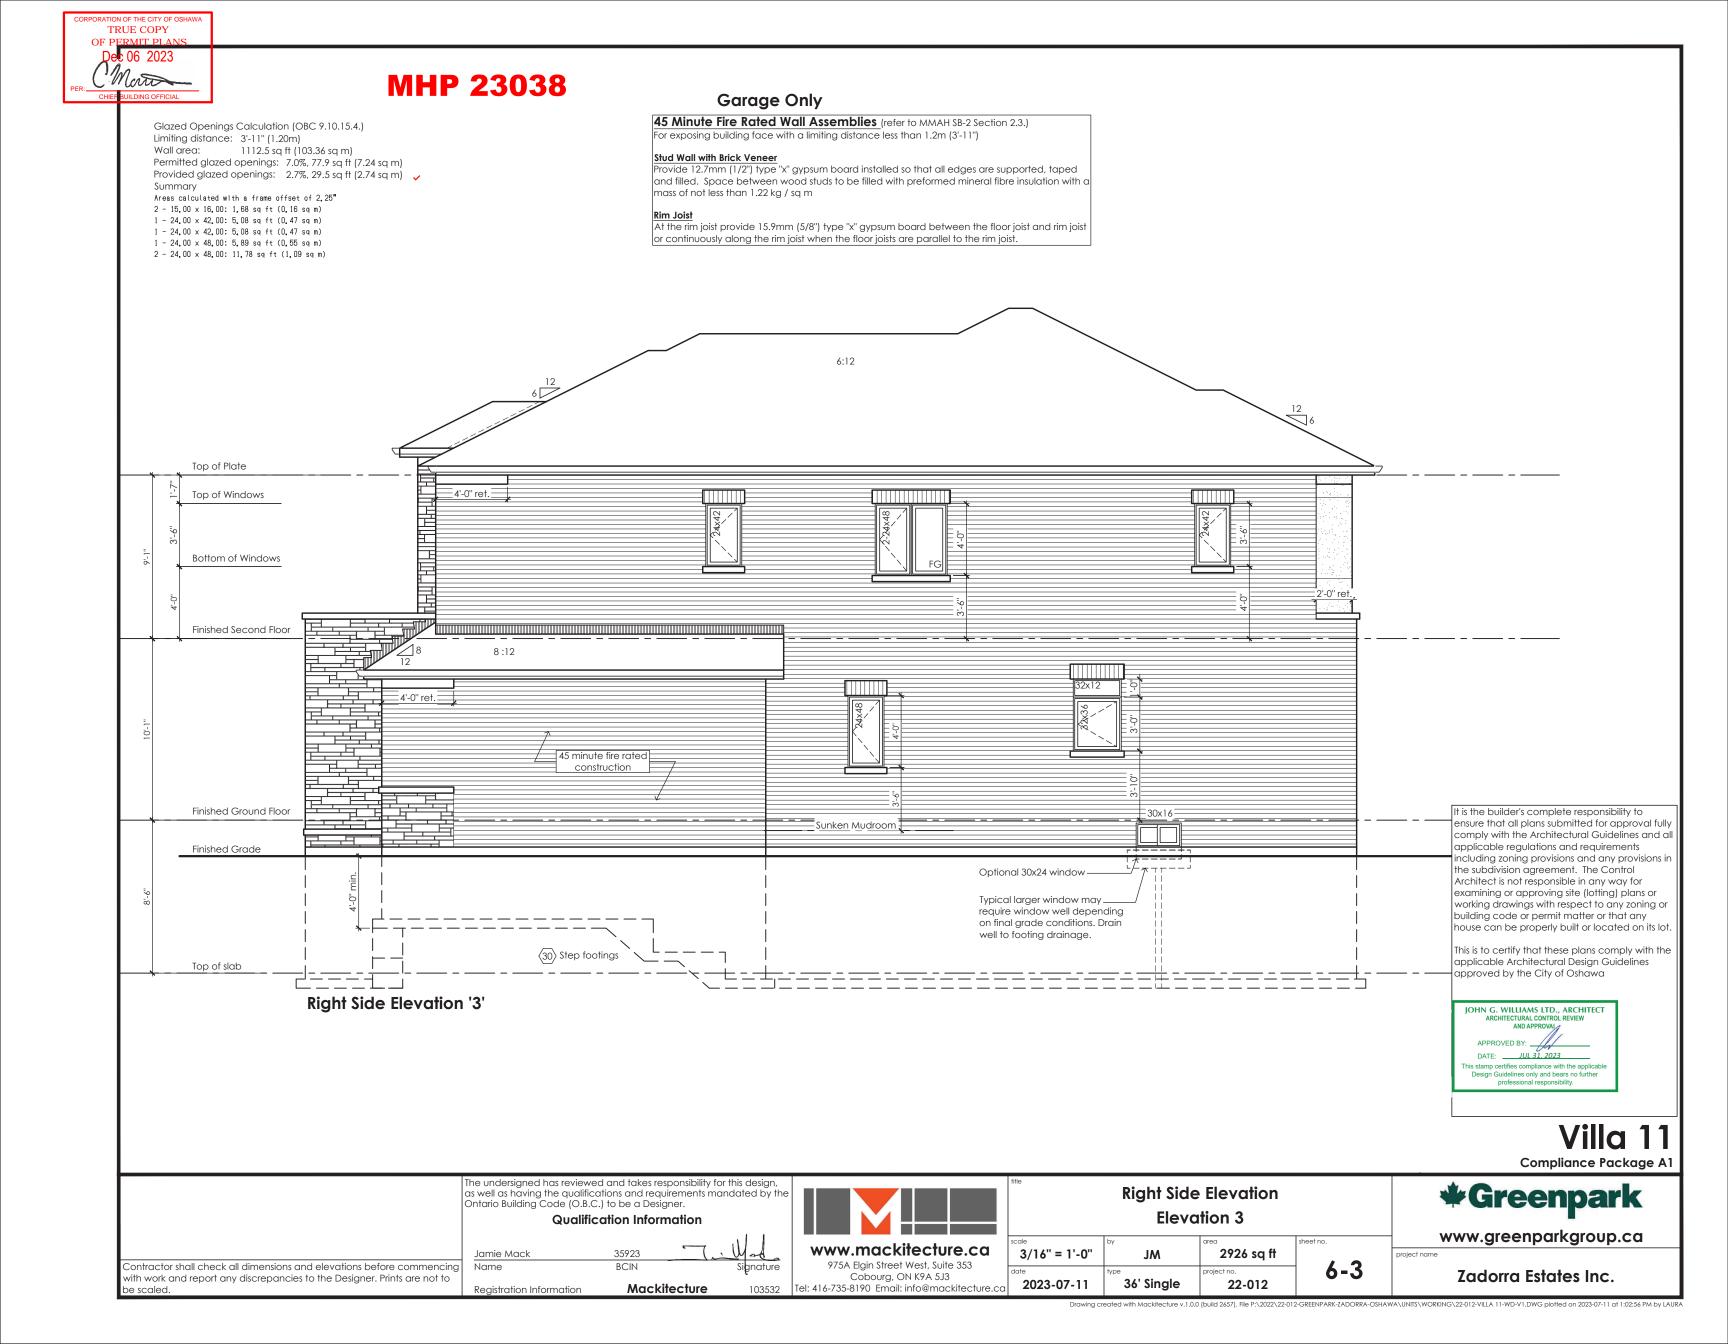

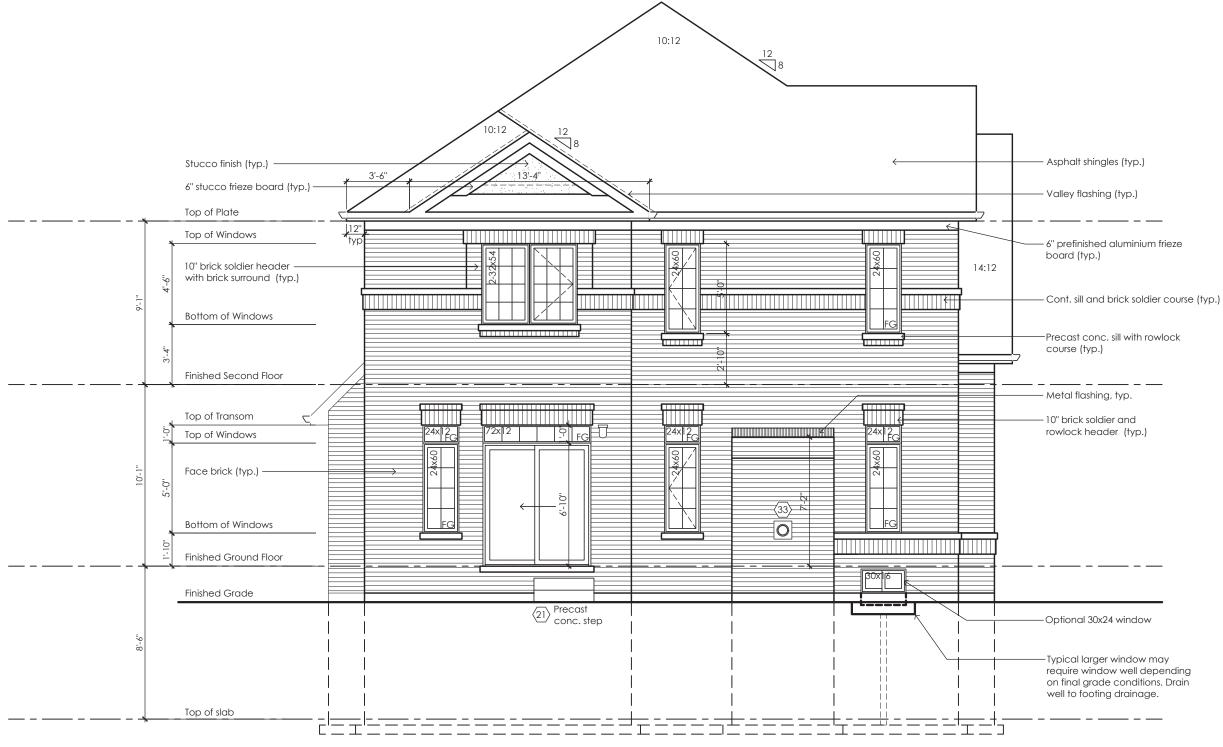

Rear Elevation '1'

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JOHN G. WILLIAMS LTD., ARCHITECT
ARCHITECTURAL CONTROL REVIEW
AND APPROVAL

APPROVED BY:

DATE: JUL 31, 2023

This stamp certifies compliance with the applicable Design Guidelines only and bears no further professional responsibility.

Villa 11
Compliance Package A1

The undersigned has reviewed and takes responsibility for this design, as well as having the qualifications and requirements mandated by the Ontario Building Code (O.B.C.) to be a Designer.

Qualification Information

Contractor shall check all dimensions and elevations before commencing with work and report any discrepancies to the Designer. Prints are not to be scaled.

Jamie Mack
Name
BCIN
Signature
Registration Information
Mackitecture
103532



Rear Elevation Elevation 1					
	3/16" = 1'-0"	J M	2952 sq ft	sheet no.	
	data	hino	project no	- 7 _1	

22-012


36' Single

2023-07-11

Greenpark

www.greenparkgroup.ca

project name

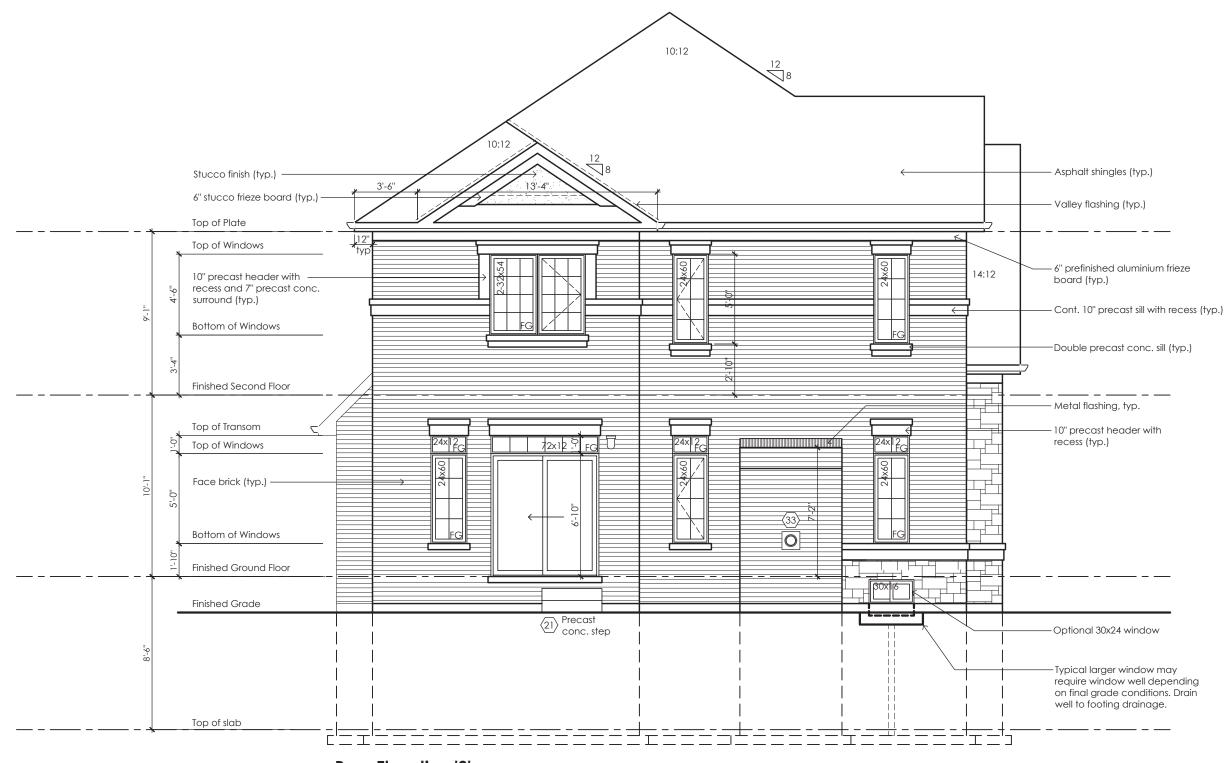

Rear Elevation '2'

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Villa 11 Compliance Package A1

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Qualification Information

BCIN Mackitecture

Contractor shall check all dimensions and elevations before commencing with work and report any discrepancies to the Designer. Prints are not to

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www.mackitecture.ca	S
975A Elgin Street West, Suite 353 Cobourg, ON K9A 5J3	-
Tel: 416-735-8190 Email: info@mackitecture.cal	

Rear Elevation Elevation 2				
3/16" = 1'-0"	J M	2938 sq ft	sheet no.	
date	type	project no.	 	

36' Single


2023-07-11

Greenpark

www.greenparkgroup.ca

Zadorra Estates Inc.

22-012

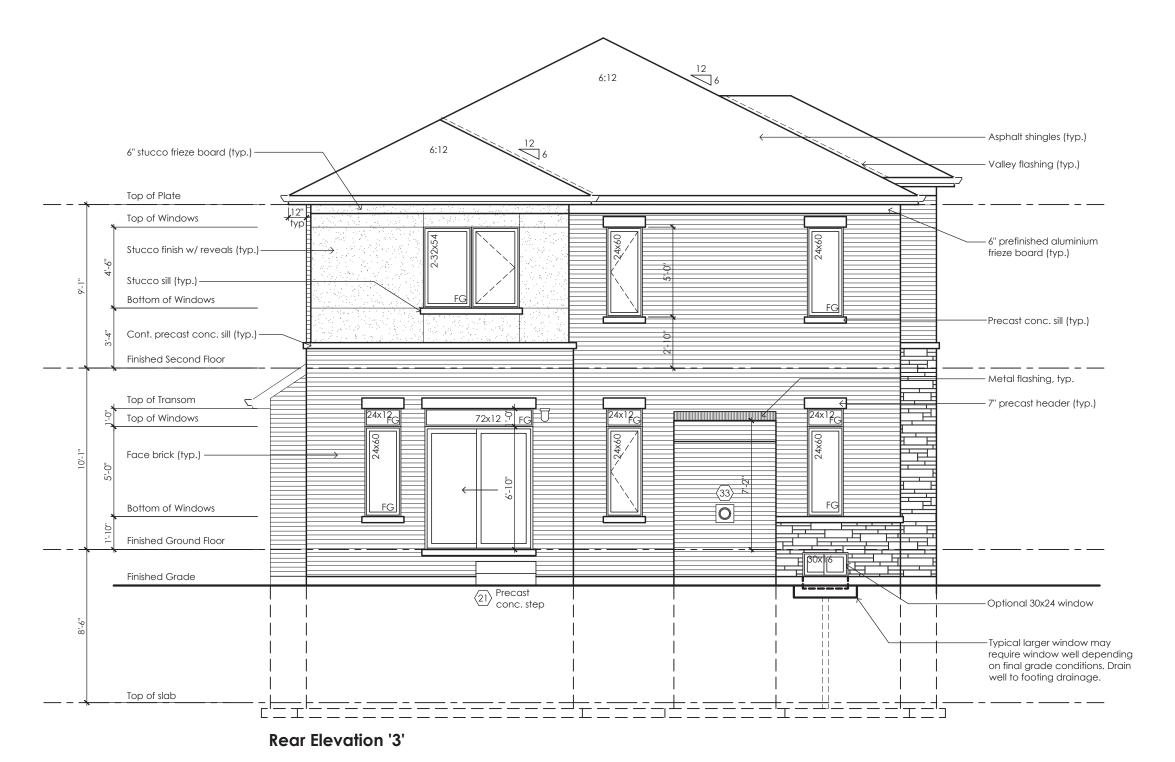

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JOHN G. WILLIAMS LTD., ARCHITECT
ARCHITECTURAL CONTROL REVIEW
AND APPROVAL

APPROVED BY:

DATE: JUL 31. 2023

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Design Guidelines only and bears no further
professional responsibility.

Villa 11
Compliance Package A1

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Qualification Information

Jamie Mack
Name

Registration Information

Mackitecture

103532

Contractor shall check all dimensions and elevations before commencing with work and report any discrepancies to the Designer. Prints are not to



Rear Elevation Elevation 3				
3/16" = 1'-0"	J M	2926 sq ft	sheet no.	
date	type	project no.	∃ 7-3	

22-012


Greenpark

www.greenparkgroup.ca

7adorra Estatos Inc

36' Single

2023-07-11

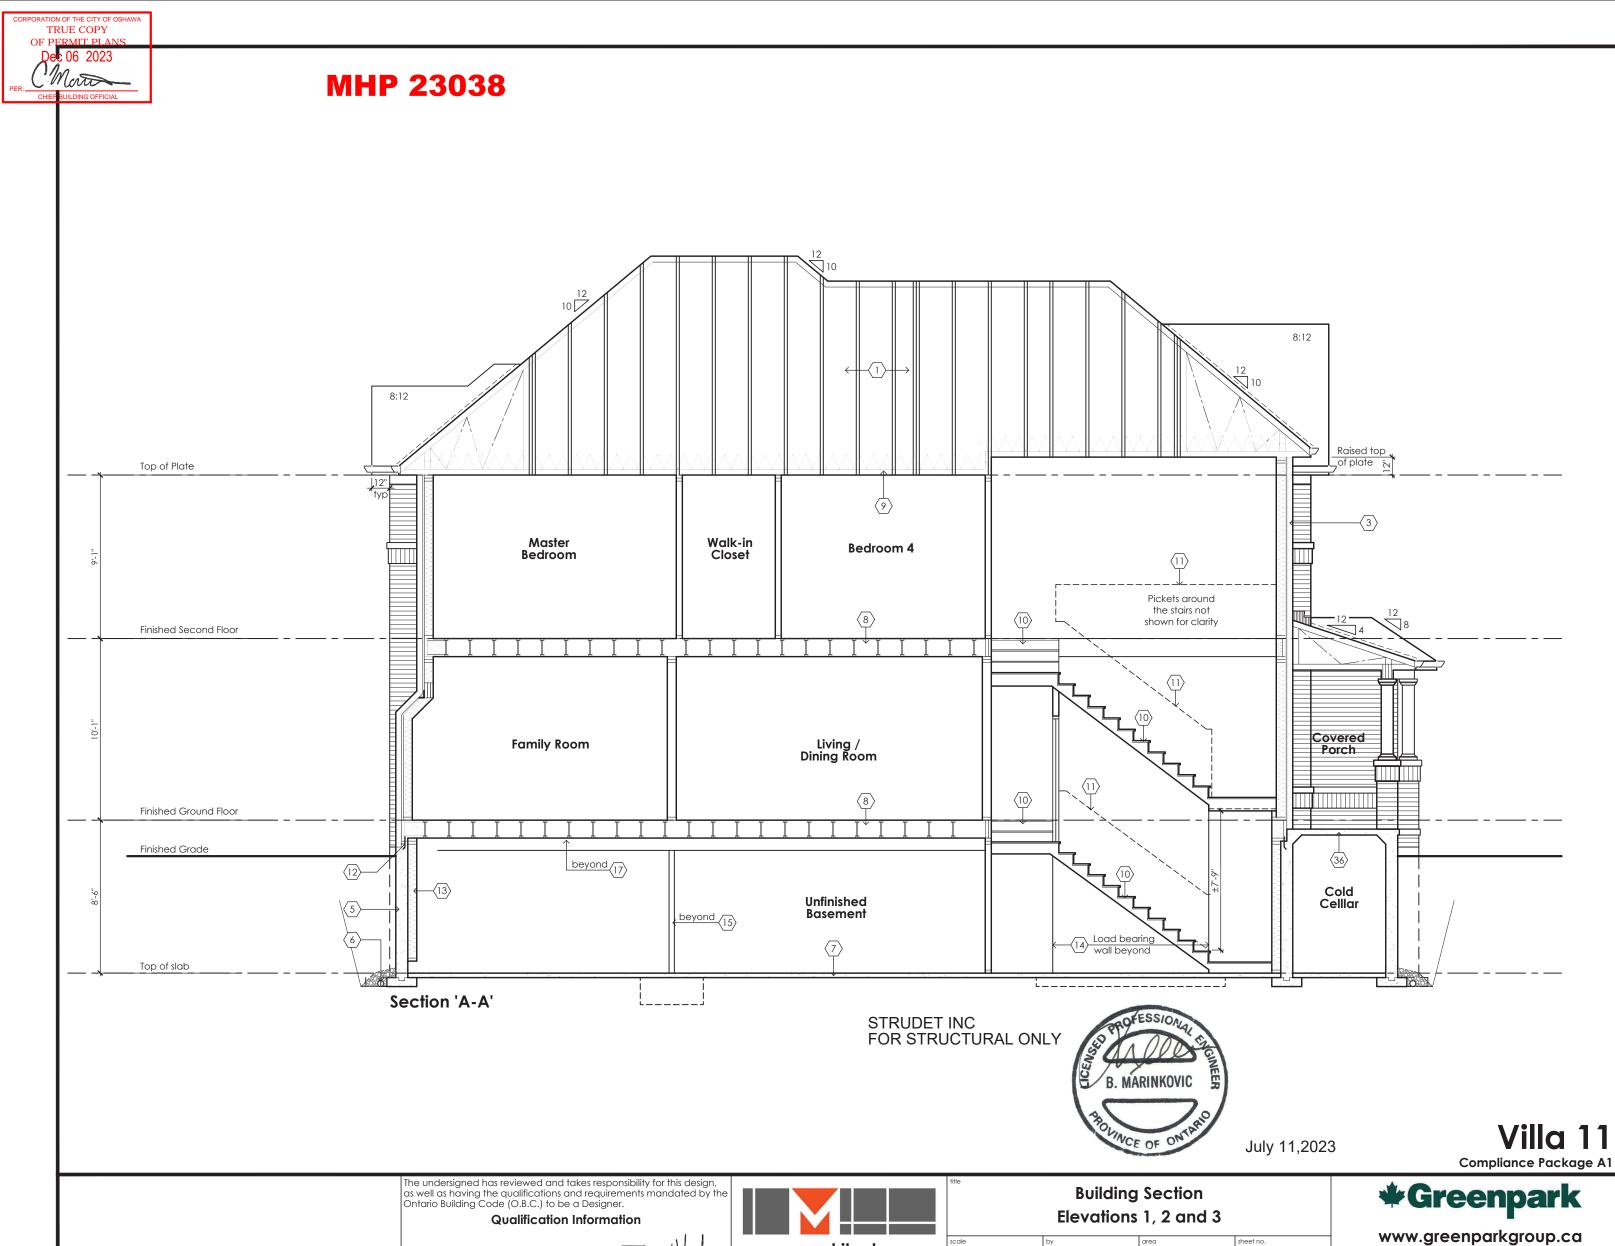

www.mackitecture.ca 3/16" = 1'-0" 975A Elgin Street West, Suite 353 Cobourg, ON K9A 5J3 Tel: 416-735-8190 Email: info@mackitecture.ca 8-1 BCIN 36' Single 22-012 2023-07-11 Mackitecture

Zadorra Estates Inc.

Contractor shall check all dimensions and elevations before commencing with work and report any discrepancies to the Designer. Prints are not to

SB-12 Calculations
Villa 11 - 1 Deck Condition

 Elevation
 Wall Area

 Front
 749.5 sq ft (69.6 sq m)

 Left side
 1128.5 sq ft (104.8 sq m)

 Right side
 1112.5 sq ft (103.4 sq m)

 Rear
 806.7 sq ft (74.9 sq m)

Rear 806.7 sq ft (74.9 sq m) 101.1 sq ft (9.4 sq m) 12.53% **Total** 3797.2 sq ft (352.8 sq m) 298.8 sq ft (27.8 sq m) 7.87%

Percentage

11.04% 7.58% 2.65% 12.53%

Window Area

82.7 sq ft (7.7 sq m) 85.5 sq ft (7.9 sq m)

29.5 sq ft (2.7 sq m) 101.1 sq ft (9.4 sq m



Rear Elevation '1'
Deck Condition

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JOHN G. WILLIAMS LTD., ARCHITECT
ARCHITECTURAL CONTROL REVIEW
AND APPROVAL

APPROVED BY:

DATE: JUL 31, 2023

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Villa 11
Compliance Package A1

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Qualification Information

Jamie Mack
Name

BCIN

Signature

Registration Information

Mackitecture

103532

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Deck Elevation Elevation 1 scale 3/16" = 1'-0" JM 2952 sq ft date type project no. sheet no. 29 1

22-012

36' Single

2023-07-11

Greenpark

www.greenparkgroup.ca

SB-12 Calculations
Villa 11 - 2 Deck Condition

 Elevation
 Wall Area

 Front
 744.7 sq ft (69.2 sq m)

 Left side
 1114.0 sq ft (103.5 sq m)

 Right side
 1112.5 sq ft (103.4 sq m)

 Rear
 806.7 sq ft (74.9 sq m)

 Total
 3777.9 sq ft (351.0 sq m)

 744.7 sq ff (69.2 sq m)
 83.1 sq ff (7.7 sq m)
 11.15%

 1114.0 sq ff (103.5 sq m)
 83.5 sq ff (7.8 sq m)
 7.49%

 1112.5 sq ff (103.4 sq m)
 29.5 sq ff (2.7 sq m)
 2.65%

 806.7 sq ff (74.9 sq m)
 101.1 sq ff (9.4 sq m)
 12.53%

 3777.9 sq ff (351.0 sq m)
 297.1 sq ff (27.6 sq m)
 7.86%

Window Area

Percentage 11.15% 7.49% 2.65% 12.53%

10:12 Stucco finish (typ.) Asphalt shingles (typ.) 6" stucco frieze board (typ.) Valley flashing (typ.) Top of Windows 6" prefinished aluminium frieze 14:12 recess and 7" precast conc. surround (typ.) Cont. 10" precast sill with recess (typ.) Bottom of Windows -Double precast conc. sill (typ.) Finished Second Floor Metal flashing, typ. Top of Transom 10" precast header with Top of Windows Face brick (typ.) -Bottom of Windows 0 Finished Ground Floor Provide window when height from ground floor to Upgrade window when grade is 4'-4" or greater. height from ground floor to grade is 4'-4" or greater. Finished Grade Top of slab

It is the builder's complete responsibility to ensure that all plans submitted for approval fully comply with the Architectural Guidelines and all applicable regulations and requirements including zoning provisions and any provisions in the subdivision agreement. The Control Architect is not responsible in any way for examining or approving site (lotting) plans or working drawings with respect to any zoning or building code or permit matter or that any house can be properly built or located on its lot.

This is to certify that these plans comply with the applicable Architectural Design Guidelines approved by the City of Oshawa

JOHN G. WILLIAMS LTD., ARCHITECT
ARCHITECTURAL CONTROL REVIEW
AND APPROVAL

APPROVED BY:

DATE: JUL 31, 2023

This stamp certifies compliance with the applicable
Design Guidelines only and bears no further
professional responsibility.

Villa 11
Compliance Package A1

The undersigned has reviewed and takes responsibility for this design, as well as having the qualifications and requirements mandated by the Ontario Building Code (O.B.C.) to be a Designer.

Rear Elevation '2'

Deck Condition

Qualification Information

Jamie Mack
Name

Registration Information

Mackitecture

103532

Contractor shall check all dimensions and elevations before commencing with work and report any discrepancies to the Designer. Prints are not to



Deck Elevation Elevation 2

3/16" = 1'-0"

JM

2938 sq ft

ate

2023-07-11

36' Single

22-012

sheet no.

2938 sq ft

22-012

Greenpark

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SB-12 Calculations Villa 11 - 3 Deck Condition

Elevation Wall Area 774.9 sq ft (72.0 sq m) 1145.9 sq ft (106.5 sq m) 1112.5 sq ft (103.4 sq m) 823.7 sq ft (76.5 sq m) Left side Right side Rear Total

Window Area Percentage 93.7 sq ft (8.7 sq m) 89.9 sq ft (8.4 sq m) 12.09% 7.85% 2.65% 29.5 sq ft (2.7 sq m) 101.1 sq ft (9.4 sq m 3857.1 sq ft (358.3 sq m) 314.2 sq ft (29.2 sq m) 8.15%



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JOHN G. WILLIAMS LTD., ARCHITECT ARCHITECTURAL CONTROL REVIEW DATE: JUL 31, 2023

> Villa 11 Compliance Package A1

The undersigned has reviewed and takes responsibility for this design, as well as having the qualifications and requirements mandated by the Ontario Building Code (O.B.C.) to be a Designer.

Qualification Information

BCIN Mackitecture

Contractor shall check all dimensions and elevations before commencing with work and report any discrepancies to the Designer. Prints are not to




Deck Elevation Elevation 3


3/16" = 1'-0" 2926 sq ft 9-3 36' Single 2023-07-11 22-012



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Partial floor plan For Deck Condition Elevations '1', '2' and '3'

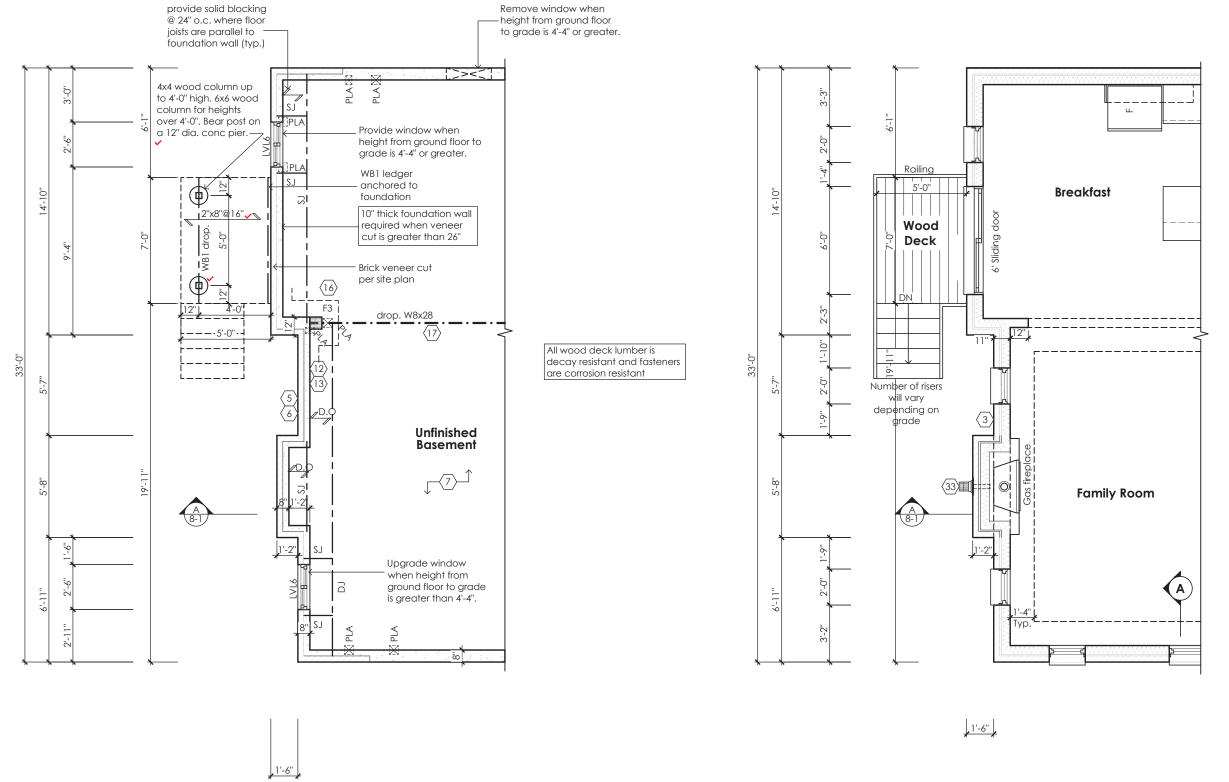

It is the builder's complete responsibility to ensure that all plans submitted for approval fully comply with the Architectural Guidelines and all applicable regulations and requirements including zoning provisions and any provisions in the subdivision agreement. The Control Architect is not responsible in any way for examining or approving site (lotting) plans or working drawings with respect to any zoning or building code or permit matter or that any house can be properly built or located on its lot.

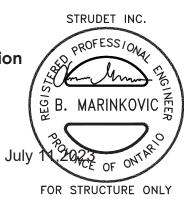This is to certify that these plans comply with the applicable Architectural Design Guidelines approved by the City of OSHAWA.

JOHN G. WILLIAMS LTD., ARCHITECT AND APPR

DATE: JUL 31, 2023

Villa 11 Compliance Package A1

The undersigned has reviewed and takes responsibility for this design, as well as having the qualifications and requirements mandated by the Ontario Building Code (O.B.C.) to be a Designer.

Elevations '1', '2' and '3'

Qualification Information

Partial Basement Plan For Deck Condition

BCIN Mackitecture



Elevations 1, 2 and 3							
3/16" = 1'-0"	J W	area -	sheet no.				
2023-07-11	type 36' Single	project no. 22-012	9-4				



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