



BUILDING PERMIT COVER PAGE

MHP 23027 Development Services Department Building Permit and Inspection Services

BUILDING PERMIT PLANS REVIEW	ACCEPTED AS NOTED	
	REVIEWED BY	DATE
ZONING		
PLANNING		
ARCHITECTURAL	CM	NOV 16, 2023
STRUCTURAL		
FIRE		
PLUMBING	CARD	
MECHANICAL		
PLANS REVIEW COMPLETED	CM	NOV 16, 2023

SOIL CONDITIONS

SOIL CONDITIONS SHALL BE VERIFIED BY A PROFESSIONAL ENGINEER COMPETENT IN THE FIELD OF SOIL ENGINEERING, PRIOR TO PLACING ANY FOUNDATION.

THE PERMIT PLANS HAVE BEEN REVIEWED FOR ONE (1) DWELLING UNIT. ANY FUTURE CHANGES WILL REQUIRE A SEPARATE BUILDING PERMIT

PLUMBING INSTALLATIONS

ALL PLUMBING INSTALLATIONS ARE TO BE DONE BY A PLUMBING CONTRACTOR POSSESSING AN ONTARIO COLLEGE OF TRADES MEMBERSHIP. NO PLUMBING IS TO BE COVERED UNTIL INSPECTED AND APPROVED BY A PLUMBING INSPECTOR. TELEPHONE 905-436-5658 WHEN READY FOR AN INSPECTION AND TESTING.

ALL STANDARDS REFERRED TO IN THESE BUILDING PERMIT DOCUMENTS SHALL BE THE EDITION DESIGNATED IN OBC 2012 AS AMENDED.

RAIN WATER DOWNSPOUTS ARE TO BE DISCHARGED AT GRADE AND NOT CONNECTED TO WEEPING TILES.

FUTURE ALTERATIONS

A SEPARATE BUILDING PERMIT IS REQUIRED FOR ANY PROPOSED INTERIOR PARTITIONS AND/OR ALTERATIONS.

NOTE:

IT IS RECOMMENDED THAT CRUSHED CONCRETE OR SLAG AGGREGATE **NOT** TO BE USED FOR BACKFILL UNDER CONCRETE SLABS, AROUND SEWER LATERALS OR WEEPERS.

AS BUILT SURVEY

UPON COMPLETION OF THE FOUNDATION, A SURVEY PREPARED BY AN ONTARIO LAND SURVEYOR INDICATING THE LOCATION OF THE BUILDING TO ALL PROPERTY LINES IS REQUIRED TO BE SUBMITTED TO THE BUILDING DEPARTMENT

COPY OF THE STAMPED/REVIEWED DRAWINGS MUST REMAIN ON SITE DURING CONSTRUCTION.

MHP CERTIFICATION

ALL MARKUPS AND STAMPS APPLIED TO BASE MODEL AND BASE ELEVATION SHALL APPLY AS APPLICABLE TO THE ENTIRE MODEL HOUSE PLAN

IMPORTANT NOTE

NEITHER THE ISSUANCE OF A PERMIT NOR THE CARRYING OUT OF INSPECTIONS BY THE CITY RELIEVE THE APPLICANT FROM FULL RESPONSIBILITY FOR COMPLIANCE WITH THE PROVISIONS OF THE BUILDING CODE ACT AND THE ONTARIO BUILDING CODE, BOTH AS AMENDED, AS WELL AS OTHER APPLICABLE STATUTES AND REGULATIONS OF THE PROVINCE OF ONTARIO AND ALL RELEVANT BY-LAWS OF THE CITY OF OSHAWA AND THE REGIONAL MUNICIPALITY OF DURHAM.

OBC 9.10.14.5 - CLADDING

CLADDING ON THE EXPOSING BUILDING FACE IS PERMITTED TO BE VINYL WHEN WITHIN 600mm OF PROPERTY LINE, PROVIDED THAT THE VINYL CONFORMS TO OBC DIV. B. 9.27.13. IS INSTALLED OVER SHEATHING PAPER AND 12.7mm DRYWALL, HAS A FLAME SPREAD RATING NOT GREATER THAN 25, AND IS NOT MORE THAN 2mm THICK AND THE ENTIRE EXTERIOR WALL HAS A MINIMUM FIRE RESISTANCE RATING OF ¾ HOURS.

PREFABRICATED WOOD TRUSSES

FABRICATION AND ERECTION DRAWINGS WITH DESIGN DATA, PREPARED AND SEALED BY A PROFESSIONAL ENGINEER, MUST BE AVAILABLE ON SITE FOR REVIEW BY THE BUILDING INSPECTOR

ROOF CEILING INSULATION

ROOF FRAMING OR TRUSS HEEL JOINT MUST PERMIT SUFFICIENT SPACE FOR THE EXTENSION OF THE ROOF-CEILING INSULATION OVER EXTERIOR WALLS MINIMIZE THERMAL BRIDGES. AN UNOBSTRUCTED VENTILATION SPACE MUST BE PROVIDED OVER EXTERIOR WALLS TO ALLOW UNIMPEDED AIR FLOW FORM SOFFIT VENTS TO ROOF VENTS.

ALL ELECTRICAL WIRING MUST BE INSPECTED BY THE ELECTRICAL SAFETY AUTHORITY. SEPARATE INSPECTION APPLICATIONS (PERMITS) MUST BE FILED. WE RECOMMEND YOU USE A QUALIFIED ELECTRICAL CONTRACTOR. FOR MORE INFORMATION PLEASE CALL:



ELECTRICAL SAFETY AUTHORITY

1-877-ESA-SAFE OR VISIT WWW.ESASAFE.COM

BEDROOM WINDOWS

- (1) EVERY FLOOR LEVEL CONTAINING BEDROOMS IN A *SUITE* SHALL BE PROVIDED WITH AT LEAST 1 OUTSIDE WINDOW THAT CAN BE OPENED FROM THE INSIDE WITHOUT THE USE OF TOOLS, AND EACH SUCH WINDOW SHALL PROVIDE AN INDIVIDUAL, UNOBSTRUCTED OPEN PORTION HAVING A MINIMUM AREA OF 0.35M<sup>2</sup> (3.8 SQ.FT.) WITH NO DIMENSION LESS THAN 380 MM (15 IN).
- (2) EXCEPT FOR *BASEMENT* AREAS, THE WINDOW DESCRIBED IN SENTENCE (1) SHALL HAVE A MAXIMUM SILL HEIGHT OF 1M (3 FT 3 IN) ABOVE THE FLOOR.
- (3) WHEN SLIDING WINDOWS ARE USED, THE MINIMUM DIMENSION DESCRIBED IN SENTENCE (1) SHALL APPLY TO THE OPENABLE PORTION OF THE WINDOW.

ATTIC HATCHES SHALL NOT BE LESS THAN 550mm (21 5/8") BY 900mm (35")

OBC 9.26.4.1.

FLASHING REQUIRED AT ALL ROOF-WALL JUNCTIONS

INTERIOR FINISH OF EXITS

THE FLAME SPREAD RATING OF WALL OR CEILING FINISH IN AN EXIT MUST NOT EXCEED 25.

INTERIOR FINISH (EXCEPT EXITS)

FLAME SPREAD RATING OF INTERIOR FINISH MATERIALS SHALL NOT EXCEED 150 ON WALLS AND 150 ON CEILINGS. COMBUSTIBLE WALL AND CEILING FINISHES SUCH AS WOOD, PLYWOOD, PLASTIC, FABRIC, CARPET, ETC. MUST BE APPROVED BY THE INSPECTOR PRIOR TO THE INSTALLATION.

DIV.B. 9.10.14.1 EXPOSING BUILDING FACE OF HOUSES

UNPROTECTED OPENINGS IN THE EXPOSING BUILDING FACE SHALL NOT BE PERMITTED IF THE LIMITING DISTANCE IS LESS THAN 1.2m (3'11") AND SHALL BE LIMITED IN CONFORMANCE WITH THE REQUIREMENTS FOR UNPROTECTED OPENINGS IN DIV. B ARTICLE 9.10.15.1. WHERE THE LIMITING DISTANCE IS 1.2m (3'11") OR GREATER.

THE EXPOSING BUILDING FACE SHALL HAVE A FIRE RESISTANCE RATING OF NOT LESS THAN 45 MINUTES WHERE THE LIMITING DISTANCE IS LESS THAN 1.2m.

RESISTANCE TO FORCED ENTRY 2012 O.B.C. DIV B. 9.7.5.2. & 9.7.5.3.

A return air inlet shall be located in any room where at least 1/2 of the floor area is located over an unconditioned space (e.g. room over a garage)

1. SWINGING DOORS PROVIDING ACCESS TO DWELLING UNITS SHALL SATISFY THE REQUIREMENTS FOR RESISTANCE TO FORCED ENTRY AS DESCRIBED IN SUBSECTION 9.7.5.2.
2. WINDOWS IN DWELLING UNITS THAT ARE LOCATED WITHIN 2M OF ADJACENT GROUND LEVEL SHALL CONFORM TO THE REQUIREMENTS FOR RESISTANCE TO FORCED ENTRY AS DESCRIBED IN CLAUSE 5.3.5.OF AAMA/WDMA/CSA 101/1.S.2/A440.

2012 Code

9.8.8.1.(8)(a)(b) Windows over Stairs, Ramps and Landings

- (2) In *dwelling units*, glazing installed over stairs, ramps and landings that extend to less than 900 mm (2 ft 11 in) above the surface to the treads, ramp or landing shall be,
- (a) protected by *guards*, in accordance with this Subsection, or
- (b) non-openable and designed to withstand the specified lateral loads for *guards* as provided in Article 4.1.5.14.

2012 OBC DIV. B, 9.8.2.1. to 9.8.4.7. STAIR DIMENSIONS						
STAIR TYPE	MAX. RISE, mm, ALL STEPS	MIN. RISE, mm, ALL STEPS	MAX. RUN, mm RECTANGULAR TREADS	MIN. RUN, mm RECTANGULAR TREADS	STAIR WIDTH, mm	HEADROOM, mm
PRIVATE STAIRS	200	125	355	255	860	1950
PUBLIC STAIRS	180	125	NO LIMIT	280	900	2050
SERVICE STAIRS	NO LIMIT	125	355	NO LIMIT	900	2050
STAIR TO UNOCCUPIED ATTIC SPACE	NO LIMIT	125	355	NO LIMIT	860	1950
STAIRS TO CRAWL SPACE	NO LIMIT	125	355	NO LIMIT	860	1950
STAIRS THAT SERVE MEZZANINES NOT EXCEEDING 20 m <sup>2</sup> WITHIN LIVE/WORK UNITS	NO LIMIT	125	355	NO LIMIT	WIDTH AS PER DIV B 9.8.2.1.(3)	2050
<b>NOTE:</b> THE CURVED EDGES OF TREADS SHALL NOT REDUCE THE REQUIRED TREAD DEPTH BY MORE THAN 15mm AND SHALL NOT EXCEED 25mm HORIZONTALLY.						

STRUCTURAL ALTERATIONS

ALL STRUCTURAL ALTERATIONS MUST BE FIELD REVIEWED BY A PROFESSIONAL ENGINEER IF REQUIRED BY THE BUILDING INSPECTOR

FINISHED SITE GRADING

THE BUILDING SHALL BE LOCATED AND THE BUILDING SITE GRADED SO THAT WATER WILL NOT ACCUMULATE AT OR NEAR THE BUILDING AND WILL NOT ADVERSELY AFFECT ANY ADJACENT PROPERTIES.

A CURSORY REVIEW OF THE STRUCTURAL ELEMENTS HAS BEEN COMPLETED AND IS RELIANT ON ENGINEER'S CERTIFICATION OF DRAWINGS.

9.5.2.3. STUD WALL REINFORCEMENT

- (1) IF WOOD WALL STUDS OR SHEET STEEL WALL STUDS ENCLOSE THE MAIN BATHROOM IN A DWELLING UNIT, REINFORCEMENT SHALL BE INSTALLED TO PERMIT THE FUTURE INSTALLATION OF A GRAB BAR ON A WALL ADJACENT TO,
- (a) A WATER CLOSET IN THE LOCATION REQUIRED BY CLAUSE 3.8.3.8.(1)(d), AND
- (b) A SHOWER OR BATHTUB IN THE LOCATION BY CLAUSE 3.8.3.13.(1)(f).


(SEE APPENDIX A.)

CORPORATION OF THE CITY OF OSHAWA

TRUE COPY

OF PERMIT PLANS

FOR 10-2023

PER: 

CHIEF BUILDING OFFICIAL

STRIP FOOTINGS FOR SINGLE FRAME PERMITS UP TO 2 STOREY

120 KPa NATIVE SOIL  
20"x6" CONCRETE STRIP FOOTINGS BELOW FOUNDATION WALLS.  
24"x8" CONCRETE STRIP FOOTINGS BELOW PARTY WALLS.

90 KPa ENGINEERED FILL SOIL  
24"x8" CONCRETE STRIP FOOTINGS WITH REINFORCING BELOW FOUNDATION WALLS.  
30"x8" CONCRETE STRIP FOOTINGS WITH REINFORCING BELOW PARTY WALLS.

100 KPa NATIVE SOIL  
22"x8" CONCRETE STRIP FOOTINGS BELOW FOUNDATION WALLS.  
28"x10" CONCRETE STRIP FOOTINGS BELOW PARTY WALLS  
OR  
28"x8" CONCRETE STRIP FOOTINGS WITH REINFORCING BELOW PARTY WALLS

GENERAL NOTE :  
ASSUMED 120/100 KPa NATIVE SOIL BEARING CAPACITY OR 90 KPa  
FOR ENGINEERED FILL, TO BE VERIFIED ON SITE. REFER TO ENGINEERED FILL  
FOOTING DETAIL FOR REINFORCEMENT.  
  
(REFER TO ENG. FILL FOOTING DETAIL)

MHP 23027

2023

AREA CALCULATIONS EL-1			
FIRST FLOOR AREA	=	968	Sq. Ft.
SECOND FLOOR AREA	=	1161	Sq. Ft.
TOTAL FLOOR AREA	=	2129	Sq. Ft.
ADD OPEN AREAS	=	10	Sq. Ft.
ADD FIN. BASEMENT AREA	=	0	Sq. Ft.
GROSS FLOOR AREA	=	2139	Sq. Ft.
GROUND FLOOR COVERAGE	=	968	Sq. Ft.
GARAGE COVERAGE / AREA	=	223	Sq. Ft.
PORCH COVERAGE / AREA	=	121	Sq. Ft.
COVERAGE W/ PORCH	=	1312	Sq. Ft.
	=	121.89	Sq. m.
COVERAGE W/O PORCH	=	1191	Sq. Ft.
	=	110.65	Sq. m.

AREA CALCULATIONS EL-2			
FIRST FLOOR AREA	=	968	Sq. Ft.
SECOND FLOOR AREA	=	1161	Sq. Ft.
TOTAL FLOOR AREA	=	2129	Sq. Ft.
ADD OPEN AREAS	=	10	Sq. Ft.
ADD FIN. BASEMENT AREA	=	0	Sq. Ft.
GROSS FLOOR AREA	=	2139	Sq. Ft.
GROUND FLOOR COVERAGE	=	968	Sq. Ft.
GARAGE COVERAGE / AREA	=	223	Sq. Ft.
PORCH COVERAGE / AREA	=	121	Sq. Ft.
COVERAGE W/ PORCH	=	1312	Sq. Ft.
	=	121.89	Sq. m.
COVERAGE W/O PORCH	=	1191	Sq. Ft.
	=	110.65	Sq. m.

AREA CALCULATIONS EL-3			
FIRST FLOOR AREA	=	968	Sq. Ft.
SECOND FLOOR AREA	=	1161	Sq. Ft.
TOTAL FLOOR AREA	=	2129	Sq. Ft.
ADD OPEN AREAS	=	10	Sq. Ft.
ADD FIN. BASEMENT AREA	=	0	Sq. Ft.
GROSS FLOOR AREA	=	2139	Sq. Ft.
GROUND FLOOR COVERAGE	=	968	Sq. Ft.
GARAGE COVERAGE / AREA	=	223	Sq. Ft.
PORCH COVERAGE / AREA	=	121	Sq. Ft.
COVERAGE W/ PORCH	=	1312	Sq. Ft.
	=	121.89	Sq. m.
COVERAGE W/O PORCH	=	1191	Sq. Ft.
	=	110.65	Sq. m.

PAD FOOTING

120 KPa NATIVE SOIL  
F1 = 42"x42"x18" CONCRETE PAD  
F2 = 36"x36"x16" CONCRETE PAD  
F3 = 30"x30"x12" CONCRETE PAD  
F4 = 24"x24"x12" CONCRETE PAD  
F5 = 18"x18"x8" CONCRETE PAD  
  
(REFER TO FLOOR PLAN FOR UNUSUAL SIZE PADS NOT ON CHART)

90 KPa ENGINEERED FILL SOIL  
F1 = 48"x48"x20" CONCRETE PAD  
F2 = 40"x40"x16" CONCRETE PAD  
F3 = 34"x34"x14" CONCRETE PAD  
F4 = 28"x28"x12" CONCRETE PAD  
F5 = 18"x18"x8" CONCRETE PAD

100 KPa NATIVE SOIL  
F1 = 46"x46"x20" CONCRETE PAD  
F2 = 38"x38"x16" CONCRETE PAD  
F3 = 32"x32"x14" CONCRETE PAD  
F4 = 26"x26"x12" CONCRETE PAD  
F5 = 17"x17"x8" CONCRETE PAD

**NOTE:**  
WHEN VENEER CUT IS GREATER THAN 26" A 10" POURED CONC. FOUNDATION WALL IS REQUIRED.

**NOTE:**  
ALL GARAGE SLABS, PORCH SLABS, STAIRS (EXPOSED CONC. FLAT WORK) TO BE 32 MPa WITH 5-8% AIR ENTRAINMENT.

BRICK VENEER LINTELS:

WL1 = 3 1/2" x 3 1/2" x 1 1/4" (90x90x6) + 2- 2" x 8" SPR.  
WL2 = 4" x 3 1/2" x 5/16" (100x90x8) + 2- 2" x 8" SPR.  
WL3 = 5" x 3 1/2" x 5/16" (125x90x8) + 2- 2" x 10" SPR.  
WL4 = 6" x 3 1/2" x 3/8" (150x90x10) + 2- 2" x 12" SPR.  
WL5 = 6" x 4" x 3/8" (150x100x10) + 2- 2" x 12" SPR.  
  
WL6 = 5" x 3 1/2" x 5/16" (125x90x8) + 2- 2" x 12" SPR.  
WL7 = 5" x 3 1/2" x 5/16" (125x90x8) + 3- 2" x 10" SPR.  
WL8 = 5" x 3 1/2" x 5/16" (125x90x8) + 3- 2" x 12" SPR.  
WL9 = 6" x 4" x 3/8" (150x100x10) + 3- 2" x 12" SPR.

WOOD LINTELS:

WB1 = 2- 2" x 8" SPRUCE BEAM  
WB2 = 3- 2" x 8" SPRUCE BEAM  
WB3 = 2- 2" x 10" SPRUCE BEAM  
WB4 = 3- 2" x 10" SPRUCE BEAM  
WB5 = 2- 2" x 12" SPRUCE BEAM  
  
WB6 = 3- 2" x 12" SPRUCE BEAM  
WB7 = 5- 2" x 12" SPRUCE BEAM  
WB10 = 4- 2" x 8" SPRUCE BEAM  
WB11 = 4- 2" x 10" SPRUCE BEAM


STEEL LINTELS:

L1 = 3 1/2 x 3 1/2 x 1 1/4 (90 x 90 x 6)  
L2 = 4" x 3 1/2" x 5/16" (100 x 90 x 8)  
L3 = 5" x 3 1/2" x 5/16" (125 x 90 x 8)  
  
L4 = 6" x 3 1/2" x 3/8" (150 x 90 x 10)  
L5 = 6" x 4" x 3/8" (150 x 100 x 10)  
L6 = 7" x 4" x 3/8" (180 x 100 x 10)

LAMINATED VENEER LUMBER (LVL BEAMS)

LVL1A = 1-1 3/4" x 7 1/4" (1-45x184)  
LVL1 = 2-1 3/4" x 7 1/4" (2-45x184)  
LVL2 = 3-1 3/4" x 7 1/4" (3-45x184)  
LVL3 = 4-1 3/4" x 7 1/4" (4-45x184)  
LVL4A = 1-1 3/4" x 9 1/2" (1-45x240)  
LVL4 = 2-1 3/4" x 9 1/2" (2-45x240)  
LVL5 = 3-1 3/4" x 9 1/2" (3-45x240)  
LVL5A = 4-1 3/4" x 9 1/2" (4-45x240)  
LVL6A = 1-1 3/4" x 11 7/8" (1-45x300)  
LVL6 = 2-1 3/4" x 11 7/8" (2-45x300)  
LVL7 = 3-1 3/4" x 11 7/8" (3-45x300)  
  
LVL7A = 4-1 3/4" x 11 7/8" (4-45x300)  
LVL8 = 2-1 3/4" x 14" (2-45x356)  
LVL9 = 3-1 3/4" x 14" (3-45x356)


2-2"x6" STUD WALL NAILED TOGETHER AND SPACED @12" O.C.  
FULL HT C/W SOLID BLOCKING 4'-0" O.C. VERTICAL AND 7/16" EXT. PLYWOOD SHEATHING.

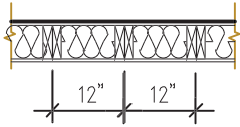

MAXIMUM HEIGHT OF WALL FOR THIS DETAIL IS 18'-0" AND  
MAXIMUM SUPPORTED LENGTH OF TRUSS IS 40'-0"

**TWO STOREY HEIGHT WALL DETAIL**

2 - 1 1/2" x 5 1/2" TIMBERSTRAND (LSL) 1.5E STUD WALL GLUED AND NAILED TOGETHER AND SPACED MAX. @10" O.C. FULL HT C/W SOLID BLOCKING MAX. 8'-0" O.C. VERTICAL AND 7/16" EXT. OSB SHEATHING.

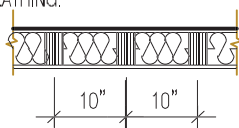

MAXIMUM HEIGHT OF WALL FOR THIS DETAIL IS 20'-2" AND  
MAXIMUM SUPPORTED LENGTH OF TRUSS IS 40'-0"

**TWO STOREY HEIGHT WALL DETAIL**

**NOTE:**  
THESE DRAWINGS ARE TO BE READ IN CONJUNCTION WITH ENGINEER APPROVED ROOF TRUSS DRAWINGS BY MANUFACTURER.

**NOTE:**  
SPACE CONVENTIONAL FLOOR JOISTS @ 12" O.C. BELOW ALL CERAMIC TILE AREAS. PROVIDE 1 ROW BRIDGING FOR SPANS OF 5'-7", 2 ROWS FOR SPANS GREATER THAN 7'

**NOTE:**  
THESE DRAWINGS ARE TO BE READ IN CONJUNCTION WITH ENGINEER APPROVED FLOOR TRUSS LAYOUT BY MANUFACTURER.

**NOTE:**  
PLANS NOT DRAWN TO ACTUAL GRADE. REFER TO FINAL GRADING PLAN.

### Door Schedule

NO.	WIDTH	HEIGHT 8' TO 9' CEILINGS	HEIGHT 10' OR MORE CEILINGS	TYPE
1	2'-10"	6'-8" (865x2033)	8'-0" (865x2439)	INSULATED ENTRANCE DOOR
1a	2'-8"	6'-8" (815x2033)	8'-0" (815x2439)	INSULATED FRONT DOORS
2	2'-8"	6'-8" (815x2033)	8'-0" (815x2439)	WOOD & GLASS DOOR
3	2'-8"	6'-8" x 1-3/4" (815x2033x45)	8'-0" x 1-3/4" (815x2439x45)	EXTERIOR SLAB DOOR
4	2'-8"	6'-8" x 1-3/8" (815x2033x35)	8'-0" x 1-3/8" (815x2439x35)	INTERIOR SLAB DOOR
5	2'-6"	6'-8" x 1-3/8" (760x2033x35)	8'-0" x 1-3/8" (760x2439x35)	INTERIOR SLAB DOOR
6	2'-2"	6'-8" x 1-3/8" (660x2033x35)	8'-0" x 1-3/8" (660x2439x35)	INTERIOR SLAB DOOR
7	1'-6"	6'-8" x 1-3/8" (460x2033x35)	8'-0" x 1-3/8" (460x2439x35)	INTERIOR SLAB DOOR
8	3'-0"	6'-8" x 1-3/8" (915x2033x35)	8'-0" x 1-3/8" (915x2439x35)	INTERIOR SLAB DOOR

RIVER 11 ELEV.-1 ENERGY EFFICIENCY- A1 PACKAGE			
ELEVATION	WALL FT²	OPENING FT²	PERCENTAGE
FRONT	508.00	62.00	12.20 %
LEFT SIDE	1134.33	151.08	13.32 %
RIGHT SIDE	1133.77	34.67	3.06 %
REAR	486.11	118.00	24.27 %
TOTAL	3262.21	365.75	11.21 %

RIVER 11 ELEV.-2 ENERGY EFFICIENCY- A1 PACKAGE			
ELEVATION	WALL FT²	OPENING FT²	PERCENTAGE
FRONT	510.13	69.28	13.58 %
LEFT SIDE	1136.06	156.16	13.75 %
RIGHT SIDE	1132.25	34.67	3.06 %
REAR	486.11	118.00	24.27 %
TOTAL	3264.55	378.11	11.58 %

RIVER 11 ELEV.-3 ENERGY EFFICIENCY- A1 PACKAGE			
ELEVATION	WALL FT²	OPENING FT²	PERCENTAGE
FRONT	502.69	83.00	16.51 %
LEFT SIDE	1130.67	144.75	12.80 %
RIGHT SIDE	1133.77	34.67	3.06 %
REAR	486.11	118.00	24.27 %
TOTAL	3253.24	380.42	11.69 %

It is the builder's complete responsibility to ensure that all plans submitted for approval fully comply with the Architectural Guidelines and all applicable regulations and requirements including zoning provisions and any provisions in the subdivision agreement. The Control Architect is not responsible in any way for examining or approving site (lotting) plans or working drawings with respect to any zoning or building code or permit matter or that any house can be properly built or located on its lot.

This is to certify that these plans comply with the applicable Architectural Design Guidelines approved by the City of Oshawa

2139

CORNER LOT 6

RIVER 11 (GR)

ELEVATION 1

A1 PACKAGE

O.REG. 332/12

THE CONTRACTOR SHALL CHECK AND VERIFY ALL DIMENSIONS AND CONDITIONS ON SITE BEFORE PROCEEDING WITH CONSTRUCTION. ANY DISCREPANCIES SHALL BE REPORTED TO JARDIN DESIGN GROUP INC. PRIOR TO COMMENCEMENT OF WORK.

JARDIN DESIGN GROUP INC. IS NOT RESPONSIBLE FOR THE ACCURACY OF SURVEY, STRUCTURAL OR ENGINEERING INFORMATION SHOWN ON THESE DRAWINGS OR FOR CONSTRUCTION STARTED PRIOR TO THE ISSUANCE OF A BUILDING PERMIT. REFER TO THE APPROPRIATE ENGINEERING DRAWINGS BEFORE PROCEEDING WITH WORK.

AS CONSTRUCTED INVERTS MUST BE VERIFIED PRIOR TO POURING FOOTINGS.

JARDIN DESIGN GROUP INC. HAS NOT BEEN RETAINED TO CARRY OUT OFFICIAL REVIEW OF THE WORK AND ASSUMES NO RESPONSIBILITY FOR THE FAILURE OF THE CONTRACTOR OR SUB CONTRACTOR TO CARRY OUT THE WORK IN ACCORDANCE WITH THE CONTRACT DOCUMENTS.

THIS DRAWING IS AN INSTRUMENT OF SERVICE. IS PROVIDED BY AND IS THE PROPERTY OF JARDIN DESIGN GROUP INC. THIS DRAWING IS NOT TO BE REPRODUCED.

No:      DATE:      WORK DESCRIPTION:

jardin

DESIGN GROUP INC

64 JARDIN DR. SUITE 3A  
VAUGHAN ONT. L4K 3P3  
TEL: 905 660-3377 FAX: 905 660-3713  
EMAIL: info@jardindesign.ca

The undersigned has reviewed and takes responsibility for this design and has the qualifications and meets the requirements set out in the Ontario Building Code to be a designer.

QUALIFICATION INFORMATION  
Required unless design is exempt under Division C, Subsection 3.2.5 of the building code.

Walter Botter

21031

NAME      SIGNATURE      BCIN

REGISTRATION INFORMATION  
Required unless design is exempt under Division C, Subsection 3.2.4 of the building code


jardin design group inc.

27763

FIRM NAME      BCIN

TITLE SHEET

ZADORRA ESTATE INC.  
CITY OF OSHAWA



BILD

MODEL:  
RIVER 11

SCALE:  
3/16"=1'-0"


PROJ. No.  
22-16

DWG. No.  
0

DRAWN BY:      DRAWING NAME:



**MHP 23027**

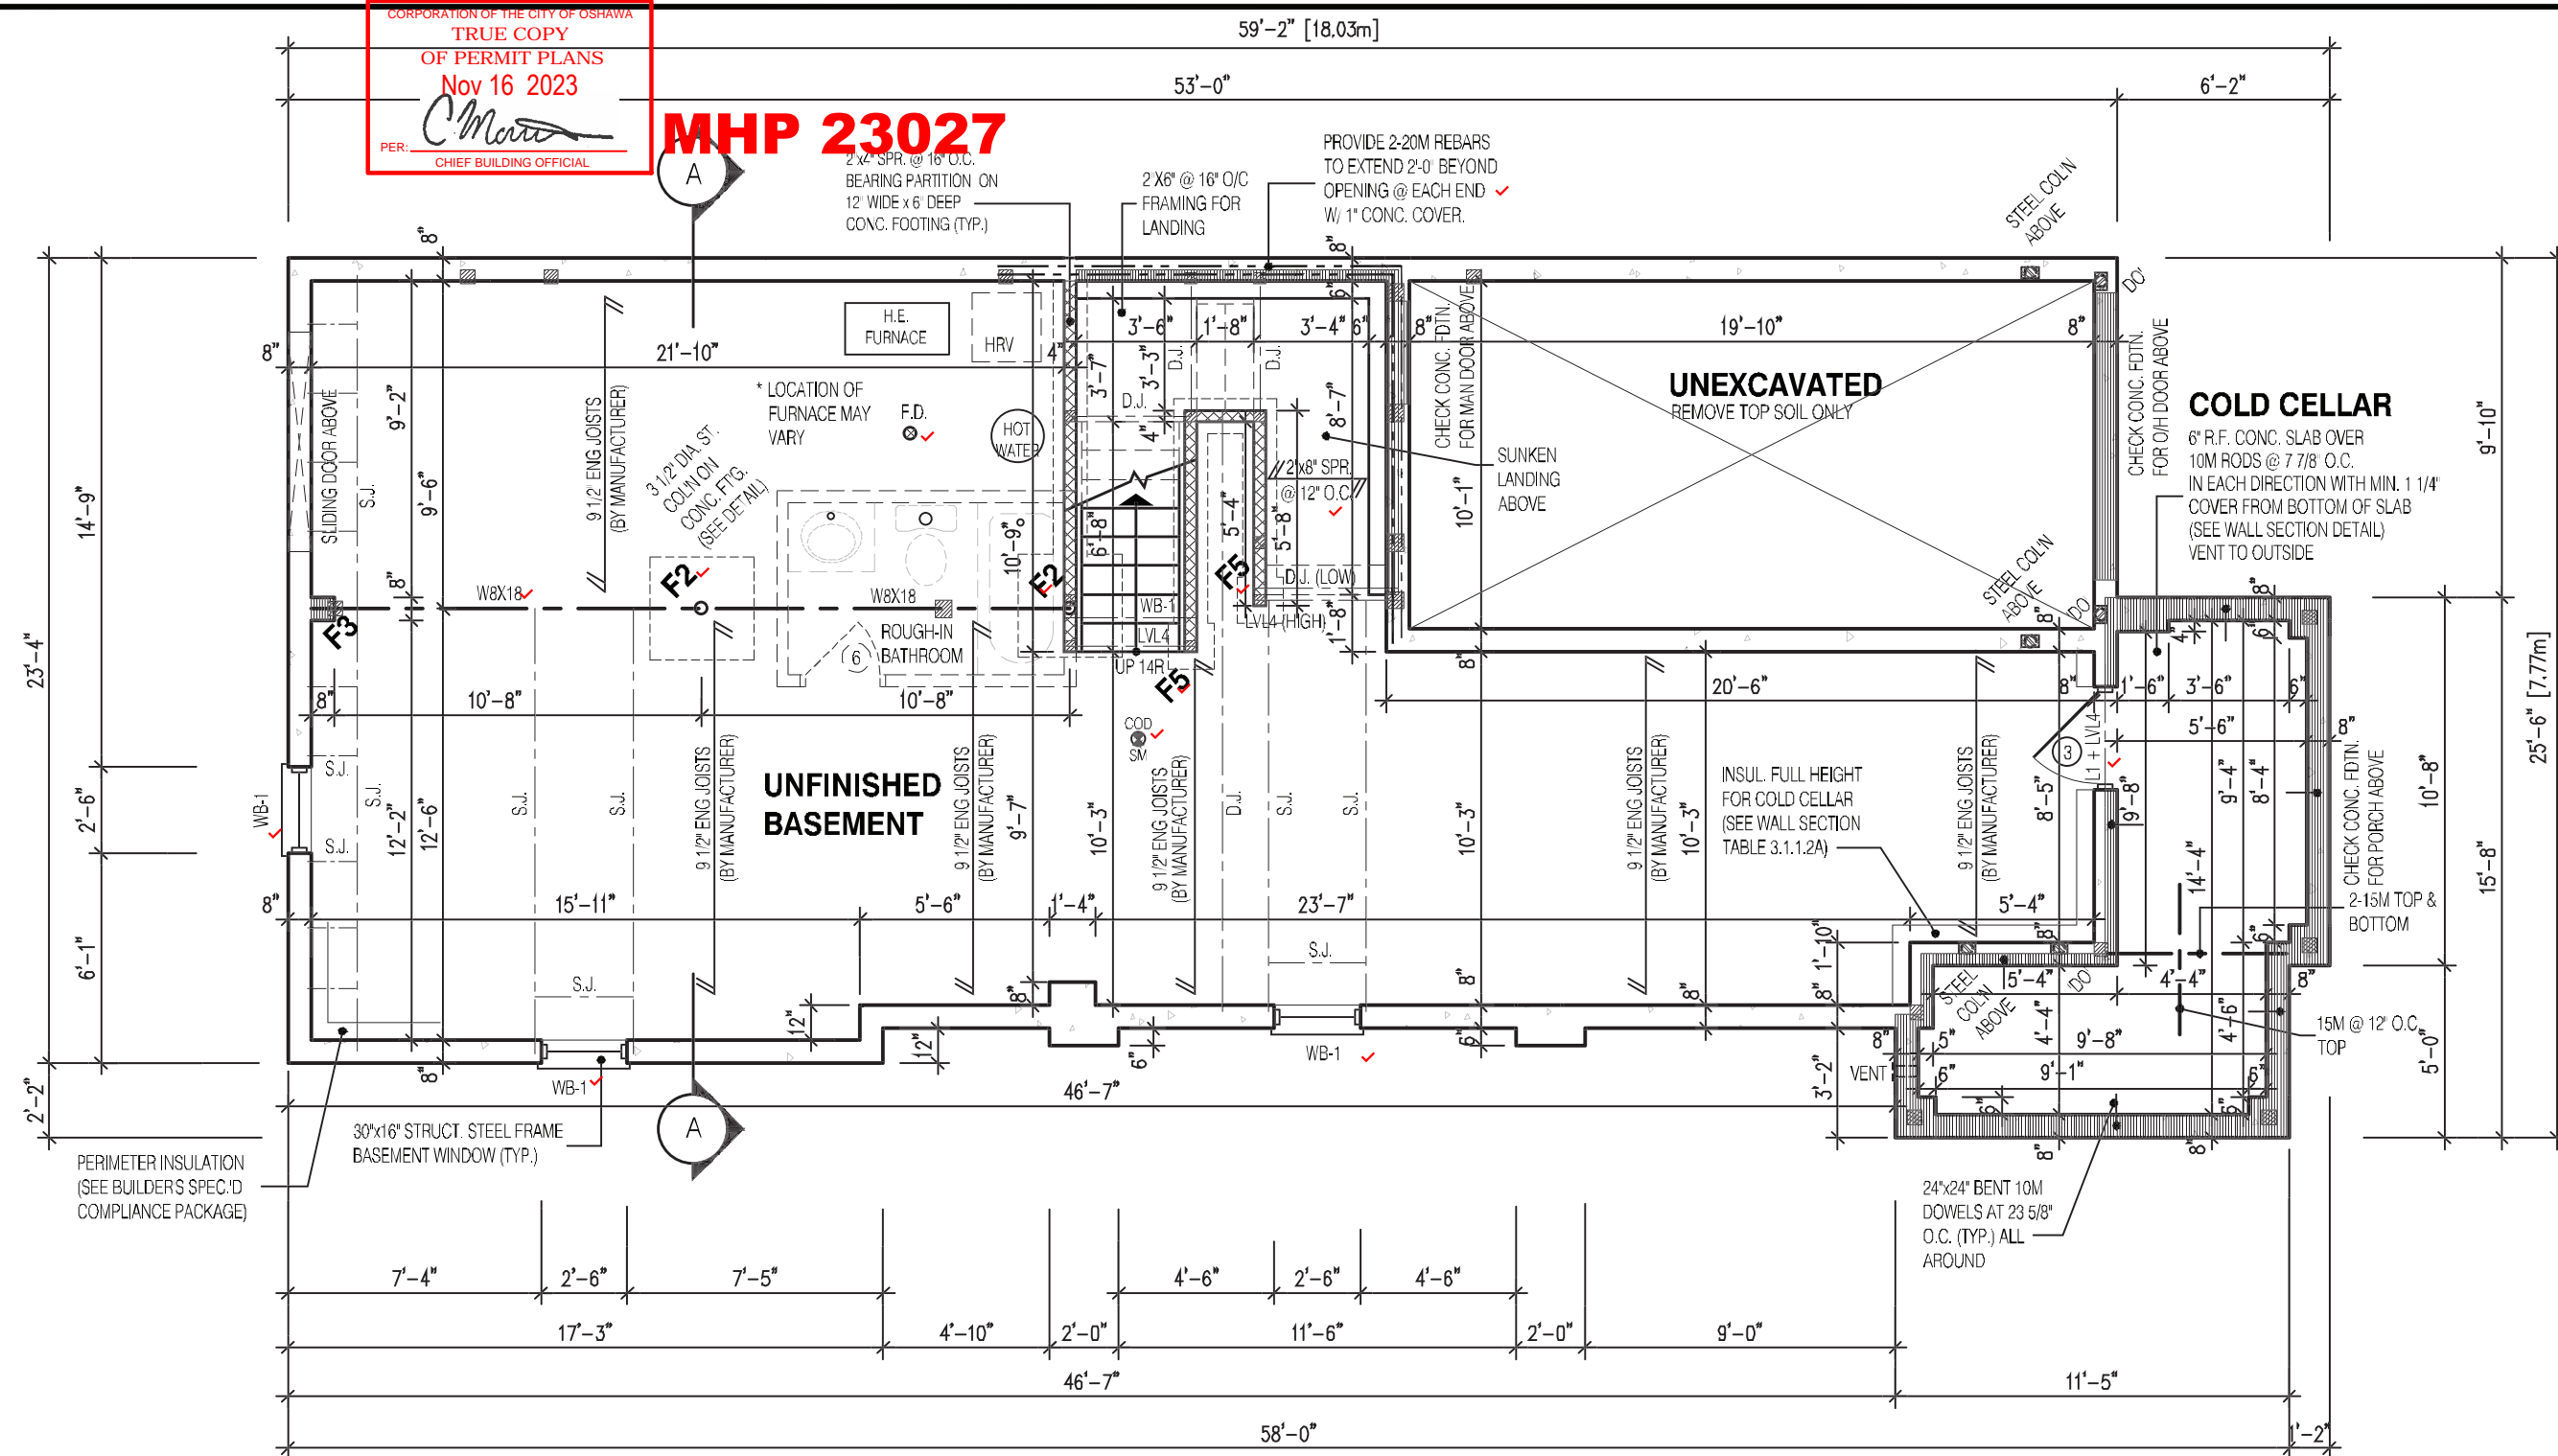

**NOTE:**  
REFER TO SHEET NO. 0-1 FOR LINTEL, BEAMS AND DOOR SIZE

**NOTE:**  
SPACE CONVENTIONAL FLOOR JOISTS @ 12" O.C. BELOW ALL CERAMIC TILE AREAS. PROVIDE 1 ROW BRIDGING FOR SPANS OF 5-7, 2 ROWS FOR SPANS GREATER THAN 7

**NOTE:**  
THESE DRAWINGS ARE TO BE READ IN CONJUNCTION WITH ENGINEER APPROVED FLOOR TRUSS LAYOUT BY MANUFACTURER.

**NOTE:**  
SUBFLOOR TO BE 3/4" PLYWOOD ON THIS LEVEL

**NOTE:**  
ALL FLOORS TO BE NAILED AND GLUED ON THIS LEVEL

**LEGEND:**

- BUILDING FACE < THAN 4'-0" (1.2m) (45 MIN. FIRE RATING REQ'D)
- INDICATES SOLID BEARING REQUIRED OR POINT LOAD FROM ABOVE
- STL. PLATE FOR STEEL COLN ABOVE
- LVL LAMINATED VENEER LUMBER
- S.J. SINGLE JOIST
- D.J. DOUBLE JOIST
- T.J. TRIPLE JOIST
- REPEAT NOTE
- SHOWER WEEPERS

STRUDET INC.

REGISTERED PROFESSIONAL ENGINEER  
B. MARINKOVIC  
May 12 2023  
FOR STRUCTURE ONLY

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JOHN G. WILLIAMS LTD., ARCHITECT  
ARCHITECTURAL CONTROL REVIEW AND APPROVAL  
APPROVED BY: *[Signature]*  
DATE: JUL 31, 2023  
This stamp certifies compliance with the applicable Design Guidelines only and bears no further professional responsibility.

2139  
CORNER LOT 6  
RIVER 11 (GR)  
ELEVATION 2  
A1 PACKAGE  
O.REG. 332/12

THE CONTRACTOR SHALL CHECK AND VERIFY ALL DIMENSIONS AND CONDITIONS ON SITE BEFORE PROCEEDING WITH CONSTRUCTION. ANY DISCREPANCIES SHALL BE REPORTED TO JARDIN DESIGN GROUP INC. PRIOR TO COMMENCEMENT OF WORK.

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AS CONSTRUCTED INVERTS MUST BE VERIFIED PRIOR TO POURING FOOTINGS.

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7	
6	
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4	MAY 8, 2023
3	MAY 3, 2023
2	MAR. 1, 2023
1	FEB. 14, 2023

No: DATE: WORK DESCRIPTION:

**jardin**  
DESIGN GROUP INC  
64 JARDIN DR. SUITE 3A  
VAUGHAN ONT. L4K 3P3  
TEL: 905 660-3377 FAX: 905 660-3713  
EMAIL: info@jardindesign.ca

The undersigned has reviewed and takes responsibility for this design and has the qualifications and meets the requirements set out in the Ontario Building Code to be a designer.

QUALIFICATION INFORMATION  
Required unless design is exempt under Division C, Subsection 3.2.5 of the building code.

Walter Botter *[Signature]* 21031  
NAME SIGNATURE BCIN

REGISTRATION INFORMATION  
Required unless design is exempt under Division C, Subsection 3.2.4 of the building code

jardin design group inc. 27763  
FIRM NAME BCIN

**BASEMENT PLAN EL-2**  
ZADORRA ESTATE INC.  
CITY OF OSHAWA

MODEL: RIVER 11  
SCALE: 3/16" = 1'-0"  
PROJ. No. 22-16 DWG. No. 1A


CORPORATION OF THE CITY OF OSHAWA  
TRUE COPY  
OF PERMIT PLANS  
Nov 16 2023  
PER: *C. Morris*  
CHIEF BUILDING OFFICIAL

MHP 23027

59'-2"

53'-0"

6'-2"

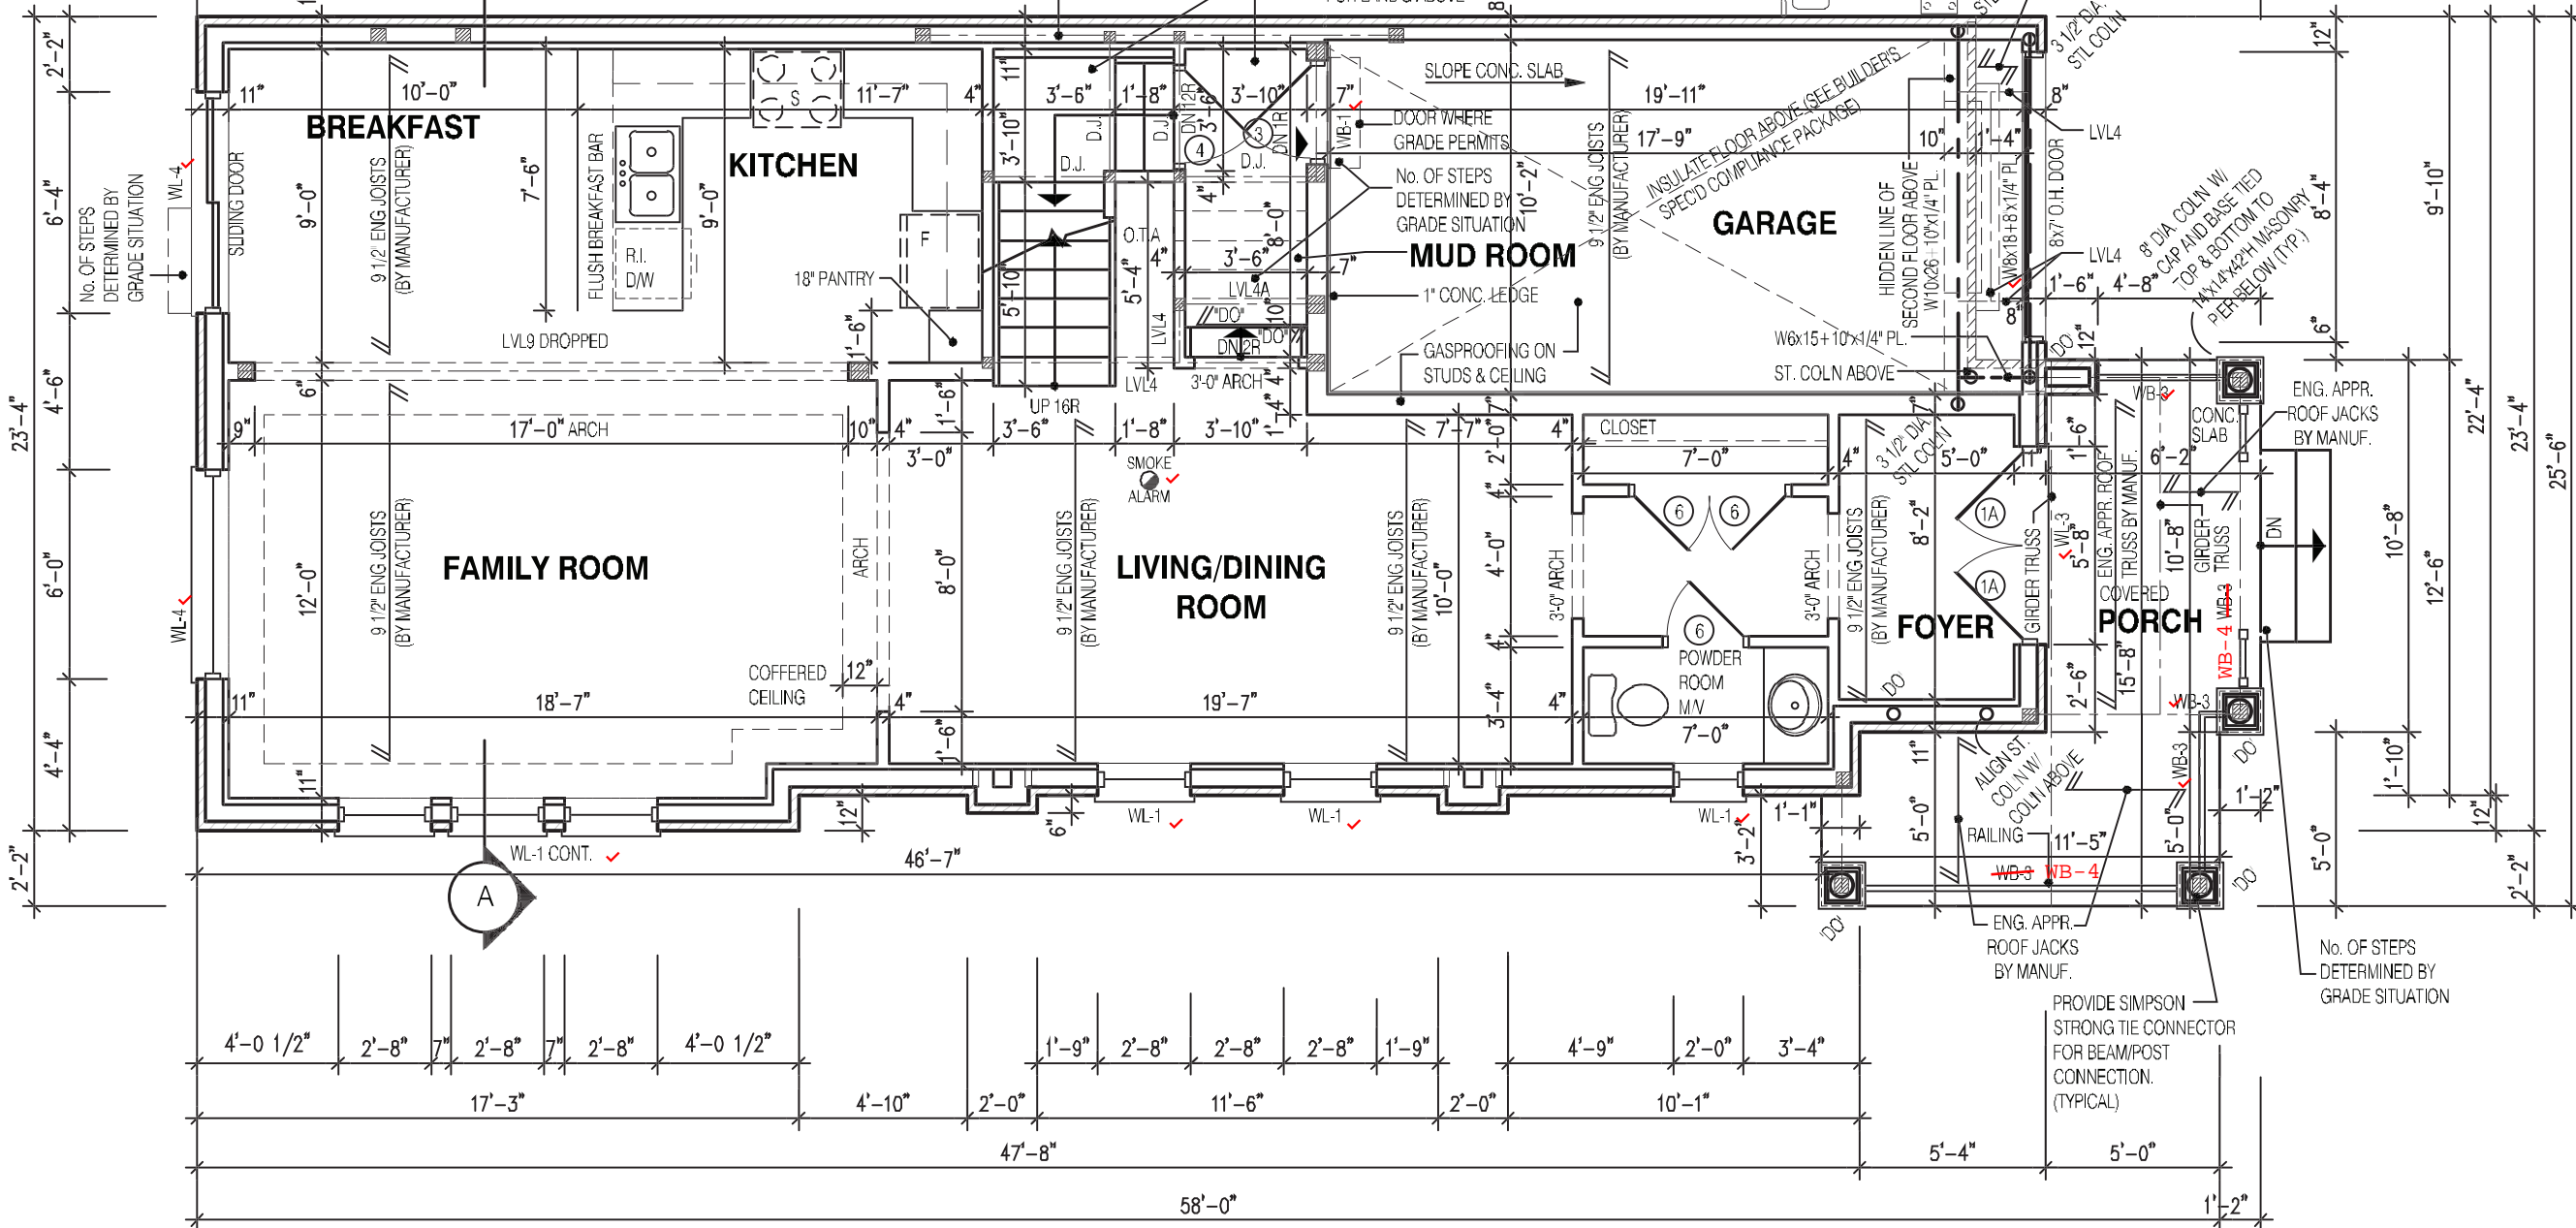

**NOTE:**

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**NOTE:**


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STRUDET INC.



FOR STRUCTURE ONLY

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JOHN G. WILLIAMS LTD., ARCHITECT  
ARCHITECTURAL CONTROL REVIEW  
AND APPROVAL

APPROVED BY: *[Signature]*  
DATE: JUL 31, 2023
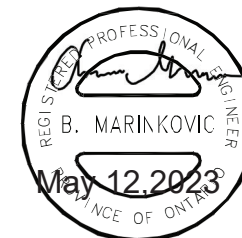
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2139  
CORNER LOT 6  
RIVER 11 (GR)  
ELEVATION 2  
A1 PACKAGE  
O.REG. 332/12

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7	
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4	MAY 8, 2023 ISSUED TO CLIENT FOR PERMIT
3	MAY 3, 2023 COORDINATED FLOOR, ROOF AND ENGINEER COMMENTS
2	MAR. 1, 2023 PREPARED TO PRE-COORDINATION STAGE & ISSUED TO CLIENT
1	FEB. 14, 2023 ADDED DRAWING TO SET

No: DATE: WORK DESCRIPTION:

**jardin**  
DESIGN GROUP INC  
64 JARDIN DR. SUITE 3A  
VAUGHAN ONT. L4K 3P3  
TEL: 905 660-3377 FAX: 905 660-3713  
EMAIL: info@jardindesign.ca

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QUALIFICATION INFORMATION  
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Walter Botter *[Signature]* 21031  
NAME SIGNATURE BCIN

REGISTRATION INFORMATION  
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jardin design group inc. 27763  
FIRM NAME BCIN

FIRST FLOOR PLAN EL-2


ZADORRA ESTATE INC.  
CITY OF OSHAWA

MODEL: RIVER 11  
SCALE: 3/16"=1'-0"  
PROJ. No. 22-16 DWG. No. 2A



CORPORATION OF THE CITY OF OSHAWA  
TRUE COPY  
OF PERMIT PLANS  
Nov 16 2023  
CHIEF BUILDING OFFICIAL

MHP 23027

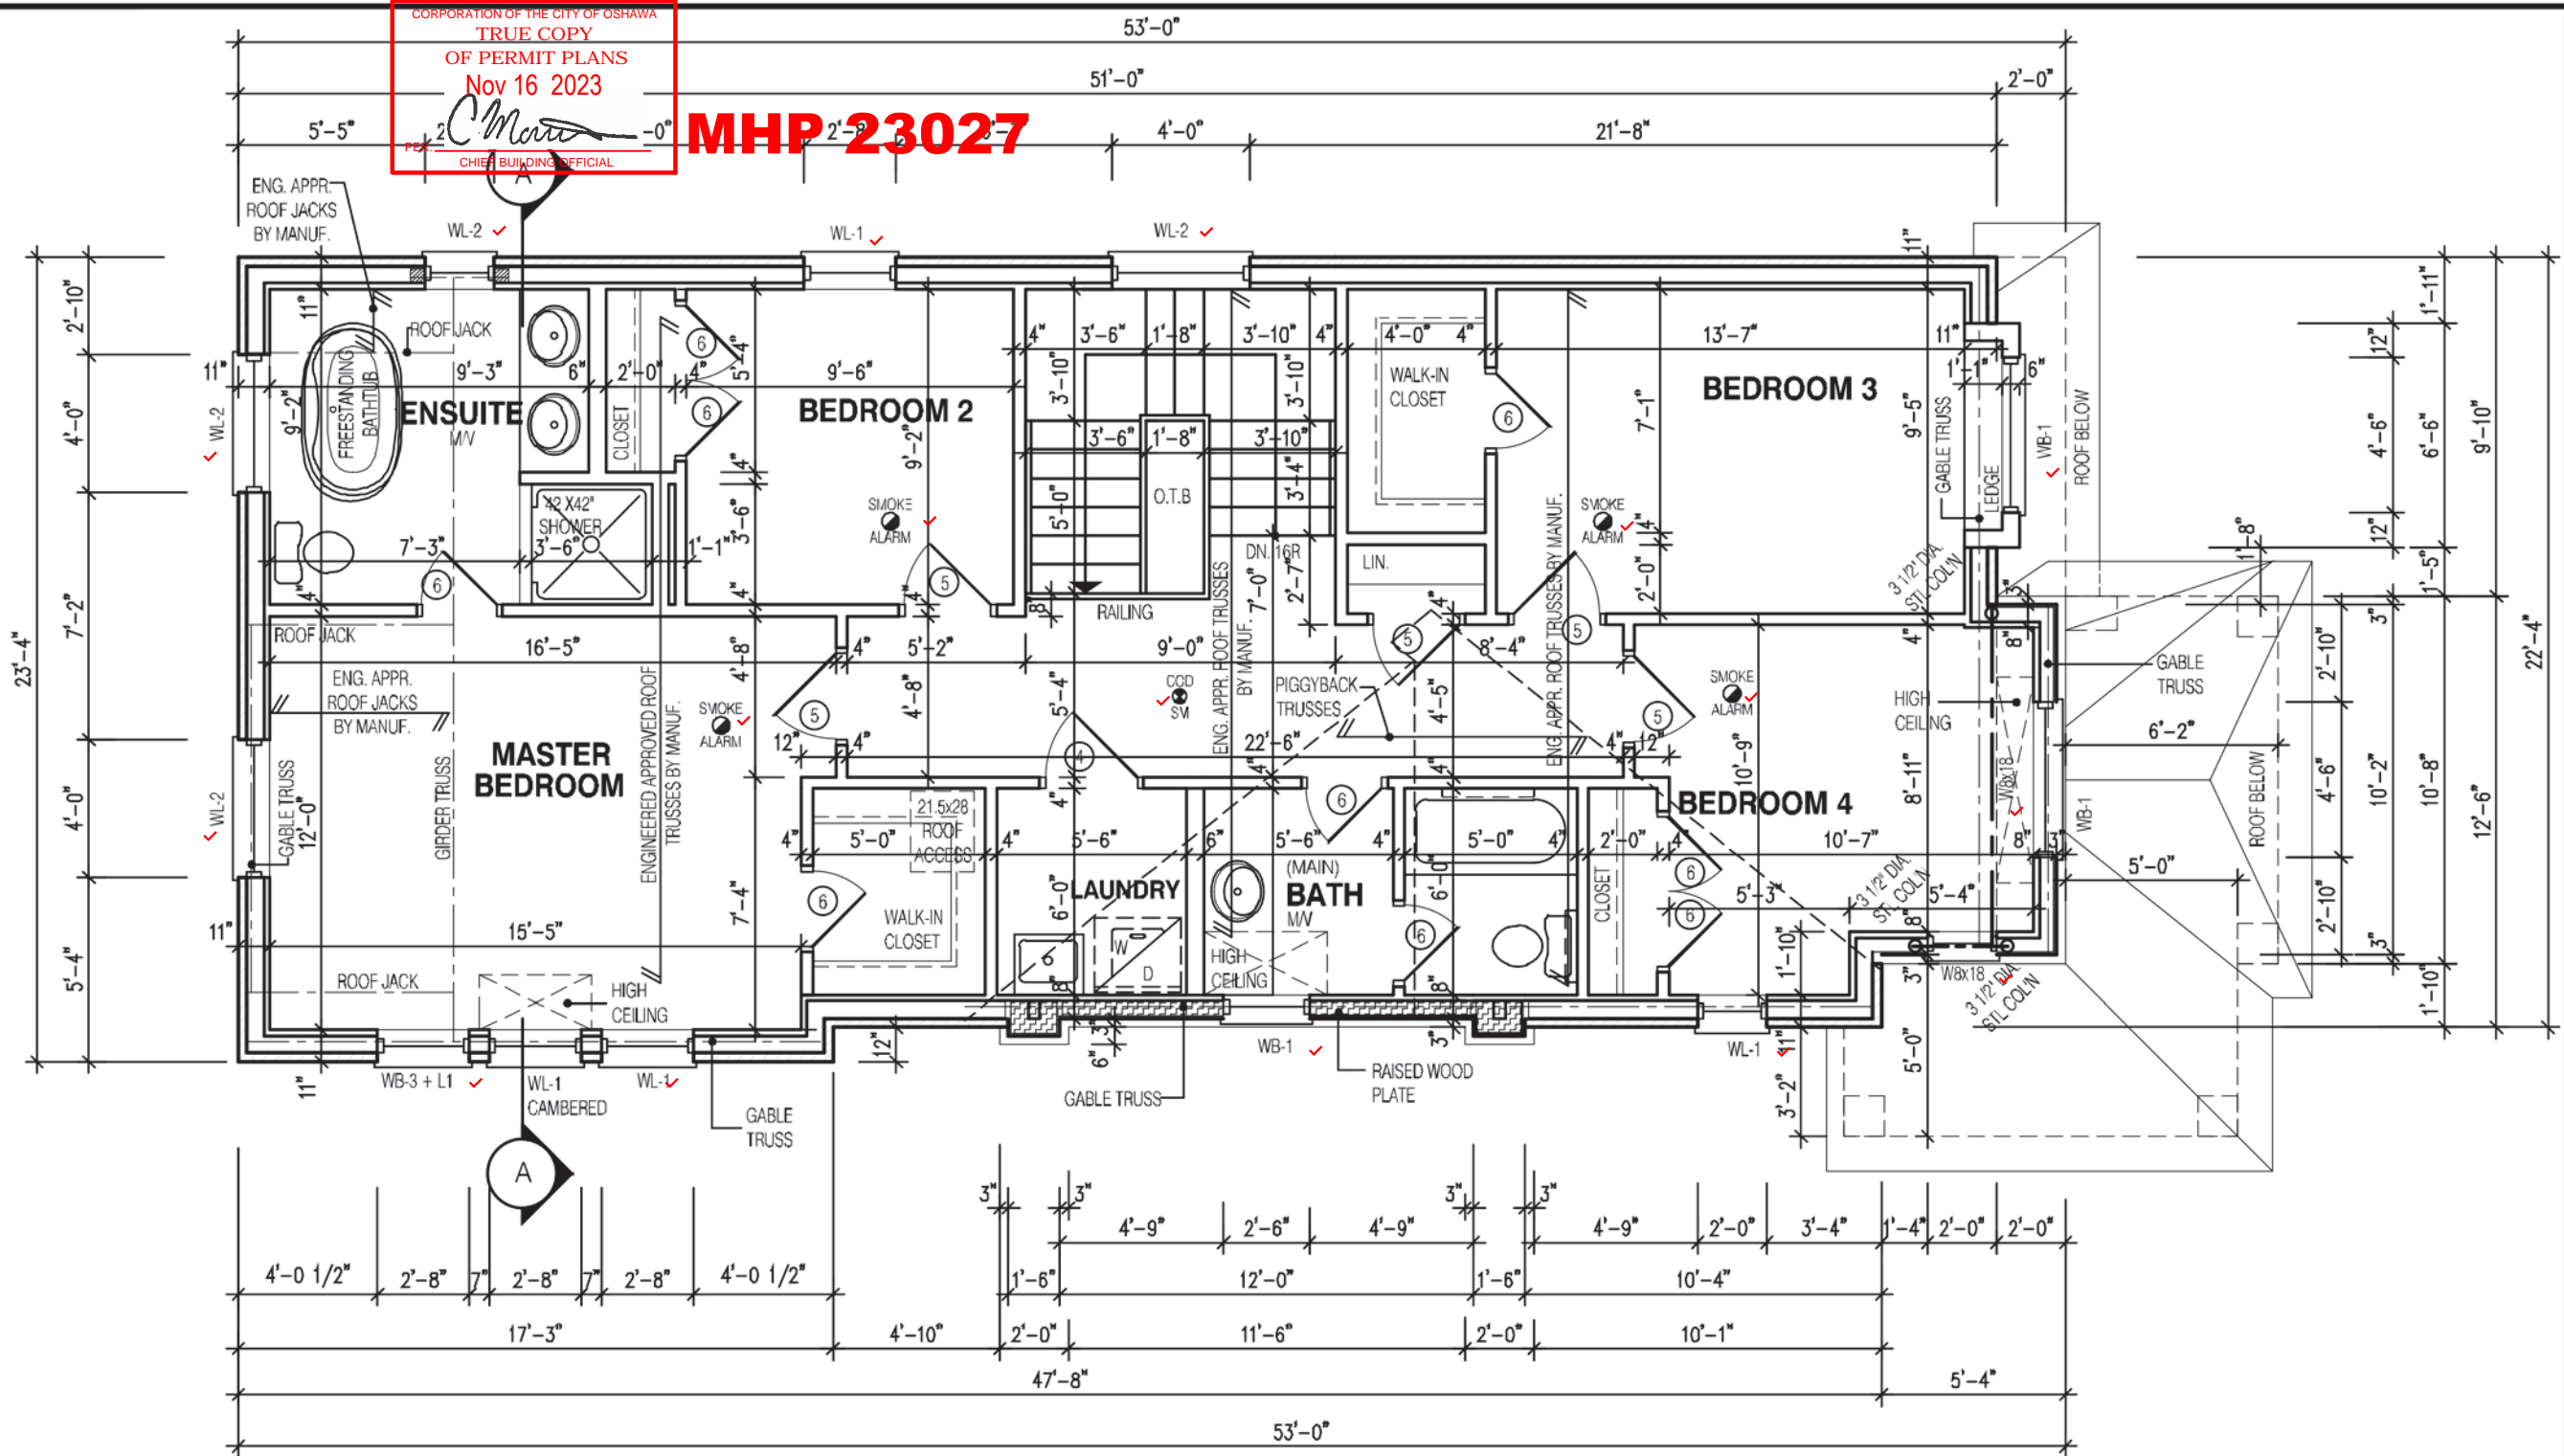

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  - REPEAT NOTE
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STRUDET INC.  
REGISTERED PROFESSIONAL ENGINEER  
B. MARINKOVIC  
May 12, 2023  
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2139  
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ELEVATION 2  
A1 PACKAGE  
O.REG. 332/12

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1	FEB. 14, 2023

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VAUGHAN ONT. L4K 3P3  
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Walter Botter  
NAME SIGNATURE BCIN

21031

REGISTRATION INFORMATION  
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jardin design group inc.

27763

FIRM NAME BCIN

27763

SECOND FL. PLAN EL-2  
ZADORRA ESTATE INC.  
CITY OF OSHAWA

MODEL:  
RIVER 11  
SCALE:  
3/16"=1'-0"  
PROJ. No.  
22-16  
DWG. No.  
3A








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CHIEF BUILDING OFFICIAL

MHP 23027

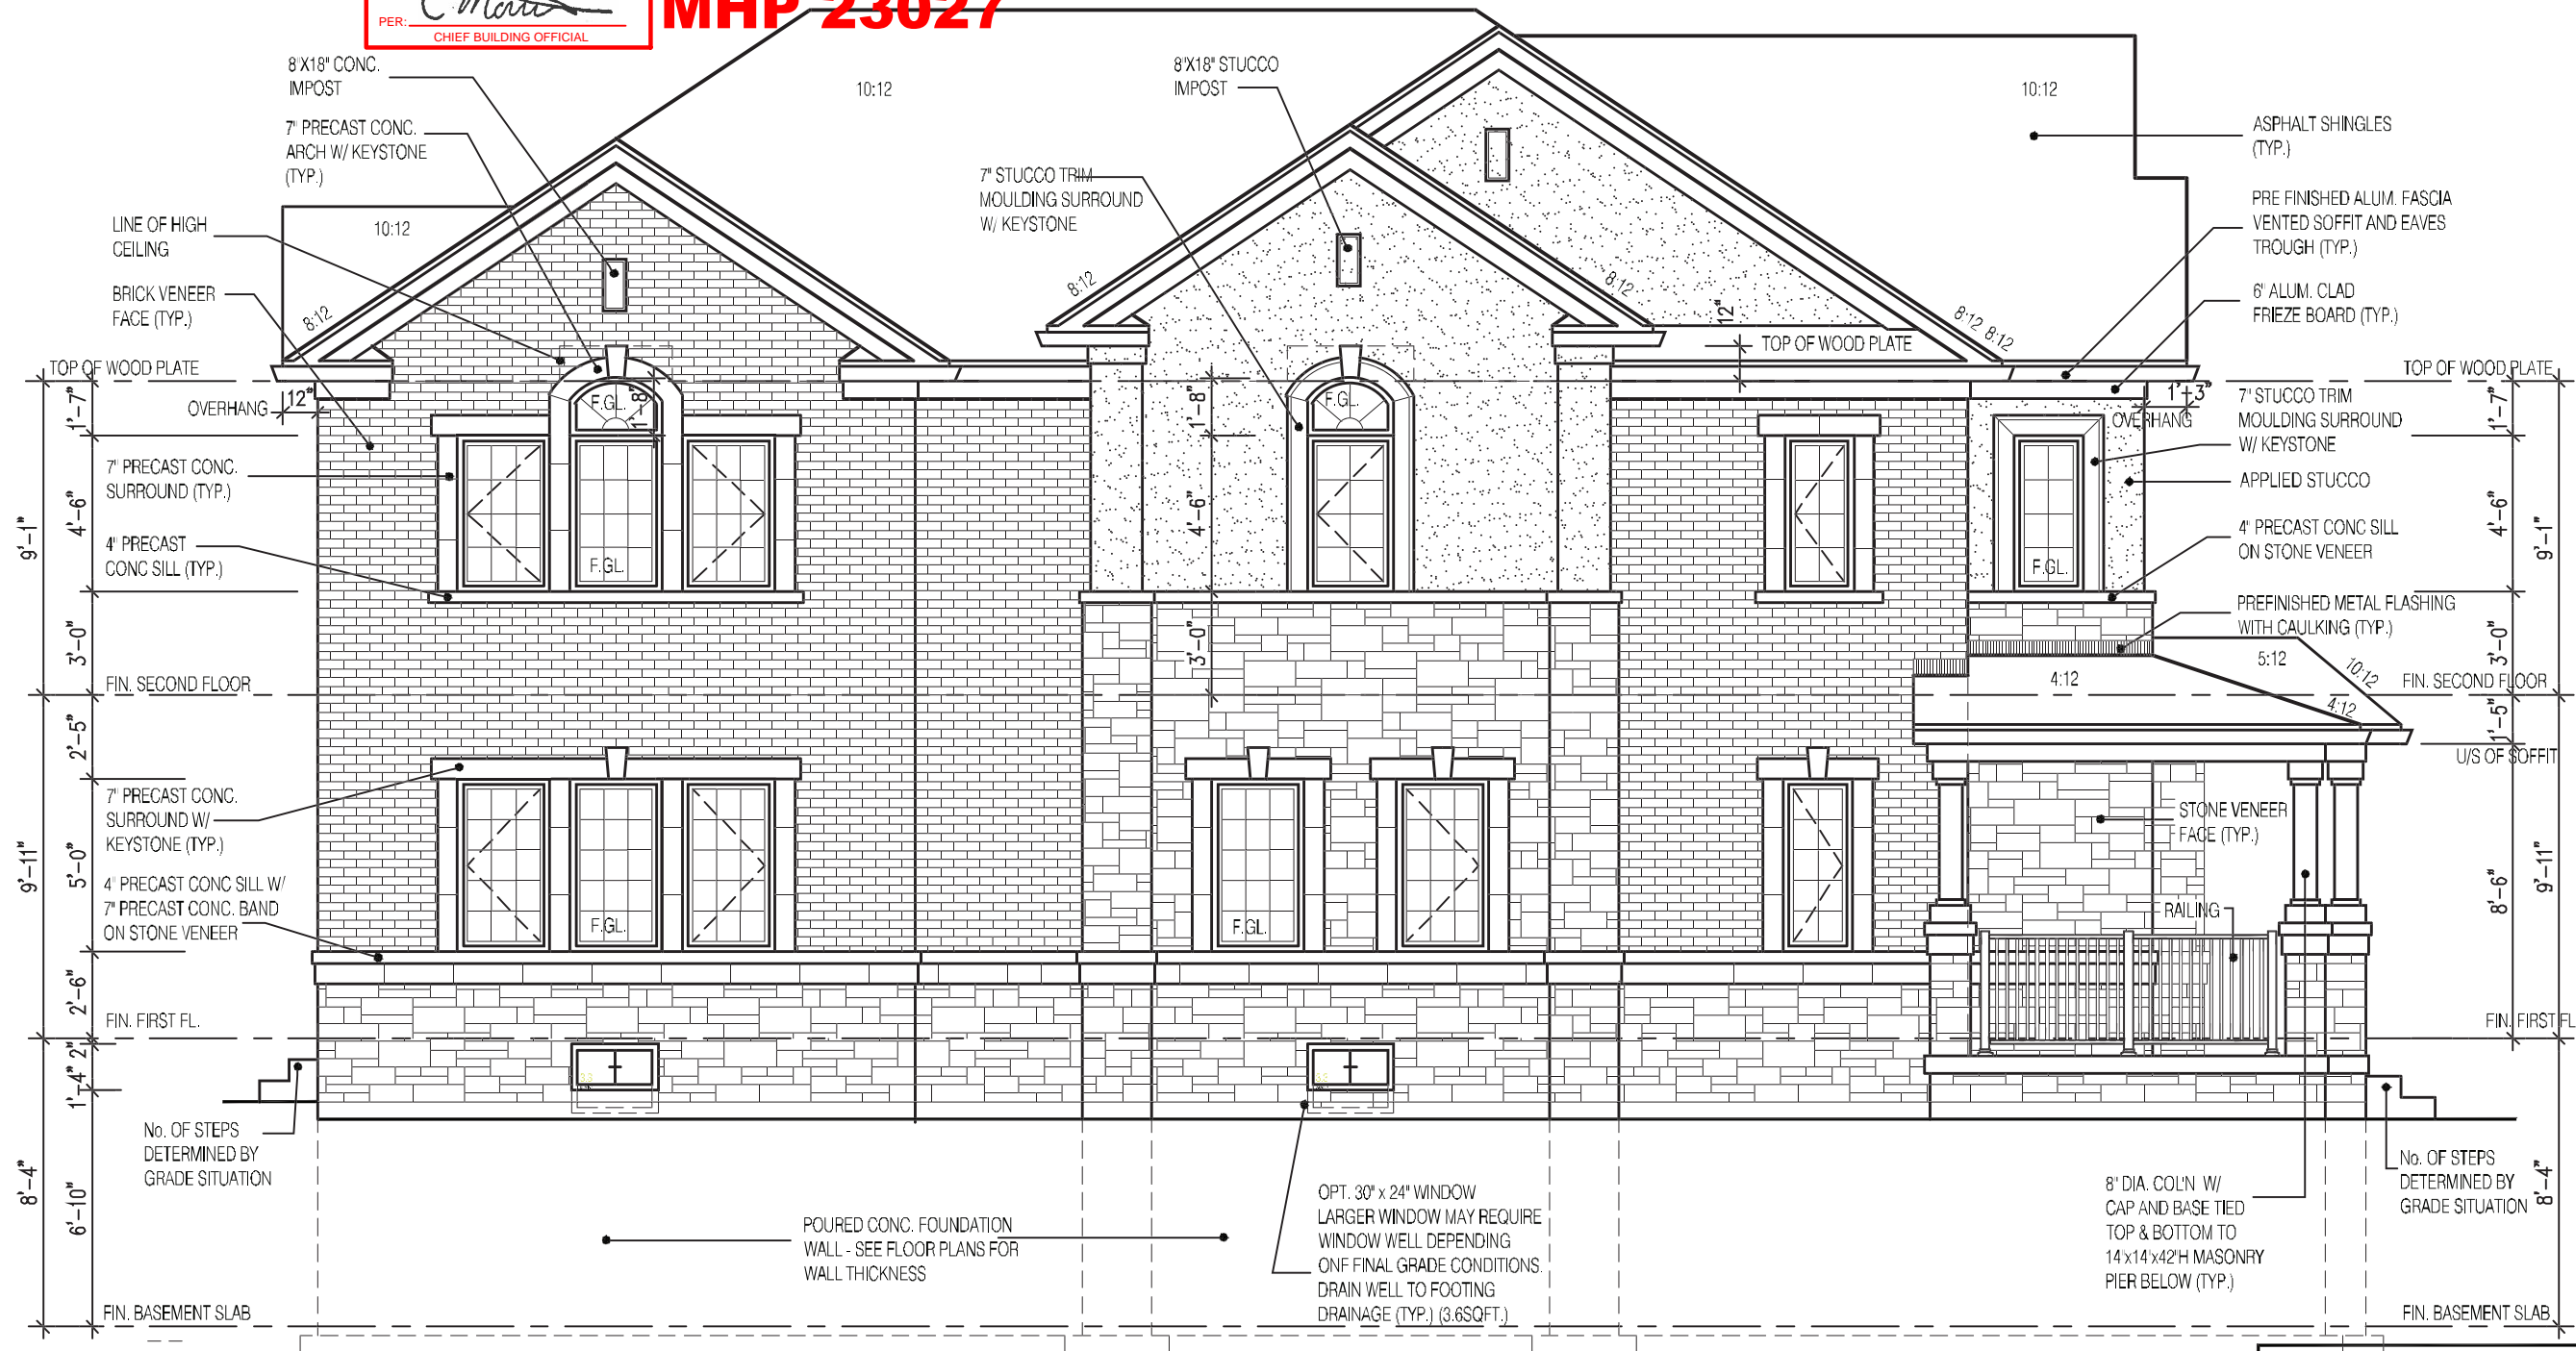

## RIVER 11 FLANKAGE ELEVATION 2

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ARCHITECTURAL CONTROL REVIEW  
AND APPROVAL  
APPROVED BY: *[Signature]*  
DATE: JUL 31, 2023  
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2139  
CORNER LOT 6  
RIVER 11 (GR)  
ELEVATION 2  
A1 PACKAGE  
O.REG. 332/12

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1	FEB. 14, 2023	ADDED DRAWING TO SET

No: DATE: WORK DESCRIPTION:

**jardin**  
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64 JARDIN DR. SUITE 3A  
VAUGHAN ONT. L4K 3P3  
TEL: 905 660-3377 FAX: 905 660-3713  
EMAIL: info@jardindesign.ca

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Walter Botter *[Signature]* 21031  
NAME SIGNATURE BCIN

REGISTRATION INFORMATION  
Required unless design is exempt under Division C, Subsection 3.2.4 of the building code.

jardin design group inc. 27763  
FIRM NAME BCIN


FLANKAGE ELEVATION 2

ZADORRA ESTATE INC.  
CITY OF OSHAWA

MODEL: RIVER 11  
SCALE: 3/16" = 1'-0"  
PROJ. No. 22-16 DWG. No. 5A



MHP 23027

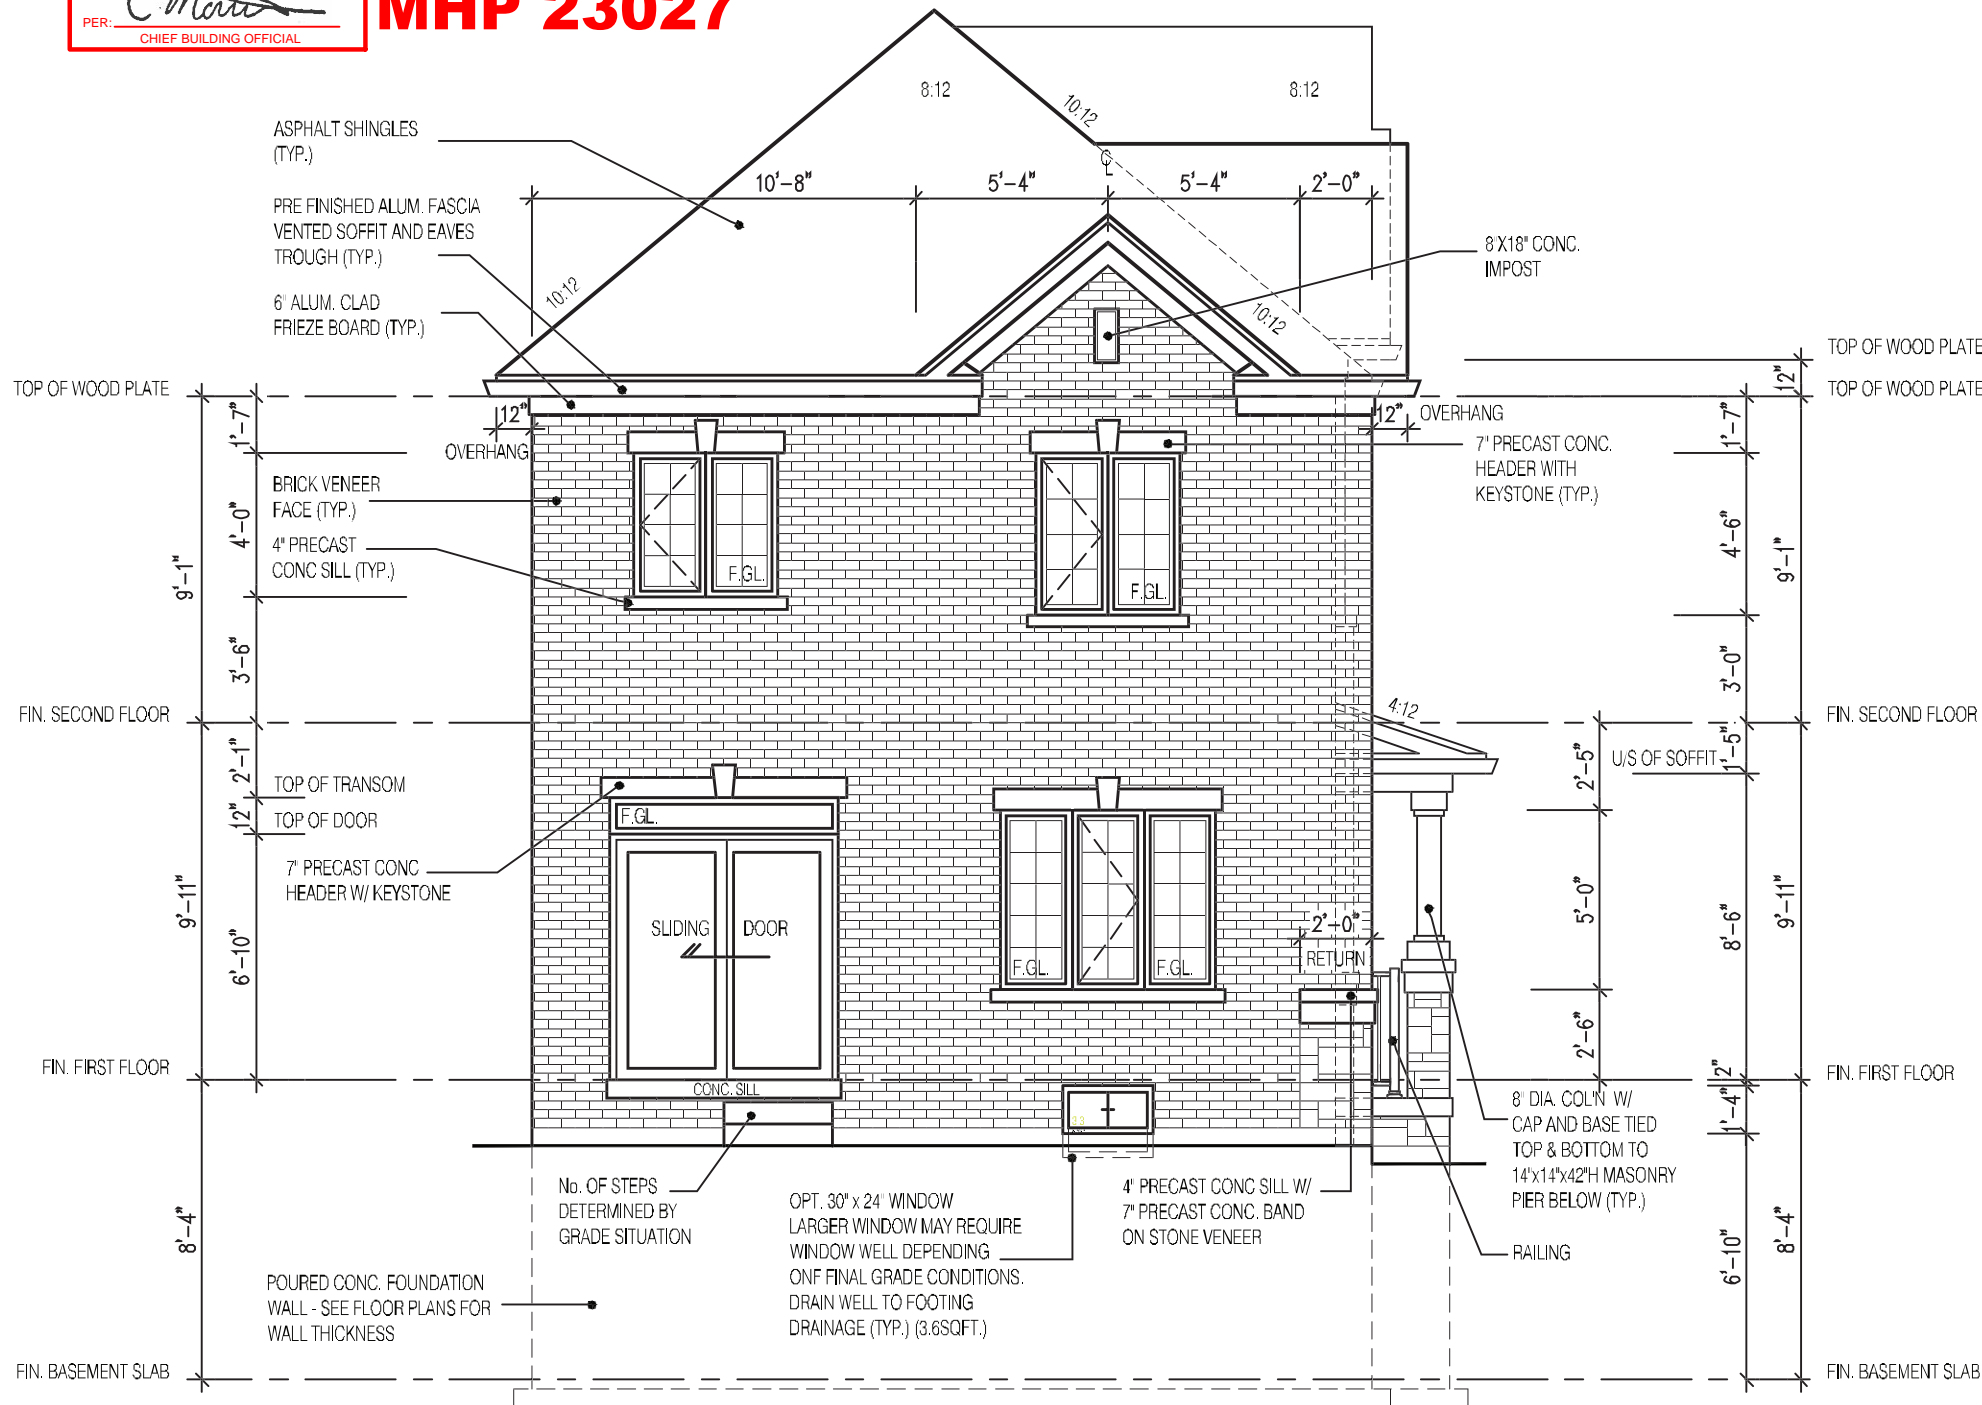

REAR ELEVATION 2  
UPGRADE

2139  
CORNER LOT 6  
RIVER 11 (GR)  
ELEVATION 2  
A1 PACKAGE  
O.REG. 332/12

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Walter Botter *Walter Botter* 21031  
NAME SIGNATURE BCIN

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jardin design group inc. 27763  
FIRM NAME BCIN

REAR ELEVATION 2  
ZADORRA ESTATE INC.  
CITY OF OSHAWA

MODEL: RIVER 11  
SCALE: 3/16" = 1'-0"  
PROJ. No. 22-16 DWG. No. 6A

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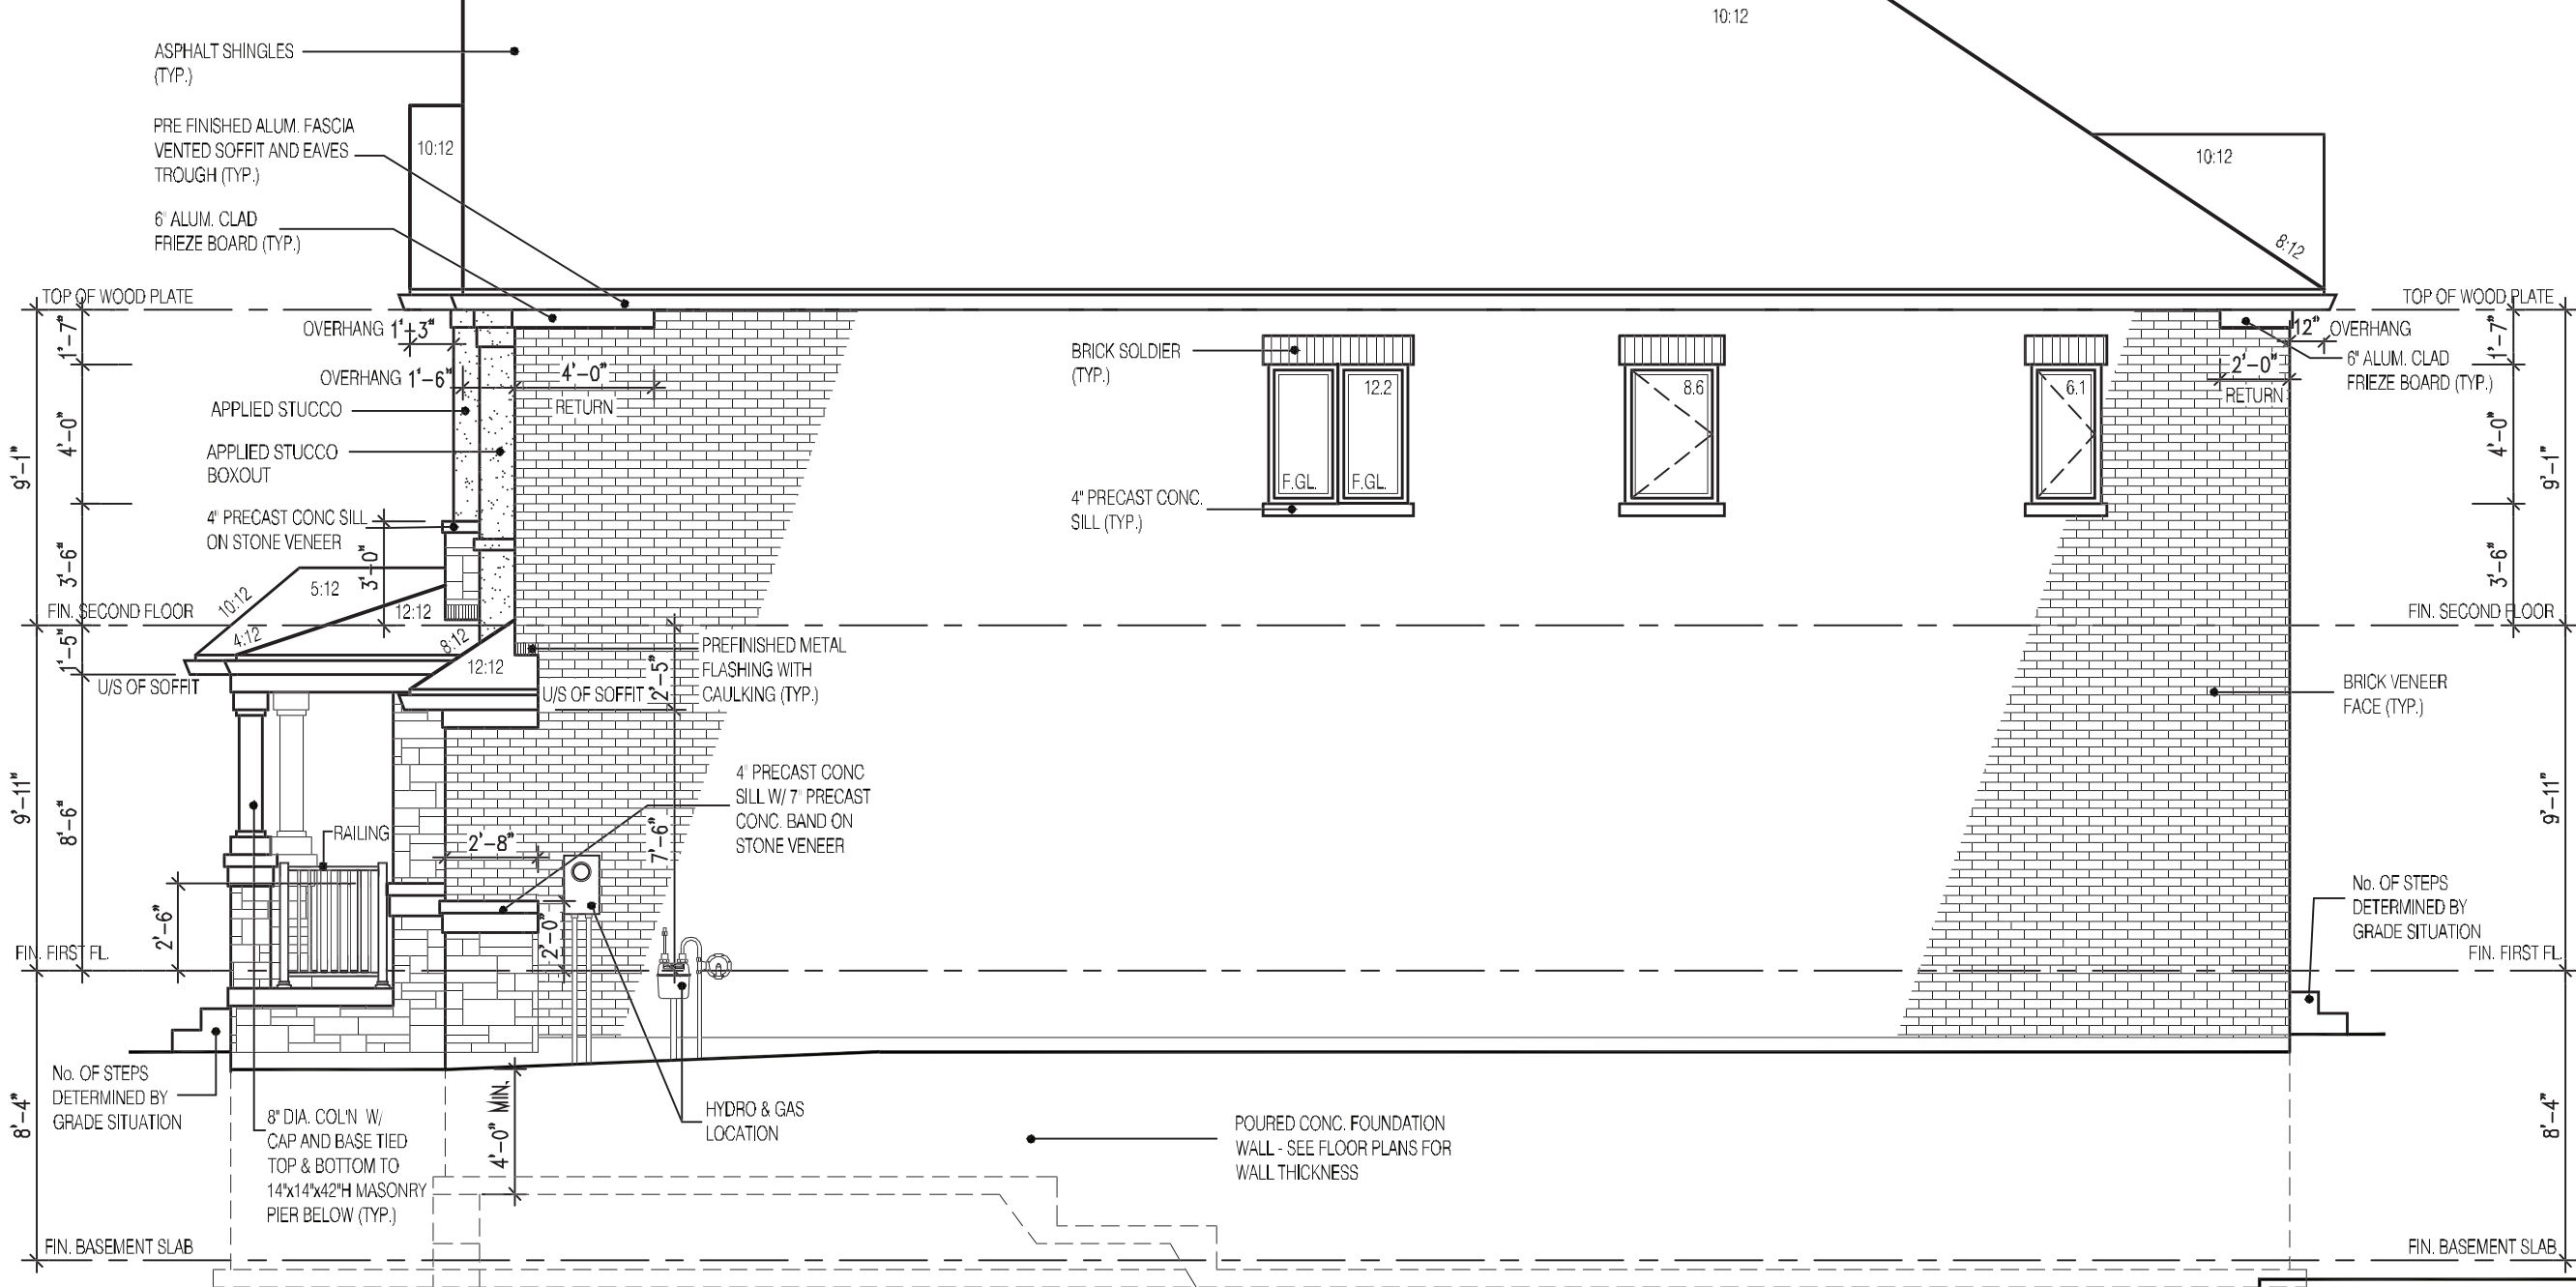
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TRUE COPY  
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Nov 16 2023  
PER: *C. Morris*  
CHIEF BUILDING OFFICER

MHP 23027



SIDE ELEVATION 2  
UNPROTECTED OPENINGS

WALL AREA  
ALLOWABLE WINDOW AREA @ 7.0% (1.2m SIDEYARD)  
ACTUAL GLAZED AREA

1111  $\Phi$   
77.8  $\Phi$   
26.9  $\Phi$  ✓

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2139  
CORNER LOT 6  
RIVER 11 (GR)  
ELEVATION 2  
A1 PACKAGE  
O.REG. 332/12

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2	MAR. 1, 2023	PREPARED TO PRE-COORDINATION STAGE & ISSUED TO CLIENT
1	FEB. 14, 2023	ADDED DRAWING TO SET

No: DATE: WORK DESCRIPTION:

**jardin**  
DESIGN GROUP INC  
64 JARDIN DR. SUITE 3A  
VAUGHAN ONT. L4K 3P3  
TEL: 905 660-3377 FAX: 905 660-3713  
EMAIL: info@jardindesign.ca

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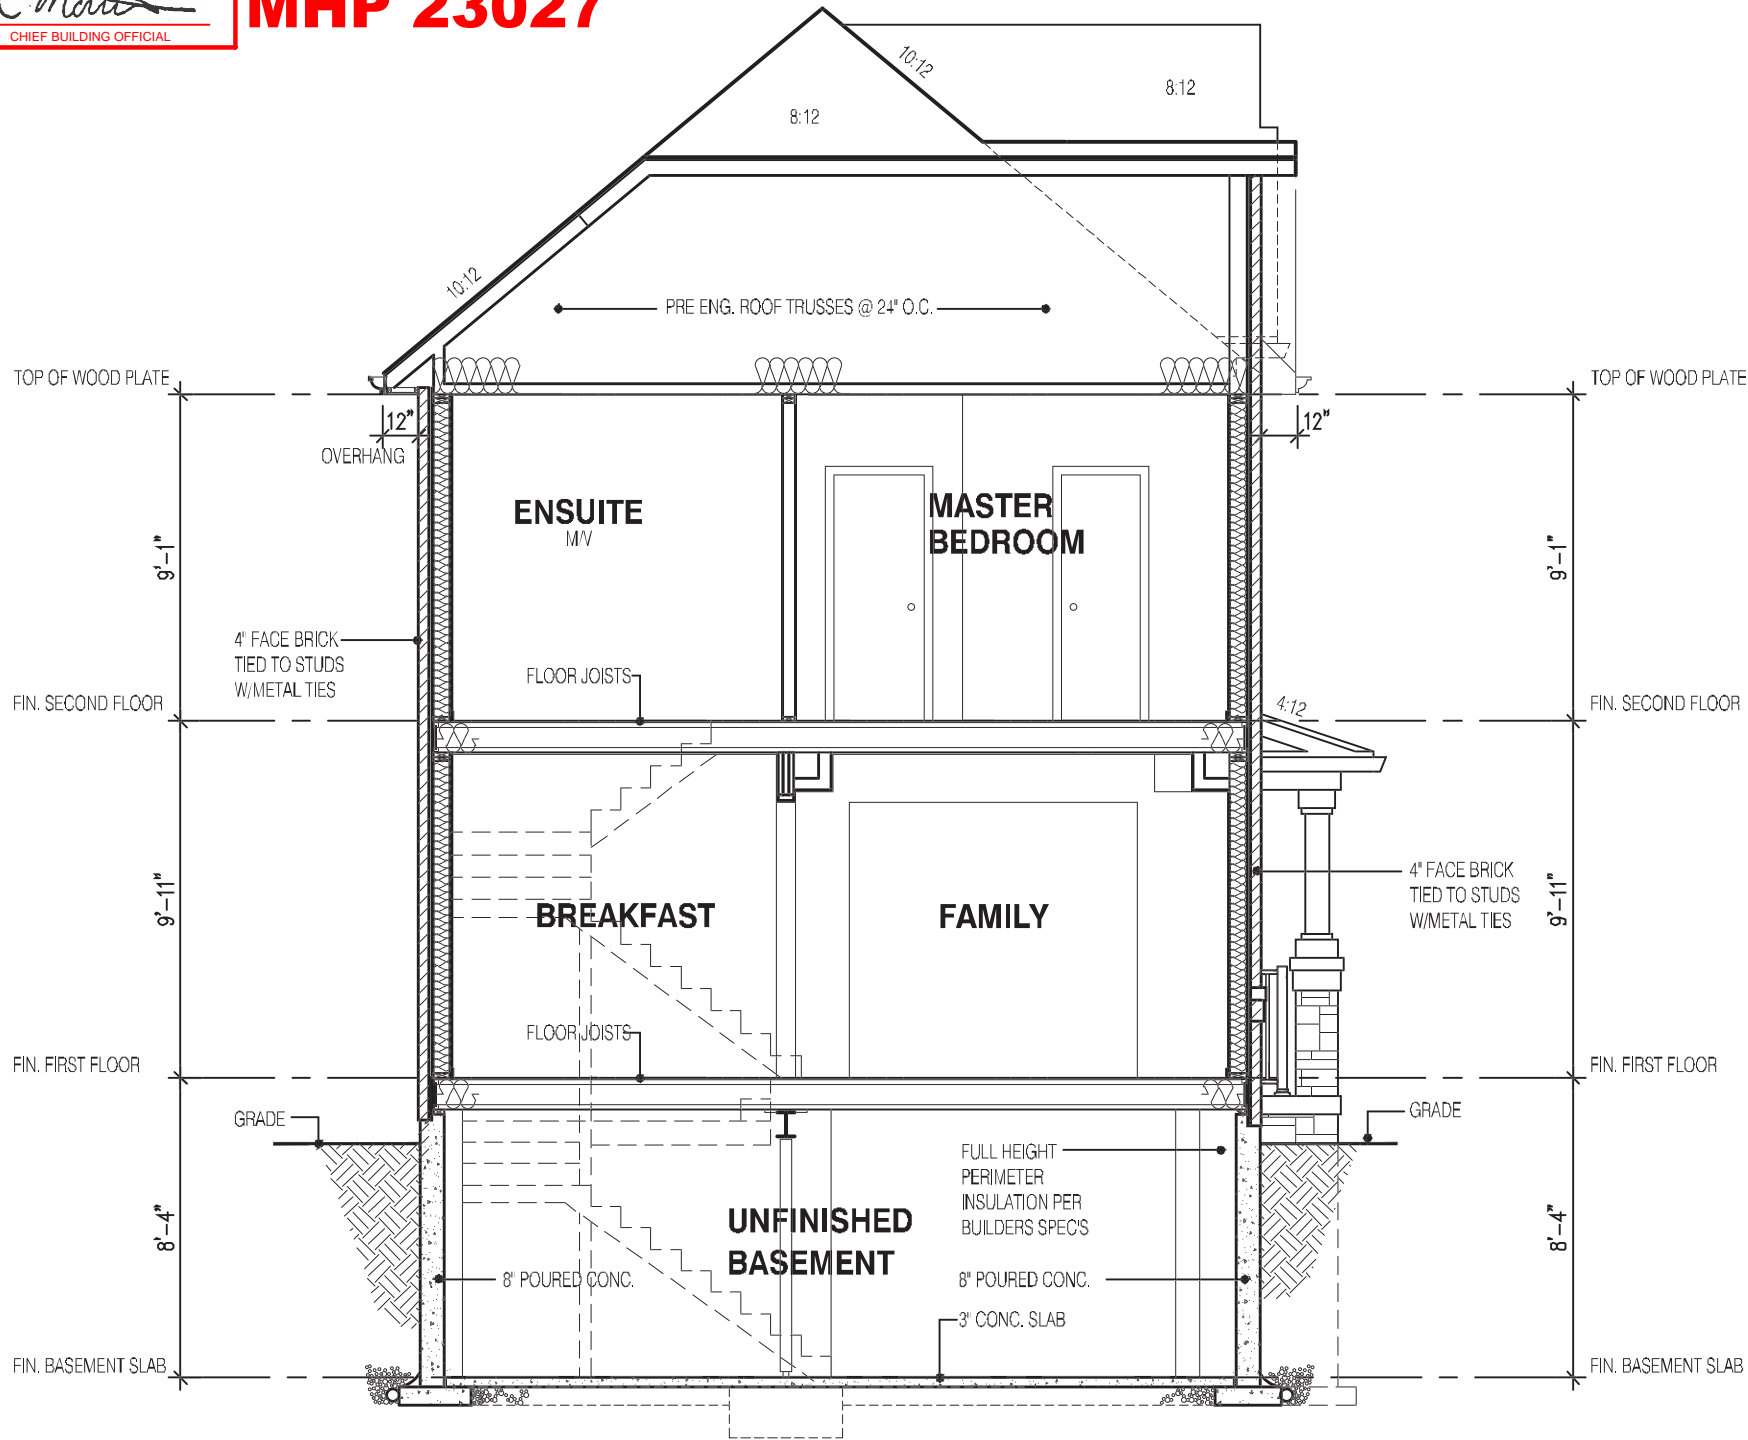
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jardin design group inc. 27763  
FIRM NAME BCIN

SIDE ELEVATION 2  
ZADORRA ESTATE INC.  
CITY OF OSHAWA

MODEL: RIVER 11  
SCALE: 3/16" = 1'-0"  
PROJ. No. 22-16 DWG. No. 7A

MHP 23027



SECTION A ELEVATION 2

STRUDET INC.



FOR STRUCTURE ONLY

2139  
CORNER LOT 6  
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SECTION A ELEV-2  
ZADORRA ESTATE INC.  
CITY OF OSHAWA

MODEL: RIVER 11  
SCALE: 3/16"=1'-0"  
PROJ. No. 22-16 DWG. No. 8A

It is the builder's complete responsibility to ensure that all plans submitted for approval fully comply with the Architectural Guidelines and all applicable regulations and requirements including zoning provisions and any provisions in the subdivision agreement. The Control Architect is not responsible in any way for examining or approving site (lotting) plans or working drawings with respect to any zoning or building code or permit matter or that any house can be properly built or located on its lot.

This is to certify that these plans comply with the applicable Architectural Design Guidelines approved by the City of Oshawa