STRIP FOOTINGS FOR SINGLES AND SEMIS UP TO 2 STOREY

P.ENG SOILS REPORT IS REO'D TO CONFIRM BEARING CAPACITY OF SOILS. SEE FIELD INSPECTOR

120 KPa NATIVE SOIL

20'x6" CONCRETE STRIP FOOTINGS BELOW FOUNDATION WALLS. 24'x8' CONCRETE STRIP FOOTINGS BELOW PARTY WALLS.

90 KPa ENGINEERED FILL SOIL

24'x8" CONCRETE STRIP FOOTINGS WITH REINFORCING BELOW FOUNDATION WALLS, 30'x8" CONCRETE STRIP FOOTINGS WITH REINFORCING BELOW PARTY WALLS.

100 KPa NATIVE SOIL

22'x8" CONCRETE STRIP FOOTINGS BELOW FOUNDATION WALLS. 28"x10" CONCRETE STRIP FOOTINGS BELOW PARTY WALLS 28'x8' CONCRETE STRIP FOOTINGS WITH REINFORCING BELOW PARTY WALLS

GENERAL NOTE

ASSUMED 120/100 KPa NATIVE SOIL BEARING CAPACITY OR 90 KPa FOR ENGINEERED FILL. TO BE VERIFIED ON SITE, REFER TO ENGINEERED FILL FOOTING DETAIL FOR REINFORCEMENT.

(REFER TO ENG. FILL FOOTING DETAIL)

AREA CALCULATIONS EL-1

FIRST FLOOR AREA = 1088 Sq. Ft. SECOND FLOOR AREA = 1312 Sq. Ft. TOTAL FLOOR AREA = 2400 Sq. Ft. ADD OPEN AREAS 0 Sq. Ft ADD FIN. BASEMENT AREA 0 Sq. Ft. = 2400 sg. Ft. GROSS FLOOR AREA

GROUND FLOOR COVERAGE = 1088 Sq. Ft. GARAGE COVERAGE / AREA = 242 Sa. Ft PORCH COVERAGE / AREA 62 Sq. Ft. = 1392 Sq. Ft. COVERAGE W/ PORCH = 129.32 Sa. m.

= 1330 Sq. Ft. COVERAGE W/O PORCH = 123.56 Sq. m.

AREA CALCULATIONS EL-2

ELEVATION

RONT

FET SIDE

RIGHT SIDE

FIRST FLOOR AREA 1088 Sq. Ft. SECOND FLOOR AREA = 1312 Sq. Ft. TOTAL FLOOR AREA 2400 Sq. Ft. ADD OPEN AREAS 0 Sq. Ft. ADD FIN. BA\$EMENT AREA 0 Sq. Ft. = 2400 Sq. Ft. GROSS FLOOR AREA GROUND FLOOR COVERAGE = 1088 Sq. Ft. GARAGE COVERAGE / AREA = 242 Sq. Ft. PORCH COVERAGE / AREA 62 Sq. Ft.

= 1392 Sq. Ft. COVERAGE W/ PORCH = 129.32 Sq. m. = 1330 Sq. Ft. COVERAGE W/O PORCH = 123.56 Sq. m.

AREA CALCULATIONS EL-3

FIRST FLOOR AREA = 1088 Sq. Ft. SECOND FLOOR AREA = 1327 Sq. Ft. = 2415 Sq. Ft. TOTAL FLOOR AREA ADD OPEN AREAS 0 Sq. Ft. ADD FIN, BASEMENT AREA 0 Sq. Ft. = 2415 Sq. Ft. GROSS FLOOR AREA GROUND FLOOR COVERAGE = 1088 Sa. Ft

GARAGE COVERAGE / AREA = 241 Sq. Ft. PORCH COVERAGE / AREA 62 Sq. Ft. = 1391 Sq. Ft. COVERAGE W/ PORCH = 129.23 Sq. m.

= 1329 Sq. Ft. COVERAGE W/O PORCH $= 123.47 \, \text{Sq. m.}$

OPENING FT²

83.24

102.14

0.00

121,27

200.05

307.41

WALL FT²

523.40

1216.65

1196,36

494,79

2424.00

3461.23

ENERGY EFFICIENCY- A1 PACKA

PERCENTAGE

15,90 %

8,40 %

0.00%

24.51 %

0.04.0/

8.88 %

8 92 %

ENERGY EFFICIENCY- A1 PACKA

O.REG. 332/12

HE CONTRACTOR SHALL CHECK AND VERIFY ALL DIVIENSIONS AN

CONDITIONS ON SITE BEFORE PROCEEDING WITH CONSTRUCTION. DISCREPANCIES SHALL BE REPORTED TO JARDIN DESIGN GROUPRIOR TO COMMENCEMENT OF WORK. JARDIN DESIGN GROUP INC. IS NOT RESPONSIBLE FOR THE ACCURAC OF SURVEY, STRUCTURAL OR ENGINEERING INFORMATION SHOWN OF

HESE DRAWINGS OR FOR CONSTRUCTION STARTED PRIOR TO THE

SUANCE OF A BUILDING PERMIT. REFER TO THE APPROPRIATE

AS CONSTRUCTED INVERTS MUST BE VERIFIED PRIOR TO POURING

JARDIN DESIGN GROUP INC. HAS NOT BEEN RETAINED TO CARRY OU GENERAL REVIEW OF THE WORK AND ASSUVES NO RESPONSIBILITY FOR THE FALLIPE OF THE CONTRACTOR OR SUB CONTRACTOR TO

THIS DRAWING IS AN INSTRUMENT OF SERVICE. IS PROVIDED BY AND I

IE PROPERTY OF JARDIN DESIGN GROUP INC. THIS DRAWING IS NO

AUG. 10, 2022 ISSUED FOR BUILDING PERMIT

COORDINATED FLOOR, ROOF AND

PREPARED TO PRE-COORDINATION

WORK DESCRIPTION:

NGINEER COMMENTS REVISED AS PER CLIENT COMMEN

& RE-ISSUED TO CHENT

STAGE & ISSUED TO CLIENT

REVISED AS PER CLIENT &

SSUED FOR BROCHURE

SUED TO CLIENT FOR

PRELIMINARY REVIEW

DESIGN GROUP INC

64 JARDIN DR. SUITE 3A

VAUGHAN ONT, L4K 3P3

EL: 905 660-3377 FAX: 905 660-3713

EMAIL: info@iardindesian.ca

he undersigned has reviewed and takes responsibility

or this design and has the qualifications and meets the

equirements set out in the Ontario Building Code to be

ARRY OUT THE WORK IN ACCORDANCE WITH THE CONTRACT

D BE SCALED

AUG. 3, 2022

JUN. 2, 2022

MAY 10, 2022

MAR. 23, 2022

JAN. 26, 2022

DATE:

NGINEERING DRAWINGS BEFORE PROCEEDING WITH WORK.

2400

9.14m LOTS

GARDEN 3 (GR)

ELEVATION 1, 2 & 3

A1 PACKAGE

PAD FOOTING

120 KPa NATIVE SOI 90 KPa ENGINEERED FILL SOIL 100 KPa NATIVE SOII F1 = 42"x42"x18" CONCRETE PAD F1 = 48'x48"x20" CONCRETE PAD F1 = 46'x46'x20' CONCRETE PAD F2 = 40"x40"x16" CONCRETE PAD F2 = 36"x36"x16" CONCRETE PAD F2 = 38"x38"x16" CONCRETE PAD F3 = 30'x30'x12" CONCRETE PAD F3 = 34"x34"x14" CONCRETE PAD F3 = 32'x32'x14' CONCRETE PAD F4 = 26'x26'x12' CONCRETE PAD F4 = 24'x24'x12'' CONCRETE PAD F4 = 28"x28"x12" CONCRETE PAD F5 = 16'x16'x8" CONCRETE PAD F5 = 17"x17"x8" CONCRETE PAD F5 = 18"x18"x8" CONCRETE PAD

NOTE:

WHEN VENEER CUT IS GREATER THAN 26" A 10" POURED CONC. FOUNDATION WALL IS REQUIRED.

NOTE:

ALL GARAGE SLABS, PORCH SLABS, STAIRS (EXPOSED CONC. FLAT WORK) TO BE 32 MPa WITH 5-8% AIR ENTRAITMENT.

BRICK VENEER LINTELS:

(REFER TO FLOOR PLAN FOR UNUSUAL SIZE PADS NOT ON CHART

 $WL1 = 3 \frac{1}{2} \times 3 \frac{1}{2} \times 1\frac{4}{90} \times 90 \times 6 + 2 \cdot 2^{n} \times 8^{n} SPR.$ $WL2 = 4'' \times 3 1 \times 15'' \times 5 \times 16'' \times 100 \times 100$ $WL3 = 5'' \times 3 \times 1^{2}'' \times 5 \times 16'' \times 125 \times 90 \times 8) + 2 - 2'' \times 10'' \text{ SPR}.$ $WL4 = 6'' \times 3 1 \times 2'' \times 3 \times 3'' (150 \times 90 \times 10) + 2 - 2'' \times 12'' SPR.$ WL5 = 6" x 4" x 3\8" {150x100x10} + 2-2" x 12" SPR.

 $WL6 = 5'' \times 3 1 \times 15'' \times 15'' \times 12'' \times 12'$ $WL7 = 5'' \times 3 \times 12'' \times 5 \times 16'' \times 125 \times 90 \times 8) + 3 - 2'' \times 10'' SPR.$ $WL8 = 5'' \times 3 \frac{1}{2}'' \times \frac{5}{16}'' (125 \times 90 \times 8) + 3 - 2'' \times 12'' SPR$ $WL9 = 6" \times 4" \times 3 \times (150 \times 100 \times 10) + 3 - 2" \times 12" SPR.$

WOOD LINTELS:

WB6 = 3-2" x 12" SPRUCE BEAM WB1 = 2-2"x8" SPRUCE BEAM WB2 = 3-2"x8" SPRUCE BEAM WB7 = 5-2" x 12" SPRUCE BEAM WB10 = 4-2" x 8" SPRUCE BEAM WB3 = 2-2" x 10" SPRUCE BEAM WB4 = 3-2" x 10" SPRUCE BEAM WB11 = 4-2" x 10" SPRUCE BEAM WB5 = 2-2" x 12" SPRUCE BEAM

STEEL LINTELS:

 $L1 = 3.1 \times 3.1 \times 1.14$ (90 x 90 x 6) L4 = 6 x 3.1 \(\text{2"} \text{ x 3\8'} \) (150 x 90 x 10) $L2 = 4^{\circ} \times 3 \times 1/2^{\circ} \times 5/16^{\circ} (100 \times 90 \times 8)$ $L5 = 6^{\circ} \times 4^{\circ} \times 3/8^{\circ} (150 \times 100 \times 10)$ L3 = 5" x 3 1\2" x 5\16" (125 x 90 x 8) L6 = 7" x 4" x 3\8" (180 x 100 x 10)

LAMINATED VENEER LUMBER (LVL BEAMS)


LVL1A = 1-1 3/4" x 7 1/4" (1-45x184) $LVL1 = 2-13/4" \times 71/4" (2-45x184)$ $LVL2 = 3-13/4" \times 71/4" (3-45\times184)$ $IV|3 = 4-1.3/4" \times 7.1/4" (4-45x184)$ LVL4A = 1-1 3/4" x 9 1/2" (1-45x240) $LVL4 = 2-1 3/4" \times 9 1/2" (2-45x240)$ $LVL5 = 3-1 3/4" \times 9 1/2" (3-45x240)$ $LVL5A = 4-1 3/4" \times 9 1/2" (4-45x240)$ LVL6A= 1-1 3/4" x 11 7/8" (1-45x300) $LVL6 = 2-1 3/4" \times 11 7/8" (2-45x300)$

 $LVL7 = 3-13/4" \times 117/8" (3-45x300)$

LVL7A= 4-1 3/4" x 11 7/8" (4-45x300) LVL8 = 2-1 3/4" x 14" (2-45x356) LVL9 = 3-1 3/4" x 14" (3-45x356)

NOT THE GRANTING OF A PERMIT NOR REVIEWING OF SPECS & DRAWINGS NOR INSPECTIONS MADE DURING INSTALLATION BY THE OFFICIAL HAVING TURISDICTION SHALL RELIEVE THE OWNER FROM REQUIREMENTS OF THE ONTARIO BUILDING CODE AND ANY OTHER REFERENCED REQUIREMENTS.


2-2"x6" STUD WALL NAILED TOGETHER AND SPACED @12" O.C. FULL HT C/W SOLID BLOCKING 41-0" O.C. VERTICAL AND 7/16" EXT. PLYWOOD SHEATHING.

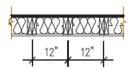

MAXIMUM HEIGHT OF WALL FOR THIS DETAIL IS 18-0" AND MAXIMUM SUPPORTED LENGTH OF TRUSS IS 40'-0"

TWO STOREY HEIGHT WALL

2 - 1 1/2" x 5 1/2" TIMBERSTRAND (LSL) 1.5E STUD WALL GLUED AND NAILED TOGETHER AND SPACED MAX. @10'O.C. FULL HT C/W SOLID BLOCKING MAX. 8'-0"O.C. VERTICAL AND 7/16" EXT. OSB SHEATHING.

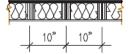

MAXIMUM HEIGHT OF WALL FOR THIS DETAIL IS 20'-2" AND MAXIMUM SUPPORTED LENGTH OF TRUSS IS 40'-0"

GARDEN 3 ELEV1 (3 BEDROOM)	ENERGY EFFICIENCY- A1 PACKAGE				
ELEVATION	WALL FT ²	OPENING FT ²	PERCENTAGE		
FRONT	523.40	83.24	15.90 %		
LEFT SIDE	1216.65	91.50	7.52 %		
RIGHT SIDE	1196.36	0.00	0.00 %		
REAR	494,79	121.27	24.51 %		
TOTAL 3431.20 296.01 8.63 %					
ALL NEW WINDOW	ALL NEW WINDOWS AND SLIDING GLASS DOORS ENERGY PERFORMANCE				

TOTAL 3431.20 290.01 6.03 % TOTAL 3431.20 300.03	0.34 76
TO COMPLY WITH THE THERMAL REQUIREMENTS CEPTIFIED VALUES CHAIL DEMAND ON	CIENCY- A1 PACKAG
FOR REVIEW DURING CONSTRUCTION WALL FT ² OPENING FT ²	PERCENTAGE
FLOORING IN KITCHENS, WASHROOMS, LAUNDRY, AND STORAGE AREAS, SHALL CONSIST OF PROPERTINAL INCORPORATION SIGN STEP	16.31 %
FELTED-SYNTHETIC-FIBRE FLOOR COVERING, DEPOKE FINAL INSPECTION SIGN-OFF 1249.09 102.14	8.18 %
CONCRETE, TILE, OR OTHER FLOORING PROVIDING A SIMILAR WATER RESISTANCE. P.ENG SOILS REPORT MAY BE REQ'D TO CONFIRM BEARING CAPACITY OF 1202.22 0.00	0.00 %
MAX, HOT WATER TEMP, SHALL NOT 121.27 SOILS. SEE FIELD INSPECTOR 494.79 121.27	24.51 %
EXCEED 49°C (120°F) EXCEPT FOR INSTALLATION OF FLUSH STEEL BEAMS	

EXCEED 49°C (120°F) EXCEPT FOR ISHWASHERS AND CLOTHES WASHER HALL CONFORM TO THE REQUIREMENTS OF 296.77 SECTION 9.27 OF DIVISION B OR HAVE A CCMC OR BMEC APPROVAL, OR A MINISTERS RULING DRAWINGS AND SPECIFICATIONS TO BUILDING GY EFF

A SEPARATE PERMIT IS REQUIRED FOR THE FINISHING OF ALL ROUGHIN PLUBMING FIXTURES LOCATED ADJACENT TO SLEEPING AREAS 91.50

MASTER PLAN

OPTIONS: (SAME AS ABOVE PLUS), **SUNKEN**

OUT DECK, WALK OUT DECK/BASEMENT.

FOYER, ALT 2ND FLOOR (4 bedroom), LOOK

ELEVATION: 1

MODEL: GARDEN 3

BEDROOMS: 3

OPENING FT2 PERCENTAGE WALL OR PORCH SLAB SHALL BE 515.06 82.33 15.98 % REVIEWED PRIOR TO POURING CONRET 1222.07 102.14 8.36 % 1198,54 0.00 0.00 % HIGHI SIJE ON EACH FLOOR LEVEL AND WITHIN EACH SLEEPING ROOM. ALL SMOKE 494,79 121.27 24.51 % ALARMS SHALL BE INTERCONNECTED. EACH DEVICE SHALL HAVE A VISUAL SIGNALING COMPONENT IN ADDITION TO THE TEMPORAL PATTERN IN

B. MARINKOVIC

january 16.202

FOR STRUCTURE ONLY

CONFORMANCE WITH 18.5.3. OF "LIGHT, COLOUR AND PULSE CHARACTERISTICS" OF NFPA 72 TOTAL 3428 46 305.74 STRUDET INC. CITY OF CAMBRIDGE **BUILDING DIVISION**

> HESE PLANS have been examined for compliance th the Ontario Building Code Requirements. A Iding Permit is in Order to issue subject to any anges noted under the condition that the building will nstructed in accordance with the code

> > **INSPECTOR**

It is the builder's complete responsibility to ensure that all plans submitted for approva fully comply with the Architectural Guideline and all applicable regulations and requiremen

This is to certify that these plans comp with the applicable Architectural Design Guidelines approved by the City of CAMBRIDGE.

ı designer 2023-03-07 QUALIFICATION INFORMATION quired unless design is execute under Division C, Subsectio DATE 3.2.5 of t Nalter Botter

NAME and am application regulations and requirement including zoning provisions and any provision in the subdivision agreement. The Contr Architect is not responsible in any way fe examining or approving site (lotting) plans; working drawings with respect to any zoning building code or permit matter or that ar house can be properly built or located on its I

REGISTRATION INFORMATION Required unless design is exempt under Division C, Subsection 3.2.4 of the building code

ardin design group inc.

FIRM NAME

TITLE SHEE

BARLASSINA CONSTRUCTION CITY OF CAMBRIDGE



GARDEN 3 (GR) SCALE:

3/16"=1'-0" PROJ. No. WG. No 21-35

27763

TWO STOREY HEIGHT WALL DETAIL

NOTE:

THESE DRAWINGS ARE TO BE READ IN CONJUNCTION WITH ENGINEER APPROVED ROOF TRUSS DRAWINGS BY MANUFACTURER

NOTE:

SPACE CONVENTIONAL FLOOR JOISTS @ 12" O.C. BELOW ALL CERAMIC TILE AREAS, PROVIDE 1 ROW BRIDGING FOR SPANS OF 5'-7', 2 ROWS FOR SPANS GREATER THAN 7'

NOTE:

THESE DRAWINGS ARE TO BE READ IN CONJUNCTION WITH ENGINEER APPROVED FLOOR TRUSS LAYOUT BY MANUFACTURER.


NOTE:


PLANS NOT DRAWN TO ACTUAL GRADE, REFER TO FINAL GRADING PLAN.


Door Schedule


S	NO.	WIDTH HEIGHT 8' TO 9' CEILINGS		HEIGHT 10' OR MORE CEILINGS		TYPE	
1	1	2 ' -10"	6 ^l -8"	(865×2033)	8 <mark>'</mark> -0"	(865×2439)	INSULATED ENTRANCE DOOF
1	1a	2'-8"	6'-8"	(815x2033)	8'-0"	(815x2439)	INSULATED FRONT DOORS
١	2	2'-8"	6'-8"	(815x2033)	8'-0"	(815x2439)	WOOD & GLASS DOOR
ı	3	2'-8"	6'-8 x 1-3/4"	(815x2033x45)	8 ' -0" x 1-3/4"	(815x2439x45)	EXTERIOR SLAB DOOR
1	4	2'-8"	6'-8" x 1-3/8"	(815x2033x35)	8'-0" x 1-3/8"	(815x2439x35)	INTERIOR SLAB DOOR
l	5	2'-6"	6'-8" x 1-3/8"	(760x2033x35)	8'-0" x 1-3/8"	(760x2439x35)	INTERIOR SLAB DOOR
l	6	2'-2"	6'-8" x 1-3/8"	(660x2033x35)	8'-0" x 1-3/8"	(660x2439x35)	INTERIOR SLAB DOOR
	7	1'-6"	6'-8" x 1-3/8"	(460x2033x35)	8'-0" x 1-3/8"	(460x2439x35)	INTERIOR SLAB DOOR
	8	3'-0"	6'-8" x 1-3/8"	(915x2033x35)	8'-0" x 1-3/8"	(915x2439x35)	INTERIOR SLAB DOOR


DRAWING NAME

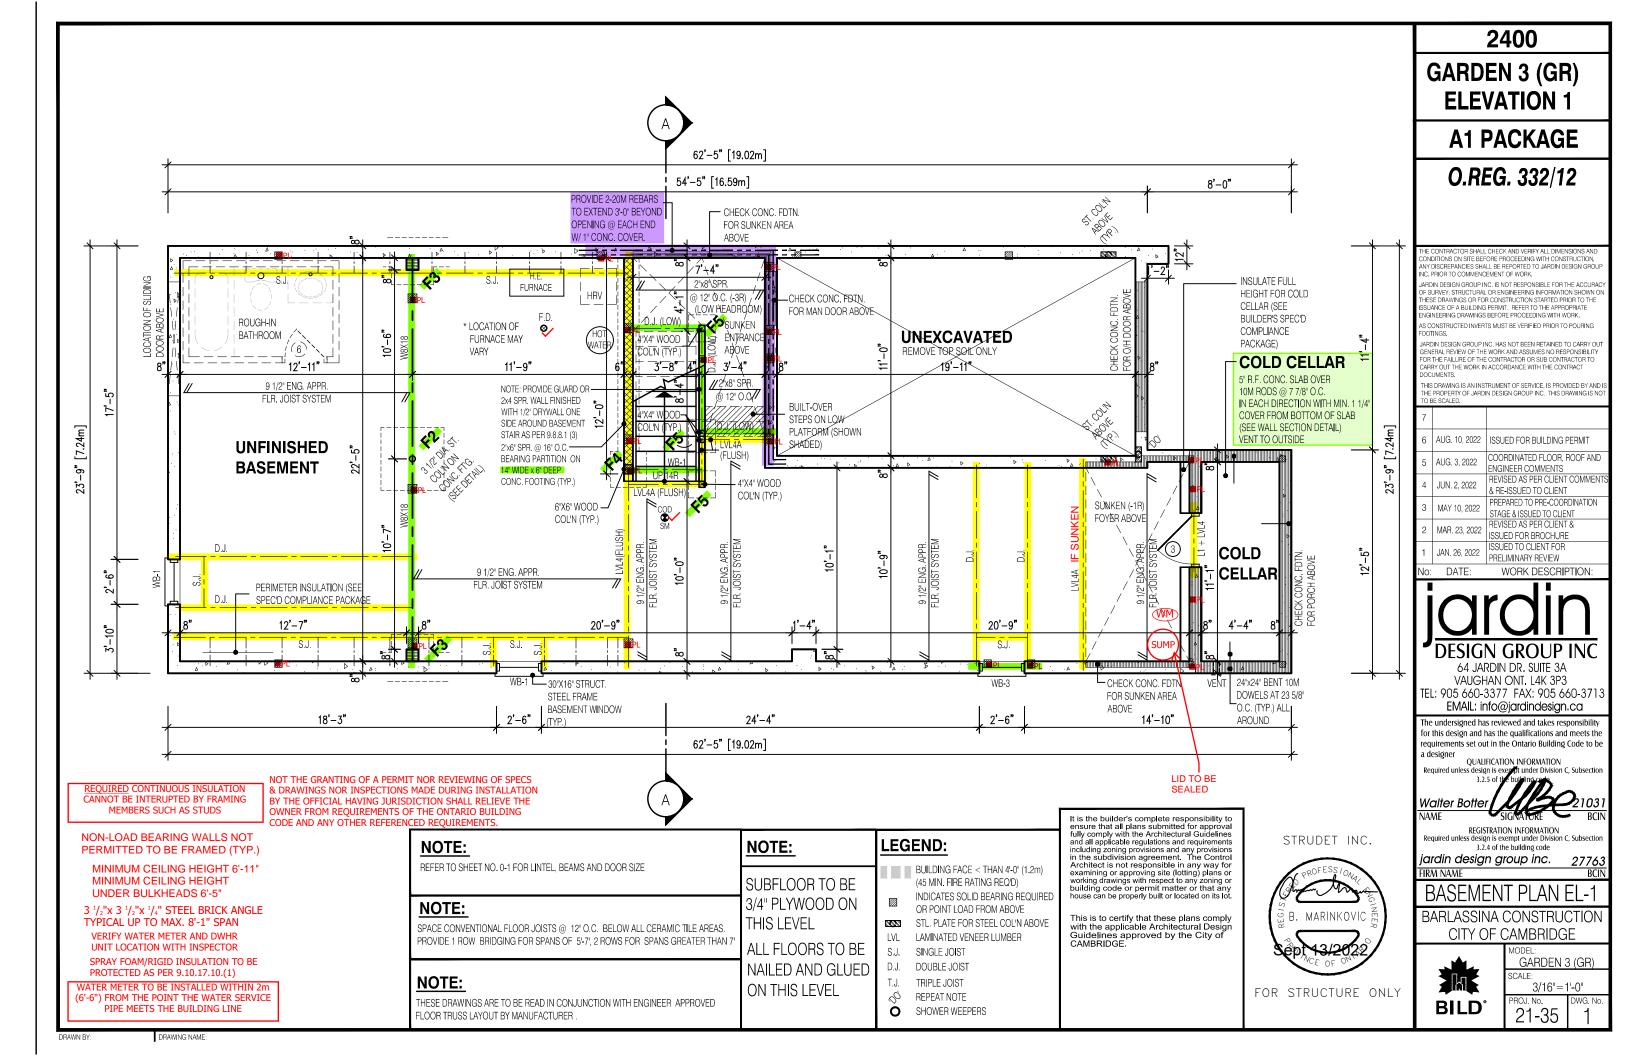

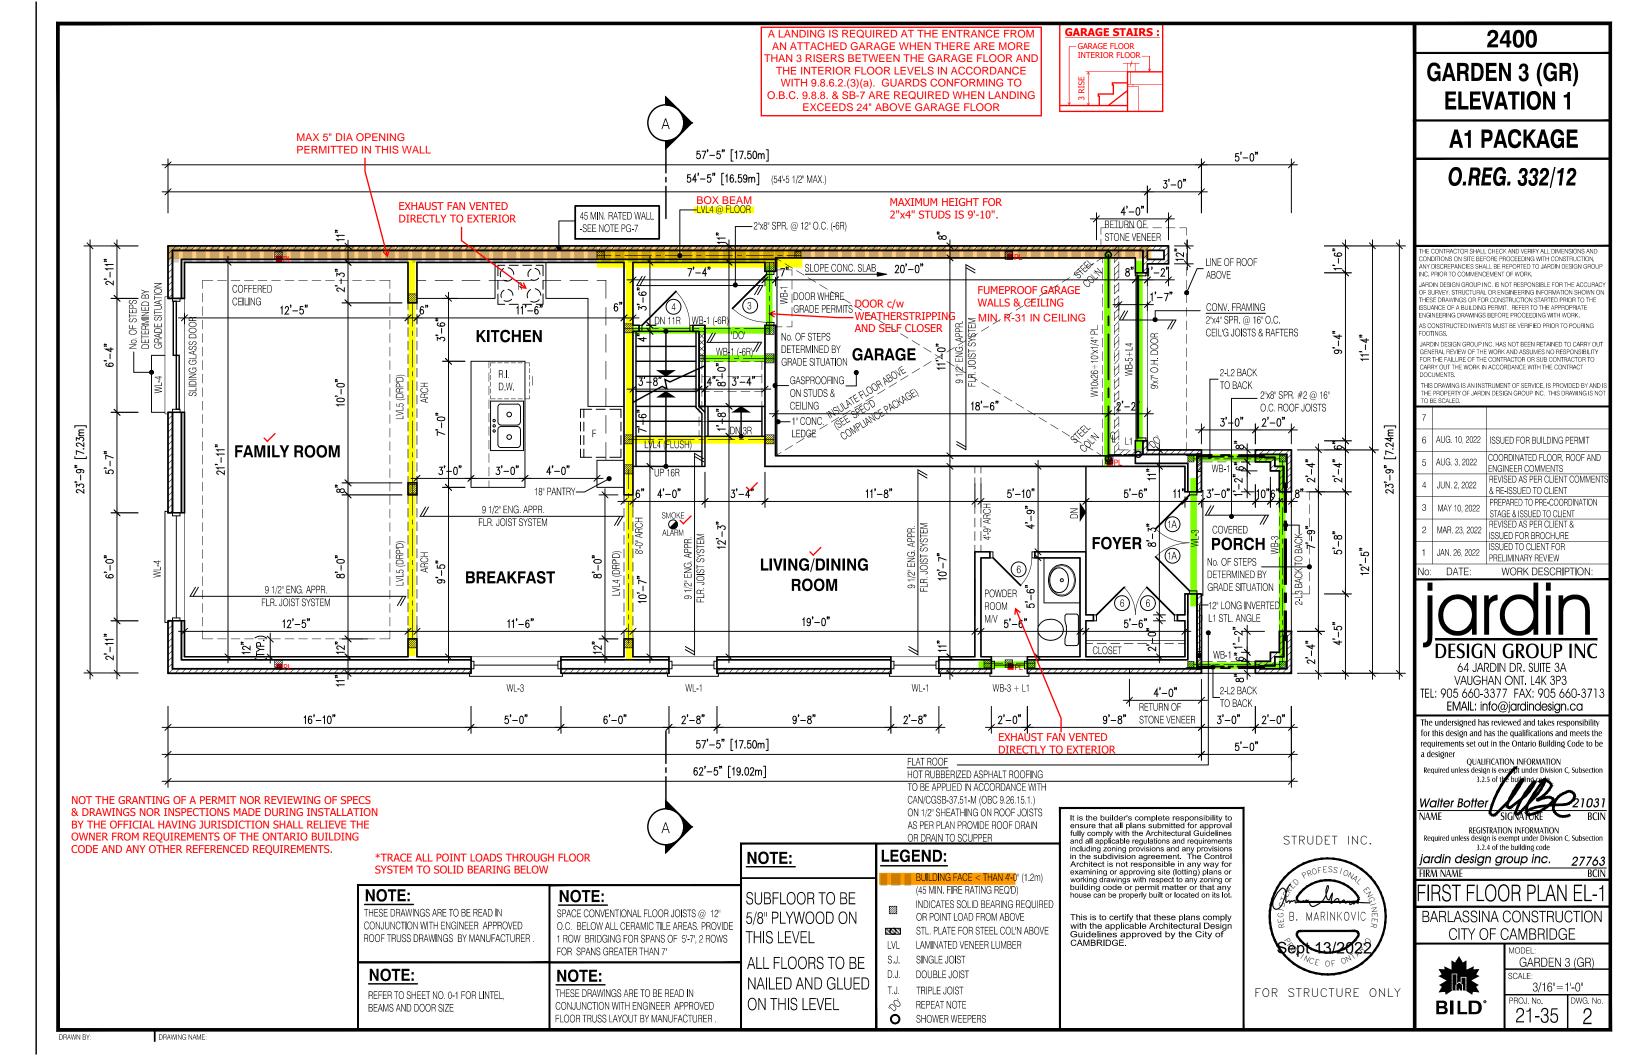

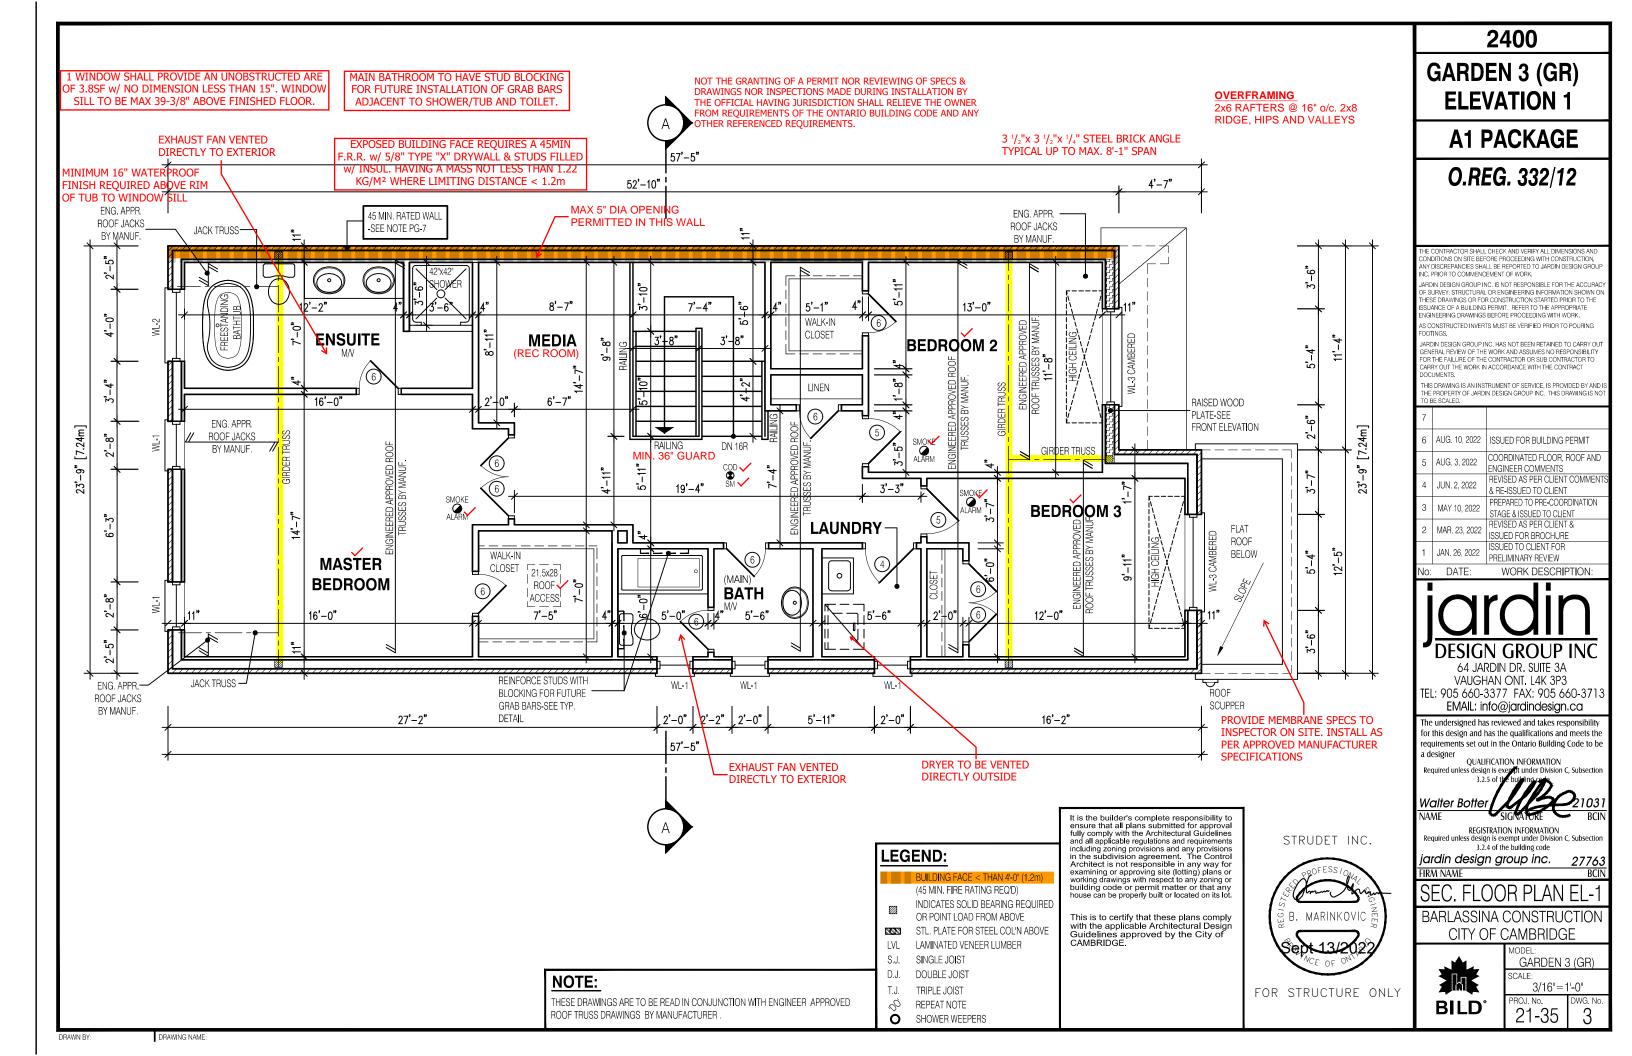

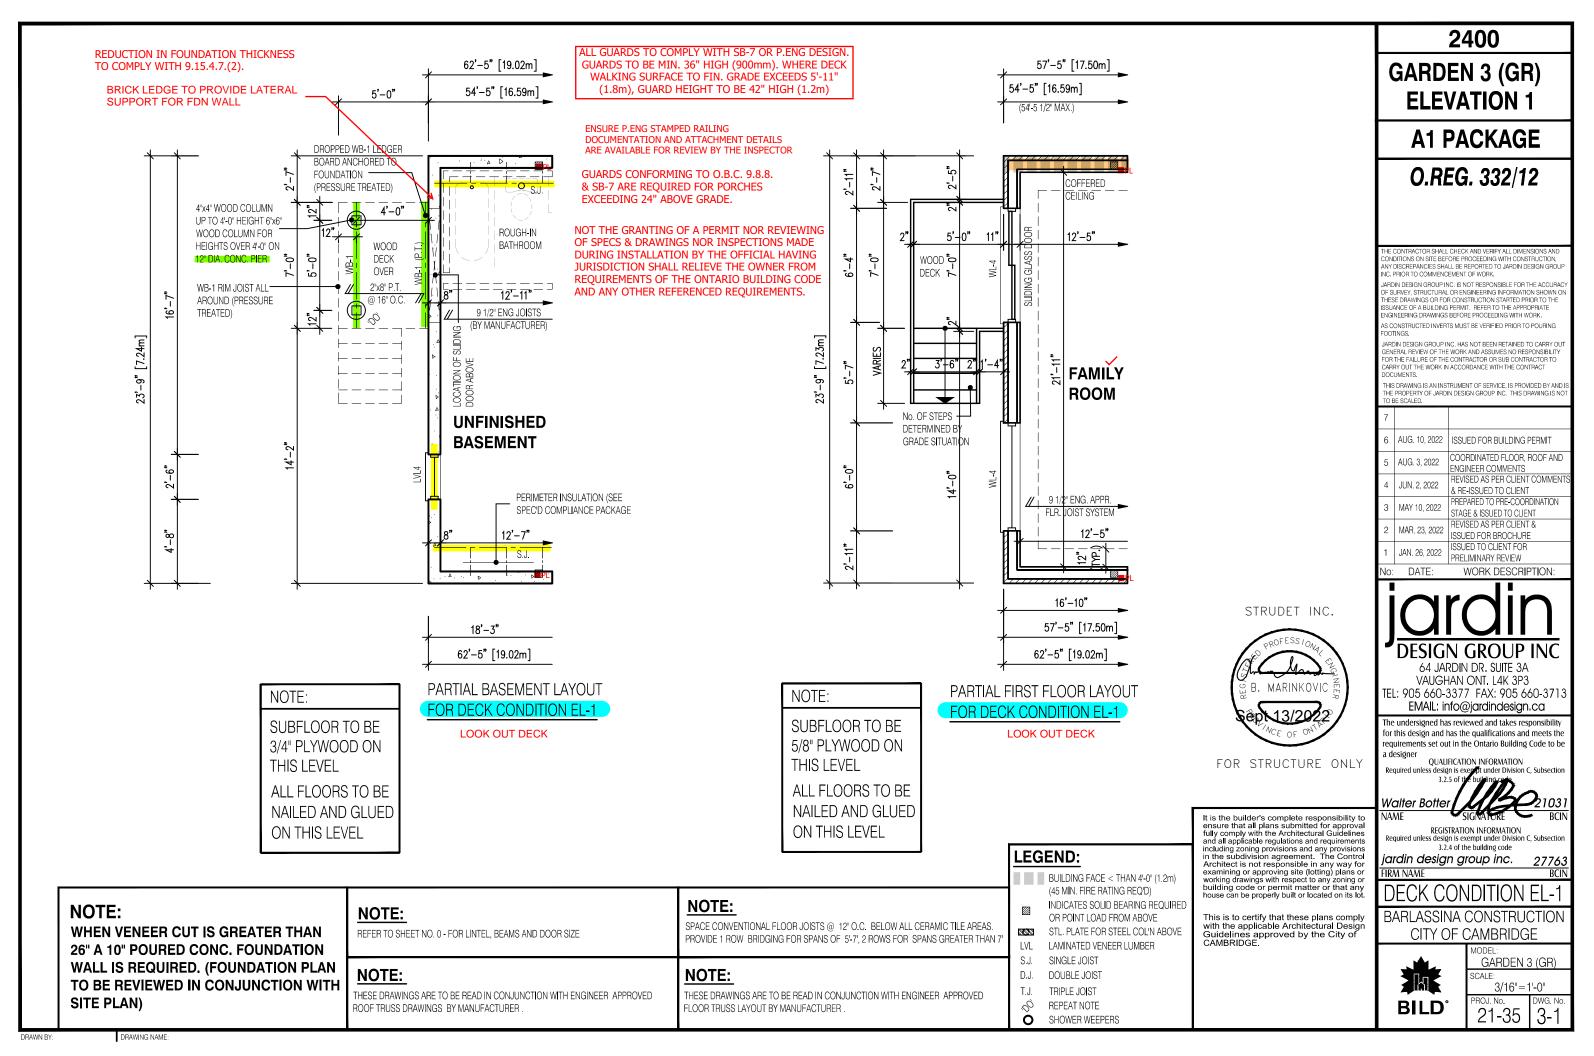

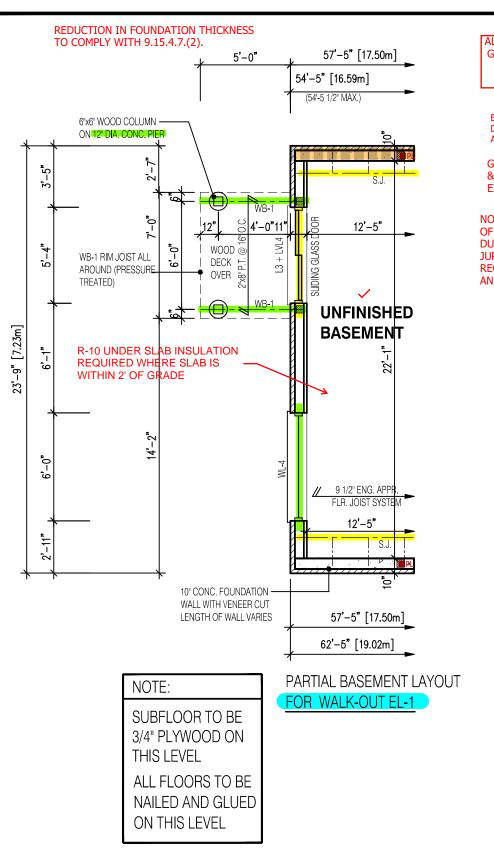

ALL GUARDS TO COMPLY WITH SB-7 OR P.ENG DESIGN.
GUARDS TO BE MIN. 36" HIGH (900mm). WHERE DECK
WALKING SURFACE TO FIN. GRADE EXCEEDS 5'-11"
(1.8m), GUARD HEIGHT TO BE 42" HIGH (1.2m)

ENSURE P.ENG STAMPED RAILING DOCUMENTATION AND ATTACHMENT DETAILS ARE AVAILABLE FOR REVIEW BY THE INSPECTOR

GUARDS CONFORMING TO O.B.C. 9.8.8. & SB-7 ARE REQUIRED FOR PORCHES EXCEEDING 24" ABOVE GRADE.

NOT THE GRANTING OF A PERMIT NOR REVIEWING OF SPECS & DRAWINGS NOR INSPECTIONS MADE DURING INSTALLATION BY THE OFFICIAL HAVING JURISDICTION SHALL RELIEVE THE OWNER FROM REQUIREMENTS OF THE ONTARIO BUILDING CODE AND ANY OTHER REFERENCED REQUIREMENTS.

54'-5" [16.59m] (54'-5 1/2" MAX.)

57'-5" [17.50m]

NOTE:

SUBFLOOR TO BE 5/8" PLYWOOD ON THIS LEVEL ALL FLOORS TO BE

ALL FLOORS TO BE NAILED AND GLUED ON THIS LEVEL PARTIAL FIRST FLOOR LAYOUT

STRUDET INC.



FOR STRUCTURE ONLY

NOTE:

WHEN VENEER CUT IS GREATER THAN 26" A 10" POURED CONC. FOUNDATION WALL IS REQUIRED. (FOUNDATION PLAN TO BE REVIEWED IN CONJUNCTION WITH SITE PLAN)

NOTE:

REFER TO SHEET NO. 0 - FOR LINTEL, BEAMS AND DOOR SIZE

NOTE:

THESE DRAWINGS ARE TO BE READ IN CONJUNCTION WITH ENGINEER APPROVED ROOF TRUSS DRAWINGS BY MANUFACTURER.

NOTE:

SPACE CONVENTIONAL FLOOR JOISTS @ 12" O.C. BELOW ALL CERAMIC TILE AREAS. PROVIDE 1 ROW BRIDGING FOR SPANS OF 5-7', 2 ROWS FOR SPANS GREATER THAN 7'

NOTE:

THESE DRAWINGS ARE TO BE READ IN CONJUNCTION WITH ENGINEER APPROVED FLOOR TRUSS LAYOUT BY MANUFACTURER .

LEGEND:

WITH BASEMENT WALK-OUT EL-1

BUILDING FACE < THAN 4'-0" (1.2m) (45 MIN. FIRE RATING REQ'D)

INDICATES SOLID BEARING REQUIRED OR POINT LOAD FROM ABOVE

SSTL. PLATE FOR STEEL COL'N ABOVE

LVL LAMINATED VENEER LUMBER

S.J. SINGLE JOIST

D.J. DOUBLE JOIST
T.J. TRIPLE JOIST

REPEAT NOTE
SHOWER WEEPERS

It is the builder's complete responsibility to ensure that all plans submitted for approval fully comply with the Architectural Guidelines and all applicable regulations and requirements including zoning provisions and any provisions in the subdivision agreement. The Control Architect is not responsible in any way for examining or approving site (lotting) plans or working drawings with respect to any zoning or building code or permit matter or that any house can be properly built or located on its lot.

This is to certify that these plans comply with the applicable Architectural Design Guidelines approved by the City of CAMBRIDGE.

2400

GARDEN 3 (GR) ELEVATION 1

A1 PACKAGE

O.REG. 332/12

THE CONTRACTOR SHALL CHECK AND VERIFY ALL DIMENSIONS AND CONDITIONS ON SITE BEFORE PROCEEDING WITH CONSTRUCTION, ANY DISCREPANCIES SHALL BE REPORTED TO JARDIN DESIGN GROUF NC. PRIOR TO COMMENCEMENT OF WORK,

JARDIN DESIGN GROUP INC. IS NOT RESPONSIBLE FOR THE ACCURACY OF SURVEY, STRUCTURAL OR ENGINEERING INFORMATION SHOWN ON THESE DRAWINGS OR FOR CONSTRUCTION STARTED PRIOR TO THE ISSUANCE OF A BUILDING PERMIT, REFER TO THE APPROPRIATE ENGINEERING DRAWINGS BEFORE PROCEEDING WITH WORK.

AS CONSTRUCTED INVERTS MUST BE VERIFIED PRIOR TO POURING

JARDIN DESIGN GROUP INC. HAS NOT BEEN RETAINED TO CARRY OUT GENERAL REVIEW OF THE WORK AND ASSUMES NO RESPONSIBILITY FOR THE FAILURE OF THE CONTRACTOR OF SUB CONTRACTOR TO CARRY OUT THE WORK IN ACCORDANCE WITH THE CONTRACT DOCUMENTS.

THIS DRAWING IS AN INSTRUMENT OF SERVICE, IS PROVIDED BY AND IT THE PROPERTY OF JARDIN DESIGN GROUP INC. THIS DRAWING IS NOT TO BE SCALED.

ı	7		
	6	AUG. 10, 2022	ISSUED FOR BUILDING PERMIT
	5	AUG. 3, 2022	COORDINATED FLOOR, ROOF AND ENGINEER COMMENTS
	4	JUN. 2, 2022	REVISED AS PER CLIENT COMMEN & RE-ISSUED TO CLIENT
	3	MAY 10, 2022	PREPARED TO PRE-COORDINATION STAGE & ISSUED TO CLIENT
	2	MAR. 23, 2022	REVISED AS PER CLIENT & ISSUED FOR BROCHURE
	1	JAN. 26, 2022	ISSUED TO CLIENT FOR PRELIMINARY REVIEW

lo: DATE: WORK DESCRIPTION:

Jardin DESIGN GROUP INC

64 JARDIN DR. SUITE 3A VAUGHAN ONT. L4K 3P3 TEL: 905 660-3377 FAX: 905 660-371 EMAIL: info@jardindesign.ca

The undersigned has reviewed and takes responsibility for this design and has the qualifications and meets the requirements set out in the Ontario Building Code to be a designer

QUALIFICATION INFORMATION

Required unless design is executify under Division C, Subsection

Walter Botter SiGNATORE BC

REGISTRATION INFORMATION
Required unless design is exempt under Division C, Subsection

3.2.4 of the building code

jardin design group inc. FIRM NAME

WALK-OUT CONDITION EL-1

BARLASSINA CONSTRUCTION CITY OF CAMBRIDGE




GARDEN 3 (GR)


SCALE: 3/16"=1'-0" PROJ. No. DWG

21-35 3-2

DRAWING NAME:

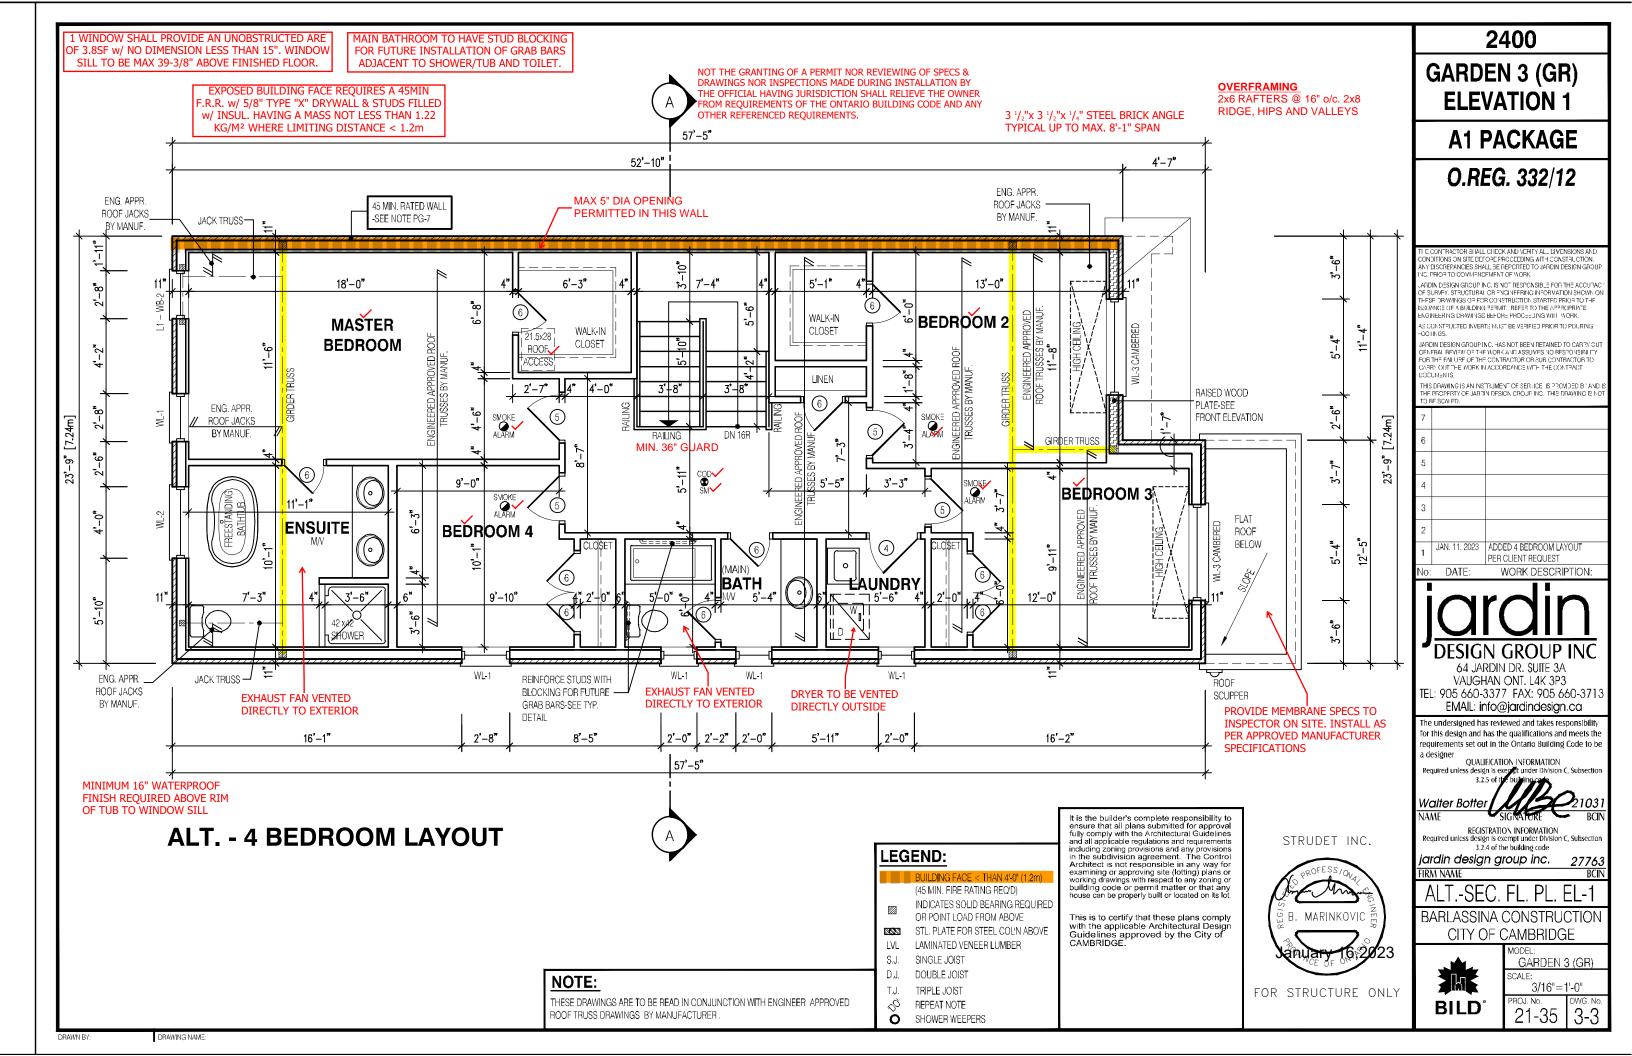

$3^{1}/_{2}$ "x $3^{1}/_{2}$ "x $^{1}/_{4}$ " STEEL BRICK ANGLE TYPICAL UP TO MAX. 8'-1" SPAN

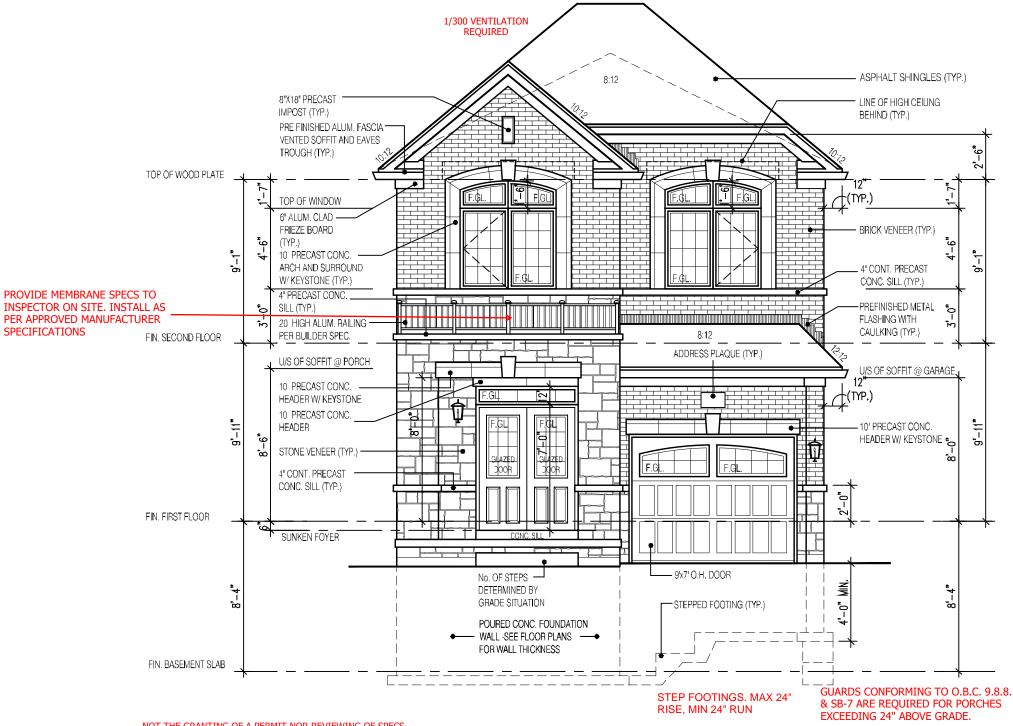


NOT THE GRANTING OF A PERMIT NOR REVIEWING OF SPECS & DRAWINGS NOR INSPECTIONS MADE DURING INSTALLATION BY THE OFFICIAL HAVING JURISDICTION SHALL RELIEVE THE OWNER FROM REQUIREMENTS OF THE ONTARIO BUILDING CODE AND ANY OTHER REFERENCED REQUIREMENTS.

A LIGHT IS REQUIRED AT ALL ENTRANCES TO A SINGLE FAMILY DWELLING

FRONT ELEVATION 1

ENSURE P.ENG STAMPED RAILING DOCUMENTATION AND ATTACHMENT DETAILS ARE AVAILABLE FOR REVIEW BY THE INSPECTOR

EXTERIOR CONCRETE STAIRS w/ MORE THAN 2 RISERS TO MEET THE REQUIREMENTS OF 9.8.9.2.(1)

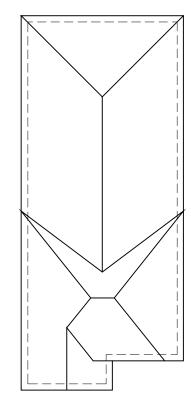

ROOF PLAN

It is the builder's complete responsibility to

or is the builder's complete responsibility to ensure that all plans submitted for approval fully comply with the Architectural Guidelines and all applicable regulations and requirements including zoning provisions and any provisions in the subdivision agreement. The Control

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GARDEN 3 (GR) **ELEVATION 1**

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O.REG. 332/12

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. ARDIN DESIGN GROUP INC. IS NOT RESPONSIBLE FOR THE ACCUPAC OF SURVEY, STEUCTURAL OR ENCLYFERING INFORMATION SHOWN OF THESE DRAWINGS OF FOR CONSTRUCTION STARTED PRIOR TO THE SUANCE OF A BUILDING PERMIT. REFER TO THE APPROPRIATE NGINEERING DRAWINGS BEFORE PROCESSING WITH WORK.

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6	AUG. 10, 2022	ISSUED FOR BUILDING PERMIT
5	AUG. 3, 2022	COORDINATED FLOOR, ROOF AND ENGINEER COMMENTS
4	JUN. 2, 2022	REVISED AS PER CLIENT COMMEN & RE-ISSUED TO CLIENT
3	MAY 10, 2022	PREPARED TO PRE-COORDINATION STAGE & ISSUED TO CLIENT
2	MAR. 23, 2022	REVISED AS PER CLIENT & ISSUED FOR BROCHURE
1	JAN. 26, 2022	ISSUED TO CLIENT FOR PRELIMINARY REVIEW

WORK DESCRIPTION:



64 JARDIN DR. SUITE 3A VAUGHAN ONT. L4K 3P3 TEL: 905 660-3377 FAX: 905 660-3713 EMAIL: info@jardindesign.ca

The undersigned has reviewed and takes responsibility for this design and has the qualifications and meets the requirements set out in the Ontario Building Code to be

a designer QUALIFICATION INFORMATION

Walter Botter NAME

REGISTRATION INFORMATION
Required unless design is exempt under Division C, Subsection 3.2.4 of the building code

ardin design group inc.

RM NAME

FRONT ELEVATION ²

CITY OF CAMBRIDGE

GARDEN 3 (GR)


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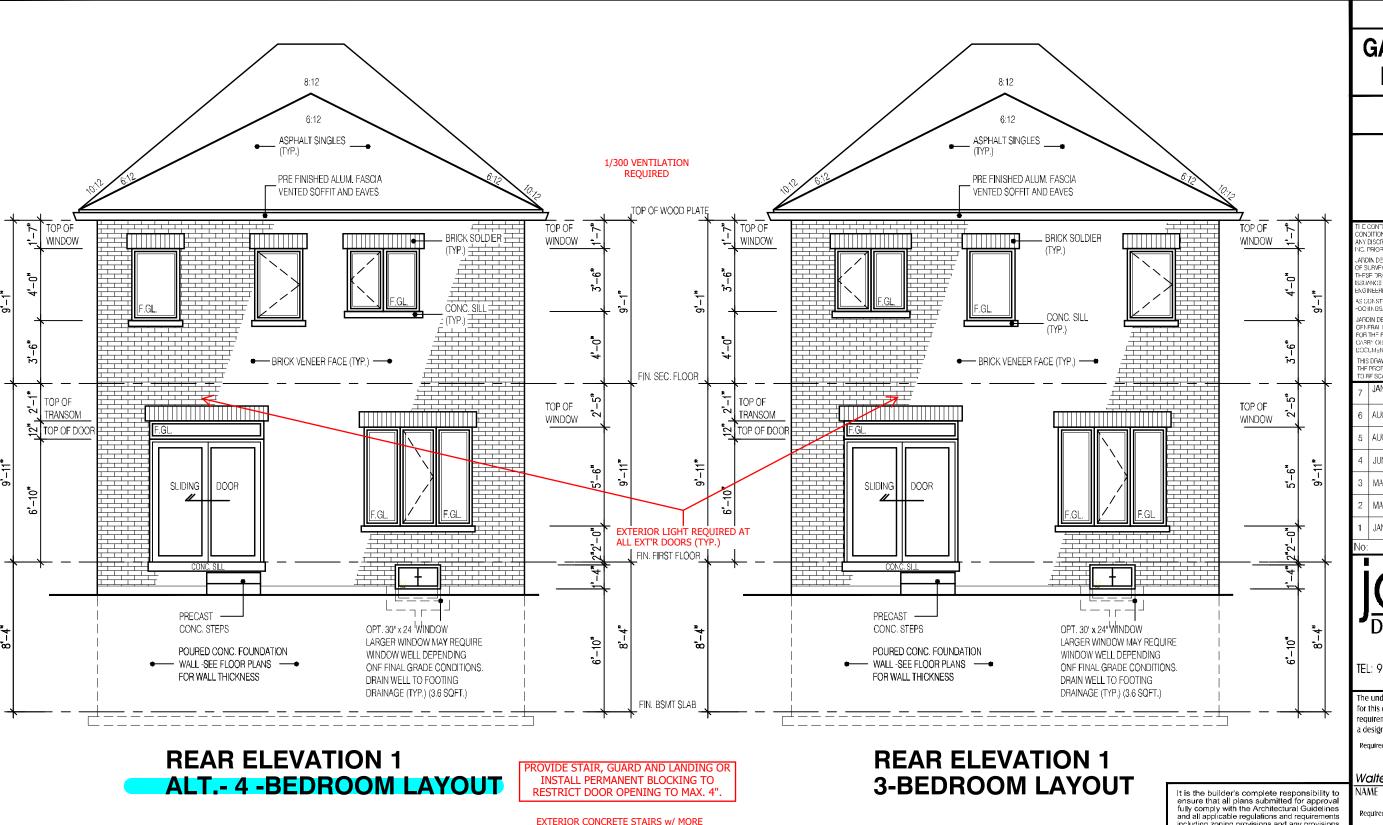


BARLASSINA CONSTRUCTION

SCALE: PROJ. No. 21-35

DRAWING NAME:



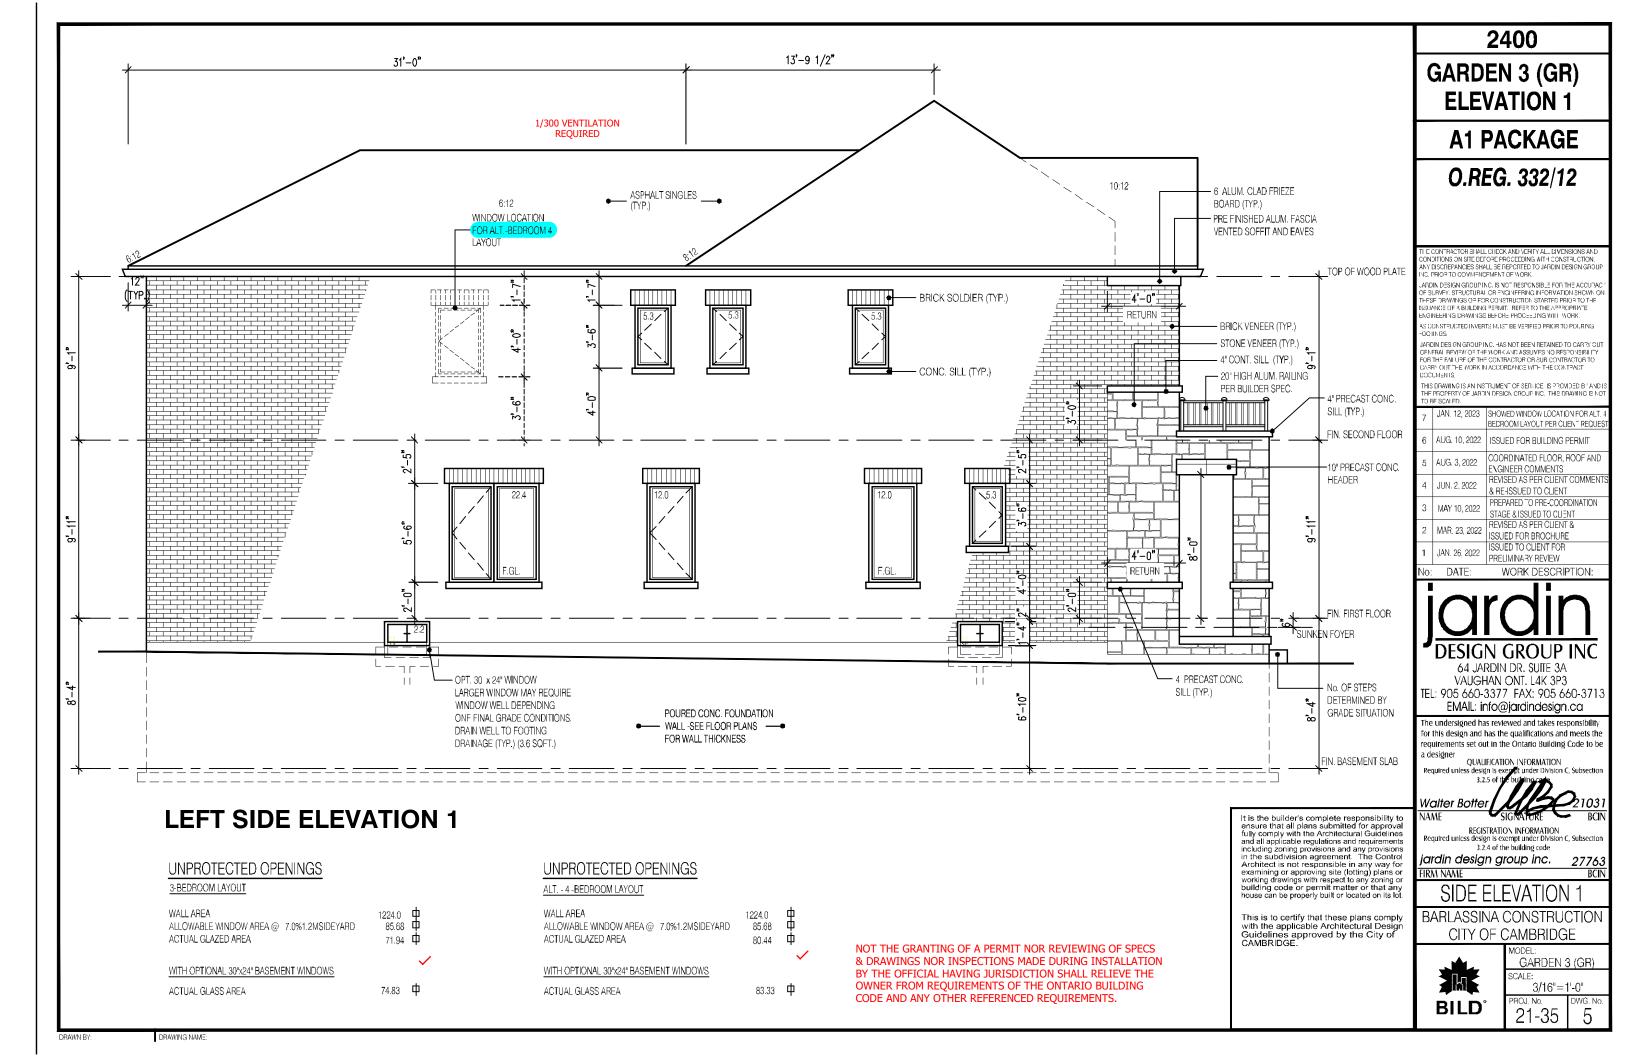

EXTERIOR CONCRETE STAIRS W/ MORE THAN 2 RISERS TO MEET THE REQUIREMENTS OF 9.8.9.2.(1)

NOT THE GRANTING OF A PERMIT NOR REVIEWING OF SPECS & DRAWINGS NOR INSPECTIONS MADE DURING INSTALLATION

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6 AUG. 10, 2022 ISSUED FOR BUILDING PERMIT 5 AUG. 3, 2022 COORDINATED FLOOR, ROOF AND ENGINEER COMMENTS 4 JUN. 2, 2022 REVISED AS PER CLIENT COMMENT 8 RE-ISSUED TO CLIENT 7 AMAY 10, 2022 PREPARED TO PRE-COORDINATION STAGE & ISSUED TO CLIENT 2 MAR. 23, 2022 REVISED AS PER CLIENT & ISSUED FOR BROCHURE 1 JAN. 26, 2022 ISSUED FOR BROCHURE 1 JAN. 26, 2022	7	JAN. 12, 2023	LAYOUT PER CLIENT REQUEST
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QUALIFICATION INFORMATION

Walter Botter

REGISTRATION INFORMATION Required unless design is exempt under Division C, Subsection

3.2.4 of the building code ardin design group inc.

IRM NAME

REAR ELEVATION


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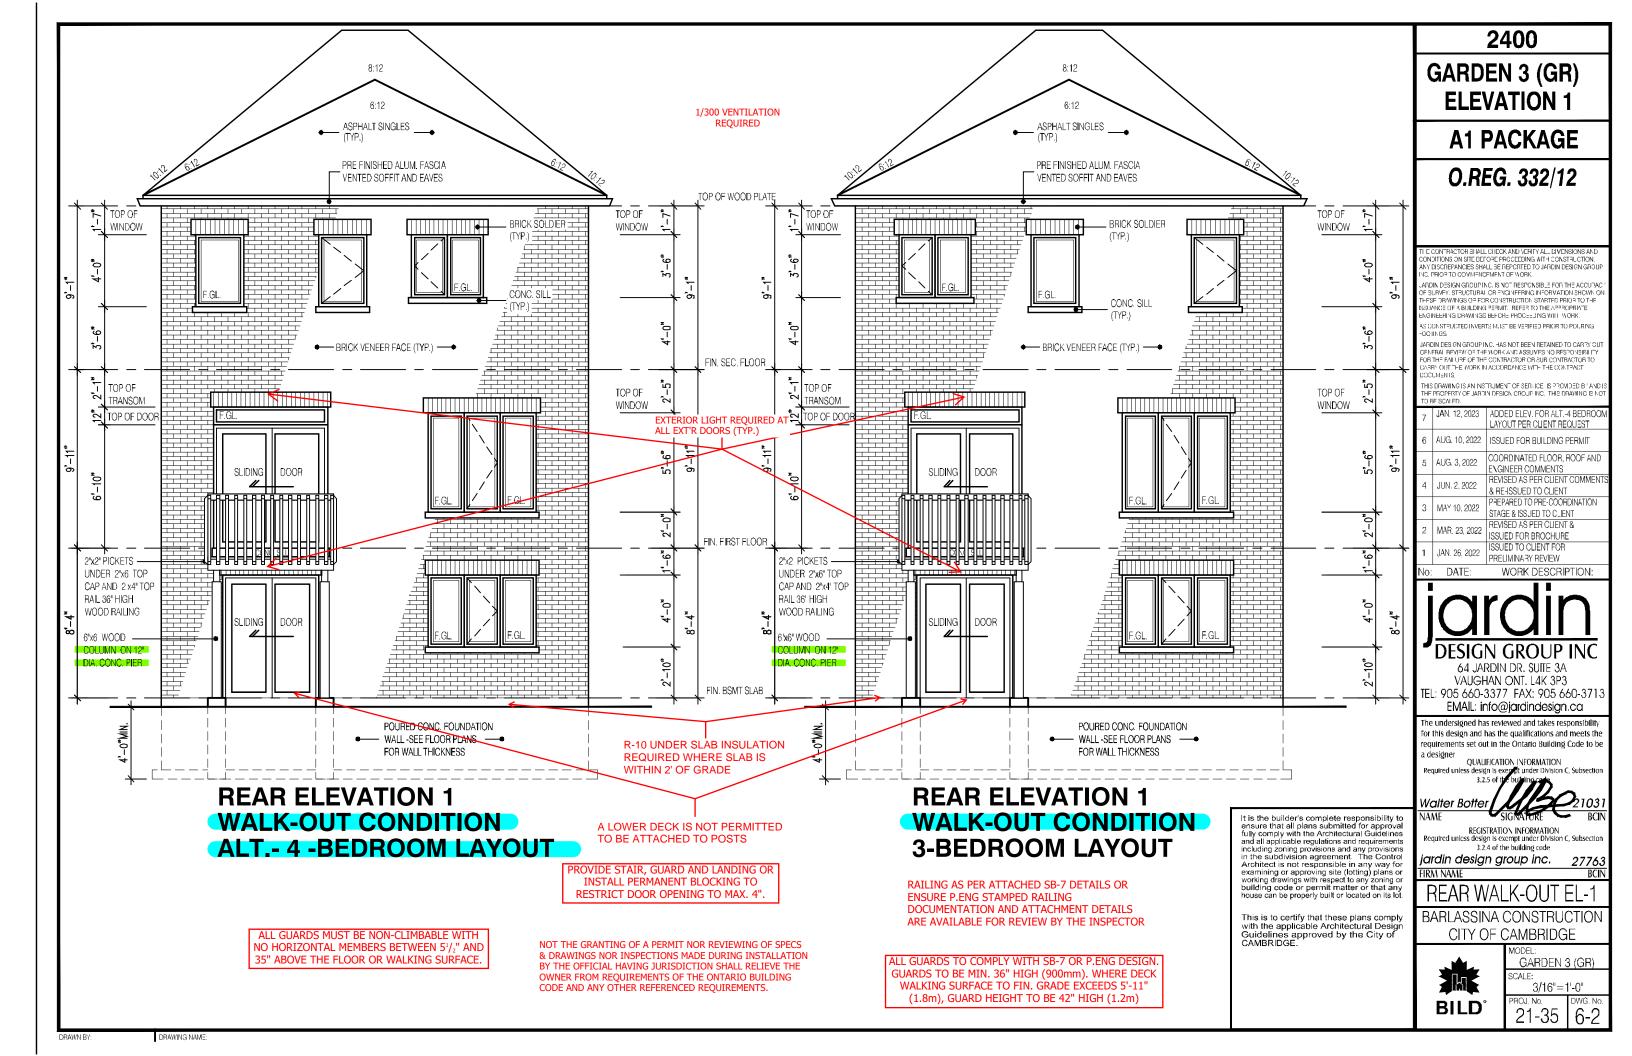



GARDEN 3 (GR) SCALE: 3/16"=1'-0"


PROJ. No. 21-35

BY THE OFFICIAL HAVING JURISDICTION SHALL RELIEVE THE OWNER FROM REQUIREMENTS OF THE ONTARIO BUILDING CODE AND ANY OTHER REFERENCED REQUIREMENTS.



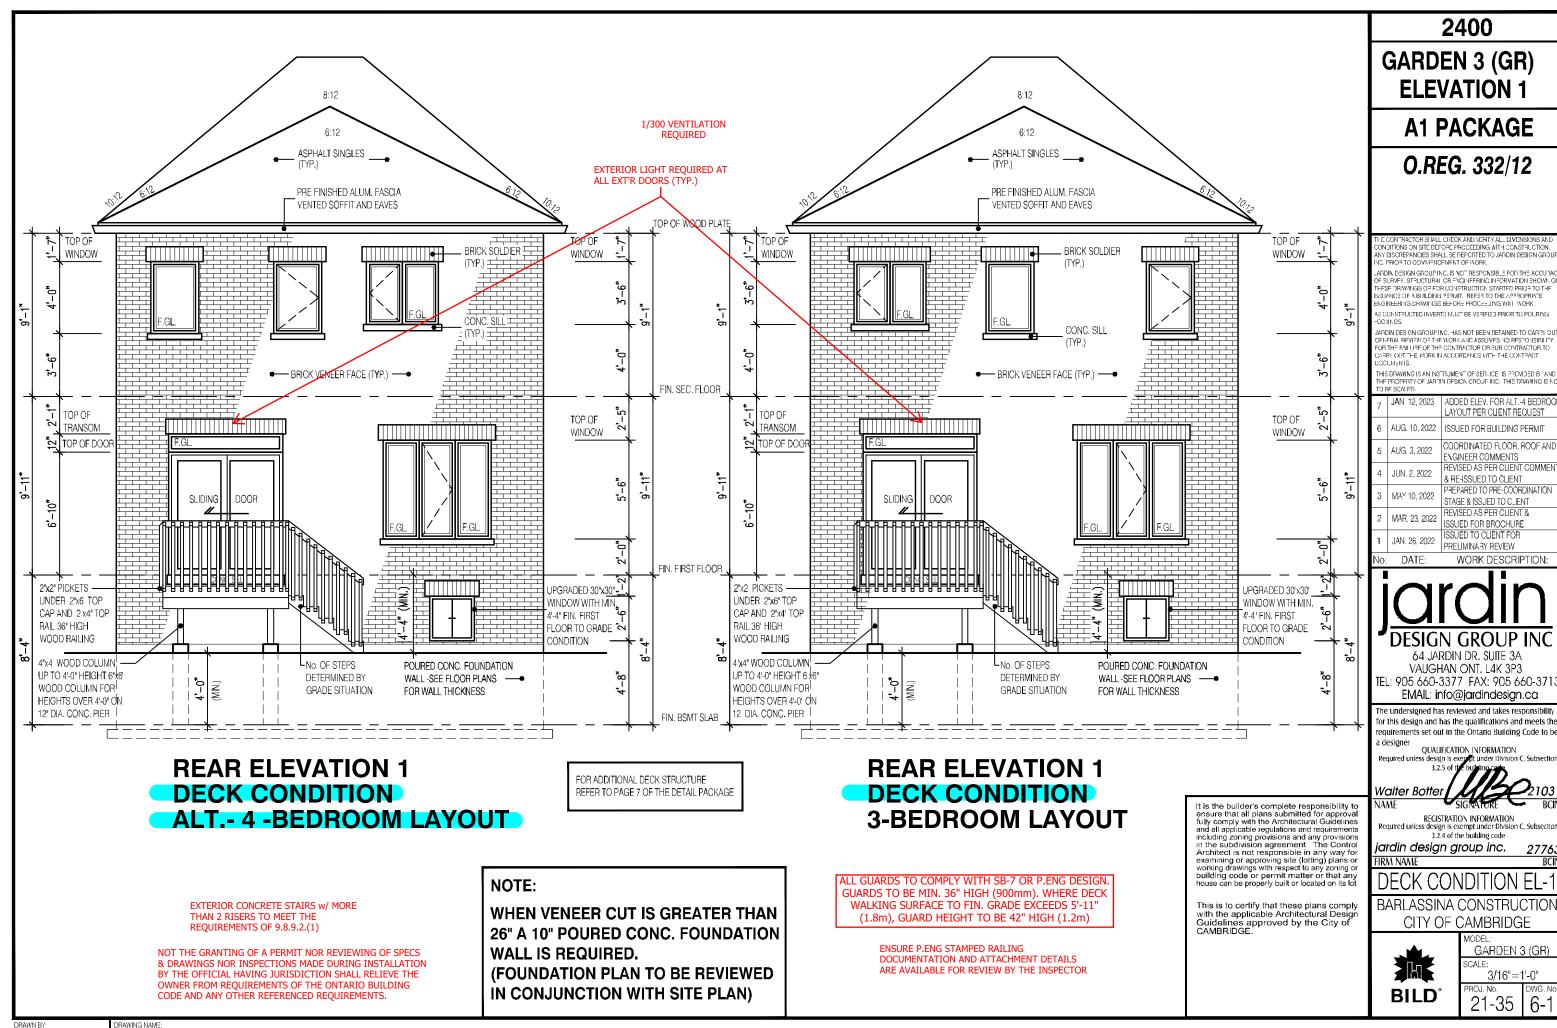

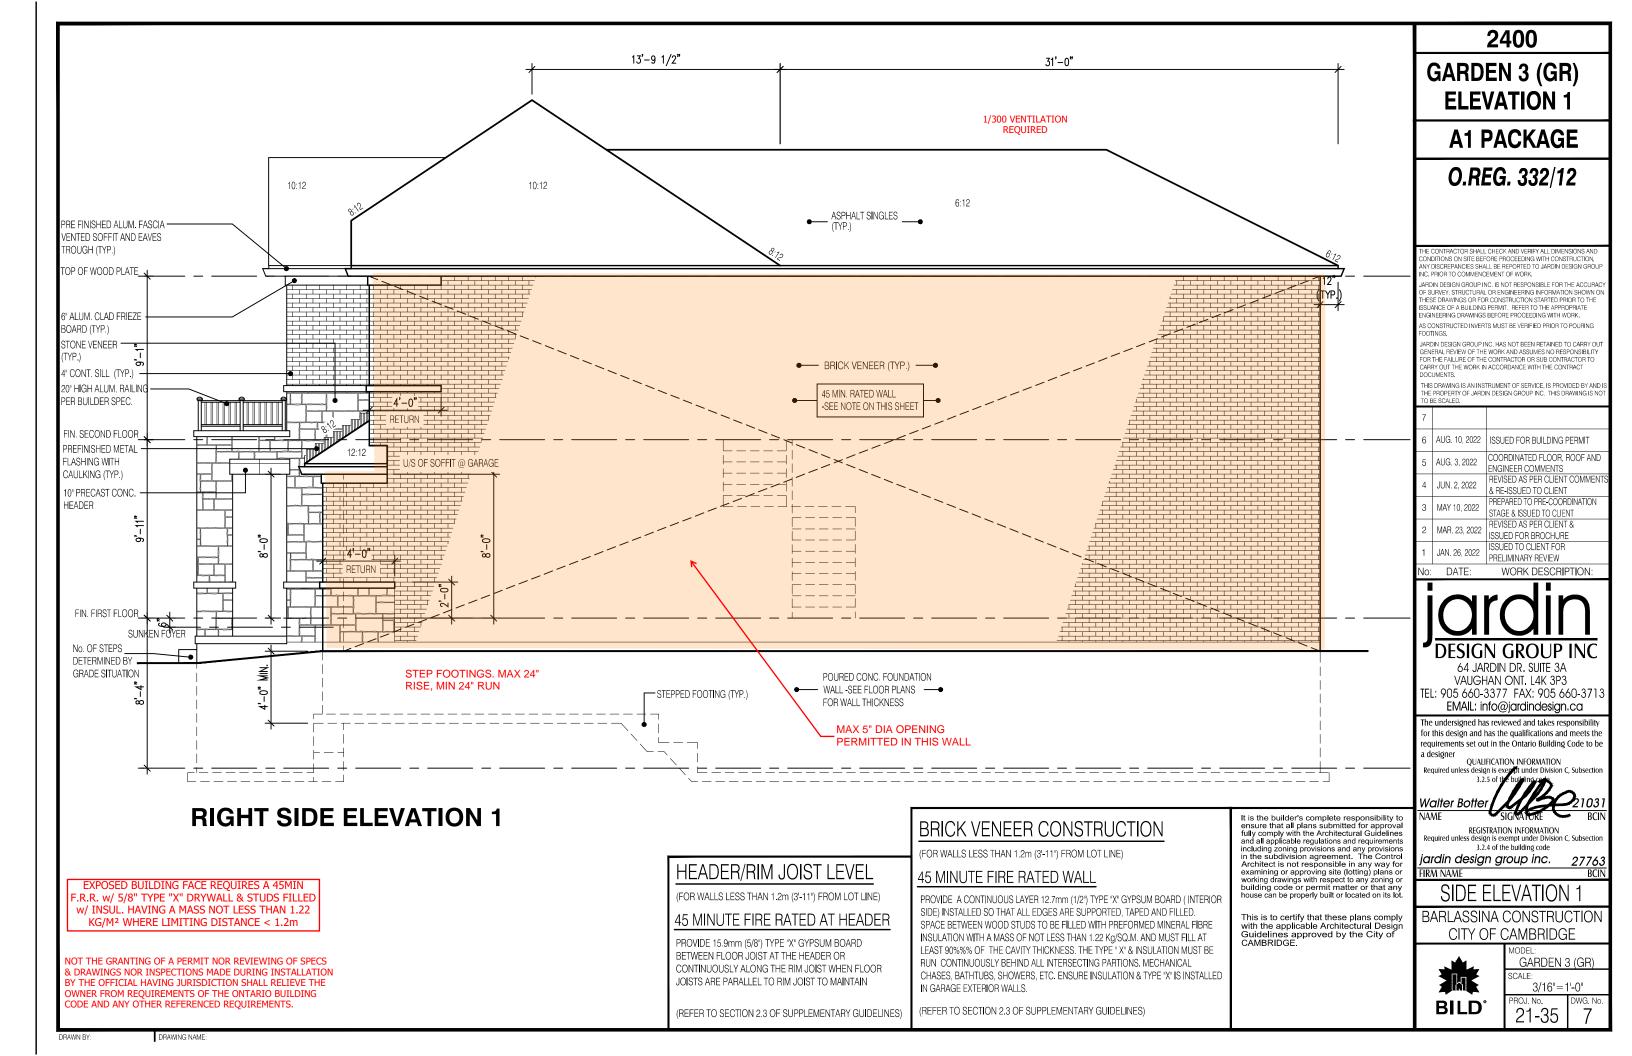

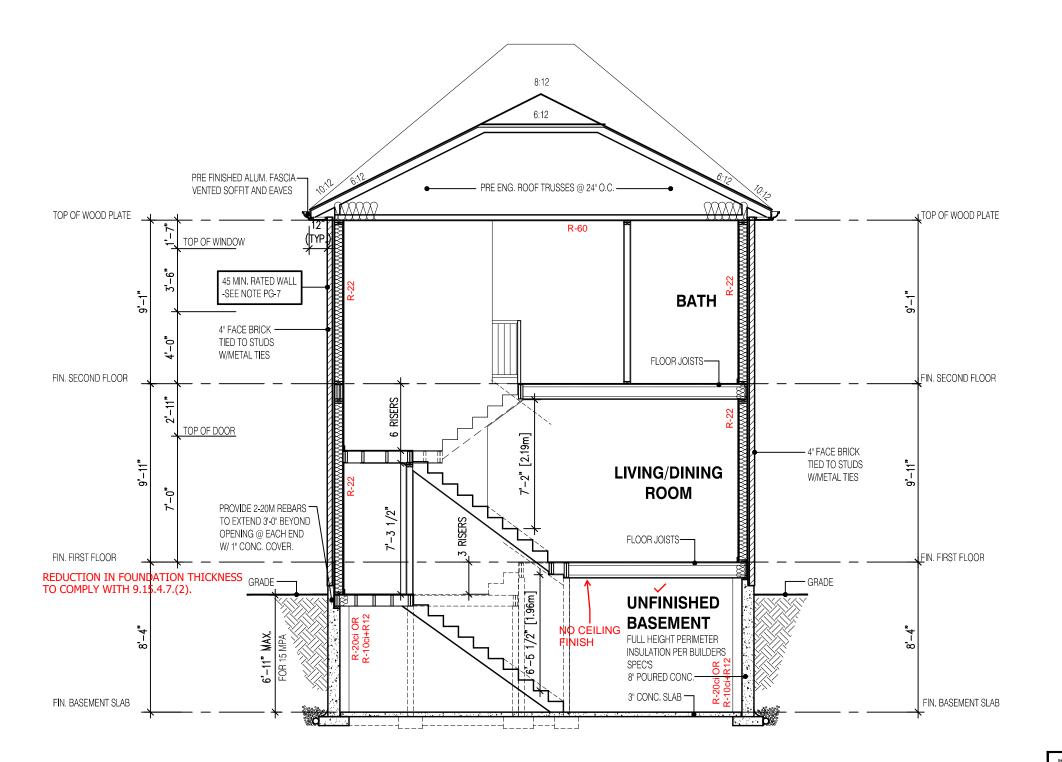

SECTION A-A ELEVATION 1

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STRUDET INC.



FOR STRUCTURE ONLY

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SECTION ELEVATION 1

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GARDEN 3 (GR) SCALE:

3/16"=1'-0" ROJ. No. 21-35