#### DOOR SHEDULE:

1 = 2'-10" x 6'-8" INSULATED ENTRANCE DOOR 1A = 2'-8" x 6'-8" INSULATED ENTRANCE DOOR

 $2 = 2'-8" \times 6'-8"$  EXTERIOR GLAZED DOOR

 $3 = 2'-8" \times 6'-8"$  SLAB DOOR (1 3/4" EXTERIOR

 $4 = 2'-8" \times 6'-8"$  SLAB DOOR (1 3/8" INTERIOR)  $5 = 2'-6'' \times 6'-8''' \text{ SLAB DOOR } (1.3/8''' \text{ INTERIOR})$ 

 $6 = 2'-2'' \times 6'-8''$  SLAB DOOR (1 3/8" INTERIOR)

 $7 = 1'-6" \times 6'-8"$  SLAB DOOR (1 3/8" INTERIOR)

 $8 = 2'-6'' \times 6'-8''' BI-FOLD (1 3/8''' INTERIOR)$ 

 $9 = 3'-0" \times 6'-8" BI-FOLD (1 3/8" INTERIOR)$ 

10= 2- 2'-0" x 6'-8" BI-FOLD (1 3/8" INTERIOR)

11= 2- 2'-6" x 6'-8" BI-FOLD (1 3/8" INTERIOR)

12 = 2'-6" x 6'-8" FRENCH DOOR (1 3/8" INTERIOR)

#### **PAD FOOTING**

120 KPa NATIVE SOIL 90 KPa ENGINEERED FILL SOIL

F1 = 42"x42"x18" CONCRETE PAD F1 = 48"x48"x20" CONCRETE PAD F2 = 36"x36"x16" CONCRETE PAD F2 = 40"x40"x16" CONCRETE PAD

F3 = 30"x30"x12" CONCRETE PAD F3 = 34"x34"x14" CONCRETE PAD

F4 = 24"x24"x12" CONCRETE PAD F4 = 28"x28"x12" CONCRETE PAD F5 = 16"x16"x8" CONCRETE PAD F5 = 18"x18"x8" CONCRETE PAD

(REFER TO FLOOR PLAN FOR UNUSUAL SIZE PADS NOT ON CHART)

#### NOTE:

WHEN VENEER CUT IS GREATER THAN 26" A 10" POURED CONC. FOUNDATION WALL IS REQUIRED.

#### NOTE:

ALL GARAGE SLABS, PORCH SLABS, STAIRS (EXPOSED CONC. FLAT WORK) TO BE 32 MPa WITH 5-8% AIR ENTRAITMENT

#### **BRICK VENEER LINTELS:**

WL2 = 4" x 3 1\2" x 5\16" (100x90x8) + 2- 2" x 8" SPR.

 $WL3 = 5" \times 3 \times 12" \times 5 \times 16" (125 \times 90 \times 8) + 2 - 2" \times 10" SPR.$  $WL4 = 6" \times 3 \times 1 \times 2" \times 3 \times 8" (150 \times 90 \times 10) + 2 - 2" \times 12" SPR.$  $WL5 = 6" \times 4" \times 3\8" (150\times100\times10) + 2-2" \times 12" SPR.$ 

 $WL6 = 5" \times 3 \times 1/2" \times 5/16" (125 \times 90 \times 8) + 2 - 2" \times 12" SPR.$  $WL7 = 5" \times 3 \times 12" \times 5 \times 16" (125 \times 90 \times 8) + 3 - 2" \times 10" SPR$  $WL8 = 5'' \times 3 \times 1^2 \times 5 \times 16'' \times 125 \times 90 \times 8) + 3 - 2'' \times 12'' \text{ SPR}.$  $WL9 = 6" \times 4" \times 3\8" (150\times100\times10) + 3-2" \times 12" SPR.$ 

#### **WOOD LINTELS:**

WB1 = 2- 2" x 8" SPRUCE BEAM WB6 = 3-2" x 12" SPRUCE BEAM WB2 = 3-2" x 8" SPRUCE BEAM WB7 = 5- 2" x 12" SPRUCE BEAM WB3 = 2- 2" x 10" SPRUCE BEAM WB10 = 4- 2" x 8" SPRUCE BEAM WB4 = 3- 2" x 10" SPRUCE BEAM WB11 = 4- 2" x 10" SPRUCE BEAM

WB5 = 2-2" x 12" SPRUCE BEAM

## **STEEL LINTELS:**

 $L1 = 3 \frac{1}{2} \times 3 \frac{1}{4} (90 \times 90 \times 6)$   $L4 = 6'' \times 3 \frac{1}{2}'' \times 3 \%'' (150 \times 90 \times 10)$ L2 = 4" x 3 1\2" x 5\16" (100 x 90 x 8) L5 = 6" x 4" x 3\8" (150 x 100 x 10) L3 = 5" x 3 1\2" x 5\16" (125 x 90 x 8) L6 = 7" x 4" x 3\8" (180 x 100 x 10)

# LAMINATED VENEER LUMBER (LVL BEAMS)

LVL1A = 1-1 3/4" x 7 1/4" (1-45x184)  $LVL1 = 2-1 3/4" \times 7 1/4" (2-45\times184)$  $LVL2 = 3-1 3/4" \times 7 1/4" (3-45 \times 184)$ LVL3 = 4-13/4" x 7 1/4" (4-45x184)

 $LVL4A = 1-1 3/4" \times 9 1/2" (1-45x240)$  $LVL4 = 2-1 3/4" \times 9 1/2" (2-45x240)$ LVL5 = 3-13/4" x 9 1/2" (3-45x240)

 $LVL5A = 4-1 3/4" \times 9 1/2" (4-45x240)$ LVL6A= 1-1 3/4" x 11 7/8" (1-45x300)

IVI6 = 2-1.3/4" x 11.7/8" (2-45x300) LVL7 = 3-13/4" x 11 7/8" (3-45x300) LVL7A= 4-1 3/4" x 11 7/8" (4-45x300)


 $LVL8 = 2-1 3/4" \times 14" (2-45x356)$  $LVL9 = 3-1 3/4" \times 14" (3-45 \times 356)$  PROVIDE P.ENG APPROVED TRUSS & FLOOR DRAWINGS AND SPECIFICATIONS TO BUILDING INSPECTOR AT FRAMING INSPECTION


SHALL CONFORM TO THE REQUIREMENTS OF 9.23.9.2.(3), (4) & (5)

SOILS, SEE FIELD INSPECTOR

INAL GRADING CERTIFICATE REO'D BEFORE FINAL INSPECTION SIGN-OFF

ENERGY PERFORMANCE LABELS FOR ALL CERTIFIED VALUES SHALL REMAIN ON FOR REVIEW DURING CONSTRUCTION

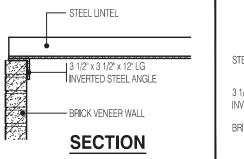

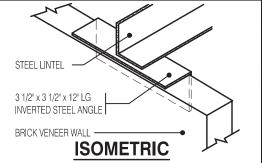

# **INVERTED STEEL ANGLE DETAIL**

Scale: 3/4" = 1'-0"

 $\sim$ 

4

9

3

Units

2

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ock

| WILLOW 3E ELEV1                         |                      | ENER                    | GY EFFICIENCY- SB12 |
|---|----------------------|-------------------------|---------------------|
| ELEVATION                               | WALL FT <sup>2</sup> | OPENING FT <sup>2</sup> | PERCENTAGE          |
| FRONT                                   | 431.06               | 81.89                   | 19.00 %             |
| LEFT SIDE                               | 1103.56              | 71.60                   | 6.49 %              |
| RIGHT SIDE                              | 1103.56              | 0.00                    | 0.00 %              |
| REAR                                    | 379.06               | 97.43                   | 25.70 %             |
|   |                      |                         |                     |
| TOTAL                                   | 3017.24              | 250.92                  | 8.32 %              |
| WILLOW 3E ELEV2 ENERGY EFFICIENCY- SB12 |                      |                         |                     |
| ELEVATION                               | WALL FT <sup>2</sup> | OPENING FT <sup>2</sup> | PERCENTAGE          |
| FRONT                                   | 425.05               | 83.19                   | 19.57 %             |
| LEFT SIDE                               | 1103.56              | 71.60                   | 6.49 %              |
| RIGHT SIDE                              | 1103.56              | 0.00                    | 0.00 %              |
| REAR                                    | 379.06               | 97.43                   | 25.70 %             |
|   |                      |                         |                     |
| TOTAL                                   | 3011.23              | 252.22                  | 8.38 %              |
| WILLOW 3E ELEV3 ENERGY EFFICIENCY- SB12 |                      |                         |                     |
| ELEVATION                               | WALL FT <sup>2</sup> | OPENING FT <sup>2</sup> | PERCENTAGE          |
| FRONT                                   | 425.05               | 76.54                   | 18.01 %             |
|   |                      |                         |                     |

| REAR                                 | 379.06   | 97.43                   | 25.70 %             |
|--------------------------------------|--|-------------------------|---------------------|
|                                      |  |                         |                     |
| TOTAL                                | 3011.23  | 252.22                  | 8.38 %              |
| WILLOW 3E ELEV3 ENERGY EFFICIENCY-SI |  |                         | GY EFFICIENCY- SB12 |
| ELEVATION                            | WALL FT <sup>2</sup>   | OPENING FT <sup>2</sup> | PERCENTAGE          |
| RONT                                 | 425.05   | 76.54                   | 18.01 %             |
| EFT SIDE                             | 1103.56  | 71.60                   | 6.49 %              |
| RIGHT SIDE                           | 1103.56  | 0.00                    | 0.00 %              |
| REAR                                 | 379.06   | 97.43                   | 25.70 %             |
|                                      |  |                         |                     |
| _                                    | , and the second |                         |                     |

245.57

8.16 %

#### NOTE:

HESE DRAWINGS ARE TO BE READ IN CONJUNCTION WITH ENGINEER APPROVED ROOF TRUSS DRAWINGS BY MANUFACTURER

3011.23

#### NOTE:

SPACE CONVENTIONAL FLOOR JOISTS @ 12" O.C. BELOW ALL CERAMIC TILE AREAS. PROVIDE 1 ROW BRIDGING FOR SPANS OF 5'-7', 2 ROWS FOR SPANS GREATER THAN 7

#### NOTE:

THESE DRAWINGS ARE TO BE READ IN CONJUNCTION WITH ENGINEER APPROVED FLOOR TRUSS LAYOUT BY MANUFACTURER

#### NOTE:

PLANS NOT DRAWN TO ACTUAL GRADE. REFER TO FINAL GRADING PLAN.

# LEGEND:

BUILDING FACE < THAN 4'-0" (1.2m) (45 MIN. FIRE RATING REQ'D)

INDICATES SOLID BEARING REQUIRED OR POINT LOAD FROM ABOVE

STL. PLATE FOR STEEL COL'N ABOVE LVL LAMINATED VENEER LUMBER

S.J. SINGLE JOIST

D.J. DOUBLE JOIST TRIPLE JOIST

REPEAT NOTE 0

0 SHOWER WEEPERS

# AREA CALCULATIONS EL-1

FIRST FLOOR AREA 802 Sq. Ft. SECOND FLOOR AREA = 973 Sq. Ft. = 1775 Sq. Ft. TOTAL FLOOR AREA ADD OPEN AREAS 0 Sa. Ft. ADD FIN. BASEMENT AREA = 0 Sq. Ft. = 1775 Sq. Ft. GROSS FLOOR AREA GROUND FLOOR COVERAGE = 802 Sq. Ft. GARAGE COVERAGE / AREA = 216 Sq. Ft. PORCH COVERAGE / AREA = 67 Sq. Ft. COVERAGE W/ PORCH = 1018 Sq. Ft. = 94.57 Sq. m. = 1085 Sq. Ft. COVERAGE W/O PORCH  $= 100.80 \, \text{Sa. m.}$ 

# AREA CALCULATIONS EL-2

802 Sq. Ft. FIRST FLOOR AREA SECOND FLOOR AREA 963 Sq. Ft. = 1765 Sq. Ft. TOTAL FLOOR AREA ADD OPEN AREAS 0 Sq. Ft. ADD FIN. BASEMENT AREA 0 Sq. Ft. 1765 Sq. Ft. GROSS FLOOR AREA GROUND FLOOR COVERAGE = 802 Sq. Ft. GARAGE COVERAGE / AREA = 216 Sq. Ft. PORCH COVERAGE / AREA = 67 Sq. Ft. COVERAGE W/ PORCH = 1018 Sq. Ft = 94.57 Sq. m. = 1085 Sq. Ft COVERAGE W/O PORCH = 100.80 Sq. m

## AREA CALCULATIONS EL-3

FIRST FLOOR AREA 802 Sq. Ft. SECOND FLOOR AREA = 963 Sq. Ft. = 1765 Sq. Ft. TOTAL FLOOR AREA ADD OPEN AREAS 0 Sq. Ft. ADD FIN. BASEMENT AREA 0 Sq. Ft. GROSS FLOOR AREA 1765 Sg. Ft. GROUND FLOOR COVERAGE = 802 Sq. Ft. GARAGE COVERAGE / AREA = 216 Sq. Ft. PORCH COVERAGE / AREA = 67 Sq. Ft. = 1018 Sq. Ft COVERAGE W/ PORCH = 94.57 Sq. m. = 1085 Sq. Ft COVERAGE W/O PORCH  $= 100.80 \,\mathrm{Sg.\,m.}$ 

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This is to certify that these plans comply with the applicable Architectural Desig Guidelines approved by the City of CAMBRIDGE

# CITY OF CAMBRIDGE BUILDING DIVISION

STRUDET INC.

B. MARINKOVIO

15, 202

FOR STRUCTURE ONLY

WILLOW 3E (GR) **ELEVATION 1, 2 & 3** ONDITIONS ON SITE BEFORE PROCEEDING WITH CONSTRUCTION

Y DISCREPANCIES SHALL BE REPORTED TO JARDIN DESIGN GROU NC. PRIOR TO COMMENCEMENT OF WORK. IADDIN DESIGN ODDI ID INC. IS NOT DESDONSIDI E COD THE ACCUIDA SUANCE OF A BUILDING PERMIT. REFER TO THE APPROPRIATE

NGINEERING DRAWINGS BEFORE PROCEEDING WITH WORK. S CONSTRUCTED INVERTS MUST BE VERIFIED PRIOR TO POURING

1775

**6.10m LOTS** 

**A1 PACKAGE** 

O.REG. 332/12

IARDIN DESIGN GROUP INC. HAS NOT BEEN BETAINED TO CARRY OF ARDIN DESIGN GHOUP INC. HAS NOT BEEN HETAINED TO CARRY OF ENERAL REVIEW OF THE WORK AND ASSUMES NO RESPONSIBILITY OR THE FAILURE OF THE CONTRACTOR OR SUB CONTRACTOR TO ARRY OUT THE WORK IN ACCORDANCE WITH THE CONTRACT OCUMENTS.

THIS DRAWING IS AN INSTRUMENT OF SERVICE. IS PROVIDED BY AND HE PROPERTY OF JARDIN DESIGN GROUP INC. THIS DRAWING IS N

AUG. 31, 2022 ISSUED BUILDING PERMIT COORDINATED WITH FLOOR, ROO AUG. 29, 2022 & FNGINFER'S COMMENTS PREPARED TO PRE-COORDINATIO JUNE 20, 2022 STAGE & ISSUED TO CLIENT

DATE: WORK DESCRIPTION:

MAR. 28, 2022 ISSUED TO CLIENT FOR BROCHUR

# DESIGN GROUP INC

64 JARDIN DR. SUITE 3A VAUGHAN ONT, L4K 3P3 TEL: 905 660-3377 FAX: 905 660-3713 EMAIL: info@jardindesian.ca

The undersigned has reviewed and takes responsibility for this design and has the qualifications and meets the requirements set out in the Ontario Building Code to be a designer

OUALIFICATION NEORMATION 3.2.5 of

Walter Botteri NAME

REGISTRATION INFORMATION Required unless design is exempt under Division C, Subsection 3.2.4 of the building code

jardin design group inc. FIRM NAME

TITLE SHEET

BARLASSINA CONSTRUCTION CITY OF CAMBRIDGE




WILLOW 3E 3/16"=1'-0"

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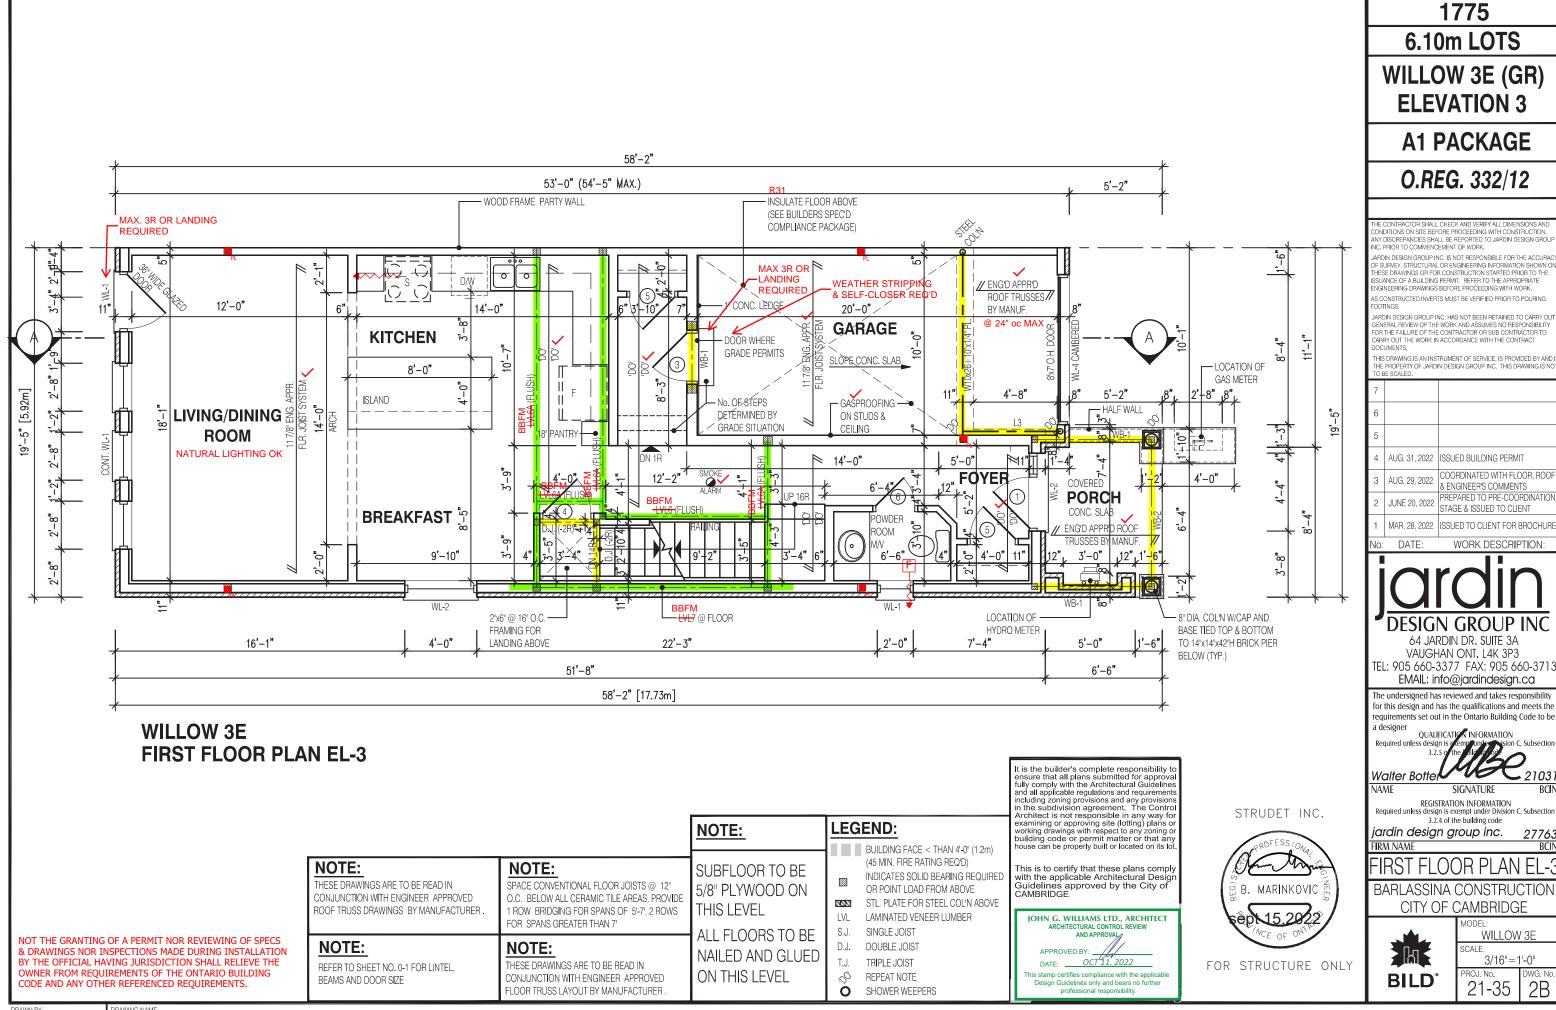
SCALE: ROJ. No.

21-35


DRAWING NAME

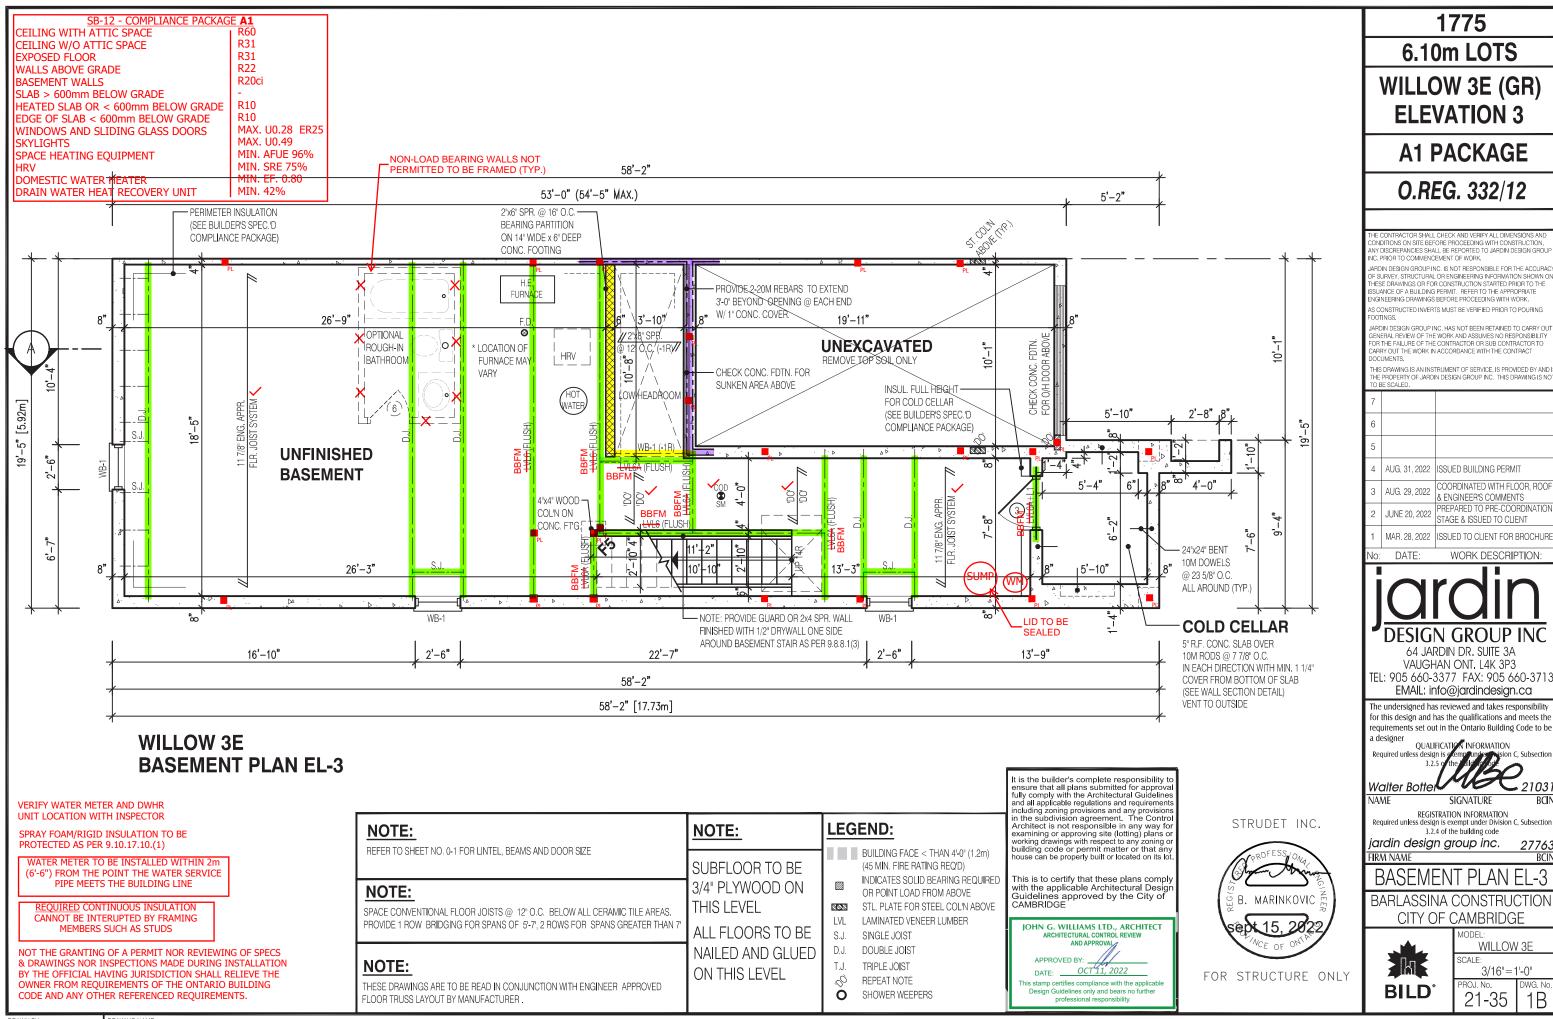

DRAWING NAME



DRAWING NAME

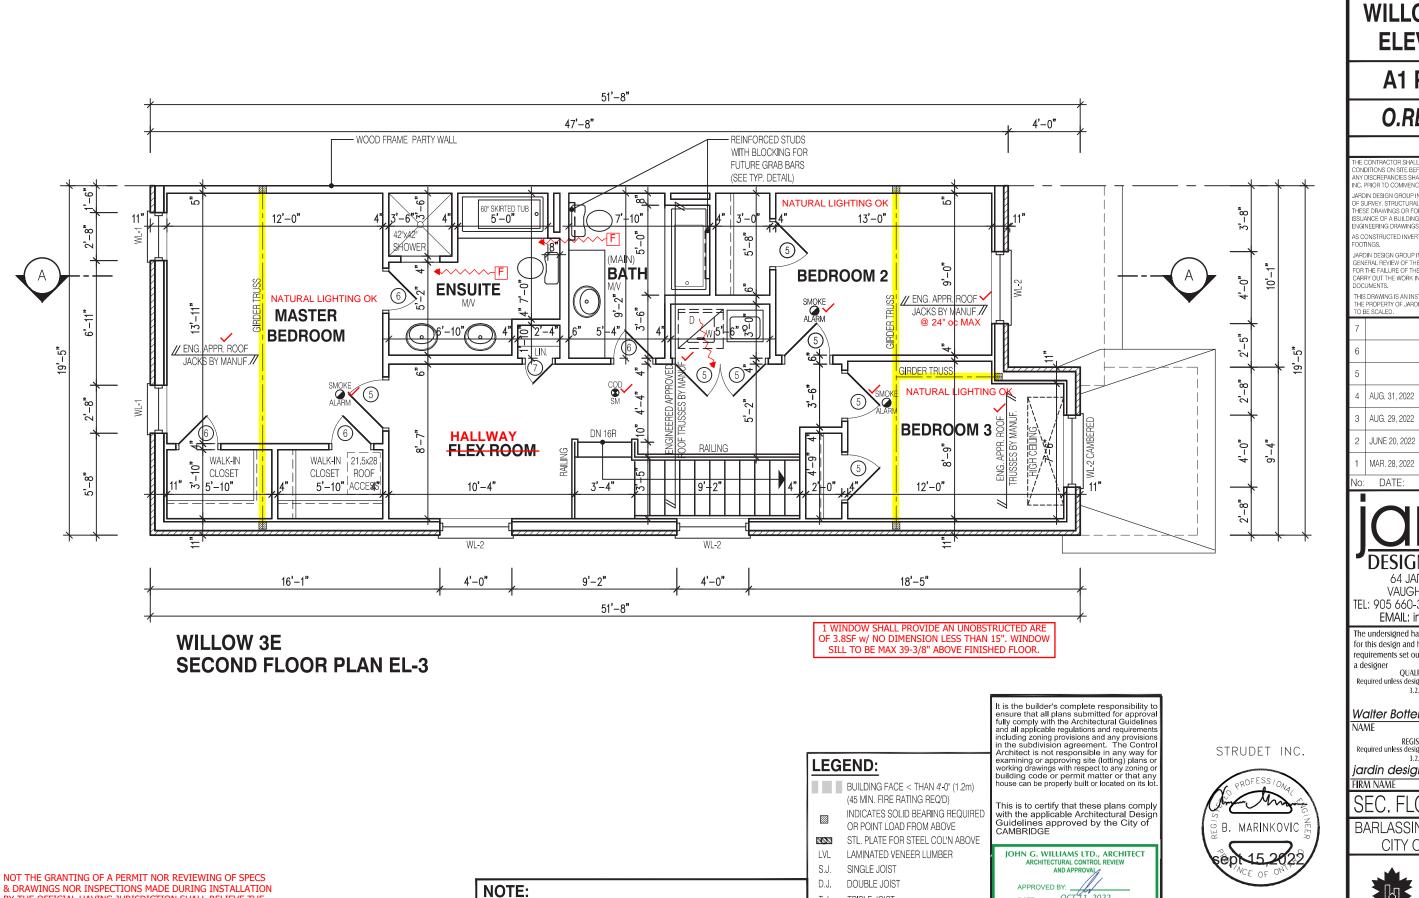

THESE DRAWINGS ARE TO BE READ IN CONJUNCTION WITH ENGINEER APPROVED

ROOF TRUSS DRAWINGS BY MANUFACTURER

1775

6.10m LOTS

WILLOW 3E (GR) **ELEVATION 3** 

**A1 PACKAGE** 

O.REG. 332/12

ONDITIONS ON SITE BEFORE PROCEEDING WITH CONSTRUCTION DISCREPANCIES SHALL BE REPORTED TO JARDIN DESIGN GROU IC. PRIOR TO COMMENCEMENT OF WORK.

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| IOE | BE SCALED.    |  |
|-----|---------------|--|
| 7   |               |  |
| 6   |               |  |
| 5   |               |  |
| 4   | AUG. 31, 2022 | ISSUED BUILDING PERMIT                               |
| 3   | AUG. 29, 2022 | COORDINATED WITH FLOOR, ROC<br>& ENGINEER'S COMMENTS |

PREPARED TO PRE-COORDINATION

STAGE & ISSUED TO CLIENT MAR. 28, 2022 ISSUED TO CLIENT FOR BROCHUR

WORK DESCRIPTION:



64 JARDIN DR. SUITE 3A VAUGHAN ONT, L4K 3P3 TEL: 905 660-3377 FAX: 905 660-3713 EMAIL: info@jardindesign.ca

The undersigned has reviewed and takes responsibility for this design and has the qualifications and meets the requirements set out in the Ontario Building Code to be QUALIFICATION INFORMATION

Walter Botter

REGISTRATION INFORMATION Required unless design is exempt under Division C, Subsection

3.2.4 of the building code jardin design group inc.

SEC. FLOOR PLAN EL-3

BARLASSINA CONSTRUCTION CITY OF CAMBRIDGE



FOR STRUCTURE ONLY

OCT 11, 2022

nis stamp certifies compliance with the applicable Design Guidelines only and bears no further

professional responsibility.

DATE:

TRIPLE JOIST

REPEAT NOTE

SHOWER WEEPERS

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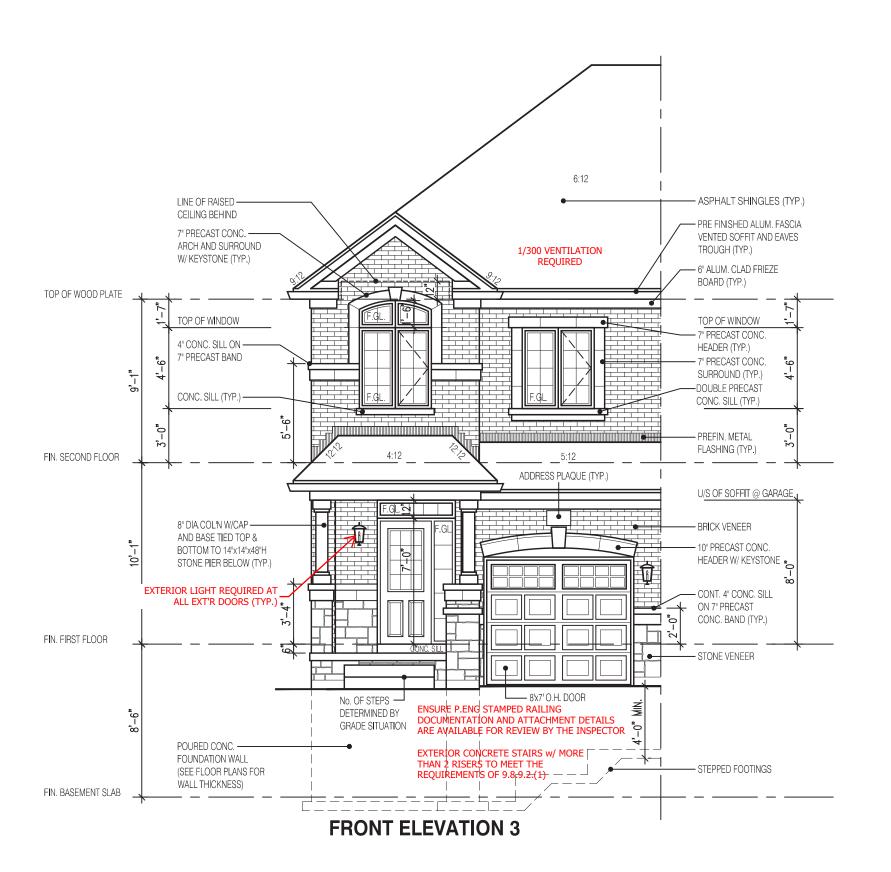
WILLOW 3E

SCALE: 3/16"=1'-0" ROJ. No. 21-35

CODE AND ANY OTHER REFERENCED REQUIREMENTS.

BY THE OFFICIAL HAVING JURISDICTION SHALL RELIEVE THE

OWNER FROM REQUIREMENTS OF THE ONTARIO BUILDING



NOT THE GRANTING OF A PERMIT NOR REVIEWING OF SPECS & DRAWINGS NOR INSPECTIONS MADE DURING INSTALLATION BY THE OFFICIAL HAVING JURISDICTION SHALL RELIEVE THE OWNER FROM REQUIREMENTS OF THE ONTARIO BUILDING CODE AND ANY OTHER REFERENCED REQUIREMENTS.

1775

**6.10m LOTS** 

WILLOW 3E (GR) **ELEVATION 3** 

A1 PACKAGE

O.REG. 332/12

THE CONTRACTOR SHALL CHECK AND VERIFY ALL DIMENSIONS AND CONDITIONS ON SITE BEFORE PROCEEDING WITH CONSTRUCTION, ANY DISCREPANCIES SHALL BE REPORTED TO JARDIN DESIGN GROUP INC. PRIOR TO COMMENCEMENT OF WORK.

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| / |               |   |
|---|---------------|---|
| 6 |               |   |
| 5 |               |   |
| 4 | AUG. 31, 2022 | ISSUED BUILDING PERMIT                                |
| 3 | AUG. 29, 2022 | COORDINATED WITH FLOOR, ROOF<br>& ENGINEER'S COMMENTS |
| 2 | JUNE 20, 2022 | PREPARED TO PRE-COORDINATION STAGE & ISSUED TO CLIENT |
| 1 | MAR. 28, 2022 | ISSUED TO CLIENT FOR BROCHURE                         |

DATE: WORK DESCRIPTION:



64 JARDIN DR. SUITE 3A VAUGHAN ONT, L4K 3P3 TEL: 905 660-3377 FAX: 905 660-3713 EMAIL: info@jardindesian.ca

The undersigned has reviewed and takes responsibility for this design and has the qualifications and meets the requirements set out in the Ontario Building Code to be a designer

QUALIFICATION INFORMATION Walter Botter

REGISTRATION INFORMATION Required unless design is exempt under Division C, Subsection

3.2.4 of the building code

iardin design group inc. IRM NAME

NAME

It is the builder's complete responsibility to ensure that all plans submitted for approva fully comply with the Architectural Guidelines and all applicable regulations and requirements including zoning provisions and any provisions in the subdivision agreement. The Contro Architect is not responsible in any way for examining or approving site (Idition) plans or

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This is to certify that these plans comply with the applicable Architectural Desig Guidelines approved by the City of CAMBRIDGE

JOHN G. WILLIAMS LTD., ARCHITECT

his stamp certifies compliance with the applicable

Design Guidelines only and bears no further

OCT 11, 2022


APPROVED BY:


FRONT ELEVATION 3

BARLASSINA CONSTRUCTION CITY OF CAMBRIDGE



WILLOW 3E SCALE: 3/16"=1'-0" ROJ. No. 21-35

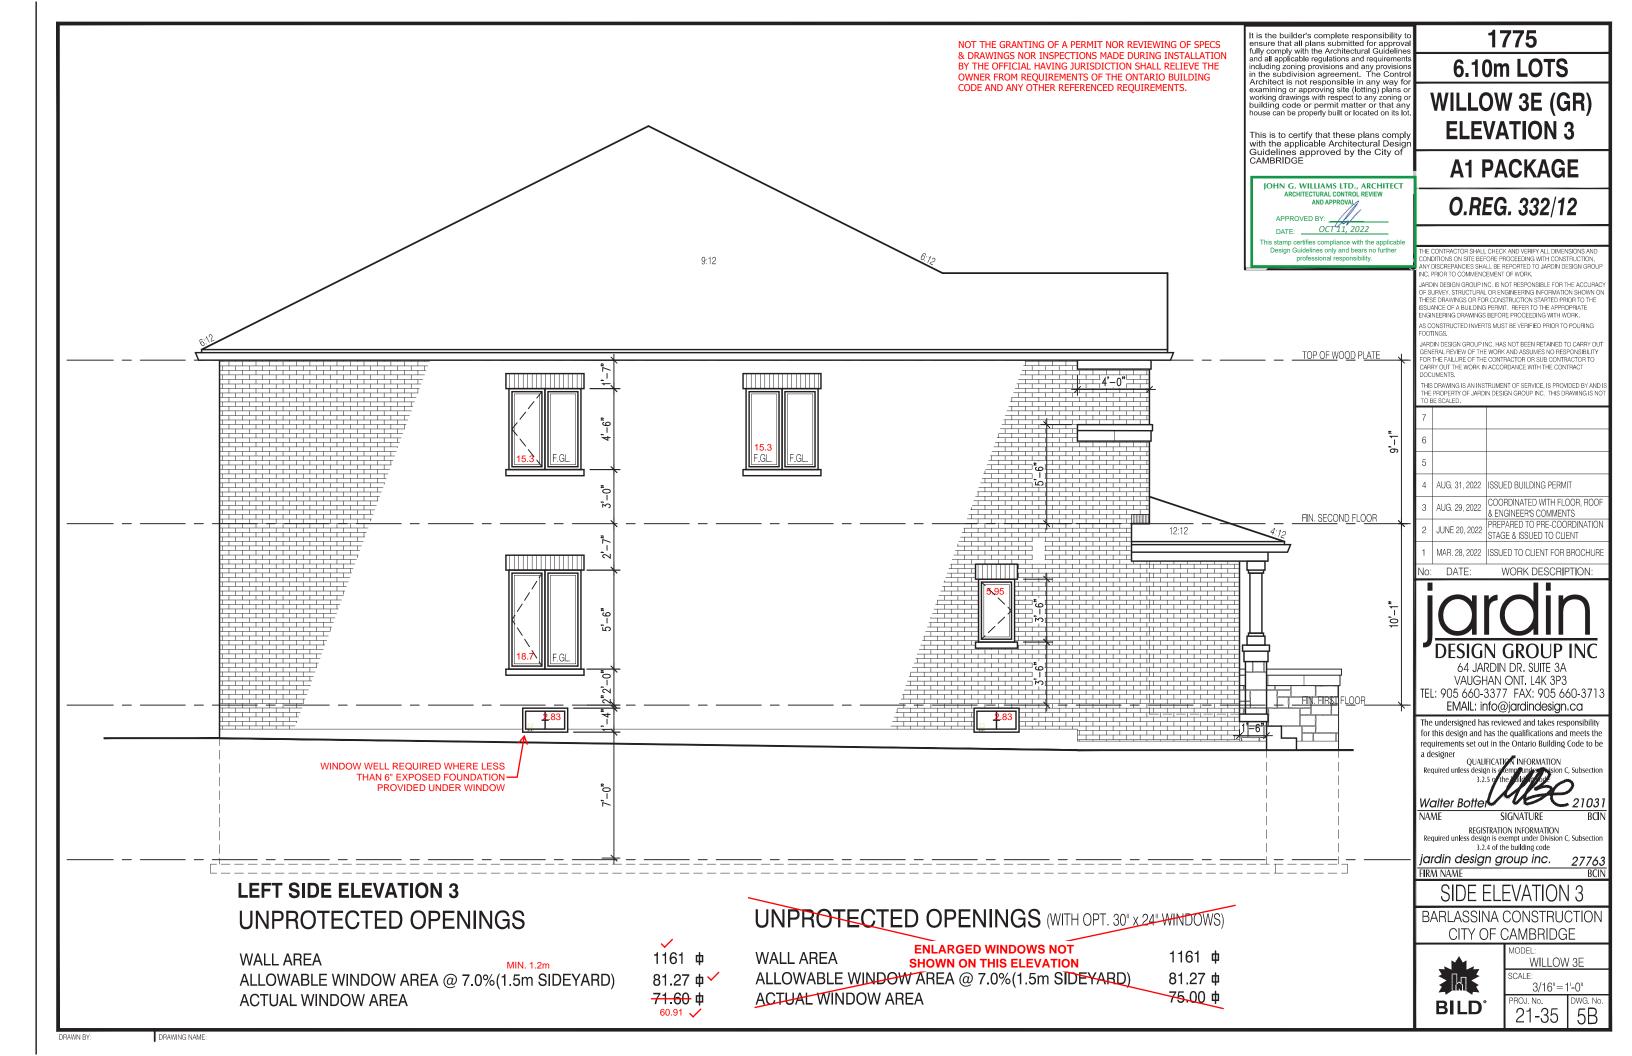

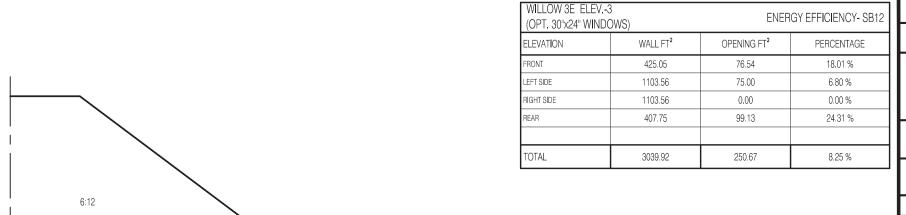

- ASPHALT SHINGLES (TYP.) PRE FINISHED ALUM. FASCIA 1/300 VENTILATION VENTED SOFFIT AND EAVES REQUIRED TROUGH (TYP.) TOP OF WOOD PLATE TOP OF WINDOW TOP OF WINDOW BRICK SOLDIER (TYP.) FACE BRICK (TYP.) PRECAST CONC SILL (TYP.) FIN. SECOND FLOOR TOP OF TRANSOM TOP OF WINDOW TOP OF DOOR 10'-1" 10'-1" MAX. 3R OR LANDING REQUIRED \_FIN. FIRST FLOOR OPT. 30" x 24" WINDOW PRECAST -LARGER WINDOW MAY CONC. STEPS 11 REQUIRE WINDOW WELL DEPENDING ONF FINAL O POURED CONC. -GRADE CONDITIONS. FOUNDATION WALL WINDOW WELL INDIRECTLY DRAIN WELL TO FOOTING (SEE FLOOR PLANS FOR CONNECTED TO WEEPING TILE DRAINAGE (TYP.) WALL THICKNESS) (3.6SQFT.) \_FIN. BASEMENT SLAB **REAR ELEVATION 3** 

> NOT THE GRANTING OF A PERMIT NOR REVIEWING OF SPECS & DRAWINGS NOR INSPECTIONS MADE DURING INSTALLATION BY THE OFFICIAL HAVING JURISDICTION SHALL RELIEVE THE OWNER FROM REQUIREMENTS OF THE ONTARIO BUILDING CODE AND ANY OTHER REFERENCED REQUIREMENTS.

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This is to certify that these plans comply with the applicable Architectural Design Guidelines approved by the City of Cambridge

JOHN G. WILLIAMS LTD., ARCHITECT ARCHITECTURAL CONTROL REVIEW AND APPROVAL APPROVED BY: DATE: OCT 11, 2022

nis stamp certifies compliance with the applicabl Design Guidelines only and bears no further professional responsibility.

1775 **6.10m LOTS** 

WILLOW 3E (GR) **ELEVATION 3** 

**A1 PACKAGE** 

O.REG. 332/12

ONDITIONS ON SITE BEFORE PROCEEDING WITH CONSTRUCTION. Y DISCREPANCIES SHALL BE REPORTED TO JARDIN DESIGN GROUI INC. PRIOR TO COMMENCEMENT OF WORK.

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| ı   | 6   |               |   |  |
| ı   | 5   |               |   |  |
| ı   | 4   | AUG. 31, 2022 | ISSUED BUILDING PERMIT                                |  |
| ı   | 3   | AUG. 29, 2022 | COORDINATED WITH FLOOR, ROOF<br>& ENGINEER'S COMMENTS |  |
| ı   | 2   | JUNE 20, 2022 | PREPARED TO PRE-COORDINATION STAGE & ISSUED TO CLIENT |  |
| ı   | 1   | MAR. 28, 2022 | ISSUED TO CLIENT FOR BROCHURE                         |  |

WORK DESCRIPTION:



VAUGHAN ONT, L4K 3P3 TEL: 905 660-3377 FAX: 905 660-3713 EMAIL: info@jardindesian.ca

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Walter Botter⊌ NAME

REGISTRATION INFORMATION
Required unless design is exempt under Division C, Subsection

3.2.4 of the building code

jardin design group inc. IRM NAME

**REAR ELEVATION 3** 

BARLASSINA CONSTRUCTION CITY OF CAMBRIDGE



WILLOW 3E SCALE:

3/16"=1'-0" ROJ. No. 21-35

