


THIS LOT GRADING PLAN HAS BEEN REVIEWED BY METROPOLITAN CONSULTING INC. FOR CONFORMANCE WITH THE APPROVED SUBDIVISION GRADING DESIGN. THE PROPOSED GRADES ON THIS PLAN ARE IN GENERAL CONFORMITY WITH THE APPROVED GRADING PLAN AS IT RELATES TO THIS LOT AND ADJACENT LOTS. WHERE THE BASEMENT FLOOR OR OTHER FOUNDATION ELEVATIONS ARE PROPOSED AT A DIFFERENT ELEVATION THAN THAT SHOWN ON THE APPROVED SUBDIVISION PLANS THE SEWER LATERALS HAVE BEEN REVIEWED AND WE ARE SATISFIED THAT THE MINIMUM GRADES FOR THESE LATERALS CAN BE MAINTAINED IN ACCORDANCE WITH THE REQUIREMENTS OF THE O.B.C. AND CITY DESIGN CRITERIA. NOTE: THIS CERTIFICATION DOES NOT REPLACE THE BUILDER'S RESPONSIBILITY TO EXPOSE THE SEWER LATERALS AND CONFIRM ELEVATIONS PRIOR TO EXCAVATING FOR THE FOUNDATION. BY USE OF THIS PLAN THE BUILDER AGREES THAT THEY SHALL BE RESPONSIBLE FOR IMMEDIATELY REPORTING TO METROPOLITAN CONSULTING ANY DISCREPANCY OR VARIATION BETWEEN THE LATERAL INFORMATION AND GRADES DEPICTED ON THIS PLAN AND THE CONDITIONS FOUND IN THE FIELD.

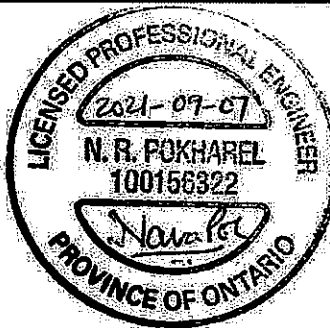

It is the builder's complete responsibility to ensure that all plans submitted for approval fully comply with the Architectural Guidelines and all applicable regulations and requirements including zoning provisions and any provisions in the subdivision agreement. The Control Architect is not responsible in any way for examining or approving site (lotting) plans or working drawings with respect to any zoning or building code or permit matter or that any house can be properly built or located on its lot.

This is to certify that these plans comply with the applicable Architectural Design Guidelines approved by the City of HAMILTON.

JOHN G. WILLIAMS LTD., ARCHITECT
ARCHITECTURAL CONTROL REVIEW
AND APPROVAL

APPROVED BY:
DATE: SEP 08, 2021

This stamp certifies compliance with the applicable Design Guidelines only and bears no further professional responsibility.

CITY OF HAMILTON
Building Division

Permit No. 21-151201


THESE STAMPED DRAWINGS SHALL BE AVAILABLE ON SITE

THE OWNER AND/OR CONTRACTOR SHALL COMPLY WITH THE ONTARIO BUILDING CODE AND ALL OTHER APPLICABLE LAW

These drawings and/or specifications have been reviewed by

CITY OF HAMILTON
BUILDING DIVISION
Planning & Development Department

SEP 13 2021

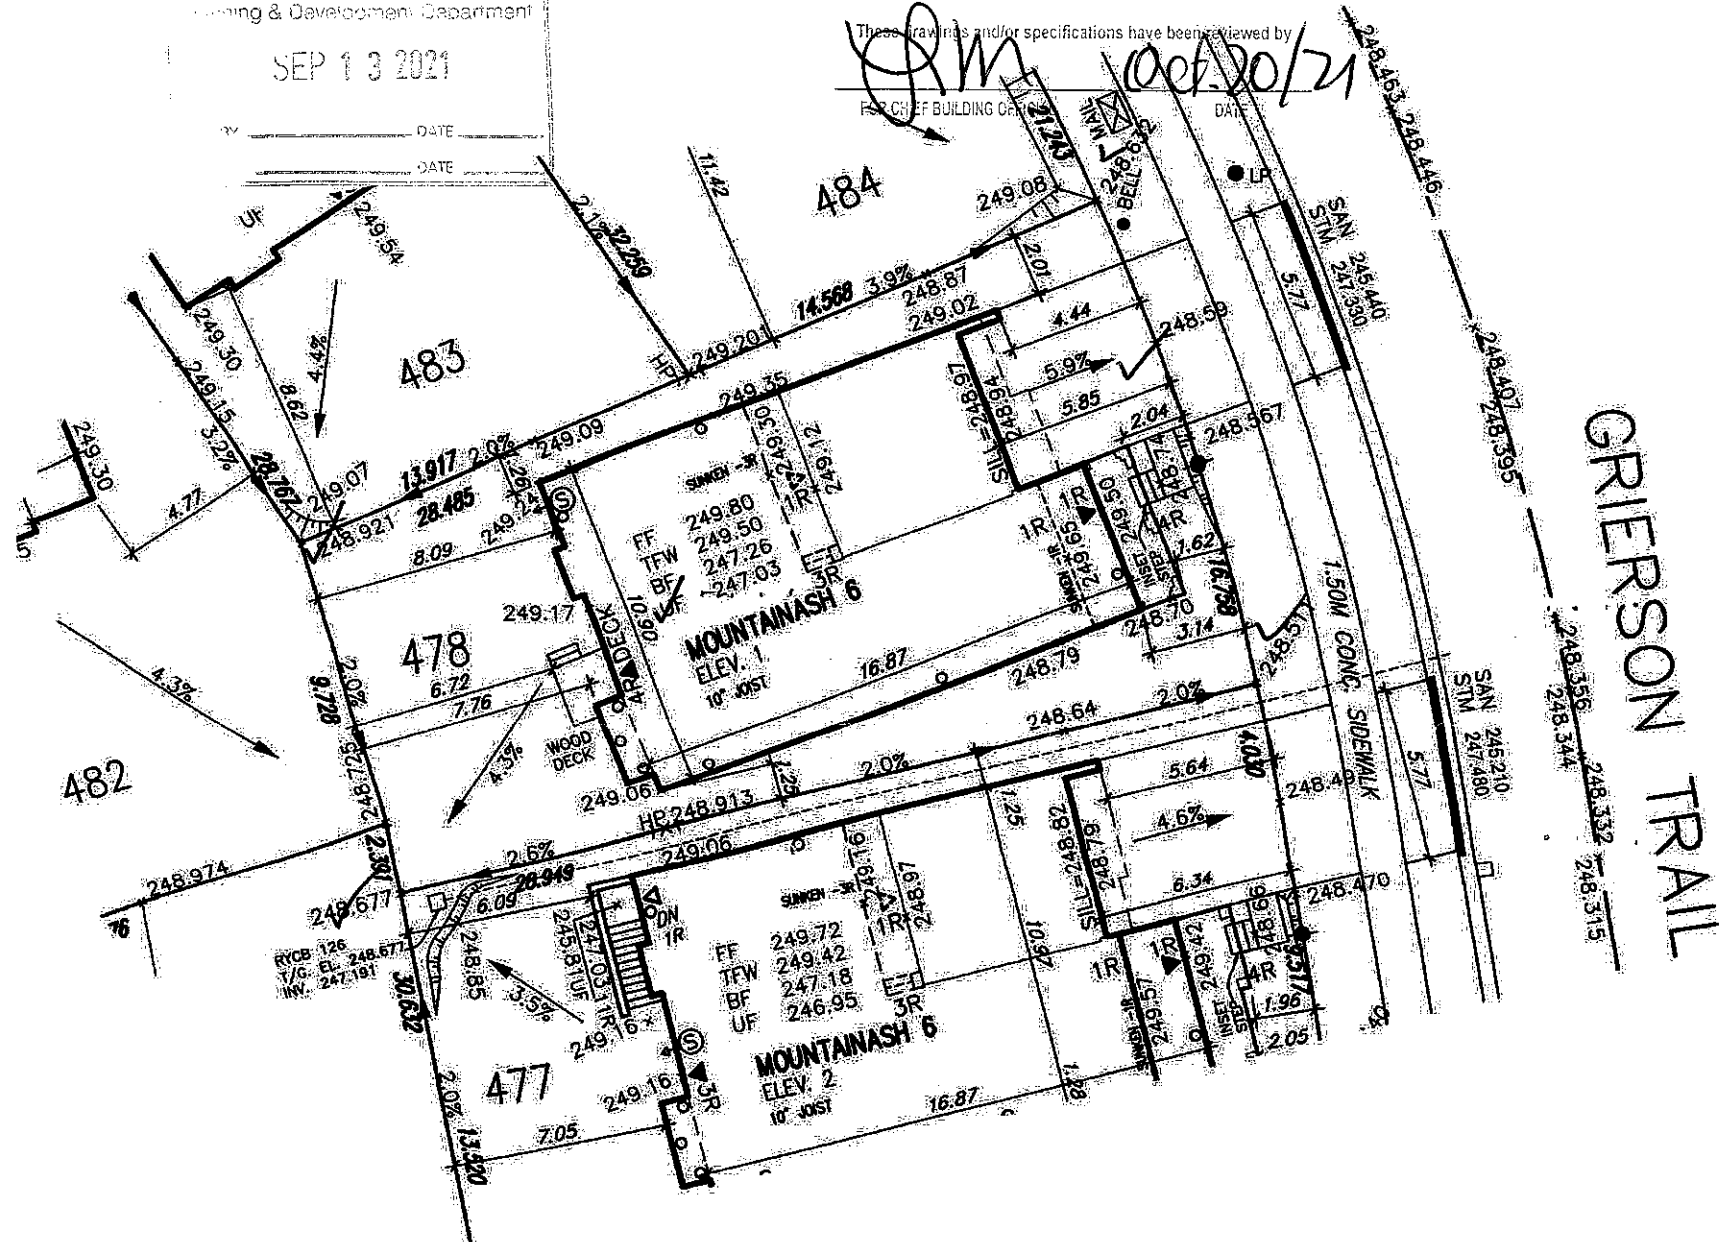

LOT 478		
LOT No.	LOT WIDTH (M) (@ 5.5m)	LOT AREA (M ²)
478	15.788	416.16

Grading Notes:

It shall be the responsibility of the builder to have all grades and services verified and checked before construction by an approved grading engineer. These grades and the placement of storm and sanitary services off the street are to meet the requirements of the municipality having jurisdiction.

VAJ Design Inc. is to be notified promptly of any discrepancies at least 1 (one) week prior to excavation commences in order that the building can be re-sited. Failure to observe these conditions may require expensive remedial action that will not be the responsibility of or cost to VAJ Design Inc. Foundation wall shall be poured to a minimum of 6" above approved grades.

Finished grade lines as indicated on the house prototype are for reference only and do not necessarily depict finish grading conditions of any particular lot.


These drawings are to be read in conjunction with municipal approved site engineering drawings prepared by Metropolitan Consulting Inc.

NOTE: REFER TO LANDSCAPE DRAWINGS FOR ALL FENCING TYPES, HEIGHTS AND LOCATIONS. CONTRACTOR TO VERIFY PRIOR TO INSTALLATION.

PROPOSED VALVE	UP LIGHT POLE	HYDRANT	TRANSFORMER
DOUBLE STM/SAN. CONNECTION	SINGLE STM/SAN. CONNECTION	CATCH BASIN	CABLE TELEVISION PEDestal
BELL PEDestal			
NO. OF ROOFS	FF FINISHED FLOOR ELEVATION	FM FIN. BASEMENT FLOOR SLAB	TFW TOP OF FOUNDATION WALL
UFR UNDERSIDE FOOTING AT REAR	UFS UNDERSIDE FOOTING AT FRONT	UFS UNDERSIDE FOOTING AT SIDE	W.O.D. WALK OUT DECK
W.O.B. WALK OUT BASEMENT	KEY	ROUNDER PLAN	

STREET SIGN	MAIL BOX	RETAINING WALL	CHAIN LINK FENCE (SEE LANDSCAPE PLAN)
ACOUSTICAL FENCE (SEE LANDSCAPE PLAN)	WOOD SCREEN FENCE (SEE LANDSCAPE PLAN)	HYDRO SERVICE LATERAL	HYDRO METER
GAS METER	SHALE DIRECTION	EMBANKMENT (ET. SLOPE UNLESS OTHERWISE NOTED)	

PROVIDE 3/4" DIA. CLEAR STONE IN THIS AREA	THIS LOT CONTAINS ENGINEERED FILL	MR. CONDITIONER REQUIRED	RAIN WATER DOWNSPOUT LOCATION (DISCHARGE INTO SPLASHPAD)
SIDE WINDOW LOCATION	OPT. DOOR LOCATION	EXTERIOR DOOR LOCATION	REDUCE SIDE YARD

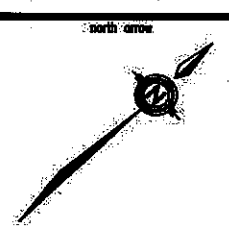

no.	description	date	by
1	ISSUED FOR PERMIT	AUG 27/21	GW

qualification information	signature	24488
name	signature	42658
VAJ Design Inc.		
Builder to verify location of all hydrants, street lights, transformers and other services. If minimum dimensions are not maintained, builder is to relocate at his own expense.		
Builder to verify service connection elevations prior to constructing foundations. All drawings NOT to be added to.		

VA3 DESIGN
255 Consumers Rd Suite 120
Toronto, ON M2J 1R4
416.630.2255 / 416.630.4782
v3design.com

Greenpark
project name: RUSSELL GARDENS PHASE 4
municipality: HAMILTON
date: JUL 2021
drawn by: GW
checked by:
scale: 1:250
LOT SITING/GRADING
20027-RG4-SITE-LAYOUTS
date: Aug 27, 2021 9:05 AM

lot/block no.	478
registered plan no.	62M-1266
project no.	20027
drawing no.	1

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