

## **Planning and Development Services**

Building Division 8850 McLaughlin Road, Unit 1 Brampton, ON L6Y 5T1

## WATER PIPE SIZING AND PLUMBING DATA SHEET CERTIFIED MODEL WITH ONE DWELLING UNIT

## THIS TABLE IS APPLICABLE FOR A HOUSE AFTER DECEMBER 31, 2017

**Builder Name:** 


**GREENPARK HOMES** 

**Certified Model Name:** 

**HEMLOCK 3** 

**Optional Floor Layout:** 

**Application No.:** 

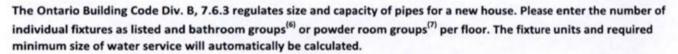

Description	Basement Floor Qty.	First Floor Qty.	Second Floor Qty.	Third Floor Qty.
Bidet				
Extra Shower			1	
Lav				
Bar Sink	ame to a supplement of the			
Powder room <sup>(7)</sup>				
Kitchen Sink		1		
Dishwasher		1		
Laundry Tub	1			
Washing Machine	1	_		
Hose Bib		2 C	TY OF BRAI	MPTON

Total Fixture Units 22.8 25. 7 F.U.

Minimum Diametre of Water Service Pipe
Required from the Property Line to the 3/4

House (Inch)

Notes:

MAR 2 8 2019

REVIEWED

(1) A potable water system shall be designed, constructed and installed to conform to good engine

practice appropriate to the circumstances, such as that described in the ASHRAE Handbooks and ASPE Data Books.

(2) No water system between the point of connection with the water service pipe or the water meter and

(2) No water system between the point of connection with the water service pipe or the water meter and the first branch that supplies a water heater that serves more than one fixture shall be less than ¾ in. in size.

(3) The minimum water pressure at the entry to the building is 200 kPa, and the total maximum length of the water system is 90 m.

(4) In a hot water distribution system of a developed length of more than 30 m from the HWT to the farthest fixture or supplying more than 4 storeys, the water temperature shall be maintained by, (a) recirculation, or (b) a self-regulating heat tracing system.

(5)


Where piping may be exposed to freezing conditions, it shall be protected from the effects of freezing.

(6) A bathroom group consists of 1 water closet, 1 lavatory, and 1 bathtub (with or without showerhead)

(7) A powder room group consists of 1 water closet and 1 lavatory.

PLEASE SEE NOTES AS TH OF THE REVIEW

Swhite

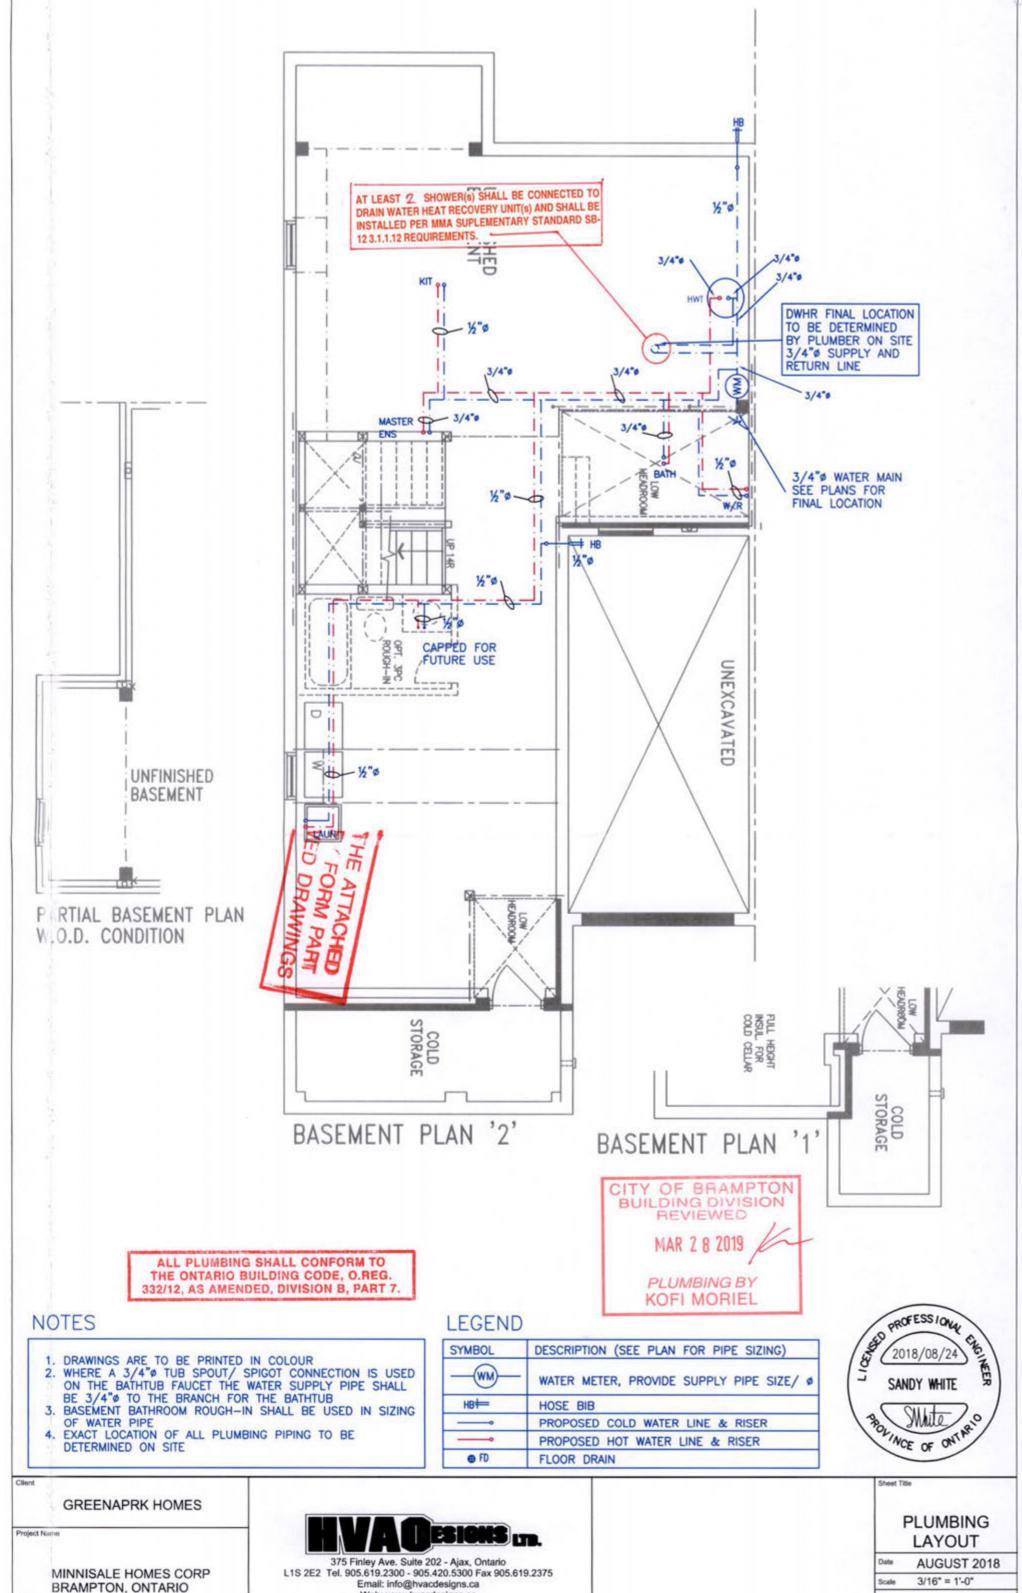


OPT 4 BED **HEMLOCK 3** 

1928 sqft

Web: www.hvacdesigns.ca Specializing in Residential Mechanical Design Services

> 79573 LO#

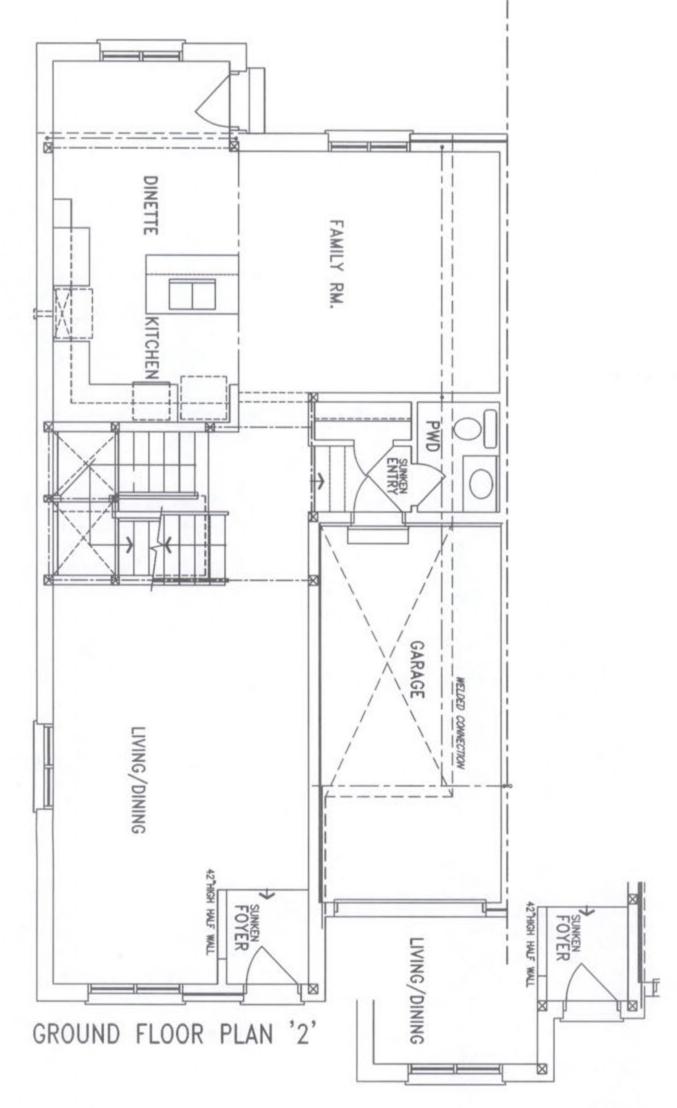

GROUND FLOOR PLAN '1'

CITY OF BRAMPTON BUILDING DIVISION REVIEWED

MAR 2 8 2019

PLUMBING BY KOFI MORIEL



Client

GREENAPRK HOMES

Project Name

MINNISALE HOMES CORP BRAMPTON, ONTARIO

OPT 4 BED HEMLOCK 3

1928 sqft




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Sheet Title

PLUMBING LAYOUT

Date AUGUST 2018 Scale 3/16" = 1'-0"

LO# 79573

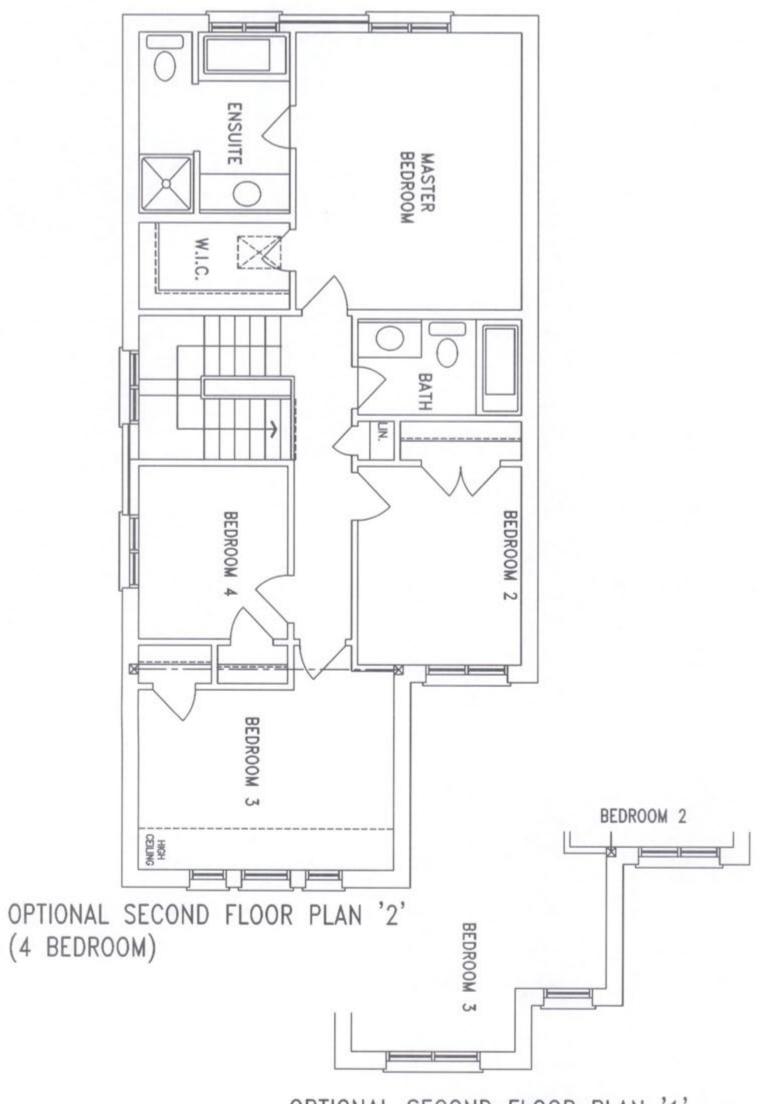

OPTIONAL SECOND FLOOR PLAN '1' (4 BEDROOM)

CITY OF BRAMPTON BUILDING DIVISION REVIEWED

MAR 2 8 2019

PLUMBING BY KOFI MORIEL



GREENAPRK HOMES

Project Name

MINNISALE HOMES CORP BRAMPTON, ONTARIO

OPT 4 BED HEMLOCK 3

1928 sqft



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PLUMBING LAYOUT

Oate AUGUST 2018
Scale 3/16" = 1'-0"

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