

## **Planning and Development Services**

Building Division 8850 McLaughlin Road, Unit 1 Brampton, ON L6Y 5T1

## WATER PIPE SIZING AND PLUMBING DATA SHEET CERTIFIED MODEL WITH ONE DWELLING UNIT

## THIS TABLE IS APPLICABLE FOR A HOUSE AFTER DECEMBER 31, 2017

**Builder Name:** 


**GREENPARK HOMES** 

**Certified Model Name:** 

**HEMLOCK 3** 

**Optional Floor Layout:** 

**Application No.:** 

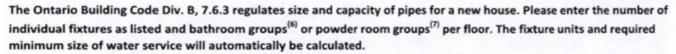

Description	Basement Floor Qty.	First Floor Qty.	Second Floor Qty.	Third Floor Qty.
Bidet				
Extra Shower			1	
Lav				
Bar Sink				
Powder room <sup>(7)</sup>				
Kitchen Sink		1		
Dishwasher		1	The second	
Laundry Tub	1			
Washing Machine	1			
Hose Bib		2		

**Total Fixture Units** 

22.8 25.7 F.U.

Minimum Diametre of Water Service Pipe

Required from the Property Line to the

the Property Line to the

House (Inch)

Notes:


- (1) A potable water system shall be designed, constructed and installed to conform to good engineering practice appropriate to the circumstances, such as that described in the ASHRAE Handbooks and ASPE Data Books.
- (2) No water system between the point of connection with the water service pipe or the water meter and the first branch that supplies a water heater that serves more than one fixture shall be less than ¾ in. in size.
- (3) The minimum water pressure at the entry to the building is 200 kPa, and the total maximum length of the water system is 90 m.
- the water system is 90 m.


  (4) In a hot water distribution system of a developed length of more than 30 m from the HWT to the PLEASE SEE The farthest fixture or supplying more than 4 storeys, the water temperature shall be maintained by, (aNOTES AS THE) recirculation, or (b) a self-regulating heat tracing system.

(5)

Where piping may be exposed to freezing conditions, it shall be protected from the effects of freezing.

- (6) A bathroom group consists of 1 water closet, 1 lavatory, and 1 bathtub (with or without showerhead)
- (7) A powder room group consists of 1 water closet and 1 lavatory.

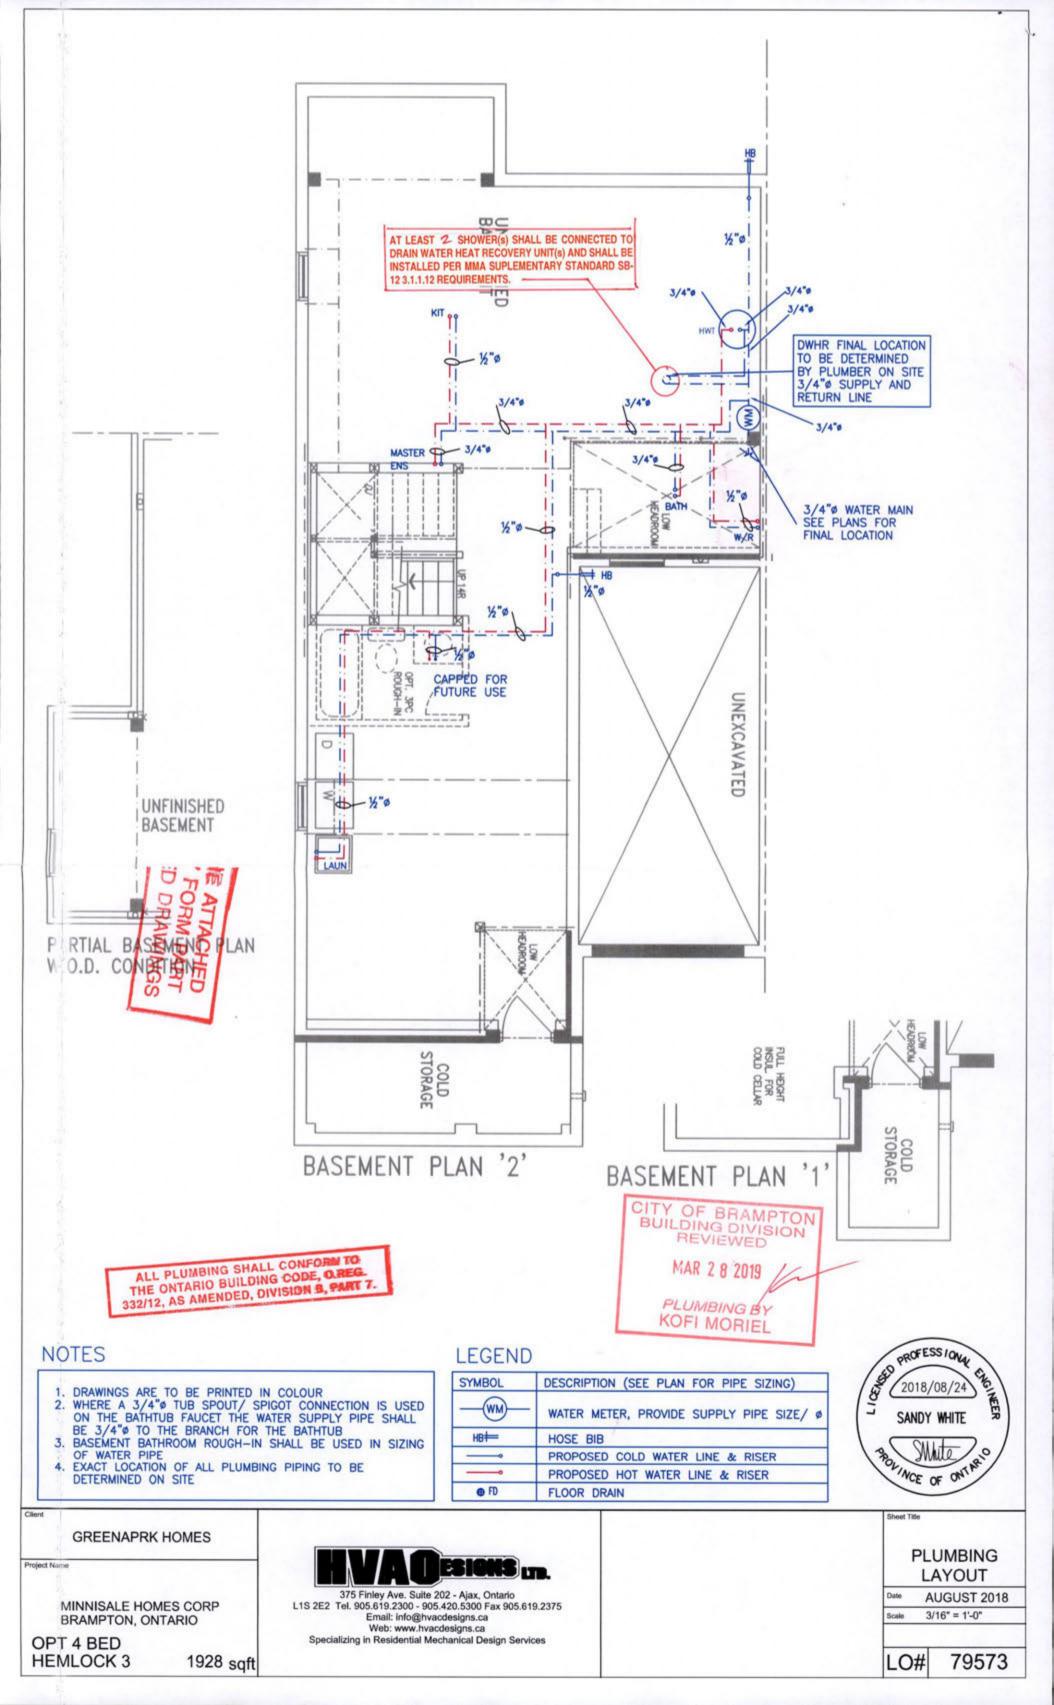

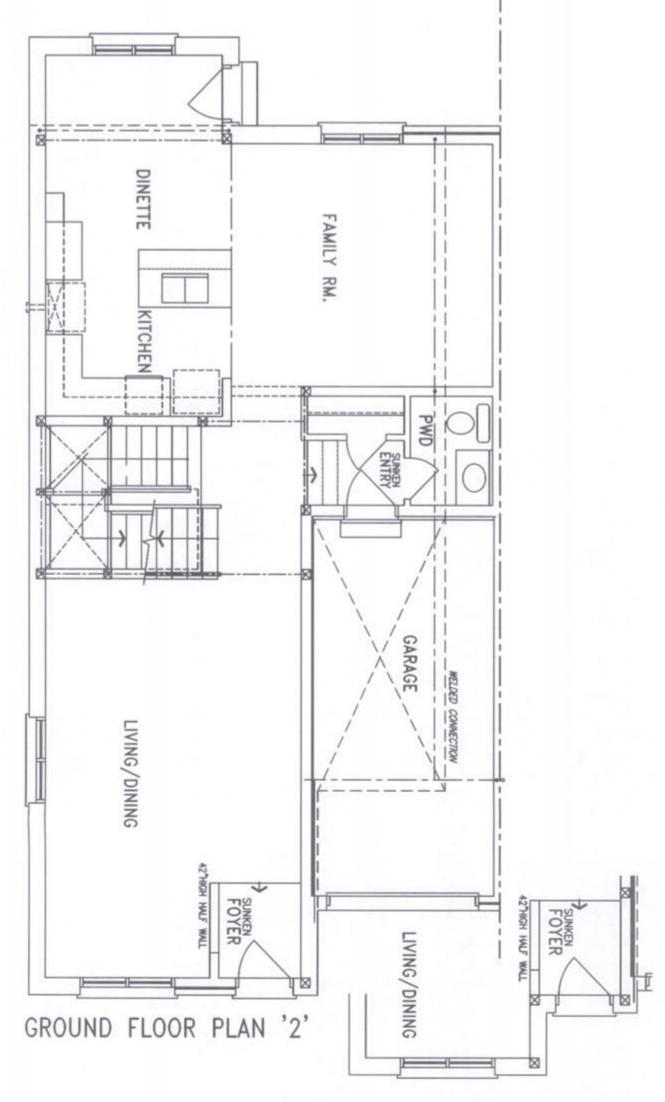

GROUND FLOOR PLAN '1'

CITY OF BRAMPTON BUILDING DIVISION REVIEWED

MAR 2 8 2019

PLUMBING BY KOFI MORIEL



Client

GREENAPRK HOMES

Project Name

MINNISALE HOMES CORP BRAMPTON, ONTARIO

OPT 4 BED HEMLOCK 3

1928 sqft




375 Finley Ave. Suite 202 - Ajax, Ontario
L1S 2E2 Tel. 905.619.2300 - 905.420.5300 Fax 905.619.2375
Email: Info@hvacdesigns.ca
Web: www.hvacdesigns.ca
Specializing in Residential Mechanical Design Services

Sheet Title

PLUMBING LAYOUT

Date AUGUST 2018 Scale 3/16" = 1'-0"

LO# 79573

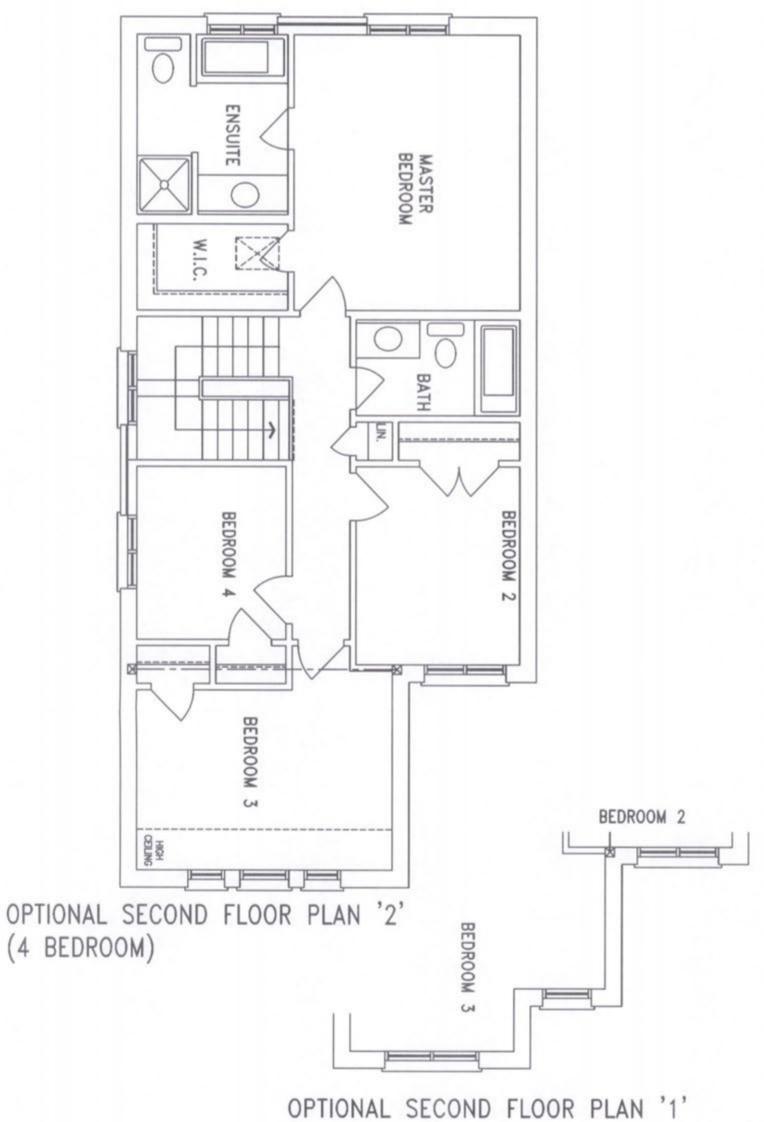

(4 BEDROOM)

CITY OF BRAMPTON BUILDING DIVISION REVIEWED

MAR 2 8 2019

PLUMBING BY KOFI MORIEL



**GREENAPRK HOMES** 

Project Name

MINNISALE HOMES CORP BRAMPTON, ONTARIO

OPT 4 BED **HEMLOCK 3** 

1928 sqft



375 Finley Ave. Suite 202 - Ajax, Ontario L1S 2E2 Tel. 905.619.2300 - 905.420.5300 Fax 905.619.2375 Email: info@hvacdesigns.ca Web: www.hvacdesigns.ca Specializing in Residential Mechanical Design Services

**PLUMBING** LAYOUT

AUGUST 2018 3/16" = 1'-0"

LO# 79573