

Planning and Development Services

Building Division 8850 McLaughlin Road, Unit 1 Brampton, ON L6Y 5T1



WATER PIPE SIZING AND PLUMBING DATA SHEET CERTIFIED MODEL WITH ONE DWELLING UNIT

THIS TABLE IS APPLICABLE FOR A HOUSE AFTER DECEMBER 31, 2017

Builder Name:

GREENPARK HOMES

Certified Model Name:

Optional Floor Layout: Application No.:

HEMLOCKS -LOT 3

The Ontario Building Code Div. B, 7.6.3 regulates size and capacity of pipes for a new house. Please enter the number of individual fixtures as listed and bathroom groups (6) or powder room groups (7) per floor. The fixture units and required minimum size of water service will automatically be calculated.

Description	Basement Floor Qty.	First Floor Qty.	Second Floor Qty.	Third Floor Qty.
Bidet				
Extra Shower			1	
Lav				
Bar Sink				
Powder room (7)				
Kitchen Sink		1		
Dishwasher		1		
Laundry Tub	1			
Washing Machine	1			
Hose Bib		2		

Total Fixture Units 22.8


Minimum Diametre of Water Service Pipe Required from the Property Line to the

3/4

House (Inch)

Notes:

- (1) A potable water system shall be designed, constructed and installed to conform to good engineering practice appropriate to the circumstances, such as that described in the ASHRAE Handbooks and ASPE Data Books.
- (2) No water system between the point of connection with the water service pipe or the water meter and the first branch that supplies a water heater that serves more than one fixture shall be less than ¾ in.
- (3) The minimum water pressure at the entry to the building is 200 kPa, and the total maximum length of the water system is 90 m.
- (4) In a hot water distribution system of a developed length of more than 30 m from the HWT to the farthest fixture or supplying more than 4 storeys, the water temperature shall be maintained by, (a) recirculation, or (b) a self-regulating heat tracing system.
- - Where piping may be exposed to freezing conditions, it shall be protected from the effects of freezing.
- (6) A bathroom group consists of 1 water closet, 1 lavatory, and 1 bathtub (with or without showerhead)
- (7) A powder room group consists of 1 water closet and 1 lavatory.

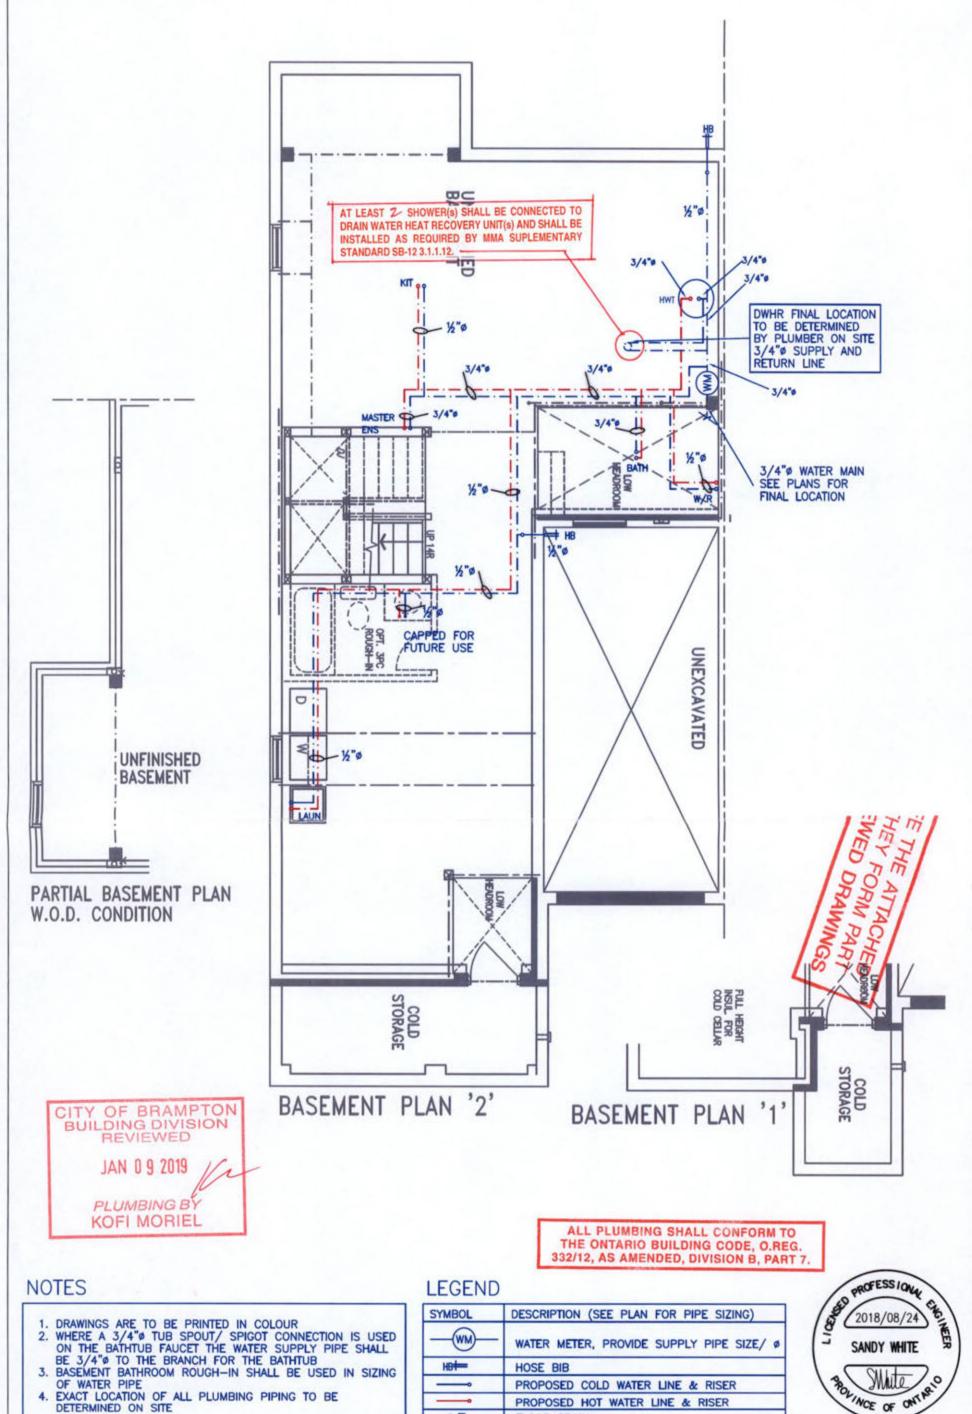

Client **GREENAPRK HOMES**

Project Name 101

MINNISALE HOMES CORP BRAMPTON, ONTARIO

OPT 4 BED **HEMLOCK 3**

1928 sqft


SYMBOL	DESCRIPTION (SEE PLAN FOR PIPE SIZING)
	WATER METER, PROVIDE SUPPLY PIPE SIZE/ Ø
HB=	HOSE BIB
	PROPOSED COLD WATER LINE & RISER
-	PROPOSED HOT WATER LINE & RISER
● FD	FLOOR DRAIN

POLINCE OF ONTIPIO

PLUMBING LAYOUT 375 Finley Ave. Sulte 202 - Ajax, Ontario L1S 2E2 Tel. 905.619.2300 - 905.420.5300 Fax 905.619.2375 AUGUST 2018 Email: info@hvacdesigns.ca Web: www.hvacdesigns.ca Specializing in Residential Mechanical Design Services

3/16" = 1'-0"

LO# 79573

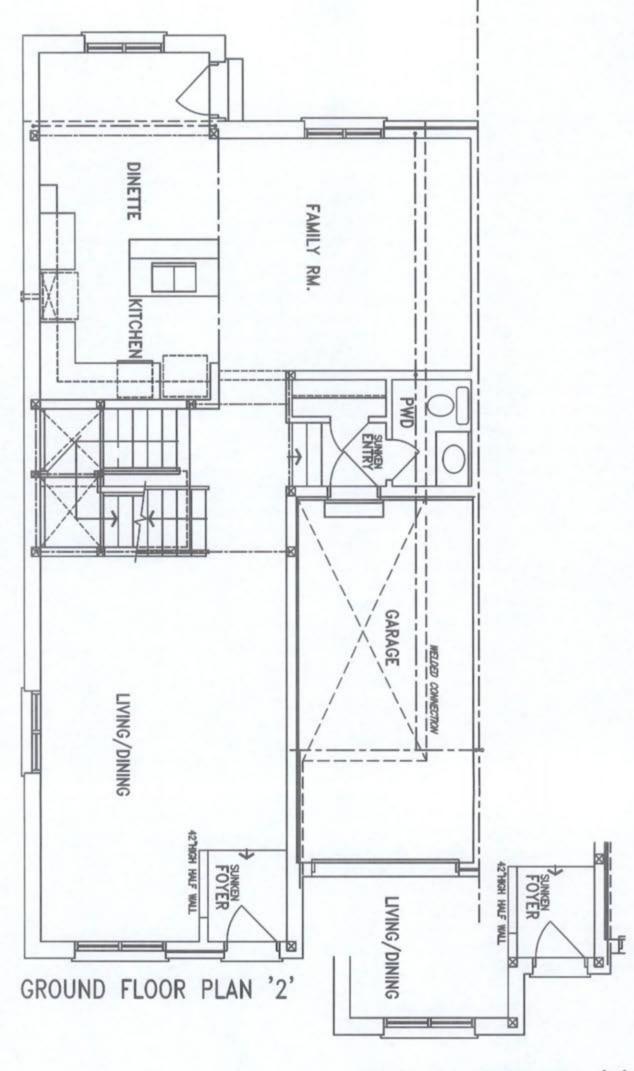

GROUND FLOOR PLAN '1'

CITY OF BRAMPTON BUILDING DIVISION REVIEWED


JAN 0 9 2019

PLUMBING BY KOFI MORIEL



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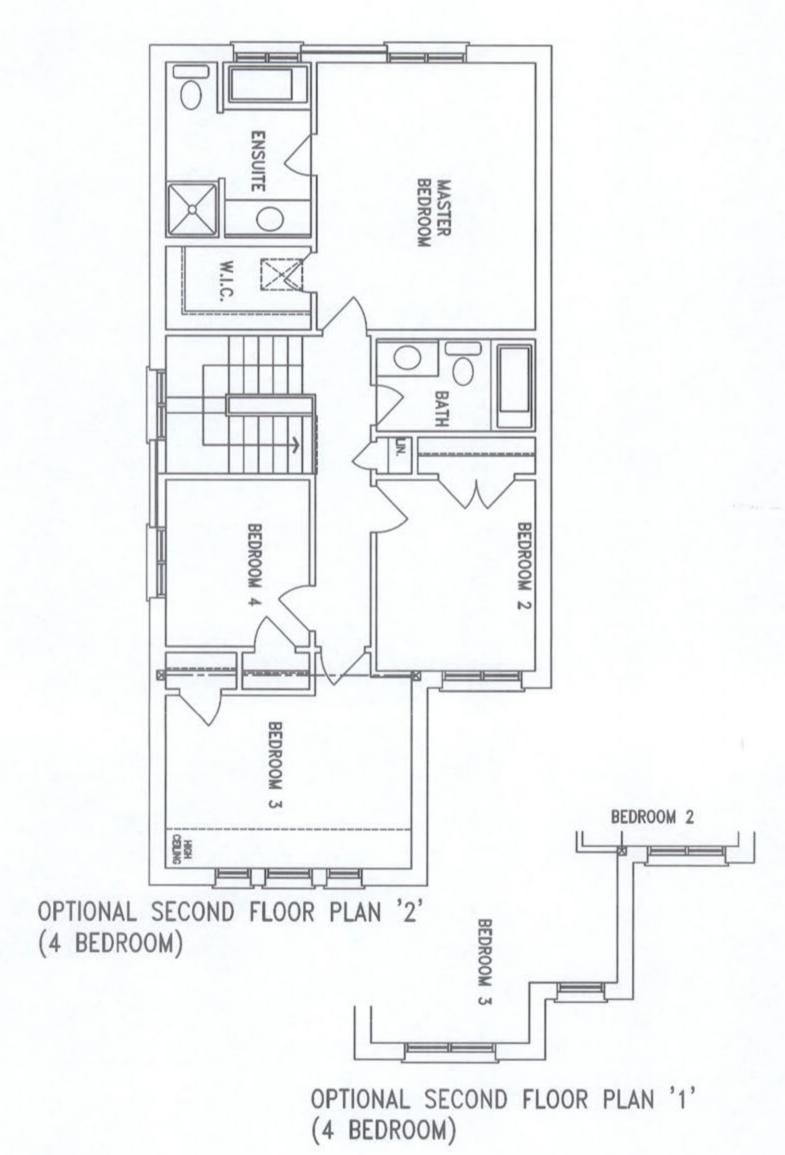
Sheet Title

PLUMBING LAYOUT

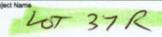AUGUST 2018

Scale 3/16" = 1'-0"

LO# 79573



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JAN 0 9 2019

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