DOC NOS.							
		8' to 9' CEILING	CEILING				
1 10 2 3 4 5 6 7	2'-10" 2'-8" 2'-8" 2'-8" 2'-6" 2'-2" 1'-6"	6'-8" 6'-8" 6'-8" 6'-8" 6'-8" 6'-8"	8'-0" 8'-0" 8'-0" 8'-0" 8'-0" 8'-0" 8'-0"	INSULATED ENTRANCE DOOR INSULATED FRONT DOORS WOOD & GLASS DOOR INSULATED EXT. SLAB DOOR INTERIOR SLAB DOOR			
FRAMIC TILE FOR CONVENTIONAL LUMBER							

TO

7 1'-	6" 6'-8"	8'-0"	INTERIOR
CERAMIC TILE	OR CONVENTION	AL LUMBER	

SPACE ALL CONVENTIONAL FLOOR JOISTS @ 12" O.C. BELOW ALL CERAMIC TILE AREAS. PROVIDE 1 ROW BRIDGING FOR SPANS OF 5'0"-7'0", 2 ROWS FOR SPANS GREATER THAN 7'0".

NOTE: ROOF FRAMING REFER TO ROOF TRUSS SHOP DRAWINGS FOR AL ROOF FRAMING INFORMATION UNLESS OTHERWISE NOTED.
REFER TO ROOF TRUSS SHOP DRAWINGS FOR AL
ROOF FRAMING INFORMATION UNLESS OTHERWISE
NOTED

VENEER CUT WHEN VENEER CUT IS GREATER THAN 26", A 10"	PLANS NOT DRAWN TO ACTUAL GRADE. FINAL APPROVED GRADING PLAN.	REFER
	i	

STRIP FOOTINGS - FOR SINGLES & SEMIS UP TO 2 STOREYS 8" OR 10" FOUNDATION WALLS WITH 2"x8" / 2"x10" FLOOR JOISTS 20"x6" CONCRETE STRIP FOOTINGS BELOW FOUNDATION WALLS.

FOUNDATION WALLS WITH ENGINEERED JOISTS OVER 16' SPANS 24"x8" CONCRETE STRIP FOOTINGS BELOW FOUNDATION WALLS.

assume the larger footing size when two conditions apply ASSUMED 120 KPa (18 p.s.i.) SOIL BEARING CAPACITY FOR SINGLES OR 90 KPa FOR ENGINEERED FILL, TO BE VERIFIED ON SITE.

F1 = 42"x42"x18" CONCRETE PAD F1 = 48"x48"x20" CONCRETE PAD F2 = 36"x36"x16" CONCRETE PAD F2 = 40"x40"x16" CONCRETE PAD F3 = 30"x30"x12" CONCRETE PAD F3 = 34"x34"x14" CONCRETE PAD F4 = 24"x24"x12" CONCRETE PAD F4 = 28"x28"x12" CONCRETE PAD F5 = 16"x16"x8" CONCRETE PAD F5 = 18"x18"x8" CONCRETE PAD (REFER TO FLOOR PLAN FOR UNUSUAL SIZE PADS NOT ON CHART.)

POURED CONCRETE FOUNDATION WALL IS REQUIRED.

EXPOSED CONCRETE (FLATWORK) ALL GARAGE SLABS, PORCH SLABS, STAIRS (EXPOSED CONC. FLAT WORK) TO BE 32 MPa. WITH 5-8% AIR ENTRAINMENT.

**WL1** =3-1/2" x 3-1/2" x 1/4"L (9Dx90x6.0L) + 2-2"x8" SPR. No.2 **WL2** =4" x 3-1/2" x 5/16"L (100x90x8.0L) + 2-2"x8" SPR. No.2

BRICK VENEER LINTELS (WL)

WL1 =3-1/2" x 3-1/2" x 1/4"L (90x90x6.0L) WL2 =4" x 3-1/2" x 5/16"L (100x90x8.0L) WL3 =5" x 3-1/2" x 5/16"L (125x90x8.0L) WL4 =6" x 3-1/2" x 3/8"L (150x90x10.0L) WL5 =6" x 4" x 3/8"L (150x100x10.0L) WL6 =5" x 3-1/2" x 5/16"L (125x90x8.0L) WL7 =5" x 3-1/2" x 5/16"L (125x90x8.0L) WL8 =5" x 3-1/2" x 5/16"L (125x90x8.0L) WL9 =6" x 4" x 3/8"L (150x100x10.0L)

WOOD LINTELS AND BEAMS (WB)

LAMINATED VENEER LUMBER (LVL) BEAMS

| STATESTAND | STA

=2-1 3/4"x14" (2-45x356) =3-1 3/4"x14" (3-45x356)

L1 =3-1/2" x 3-1/2" x 1/4"L (90x90x6.0L) L2 =4" x 3-1/2" x 5/16"L (100x90x8.0L) L3 =5" x 3-1/2" x 5/16"L (125x90x8.0L) L4 =6" x 3-1/2" x 3/8"L (150x90x10.0L) L5 =6" x 4" x 3/8"L (150x100x10.0L) L6 =7" x 4" x 3/8"L (180x100x10.0L)

LOOSE STEEL LINTELS (L)

WB1 =2-2"x8" (2-38x184) SPR. No.2 WB2 =3-2"x8" (3-38x184) SPR. No.2 WB3 =2-2"x10" (2-38x235) SPR. No.2 WB4 =3-2"x10" (3-38x235) SPR. No.2 WB5 =2-2"x12" (2-38x286) SPR. No.2 WB6 =3-2"x12" (3-38x286) SPR. No.2 WB7 =5-2"x12" (5-38x286) SPR. No.2 WB11 =4-2"x10" (4-38x235) SPR. No.2 WB12 =4-2"x12" (4-38x286) SPR. No.2

LVL6A

90 KPg. ENGINEERED FILL SOIL

+ 2-2"x10" SPR. No.2 + 2-2"x12" SPR. No.2

+ 2-2"x12" SPR. No.2 + 2-2"x12" SPR. No.2 + 3-2"x12" SPR. No.2 + 3-2"x10" SPR. No.2

+ 3-2"x10" SPR. No.2

24"x8" CONCRETE STRIP FOOTINGS BELOW PARTY WALLS.

FOOTINGS ON ENGINEERED FILL 24"x0" CONCRETE STRIP FOOTINGS WITH REINFORCING.

30"x8" CONCRETE STRIP FOOTINGS WITH REINFORCING.

(REFER TO ENGINEER FILL FOOTING DETAIL)

BELOW EXTERIOR WALLS.

PAD FOOTINGS

120 KPa. NATIME SOIL

BELOW PARTY WALLS.


=	NOTE: ENGINEERED FLOOR FRAMING
	REFER TO ENGINEERED FLOOR FLAYOUTS FOR ALL
	ENGINEERED FLOOR FRAMING INFORMATION AND
	DETAILS AND SECONDS MOTES

DETAILS, UNLESS OTHERWISE NOTED.
TWO STOREY HEIGHT
WALL DETAIL
2-2"x6" STUD WALL NAILED TOGETHER AND
SPACED @ 12"oo FUUL HEICHT o/w SOUD

EXT. PLYWOOD SHEATHING.
70.1M.XXX.1M.XXX.1M.XX?
<u> amanama</u>
12" 12" 12"
NOTE: MAXIMUM HEIGHT OF WALL FOR THIS DETAIL IS 18'-0" AND MAX. SUPPORTED
DETAIL IS 18'-O" AND MAX. SUPPORTED

BLOCKING # 4'-0" o.c. VERTICAL AND 7/16"

1	INO STUREY HEIGHT
	WALL DETAIL
1	2-1 1/2"x 5 1/2" TIMBERSTRAND (LSL) 1.5E
	STUD WALL GLUED & NAILED TOGETHER AND
	SPACED MAX. • 10°o.c. FULL HEIGHT, c/w SOLIL
	BLOCKING @ 8'-0" a.c. VERTICAL AND 7/16"
ı	EXT. OSB SHEATHING.

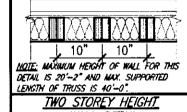

<u>WALL DETAIL</u>	
2-1 1/2"x 5 1/2" TIMBERSTRAND (LSL) 1.50	Ε
STUD WALL GLUED & MAILED TOGETHER AND	
SPACED MAX. • 9"o.c. FULL HEIGHT, c/w SOL	1
BLOCKING @ 8'-0" a.c. VERTICAL AND 7/16"	*
EXT. OSB SHEATHING.	

<u>NOTE:</u> MAXIMUM HEIGHT OF WALL FOR THIS DETAIL IS 21'-5" AND MAX. SUPPORTED LENGTH OF TRUSS IS 40'-0".

It is the builder's complete responsibility to ensure that all plans submitted for approval fully comply with the Architectural Guidelines and all applicable regulations and requirements including zoning provisions and any provisions in the subdivision agreement. The Control Architect is not responsible in any way for examining or approving site (totting) plans or working drawings with respect to any zoning of building code or permit matter or that any house can be properly built or located on its lot.

This is to certify that these plans comply with the applicable Architectural Design Guidelines approved by the City of HAMILTON.



STRUDET INC FOR STRUCTURE ONLY

HIGHGROVE 3 ELEVATION 1	ENERGY EFFICIENCY - OBC SB12			
ELEVATION	WALL AREA S.F.	OPENING S.F.	PERCENTAGE	
FRONT	471 S.F.	124.42 S.F.	26.42 %	
LEFT SIDE	965 S.F.	00.0 S.F.	0.00 %	
RIGHT SIDE	965 S.F.	00.0 S.F.	0.00 %	
REAR	445 S.F.	116.17 S.F.	26.11 %	
* Openings omitted as Per SB-12 3.1.1.9(4) Max 19.9 S.F. REFER TO ELEVATION FOR LOCATION		00.0 S.F.		
TOTAL SQ. FT.	2846.00 S.F.	240.59 S.F.	B.45 %	
TOTAL SQ. M.	264.40 S.M.	92.35 S.M.	8.45 %	

UNINSULATED OPENINGS (PER OBC. SB-12,3.1.1(7))					
HIGHGROVE 3 ELEVATION 2 ENERGY EFFICIENCY - OBC SB12					
ELEVATION	WA'L AREA S.F.	OPENING S.F.	PERCENTA	AGE	
FRONT	466 S.F.	127.50 S.F.	27.36	%	
LEFT SIDE	965 S.F.	00.0 S.F.	0.00	%	
RIGHT SIDE	965 S.F.	00.0 S.F.	0.00	%	
REAR	445 S.F.	116.17 S.F.	26.11	%	
* OPENINGS OMITTED AS PER SB-12 3.1.1.9(4) WAX 19.9 S.F. REFER TO ELEVATION FOR LOCATION		00.0 S.F.			
TOTAL SQ. FT.	2841.00 S.F.	243.67 S.F.	8.58	%	
TOTAL SQ. M.	263.94 S.M.	22.64 S.M.	8.58	*	

UNINSULATED OPENINGS (PER OBC. SB-12,3.1.1(7))				
HIGHGROVE 3 ELEVATION 3 ENERGY EFFICIENCY - OBC SB12				
ELEVATION	WALL AREA S.F.	OPENING S.F.	PERCENTAGE	
FRONT	461 S.F.	139.75 S.F.	30.31 %	
LEFT SIDE	965 S.F.	00.0 S.F.	0.00 %	
RIGHT SIDE	965 S.F.	00.0 S.F.	0.00 %	
REAR	445 S.F.	116.17 S.F.	26.11 %	
* OPENINGS OMITTED AS PER SB-12 3.1.1.9(4) MAX 19.9 S.F. REFER TO ELEVATION FOR LOCATION		00.0 S.F.		
TOTAL SQ. FT.	2836.00 S.F.	255.92 S.F.	9.02 %	
TOTAL SQ. M.	263.47/8.M.	23.78 S\M.	9.02 %	

AREA CALCULATIONS	ELEV '1'
GROUND FLOOR AREA SECOND FLOOR AREA	833 SF 1069 SF
TOTAL FLOOR AREA	1902 SF
	(176.70 m2)
FIRST FLOOR OPEN AREA	XX SF
SECOND FLOOR OPEN AREA	XX SF
add total open areas	+XX SF
add finished bswt area	+XX SF
GROSS FLOOR AREA	1902 SF
	(176.70 m2)
GROUND FLOOR COVERAGE	833 SF
GARAGE COVERAGE/AREA	273 SF
PORCH COVERAGE/AREA	96 SF
COVERAGE W/ PORCH	1202 SF
_	(111.67 m2)
COVERAGE W/O PORCH	1106 SF
•	(102.75 m2)

AREA CALCULATIONS	<u>FLEV '2'</u>
GROUND FLOOR AREA SECOND FLOOR AREA	842 SF 1078 SF
TOTAL FLOOR AREA	1920 SF (178.37 m2)
FIRST FLOOR OPEN AREA SECOND FLOOR OPEN AREA	XX SF XX SF
ADD TOTAL OPEN AREAS ADD FINISHED BSMT AREA	+XX SF +XX SF
GROSS FLOOR AREA	1920 SF (178.37 m2)
GROUND FLOOR COVERAGE GARAGE COVERAGE/AREA PORCH COVERAGE/AREA	842 SF 273 SF 48 SF
COVERAGE W/ PORCH	1163 SF (108.04 m2)
COVERAGE W/O PORCH	1115 SF (103.59 m2)

<u>FLFV '3'</u>
833 SF 1069 SF
1902 SF
(176.70 m2)
XX SF
XX SF
+XX SF
+XX SF
1902 SF
(176.70 m2)
833 SF
273 SF
96 SF
1202 SF
(111.67 m2)
1106 SF
(102.75 m2)

OCT 0 4 2017

## HIGHGROVE COMPLIANCE PACKAGE 'A1'

8				9	-	,	
7				8	-	·	<u>.</u>
6				7			
5				6	REVISED. ISSUED FOR PERMIT.	SEP. 28/17	7 GW
4				5	ISSUED FOR PRICING.	AUG. 23/17	7 GW
3	,			4	REVISED AS PER CLIENT COMMENTS.	JUN 21/17	₩.
2				3	CHANGED JOIST DEPTH/ FLOOR HEIGHTS	JUN 12/17	GW:
11			1	2	REVISED PER CLIENT COMMENTS.	APR. 28/17	7 G₩
0			1.	1	PRELIMINARY REVIEW.	APR. 12/17	7 GW
Ō.	description	date	by	no.	description	date	by

registration information VA3 Design Inc.


NECICA DECICA	Project of RUSS
DESIGN 255 Consumers Rd Suite 120	date APRIL
Toronto ON M2J 1R4 416.630.2255 f 416.630.4782	drawn by WT
va3design.com	GREE - 1


<b>*Green</b>	park.
project name RUSSELL GARDENS PH.2	WATERDOWN, ON.
date	OCNEDAL NO


HIGHGROVE 3


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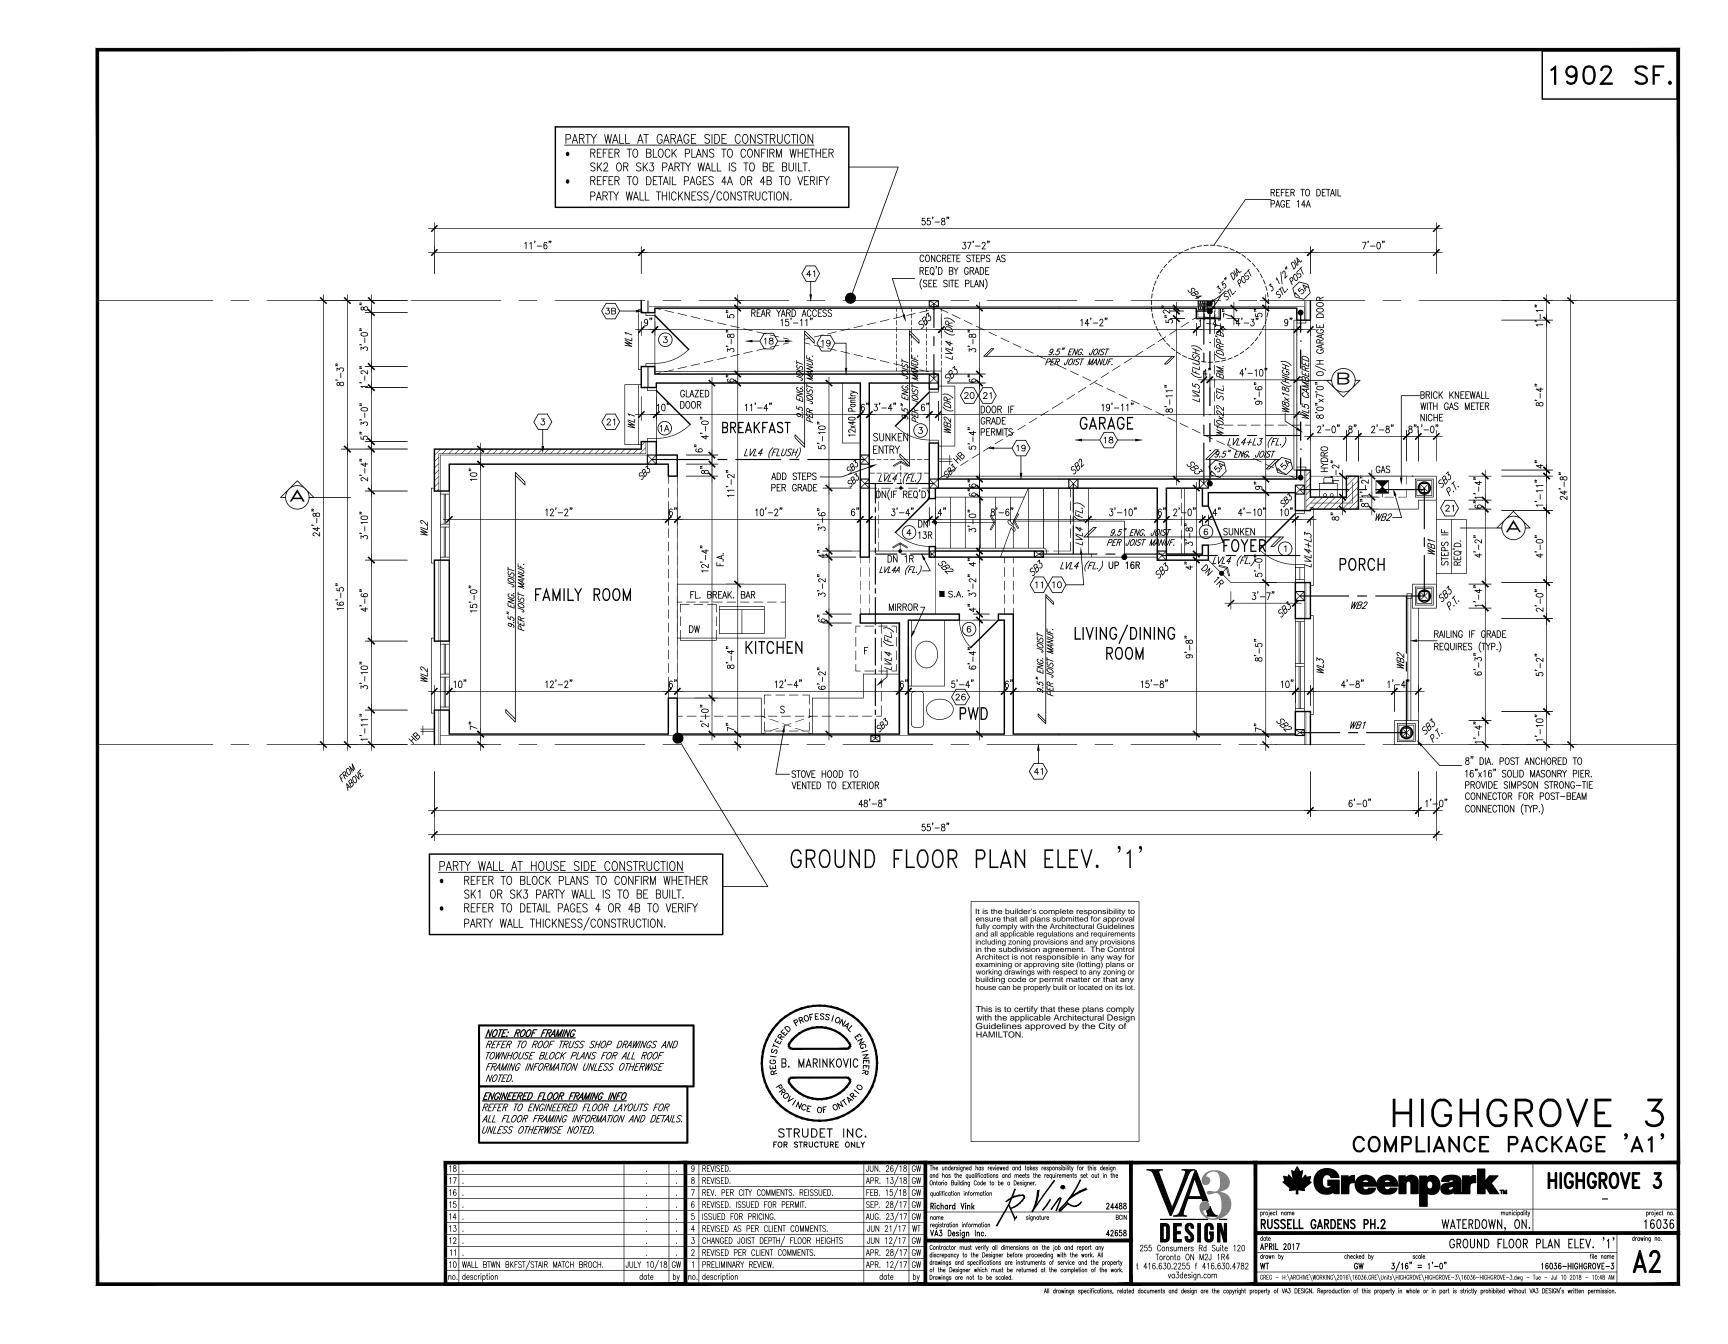
rte PRIL 2017			GENERAL NOTES & CHARTS	
rawn by /T	checked by GW	3/16" = 1'-0"	file nome 16036-HIGHGROVE-3	
REC - HENARCHMENWOR	KNC\3016\16036.08E\U	HEEV HIGHOROVE VENCHOROVE - 3 \	16036-NISHGROVE-3.deg - Thu - Sep 28 2017 - 5:23 PM	




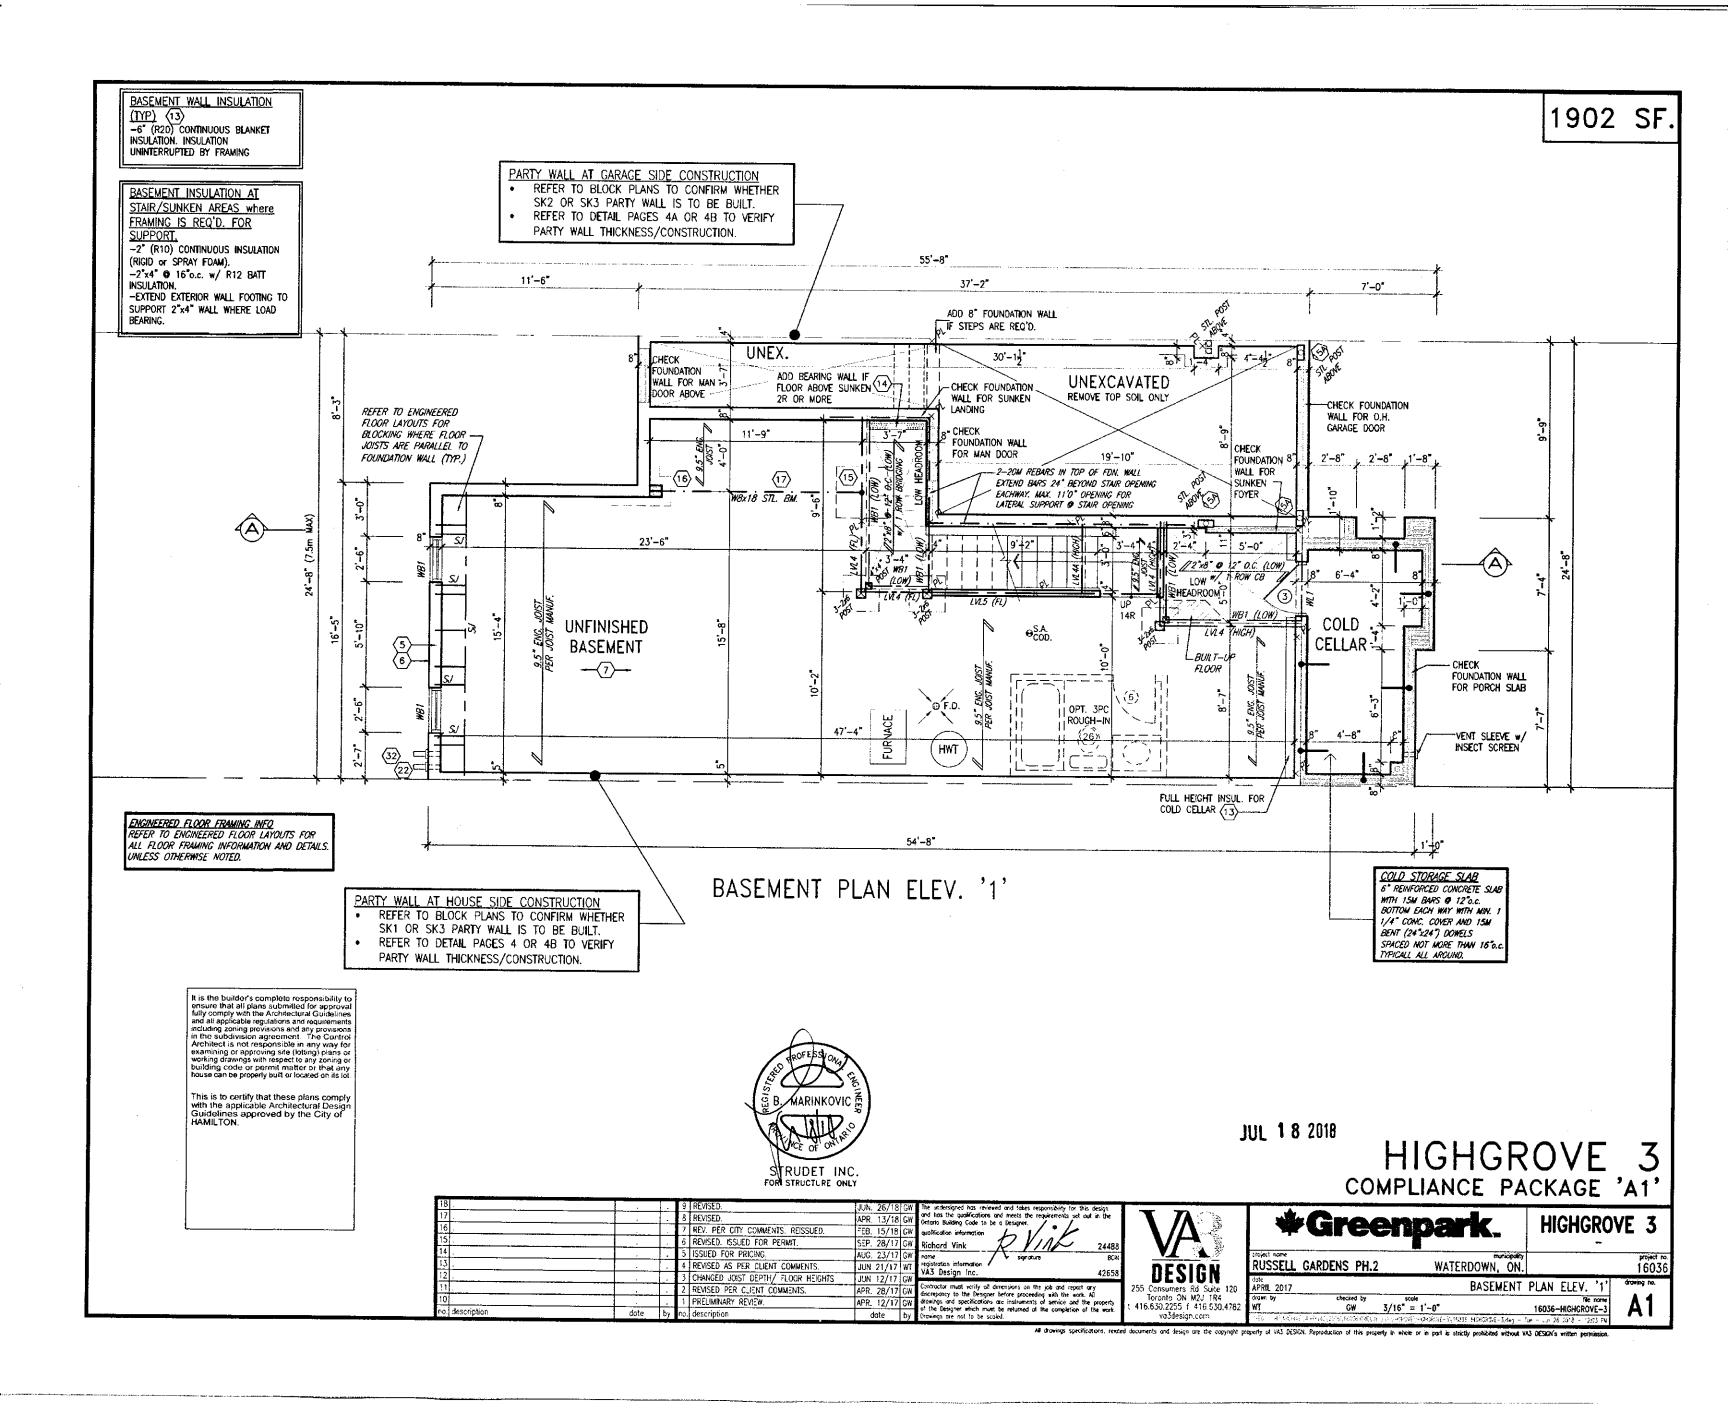


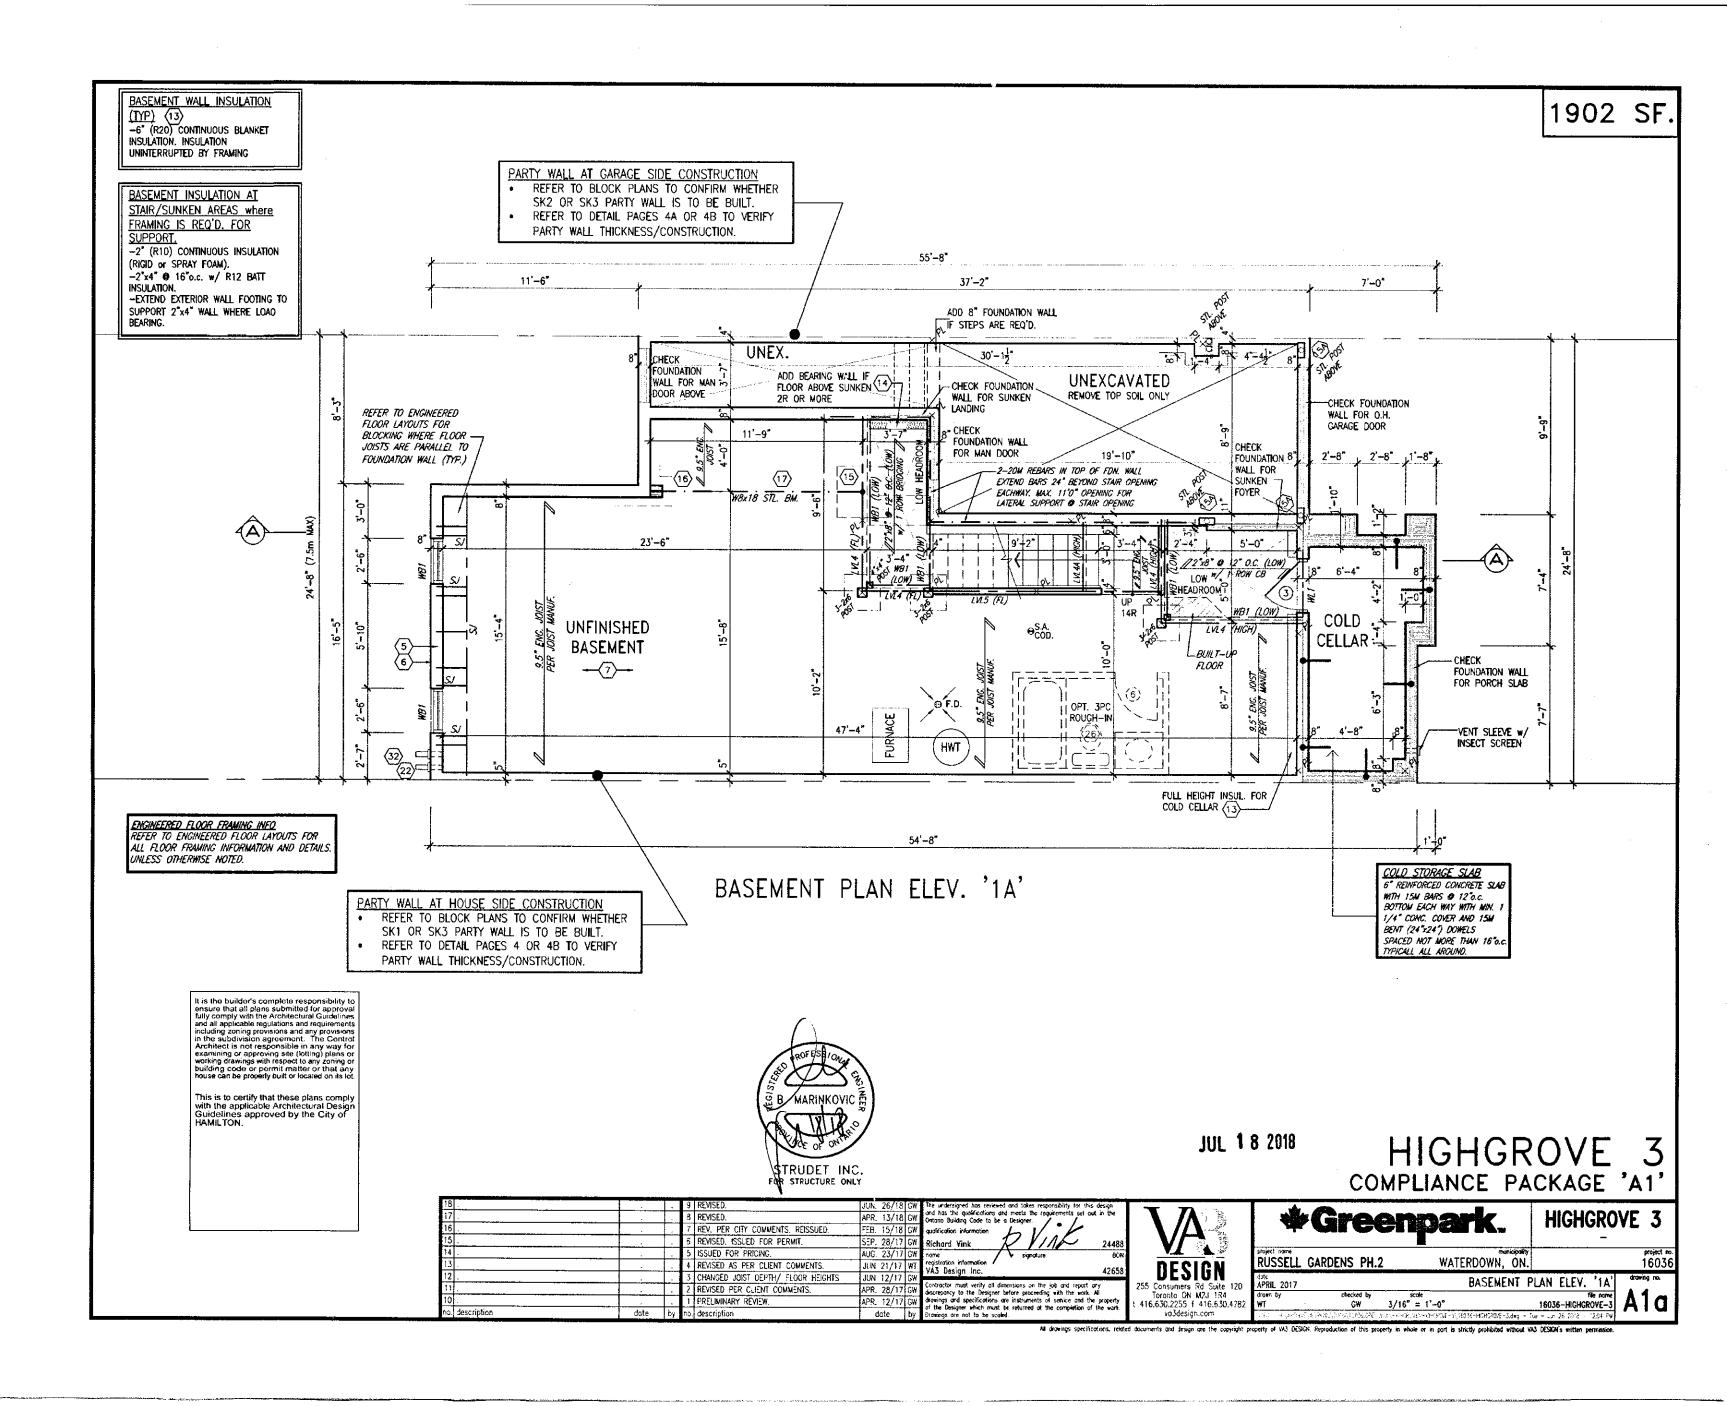


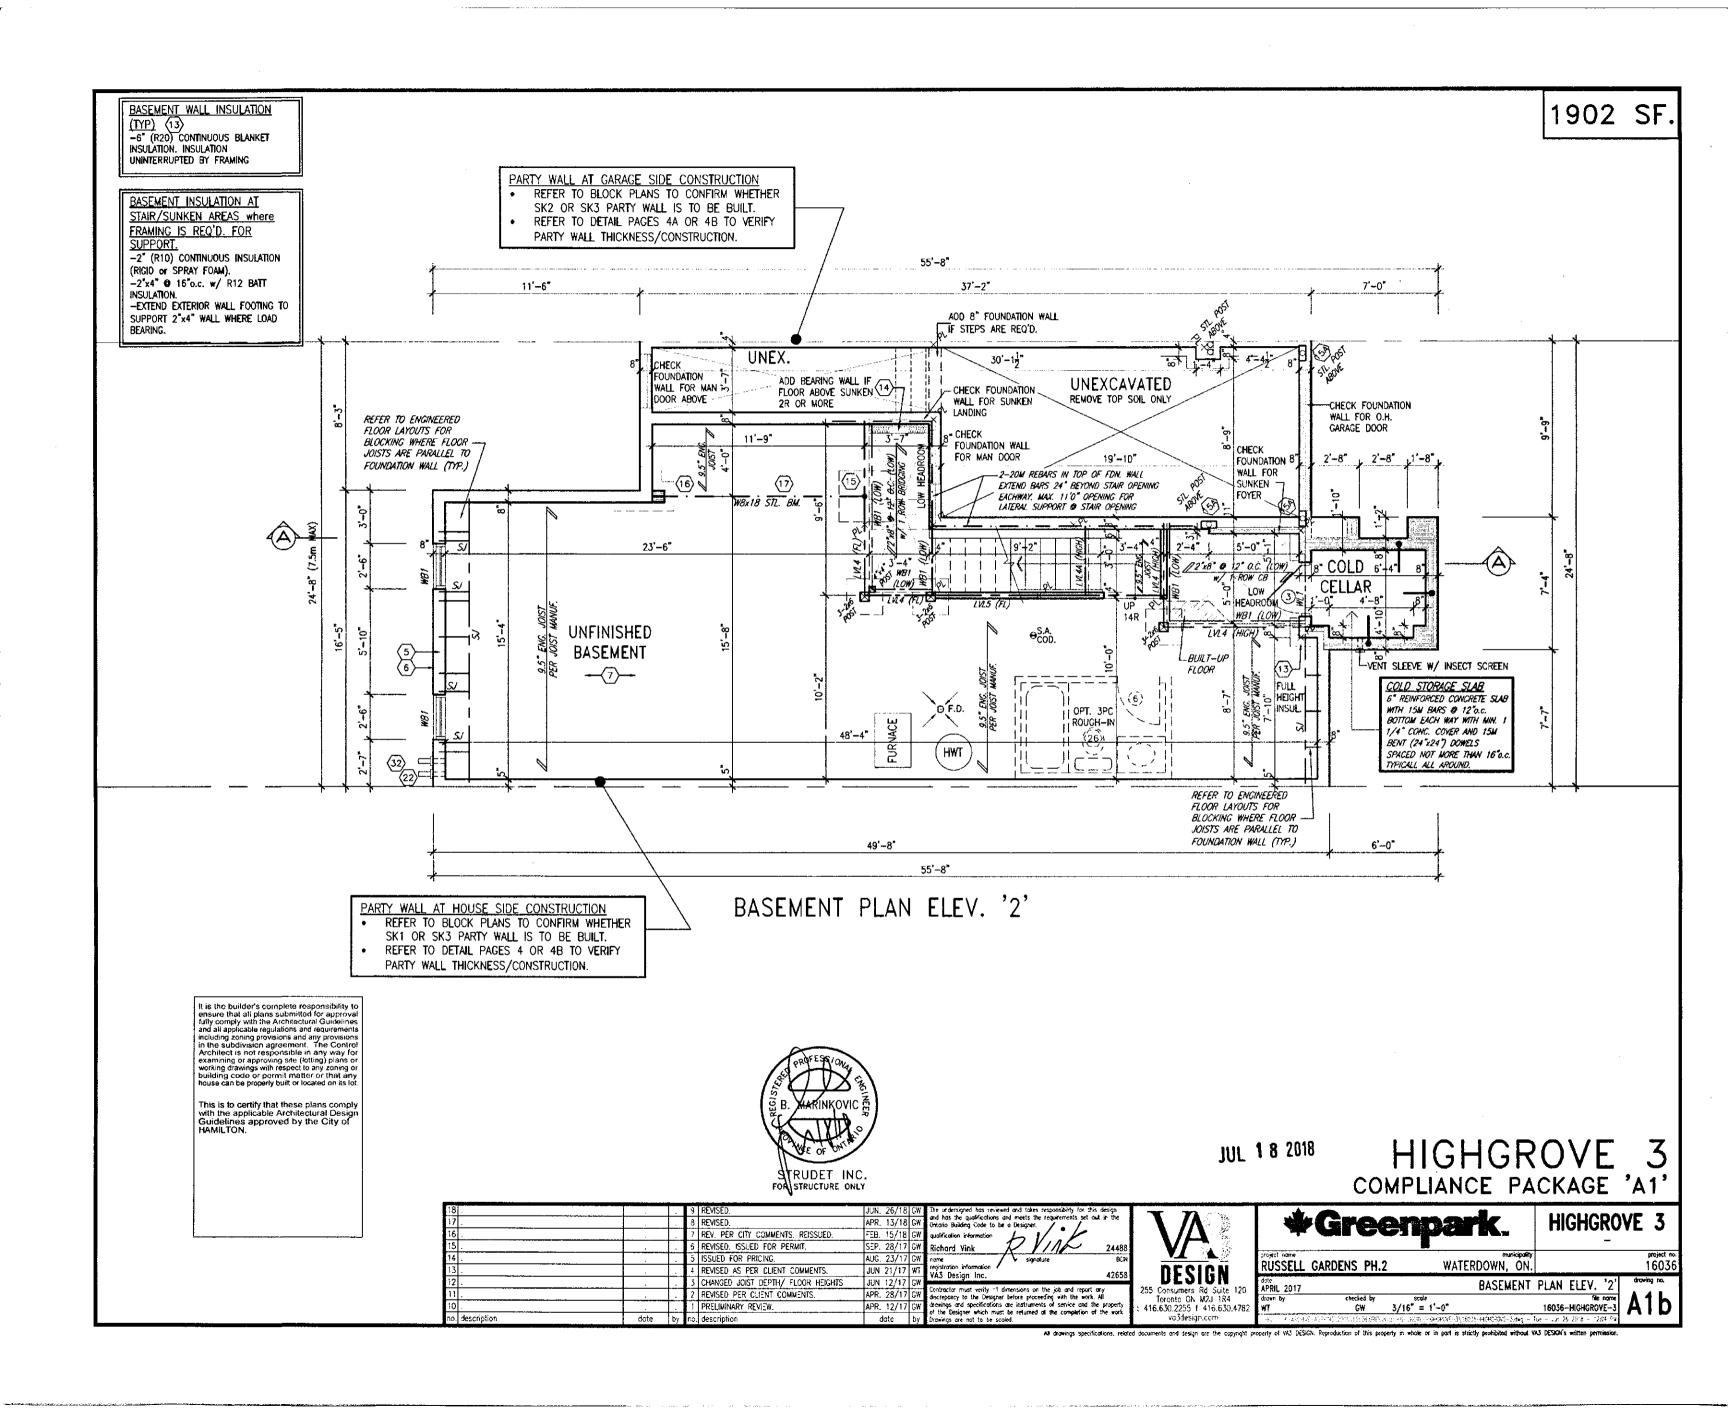


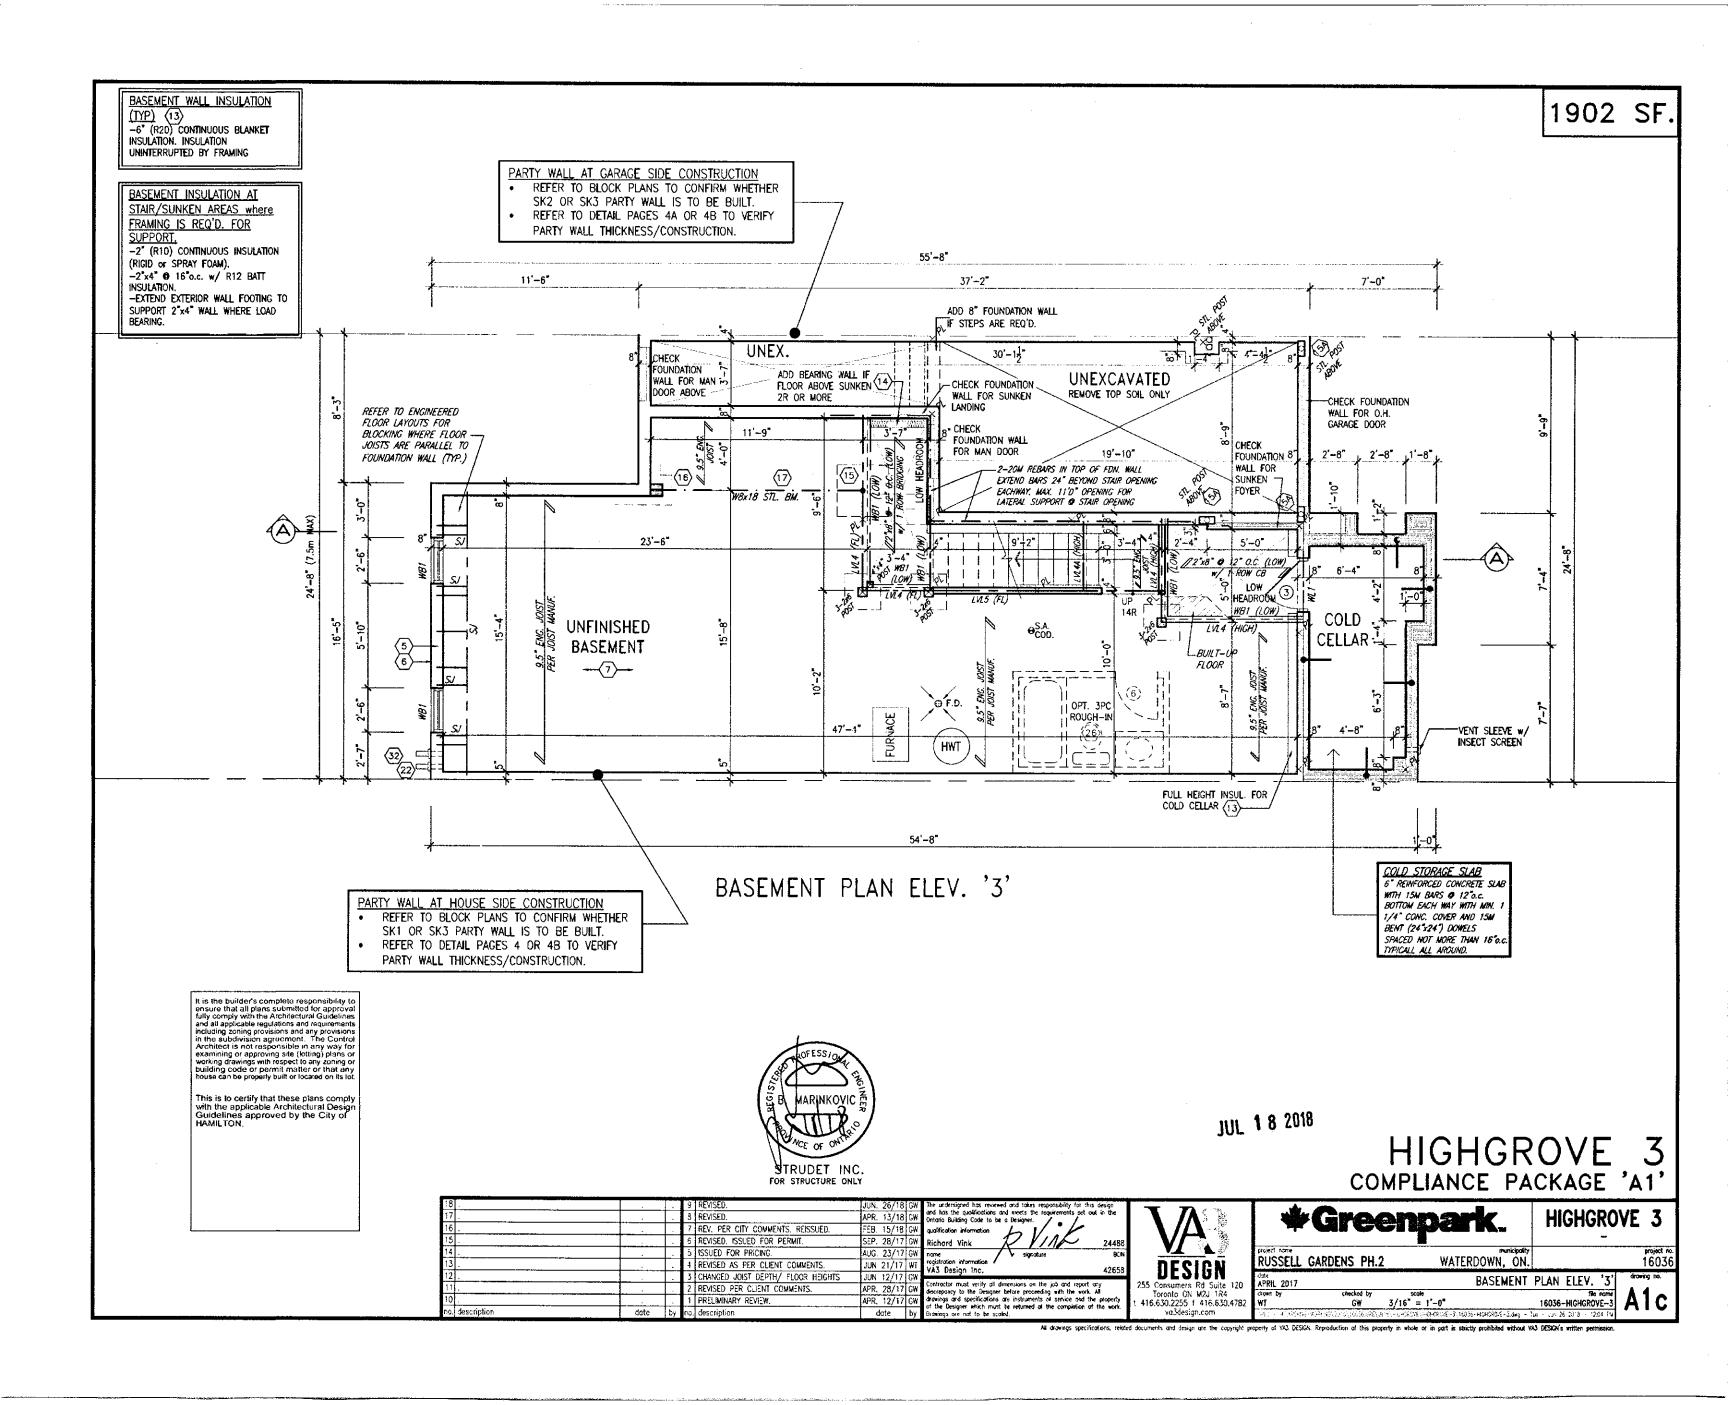


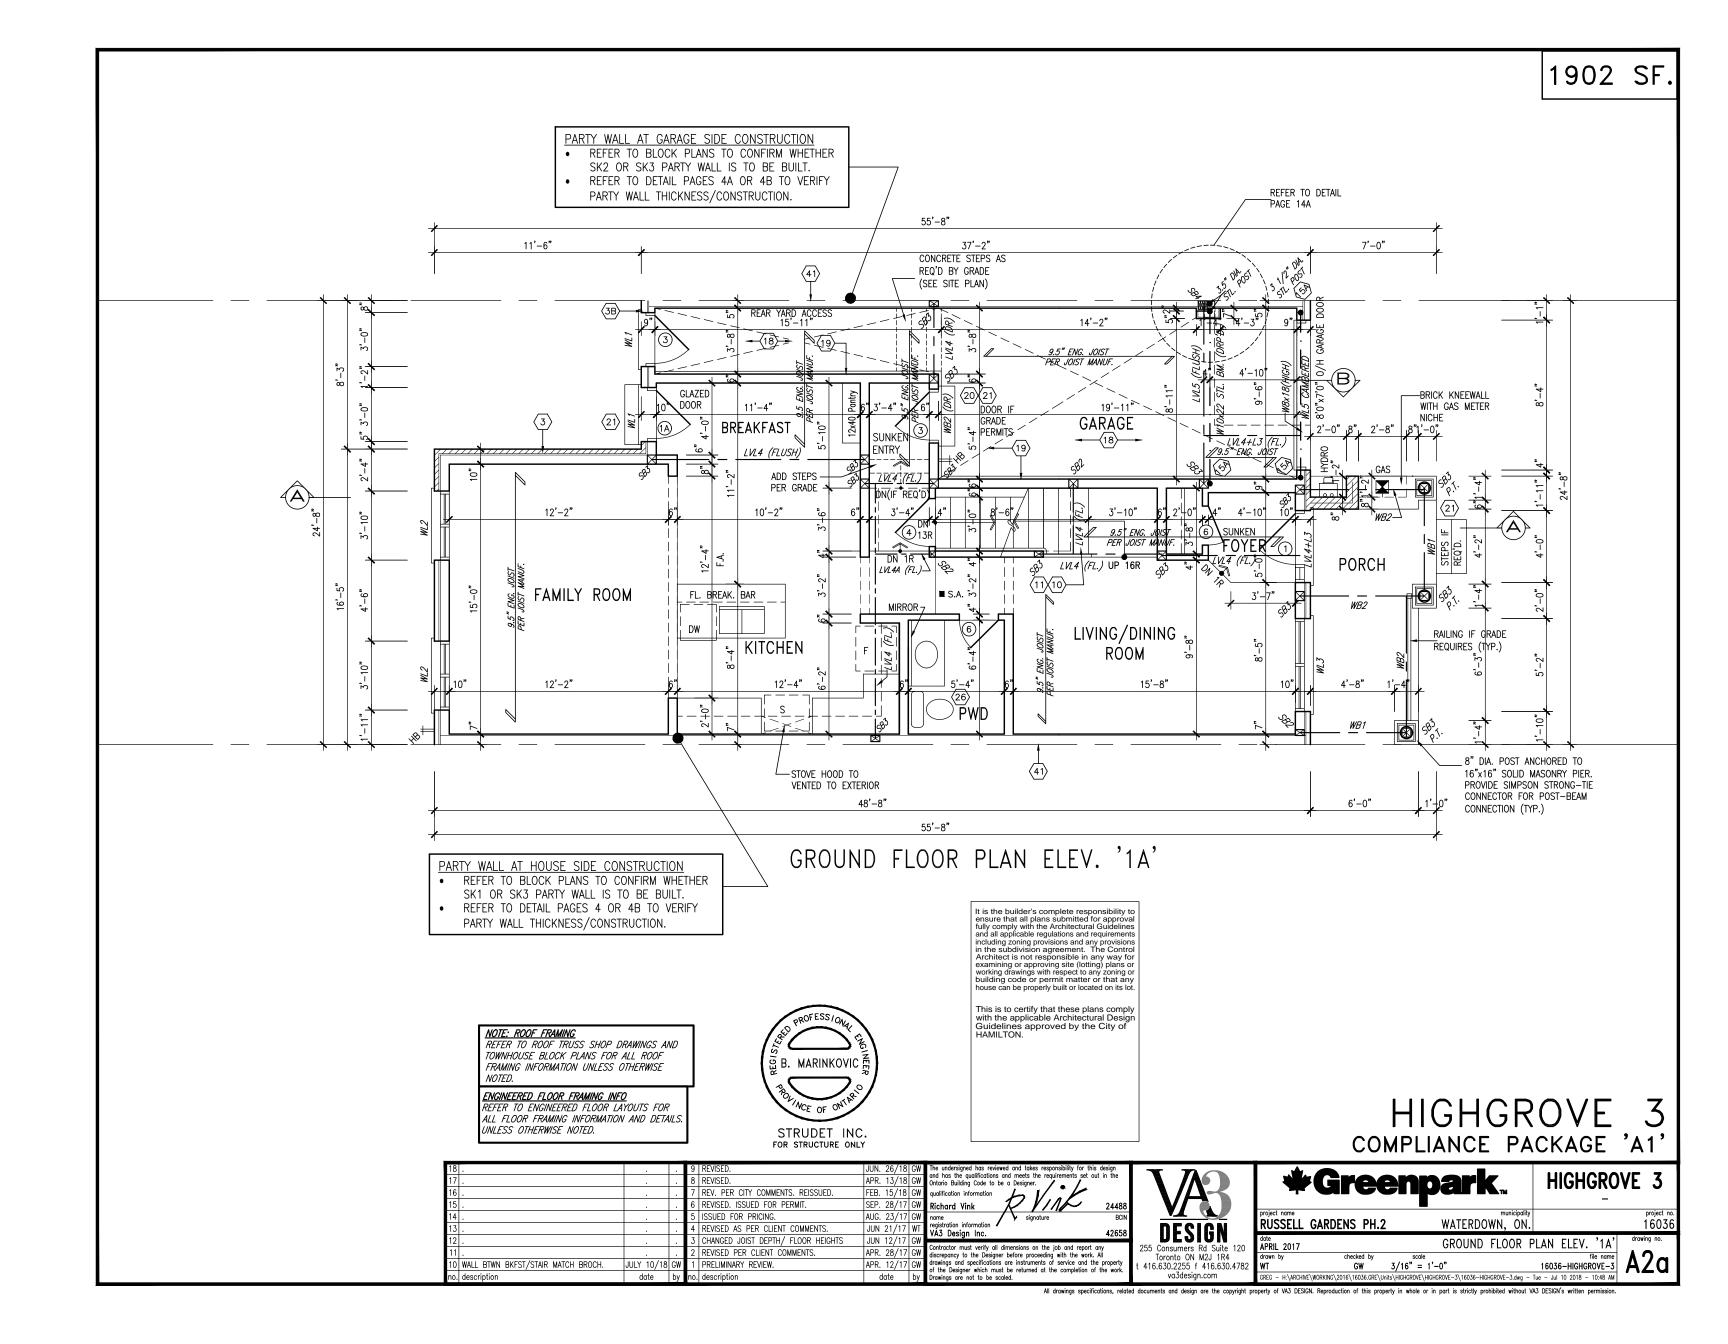


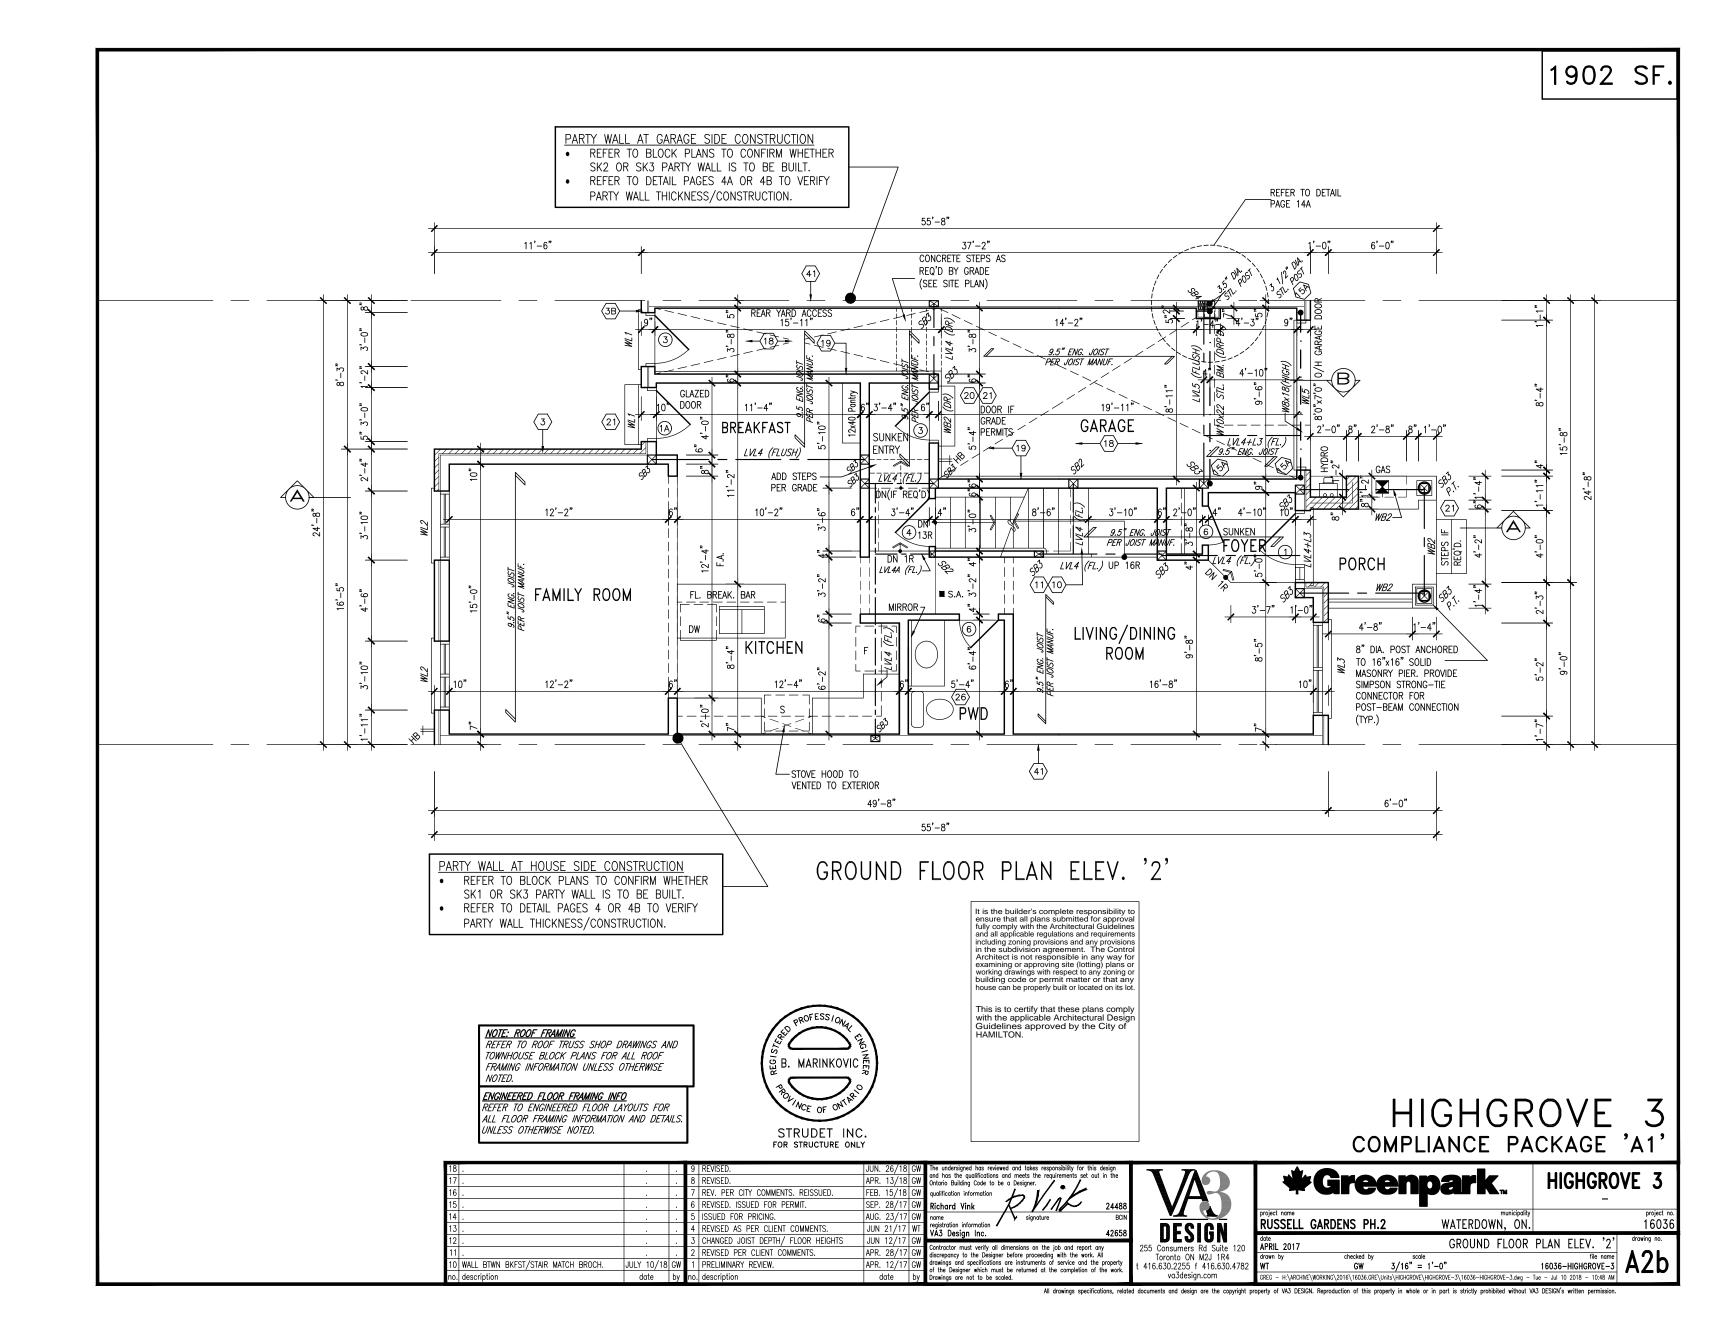


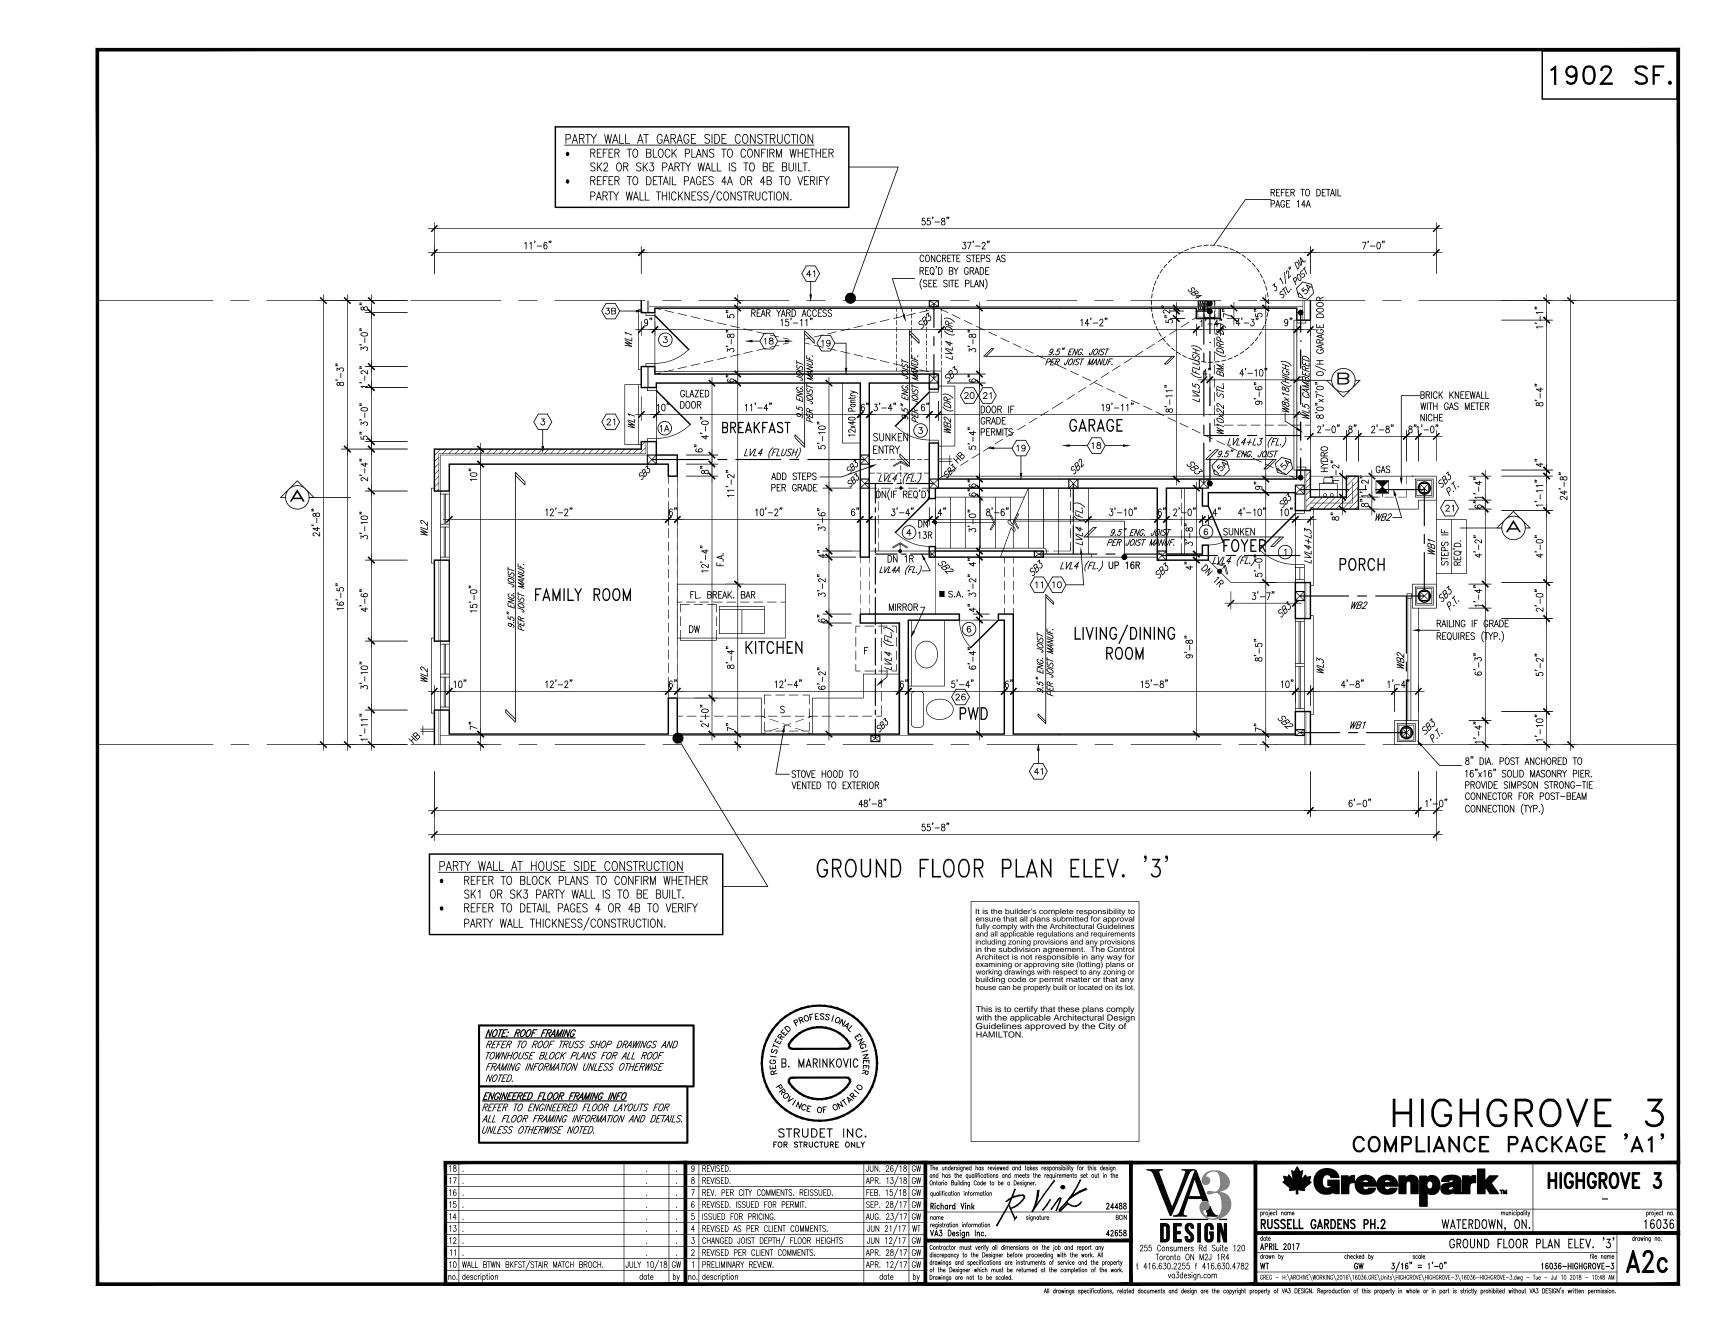


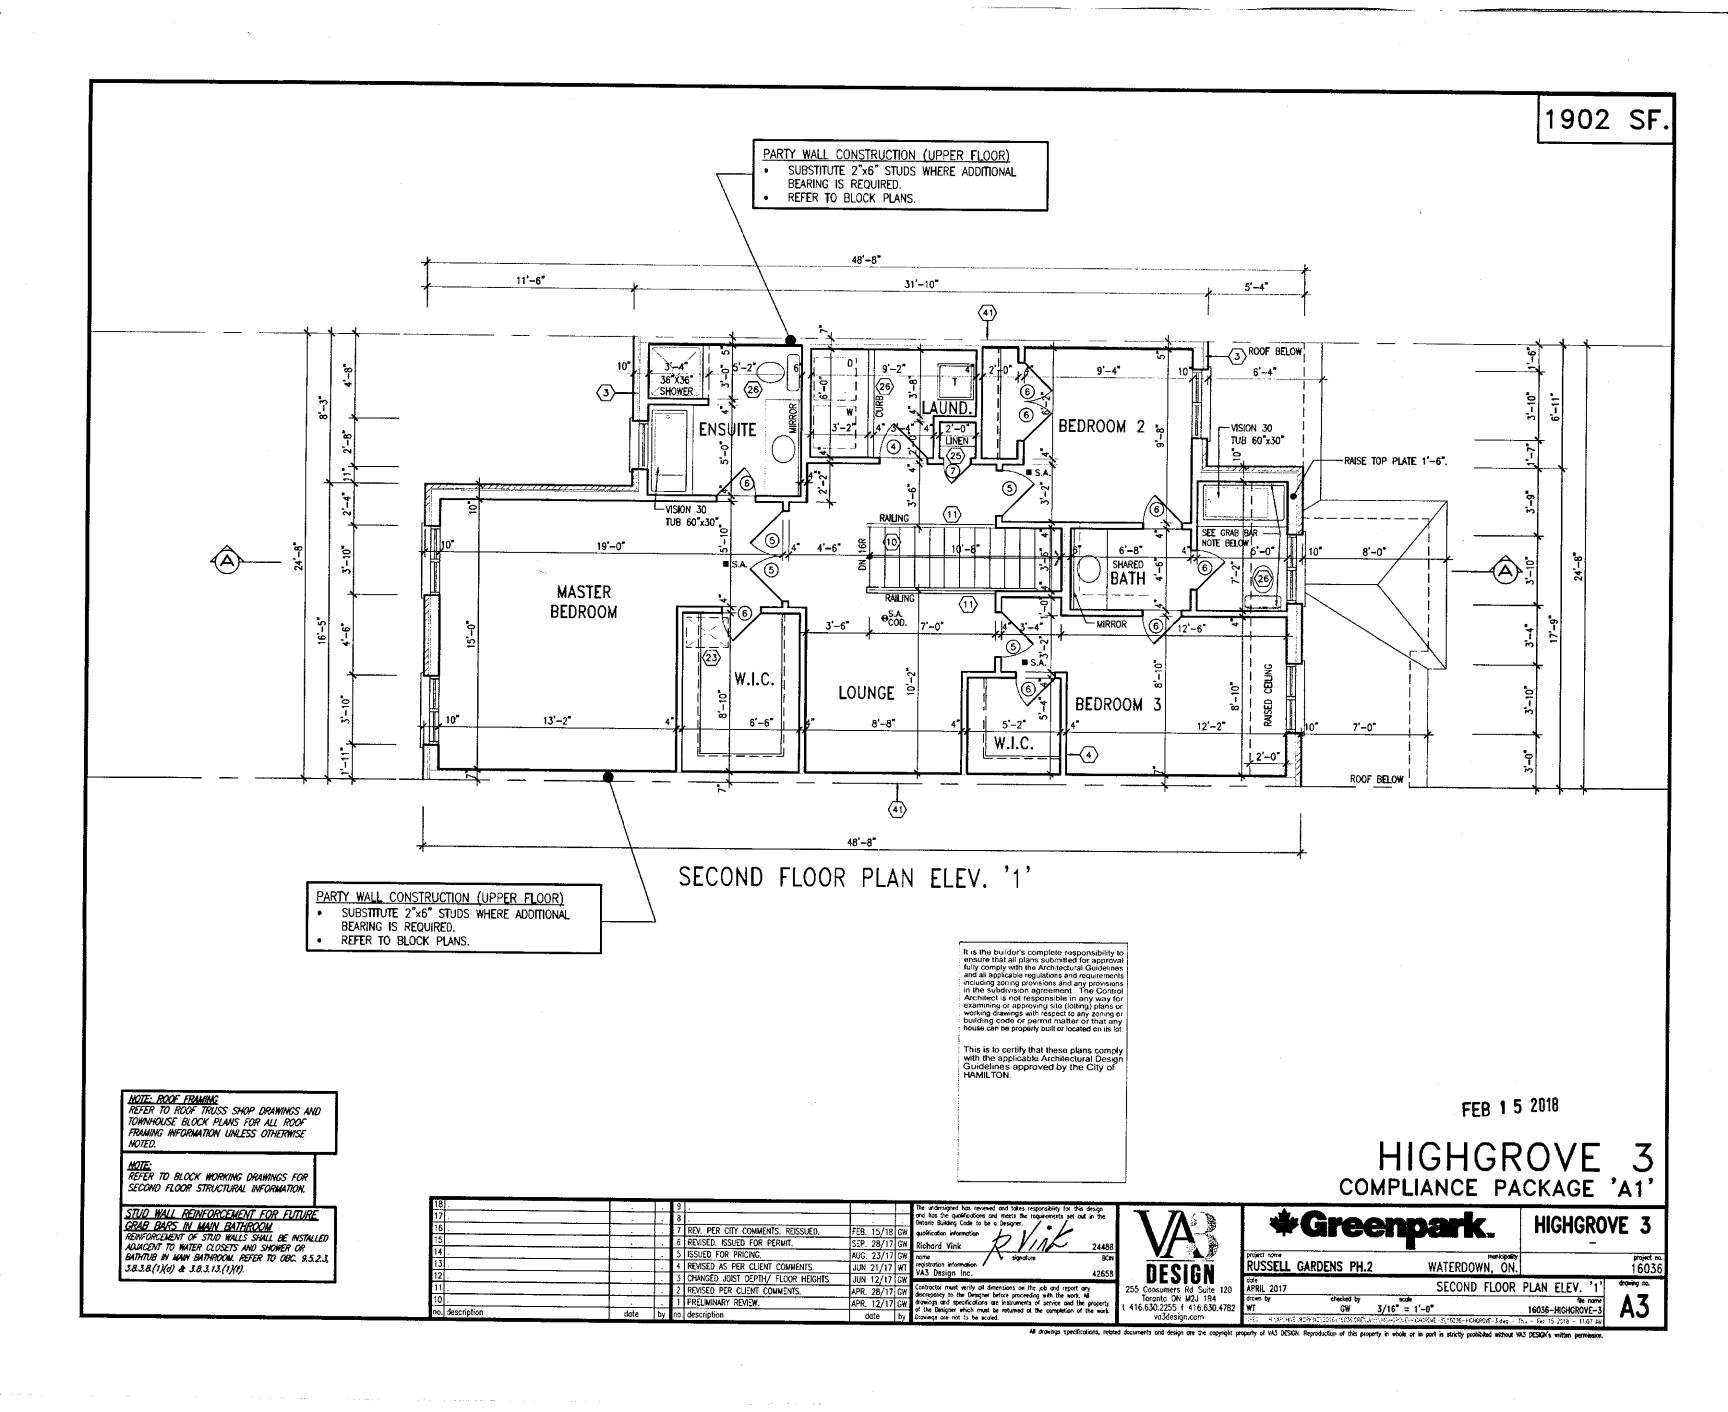


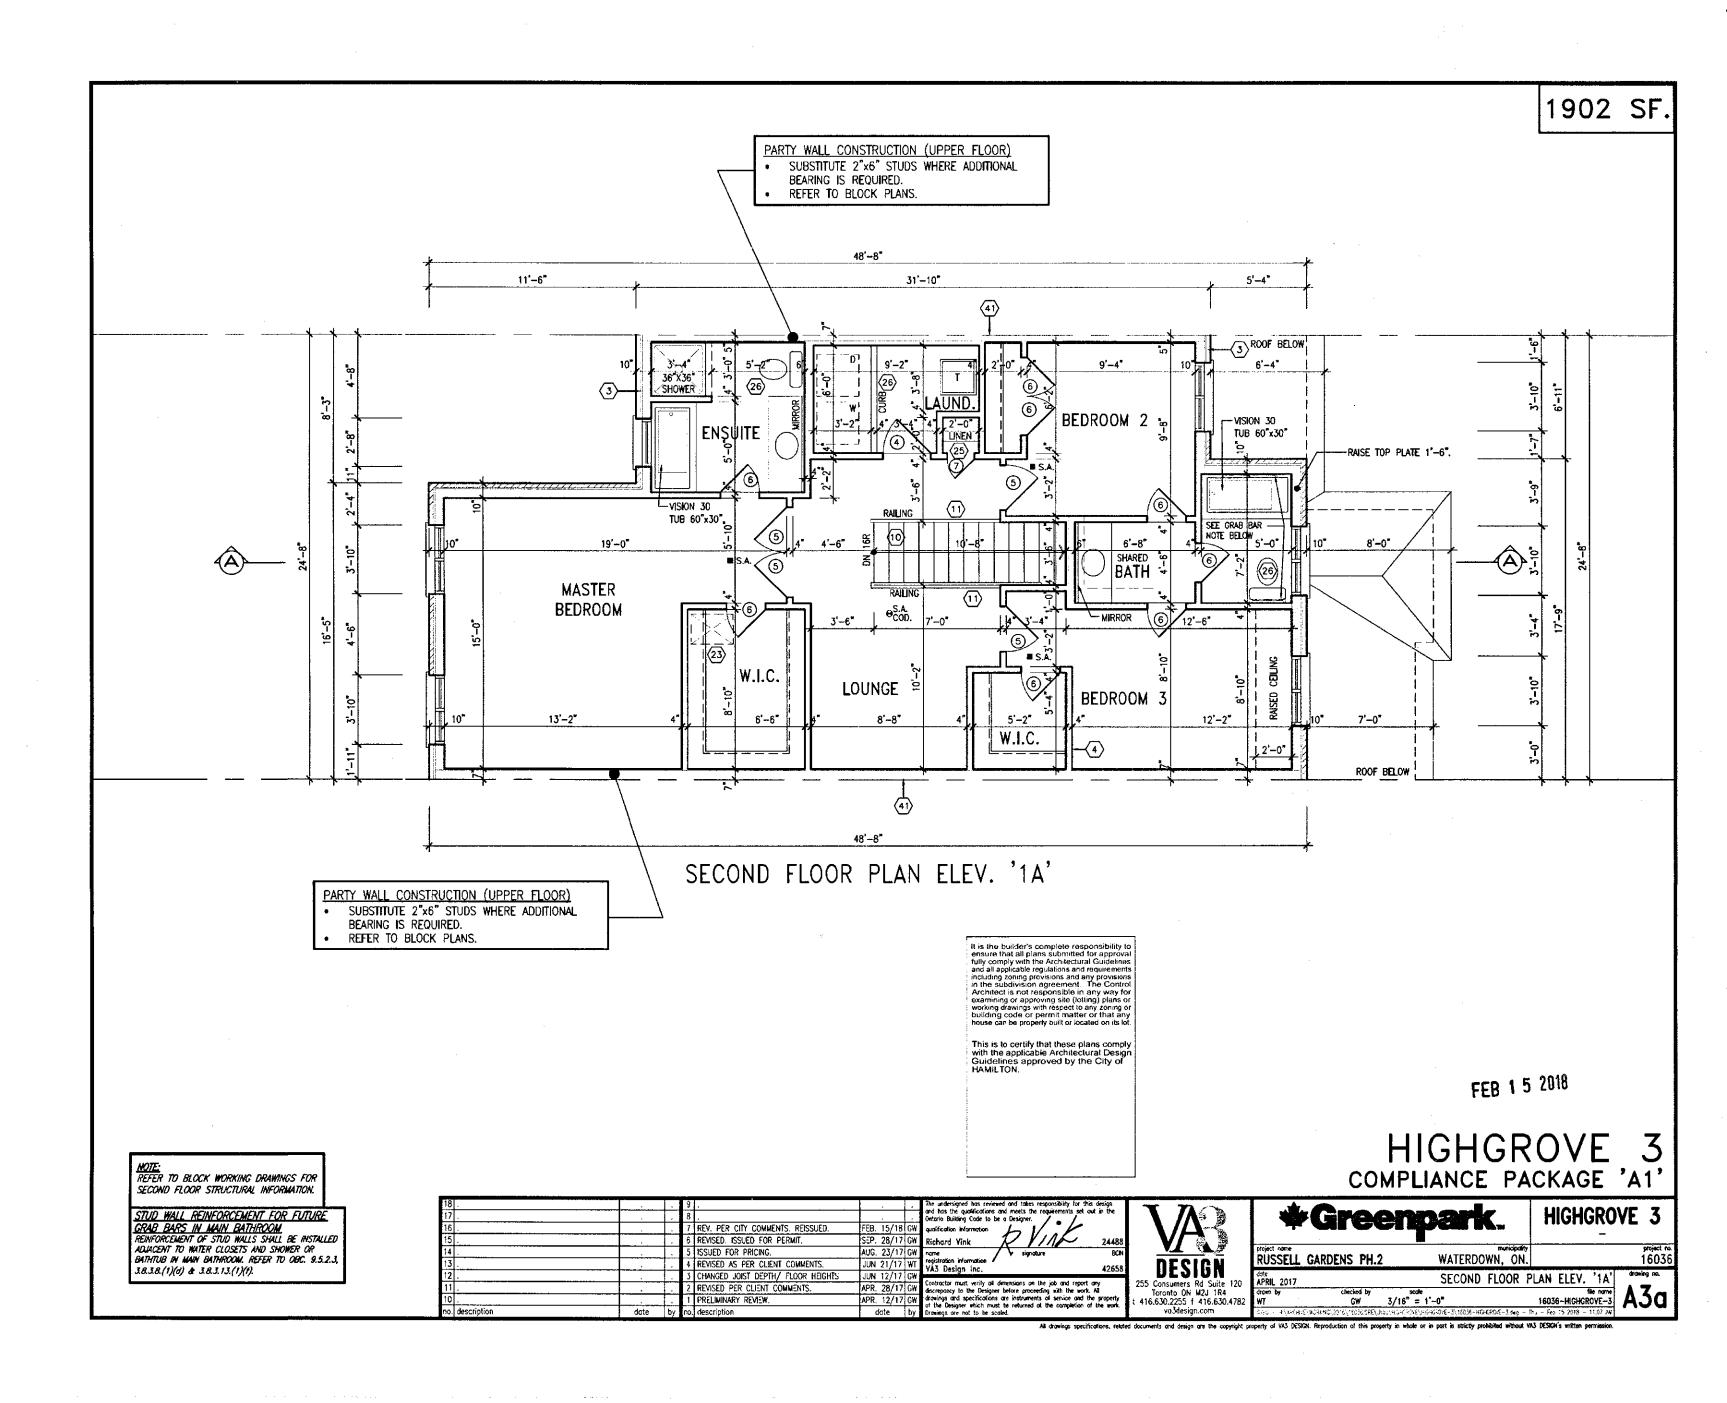


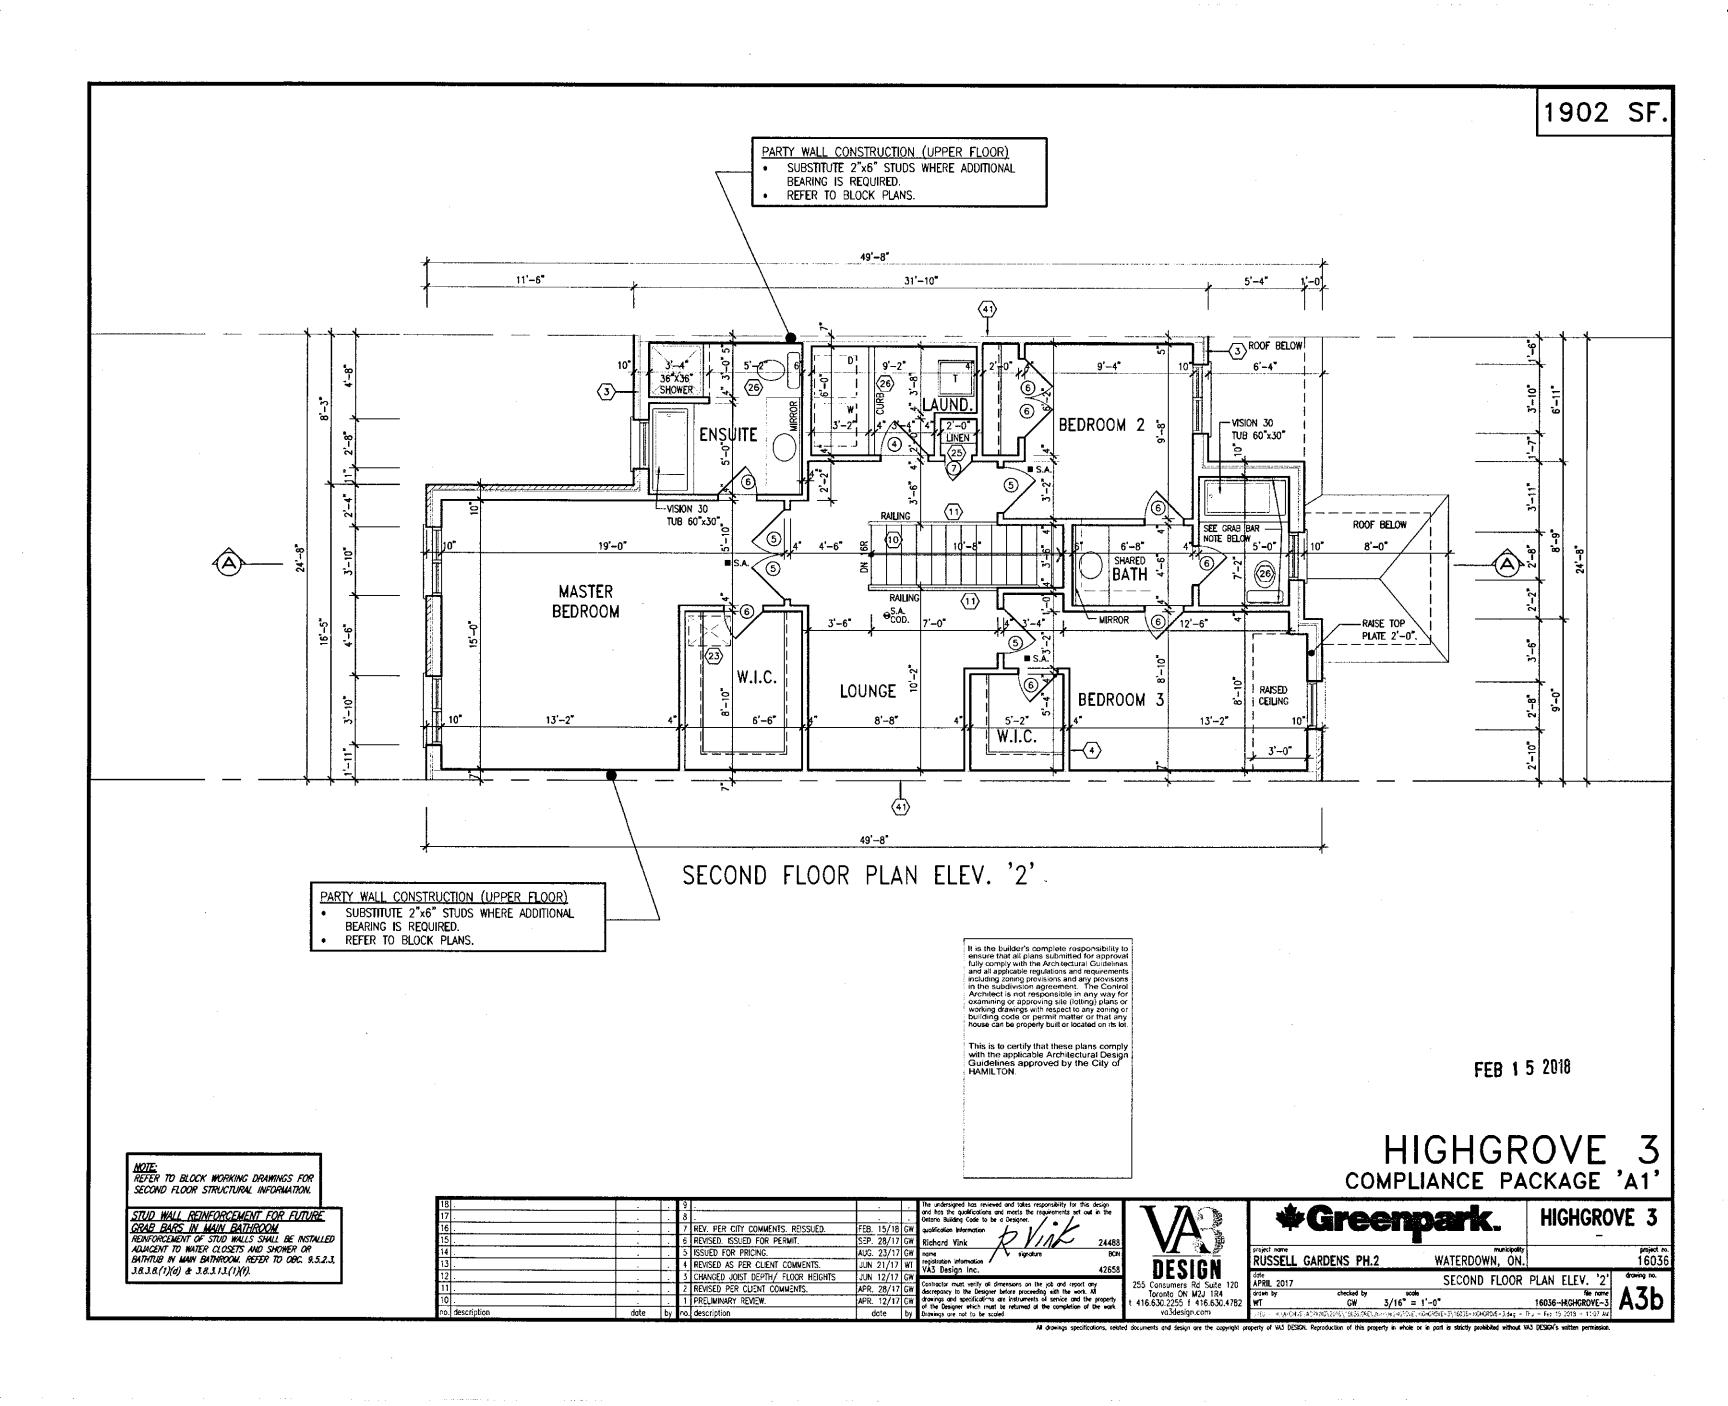


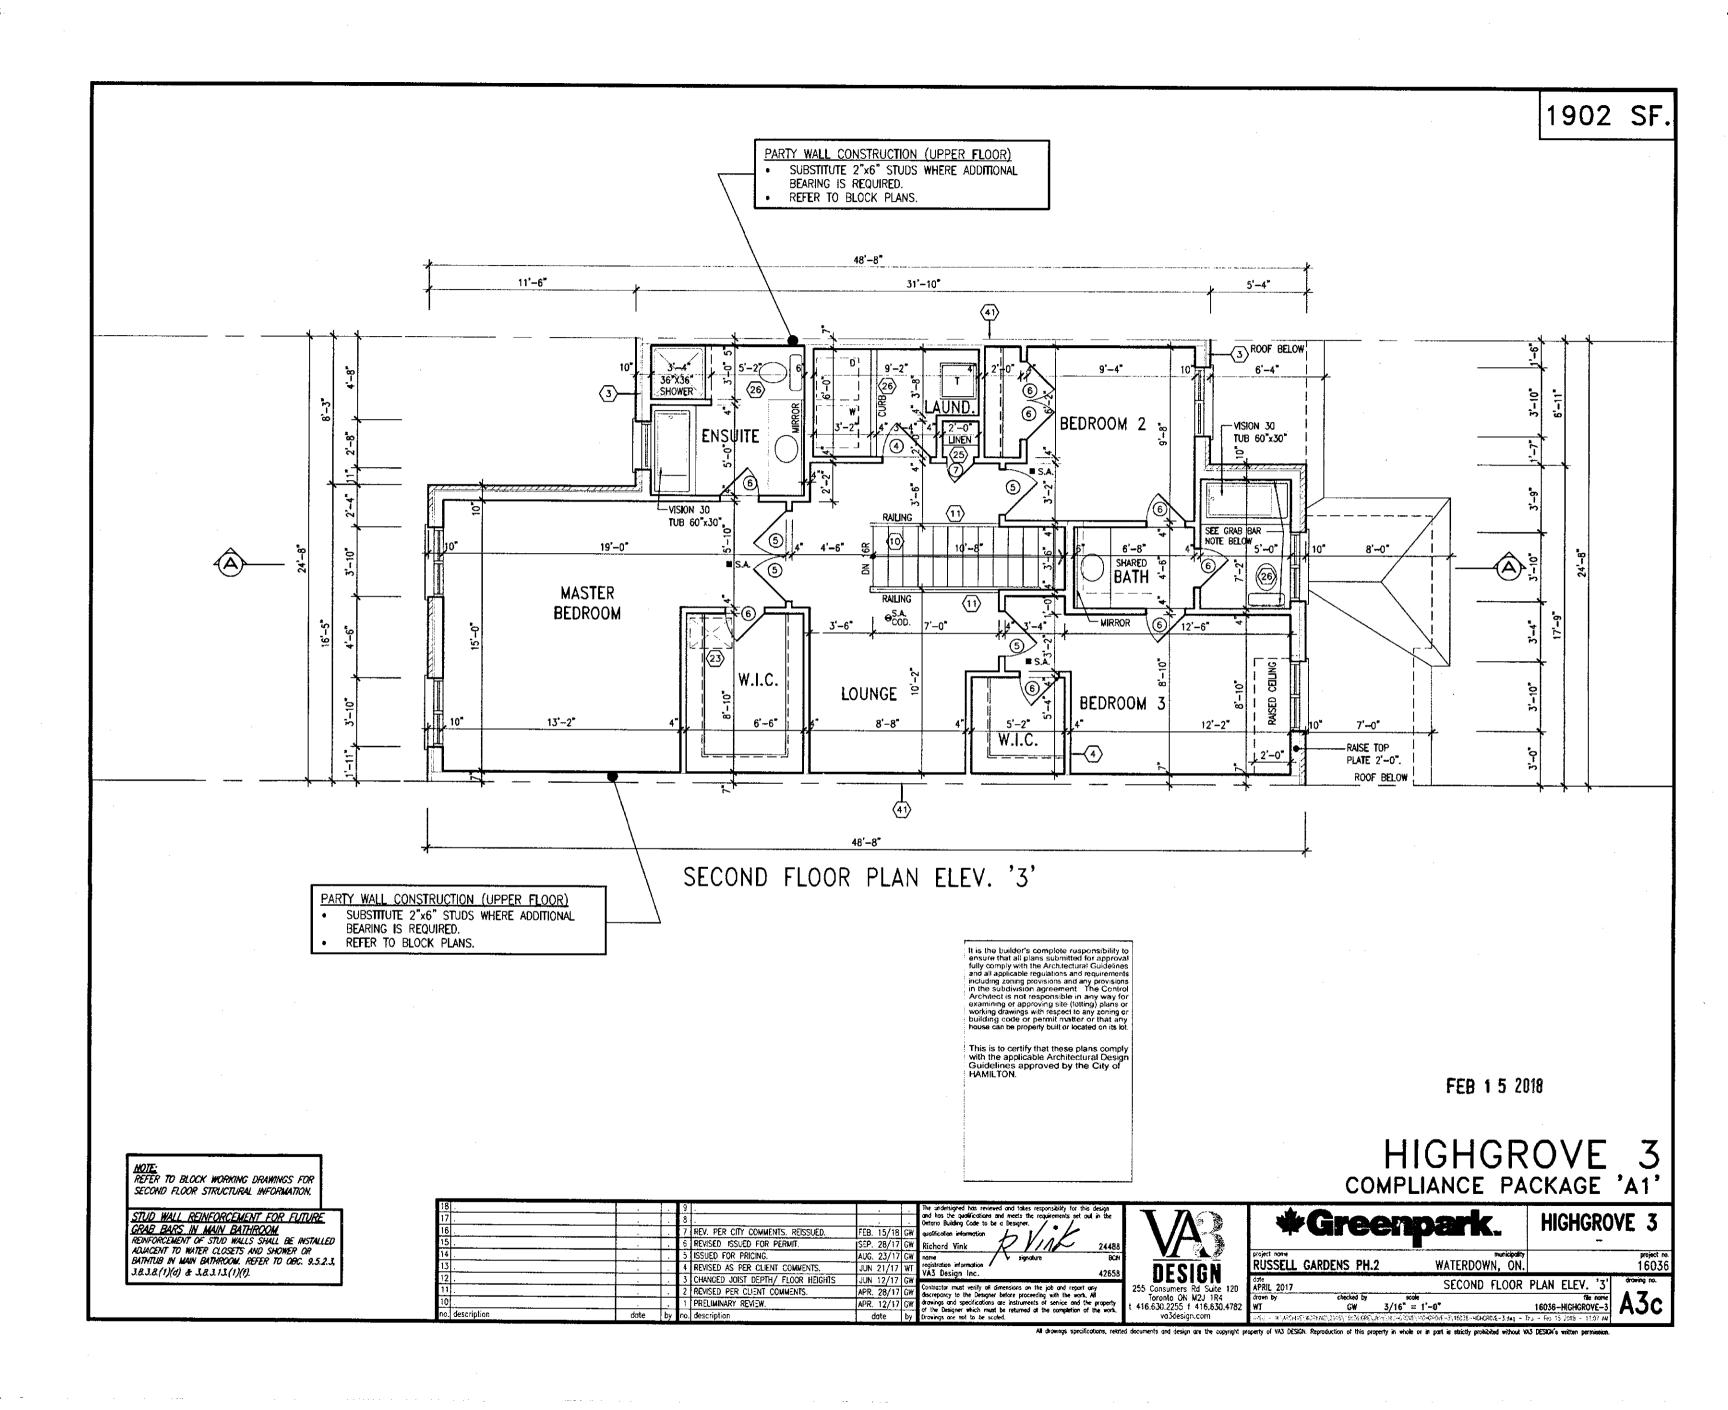


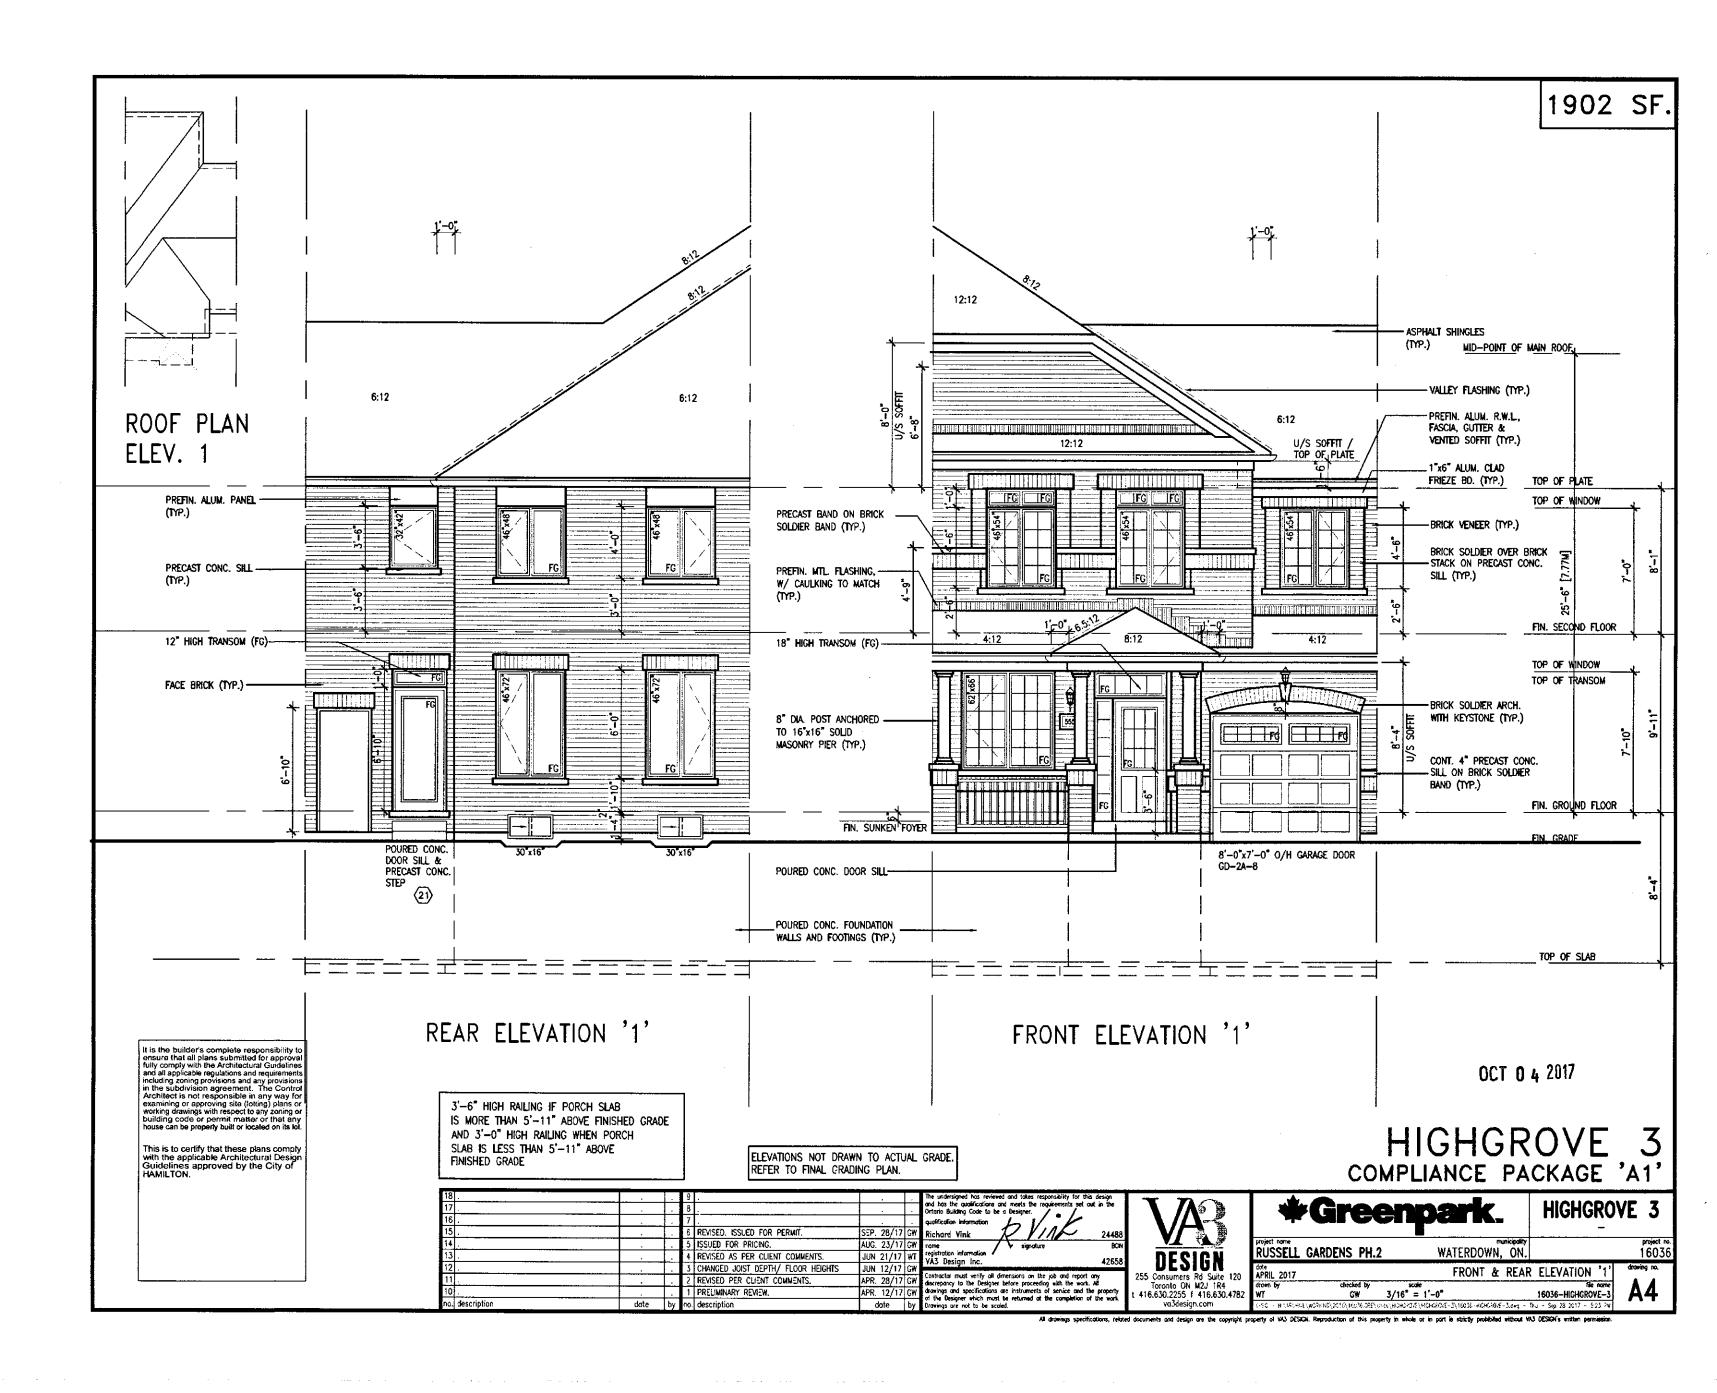


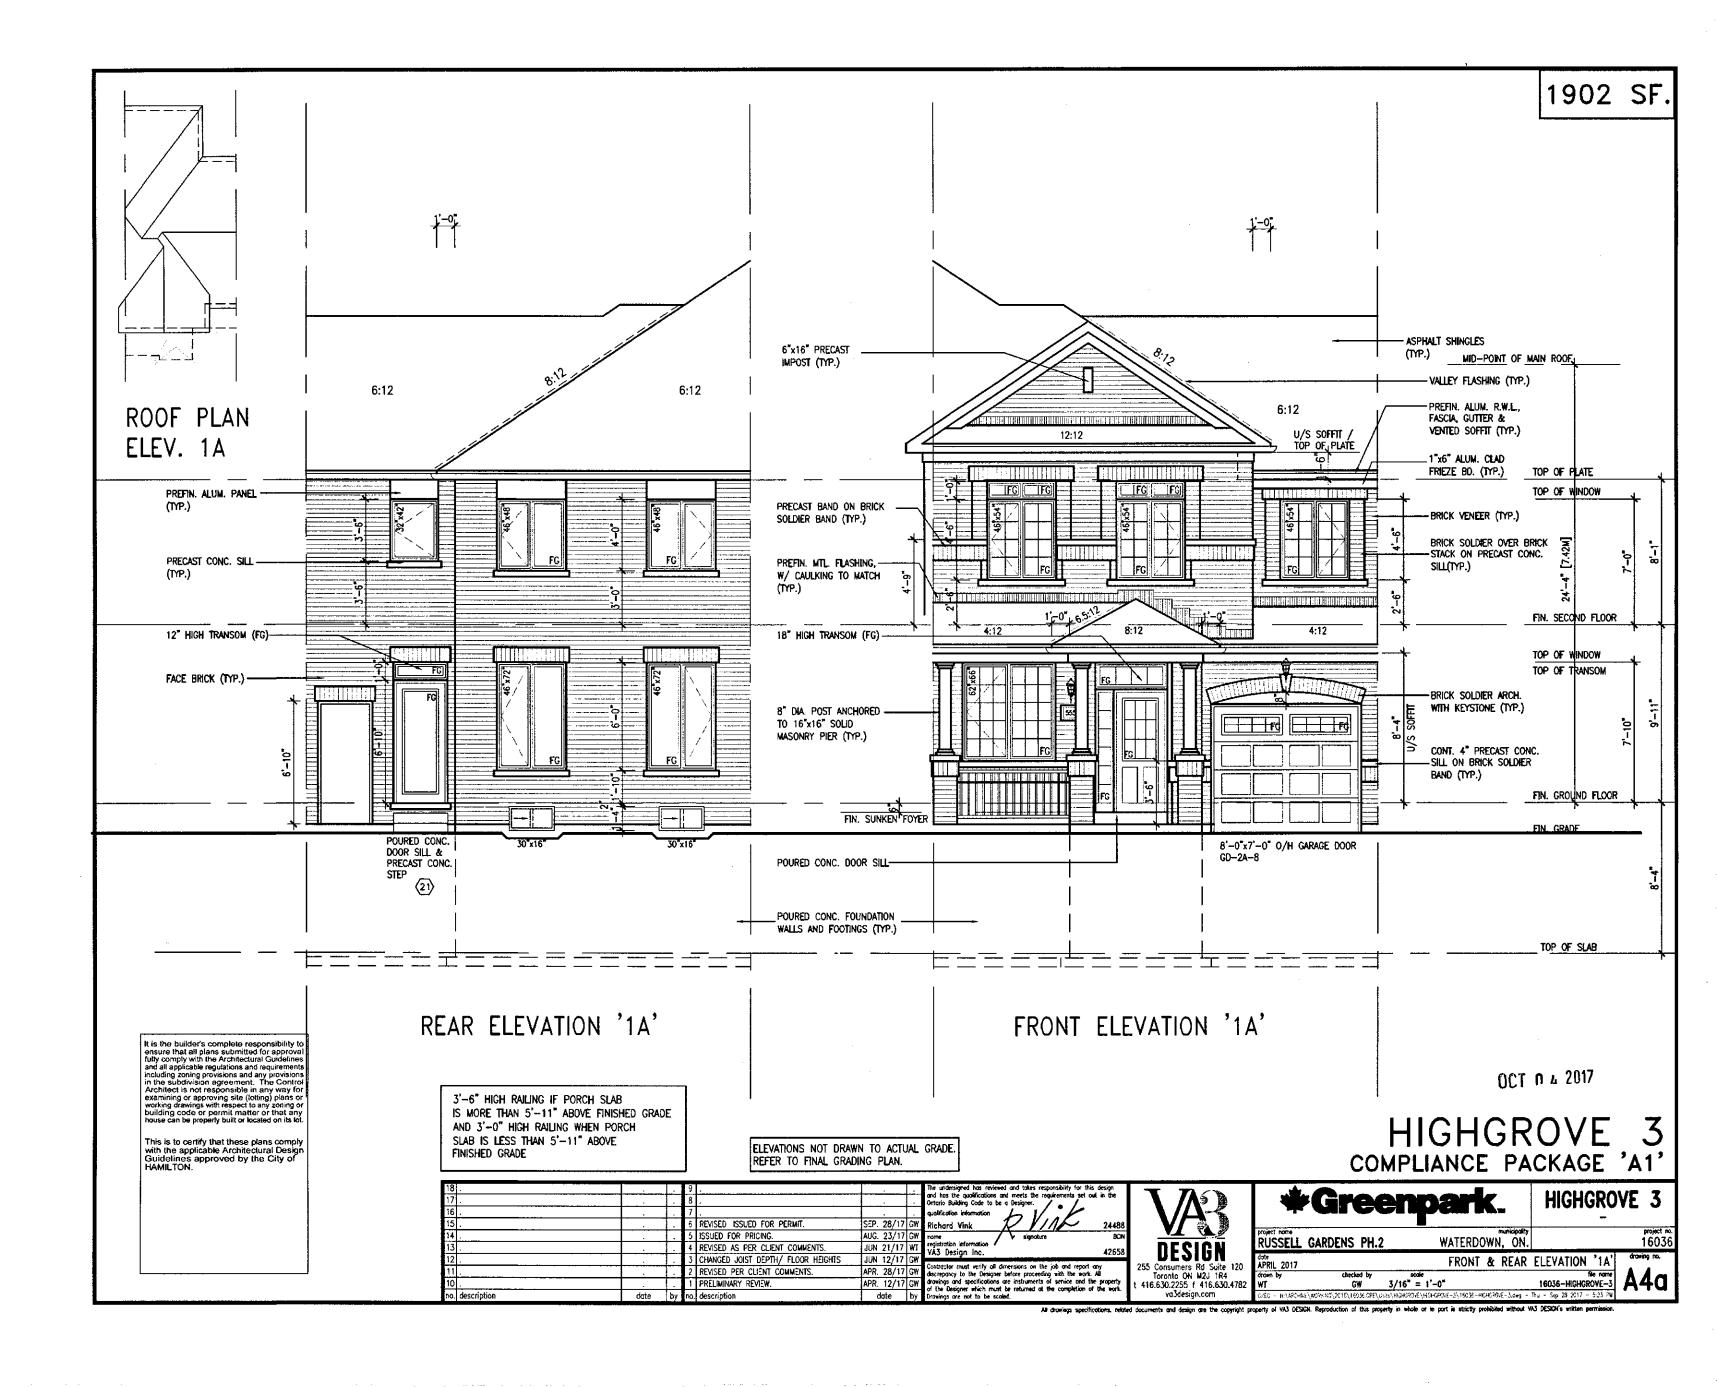


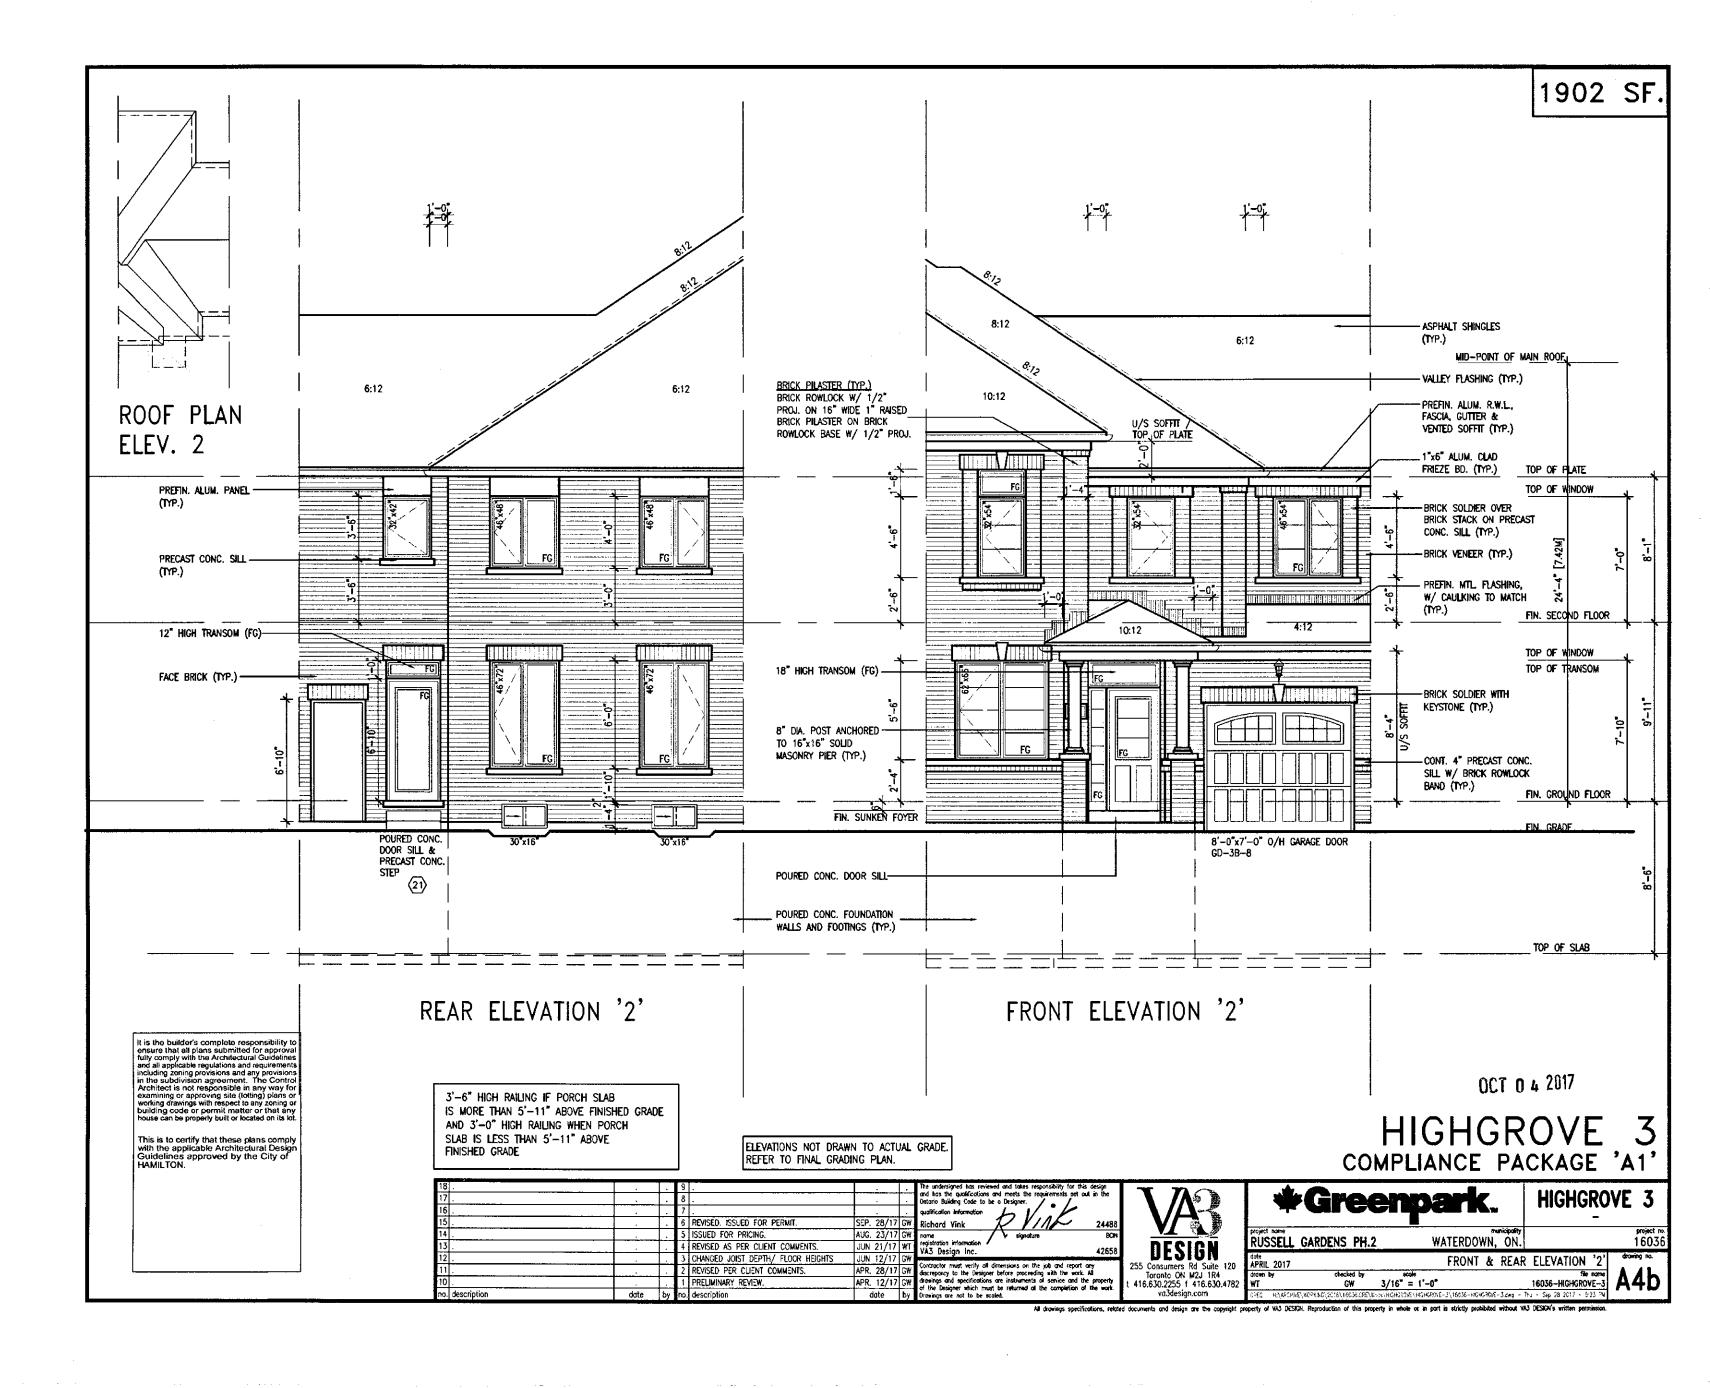


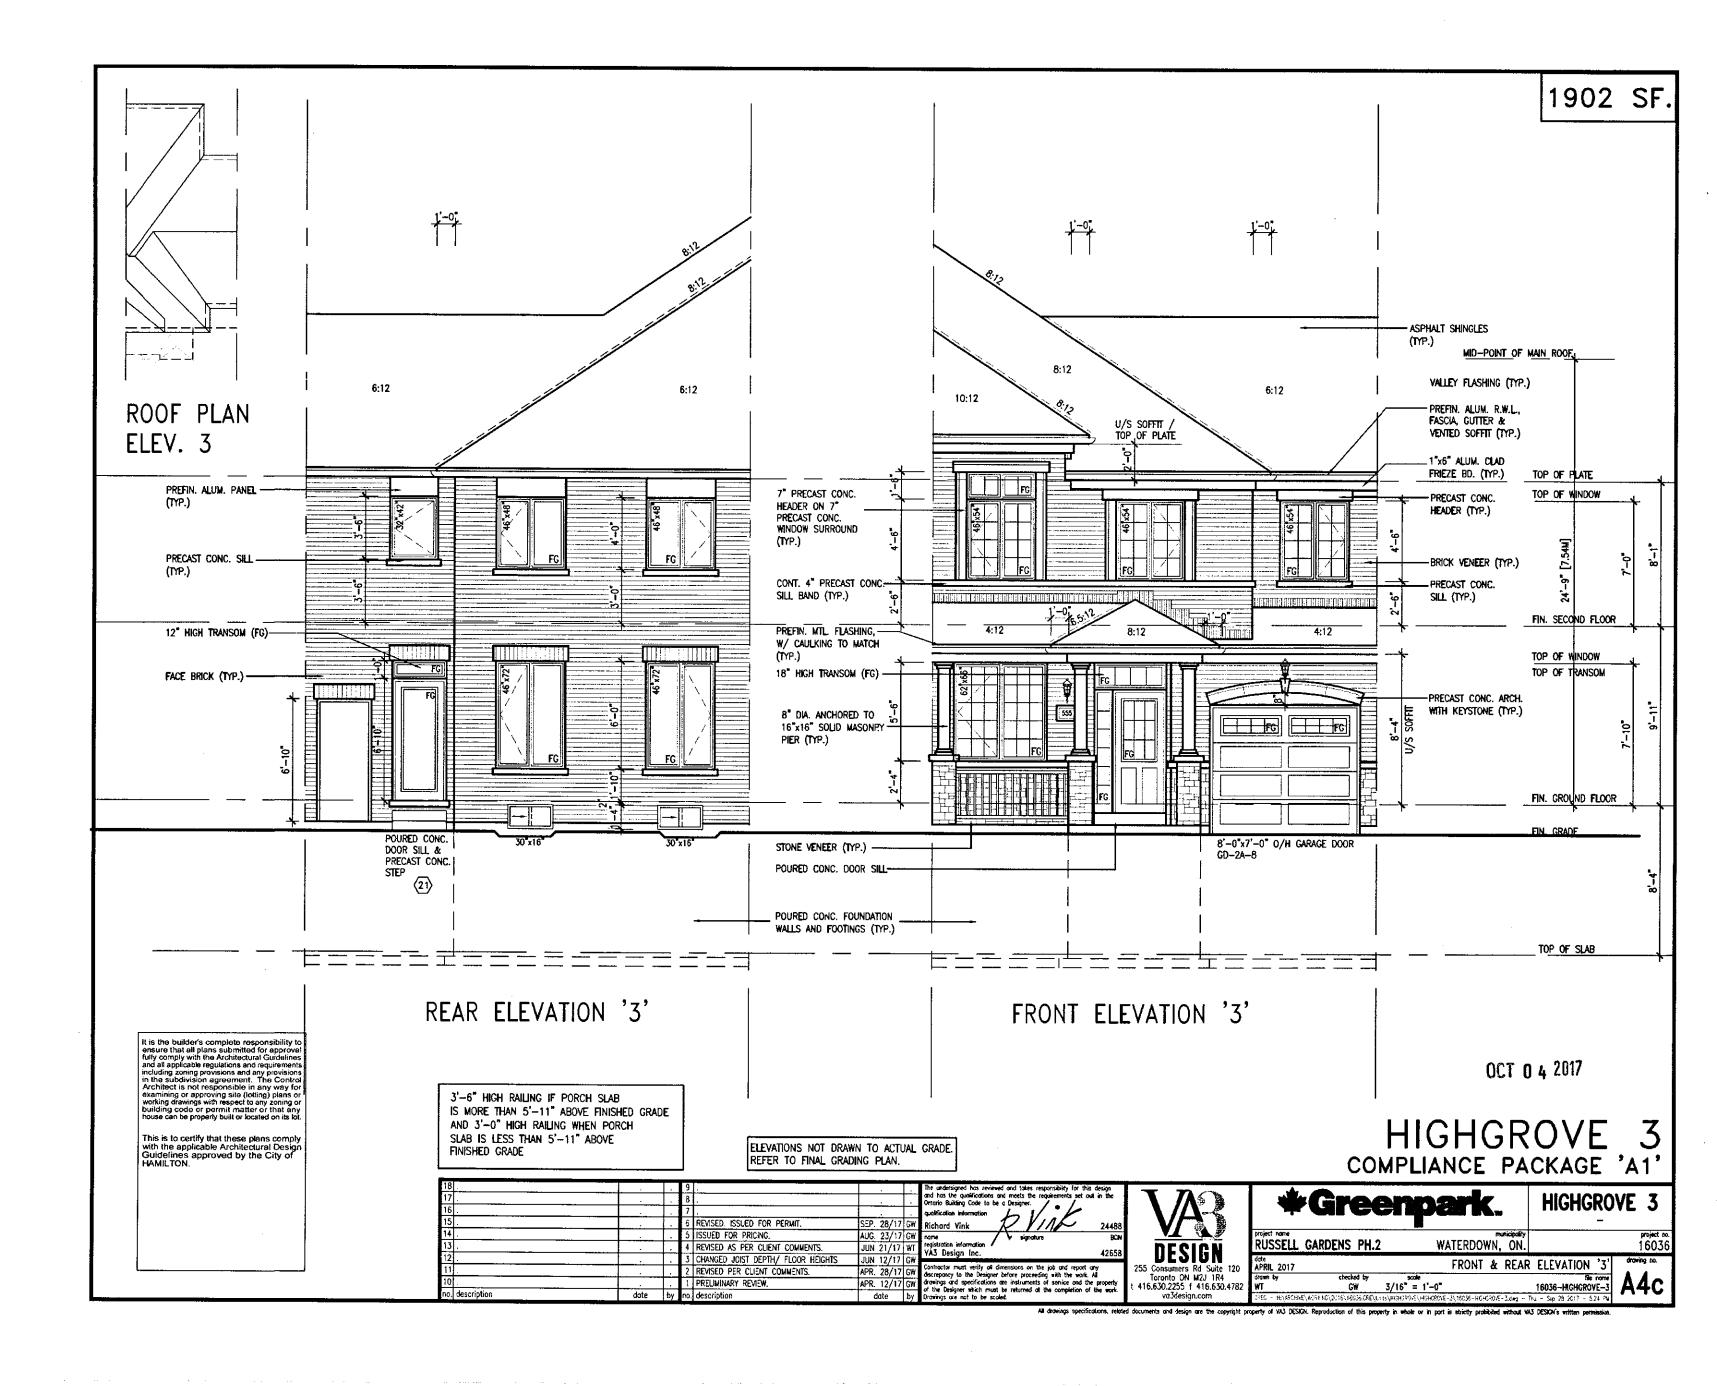


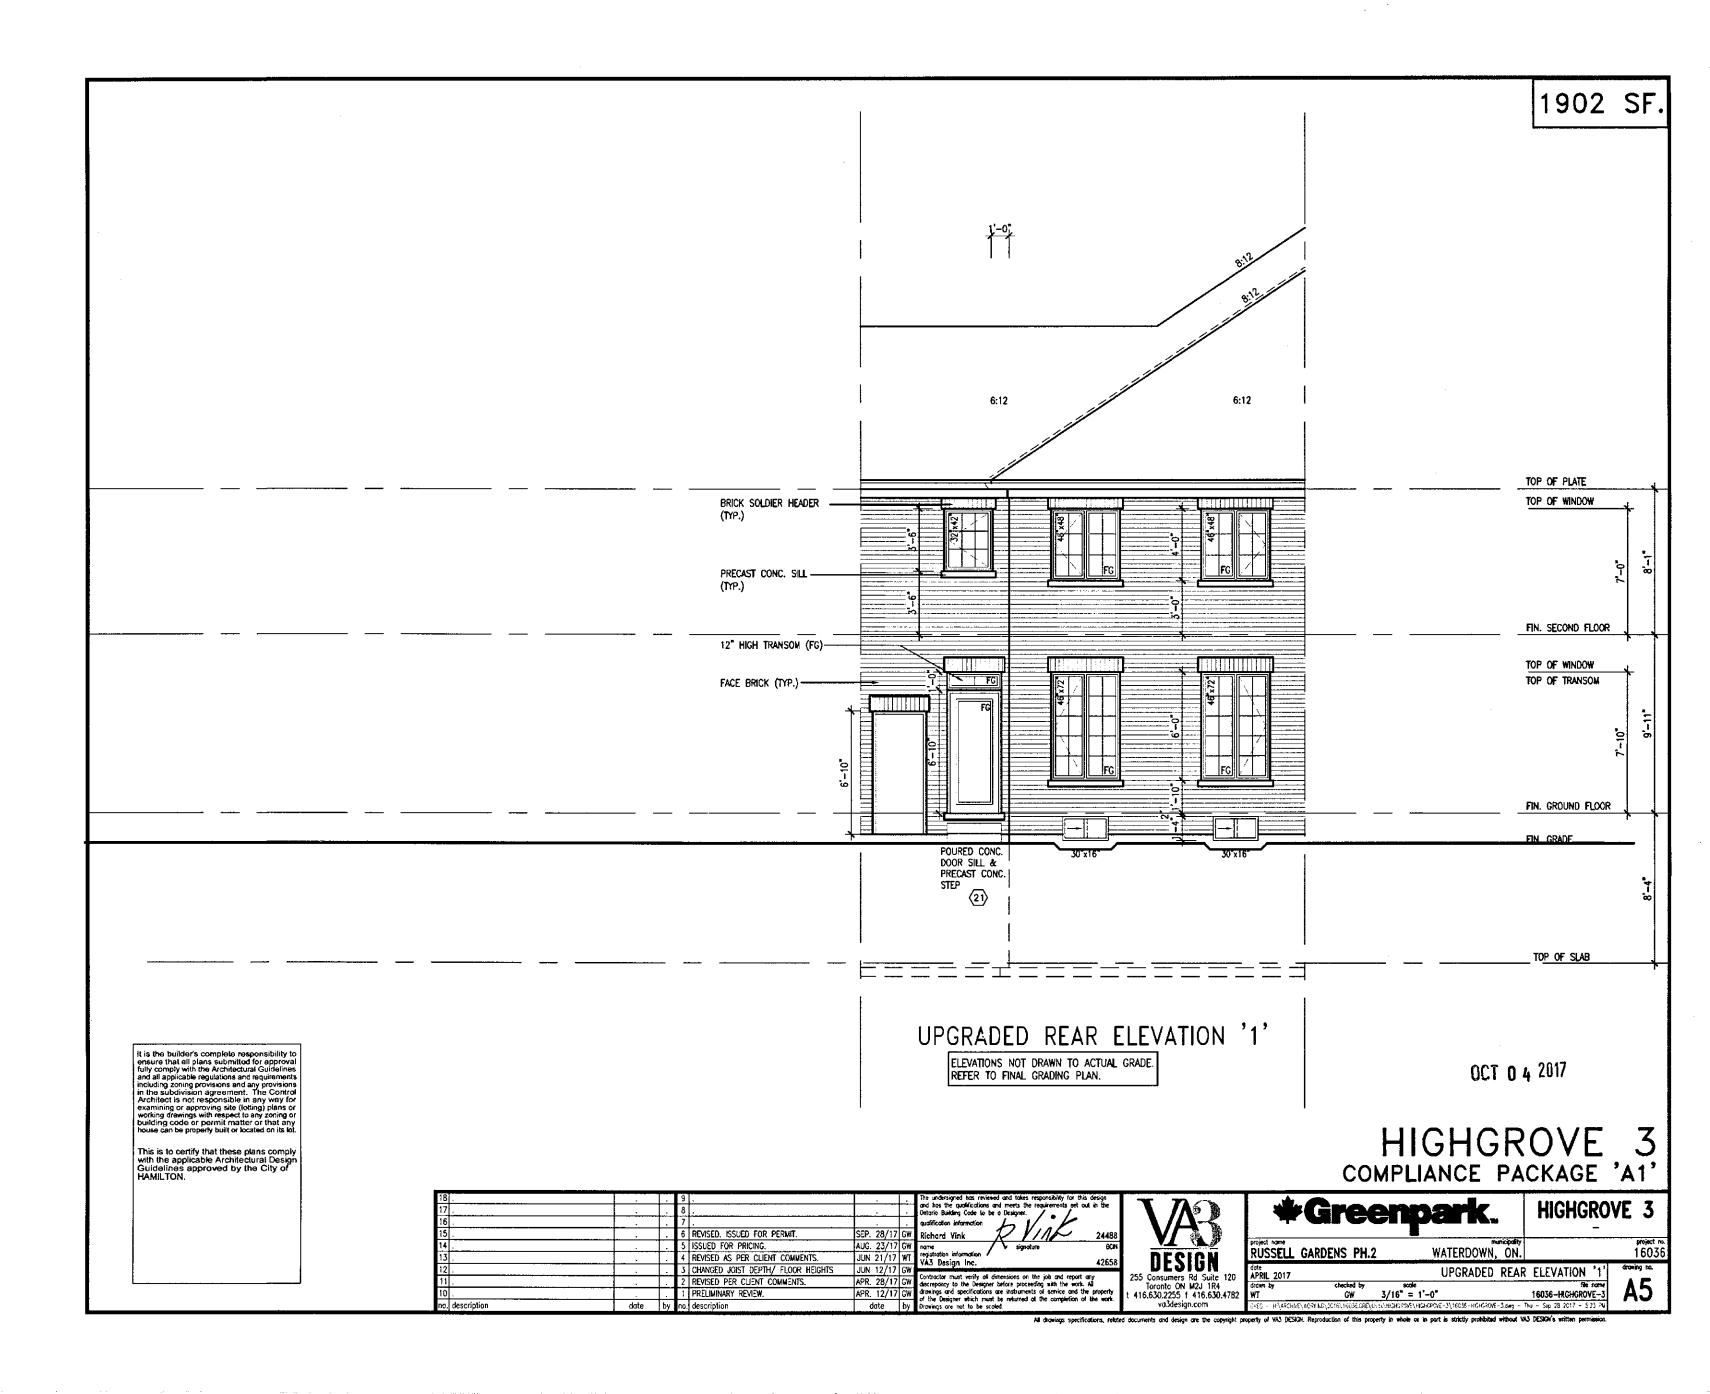


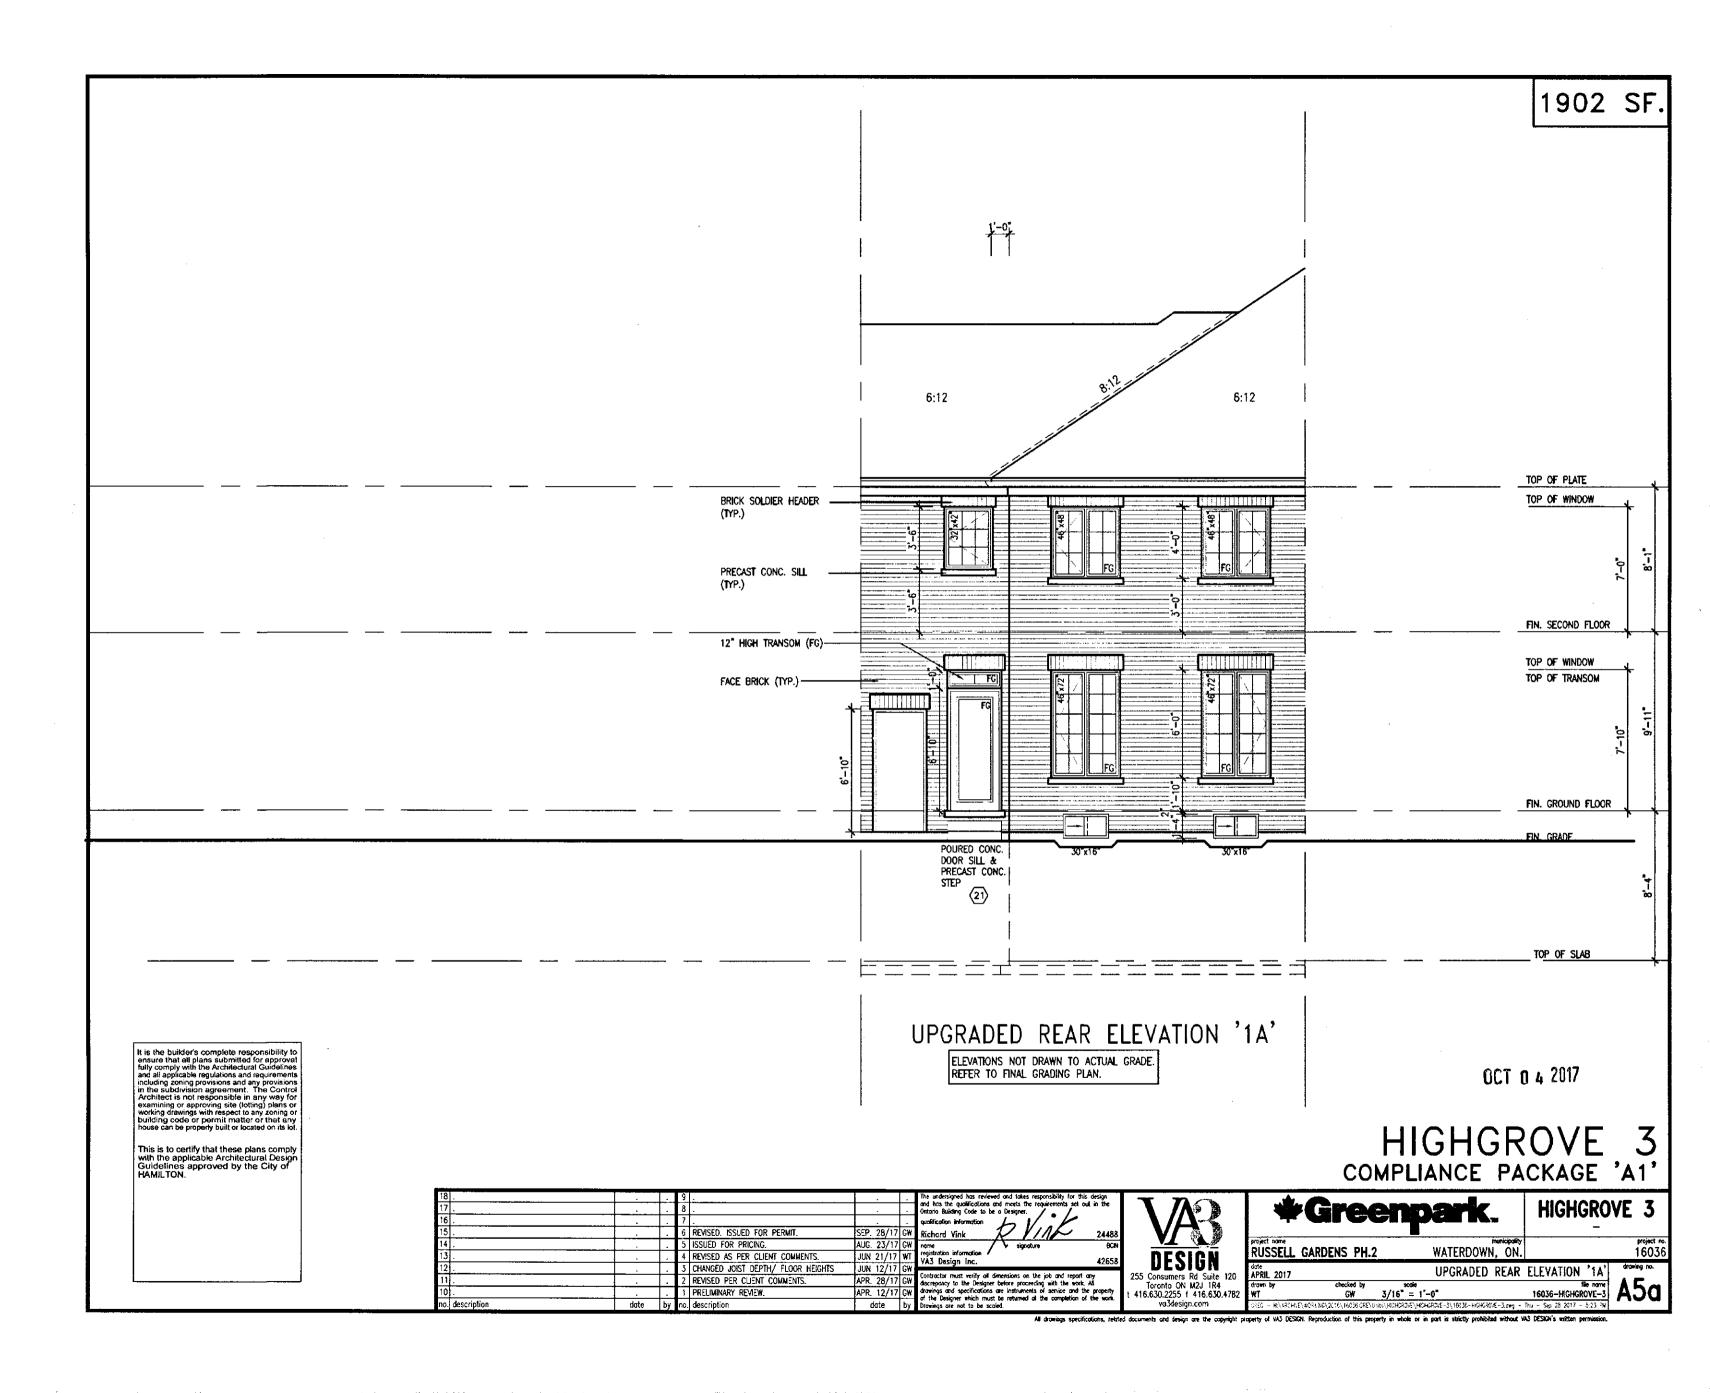


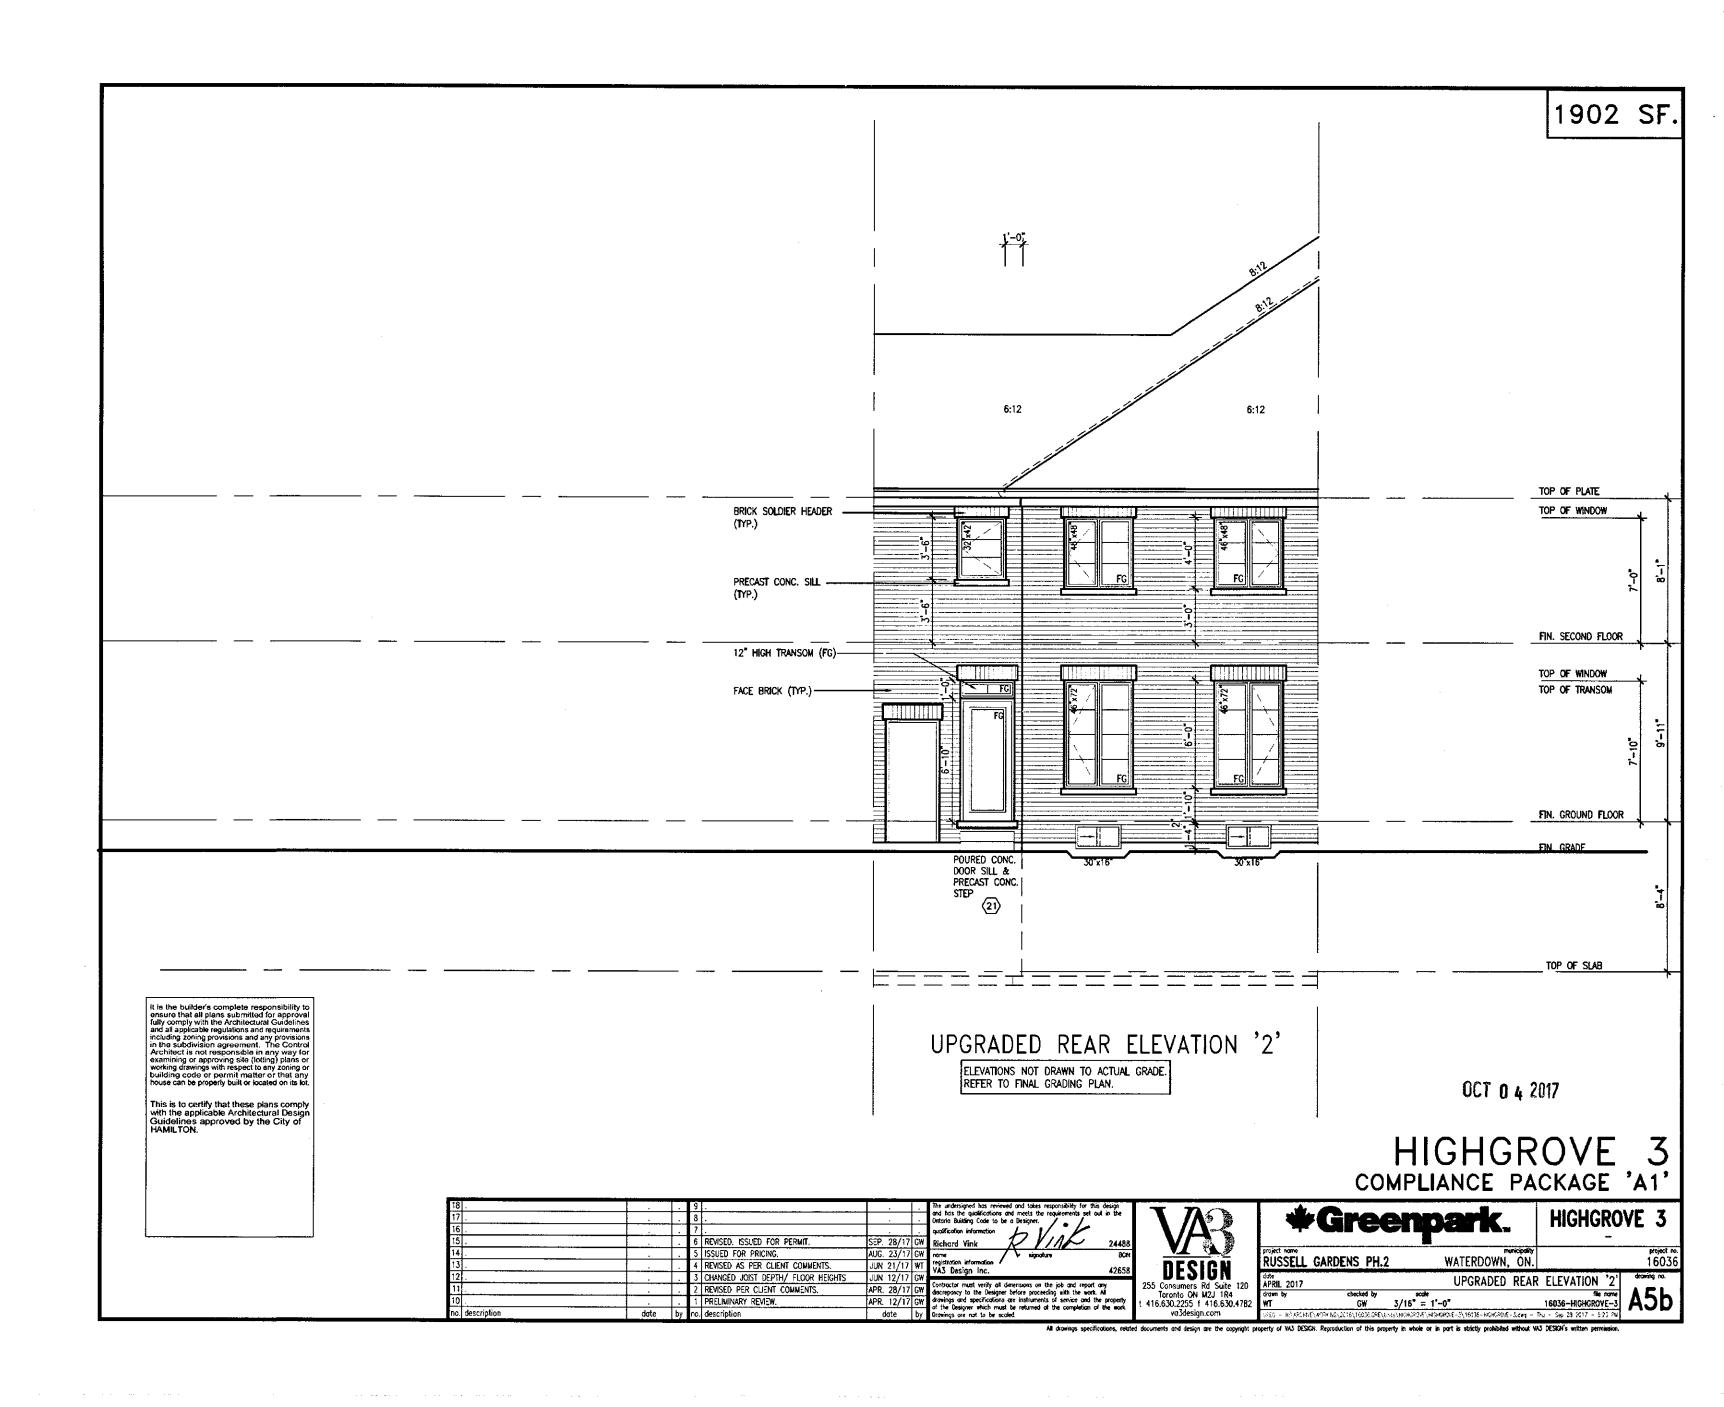


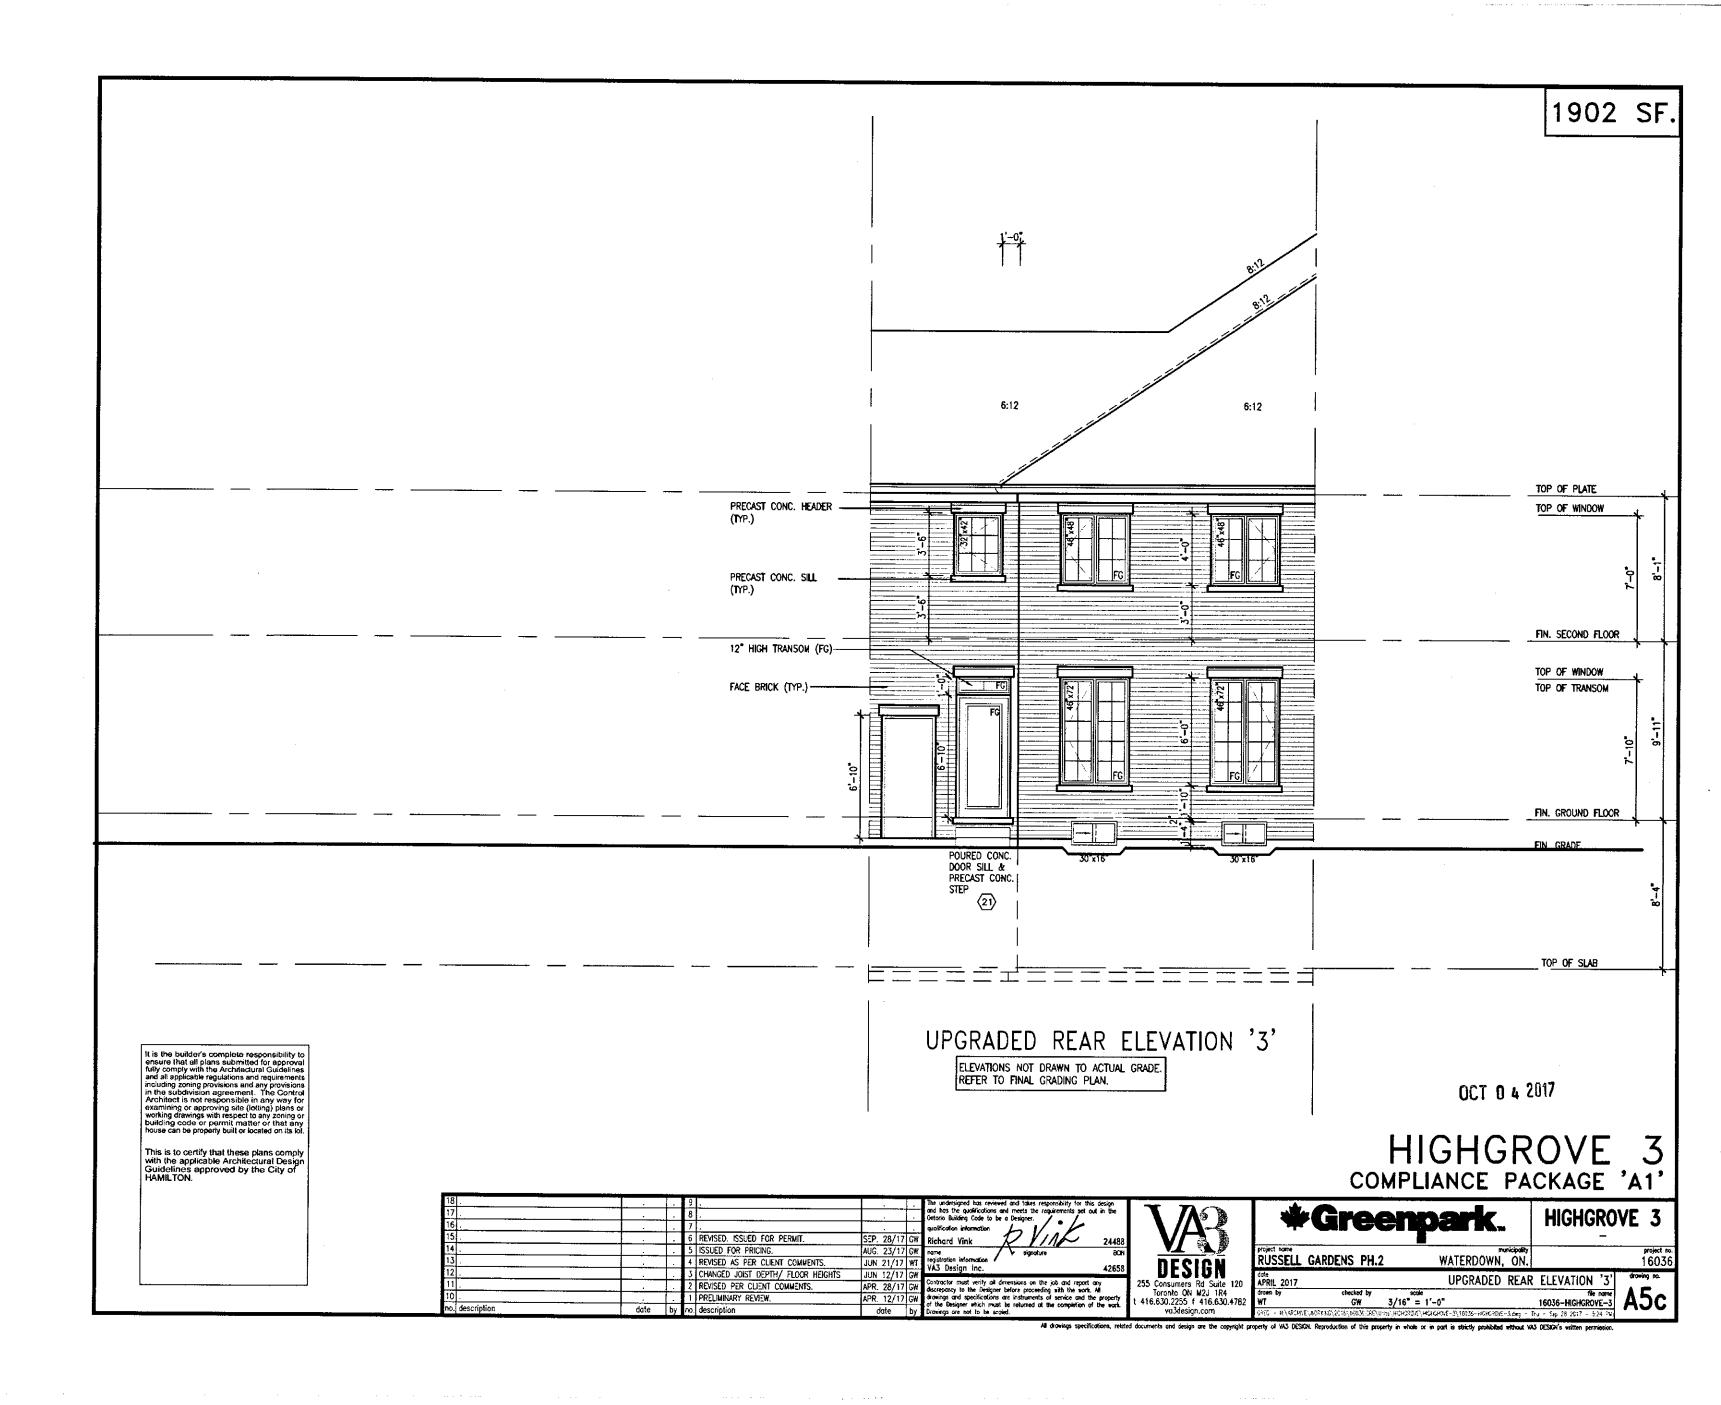


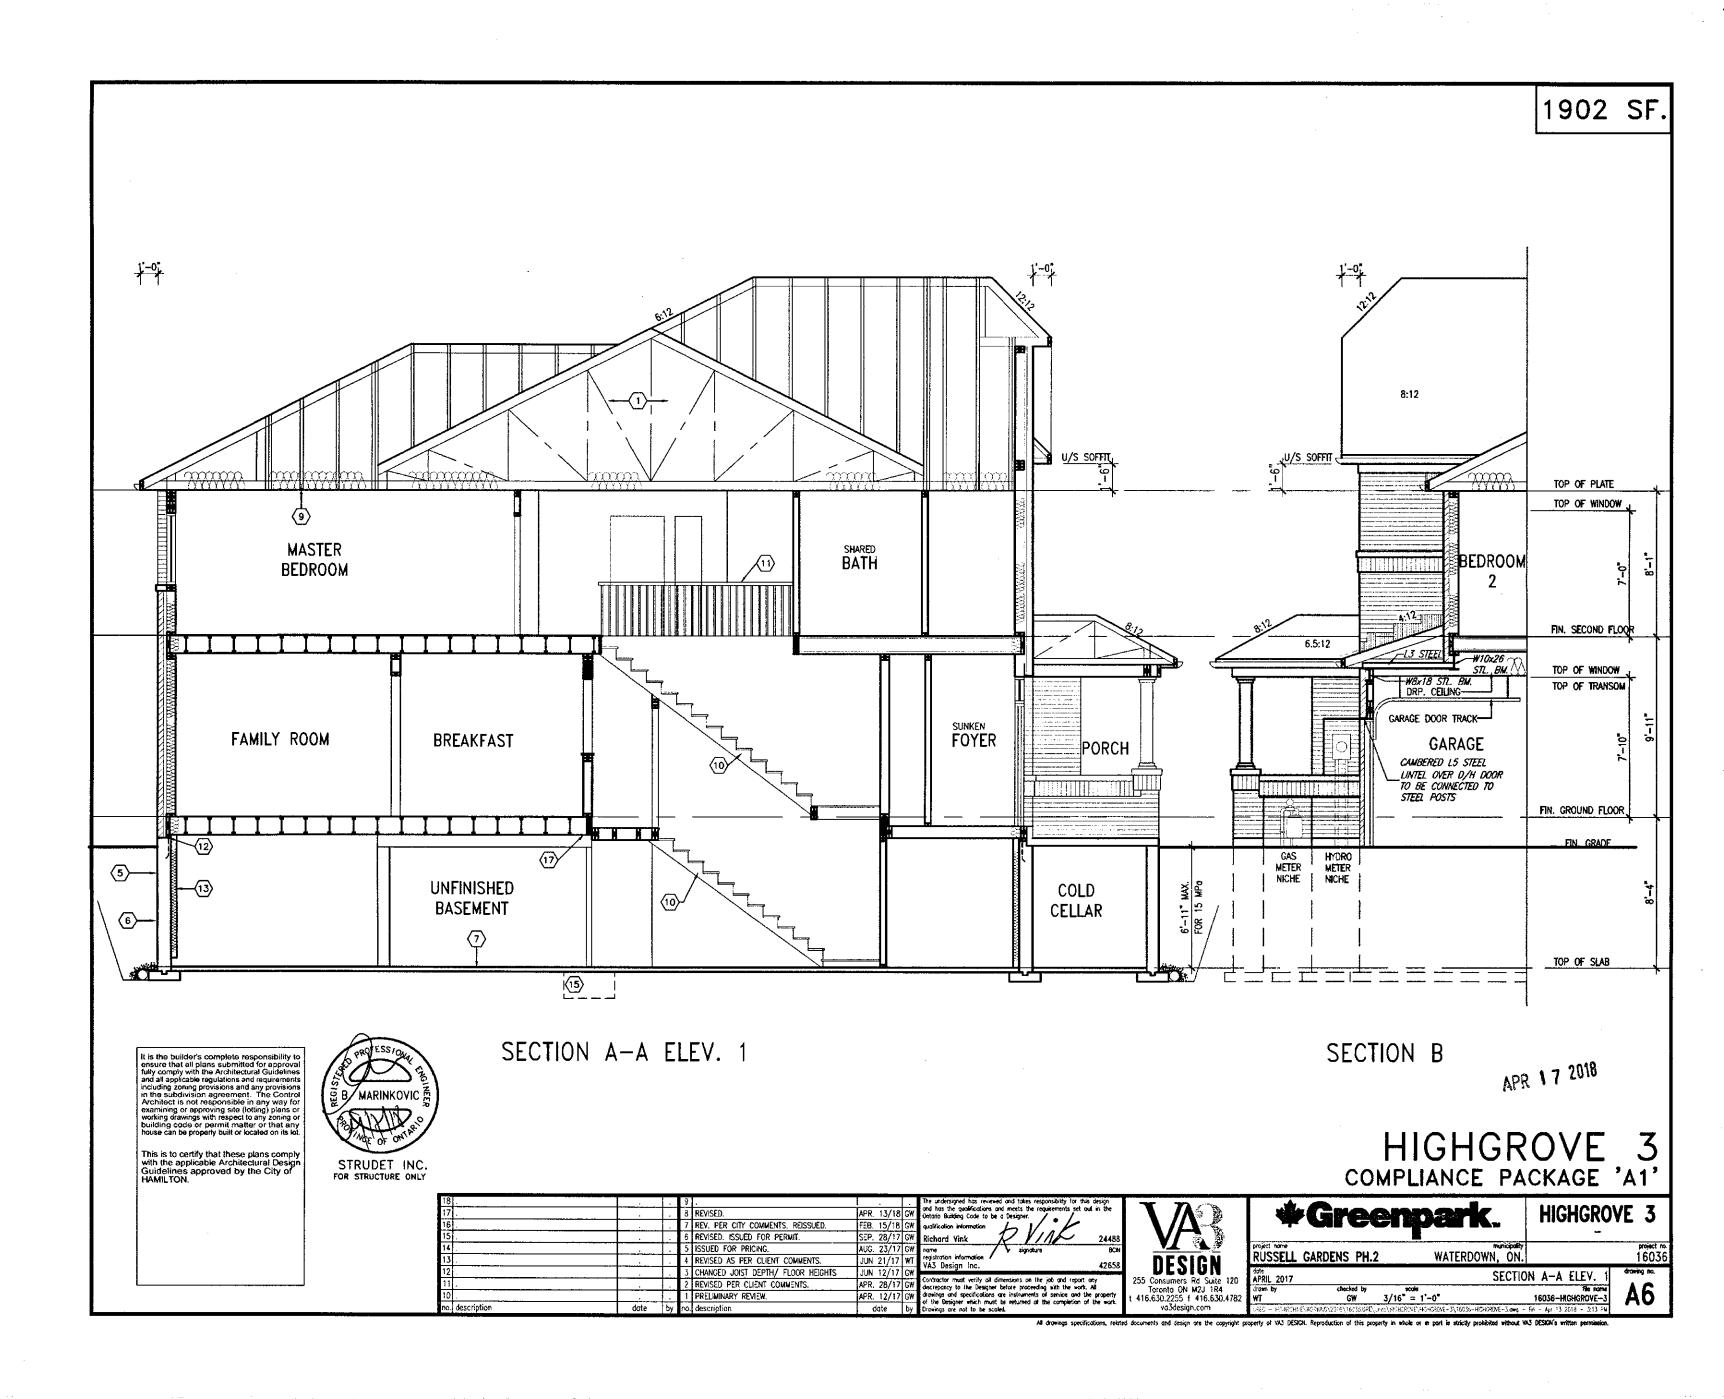

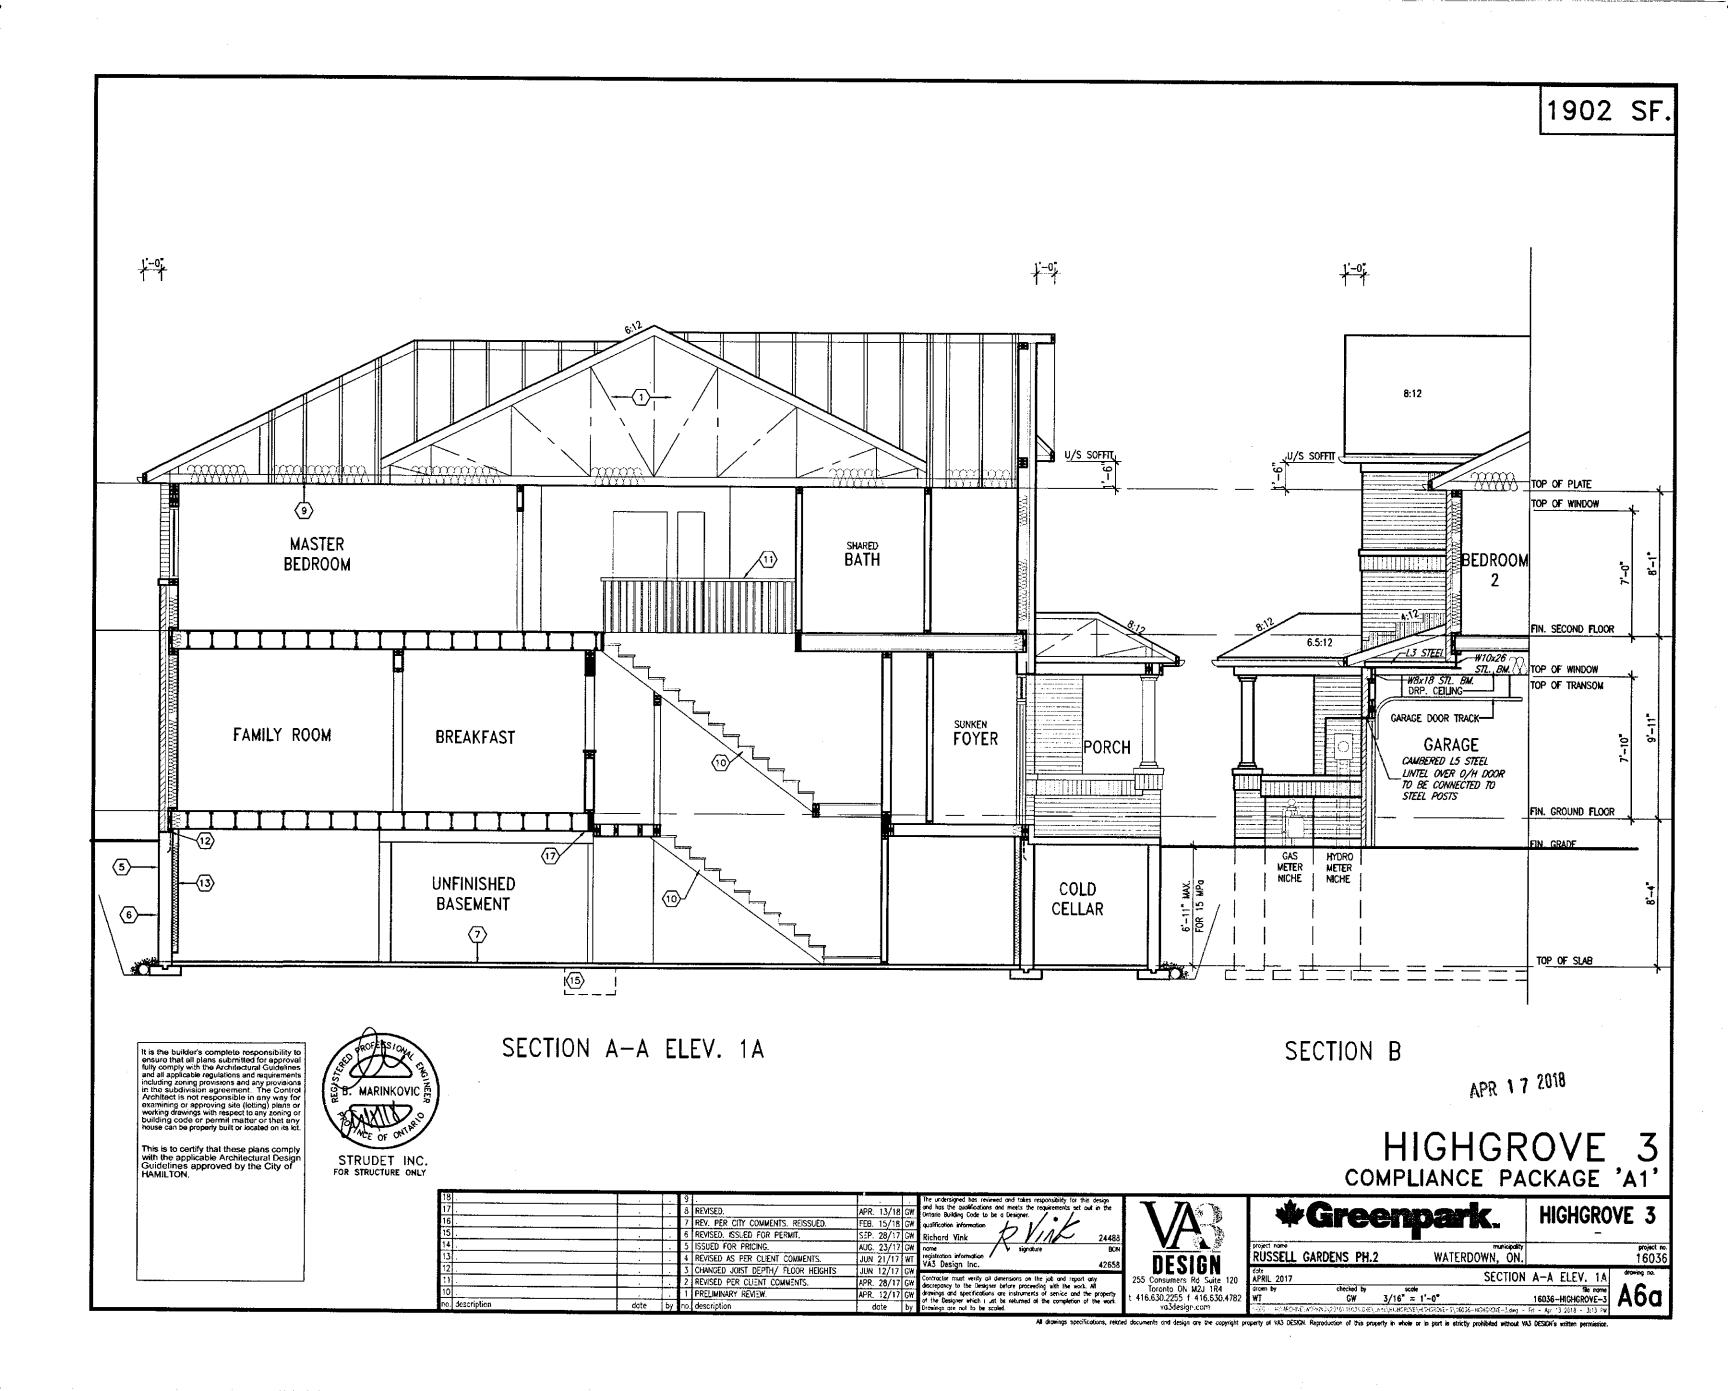

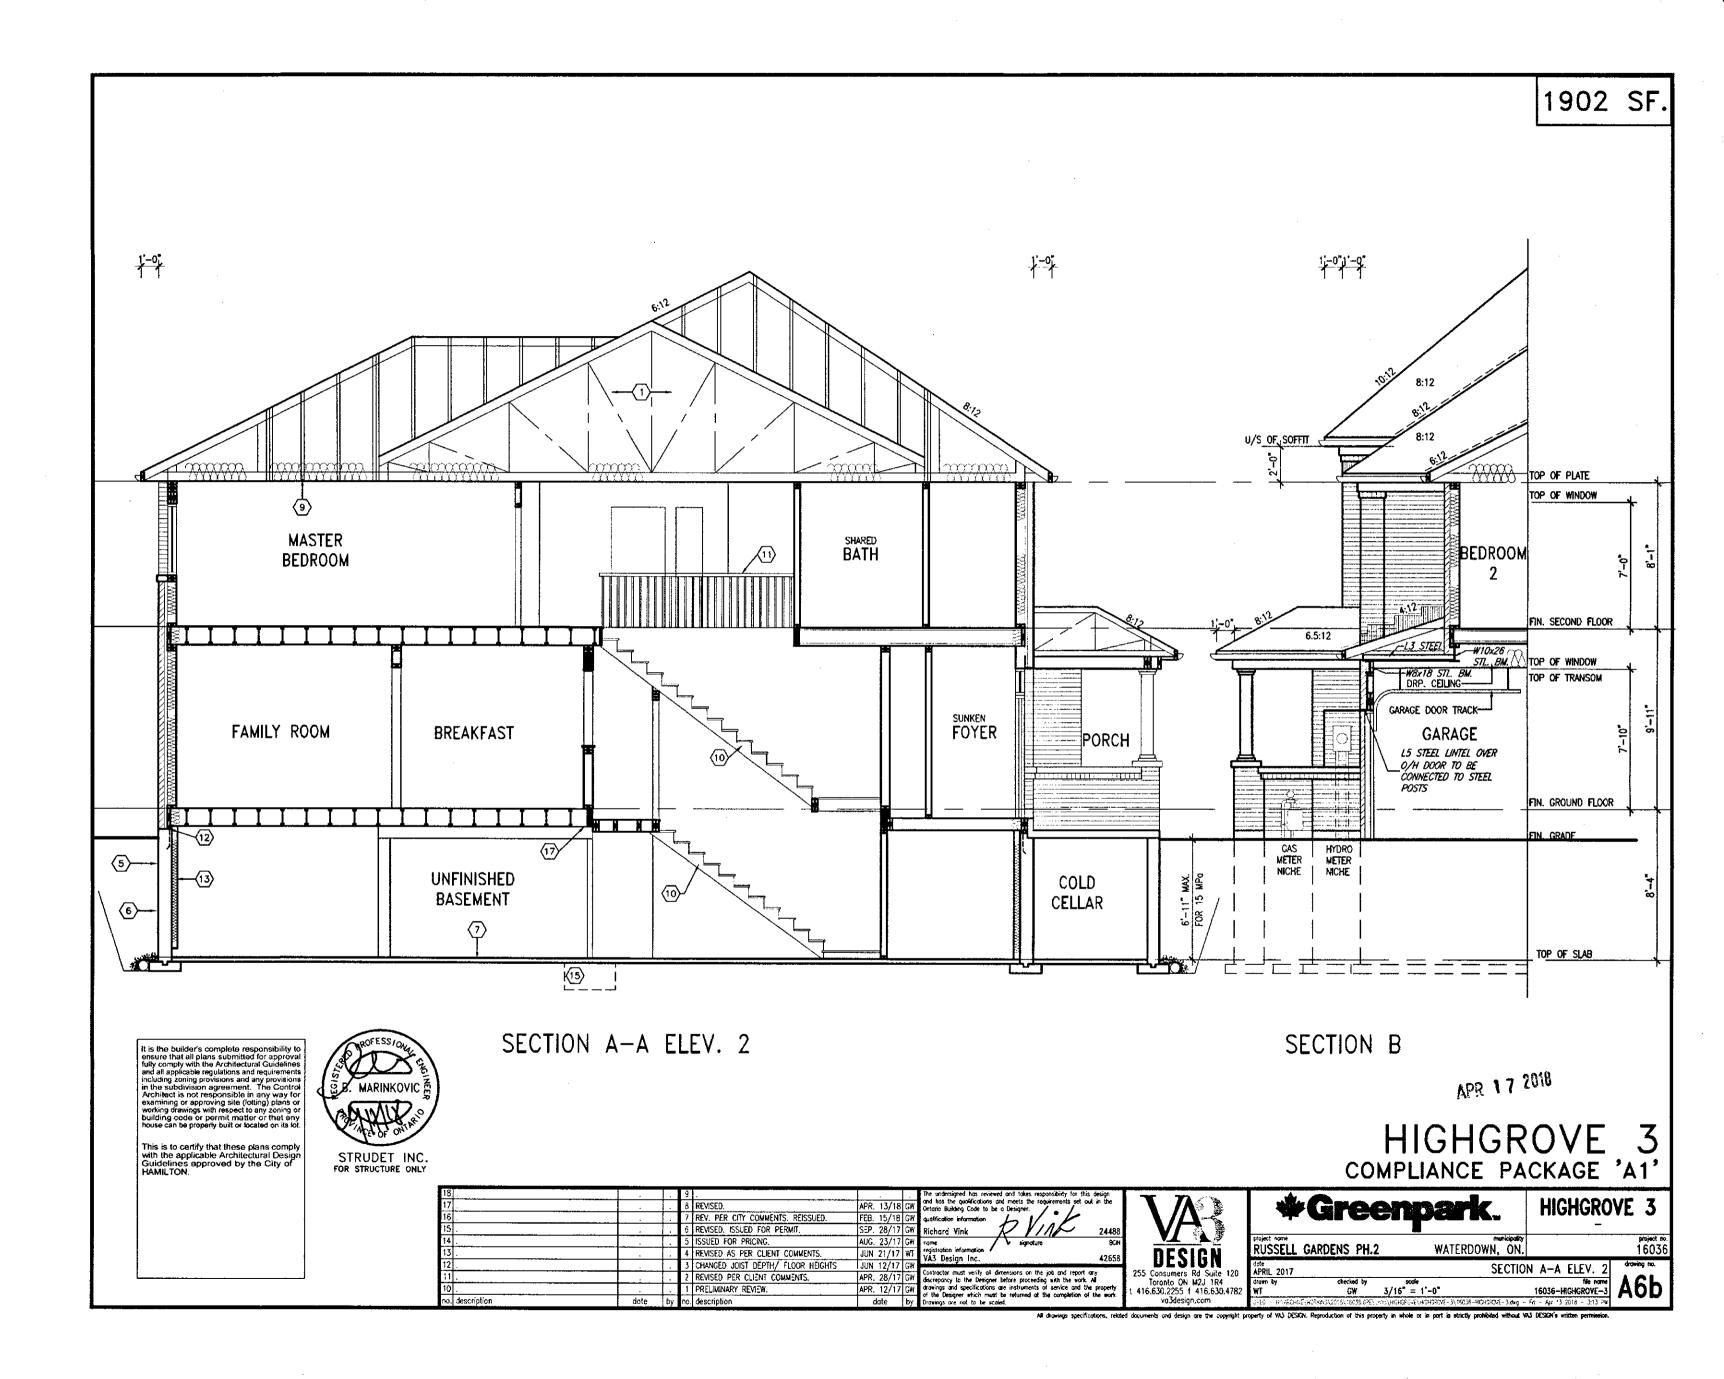

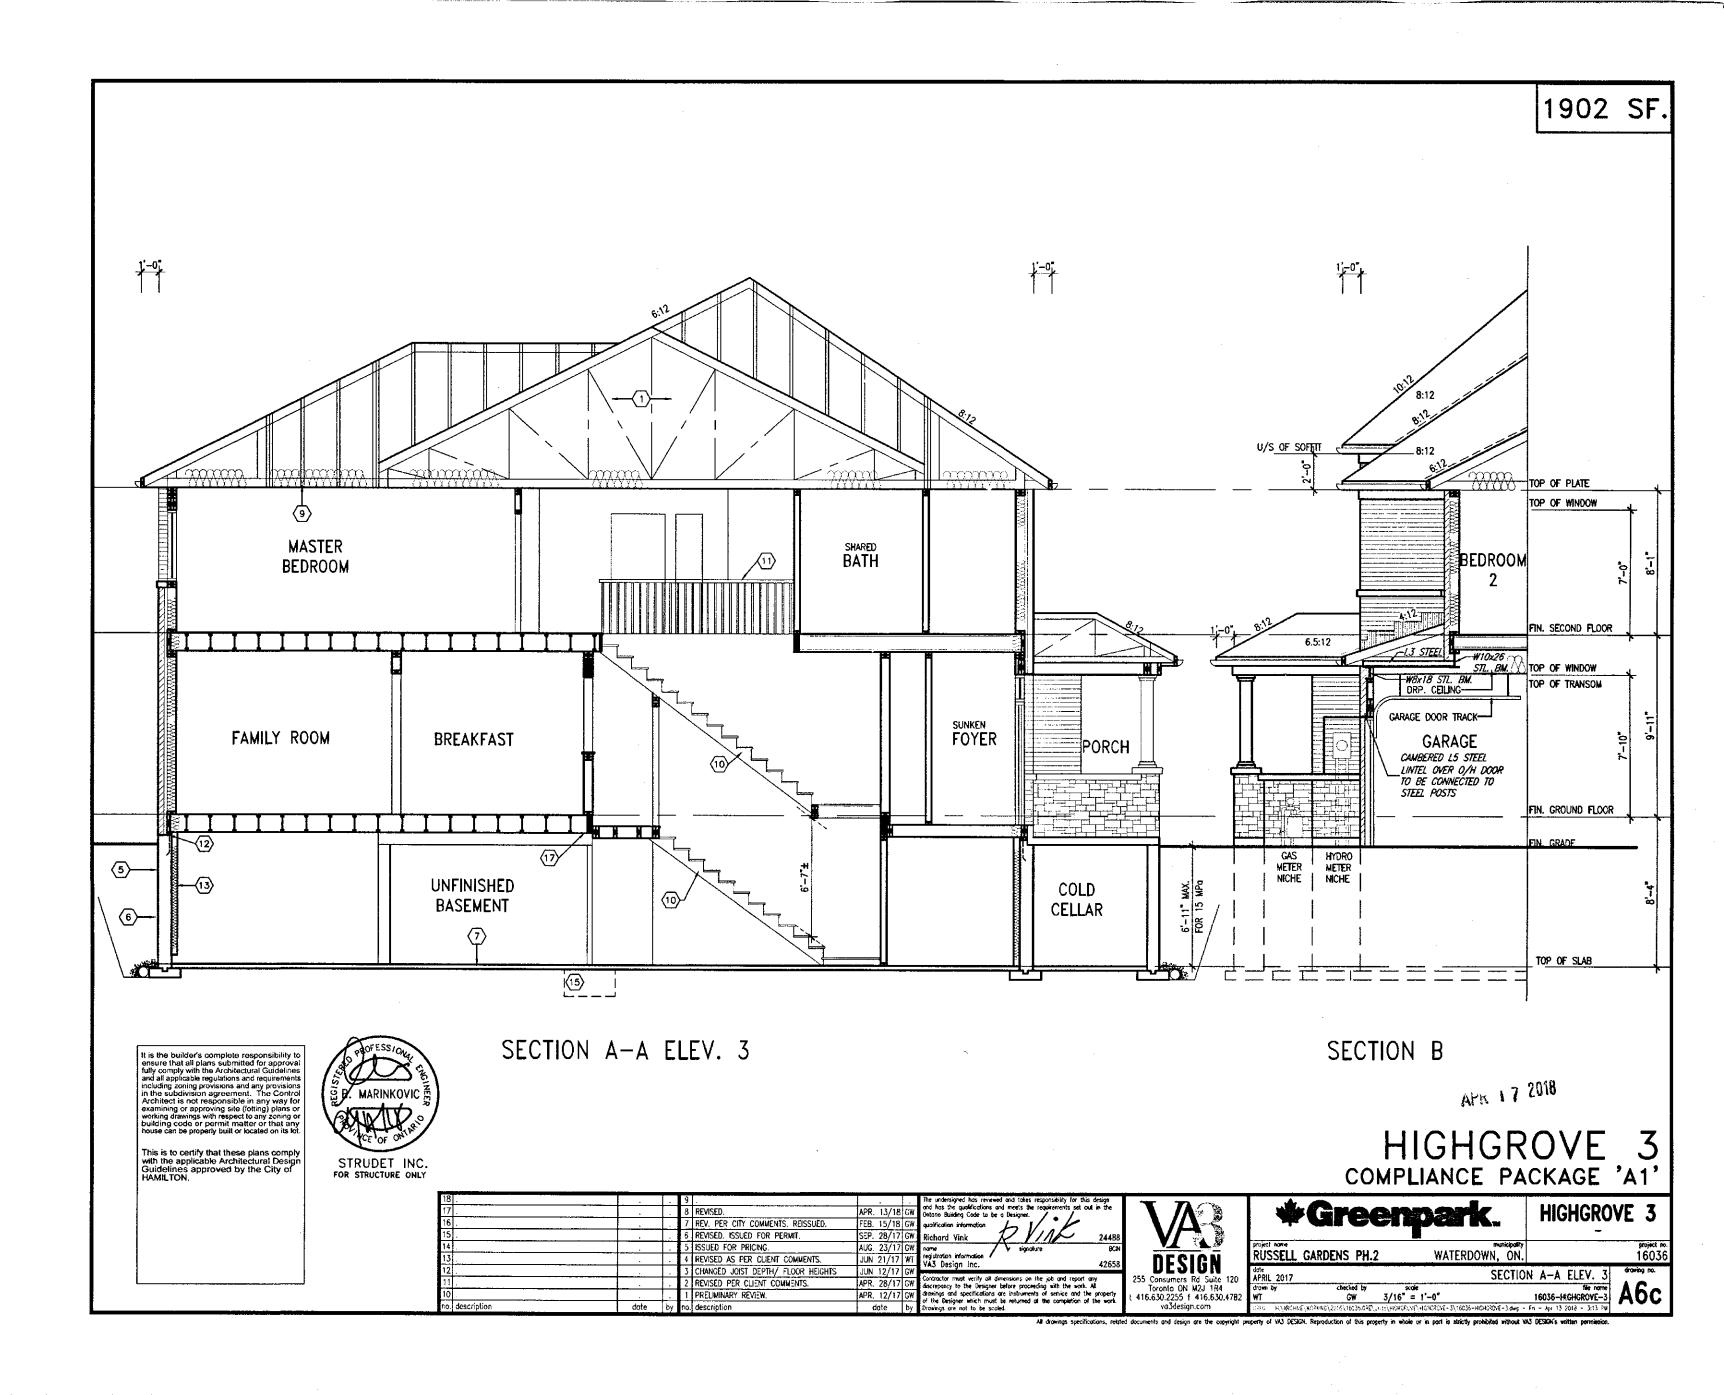

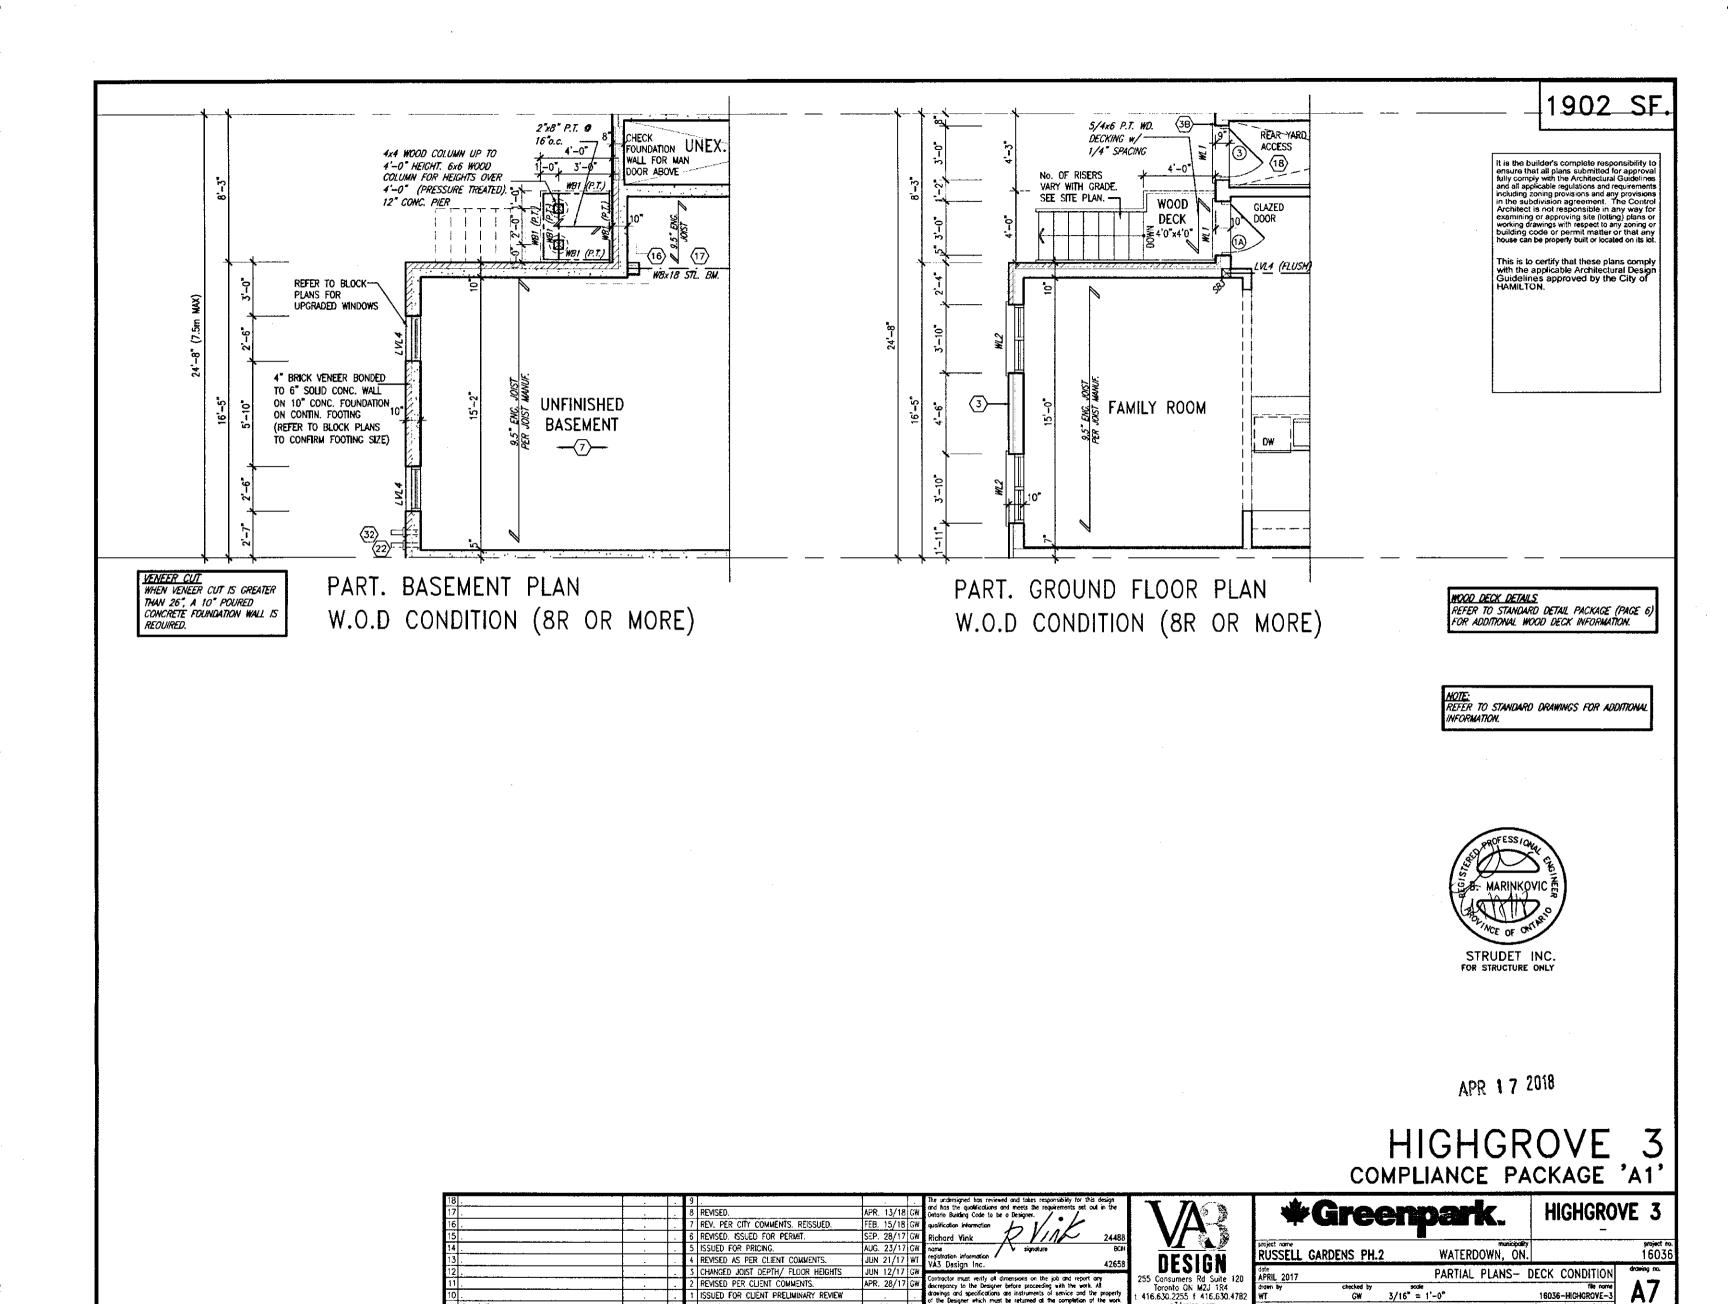


1 ISSUED FOR CLIENT PRELIMINARY REVIEW


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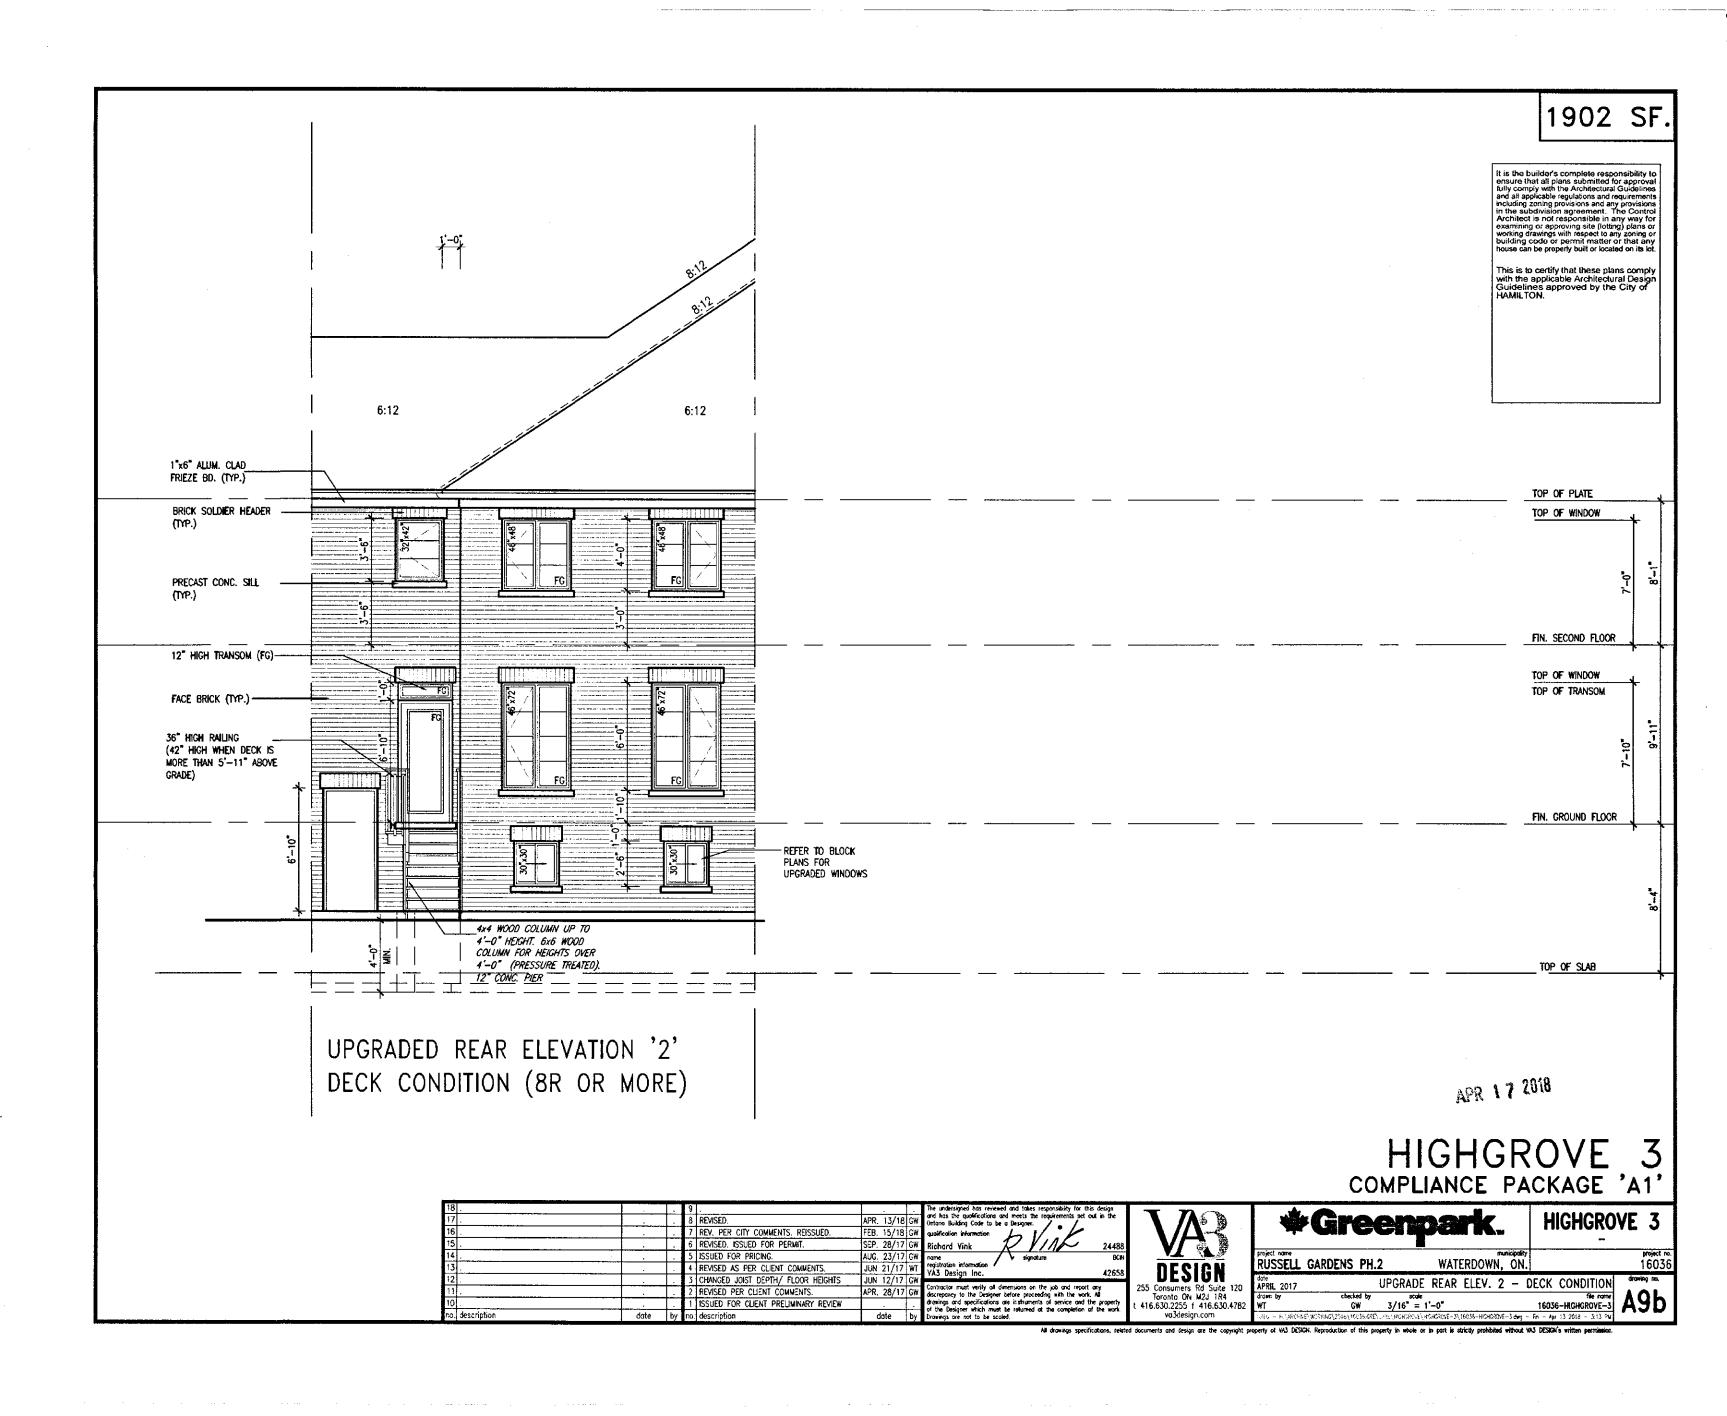
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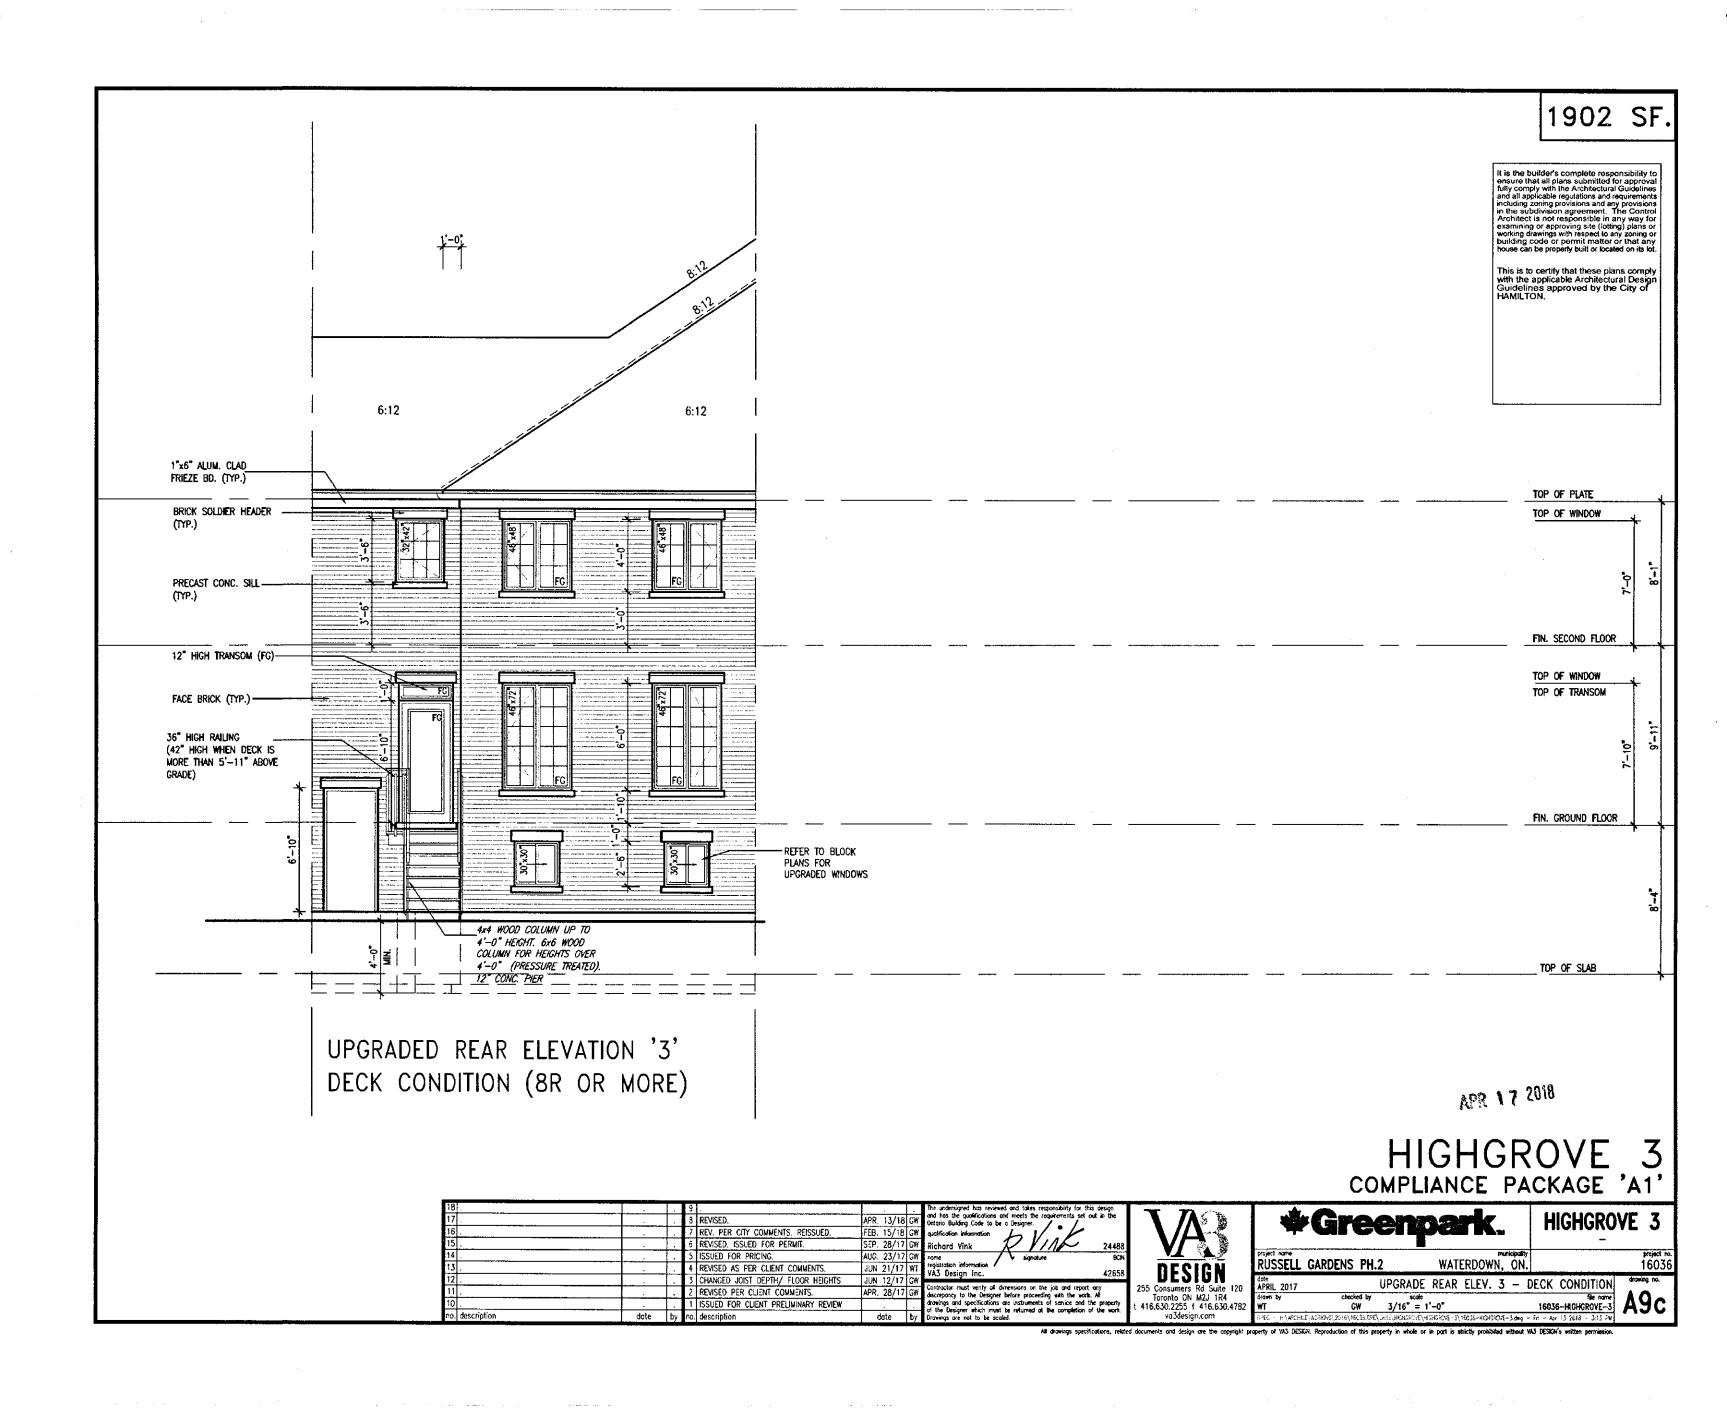
va3design.com

16036-HIGHGROVE-3





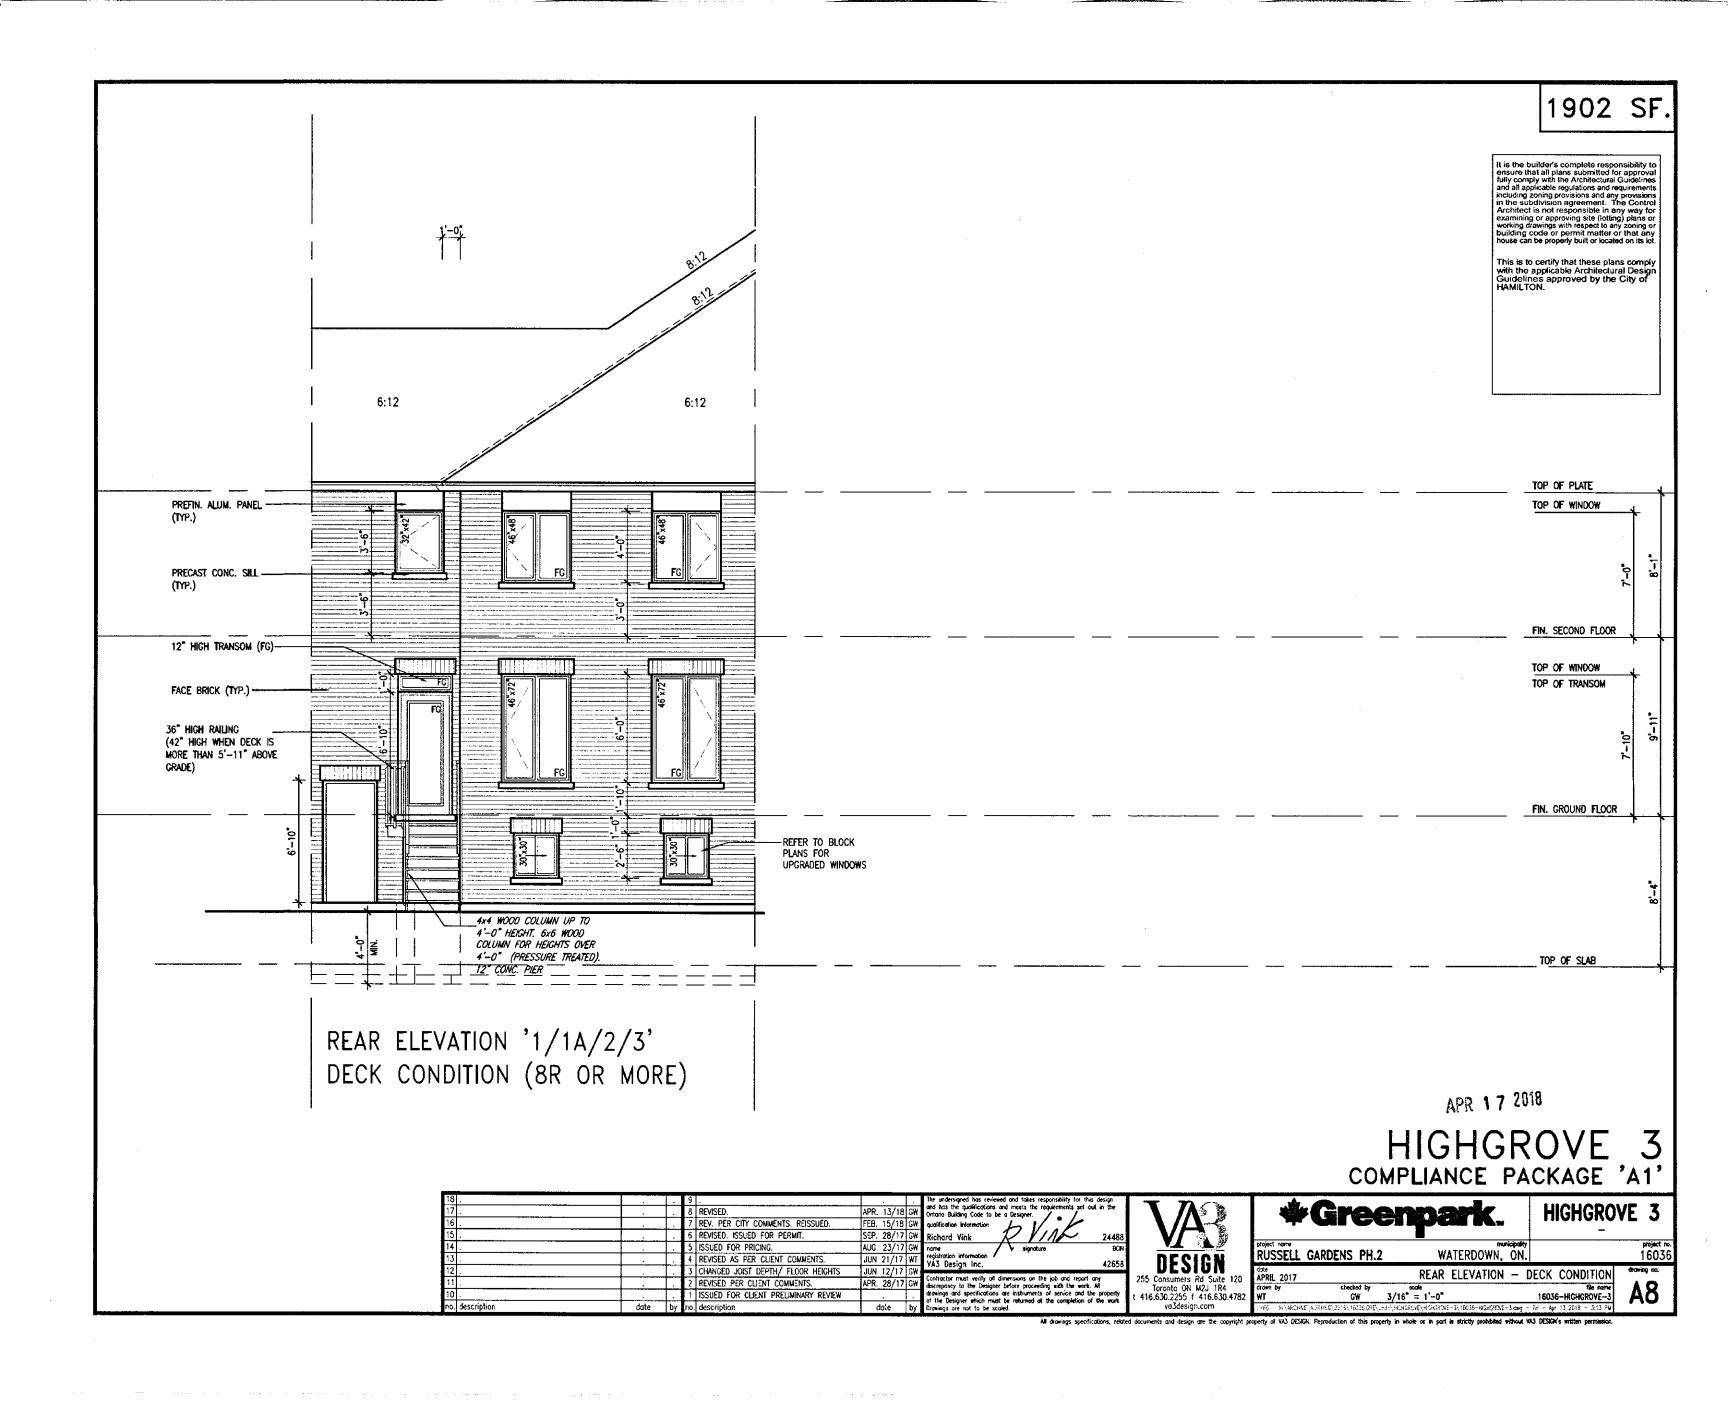

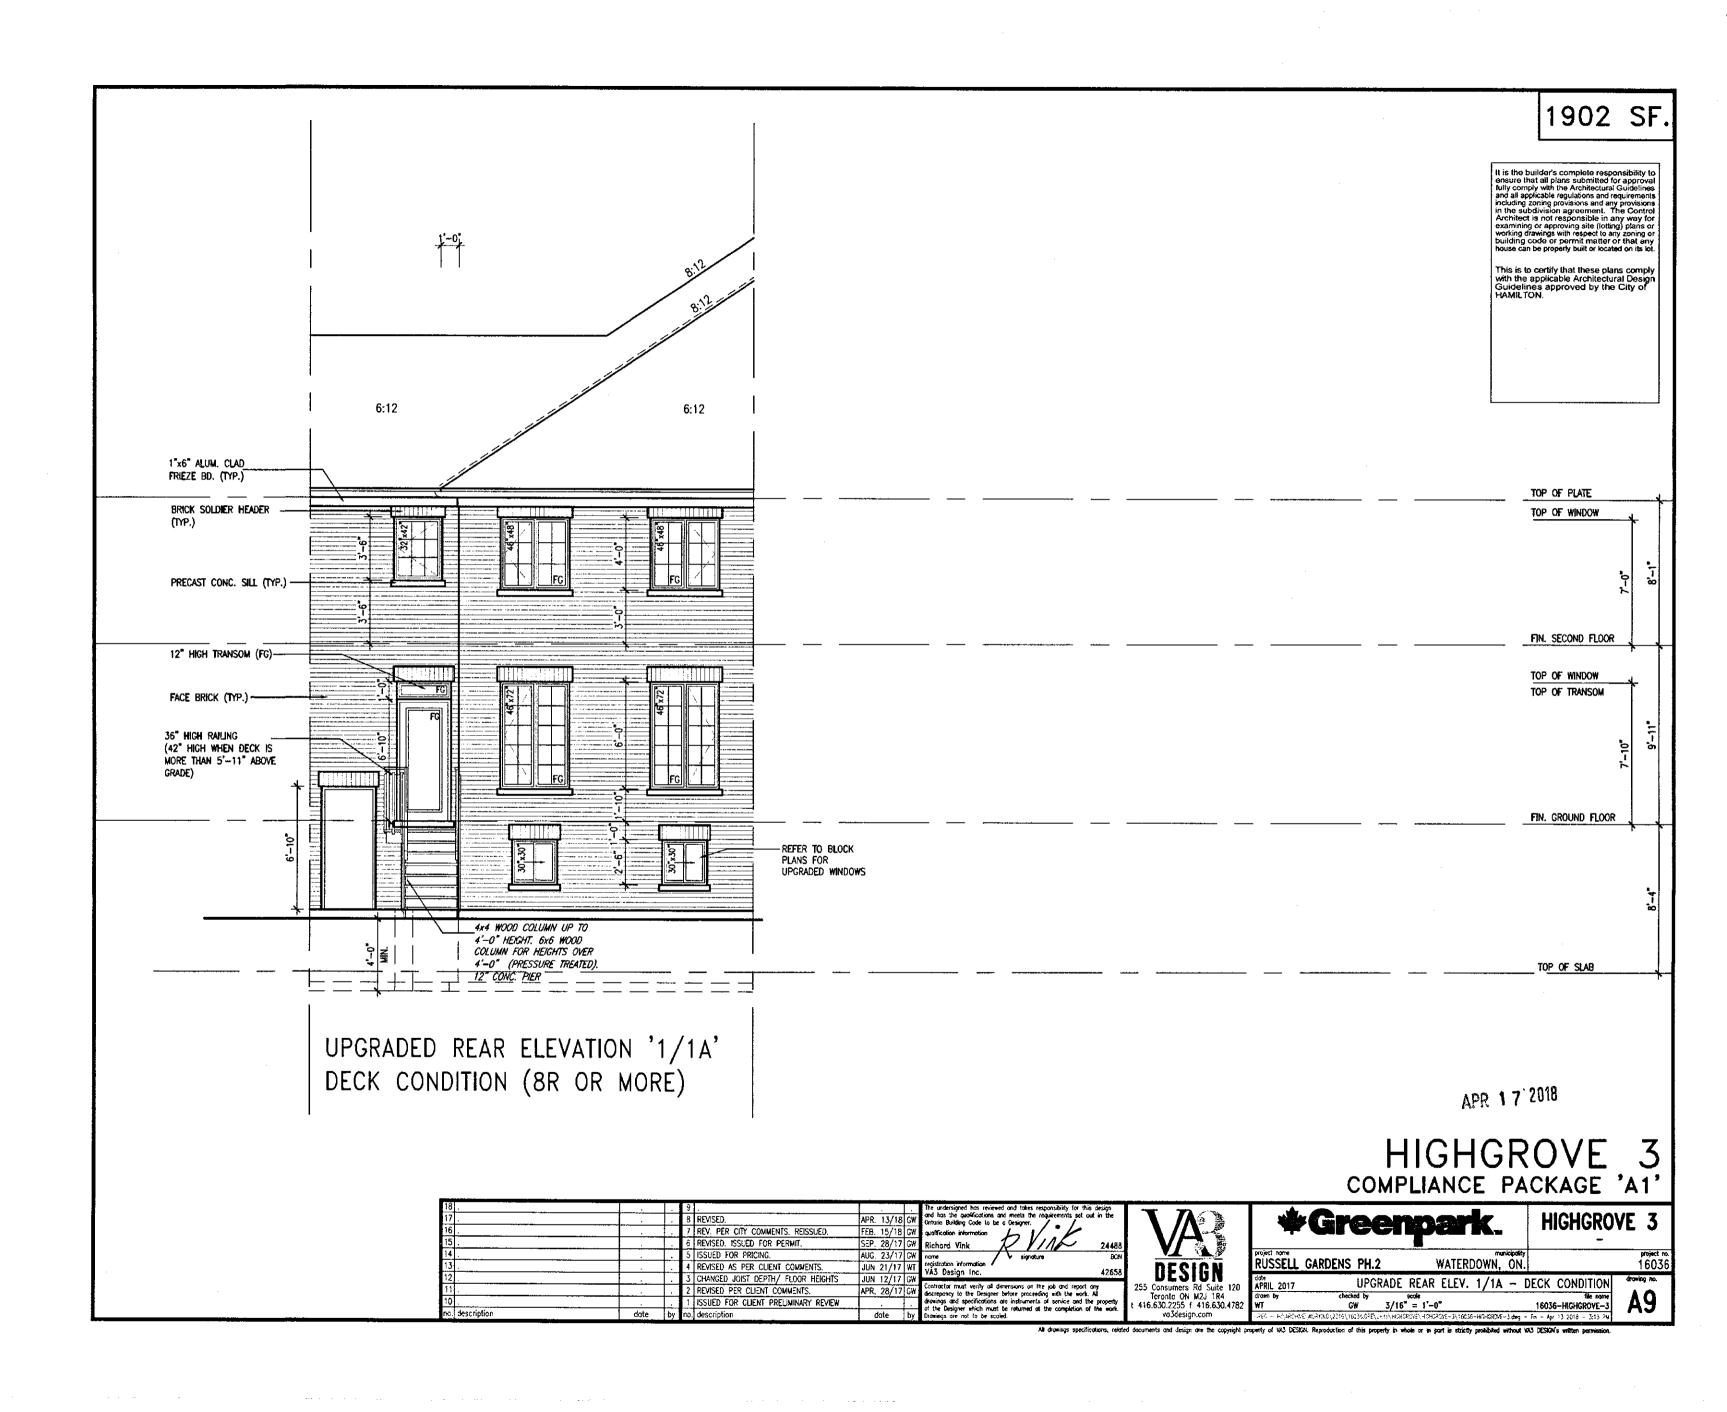

1902 SF. This is to certify that these plans comply with the applicable Architectural Design Guidelines approved by the City of HAMILTON. TOP OF PLATE TOP OF WINDOW 5/4x6 P.T. WD. DECKING W/-----1/4" SPACING REAR YARD REAR YARD ACCESS 4'-0" ACCESS (18) (18) 3'-0" 6x6 WOOD COLUMN (PRESSURE TREATED) WOOD ON 12" CONC. PIER GLAZED DOOR DECK DEC. 4'0"x4'0" 室[ FIN. SECOND FLOOR LVL4 (FLUSH) WBx 18 STL. BM. TOP OF WINDOW 3 5th (SP) TOP OF TRANSOM MAX) 24"-8" (7.5m DOOR 4" BRICK VENEER w/ 2"x6"
9 16" o.c. STUD WALL ON
10" CONC. FOUNDATION ON
CONTIN. FOOTING
(REFER TO BLOCK PLANS
TO CONFIRM FOOTING SIZE) UNFINISHED FAMILY ROOM BASEMENT FIN. GROUND FLOOR D₩ 7 TOP OF WINDOW VENEER CUT WHEN VENEER CUT IS GREATER THAN 26", A 10" POURED CONCRETE FOUNDATION WALL IS REQUIRED. PART. GROUND FLOOR PLAN PART. BASEMENT PLAN LOOK-OUT WOOD DECK DETAILS FIN. GRADE REFER TO STANDARD DETAIL PACKAGE (PAGE 6–2) FOR ADDITIONAL WOOD DECK INFORMATION. W.O.B CONDITION W.O.B CONDITION WALL AREA 308.58 SQ. FT.
LIMITING DISTANCE 2.0 M (12.0%)
OPENINGS ALLOWED 37.0 SQ. FT.
OPENINGS PROVIDED 20.5 SQ. FT. SIDE ELEVATION '1/1A/2/3' WOB CONDITION OCT n 4 2017 HIGHGROVE COMPLIANCE PACKAGE 'A1' **\*Greenpark.** HIGHGROVE 3 STRUDET INC. FOR STRUCTURE ONLY REVISED. ISSUED FOR PERMIT SEP. 28/17 0 project ro. 16036 municipality
WATERDOWN, ON. RUSSELL GARDENS PH.2 ISSUED FOR PRICING. AUC. 23/17 REVISED AS PER CLIENT COMMENTS JUN 21/17 W VA3 Design Inc. date APRIL 2017 drawn by WT PARTIAL PLANS- WOB CONDITION CHANGED JOIST DEPTH/ FLOOR HEIGHTS JUN 12/17 255 Consumers Rd Suite 120 Toronto ON M2J 1R4 t 416.630.2255 f 416.630.4782 va3design.com REVISED PER CLIENT COMMENTS. APR. 28/17 16036-HIGHGROVE-3 ISSUED FOR CLIENT PRELIMINARY REVIEW date by no. description

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