UNINSULATED OPENINGS (PER OBC. SB-12,3.1.1(7)) HIGHGROVE 1, ELEVATION 1 ENERGY EFFICIENCY - 08C S812 WALL AREA S.F. OPENING S.F. PERCENTAGE ELEVATION 441.22 S.F. 94.20 S.F. 21.35 % FRONT 3.33 S.F LEFT SIDE 838.18 S.F. 0.40 % RIGHT SIDE 838.18 S.F. 0.00 S.F 0.00 % 441.22 S.F. REAR 112.09 S.F. 25.40 % * OPENINGS OMITTED AS PER SB-12 3.1.1.9(4) MAX 19.9 S.F. REFER TO ELEVATION FOR LOCATION 0.00 S.F TOTAL SQ. FT. 8.19 % 209.62 S.F. 2558.80 S.F. 19.47 S.M. 8.19 1/2 TOTAL SQ. M. 237.72 S.M.

AREA CALCULATIONS	<u> 51EV '1'</u>
GROUND FLOOR AREA	770 SF
SECOND FLOOR AREA	824 SF
TOTAL FLOOR AREA	1594 SF
	(148.08 m2)
FIRST FLOOR OPEN AREA	XX SF
SECOND FLOOR OPEN AREA	XX SF
add total open areas	+XX SF
add finished bsmt area	+XX SF
GROSS FLOOR AREA	1594 SF
	(148.08 m2)
GROUND FLOOR COVERAGE	770 SF
GARAGE COVERAGE/AREA	296 SF
PORCH COVERAGE/AREA	89 SF
COVERAGE W/ PORCH	1155 SF
_	(107.30 m2)
COVERAGE W/O PORCH	1066 SF
• • • • • •	(99.03 m2)

UNINSULATED OPEN	<u>INGS</u> (PER OB	C. SB-12,3.1.1	(7))
HIGHGROVE 1, ELEVATION 2	ENERGY EFFICIENCY - 09C SB12		
ELEVATION	WALL AREA S.F.	OPENING S.F.	PERCENTAGE
FRONT	441.22 S.F.	82.60 S.F.	18.72 %
LEFT SIDE	838.18 S.F.	3.33 S.F.	0.40 %
RIGHT SIDE	838.18 S.F.	3.2 00.0	0.00 %
REAR	441.22 S.F.	112.09 S.F.	25.40 %
* OPENINGS OMITTED AS PER SB-12 3.1.1.9(4) MAX 19.9 S.F. REFER TO ELEVATION FOR LOCATION		0.00 S.F.	
TOTAL SQ. FT.	2558.80 S.F.	198.02 S.F.	7.74 %
TOTAL SO M	237 72 S M	18.40 S.M	7.74 %

AREA CALCULATIONS	FLEV '2'
GROUND FLOOR AREA SECOND FLOOR AREA	770 SF 824 SF
TOTAL FLOOR AREA	1594 SF (148.08 m2)
FIRST FLOOR OPEN AREA SECOND FLOOR OPEN AREA	XX SF XX SF
ADD TOTAL OPEN AREAS ADD FINISHED BSMT AREA	+XX SF +XX SF
GROSS FLOOR AREA	1594 SF (148.08 m2)
GROUND FLOOR COVERAGE GARAGE COVERAGE/AREA PORCH COVERAGE/AREA	770 SF 296 SF 89 SF
COVERAGE W/ PORCH	1155 SF
COVERAGE W/O PORCH	(107.30 m2) 1066 SF (99.03 m2)

OCT 0 4 2017

HIGHGROVE-1 COMPLIANCE PACKAGE 'A1'

#Greenpark.	
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HIGHGROVE 1

WATERDOWN, ON. 16036 SARDENS PH2 TYPICAL NOTES AND AREAS file name 16036-HIGHCROVE 1

CERAMIC TILE FOR CONVENTIONAL LUMBER (OBC 9.30.6)

SPACE ALL CONVENTIONAL FLOOR JOISTS @ 12" O.C. BELOW ALL CERAMIC TILE AREAS. PROVIDE 1 ROW BRIDGING FOR SPANS OF 5'0"-7'0", 2 ROWS FOR SPANS GREATER THAN 7'0".

NOTE: ROOF FRAMING


REFER TO ROOF TRUSS SHOP DRAWINGS FOR ALL ROOF FRAMING INFORMATION UNLESS OTHERWISE NOTED.

PLANS NOT DRAWN TO ACTUAL GRADE. REFER TO FINAL APPROVED GRADING PLAN.

NOTE: ENGINEERED FLOOR FRAMING

REFER TO ENGINEERED FLOOR FLAYOUTS FOR ALL ENGINEERED FLOOR FRAMING INFORMATION AND DETAILS. UNLESS OTHERWISE NOTED.

TWO STOREY HEIGHT WALL DETAIL 2-2"x6" STUD WALL NAILED TOGETHER AND SPACED @ 12"c.c. FULL HEIGHT, c/w SOLID BLOCKING @ 4"-0" c.c. VERTICAL AND 7/16" EXT. PLYWOOD SHEATHING. NOTE: MAXIMUM HEIGHT OF WALL FOR THIS DETAIL IS 18'-0" AND MAX. SUPPORTED LENGTH OF TRUSS IS 40'-0".

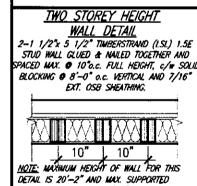

LENGTH OF TRUSS IS 40'-0".



TWO STOREY HEIGHT

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B. MARINKOVIC STRUDET INC.

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registration information VA3 Design Inc. Contractor must verify all dimensions on the job and report cry discrepancy to the Designer before proceeding with the work. All drawings and specifications are instruments of service and the pro of the Designer which must be returned at the completion of the Drawings are not to be scaled.

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C N	project name RUSSELL G
Suite 120	date APRIL 2017
2J 1R4	drawn by
16.630.4782	

dote APRIL 2017		
drawn by	checked by	
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= 1'-0"

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DIVICE VENEER LINIELS (NL)
WL1 = $3-1/2$ " x $3-1/2$ " x $1/4$ "L (89x89x6.4L) + 2-2"x8" SPR. No.2
$WL2 = 4" \times 3 - 1/2" \times 5/16" L (102 \times 89 \times 7.9 L) + 2 - 2" \times 8" SPR. No.2$
WL3 =5" x $3-1/2$ " x $5/16$ "L $(127x89x7.9L)$ + $2-2$ "x10" SPR. No.2
$WL4 = 6" \times 3 - 1/2" \times 7/16"L (152 \times 89 \times 11.0L) + 2 - 2" \times 12" SPR. No.2$
WL5 =6" x 4" x 7/16"L (152x102x11.0L) + 2-2"x12" SPR. No.2 WL6 =5" x 3-1/2" x 5/16"L (127x89x7.9L) + 2-2"x12" SPR. No.2
WL6 =5" x 3-1/2" x 5/16"L (127x89x7.9L) + 2-2"x12" SPR. No.2
WL7 =5" x 3-1/2" x 5/16"L (127x89x7.9L) + 3-2"x12" SPR. No.2 WL8 =5" x 3-1/2" x 5/16"L (127x89x7.9L) + 3-2"x10" SPR. No.2
WL8 =5" x 3-1/2" x 5/16"L (127x89x7.9L) + 3-2"x10" SPR. No.2
WL9 = 6" x 4" x 7/16" L (152x102x11.0L) + 3-2"x10" SPR. No.2
WOOD LINTELS AND BEAMS (WB)
WB1 = $2-2$ "x8" (2-38x184) SPR. No.2
WB1 =2-2"x8" (2-38x184) SPR. No.2 WB2 =3-2"x8" (3-38x184) SPR. No.2 WB3 =2-2"x10" (2-38x235) SPR. No.2
WB3 = $2-2$ "x10" (2-38x235) SPR. No.2
WB4 =3-2"x10" (3-38x235) SPR. No.2
WB5 =2-2"x12" (2-38x286) SPR. No.2
WB6 = $3-2$ "x12" (3-38x286) SPR. No.2
WB7 = $5-2$ "x12" (5-38x286) SPR. No.2
WB11 = $4-2$ "x10" ($4-38x235$) SPR. No.2
WB12 =4-2"x12" (4-38x286) SPR. No.2
LAMINATED VENEER LUMBER (LVL) BEAMS
LVL1A = $1-1 \ 3/4$ "x7 $1/4$ " $(1-45x184)$
$1.1011 \pm 9-1.3/4^{\circ} \times 7.1/4^{\circ} (9-45 \times 184)$
1189
$1 \text{ LVL3} = 4-1 3/4^{\circ}\text{x}/ 1/4^{\circ} (4-45\text{x}184)$
LVL4A =1-1 3/4"x9 1/2" (1-45x240)
1 LVL4 = 2 - 1 3/4 x9 1/2 (2 - 43x240)
LVL5 = $3-1$ $3/4$ "x9 $1/2$ " $(3-45\times240)$
LVL5A = 4-1 3/4"x9 1/2" (4-45x240)
LVL54 = $3-1$ 3/4 x9 1/2" (3-43x240) LVL5A = $4-1$ 3/4"x9 1/2" (4-45x240) LVL6A = $1-1$ 3/4"x11 7/8" (1-45x300) LVL6 = $2-1$ 3/4"x11 7/8" (2-45x300)
$\begin{array}{cccccccccccccccccccccccccccccccccccc$
$\begin{array}{cccccccccccccccccccccccccccccccccccc$
LVL8 = $2-1 \ 3/4$ "x14" (2-45x356)
$\frac{1}{2} = \frac{1}{3} + \frac{1}{4} \times \frac{1}$
LOOSE STEEL LINTELS (L)
$L1 = 3-1/2" \times 3-1/2" \times 1/4" L (89 \times 89 \times 6.4 L)$
L2 =4" x 3-1/2" x 5/16"L (102x89x7.9L) L3 =5" x 3-1/2" x 5/16"L (127x89x7.9L)
L3 =5" x 3-1/2" x 5/16"L (127x89x7.9L) L4 =6" x 3-1/2" x 7/16"L (152x89x11.0L)
L5 =6" x 4" x 7/16"L (132x09x11.0L)
$\begin{array}{cccccccccccccccccccccccccccccccccccc$
The state of the s
DOOR SCHEDULE

NOS. WIDTH HEIGHT HEIGHT 8'to 9' 10' OR MORE CEILING CEILING

8'-0" 8'-0" 8'-0" 8'-0"

2'-10" 6'-8" 2'-8" 6'-8" 2'-8" 6'-8" 2'-8" 6'-8" 2'-6" 6'-8" 2'-6" 6'-8" 2'-2" 6'-8" 1'-6" 6'-8"

90 KPa. ENGINEERED FILL SOIL

INSULATED ENTRANCE DOOR INSULATED FRONT DOORS

WOOD & GLASS DOOR

EXTERIOR SLAB DOOR

INTERIOR SLAB DOOR INTERIOR SLAB DOOR INTERIOR SLAB DOOR INTERIOR SLAB DOOR

F1 = 42"x42"x18" CONCRETE PAD F1 = 48"x48"x20" CONCRETE PAD

F2 = 36"x36"x16" CONCRETE PAD F2 = 40"x40"x16" CONCRETE PAD

F3 = 30"x30"x12" CONCRETE PAD F3 = 34"x34"x14" CONCRETE PAD

F4 = 24"x24"x12" CONCRETE PAD F4 = 28"x28"x12" CONCRETE PAD

F5 = 16"x16"x8" CONCRETE PAD F5 = 18"x18"x8" CONCRETE PAD

(REFER TO FLOOR PLAN FOR UNUSUAL SIZE PADS NOT ON CHART.)

WHEN VENEER CUT IS GREATER THAN 26", A 10"

POURED CONCRETE FOUNDATION WALL IS REQUIRED.

EXPOSED CONCRETE (FLATWORK)


BRICK VENEER LINTELS (WL)


ALL GARAGE SLABS, PORCH SLABS, STAIRS (EXPOSED CONC. FLAT WORK) TO BE 32 MPa. WITH 5-8% AIR ENTRAINMENT.


PAD FOOTINGS


120 KPa. NATIVE SOIL


<u>VENEER CUT</u>

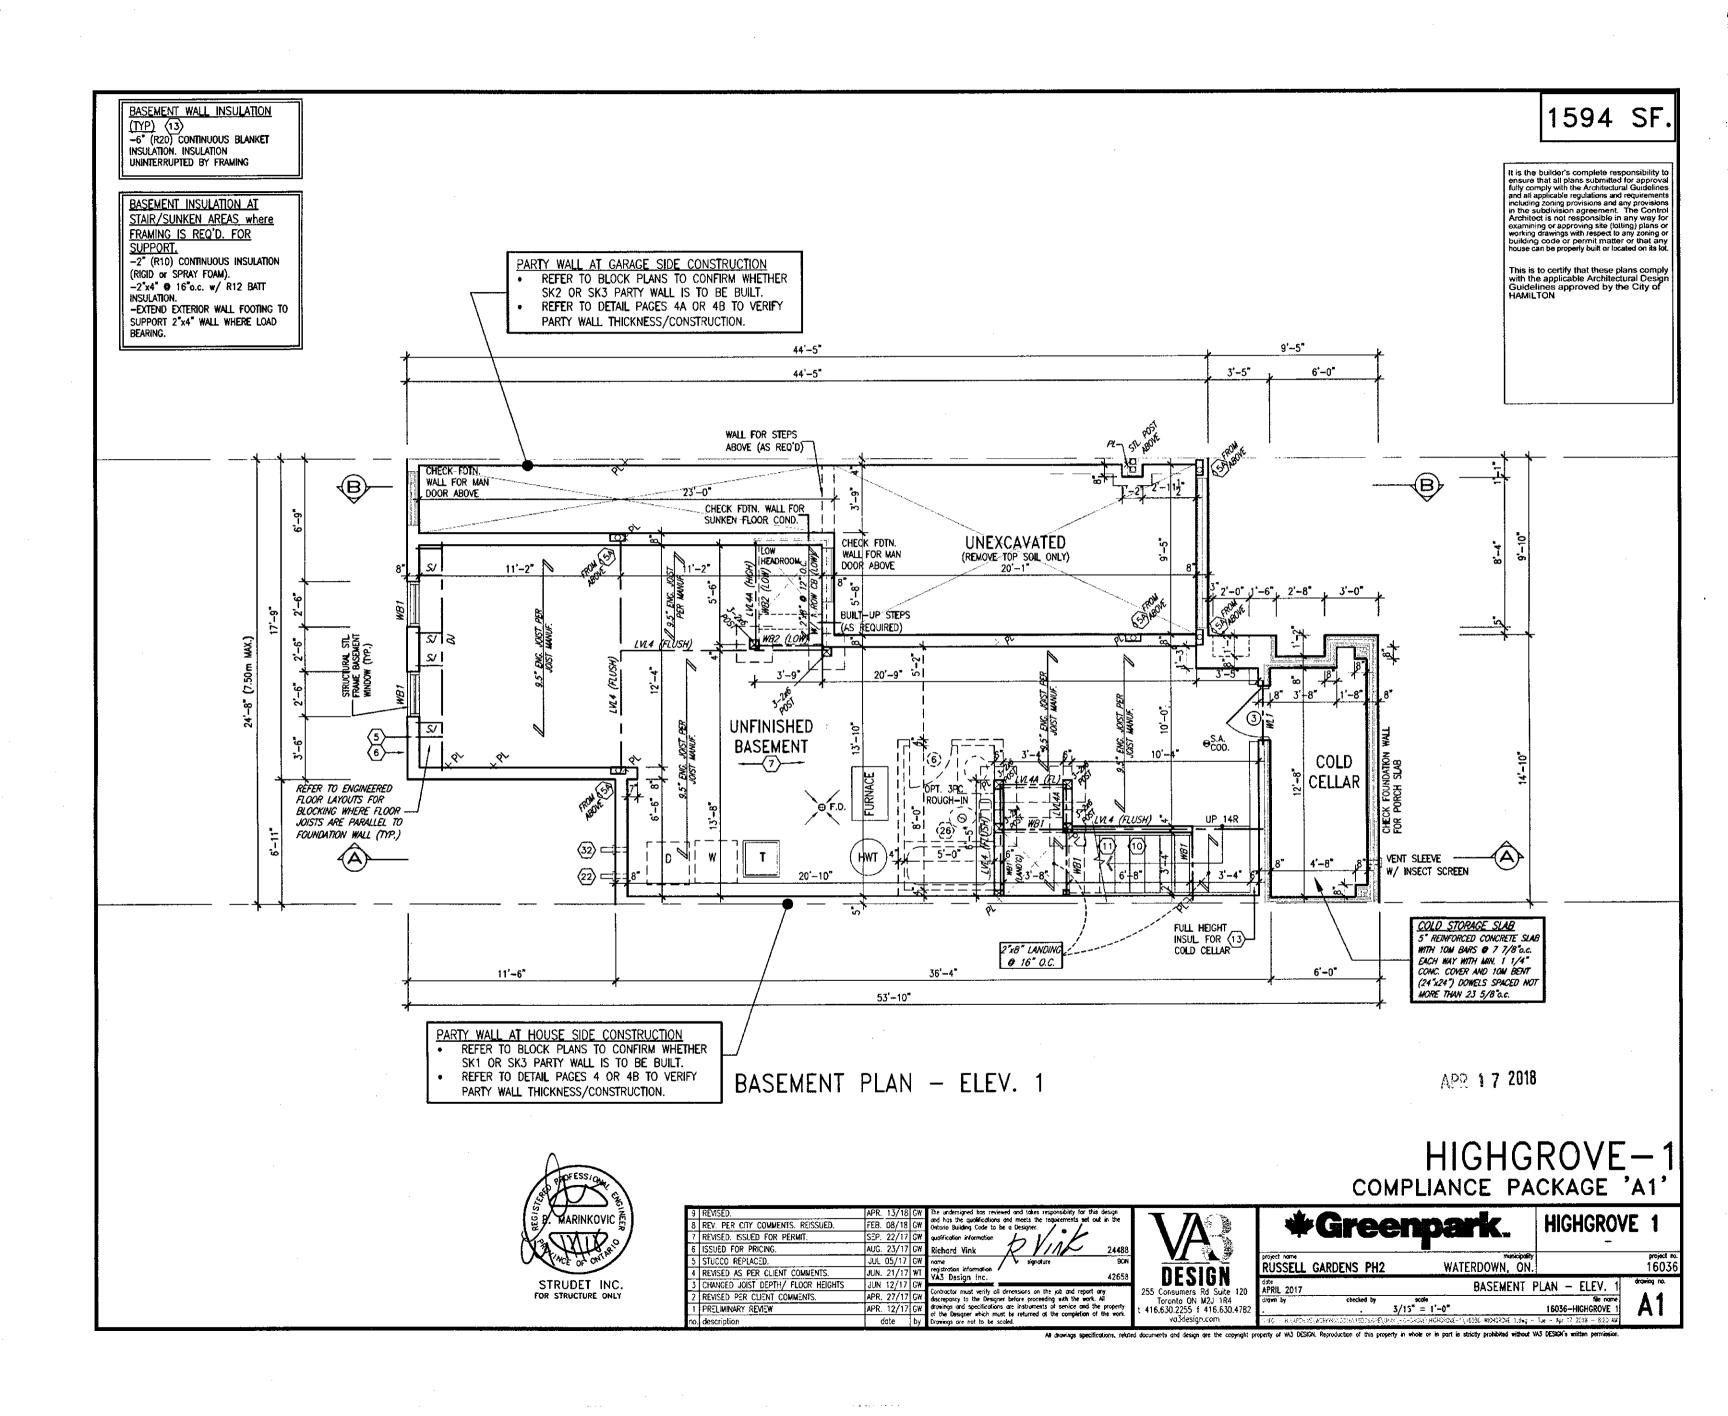


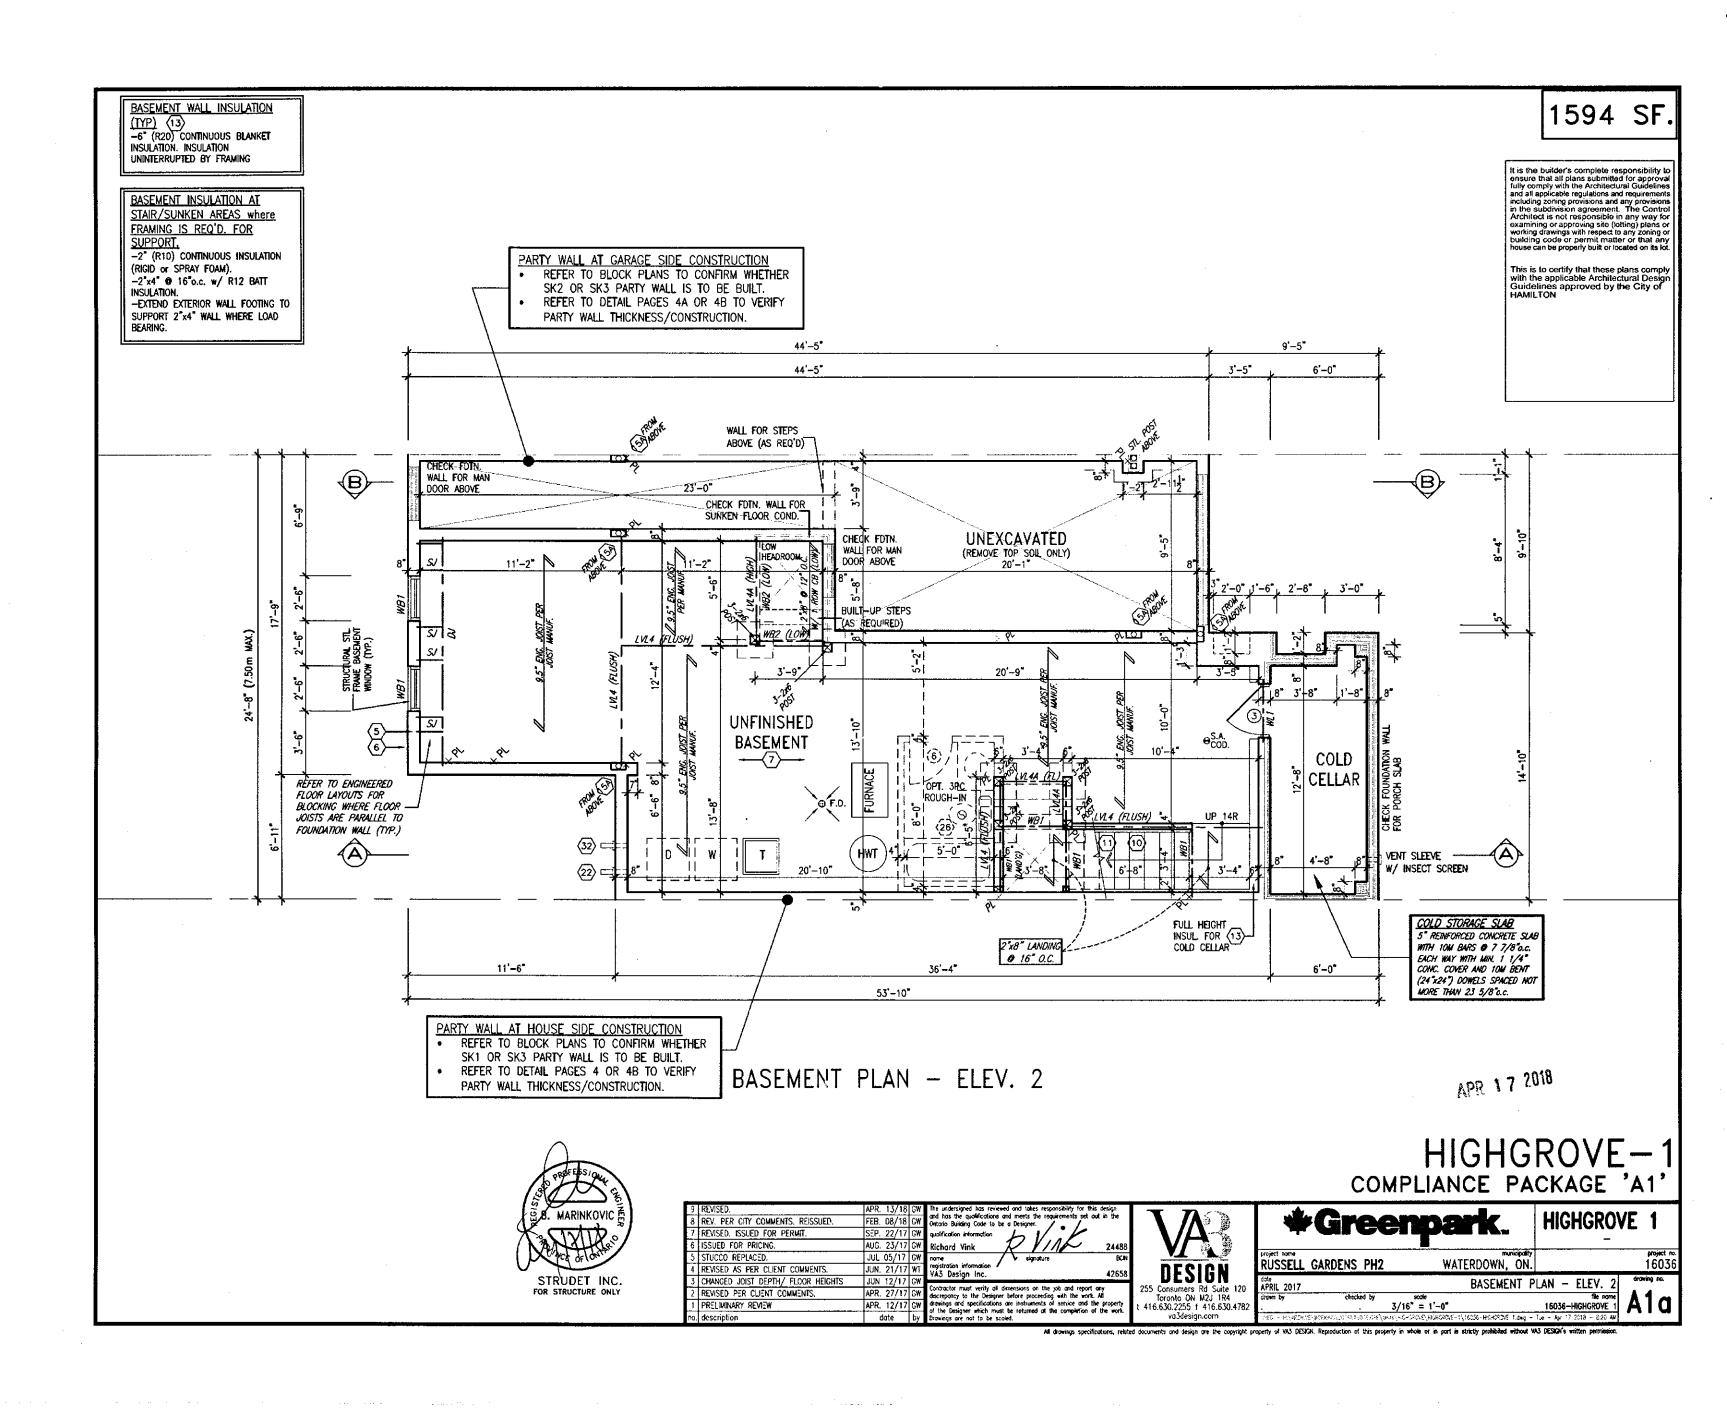


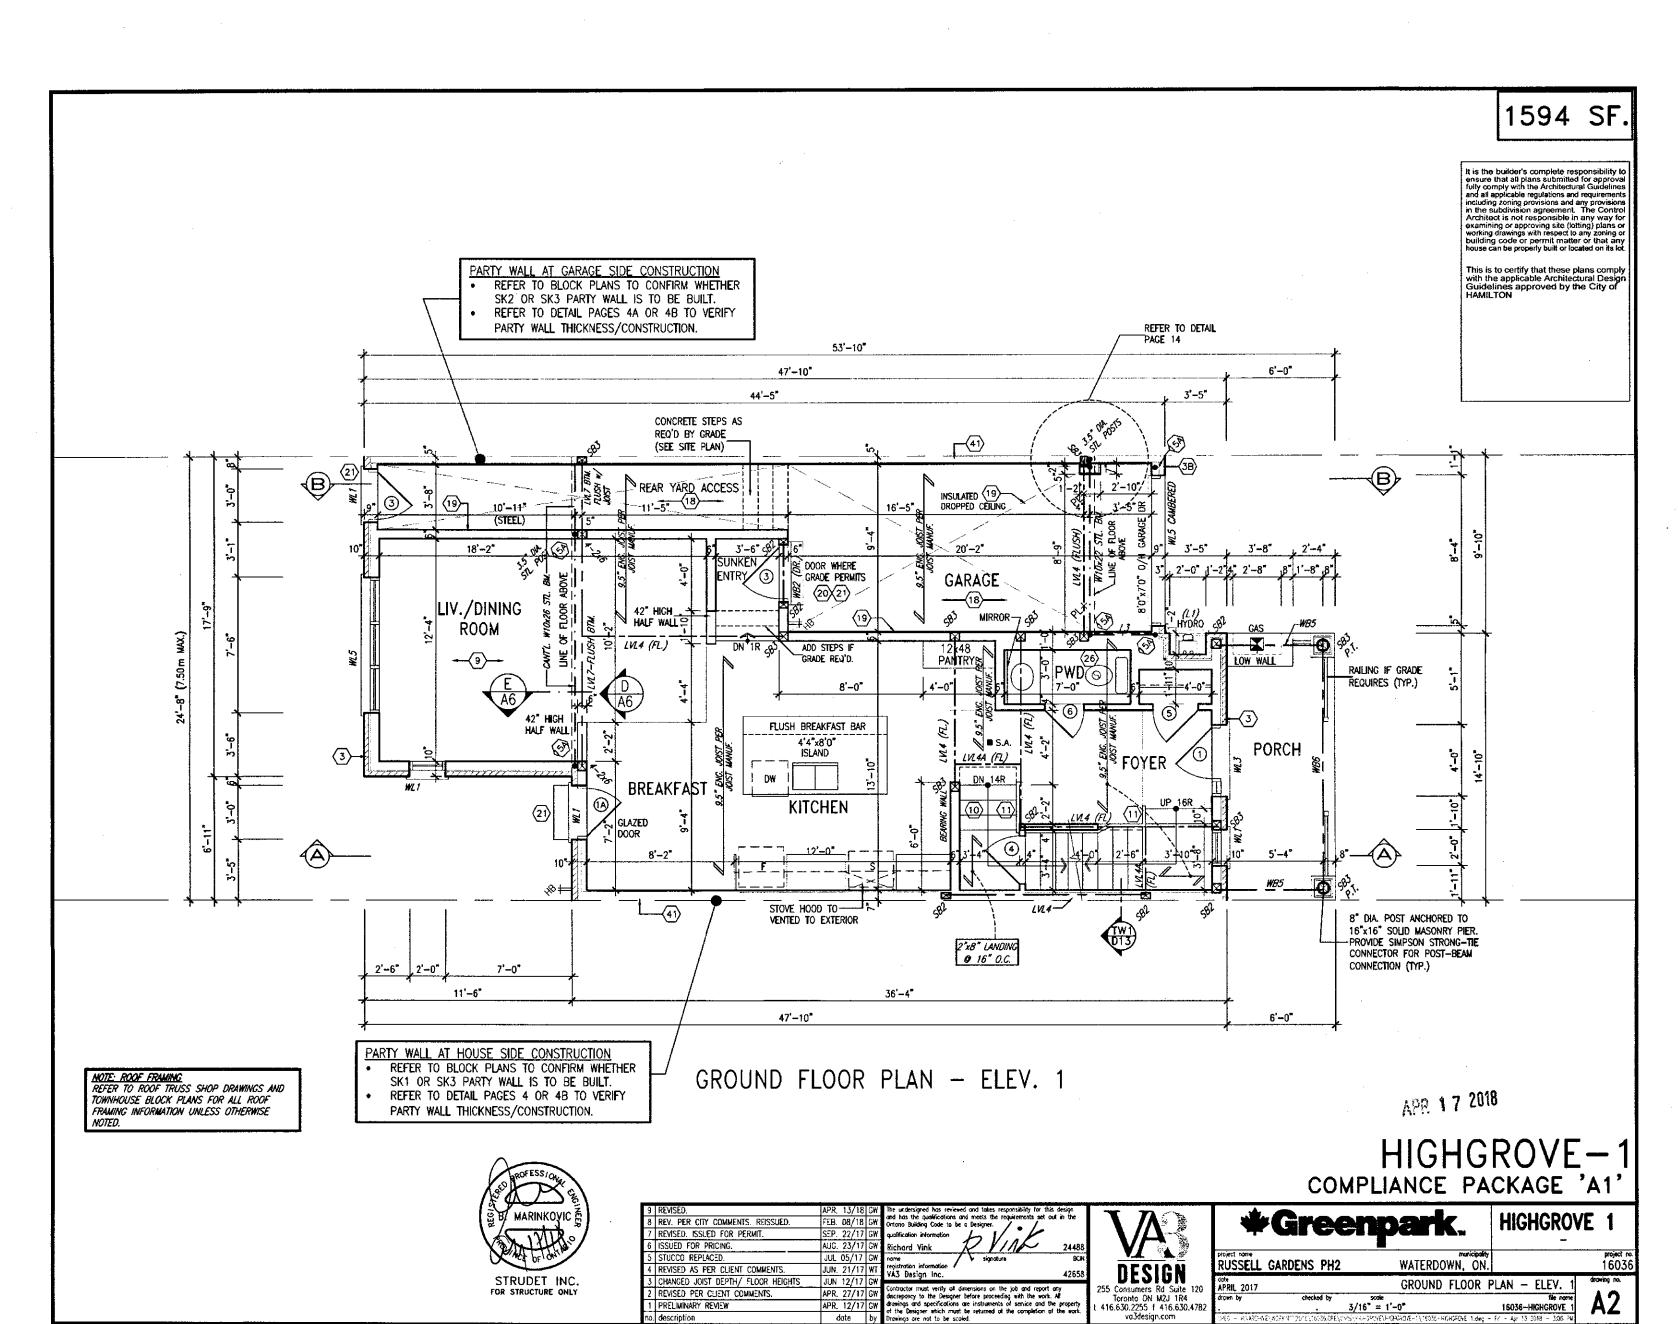


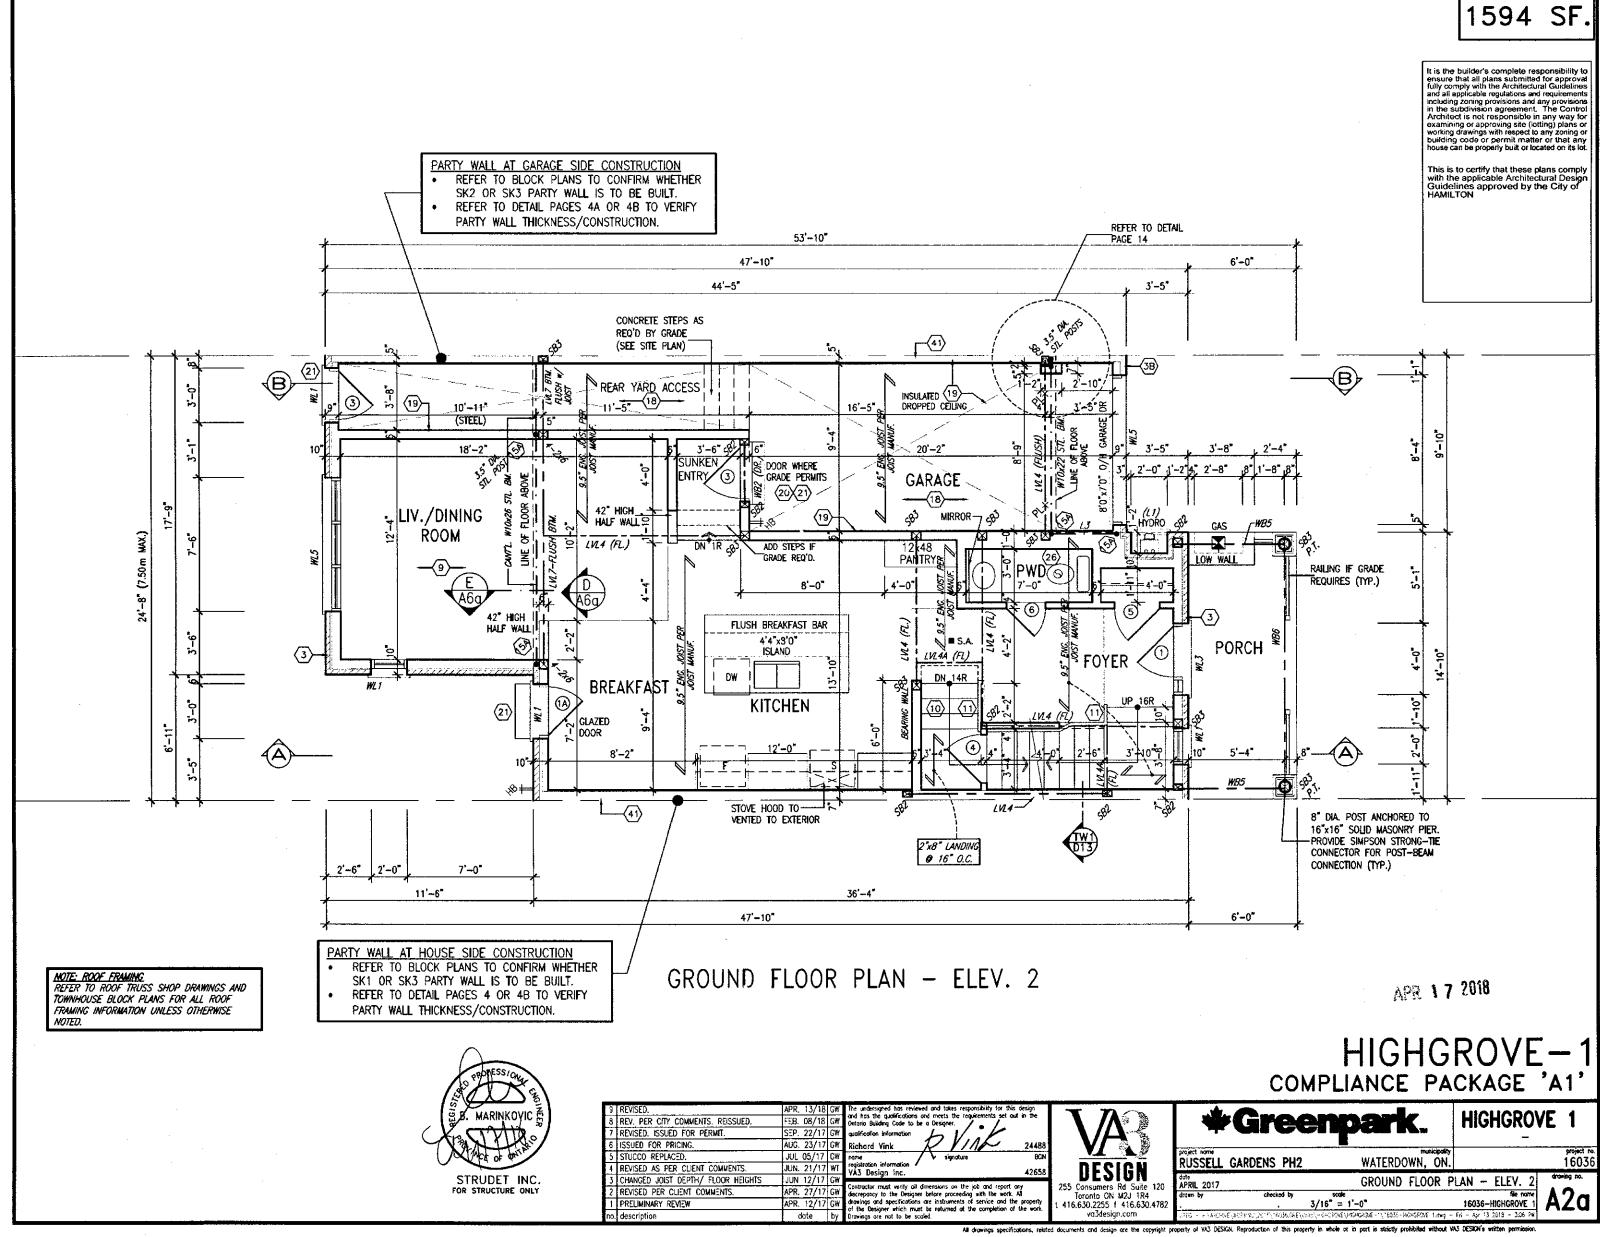

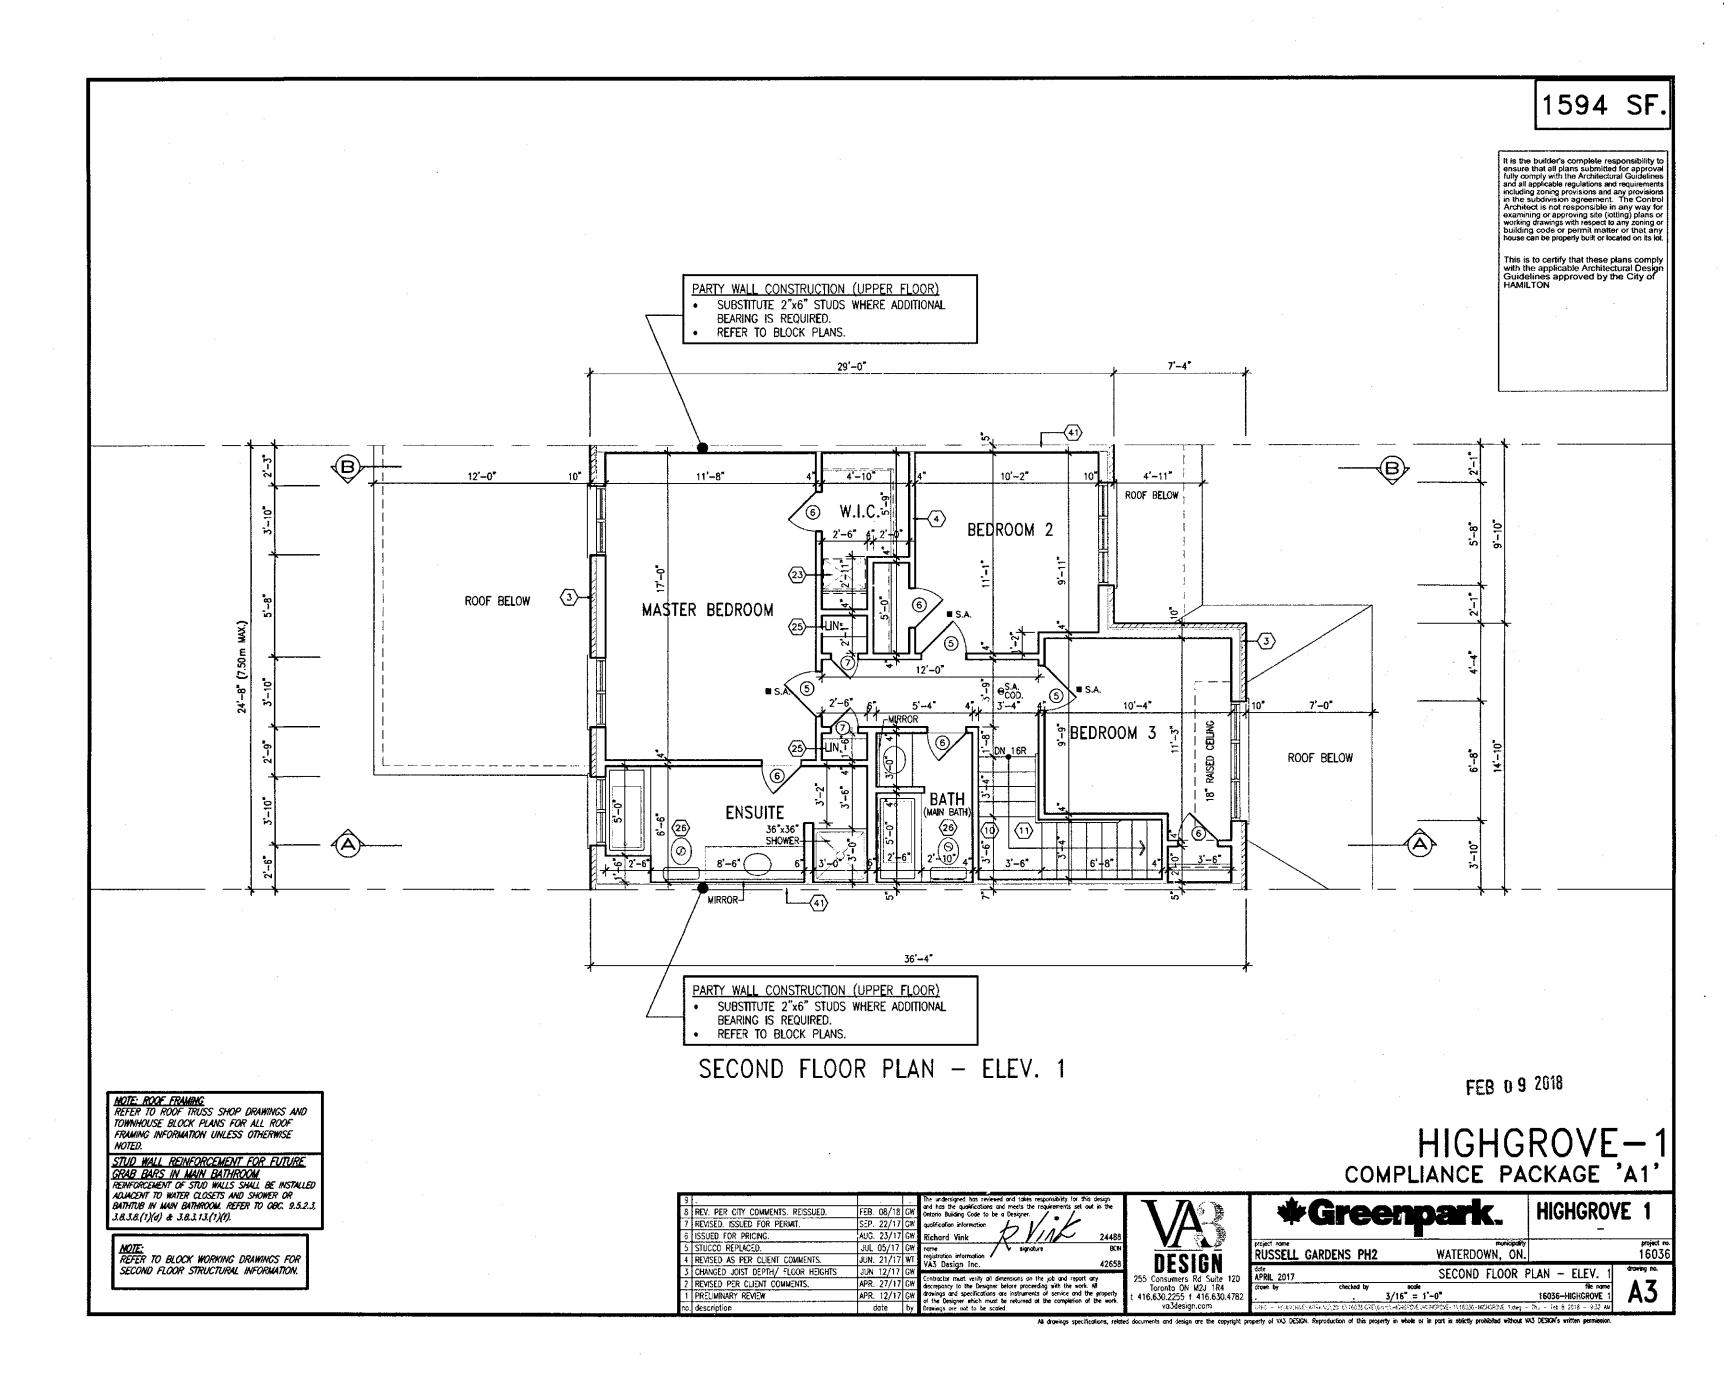

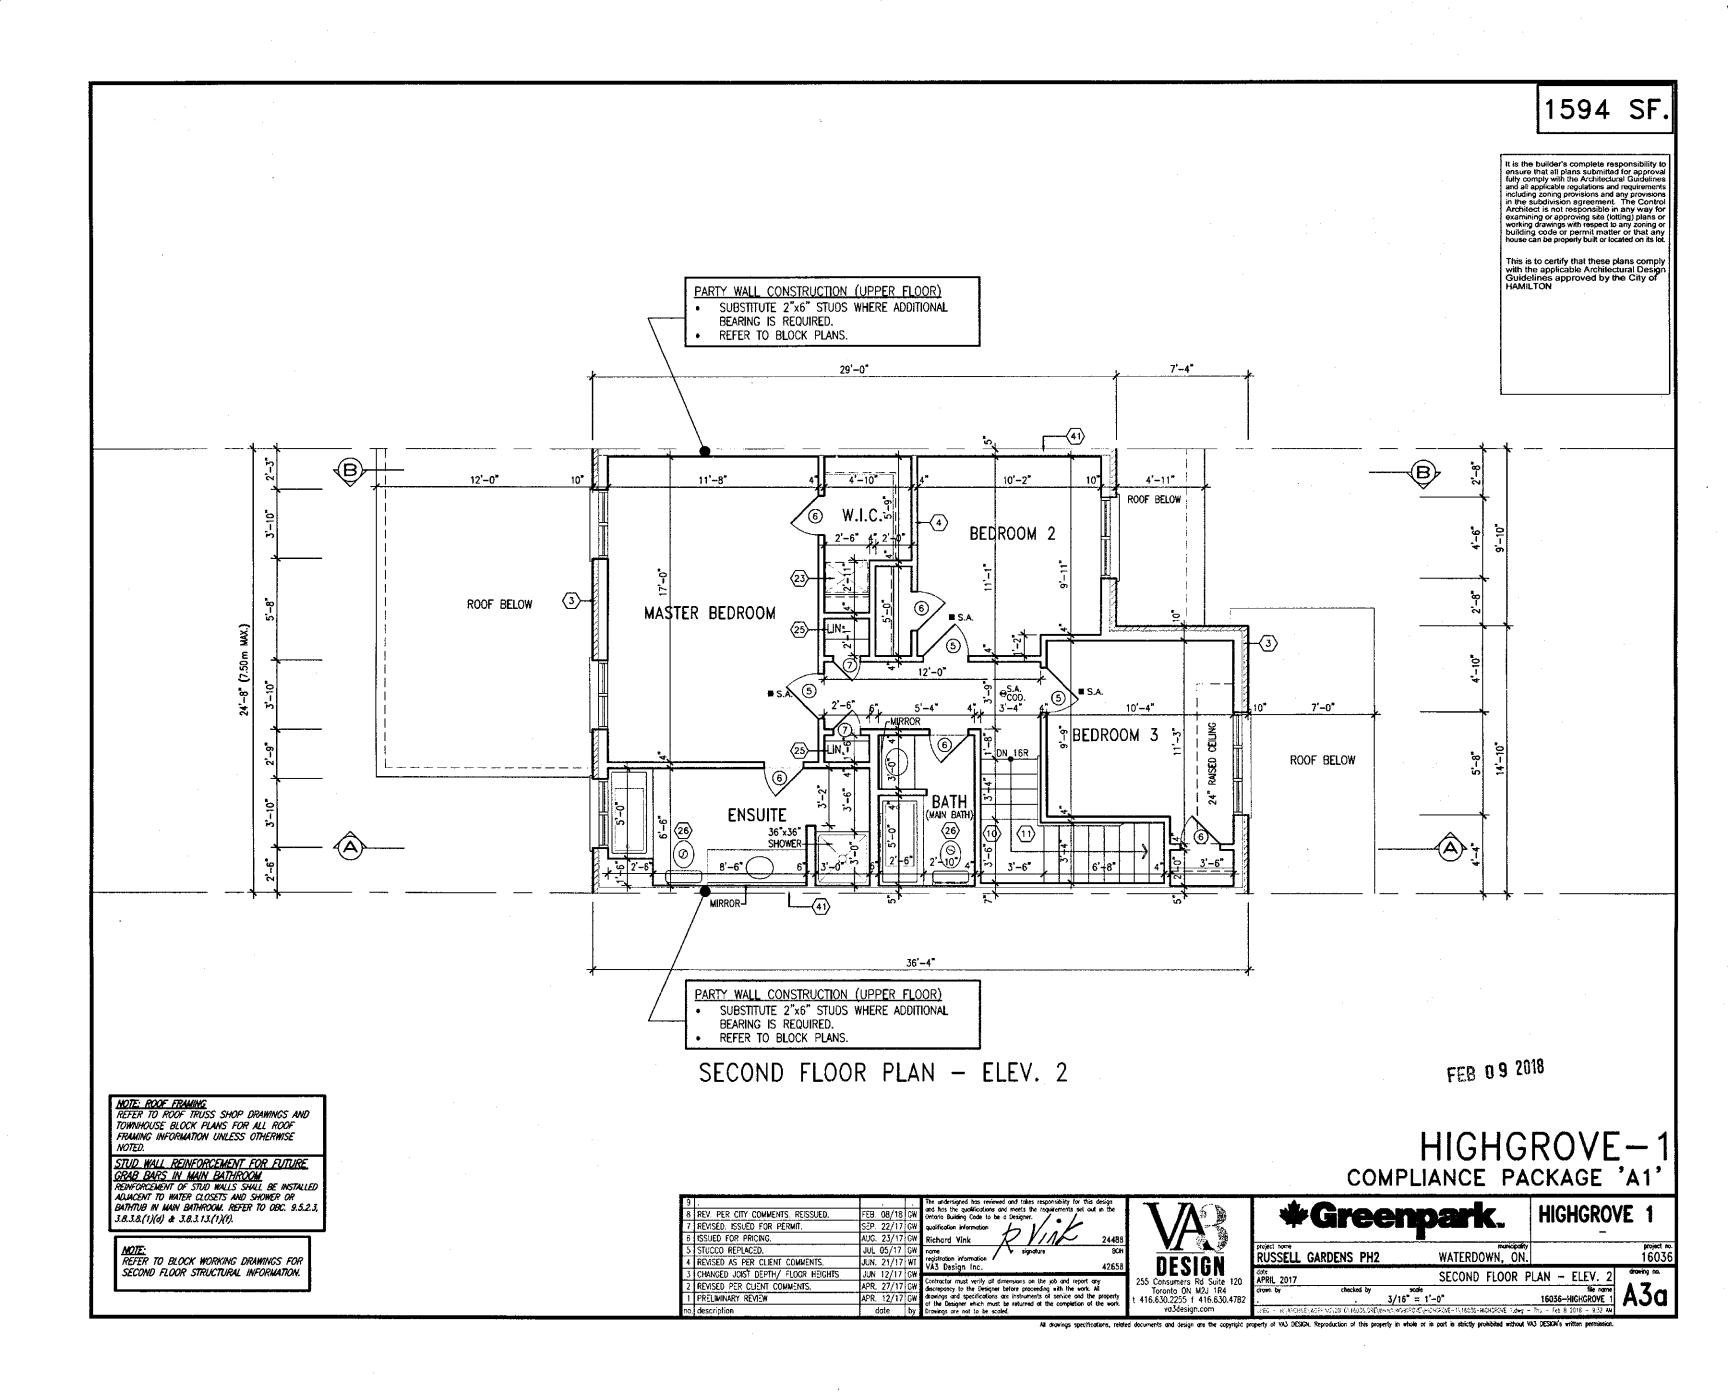

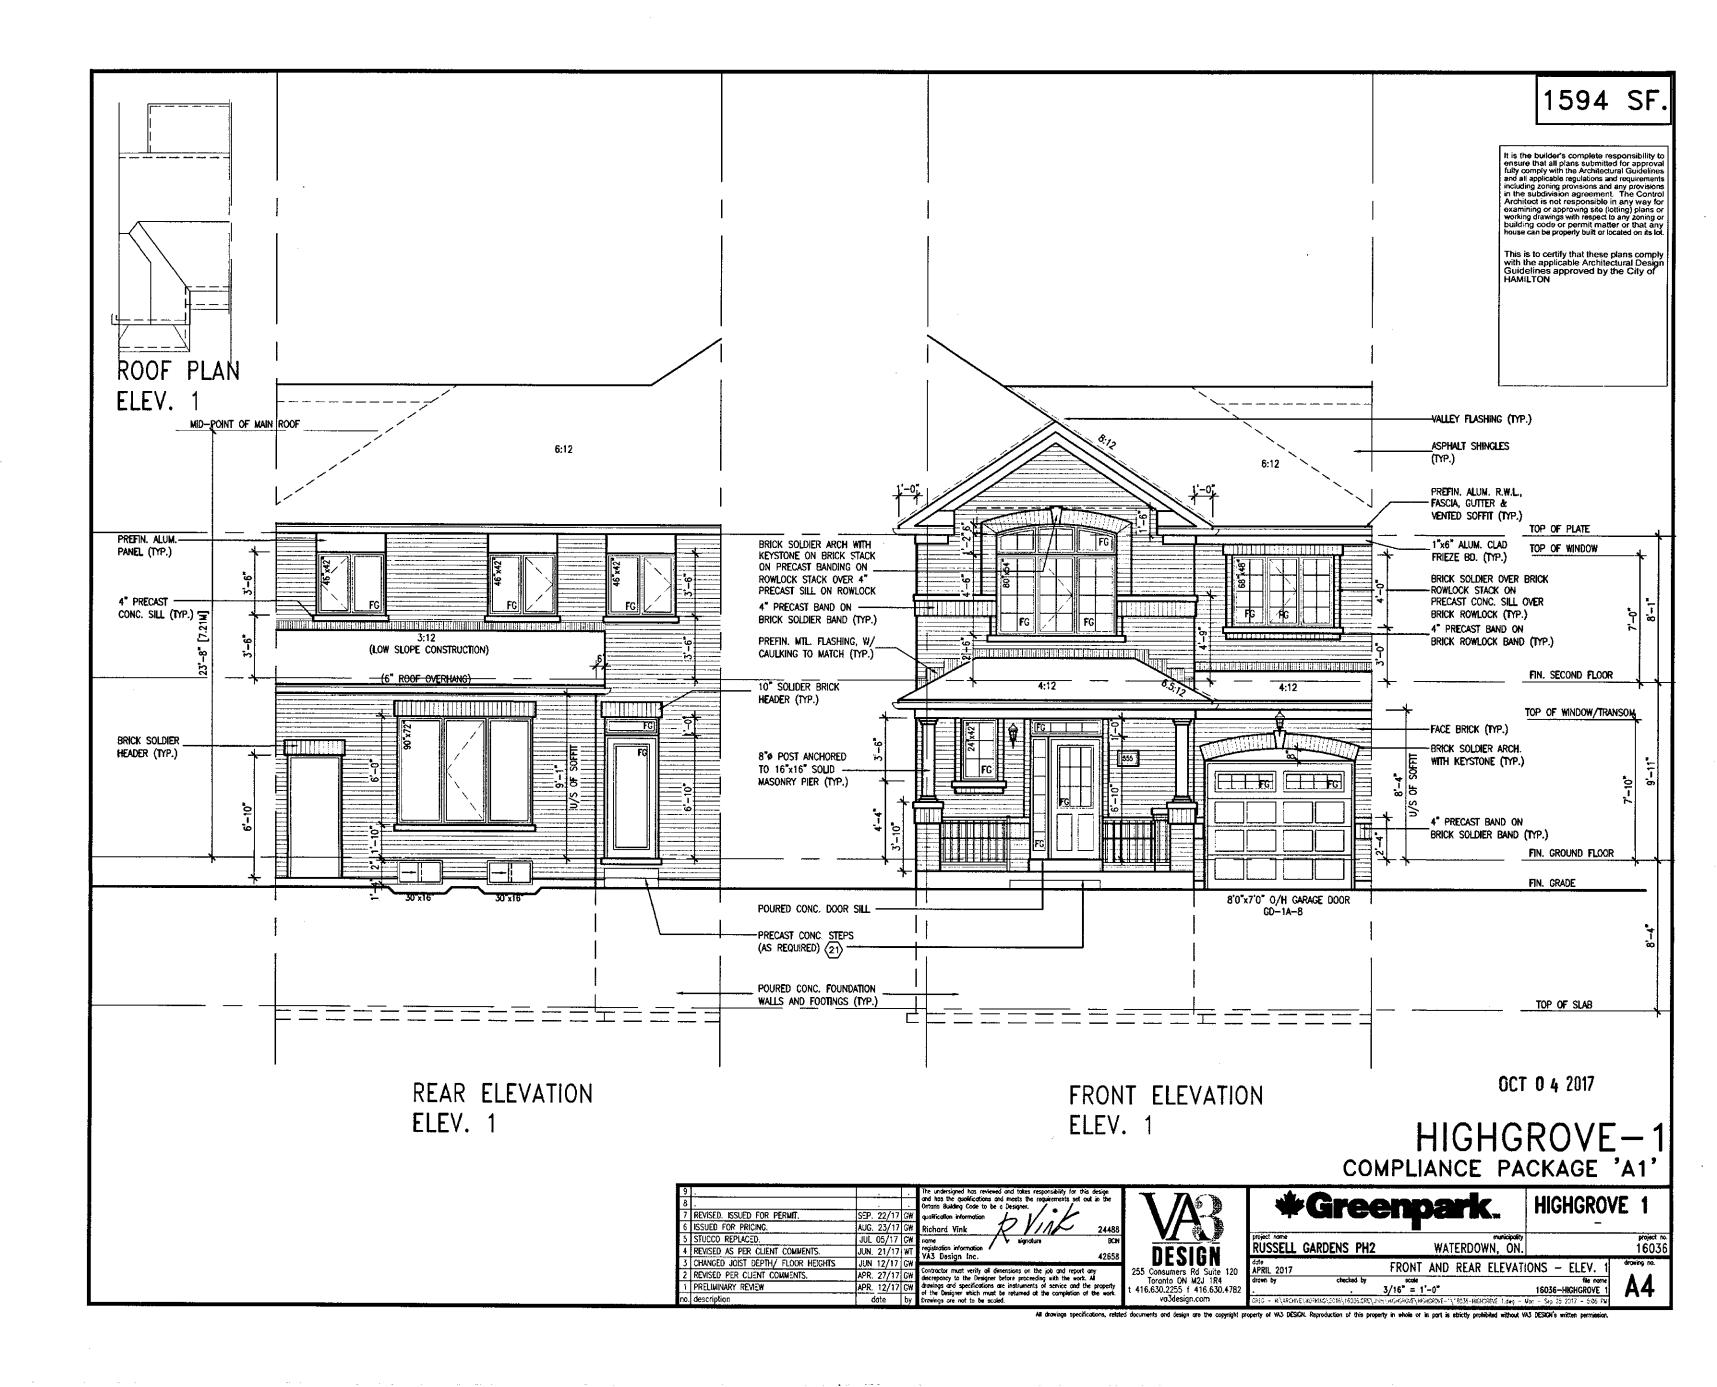


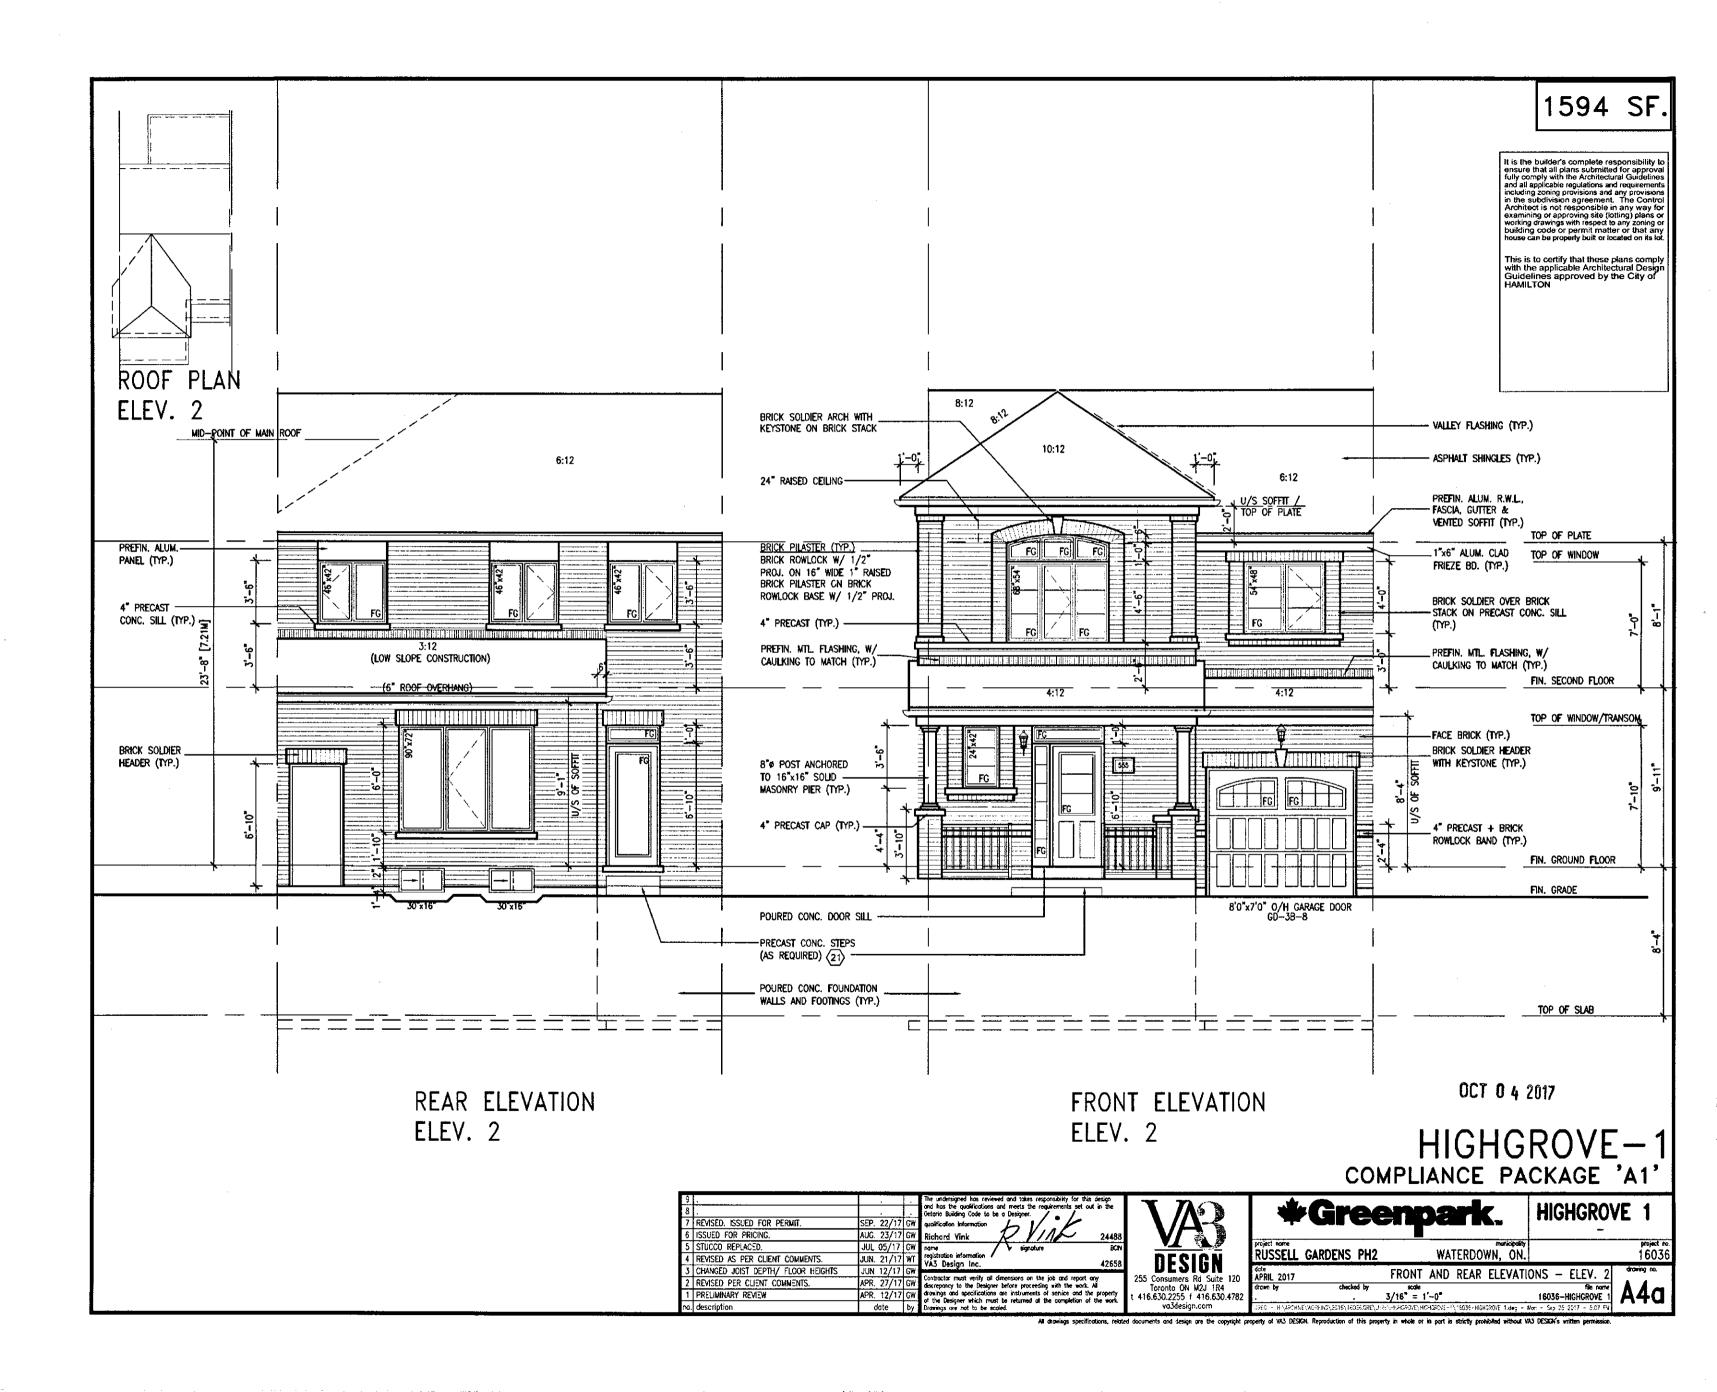



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Bas Marinkovic E STRUDET INC.

SECTION A-A ELEV. 1

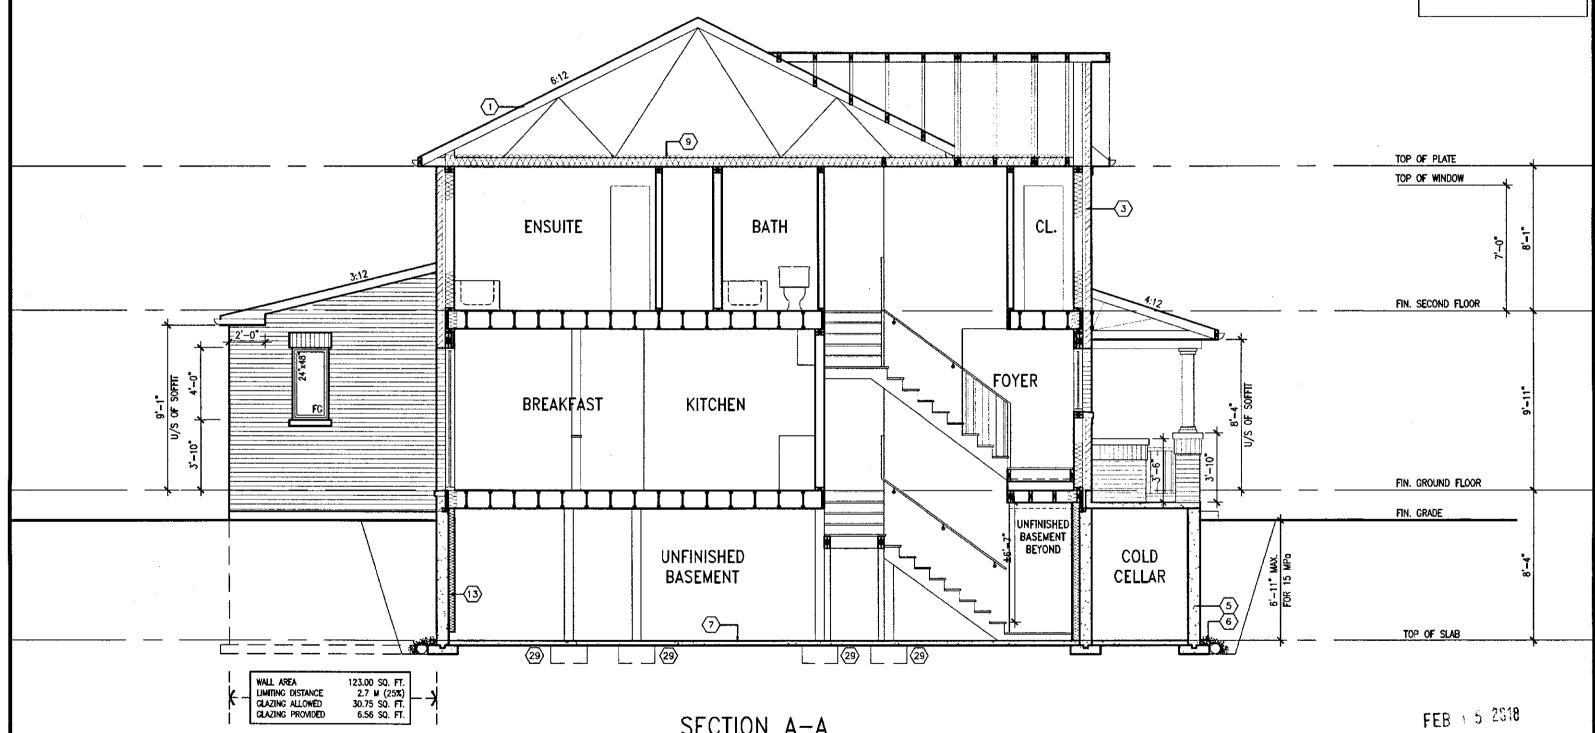HIGHGROVE-1 COMPLIANCE PACKAGE 'A1'

9		,		The undersigned has reviewed and takes responsibility for this design
8	REV. PER CITY COMMENTS. REISSUED.	FEB. 08/18	GW	and has the qualifications and meets the requirements set out in the Ontario Building Code to be a Designer.
7	REVISED. ISSUED FOR PERMIT.	SEP. 22/17	GW	qualification information
ŝ	ISSUED FOR PRICING.	AUG. 23/17	GW	Richard Vink 24488
5	STUCCO REPLACED.	JUL 05/17	Ç₩	rome signature BCN
4	REVISED AS PER CLIENT COMMENTS.	JUN. 21/17	WT	registration information / VA3 Design Inc. 42658
3	CHANGED JOIST DEPTH/ FLOOR HEIGHTS	JUN 12/17	GW	
2	REVISED PER CLIENT COMMENTS.	APR. 27/17	GW	Contractor must verify oil dimensions on the job and report any discrepancy to the Designer before proceeding with the work. All
1	PRELIMINARY REVIEW	APR. 12/17	GW	
no.	description	dote	bγ	Drawings are not to be scaled.

DESIGN 255 Consumers Rd Suite 120 Toronto ON M2J 1R4

t 416.630.2255 f 416.630.4782 va3design.com

*Greenpark.

HIGHGROVE 1

WATERDOWN, ON. project no. 16036 project name RUSSELL GARDENS PH2 SECTION A-A, ELEV. 1

APRIL 2017 drawn by
 drawn by
 checked by
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 3/16" = 1'-0"
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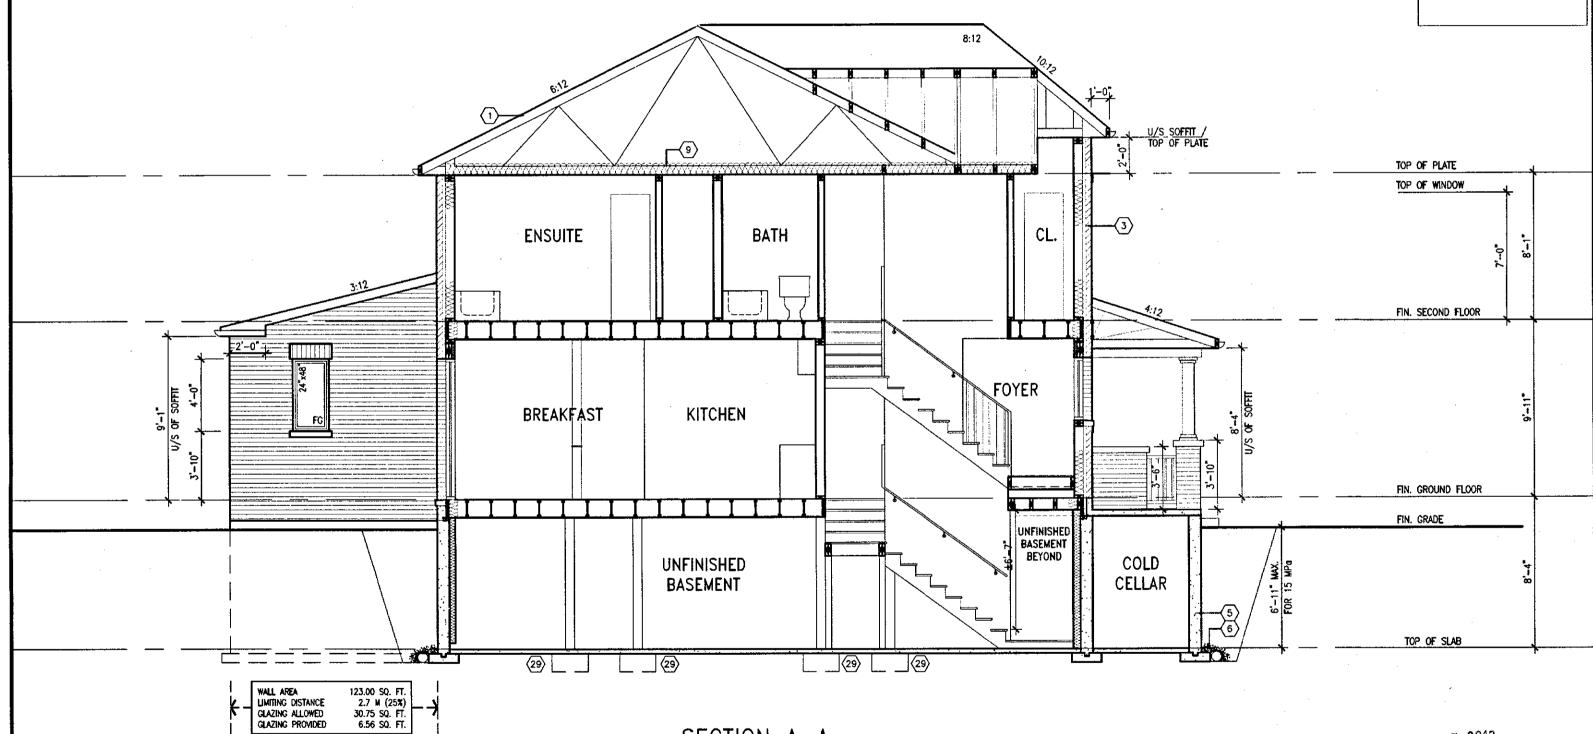
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See MARINKOVIC TO THE THE PARTY OF OF ONLY

STRUDET INC.

SECTION A-A ELEV. 2

FEB 1 5 2518

HIGHGROVE - 1

COMPLIANCE PACKAGE 'A1'

9			,	The undersigned has reviewed and takes responsibility for this design
8	REV. PER CITY COMMENTS. REISSUED.	FEB. 08/18	CW	and has the qualifications and meets the requirements set out in the Outgrio Building Code to be a Designer.
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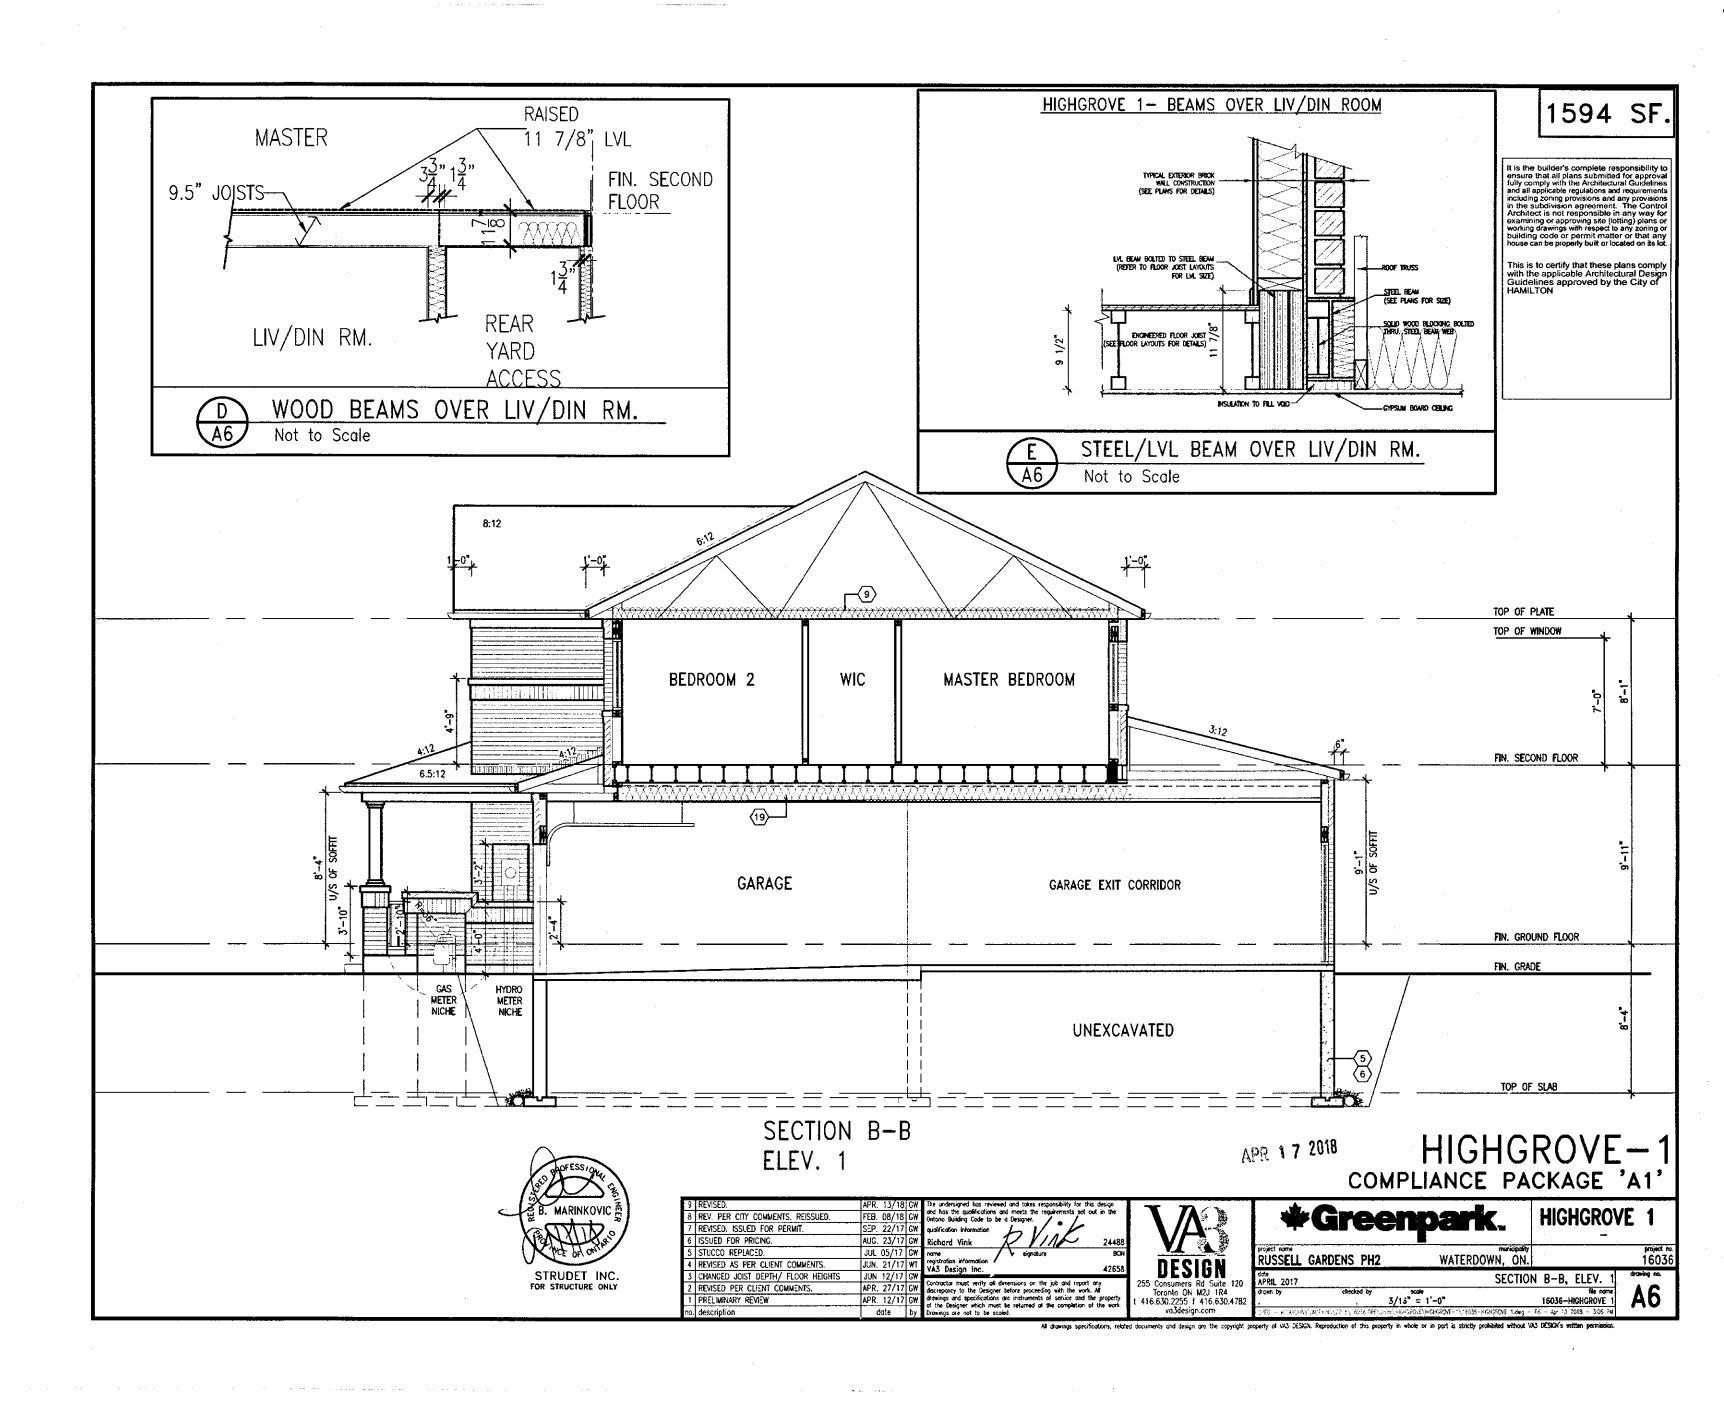



FUSSELL GARDENS PH2 WA

HIGHGROVE 1

| Checked by | Scale | 1'-0" | SECTION A-A, ELEV. 2 | Section | Se


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APR 1 7 2018

HIGHGROVE - 1 COMPLIANCE PACKAGE 'A1'
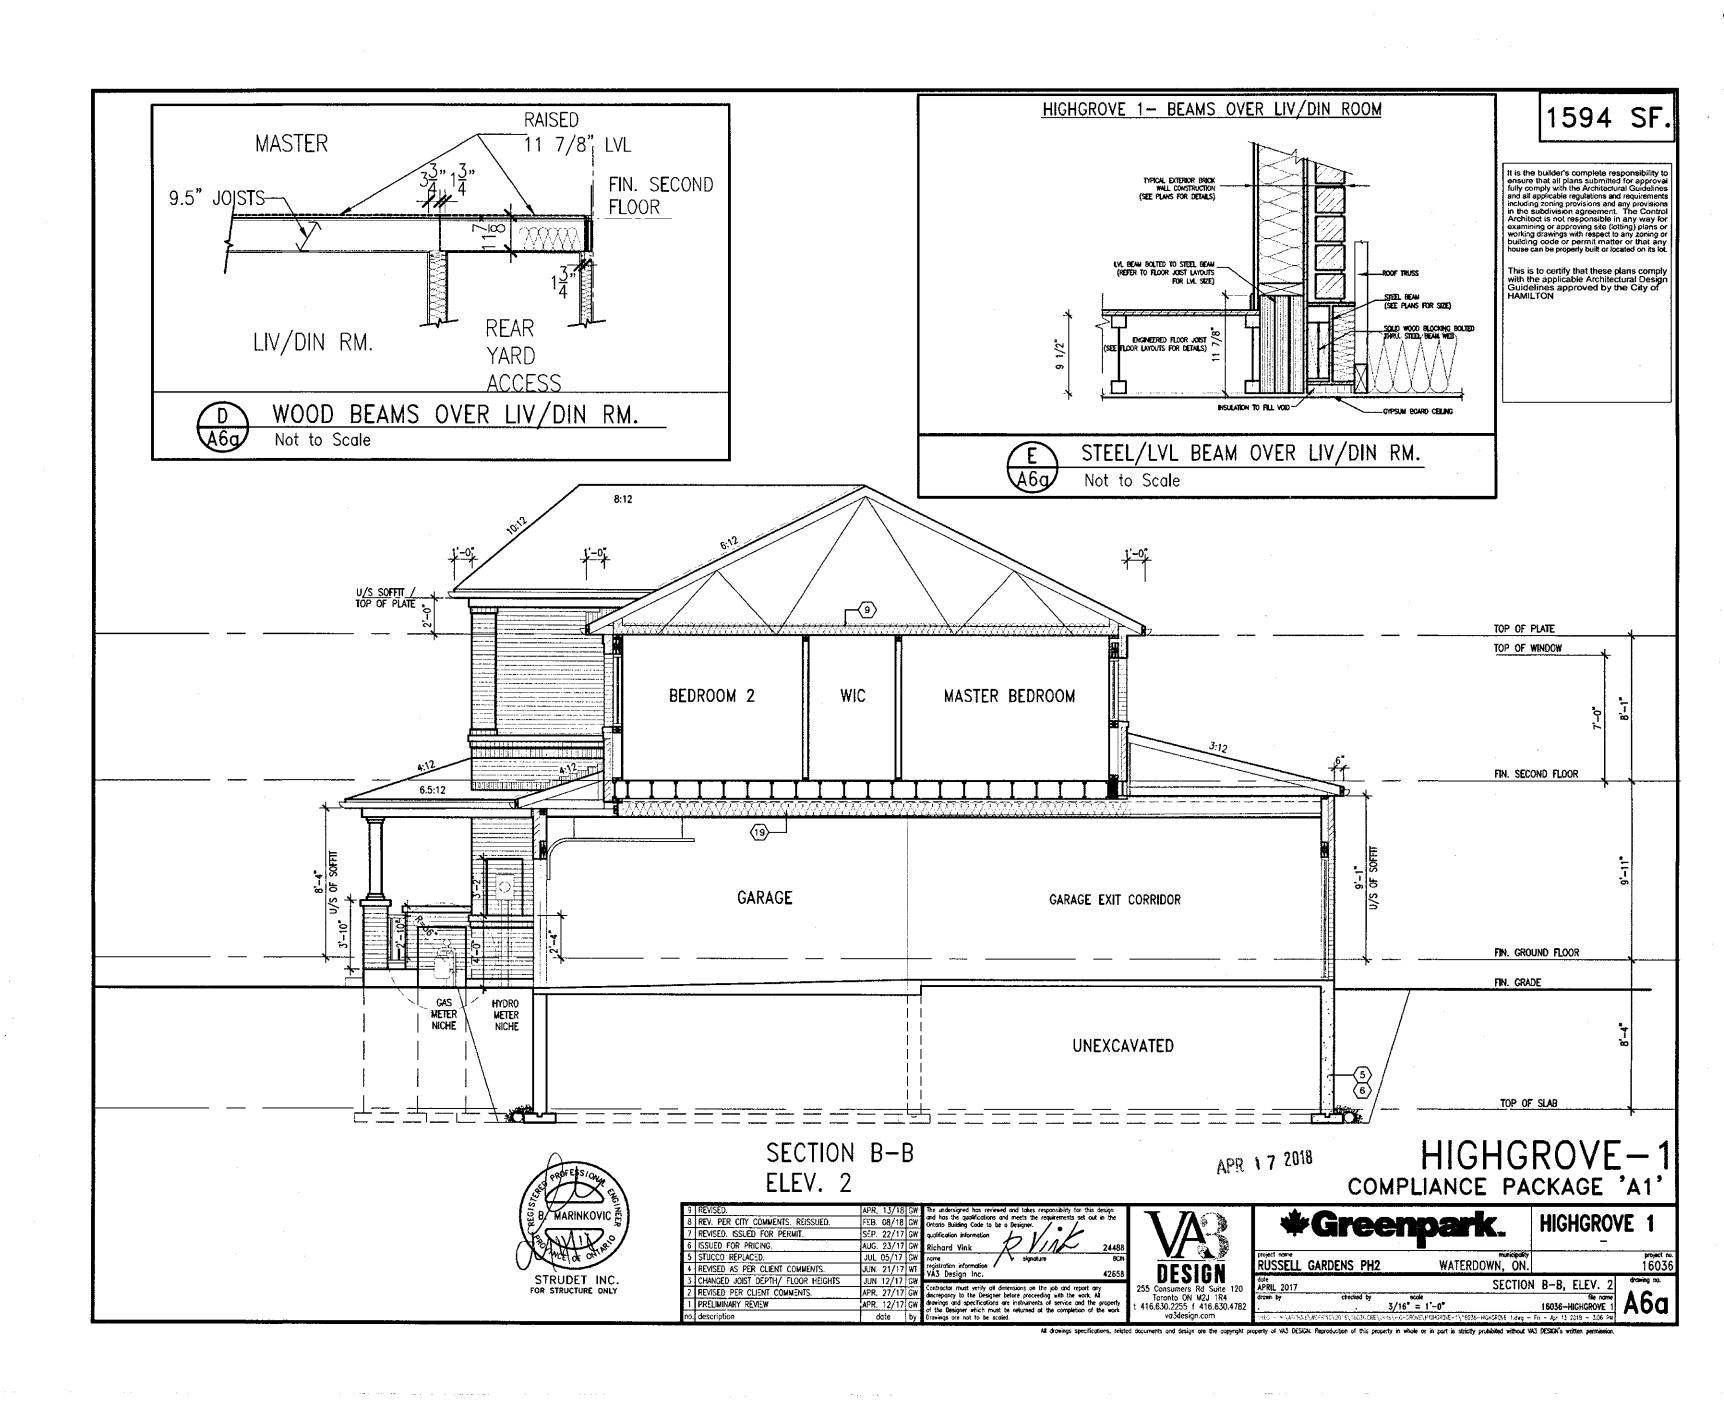
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***Greenpark**. RUSSELL GARDENS PH2 date APRIL 2017 drawn by

HIGHGROVE 1

project no. 16036 WATERDOWN, ON. PART. PLANS- W.O.B. CONDITION drawing no. **A7**

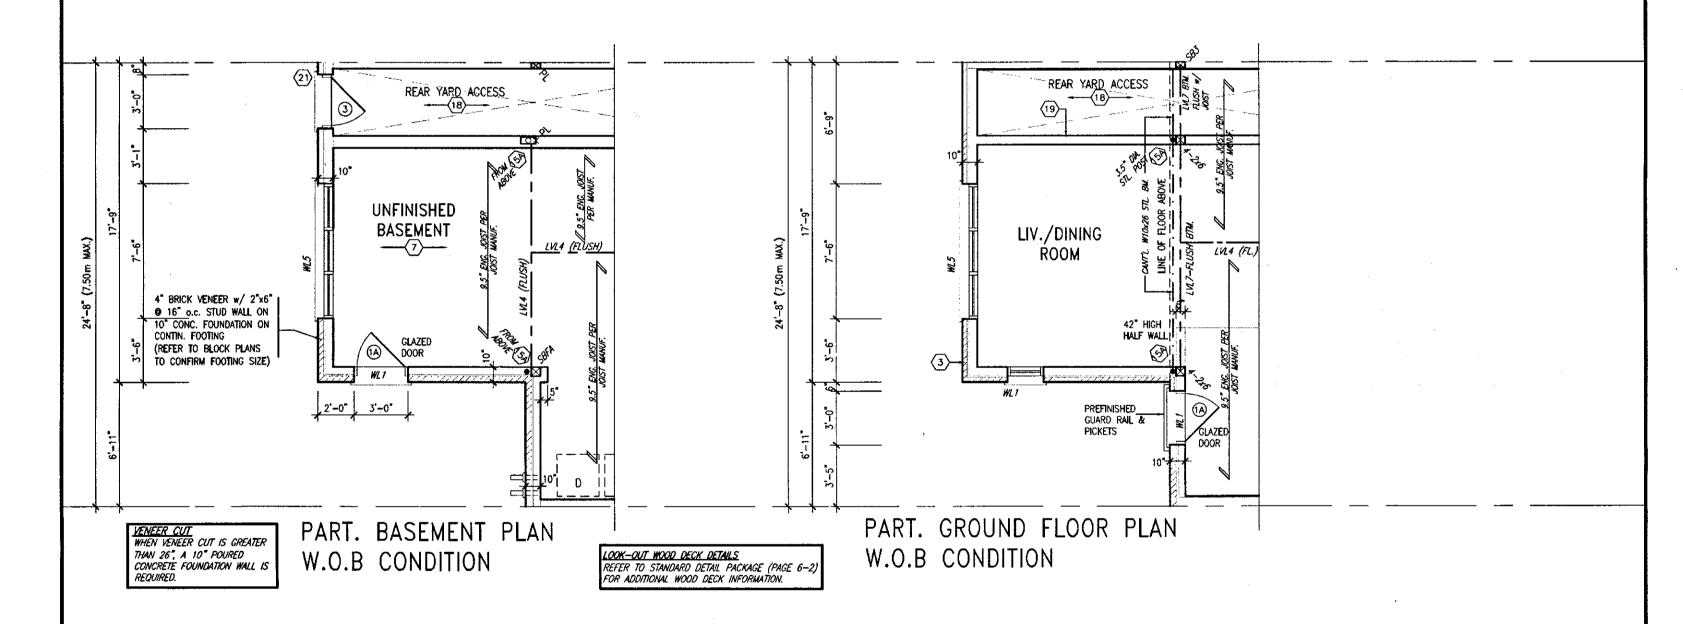3/16" = 1'-0" file name 16036-HIGHGROVE 1

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