

2284 SF.

PAD FOOTINGS

120 KPa. NATIVE SOIL

F1 = 42"x42"x18" CONCRETE PAD
F2 = 36"x36"x16" CONCRETE PAD
F3 = 30"x30"x12" CONCRETE PAD
F4 = 24"x24"x12" CONCRETE PAD
F5 = 16"x16"x8" CONCRETE PAD

90 KPa. ENGINEERED FILL SOIL

F1 = 48"x48"x20" CONCRETE PAD
F2 = 40"x40"x16" CONCRETE PAD
F3 = 34"x34"x14" CONCRETE PAD
F4 = 28"x28"x12" CONCRETE PAD
F5 = 18"x18"x8" CONCRETE PAD

(REFER TO FLOOR PLAN FOR UNUSUAL SIZE PADS NOT ON CHART.)

VENEER CUT

WHEN VENEER CUT IS GREATER THAN 26", A 10" POURED CONCRETE FOUNDATION WALL IS REQUIRED.

EXPOSED CONCRETE (FLATWORK)

ALL GARAGE SLABS, PORCH SLABS, STAIRS (EXPOSED CONC. FLAT WORK) TO BE 32 MPa. WITH 5-8% AIR ENTRAINMENT.

BRICK VENEER LINTELS (WL)

WL1 = 3-1/2" x 3-1/2" x 1/4" L (89x89x6.4L) + 2-2"x8" SPR. No.2
WL2 = 4" x 3-1/2" x 5/16" L (102x89x7.9L) + 2-2"x8" SPR. No.2
WL3 = 5" x 3-1/2" x 5/16" L (127x89x7.9L) + 2-2"x10" SPR. No.2
WL4 = 6" x 3-1/2" x 7/16" L (152x89x11.0L) + 2-2"x12" SPR. No.2
WL5 = 6" x 4" x 7/16" L (152x102x11.0L) + 2-2"x12" SPR. No.2
WL6 = 5" x 3-1/2" x 5/16" L (127x89x7.9L) + 2-2"x12" SPR. No.2
WL7 = 5" x 3-1/2" x 5/16" L (127x89x7.9L) + 3-2"x12" SPR. No.2
WL8 = 5" x 3-1/2" x 5/16" L (127x89x7.9L) + 3-2"x10" SPR. No.2
WL9 = 6" x 4" x 7/16" L (152x102x11.0L) + 3-2"x10" SPR. No.2

WOOD LINTELS AND BEAMS (WB)

WB1 = 2-2"x8" (2-38x184) SPR. No.2
WB2 = 3-2"x8" (3-38x184) SPR. No.2
WB3 = 2-2"x10" (2-38x235) SPR. No.2
WB4 = 3-2"x10" (3-38x235) SPR. No.2
WB5 = 2-2"x12" (2-38x286) SPR. No.2
WB6 = 3-2"x12" (3-38x286) SPR. No.2
WB7 = 5-2"x12" (5-38x286) SPR. No.2
WB11 = 4-2"x10" (4-38x235) SPR. No.2
WB12 = 4-2"x12" (4-38x286) SPR. No.2

LAMINATED VENEER LUMBER (LVL) BEAMS

LVL1A = 1-1 3/4"x7 1/4" (1-45x184)
LVL1 = 2-1 3/4"x7 1/4" (2-45x184)
LVL2 = 3-1 3/4"x7 1/4" (3-45x184)
LVL3 = 4-1 3/4"x7 1/4" (4-45x184)
LVL4A = 1-1 3/4"x9 1/2" (1-45x240)
LVL4 = 2-1 3/4"x9 1/2" (2-45x240)
LVL5 = 3-1 3/4"x9 1/2" (3-45x240)
LVL5A = 4-1 3/4"x9 1/2" (4-45x240)
LVL6A = 1-1 3/4"x11 7/8" (1-45x300)
LVL6 = 2-1 3/4"x11 7/8" (2-45x300)
LVL7 = 3-1 3/4"x11 7/8" (3-45x300)
LVL7A = 4-1 3/4"x11 7/8" (4-45x300)
LVL8 = 2-1 3/4"x14" (2-45x356)
LVL9 = 3-1 3/4"x14" (3-45x356)

LOOSE STEEL LINTELS (L)

L1 = 3-1/2" x 3-1/2" x 1/4" L (89x89x6.4L)
L2 = 4" x 3-1/2" x 5/16" L (102x89x7.9L)
L3 = 5" x 3-1/2" x 5/16" L (127x89x7.9L)
L4 = 6" x 3-1/2" x 7/16" L (152x89x11.0L)
L5 = 6" x 4" x 7/16" L (152x102x11.0L)
L6 = 7" x 4" x 7/16" L (178x102x11.0L)

DOOR SCHEDULE

NOS.	WIDTH	HEIGHT 8' to 9' CEILING	HEIGHT 10' OR MORE CEILING	TYPE
1	2'-10"	6'-8"	8'-0"	INSULATED ENTRANCE DOOR
1a	2'-8"	6'-8"	8'-0"	INSULATED FRONT DOORS
2	2'-8"	6'-8"	8'-0"	WOOD & GLASS DOOR
3	2'-8"	6'-8"	8'-0"	EXTERIOR SLAB DOOR
4	2'-8"	6'-8"	8'-0"	INTERIOR SLAB DOOR
5	2'-6"	6'-8"	8'-0"	INTERIOR SLAB DOOR
6	2'-2"	6'-8"	8'-0"	INTERIOR SLAB DOOR
7	1'-6"	6'-8"	8'-0"	INTERIOR SLAB DOOR

GENERAL NOTES/CONSTRUCTION DETAILS

Reviewed model drawings to be read in conjunction with reviewed general notes, constructions details and specifications

TOWNHOUSE MODELS

Reviewed townhouse model drawings to be read in conjunction with reviewed lot specific block drawings and engineered truss system

CERAMIC TILE FOR CONVENTIONAL LUMBER

(OBC 9.30.6)

SPACE ALL CONVENTIONAL FLOOR JOISTS @ 12" O.C. BELOW ALL CERAMIC TILE AREAS.
PROVIDE 1 ROW BRIDGING FOR SPANS OF 5'0"-7'0", 2 ROWS FOR SPANS GREATER THAN 7'0".

NOTE: ROOF FRAMING

REFER TO ROOF TRUSS SHOP DRAWINGS FOR ALL ROOF FRAMING INFORMATION UNLESS OTHERWISE NOTED.


PLANS NOT DRAWN TO ACTUAL GRADE. REFER TO FINAL APPROVED GRADING PLAN.

NOTE: ENGINEERED FLOOR FRAMING

REFER TO ENGINEERED FLOOR FLAYOUTS FOR ALL ENGINEERED FLOOR FRAMING INFORMATION AND DETAILS. UNLESS OTHERWISE NOTED.


TWO STOREY HEIGHT
WALL DETAIL

2-2"x6" STUD WALL NAILED TOGETHER AND SPACED @ 12" o.c. FULL HEIGHT, c/w SOLID BLOCKING @ 4'-0" o.c. VERTICAL AND 7/16" EXT. PLYWOOD SHEATHING.

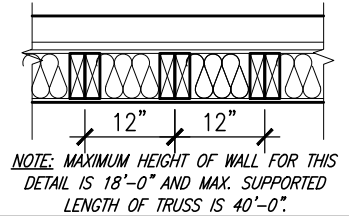


TWO STOREY HEIGHT
WALL DETAIL

2-1 1/2"x 5 1/2" TIMBERSTRAND (LSL) 1.E STUD WALL GLUED & NAILED TOGETHER AND SPACED MAX. @ 10" o.c. FULL HEIGHT, c/w SOLID BLOCKING @ 4'-0" o.c. VERTICAL AND 7/16" EXT. OSB SHEATHING GLUED AND NAILED.

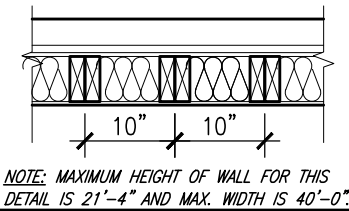

TWO STOREY HEIGHT
WALL DETAIL

2-1 1/2"x 5 1/2" TIMBERSTRAND (LSL) 1.5E STUD WALL GLUED & NAILED TOGETHER AND SPACED MAX. @ 9" o.c. FULL HEIGHT, c/w SOLID BLOCKING @ 8'-0" o.c. VERTICAL AND 7/16" EXT. OSB SHEATHING.

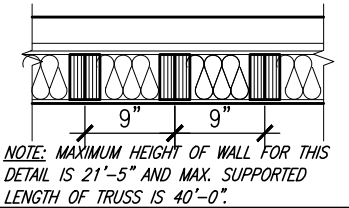

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UNINSULATED OPENINGS (PER OBC. SB-12, 3.1.1.(7))

IVY 7E AND ELEVATION 1	ENERGY EFFICIENCY - ENERGY STAR		
ELEVATION	WALL AREA S.F.	OPENING S.F.	PERCENTAGE
FRONT	548.72 S.F.	102.67 S.F.	18.71 %
LEFT SIDE	944.18 S.F.	69.07 S.F.	7.32 %
RIGHT SIDE	944.18 S.F.	0.0 S.F.	0.00 %
REAR	548.72 S.F.	132.24 S.F.	24.10 %
TOTAL SQ. FT.	2985.80 S.F.	303.98 S.F.	10.18 %
TOTAL SQ. M.	277.39 S.M.	28.24 S.M.	10.18 %

UNINSULATED OPENINGS (PER OBC. SB-12, 3.1.1.(7))

IVY 7E AND ELEVATION 2	ENERGY EFFICIENCY - ENERGY STAR		
ELEVATION	WALL AREA S.F.	OPENING S.F.	PERCENTAGE
FRONT	548.72 S.F.	70.42 S.F.	12.83 %
LEFT SIDE	944.18 S.F.	69.07 S.F.	7.32 %
RIGHT SIDE	944.18 S.F.	0.0 S.F.	0.00 %
REAR	548.72 S.F.	132.24 S.F.	24.10 %
TOTAL SQ. FT.	2985.80 S.F.	271.73 S.F.	9.10 %
TOTAL SQ. M.	277.39 S.M.	25.24 S.M.	9.10 %

UNINSULATED OPENINGS (PER OBC. SB-12, 3.1.1.(7))

IVY 7E AND ELEVATION 3	ENERGY EFFICIENCY - ENERGY STAR		
ELEVATION	WALL AREA S.F.	OPENING S.F.	PERCENTAGE
FRONT	548.72 S.F.	101.93 S.F.	18.58 %
LEFT SIDE	944.18 S.F.	69.07 S.F.	7.32 %
RIGHT SIDE	944.18 S.F.	0.0 S.F.	0.00 %
REAR	548.72 S.F.	132.24 S.F.	24.10 %
TOTAL SQ. FT.	2985.80 S.F.	303.24 S.F.	10.16 %
TOTAL SQ. M.	277.39 S.M.	28.17 S.M.	10.16 %



ENERGY STAR- V 12.7

AREA CALCULATIONS

ELEV '1'

GROUND FLOOR AREA 1064 SF
SECOND FLOOR AREA 1220 SF

TOTAL FLOOR AREA 2284 SF
(212.19 m2)

FIRST FLOOR OPEN AREA XX SF
SECOND FLOOR OPEN AREA XX SF
ADD TOTAL OPEN AREAS +XX SF
ADD FINISHED BSMT AREA +XX SF

GROSS FLOOR AREA 2284 SF
(212.19 m2)

GROUND FLOOR COVERAGE 1064 SF
GARAGE COVERAGE/AREA 217 SF
PORCH COVERAGE/AREA 104 SF

COVERAGE W/ PORCH 1385 SF
(128.67 m2)

COVERAGE W/O PORCH 1281 SF
(119.01 m2)

AREA CALCULATIONS

ELEV '2'

GROUND FLOOR AREA 1064 SF
SECOND FLOOR AREA 1211 SF

TOTAL FLOOR AREA 2275 SF
(211.35 m2)

FIRST FLOOR OPEN AREA XX SF
SECOND FLOOR OPEN AREA XX SF
ADD TOTAL OPEN AREAS +XX SF
ADD FINISHED BSMT AREA +XX SF

GROSS FLOOR AREA 2275 SF
(211.35 m2)

GROUND FLOOR COVERAGE 1064 SF
GARAGE COVERAGE/AREA 217 SF
PORCH COVERAGE/AREA 104 SF

COVERAGE W/ PORCH 1385 SF
(128.67 m2)

COVERAGE W/O PORCH 1281 SF
(119.01 m2)

AREA CALCULATIONS

ELEV '3'

GROUND FLOOR AREA 1057 SF
SECOND FLOOR AREA 1204 SF

TOTAL FLOOR AREA 2261 SF
(210.05 m2)

FIRST FLOOR OPEN AREA XX SF
SECOND FLOOR OPEN AREA XX SF
ADD TOTAL OPEN AREAS +XX SF
ADD FINISHED BSMT AREA +XX SF

GROSS FLOOR AREA 2261 SF
(210.05 m2)

GROUND FLOOR COVERAGE 1058 SF
GARAGE COVERAGE/AREA 217 SF
PORCH COVERAGE/AREA 102 SF

COVERAGE W/ PORCH 1377 SF
(127.93 m2)

COVERAGE W/O PORCH 1275 SF
(118.45 m2)

IVY-7E
ENERGY STAR/ PANEL



BUILDING: REVIEWED
SCOTT SHERRIFFS APR 19, 2017
PLANS EXAMINER DATE
Neither the issuance of a permit nor carrying out of inspections by the Town of Milton relieves the owner from full responsibility for compliance with the provisions of the Ontario Building Code Act and the Ontario Building Code, both as amended, as well as other applicable statutes and regulations of the Province of Ontario, By-laws of the Region of Halton and Town of Milton

RECEIVED
TOWN OF MILTON
MAR 29, 2017
IVY 7E
BUILDING DIVISION



9	.	.	.	The undersigned has reviewed and takes responsibility for this design and has the qualifications and meets the requirements set out in the Ontario Building Code to be a Designer.
8	.	.	.	qualification information
7	REVISED PER BLDG. DEPT. COMMENTS.	APR. 10/17	GW	Richard Vink 24488
6	ISSUED FOR PERMIT.	MAR. 01/17	GW	signature BCIN
5	REVISED. ADD SUNKEN FOYER COND.	OCT 03/16	WT	name registration information
4	2nd FLR WINDOW PANEL ADDED.	SEP 07/16	GW	VA3 Design Inc. 42658
3	REPLACED PATIO DR. w/ DOOR & WINDOW	AUG 25/16	GW	
2	RELOCATE GAS/HYDRO METERS	AUG 22/16	GW	
1	ISSUED FOR CLIENT REVIEW	AUG. 08/16	GW	
no.	description	date	by	Contractor must verify all dimensions on the job and report any discrepancy to the Designer before proceeding with the work. All drawings and specifications are instruments of service and the property of the Designer which must be returned at the completion of the work. Drawings are not to be scaled.



project name LECCO RIDGE DEV. INC.	municipality MILTON, ONT.	project no. 16015
date JULY, 2016	checked by WT	scale 3/16" = 1'-0"
GENERAL NOTES & CHARTS	file name 16015-IVY-7E	drawing no. A0

2284 SF.

ENGINEERED FLOOR FRAMING INFO
REFER TO ENGINEERED FLOOR LAYOUTS FOR ALL FLOOR FRAMING INFORMATION AND DETAILS. UNLESS OTHERWISE NOTED.

PARTY WALL DETAILS
= 1 HOUR PARTY WALL (FIRE SEPARATION)
See standard details page 4 for standard party wall construction details


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ARCHITECTURAL REVIEW & APPROVAL

MAR 20 2017

John G. Williams Limited, Architect



2284 SF.
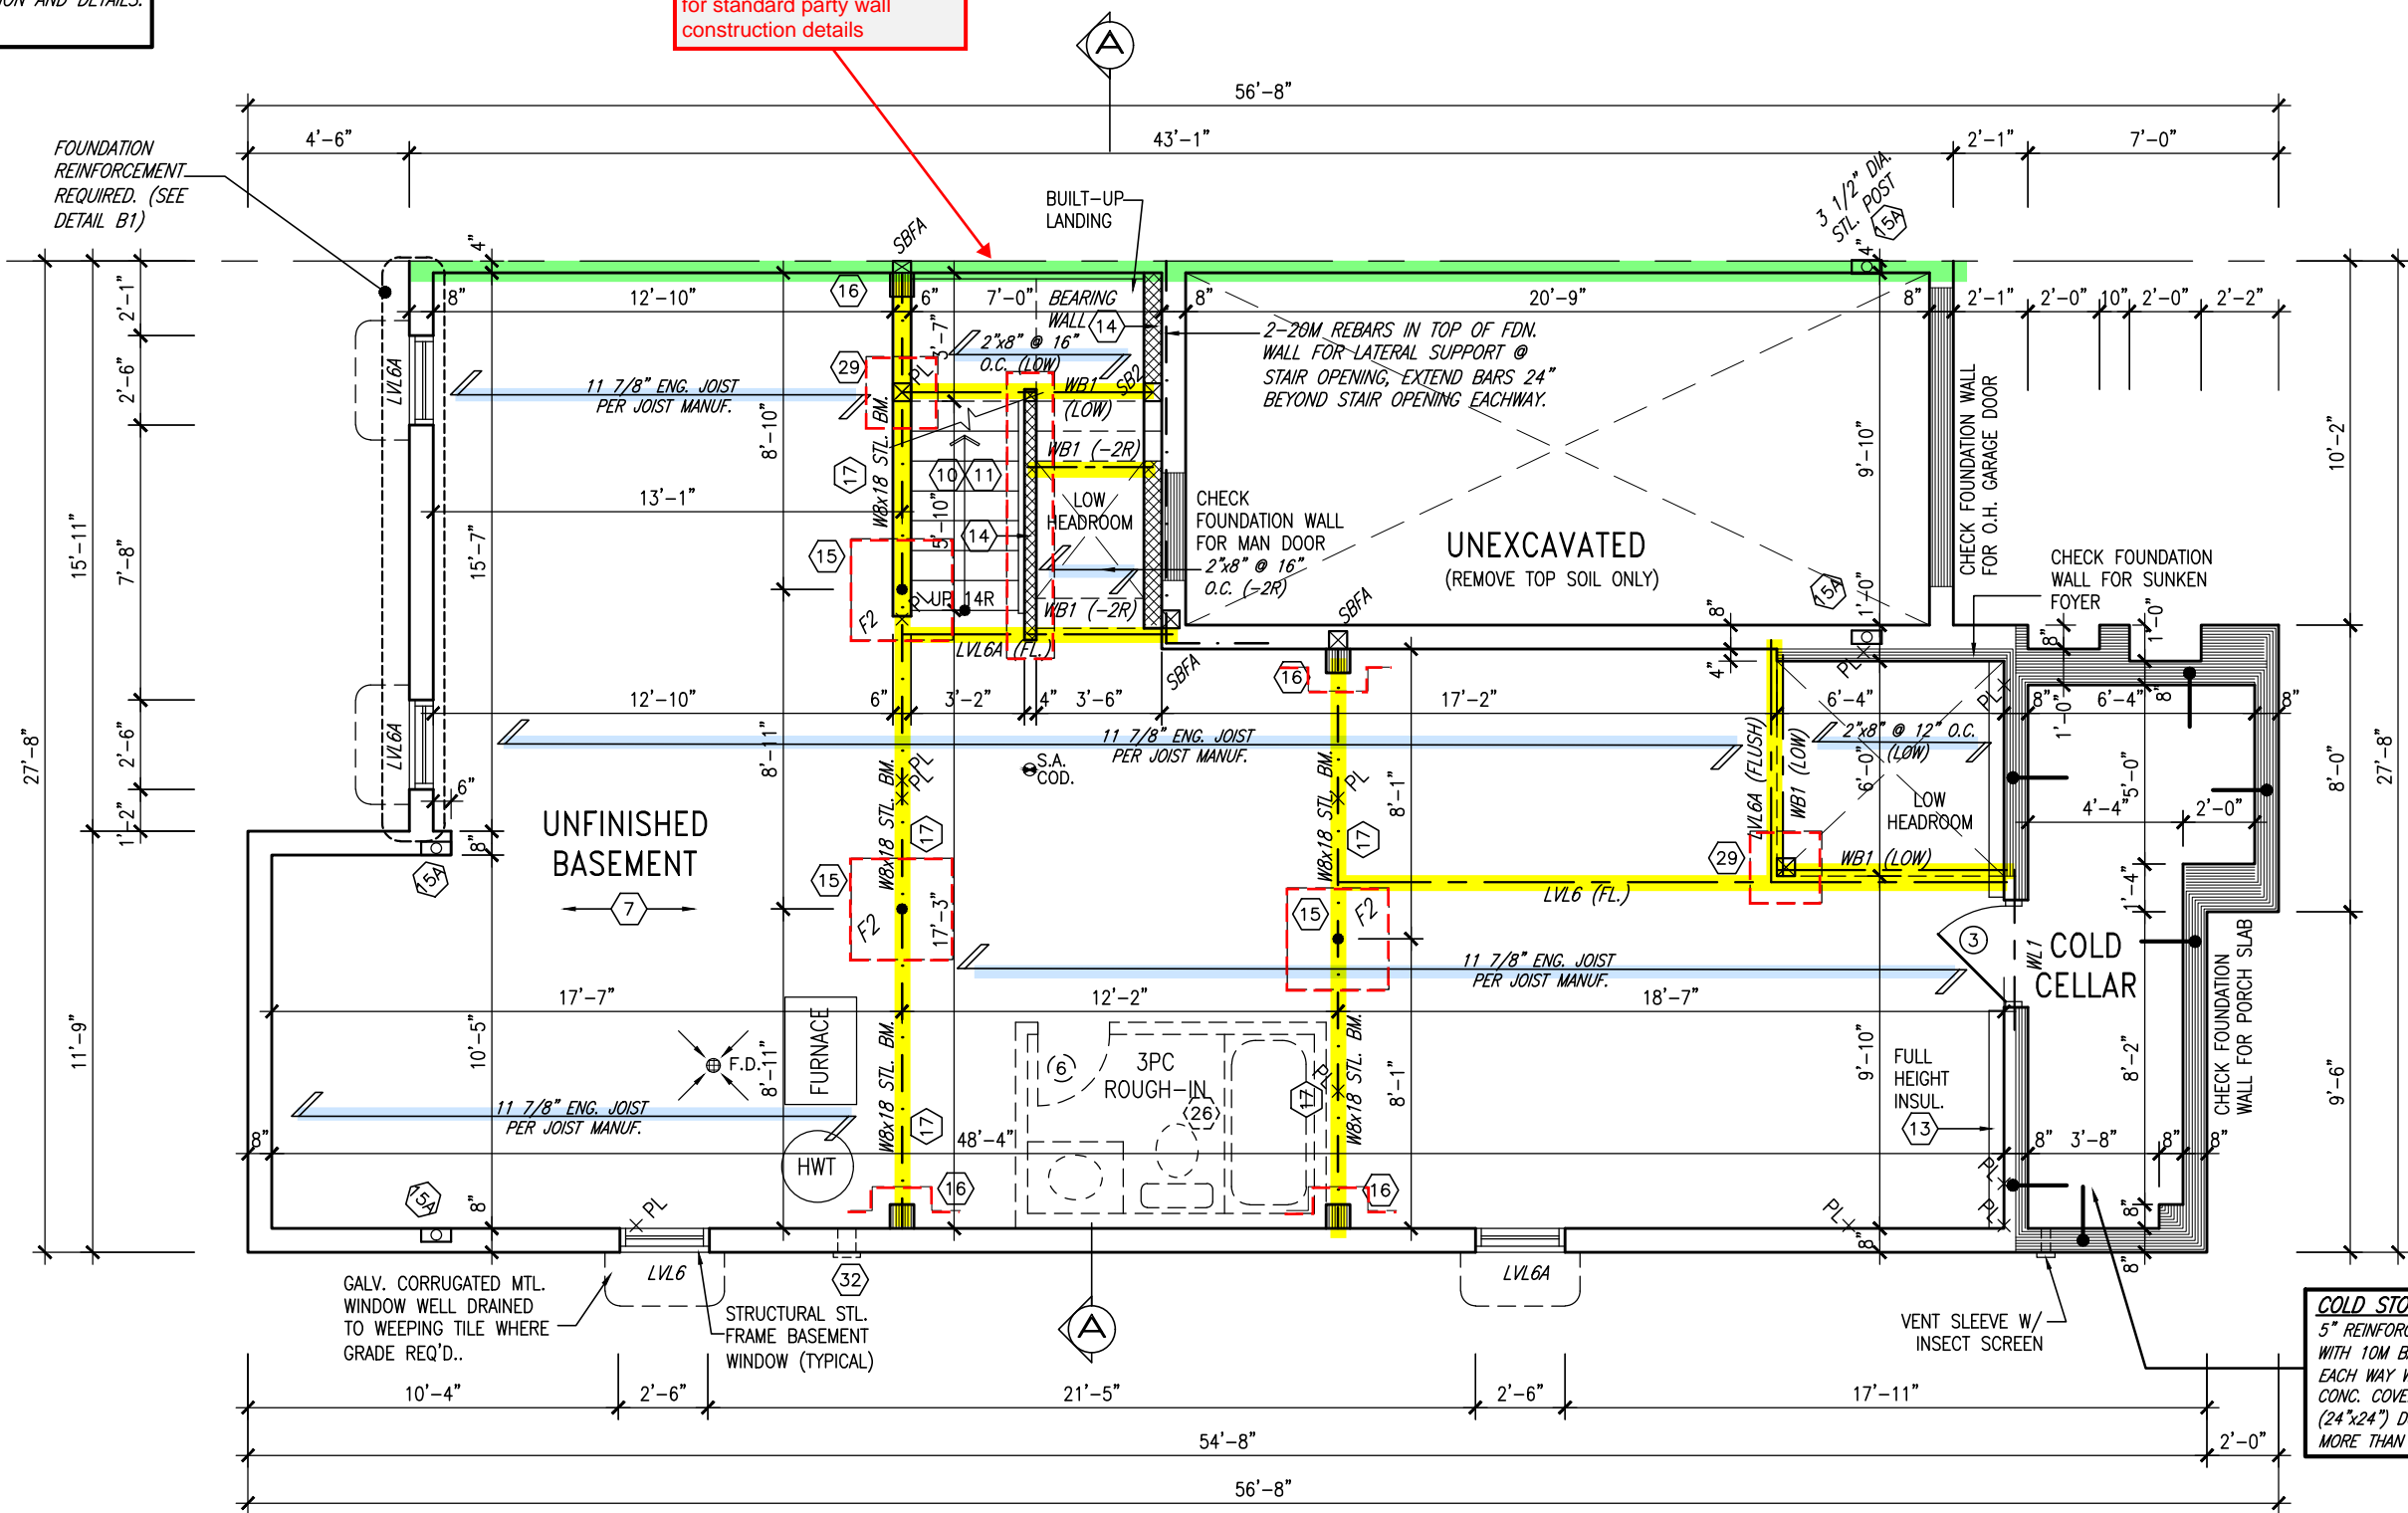
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ARCHITECTURAL REVIEW & APPROVAL
MAR 20 2017
John G. Williams Limited, Architect

= 1 HOUR PARTY WALL
(FIRE SEPARATION)

PARTY WALL DETAILS
See standard details page 4
for standard party wall
construction details

GARAGE AIR BARRIER


Garage walls/ceiling required to
include an air barrier system. Gypsum
board used as an air barrier requires
all joints to be sealed with tape and a
minimum 1 coat of compound

GARAGE DOOR

Requires weatherstripping
and a self closing device

GUARDS/HANDRAILS

Shall be provided on
porches as required
based on final lot grading

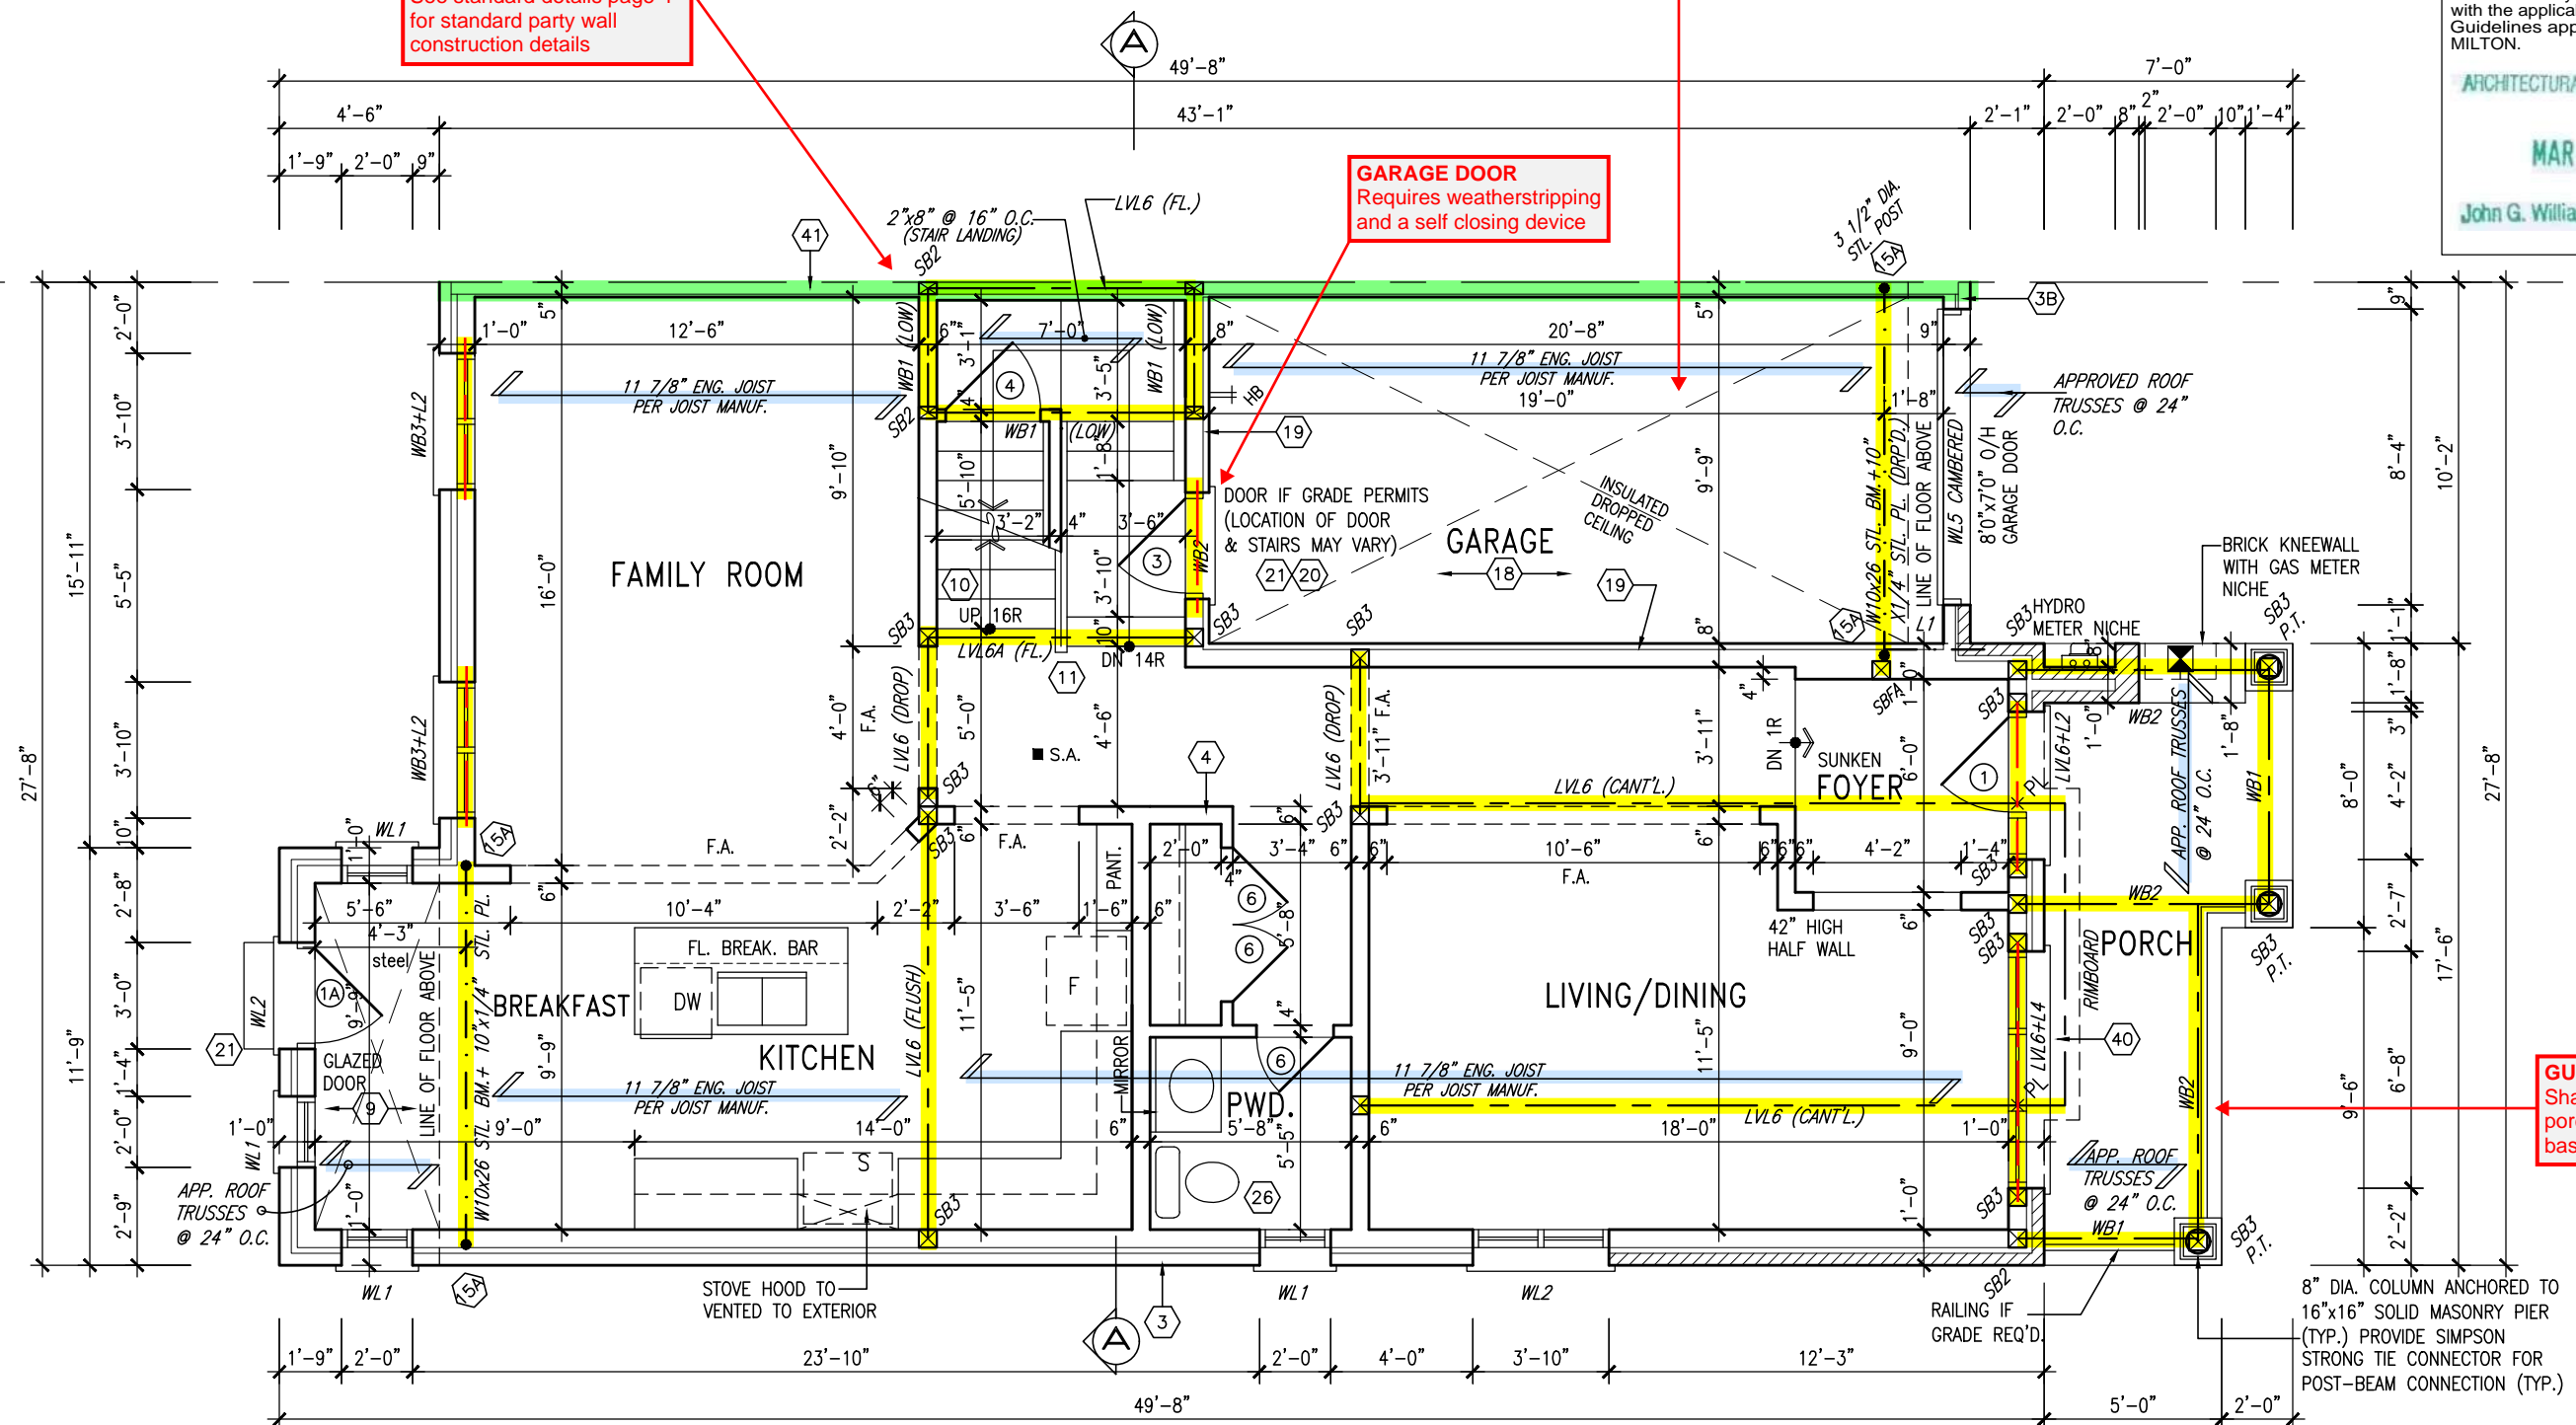

GROUND FLOOR PLAN - ELEV. '1'

ENGINEERED FLOOR SYSTEM

Reviewed model drawings to be
read in conjunction with reviewed
engineered floor system layout

TOWN OF MILTON
PLANNING AND DEVELOPMENT
IVY 7E MODEL

BUILDING: REVIEWED
SCOTT SHERRIFFS APR 19, 2017
PLANS EXAMINER DATE

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BUILDING DIVISION

ENGINEERED FLOOR SUBFLOORS
ALL SUBFLOORS TO BE 5/8" PLYWOOD AND TO
BE GLUED AND NAILED ON THIS FLOOR FOR
ENGINEERED JOIST ONLY.



STRUDET INC.
FOR STRUCTURE ONLY

9	REVISED PER BLDG. DEPT. COMMENTS.	APR. 10/17	GW
8	ISSUED FOR PERMIT.	MAR. 01/17	GW
7	REVISED. ADD SUNKEN FOYER COND.	OCT 03/16	WT
6	2nd FLR WINDOW PANEL ADDED.	SEP 07/16	GW
5	REPLACED PATIO DR. w/ DOOR & WINDOW	AUG 25/16	GW
4	RELOCATE GAS/HYDRO METERS	AUG 22/16	GW
3	ISSUED FOR CLIENT REVIEW	AUG. 08/16	GW
2			
1			
no.	description	date	by

The undersigned has reviewed and takes responsibility for this design
and has the qualifications and meets the requirements set out in the
Ontario Building Code to be a Designer.
qualification information
Richard Vink 24488
signature
VA3 Design Inc. 42658
Contractor must verify all dimensions on the job and report any
discrepancy to the Designer before proceeding with the work. All
drawings and specifications are instruments of service and the property
of the Designer which must be returned at the completion of the work.
Drawings are not to be scaled.

VA3 DESIGN
120-255 Consumers Rd
Toronto ON M2J 1R4
t 416.630.2255 f 416.630.4782
va3design.com

Greenpark.

project name
LECCO RIDGE DEV. INC.

municipality
MILTON, ONT.

date
JULY, 2016

drawn by
WT

checked by
3/16" = 1'-0"

scale
3/16" = 1'-0"

file name
16015-IVY-7E


drawing no.
A2

project no.
16015

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ARCHITECTURAL REVIEW & APPROVAL
MAR 20 2017
John G. Williams Limited, Architect



TOWNHOUSE MODELS
Reviewed townhouse model drawings to be read in conjunction with reviewed lot specific block drawings and engineered truss system

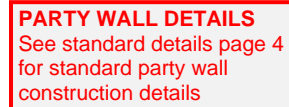BATHROOM BLOCKING
See standard details page 8
for required main bathroom
grab bar reinforcing



TOWN OF MILTON

PLANNING AND DEVELOPMENT

IVY 7E MODEL

BUILDING: REVIEWED

SCOTT SHERRIFFS

PLANS EXAMINER

APR 19, 2017

DATE

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MAR 29, 2017
IVY 7E
BUILDING DIVISION

STUD WALL REINFORCEMENT FOR FUTURE GRAB BARS IN MAIN BATHROOM
REINFORCEMENT OF STUD WALLS SHALL BE INSTALLED ADJACENT TO WATER CLOSETS AND SHOWER OR BATHTUB IN MAIN BATHROOM. REFER TO OBC. 9.5.2.3, 3.8.3.8.(1)(d) & 3.8.3.13.(1)(f).

NOTE:
REFER TO BLOCK WORKING DRAWINGS FOR
SECOND FLOOR STRUCTURAL INFORMATION.

9	.	.	.	The undersigned has reviewed and takes responsibility for this design and has the qualifications and meets the requirements set out in the
8	.	.	.	Ontario Building Code to be a Designer.
7	REVISED PER BLDG. DEPT. COMMENTS.	APR. 10/17	GW	clification information
6	ISSUED FOR PERMIT.	MAR. 01/17	GW	Richard Vink 2448
5	REVISED. ADD SUNKEN FOYER COND.	OCT 03/16	WT	name signature BC
4	2nd FLR WINDOW PANEL ADDED.	SEP 07/16	GW	registration information
3	REPLACED PATIO DR. w/ DOOR & WINDOW	AUG 25/16	GW	VA3 Design Inc. 4265
2	RELOCATE GAS/HYDRO METERS	AUG 22/16	GW	Contractor must verify all dimensions on the job and report any discrepancy to the Designer before proceeding with the work. All drawings and specifications are instruments of service and the property of the Designer which must be returned at the completion of the work. Drawings are not to be scaled.
1	ISSUED FOR CLIENT REVIEW	AUG. 08/16	GW	
no.	description	date	by	

VA3
DESIGN
120-255 Consumers Rd
Toronto ON M2J 1R4
t 416.630.2255 f 416.630.4782
va3design.com



project name LECCO RIDGE DEV. INC.	municipality MILTON, ONT.	project no. 16015
date JULY, 2016		drawing no. A3
SECOND FLOOR PLAN - ELEV. '1' drawn by _____ checked by _____ scale 3/16" = 1'-0" file name 16015-1YY-7E		
WT - H:\ARCHIVE\WORKING\2016\16015.GRE\UNITS\WV\1Y-7E\16015-1YY-7E.dwg - Tue - Apr 11 2017 - 1:41 PM		

IVY-7E
ENERGY STAR/ PANEL

IVY-7E

VY-7E

project no.
16015

ing no.

A3

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2284 SF.

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ARCHITECTURAL REVIEW & APPROVAL

MAR 20 2017

John G. Williams, Limited, Architect

= 1 HOUR PARTY WALL
(FIRE SEPARATION)

PARTY WALL DETAILS
See standard details page 4
for standard party wall
construction details

ROOF PLAN '1'

ASPHALT SHINGLES (TYP.)
VALLEY FLASHING (TYP.)

REAR ELEVATION '1'

FRONT ELEVATION '1'

GUARDS/HANDRAILS
Shall be provided on
porches as required
based on final lot grading



TOWN OF MILTON
PLANNING AND DEVELOPMENT
IVY 7E MODEL

BUILDING: REVIEWED
SCOTT SHERRIFFS APR 19, 2017
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VA3
DESIGN

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Toronto ON M2J 1R4
t 416.630.2255 f 416.630.4782
va3design.com

Greenpark.

project name
LECCO RIDGE DEV. INC.

municipality
MILTON, ONT.

IVY-7E

project no.
16015

date
JULY, 2016
drawn by
WT
checked by
scale
3/16" = 1'-0"
file name
16015-IVY-7E
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drawing no.
A4

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MAR 2/0 2017

John G. Williams Limited, Architect



IVY-7E
ENERGY STAR/ PANEL



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MAR 29, 2017
IVY 7E
BUILDING DIVISION

9	The undersigned has reviewed and takes responsibility for this design and has the qualifications and meets the requirements set out in the Ontario Building Code to be a Designer.
8	
7	REVISED PER BLDG. DEPT. COMMENTS.	APR. 10/17	GW	qualification information	
6	ISSUED FOR PERMIT.	MAR. 01/17	GW	Richard Vink	24488
5	REVISED. ADD SUNKEN FOYER COND.	OCT 03/16	WT	name	BCIN
4	2nd FLR WINDOW PANEL ADDED.	SEP 07/16	GW	registration information	
3	REPLACED PATIO DR. w/ BOOR & WINDOW	AUG 25/16	GW	VAS Design Inc.	42658
2	RELOCATE GAS/HYDRO METERS	AUG 22/16	GW		
1	ISSUED FOR CLIENT REVIEW	AUG. 08/16	GW		
no.	description	date	by	Contractor must verify all dimensions on the job and report any discrepancy to the Designer before proceeding with the work. All drawings and specifications are instruments of service and the property of the Designer which must be returned at the completion of the work. Drawings are not to be scaled.	



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t 416.630.2255 f 416.630.4782
va3design.com



project name	municipality
LECCO RIDGE DEV. INC.	MILTON, ONT.

IVY-7E

Project no.
6015

date JULY, 2016 LEFT SIDE ELEVATION - ELEV. '1'

WT - 3/16" = 1'-0" 16015-IVY-7E

rawing no.
AF


A5

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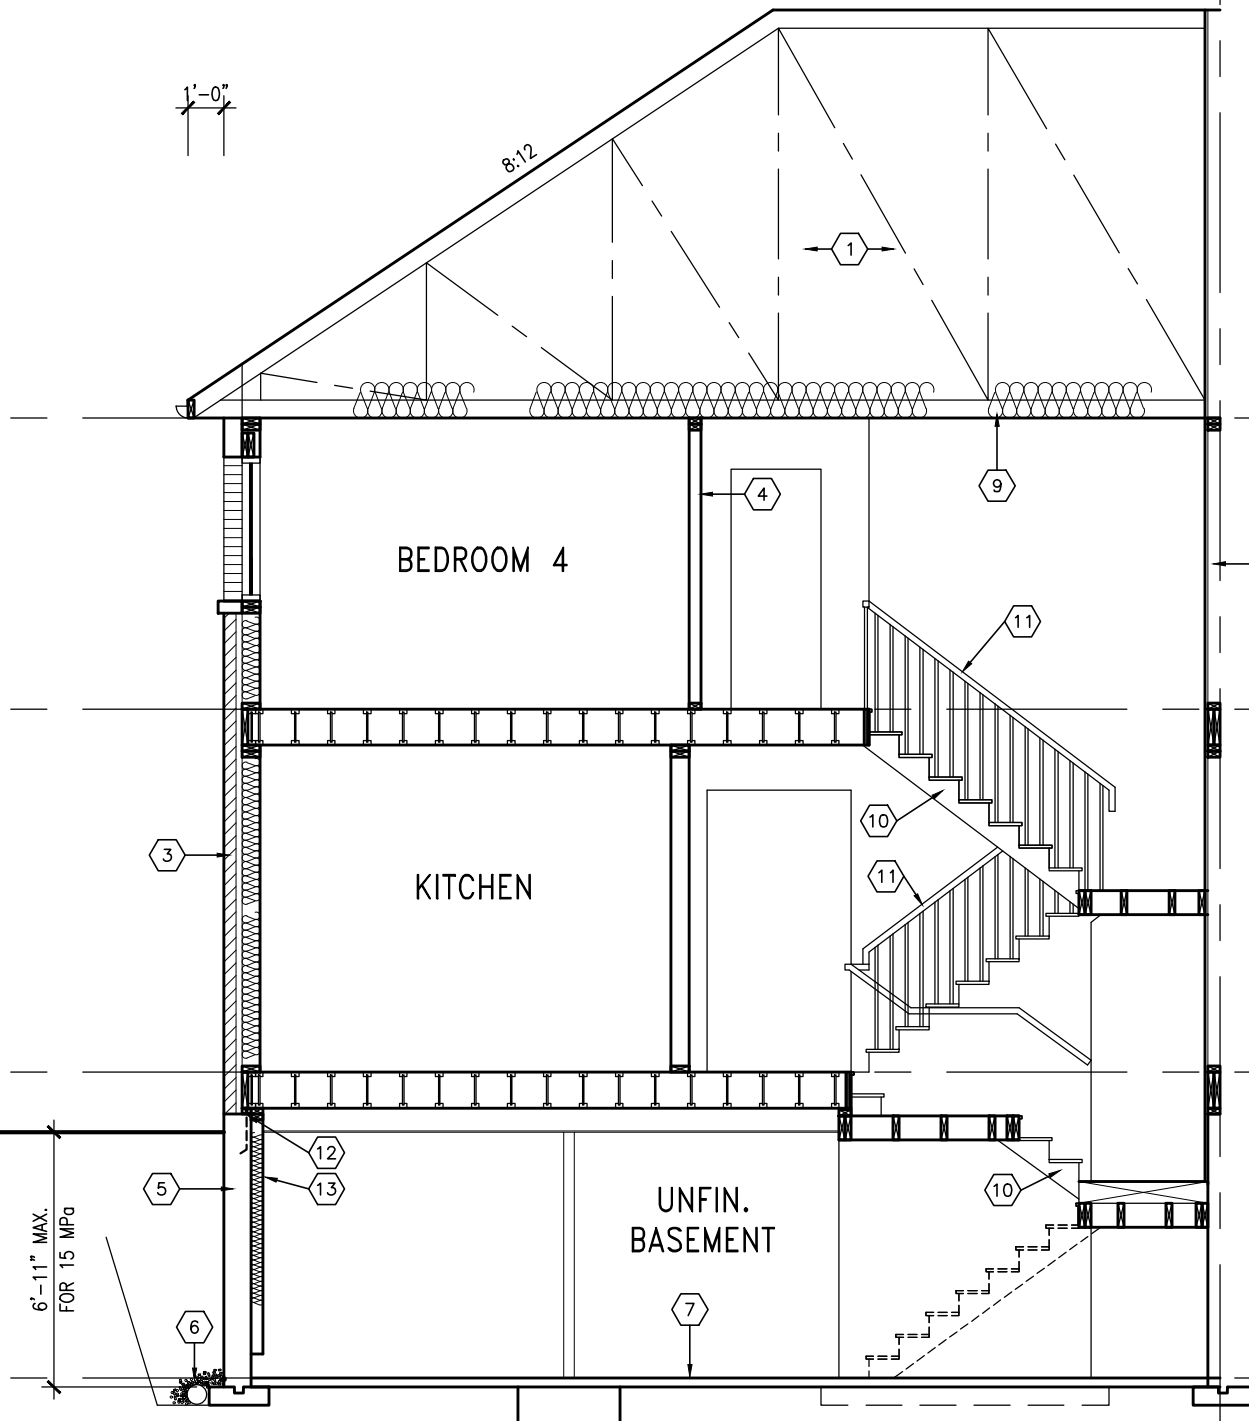
2284 SF.

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SECTION B



SECTION A-A ELEV. '1'

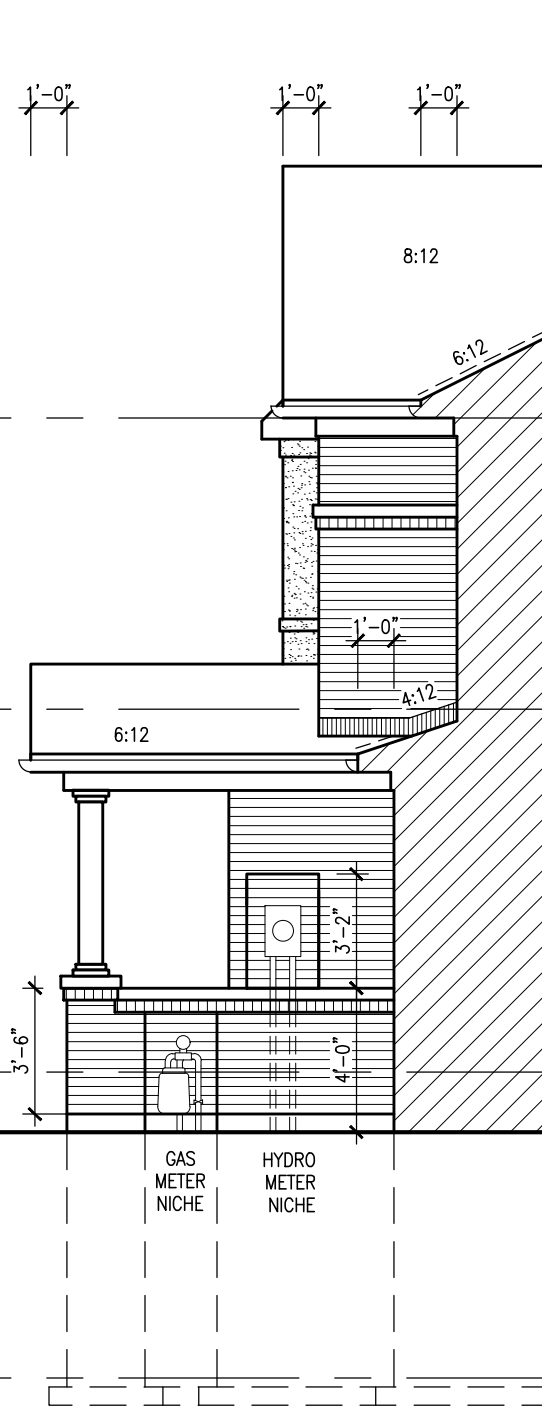TOP OF PLATE
TOP OF WINDOW
7'-0"
8'-1"
FIN. SECOND FLOOR
TOP OF WINDOW
7'-10"
10'-1"
FIN. GROUND FLOOR
FIN. GRADE
8'-6"
TOP OF SLAB

TOWN OF MILTON
PLANNING AND DEVELOPMENT
IVY 7E MODEL
BUILDING: REVIEWED
SCOTT SHERRIFFS APR 19, 2017
PLANS EXAMINER DATE
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REGISTERED PROFESSIONAL ENGINEER
B. MARINKOVIC
PROVINCE OF ONTARIO
STRUDET INC.
FOR STRUCTURE ONLY

9	.	.	.
8	.	.	.
7	REVISED PER BLDG. DEPT. COMMENTS.	APR. 10/17	GW
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qualification information
Richard Vink 24488
signature BCIN
name registration information
VA3 Design Inc. 42658

VA3 DESIGN
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Toronto ON M2J 1R4
t 416.630.2255 f 416.630.4782
va3design.com

Greenpark.
project name
LECCO RIDGE DEV. INC. MILTON, ONT.
project no.
16015
date
JULY, 2016
drawn by
WT
checked by
scale
3/16" = 1'-0"
file name
16015-IVY-7E
drawing no.
A6
SECTION A-A ELEV. 1
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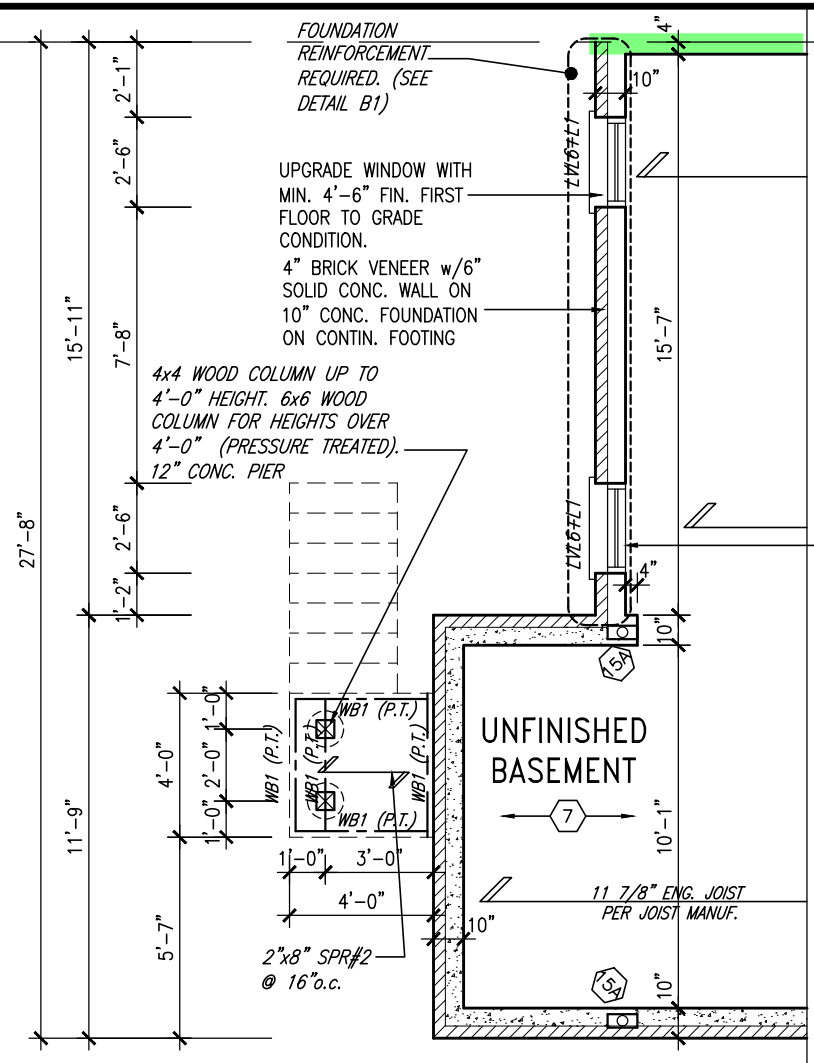
ARCHITECTURAL REVIEW & APPROVAL
MAR 20 2017
John G. Williams, Architect

= 1 HOUR PARTY WALL (FIRE SEPARATION)


PARTY WALL DETAILS
See standard details page 4 for standard party wall construction details

PART. BASEMENT PLAN
W.O.D CONDITION
(8R OR MORE)

DECK DETAILS
See standard details pages 5 and 5-2 for additional deck construction details




PART. GROUND FLOOR PLAN
W.O.D CONDITION
(8R OR MORE)

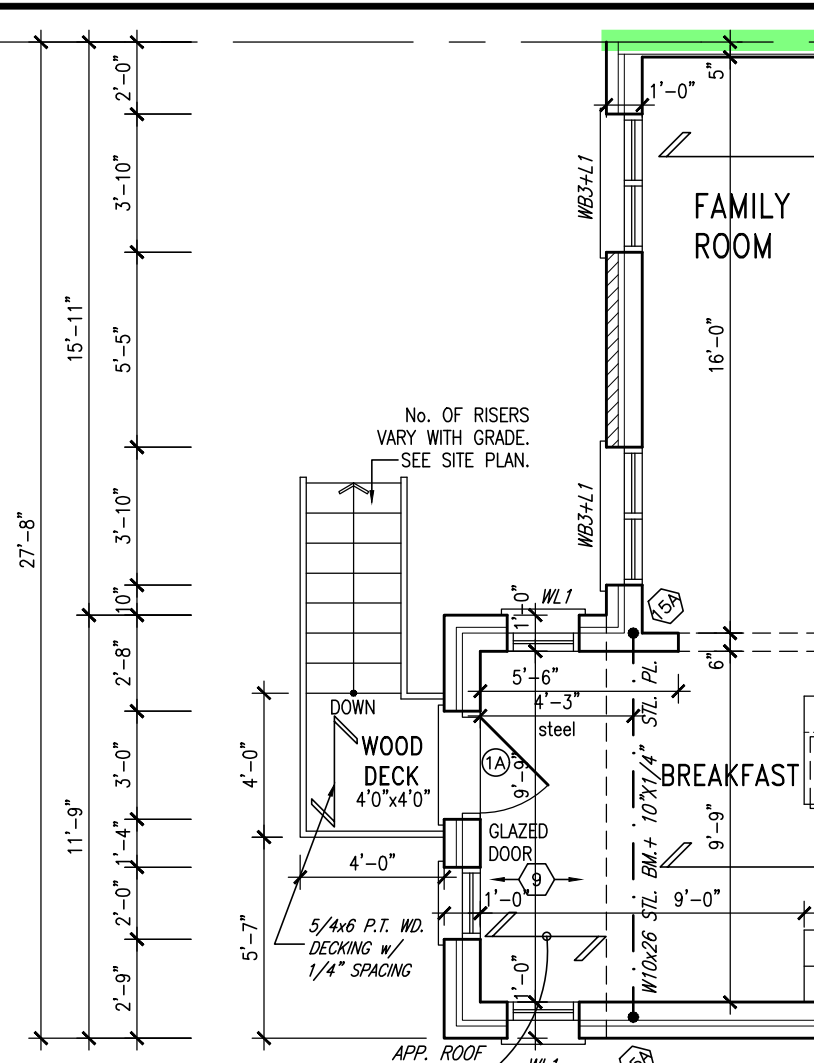


PART. BASEMENT PLAN
W.O.D CONDITION
(7R MAX.)

VENEER CUT
WHEN VENEER CUT IS GREATER THAN 26", A 10" POURED CONCRETE FOUNDATION WALL IS REQUIRED.

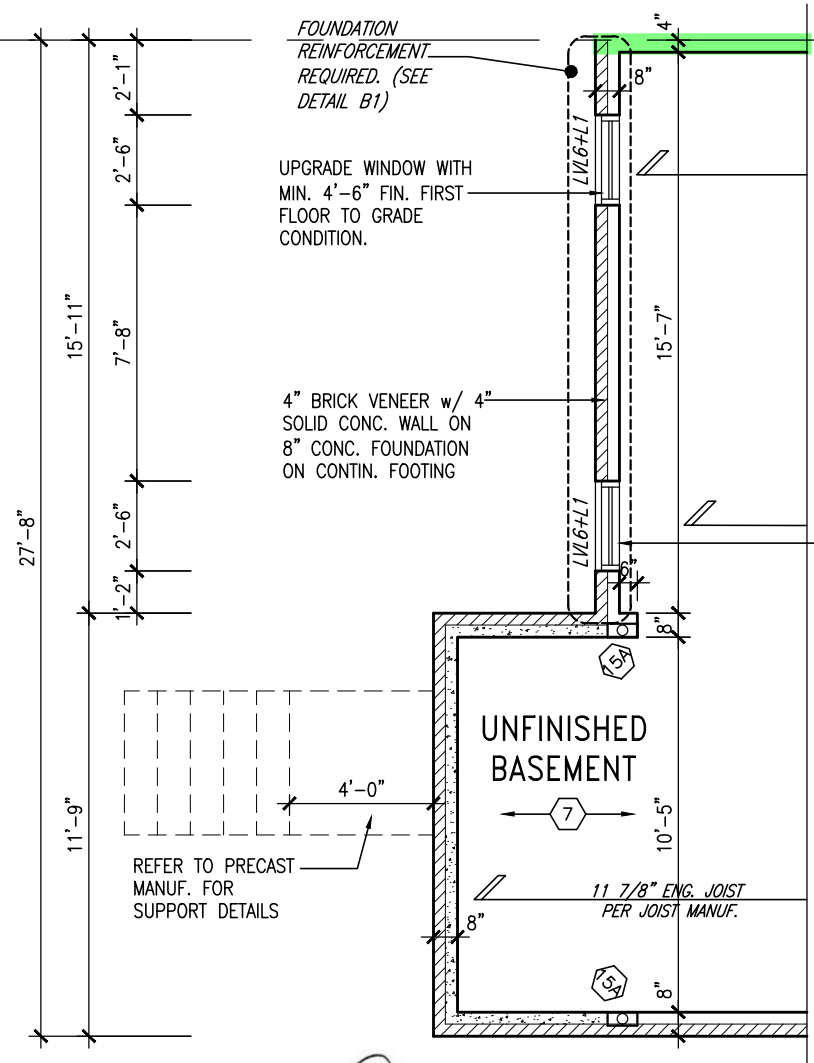

PART. GROUND FLOOR PLAN
W.O.D CONDITION
(7R MAX.)

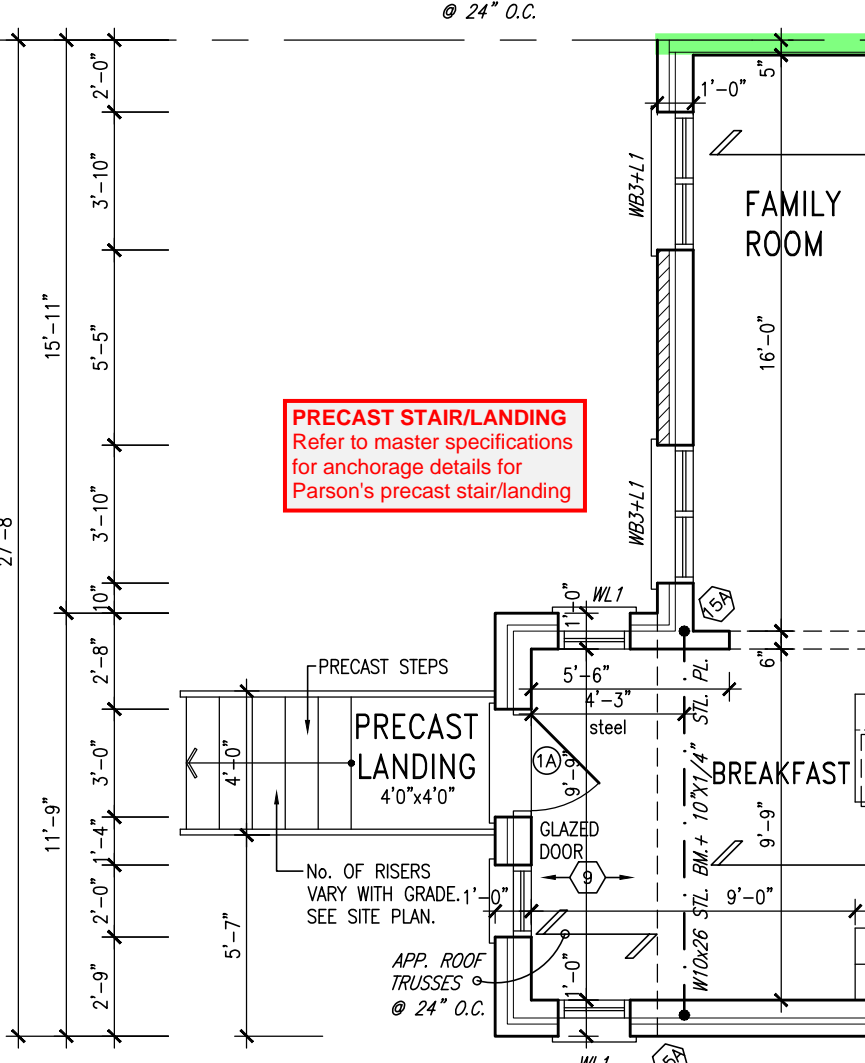

PRECAST STAIR/LANDING
Refer to master specifications for anchorage details for Parson's precast stair/landing

IVY-7E
ENERGY STAR/ PANEL

TOWN OF MILTON
PLANNING AND DEVELOPMENT
IVY 7E MODEL
BUILDING: REVIEWED
SCOTT SHERRIFFS APR 19, 2017
PLANS EXAMINER DATE
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REGISTERED PROFESSIONAL ENGINEER
B. MARINKOVIC
PROVINCE OF ONTARIO
STRUDET INC.
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2			
1			
no.	description	date	by

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qualification information
Richard Vink 24488
signature
VA3 Design Inc. 42658
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va3design.com

Greenpark.
project name
LECCO RIDGE DEV. INC.
municipality
MILTON, ONT.
date
JULY, 2016
drawn by
WT
checked by
scale
3/16" = 1'-0"
file name
16015-IVY-7E
drawing no.
A7

IVY-7E
PART. PLANS - DECK CONDITION
project no.
16015

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2284 SF.

ENGINEERED FLOOR FRAMING INFO
REFER TO ENGINEERED FLOOR LAYOUTS FOR
ALL FLOOR FRAMING INFORMATION AND DETAILS.
UNLESS OTHERWISE NOTED.

= 1 HOUR PARTY WALL
(FIRE SEPARATION)

PARTY WALL DETAILS
See standard details page 4
for standard party wall
construction details


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MAR 20 2017


John G. Williams, Architect



COLD STORAGE SLAB
5" REINFORCED CONCRETE SLAB
WITH 10M BARS @ 7' 7/8" o.c.
EACH WAY WITH MIN. 1 1/4"
CONC. COVER AND 10M BENT
(24"x24") DOWELS SPACED NOT
MORE THAN 23 5/8" o.c.

BASEMENT PLAN - ELEV. '2'

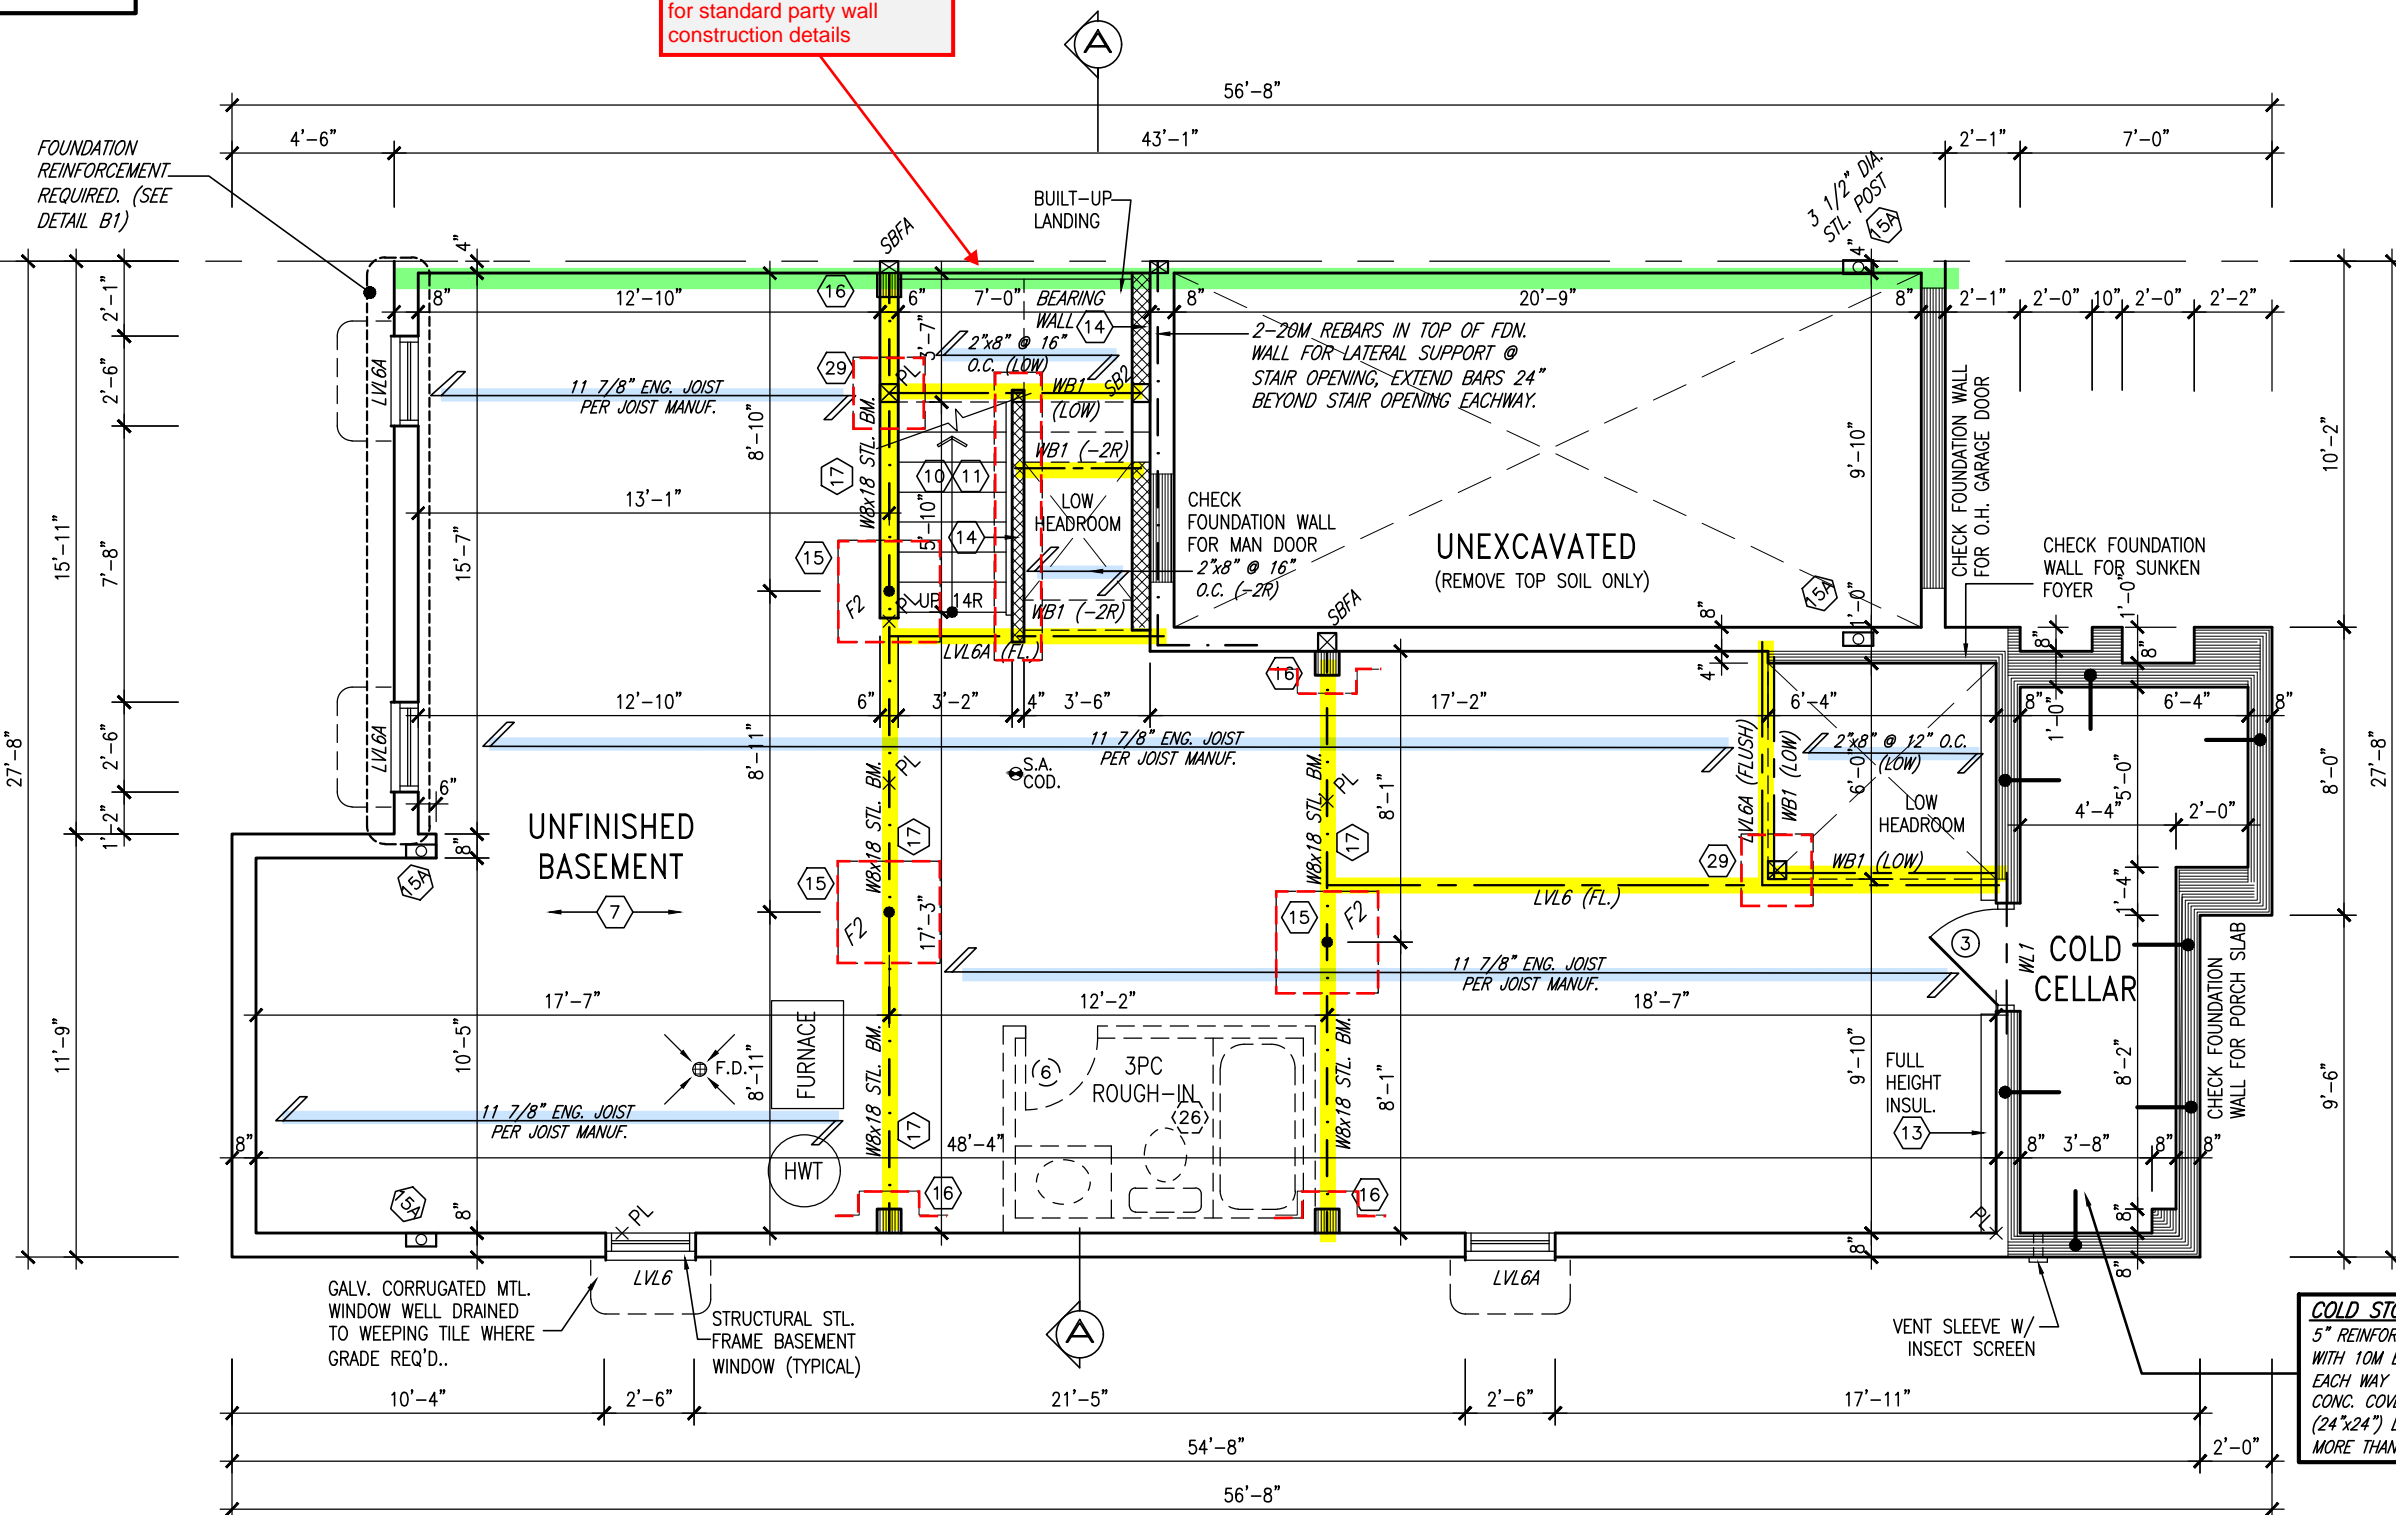ENGINEERED FLOOR SYSTEM
Reviewed model drawings to be
read in conjunction with reviewed
engineered floor system layout

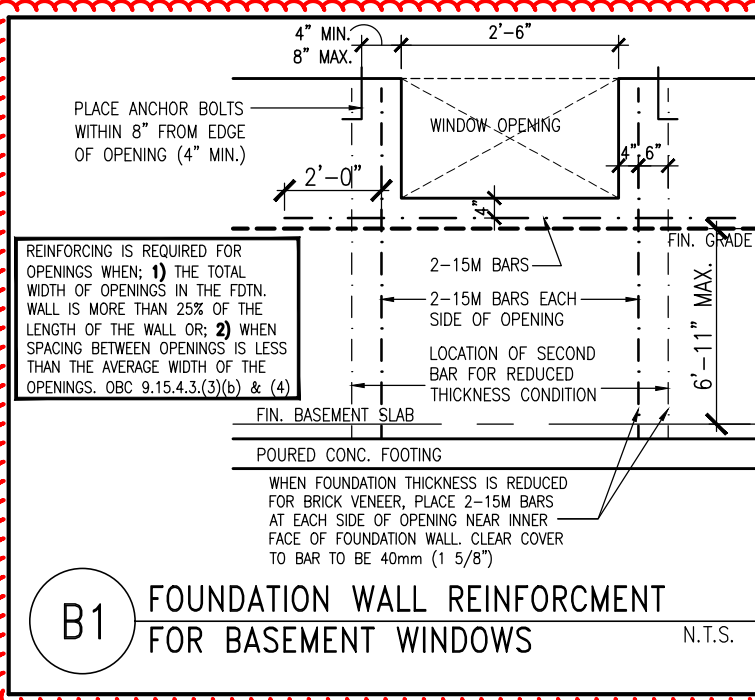

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BUILDING DIVISION

TOWN OF MILTON
PLANNING AND DEVELOPMENT
IVY 7E MODEL
BUILDING: REVIEWED
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IVY-7E
ENERGY STAR/ PANEL

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Greenpark.
project name
LECCO RIDGE DEV. INC.
municipality
MILTON, ONT.
date
JULY, 2016
checked by
scale
3/16" = 1'-0"

IVY-7E
BASEMENT PLAN - ELEV. '2'
drawing no.
16015
A1a

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MAR 2/0 2017

John G. Williams Limited, Architect

PARTY WALL DETAILS
See standard details page 4
for standard party wall
construction details

Garage walls/ceiling required to include an air barrier system. Gypsum board used as an air barrier requires all joints to be sealed with tape and a minimum 1 coat of compound


GARAGE DOOR
Requires weatherstripping
and a self closing device

GUARDS/HANDRAILS
Shall be provided on
porches as required
based on final lot grading

8" DIA. COLUMN ANCHORED TO
16"x16" SOLID MASONRY PIER
(TYP.) PROVIDE SIMPSON
STRONG TIE CONNECTOR FOR
POST-BEAM CONNECTION (TYP.)

ENGINEERED FLOOR SYSTEM
Reviewed model drawings to be read in conjunction with reviewed engineered floor system layout

NOTE 1:
FLAT ROOF FRAMING (TYP.)
2"x8" @ 12" O.C. P.T. CLG. JST.
w/ 2"x4" @ 12" O.C. P.T.
DIAGONALLY CUT CROSS PURLINS
w/ 5/8" EXTERIOR GRADE
SHEATHING + SINGLE PLY ROOF
MEMBRANE (SLOPE TO DRAIN)

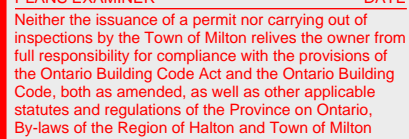

ENGINEERED FLOOR SUBFLOORS
ALL SUBFLOORS TO BE 5/8" PLYWOOD AND TO
BE GLUED AND NAILED ON THIS FLOOR FOR
ENGINEERED JOIST ONLY.



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6	ISSUED FOR PERMIT.	MAR. 01/17	GW	Richard Vink 2408
5	REVISED. ADD SUNKEN FOYER COND.	OCT 03/16	WT	name signature 9C
4	2nd FLR WINDOW PANEL ADDED.	SEP 07/16	GW	registration information VA3 Design Inc. 4265
3	REPLACED PATIO DR. w/ DOOR & WINDOW	AUG 25/16	GW	
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Drawing no.

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A2a1

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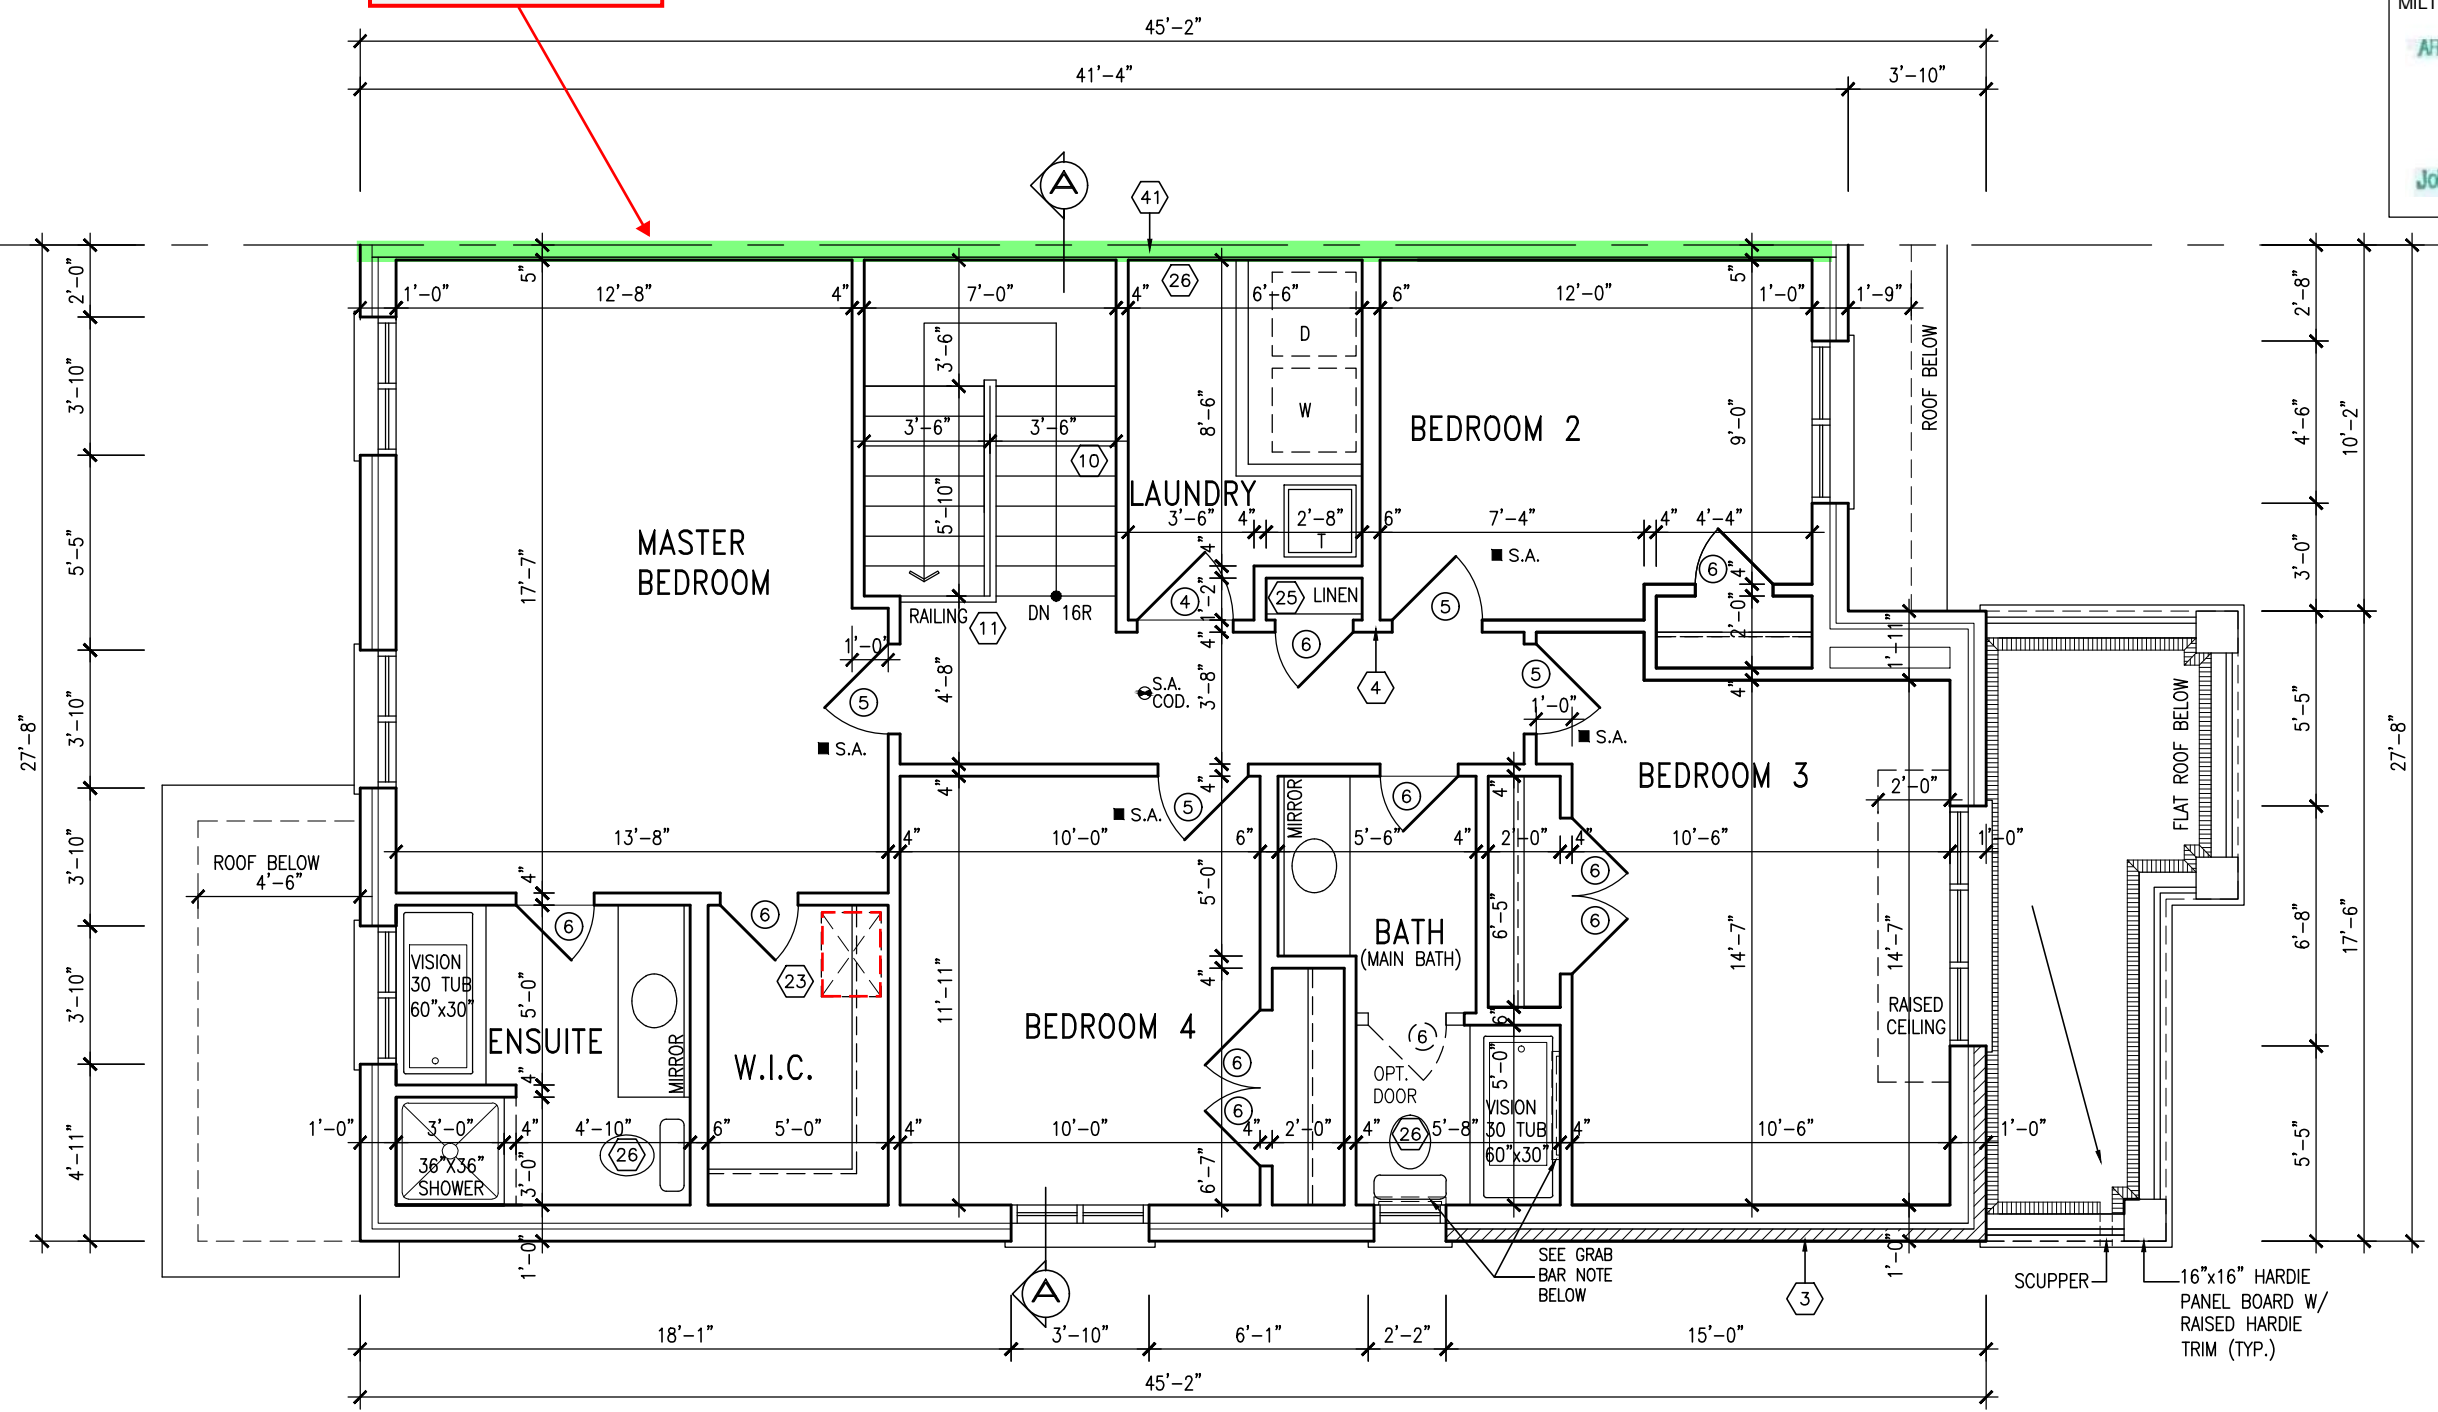
2284 SF.

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ARCHITECTURAL REVIEW & APPROVAL
MAR 20 2017
John G. Williams Limited, Architect

= 1 HOUR PARTY WALL
(FIRE SEPARATION)
PARTY WALL DETAILS
See standard details page 4
for standard party wall
construction details



TOWN OF MILTON
PLANNING AND DEVELOPMENT
IVY 7E MODEL
BUILDING: REVIEWED
SCOTT SHERRIFFS APR 19, 2017
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TOWNHOUSE MODELS
Reviewed townhouse model drawings to be read in conjunction with reviewed lot specific block drawings and engineered truss system

SECOND FLOOR PLAN ELEV. '2'

BATHROOM BLOCKING
See standard details page 8
for required main bathroom
grab bar reinforcing

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STUD WALL REINFORCEMENT FOR FUTURE GRAB BARS IN MAIN BATHROOM
REINFORCEMENT OF STUD WALLS SHALL BE INSTALLED ADJACENT TO WATER CLOSETS AND SHOWER OR BATHTUB IN MAIN BATHROOM. REFER TO OBC. 9.5.2.3, 3.8.3.8.(1)(d) & 3.8.3.13.(1)(f).

NOTE:
REFER TO BLOCK WORKING DRAWINGS FOR SECOND FLOOR STRUCTURAL INFORMATION.

9					
8					
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t 416.630.2255 f 416.630.4782
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Greenpark.		IVY-7E	
project name LECCO RIDGE DEV. INC.		project no. 16015	
date JULY, 2016		drawing no. A3a	
drawn by WT		file name 16015-IVY-7E	
checked by 3/16" = 1'-0"		scale	
project location MILTON, ONT.		drawing title SECOND FLOOR PLAN - ELEV. '2'	
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John G. Williams Limited, Architect

= 1 HOUR PARTY WALL
(FIRE SEPARATION)

PARTY WALL DETAILS
See standard details page 4
for standard party wall
construction details

ROOF PLAN '2'

ASPHALT SHINGLES (TYP.)
VALLEY FLASHING (TYP.)

REAR ELEVATION '2'

FRONT ELEVATION '2'

GUARDS/HANDRAILS
Shall be provided on
porches as required
based on final lot grading

TOWN OF MILTON
PLANNING AND DEVELOPMENT
IVY 7E MODEL

BUILDING: REVIEWED
SCOTT SHERRIFFS
PLANS EXAMINER
APR 19, 2017
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DESIGN

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t 416.630.2255 f 416.630.4782
va3design.com

Greenpark.

project name
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municipality
MILTON, ONT.

IVY-7E

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FRONT/ REAR ELEVATION - ELEV. '2'

file name
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drawing no.
A4a

2284 SF.


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ARCHITECTURAL REVIEW & APPROVAL

MAR 20 2017

John G. Williams Limited, Architect



LEFT SIDE ELEVATION '2'

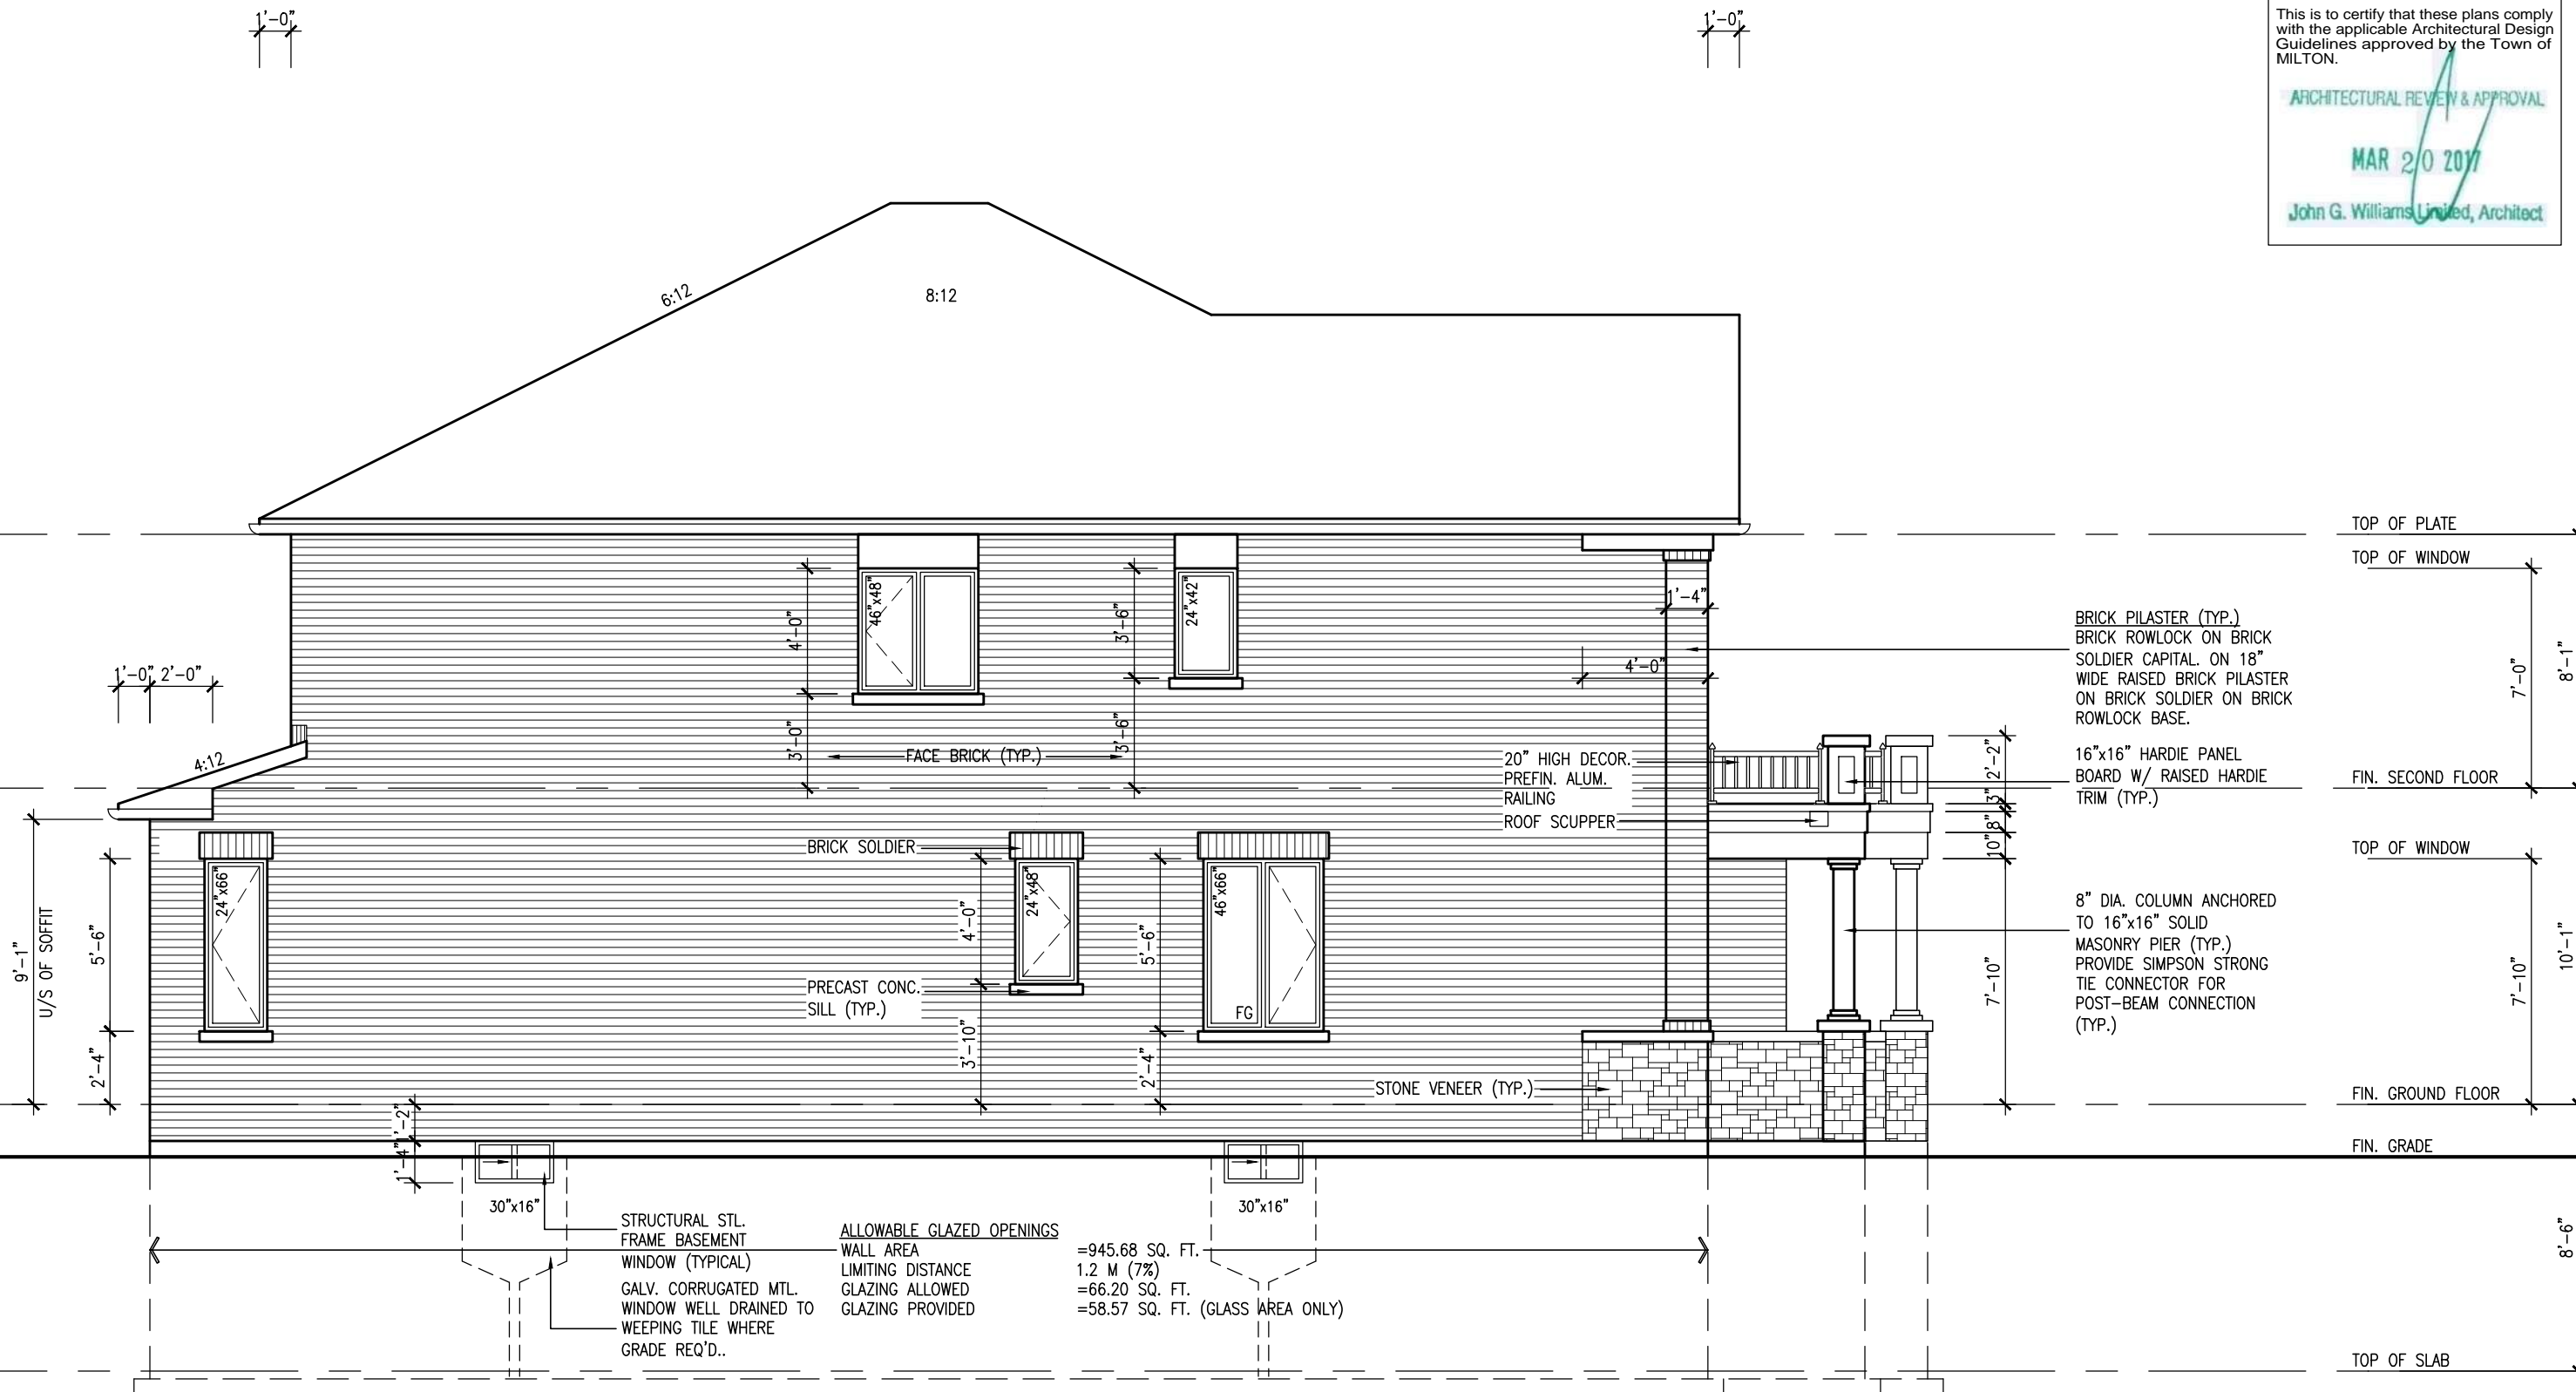IVY-7E
ENERGY STAR/ PANEL

TOWN OF MILTON
PLANNING AND DEVELOPMENT
IVY 7E MODEL

BUILDING: REVIEWED
SCOTT SHERRIFFS APR 19, 2017
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no.	description	date	by	Contractor must verify all dimensions on the job and report any discrepancy to the Designer before proceeding with the work. All drawings and specifications are instruments of service and the property of the Designer which must be returned at the completion of the work. Drawings are not to be scaled.

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va3design.com

Greenpark.

project name
LECCO RIDGE DEV. INC. MILTON, ONT.

date
JULY, 2016
drawn by
WT
checked by
scale
3/16" = 1'-0"

LEFT SIDE ELEVATION- ELEV. '2'

IVY-7E


project no.
16015

drawing no.
A5a


2284 SF.

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SECTION B

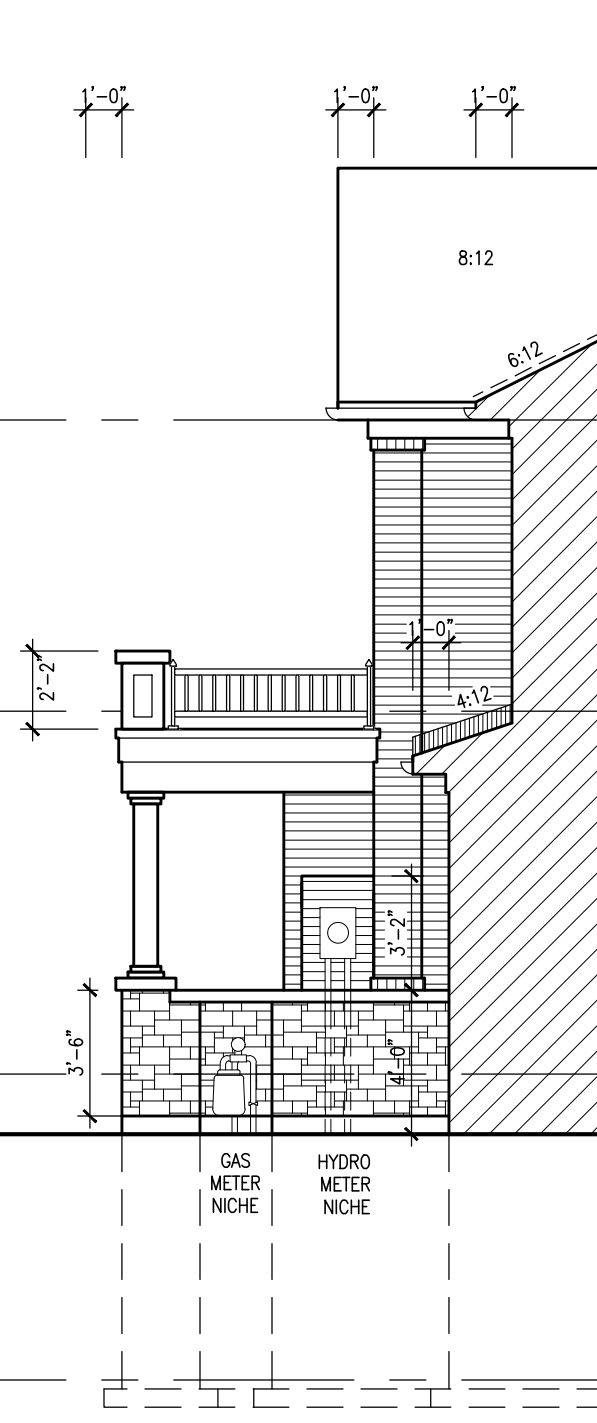

SECTION A-A ELEV. 2

TOP OF PLATE
TOP OF WINDOW
7'-0"
8'-1"
FIN. SECOND FLOOR
TOP OF WINDOW
7'-10"
10'-1"
FIN. GROUND FLOOR
FIN. GRADE
8'-6"
TOP OF SLAB

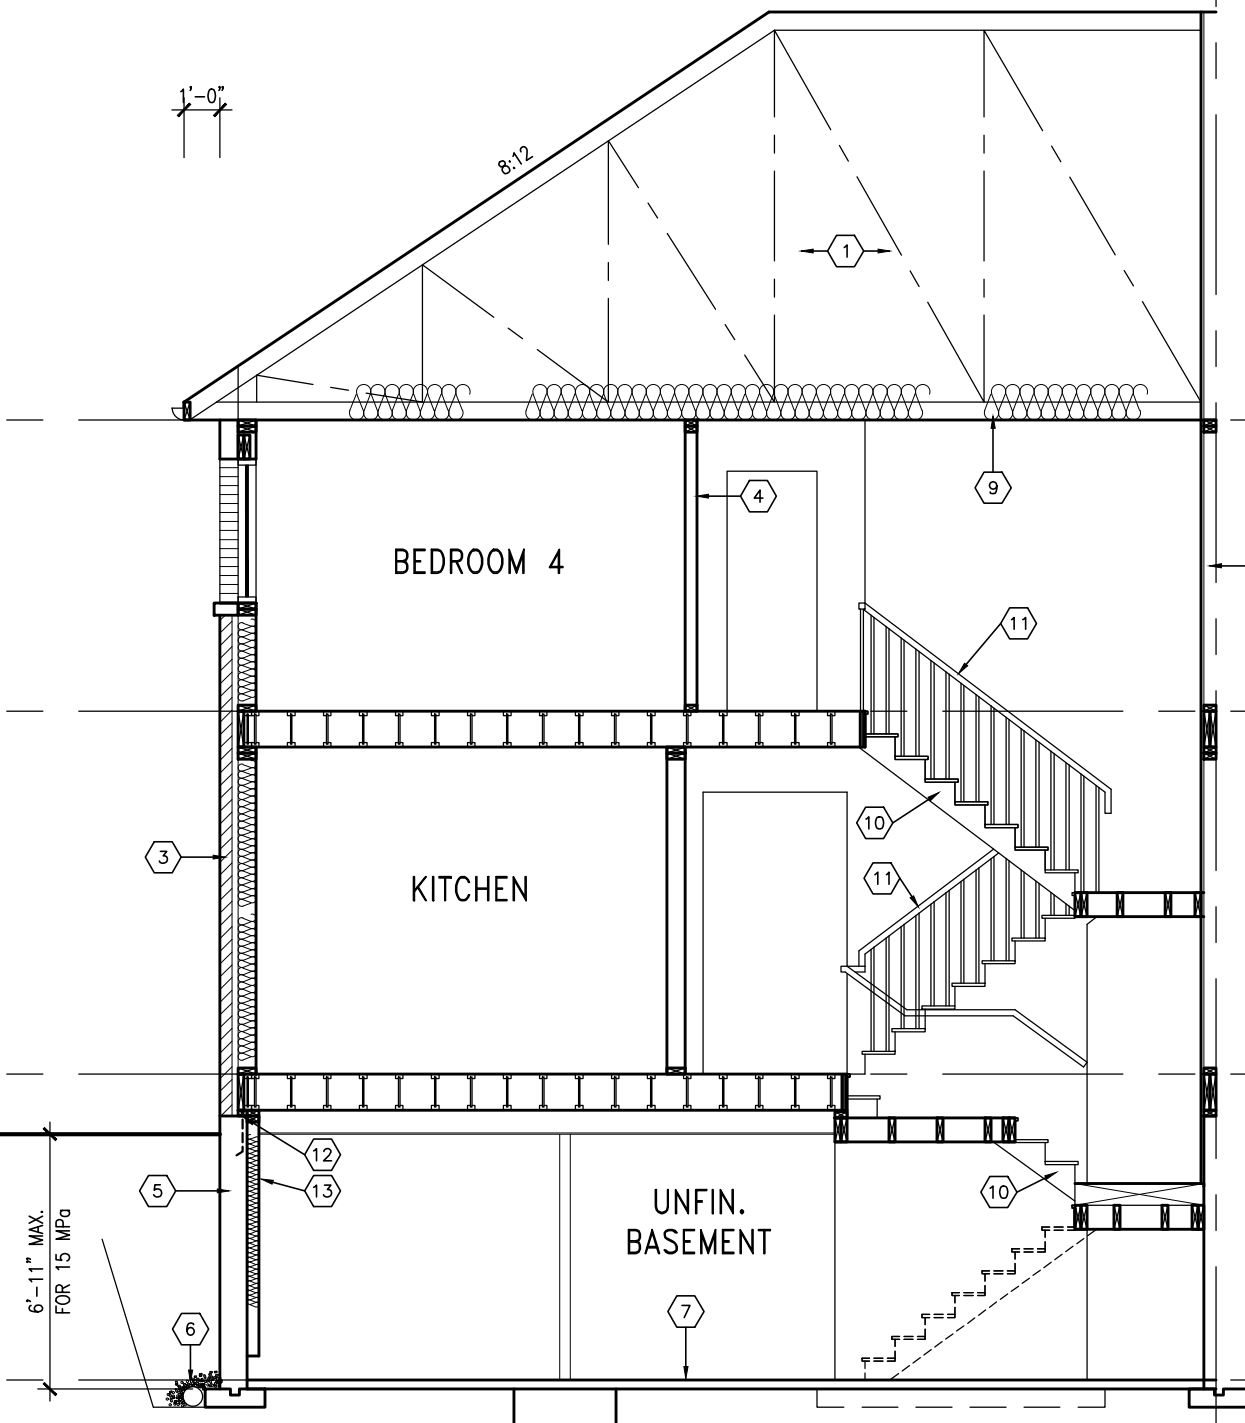IVY-7E
ENERGY STAR/ PANEL

TOWN OF MILTON
PLANNING AND DEVELOPMENT
IVY 7E MODEL
BUILDING: REVIEWED
SCOTT SHERRIFFS APR 19, 2017
PLANS EXAMINER DATE
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9	.	.	.	The undersigned has reviewed and takes responsibility for this design and has the qualifications and meets the requirements set out in the Ontario Building Code to be a Designer.
8	.	.	.	qualification information
7	REVISED PER BLDG. DEPT. COMMENTS.	APR. 10/17	GW	Richard Vink 24488
6	ISSUED FOR PERMIT.	MAR. 01/17	GW	signature BCIN
5	REVISED. ADD SUNKEN FOYER COND.	OCT 03/16	WT	VA3 Design Inc. 42658
4	2nd FLR WINDOW PANEL ADDED.	SEP 07/16	GW	
3	REPLACED PATIO DR. w/ DOOR & WINDOW	AUG 25/16	GW	
2	RELOCATE GAS/HYDRO METERS	AUG 22/16	GW	
1	ISSUED FOR CLIENT REVIEW	AUG. 08/16	GW	
no.	description	date	by	

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Greenpark.

project name **LECCO RIDGE DEV. INC.** municipality **MILTON, ONT.** project no. **16012**
date **JULY, 2016** checked by **WT** scale **3/16" = 1'-0"** file name **16015-IVY-7E**
drawing no. **A6a**
SECTION A-A ELEV. 1
GREG - H:\ARCHIVE\WORKING\2016\16015.GRE\UNITS\IVY\IVY-7E\16015-IVY-7E.dwg - Tue - Apr 11 2017 - 1:42 PM

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TOWN OF MILTON
MAR 29, 2017
IVY 7E
BUILDING DIVISION

The logo for the Town of Milton Planning and Development is located in the top left corner. It features a stylized 'M' inside a square frame, with the word 'MILTON' written vertically to its right. To the right of the logo, the text 'TOWN OF MILTON' is written in a large, bold, serif font. Below this, 'PLANNING AND DEVELOPMENT' is written in a smaller, bold, serif font. At the bottom right of the logo area, 'IVY 7E MODEL' is written in a bold, serif font.

2284 SF.

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ARCHITECTURAL REVIEW & APPROVAL

MAR 20 2017

John G. Williams Limited, Architect

= 1 HOUR PARTY WALL
(FIRE SEPARATION)

PARTY WALL DETAILS
See standard details page 4
for standard party wall
construction details

REAR ELEVATION ELEV. 2
DECK CONDITION (8R OR MORE)


DECK DETAILS
See standard details pages 5
and 5-2 for additional deck
construction details

ELEVATIONS NOT DRAWN TO ACTUAL GRADE.
REFER TO FINAL GRADING PLAN.


REAR ELEVATION ELEV. 2
DECK CONDITION (7R MAX.)

PRECAST STAIR/LANDING
Refer to master specifications
for anchorage details for
Parson's precast stair/landing

IVY-7E
ENERGY STAR/ PANEL

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7	REVISED PER BLDG. DEPT. COMMENTS.	APR. 10/17	GW		
6	ISSUED FOR PERMIT.	MAR. 01/17	GW	Richard Vink	2448-BC
5	REVISED. ADD SUNKEN FOYER COND.	OCT 03/16	WT	 signature	
4	2nd FLR WINDOW PANEL ADDED.	SEP 07/16	GW	name registration information VA5 Design Inc.	4265
3	REPLACED PATIO DR. w/ DOOR & WINDOW	AUG 25/16	GW		
2	RELOCATE GAS/HYDRO METERS	AUG 22/16	GW		
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no	description	date	by	Contractor must verify all dimensions on the job and report any discrepancy to the Designer before proceeding with the work. All drawings and specifications are instruments of service and the property of the Designer which must be returned at the completion of the work. Drawings are not to be scaled.	

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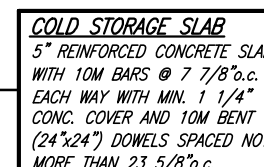
		<div>IVY-7E</div> <div>-</div>	
project name LECCO RIDGE DEV. INC.		municipality MILTON, ONT.	
date JULY, 2016		project no. 16015	
drawing no. REAR ELEVATION ELEV. 2 - DECK CONDITION		drawing no. <div>A8a</div>	
drawn by -		checked by scale 3/16" = 1'-0"	
file name 16015-IVY-7E			
WFG - H:\ARCHIVE\WORKING\2016\16015 GRF\UNITS\IVY-7E\16015-IVY-7E.dwg - Tue - Apr 11 2017 - 1:42 PM			

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2284 SF.

MAR 2/0 2017

John G. Williams Limited, Architect



ENGINEERED FLOOR SYSTEM
Reviewed model drawings to be read in conjunction with reviewed engineered floor system layout

IVY-7E

IVY-7E

project no.
16015

Drawing no.

drawing no.


A1b

ATL

REGISTERED PROFESSIONAL ENGINEER
B. MARINKOVIC
PROVINCE OF ONTARIO
STRUDET INC.
FOR STRUCTURE ONLY

9	.	.	.	The undersigned has reviewed and takes responsibility for this design and has the qualifications and meets the requirements set out in the Ontario Building Code to be a Designer.
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7	REVISED PER BLDG. DEPT. COMMENTS.	APR. 10/17	GW	qualification information
6	ISSUED FOR PERMIT.	MAR. 01/17	GW	Richard Vink 24488 BCIN
5	REVISED. ADD SUNKEN FOYER COND.	OCT 03/16	WT	signature <i>R Vink</i>
4	2nd FLR WINDOW PANEL ADDED.	SEP 07/16	GW	registration information V&S Design Inc. 42658
3	REPLACED PATIO DR. w/ DOOR & WINDOW	AUG 25/16	GW	
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1	ISSUED FOR CLIENT REVIEW	AUG. 08/16	GW	
no	description	date	by	

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 **Greenpark™**

Client name: **CCO RIDGE DEV. INC.** Municipality: **MILTON,**

Project: **BASEMENT**

Scale: **1" = 3'-0"**

Drawn by: **—** Checked by: **—** Scale: **1" = 3'-0"**

File path: **H:\ARCHIVE\WORKING\2016\16015 (CRF)\UNITS\16015-NY-7E.dwg**

IVY-7E	
-	
locality	project no.
INT.	16015
PLAN - ELEV. '3'	
drawing no.	
file name	
16015-IVY-7E	
A1b	
Tue - Apr 11 2017 - 1:42 PM	

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ARCHITECTURAL REVIEW & APPROVAL
MAR 20 2017
John G. Williams, Architect

= 1 HOUR PARTY WALL
(FIRE SEPARATION)

PARTY WALL DETAILS
See standard details page 4
for standard party wall
construction details

GARAGE AIR BARRIER
Garage walls/ceiling required to
include an air barrier system. Gypsum
board used as an air barrier requires
all joints to be sealed with tape and a
minimum 1 coat of compound

GARAGE DOOR
Requires weatherstripping
and a self closing device

GUARDS/HANDRAILS
Shall be provided on
porches as required
based on final lot grading

ENGINEERED FLOOR SYSTEM
Reviewed model drawings to be
read in conjunction with reviewed
engineered floor system layout

TOWN OF MILTON
PLANNING AND DEVELOPMENT
IVY 7E MODEL

BUILDING: REVIEWED
SCOTT SHERRIFFS APR 19, 2017
PLANS EXAMINER DATE

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By-laws of the Region of Halton and Town of Milton

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BUILDING DIVISION

ENGINEERED FLOOR SUBFLOORS
ALL SUBFLOORS TO BE 5/8" PLYWOOD AND TO
BE GLUED AND NAILED ON THIS FLOOR FOR
ENGINEERED JOIST ONLY.



9	REVISED PER BLDG. DEPT. COMMENTS.	APR. 10/17	GW
8	ISSUED FOR PERMIT.	MAR. 01/17	GW
7	REPLACED PATIO DR. w/ DOOR & WINDOW	AUG 25/16	GW
6	2nd FLR WINDOW PANEL ADDED.	SEP 07/16	GW
5	RELOCATE GAS/HYDRO METERS	AUG 22/16	GW
4	ISSUED FOR CLIENT REVIEW	AUG. 08/16	GW
3			
2			
1			
no.	description	date	by

The undersigned has reviewed and takes responsibility for this design and has the qualifications and meets the requirements set out in the Ontario Building Code to be a Designer.

Richard Vink
signature
24488
BCIN
VA3 Design Inc.
42658

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Greenpark.

project name
LECCO RIDGE DEV. INC.

municipality
MILTON, ONT.

project no.
16015

date
JULY, 2016

checked by
scale
3/16" = 1'-0"


file name
16015-IVY-7E

drawing no.
A2b

GROUND FLOOR PLAN - ELEV. '3'

IVY-7E
ENERGY STAR/ PANEL

GROUND FLOOR PLAN - ELEV. '3'

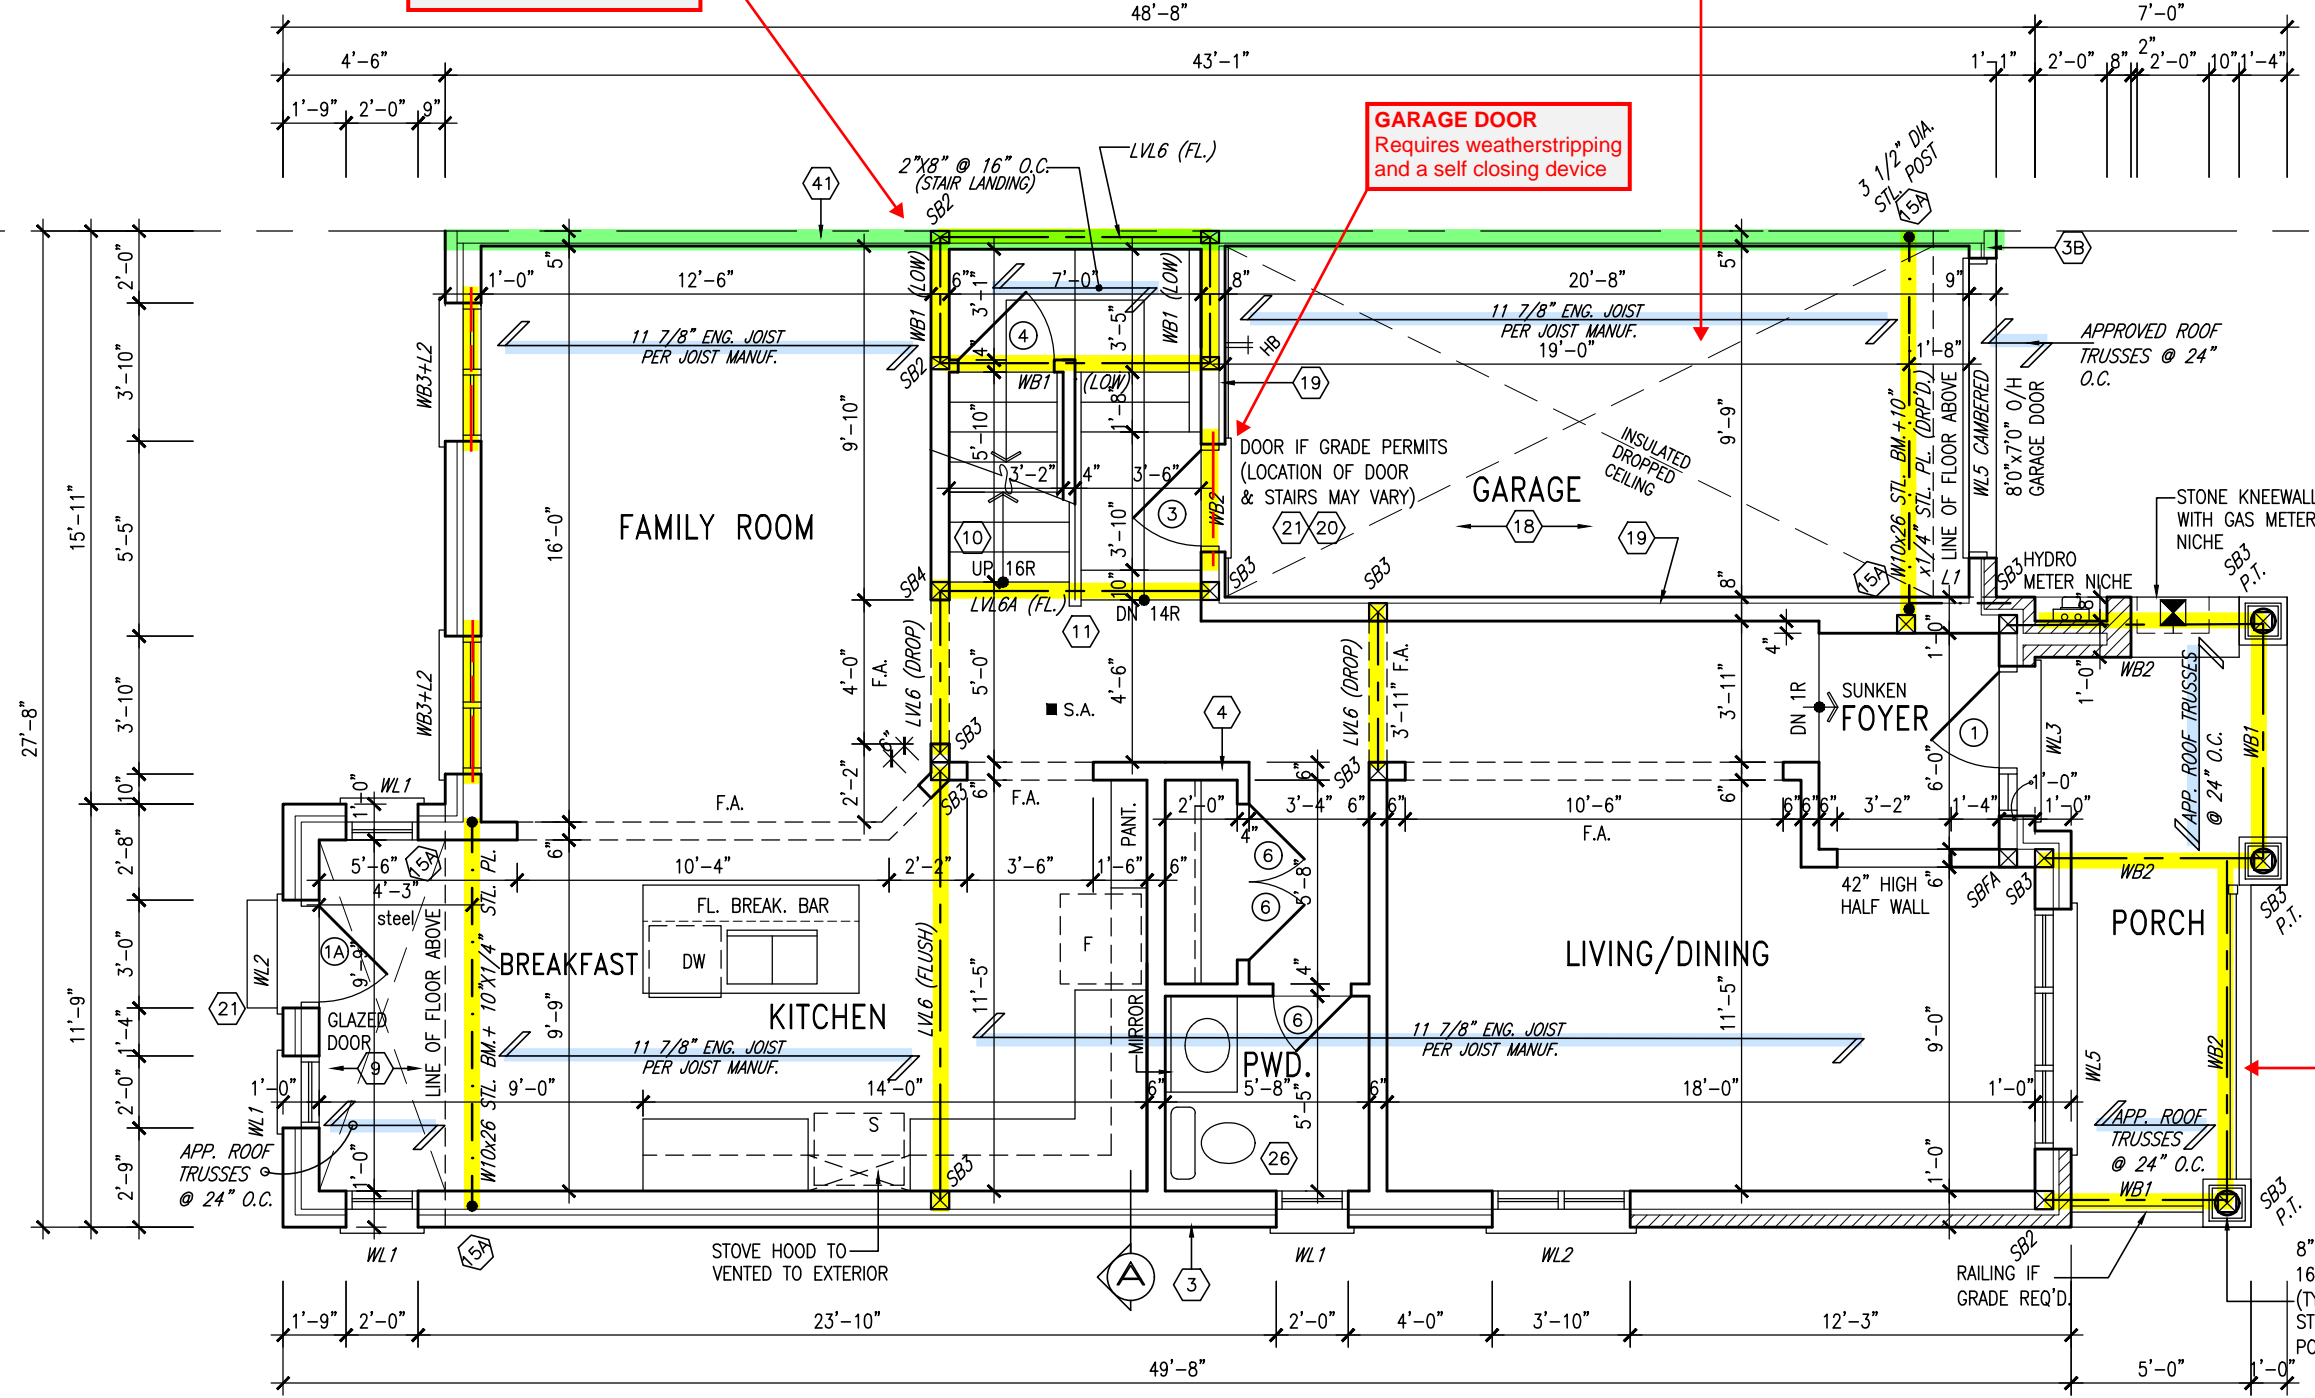

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ARCHITECTURAL REVIEW & APPROVAL

MAR 20 2017

John G. Williams Limited, Architect



BATHROOM BLOCKING
See standard details page 8
for required main bathroom
grab bar reinforcing

STUD WALL REINFORCEMENT FOR FUTURE GRAB BARS IN MAIN BATHROOM
REINFORCEMENT OF STUD WALLS SHALL BE INSTALLED ADJACENT TO WATER CLOSETS AND SHOWER OR BATHTUB IN MAIN BATHROOM. REFER TO OBC. 9.5.2.3, 3.8.3.8.(1)(d) & 3.8.3.13.(1)(f).

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8	.	.	.	Ontario Building Code to be a Designer.
7	REVISED PER BLDG. DEPT. COMMENTS.	APR. 10/17	GW	clification information
6	ISSUED FOR PERMIT.	MAR. 01/17	GW	Richard Vink 2448
5	REVISED. ADD SUNKEN FOYER COND.	OCT 03/16	WT	name BC
4	2nd FLR WINDOW PANEL ADDED.	SEP 07/16	GW	registration information signature
3	REPLACED PATIO DR. w/ DOOR & WINDOW	AUG 25/16	GW	VA3 Design Inc. 4265
2	RELOCATE GAS/HYDRO METERS	AUG 22/16	GW	Contractor must verify all dimensions on the job and report any discrepancy to the Designer before proceeding with the work. All drawings and specifications are instruments of service and the property of the Designer which must be returned at the completion of the work.
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project name	municipality	project no.
LECCO RIDGE DEV. INC.	MILTON, ONT.	16015
date		drawing no.
JULY, 2016		33
SECOND FLOOR PLAN - LECCO		
drawn by	checked by	scale
WT	-	3/16" = 1'-0"
file name		A3b
16015-IY-7E		
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= 1 HOUR PARTY WALL
(FIRE SEPARATION)

PARTY WALL DETAILS
See standard details page 4
for standard party wall
construction details

ROOF PLAN '3'

ASPHALT SHINGLES (TYP.)
VALLEY FLASHING (TYP.)

REAR ELEVATION '3'

FRONT ELEVATION '3'

GUARDS/HANDRAILS
Shall be provided on
porches as required
based on final lot grading

TOWN OF MILTON
PLANNING AND DEVELOPMENT
IVY 7E MODEL

BUILDING: REVIEWED
SCOTT SHERRIFFS APR 19, 2017
PLANS EXAMINER DATE

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BUILDING DIVISION

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7	REVISED PER BLDG. DEPT. COMMENTS.	APR. 10/17	GW	Richard Vink 24488
6	ISSUED FOR PERMIT.	MAR. 01/17	GW	signature BCIN
5	REVISED. ADD SUNKEN FOYER COND.	OCT 03/16	WT	name registration information
4	2nd FLR WINDOW PANEL ADDED.	SEP 07/16	GW	VA3 Design Inc. 42658
3	REPLACED PATIO DR. w/ DOOR & WINDOW	AUG 25/16	GW	Contractor must verify all dimensions on the job and report any discrepancy to the Designer before proceeding with the work. All drawings and specifications are instruments of service and the property of the Designer which must be returned at the completion of the work. Drawings are not to be scaled.
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1	ISSUED FOR CLIENT REVIEW	AUG. 08/16	GW	
no.	description	date	by	

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t 416.630.2255 f 416.630.4782
va3design.com

Greenpark.

project name
LECCO RIDGE DEV. INC.

date
JULY, 2016

checked by
WT

scale
3/16" = 1'-0"

file name
16015-IVY-7E

IVY-7E
ENERGY STAR/ PANEL

IVY-7E

project no.
16015

drawing no.
A4b

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ARCHITECTURAL REVIEW & APPROVAL
MAR 20 2017
John G. Williams Limited, Architect



 Greenpark™		IVY-7E -	
project name	ECCO RIDGE DEV. INC.	municipality	MILTON, ONT.
project no.	16015		
date	JULY, 2016		LEFT SIDE ELEVATION - ELEV. '3'
drawn by	checked by	scale	file name
-	-	3/16" = 1'-0"	16015-IVY-7E
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drawing no.			A5b


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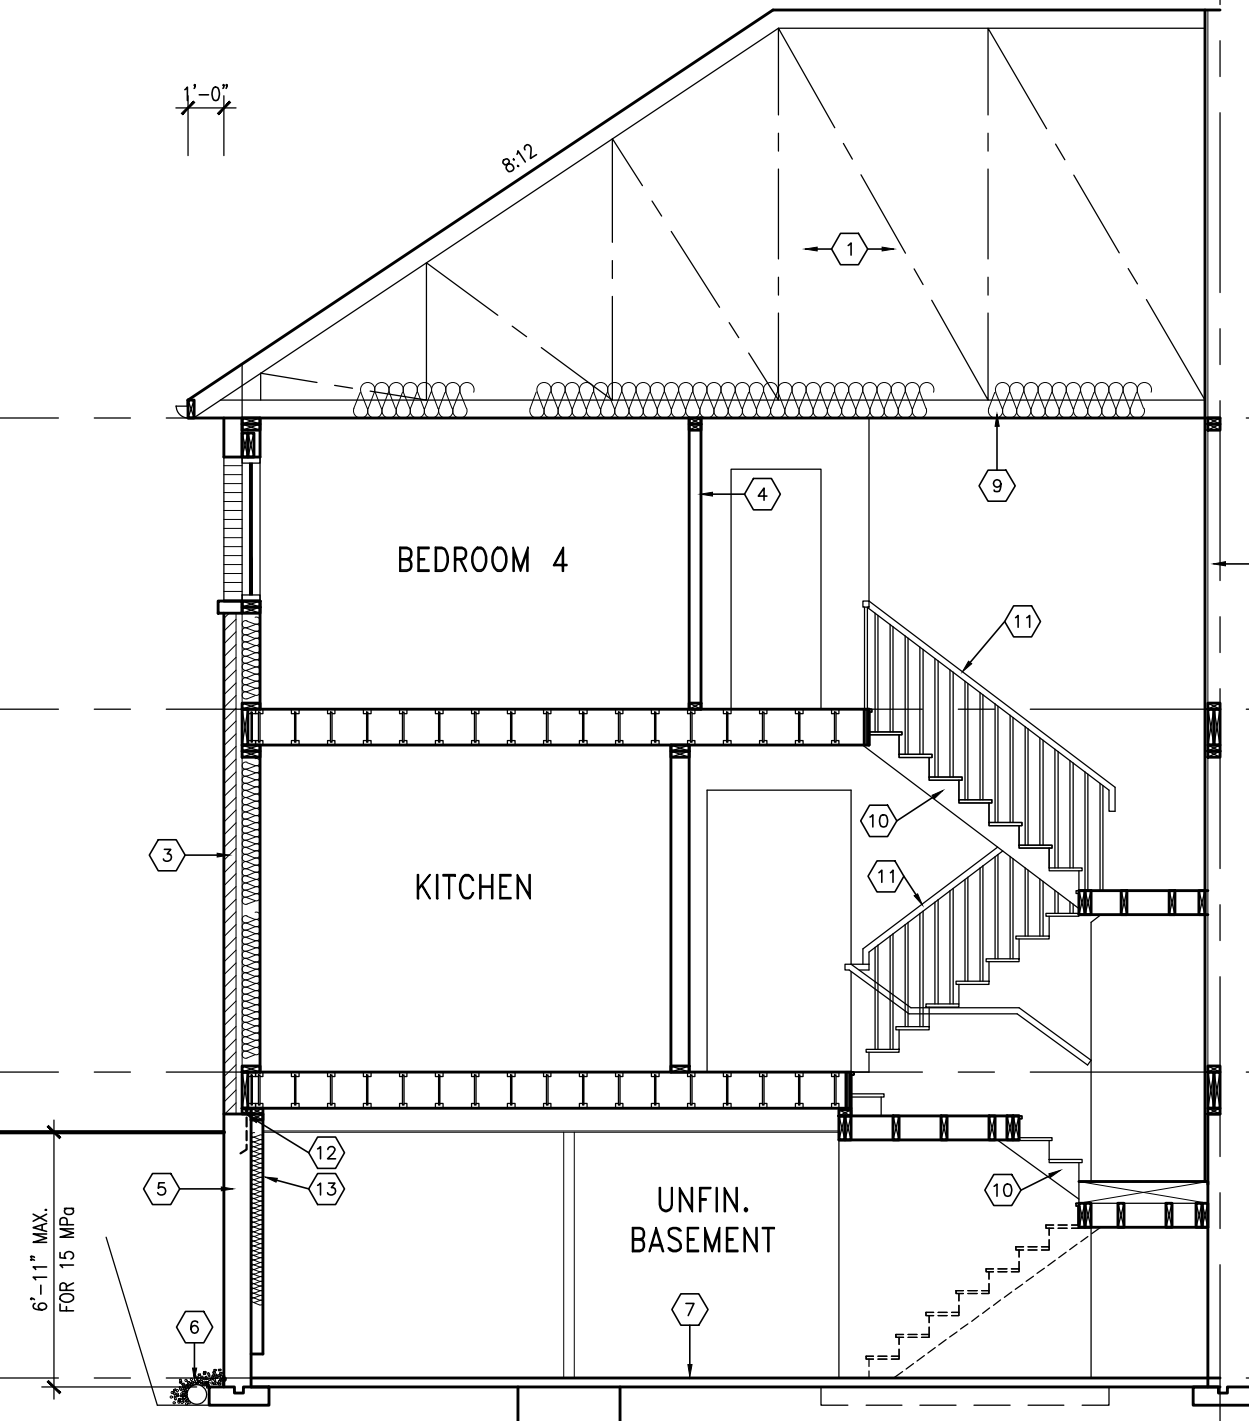
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STONE TO BRICK TRANSITION DETAIL



SECTION B



SECTION A-A ELEV. 3

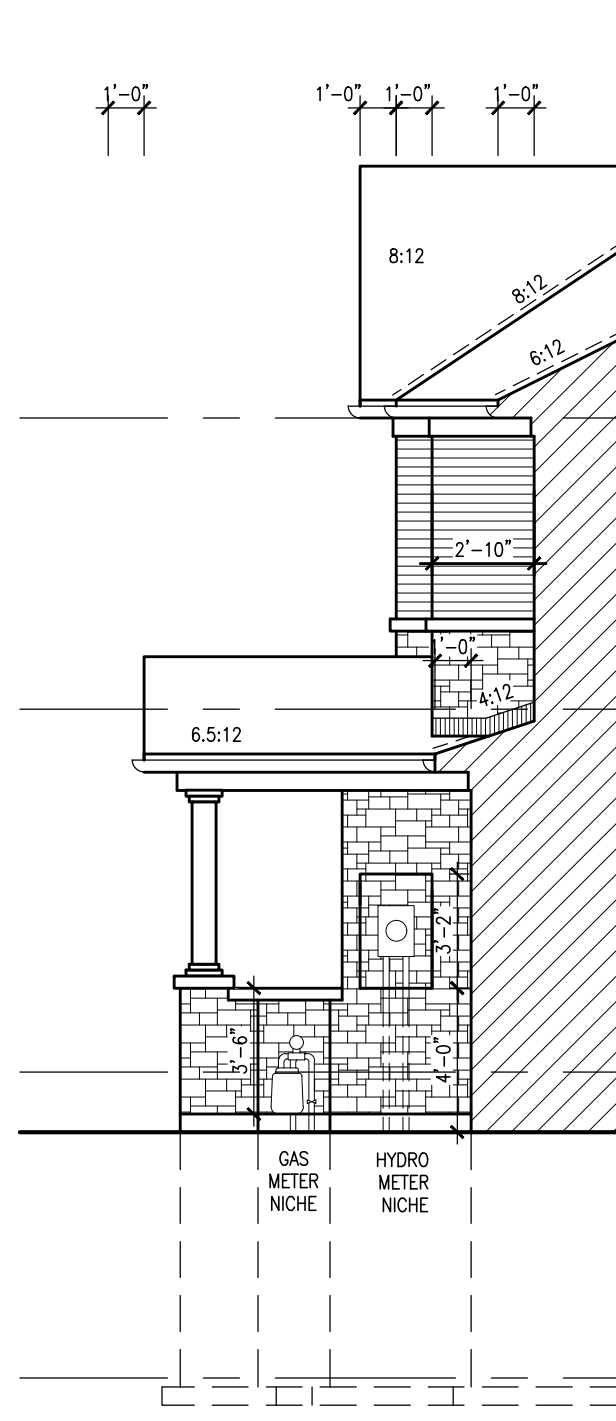IVY-7E
ENERGY STAR/ PANEL

TOWN OF MILTON
PLANNING AND DEVELOPMENT
IVY 7E MODEL

BUILDING: REVIEWED
SCOTT SHERRIFFS APR 19, 2017
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MAR 29, 2017
IVY 7E
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9	ISSUED FOR PERMIT.	MAR. 01/17	GW	qualification information	Richard Vink	24488
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6	ISSUED FOR PERMIT.	MAR. 01/17	GW	registration information	VA3 Design Inc.	42658
5	REVISED. ADD SUNKEN FOYER COND.	OCT 03/16	WT			
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Greenpark.
project name
LECCO RIDGE DEV. INC.
municipality
MILTON, ONT.

IVY-7E
project no.
16015
drawing no.
A6b
SECTION A-A ELEV. 3
date
JULY, 2016
drawn by
WT
checked by
scale
3/16" = 1'-0"
file name
16015-IVY-7E
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