

10018.00 S.F. (930.70 m2)

90 KPa. ENGINEERED FILL SOIL .F1 = 42"x42"x18" CONCRETE PAD F1 = 48"x48"x20" CONCRETE P 2 = 36"x36"x16" CONCRETE PAD F2 = 40"x40"x16" CONCRETE PA F4 = 24"x24"x12" CONCRETE PAD F4 = 28"x28"x12" CONCRETE PAD

REFER TO FLOOR PLAN FOR UNUSUAL SIZE PADS NOT ON CHART.) STRIP FOOTINGS - FOR 2 STOREY TOWNHOUSES

FOOTINGS ON NATIVE SOIL (120 kPa.)

24"x8" CONCRETE STRIP FOOTINGS BELOW EXTERIOR WALLS (UNLESS

24"x8" CONCRETE STRIP FOOTINGS (with REINF.) BELOW PARTY WALLS. 32"x8" CONCRETE STRIP FOOTINGS (with REINF.) BELOW FIRE WALLS. FOOTINGS ON ENGINEERED FILL (90 kPa.) 24"x8" CONCRETE STRIP FOOTINGS—with REINFOREMENT, AS NOTED ON PLAN

32"x8" CONCRETE STRIP FOOTINGS BELOW EXTERIOR WALLS—with REINFORCEMENT (UNLESS OTHERWISE NOTED). 32"x8" CONCRETE STRIP FOOTINGS— with REINFORCEMENT BELOW PARTY WALLS 44"x8" CONCRETE STRIP FOOTINGS - with REINFORCEMENT BELOW FIRE WALLS

ASSUME 120kPa/17.4psi SOIL BEARING CAPACITY FOR NATIVE SOIL SOIL BEARING TO BE VERIFIED ON-SITE BY SOILS ENGINEER.

WHEN VENEER CUT IS GREATER THAN 26", A 10" POURED CONCRETE FOUNDATION WALL IS

REFER TO INDIVIDUAL UNITS

-BASEMENT AND GROUND

-GROUND FLOOR AND


-DOUBLE VOLUME WALL LOCATION AND DETAILS

SECOND FLOOR LINTELS

OVERLAP OF DEMISING LINE/

SUMP PUMP LOCATION



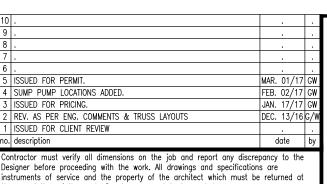

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Ontario Building Code to be a Designer.
qualification information
Richard Vink
name
resistration information

***Greenpark**...

BLOCK 34 BLOCK 343 PLAN 1/8" = 1'-0"
file name
16015-BLOCK-343

drawing no.
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REVISION CLOUD INDICATES CONDITION THAT DIFFERS FROM STANDARD UNIT

BUILDING AREA

10018.00 S.F. (930.70 m2)

PAD FOOTINGS 120 KPa. NATIVE SOIL 90 KPa. ENGINEERED FILL SOIL $\overline{F1} = 42\text{"x}42\text{"x}18\text{" CONCRETE PAD } \overline{F1} = 48\text{"x}48\text{"x}20\text{" CONCRETE PAD } \overline{F1} = 48\text{"x}20\text{" CONCRETE PAD } \overline{F1} = 48\text{"x}20\text{" CONCRETE PAD } \overline{F1} = 48\text{"x}20\text{" CONCRETE PAD } \overline$ F2 = 36"x36"x16" CONCRETE PAD F2 = 40"x40"x16" CONCRETE PAD F3 = 30"x30"x12" CONCRETE PAD F3 = 34"x34"x14" CONCRETE PAD

F4 = 24"x24"x12" CONCRETE PAD F4 = 28"x28"x12" CONCRETE PAD F5 = 16"x16"x8" CONCRETE PAD F5 = 18"x18"x8" CONCRETE PAD REFER TO FLOOR PLAN FOR UNUSUAL SIZE PADS NOT ON CHART.)

STRIP FOOTINGS - FOR 2 STOREY TOWNHOUSES FOOTINGS ON NATIVE SOIL (120 kPa.)

20"x6" CONCRETE STRIP FOOTINGS AS NOTED ON PLAN 24"x8" CONCRETE STRIP FOOTINGS BELOW EXTERIOR WALLS (UNLESS

24"x8" CONCRETE STRIP FOOTINGS (with REINF.) BELOW PARTY WALLS.

32"x8" CONCRETE STRIP FOOTINGS (with REINF.) BELOW FIRE WALLS. FOOTINGS ON ENGINEERED FILL (90 kPa.) 24"x8" CONCRETE STRIP FOOTINGS—with REINFOREMENT, AS NOTED ON PLAN 32"x8" CONCRETE STRIP FOOTINGS BELOW EXTERIOR WALLS—with REINFORCEMENT (UNLESS OTHERWISE NOTED).

32"x8" CONCRETE STRIP FOOTINGS- with REINFORCEMENT BELOW PARTY WALLS. 44"x8" CONCRETE STRIP FOOTINGS - with REINFORCEMENT BELOW FIRE WALLS. (REFER TO FOOTING DETAIL FOR REINFORCEMENT)

ASSUME 120kPa/17.4psi SOIL BEARING CAPACITY FOR NATIVE SOIL OR 90kPa/ 13.0psi FOR ENGINEERED FILL. SOIL BEARING TO BE VERIFIED ON—SITE BY SOILS ENGINEER.

<u>VENEER CUT</u>

WHEN VENEER CUT IS GREATER THAN 26", A 10" POURED CONCRETE FOUNDATION WALL IS REQUIRED.

<u>REFER TO INDIVIDUAL UNITS</u> FOR THE FOLLOWING

-GROUND FLOOR ROOF STRUCTURE

-BASEMENT AND GROUND FLOOR LINTELS -GROUND FLOOR AND

SECOND FLOOR STRUCTURE -DOUBLE VOLUME WALL LOCATION AND DETAILS

-CONCRETE SLABS

ROOF TRUSSES AND SECOND FLOOR LINTELS SHOWN ON BLOCK PLANS

SOFFIT VENTING

= 1 HOUR PARTY WALL

(FIRE SEPARATION)


PARTY WALL DETAILS

or standard party wall onstruction details

ee standard details page

NO SOFFIT VENTING AT ROOF OVERLAP OF DEMISING LINE/ PARTY WALL.



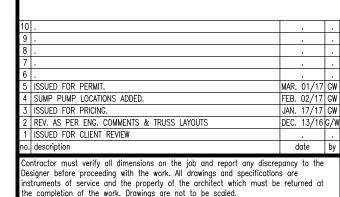



DESIGN.


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LECCO RIDGE DEV. INC.

BLOCK 34 BLOCK 343 PLAN 1/8" = 1'-0"
16015-BLOCK-343

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GROUND FLOOR PLAN

iewed townhouse block drawings to be ead in conjunction with reviewed townhouse odel drawings and engineered truss syster **ENERAL NOTES/CONSTRUCTION DETAILS** viewed model drawings to be read in junction with reviewed general notes,

ructions details and specifications

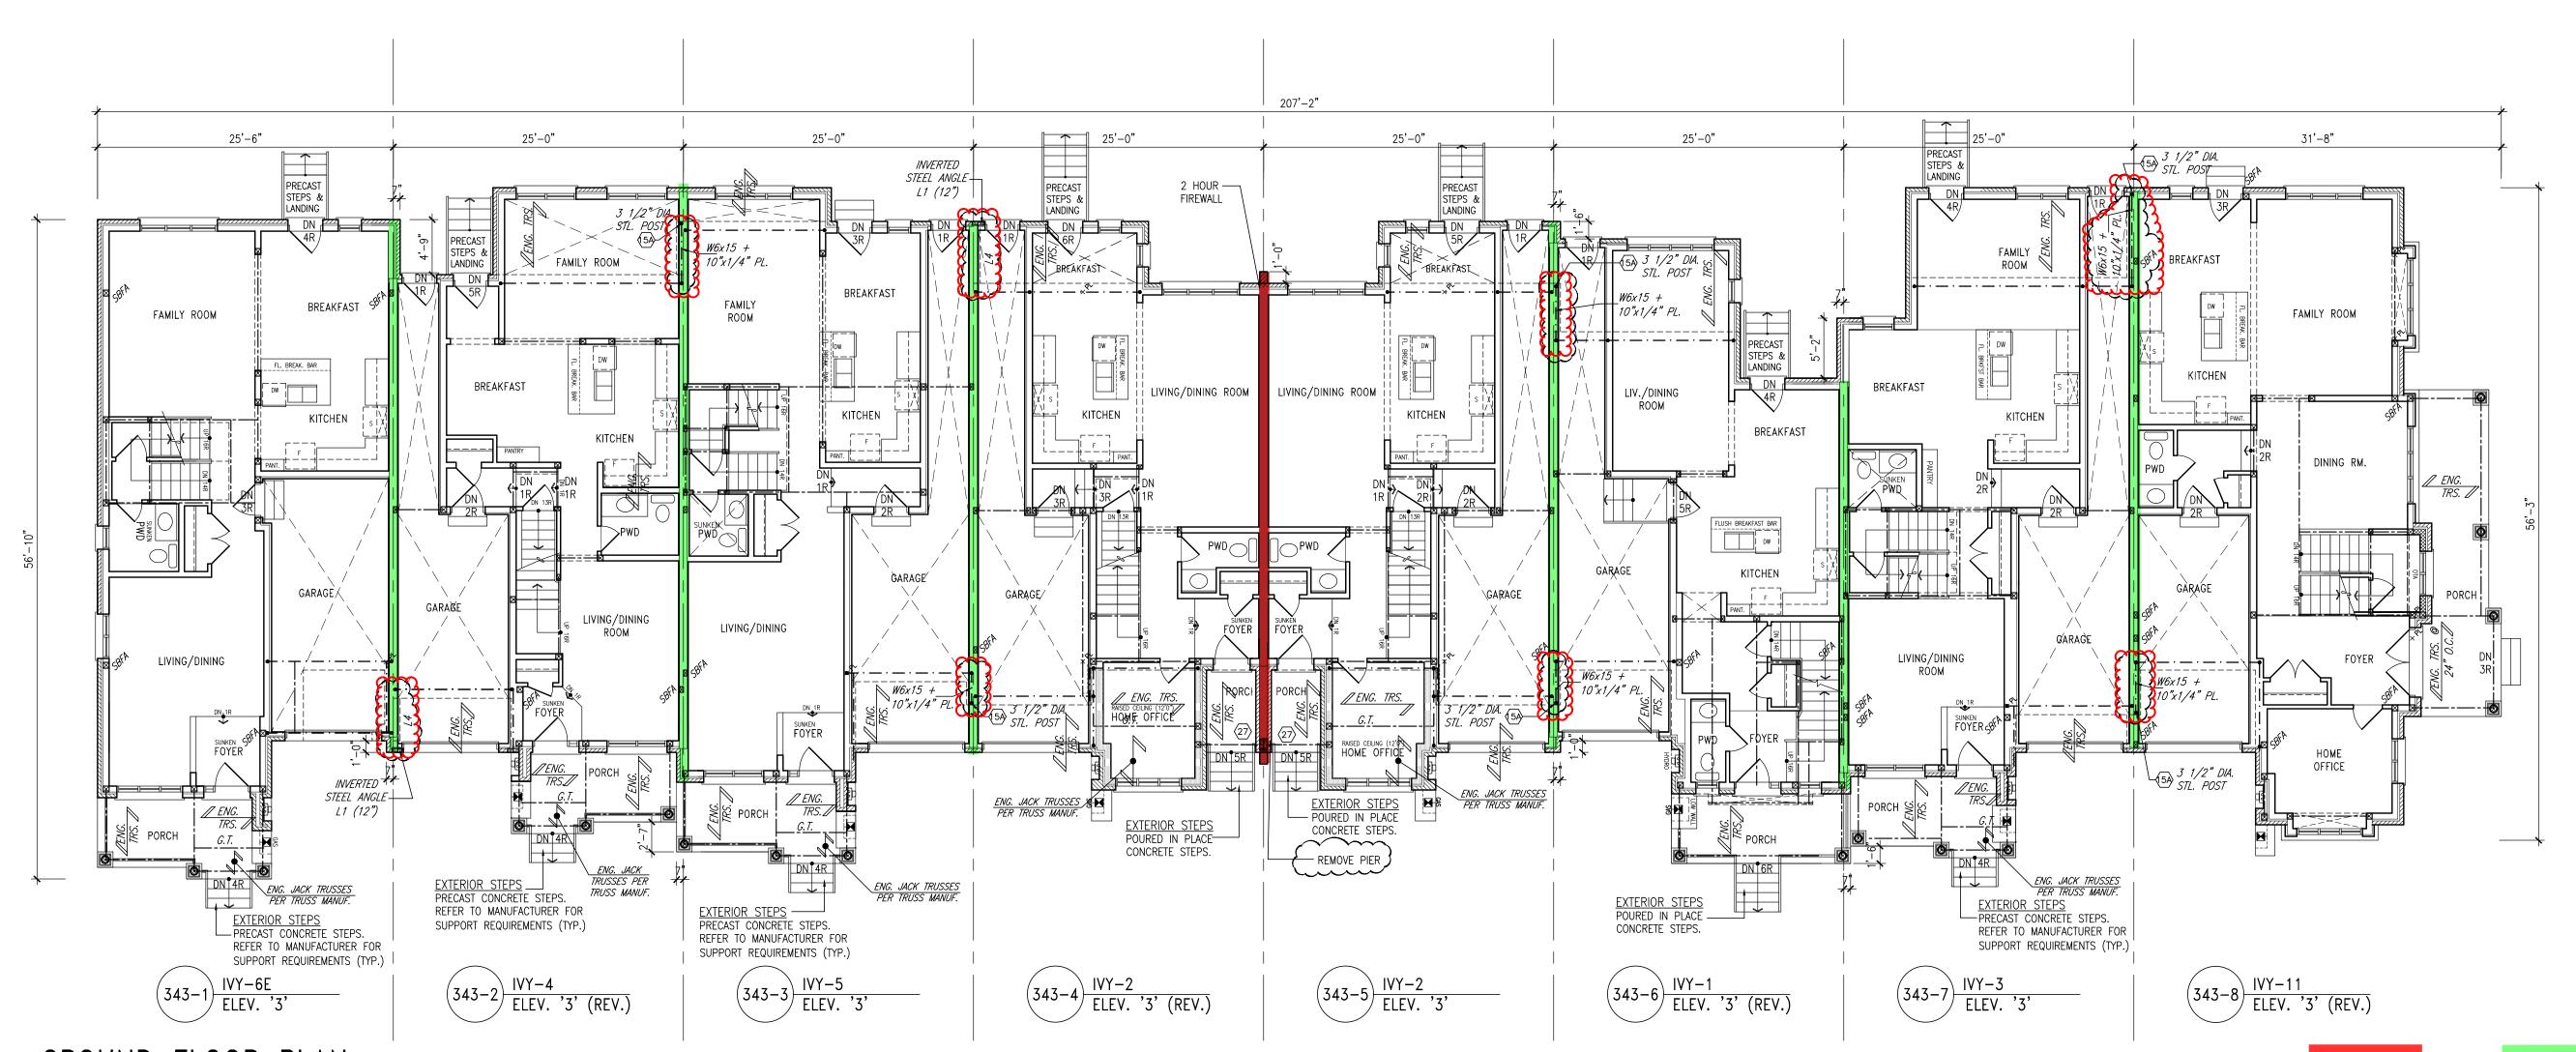

BLOCK 343 ELEVATION

(NON-COMBUSTIBLE)

FIREWALL DETAILS

for standard firewall construction details

See standard details page



