


BASEMENT PLAN

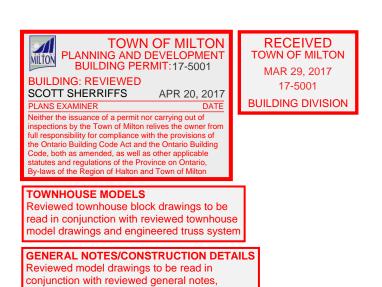


uctions details and specifications

RAINAGE AND WEEPING TILE \ arating basement space from cavated areas (under porches an

= 2 HOUR FIREWALL (NON-COMBUSTIBLE) EWALL DETAILS e standard details page 5

= 1 HOUR PARTY WALL (FIRE SEPARATION) PARTY WALL DETAILS See standard details page 4 for standard party wall construction details



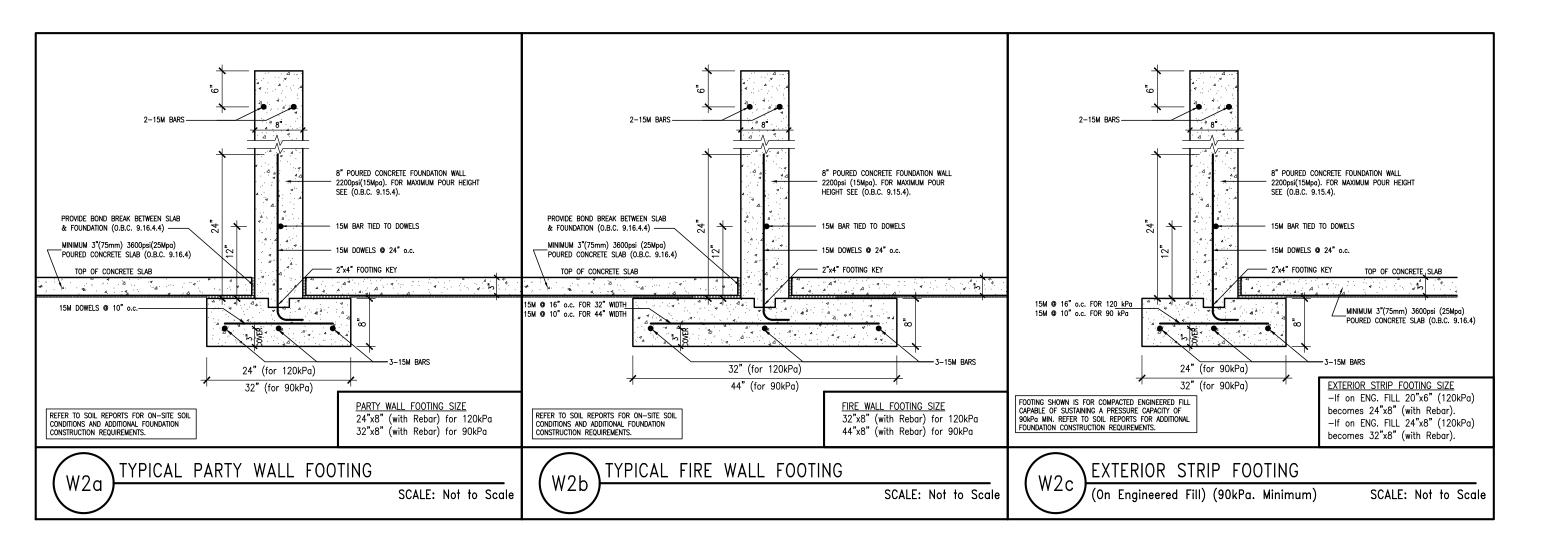

REFER TO GRADING PLAN FOR NUMBER OF STEPS.

BLOCK 329 ELEVATION

BUILDING AREA 8863.29 S.F. (823.42 m2)

PAD FOOTINGS 120 KPa. NATIVE SOIL 90 KPa. ENGINEERED FILL SOIL F1 = 42"x42"x18" CONCRETE PAD F1 = 48"x48"x20" CONCRETE P F2 = 36"x36"x16" CONCRETE PAD F2 = 40"x40"x16" CONCRETE PAD F3 = 30"x30"x12" CONCRETE PAD F3 = 34"x34"x14" CONCRETE PAD F5 = 16"x16"x8" CONCRETE PAD F5 = 18"x18"x8" CONCRETE PAD REFER TO FLOOR PLAN FOR UNUSUAL SIZE PADS NOT ON CHART.)

STRIP FOOTINGS — FOR 2 STOREY TOWNHOUSES

<u>FOOTINGS ON NATIVE SOIL (120 kPa.)</u> 20"x6" CONCRETE STRIP FOOTINGS AS NOTED ON PLAN

24"x8" CONCRETE STRIP FOOTINGS BELOW EXTERIOR WALLS (UNLESS OTHERWISE NOTED). 24"x8" CONCRETE STRIP FOOTINGS (with REINF.) BELOW PARTY WALLS.

32"x8" CONCRETE STRIP FOOTINGS (with REINF.) BELOW FIRE WALLS. FOOTINGS ON ENGINEERED FILL (90 kPa.) 24"x8" CONCRETE STRIP FOOTINGS—with REINFOREMENT, AS NOTED ON PLAN 32"x8" CONCRETE STRIP FOOTINGS BELOW EXTERIOR WALLS—with REINFORCEMENT (UNLESS OTHERWISE NOTED).

32"x8" CONCRETE STRIP FOOTINGS— with REINFORCEMENT BELOW PARTY WALLS 44"x8" CONCRETE STRIP FOOTINGS - with REINFORCEMENT BELOW FIRE WALLS. (REFER TO FOOTING DETAIL FOR REINFORCEMENT)

ASSUME 120kPa/17.4psi SOIL BEARING CAPACITY FOR NATIVE SOIL OR 90kPa/ 13.0psi FOR ENGINEERED FILL. SOIL BEARING TO BE VERIFIED ON—SITE BY SOILS ENGINEER.

<u>VENEER CUT</u>

WHEN VENEER CUT IS GREATER THAN 26", A 10" POURED CONCRETE FOUNDATION WALL IS REQUIRED.

REFER TO INDIVIDUAL UNITS FOR THE FOLLOWING -GROUND FLOOR ROOF

STRUCTURE

-BASEMENT AND GROUND FLOOR LINTELS

-GROUND FLOOR AND SECOND FLOOR STRUCTURE

-DOUBLE VOLUME WALL

LOCATION AND DETAILS -CONCRETE SLABS


ROOF TRUSSES AND


SECOND FLOOR LINTELS SHOWN ON BLOCK PLANS

SOFFIT VENTING NO SOFFIT VENTING AT ROOF

OVERLAP OF DEMISING LINE/ PARTY WALL.

SUMP PUMP LOCATION

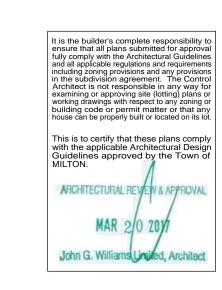

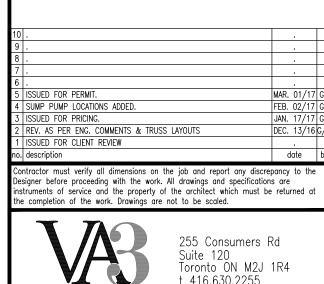



t 416.630.2255 f 416.630.4782

All drawings specifications, related documents and design are the copyright property of VA3 DESIGN. Reproduction of this property in whole or in part is strictly prohibited without VA3 DESIGN's written permission. Ontorio Building Code to be a Designer.
qualification information
Richard Vink
name
remistration information

LECCO RIDGE DEV. INC.

BLOCK 32 BLOCK 329 PLAI 1/8" = 1'-0" drawing no.
16015-BLOCK-329

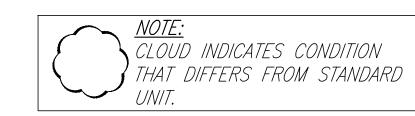

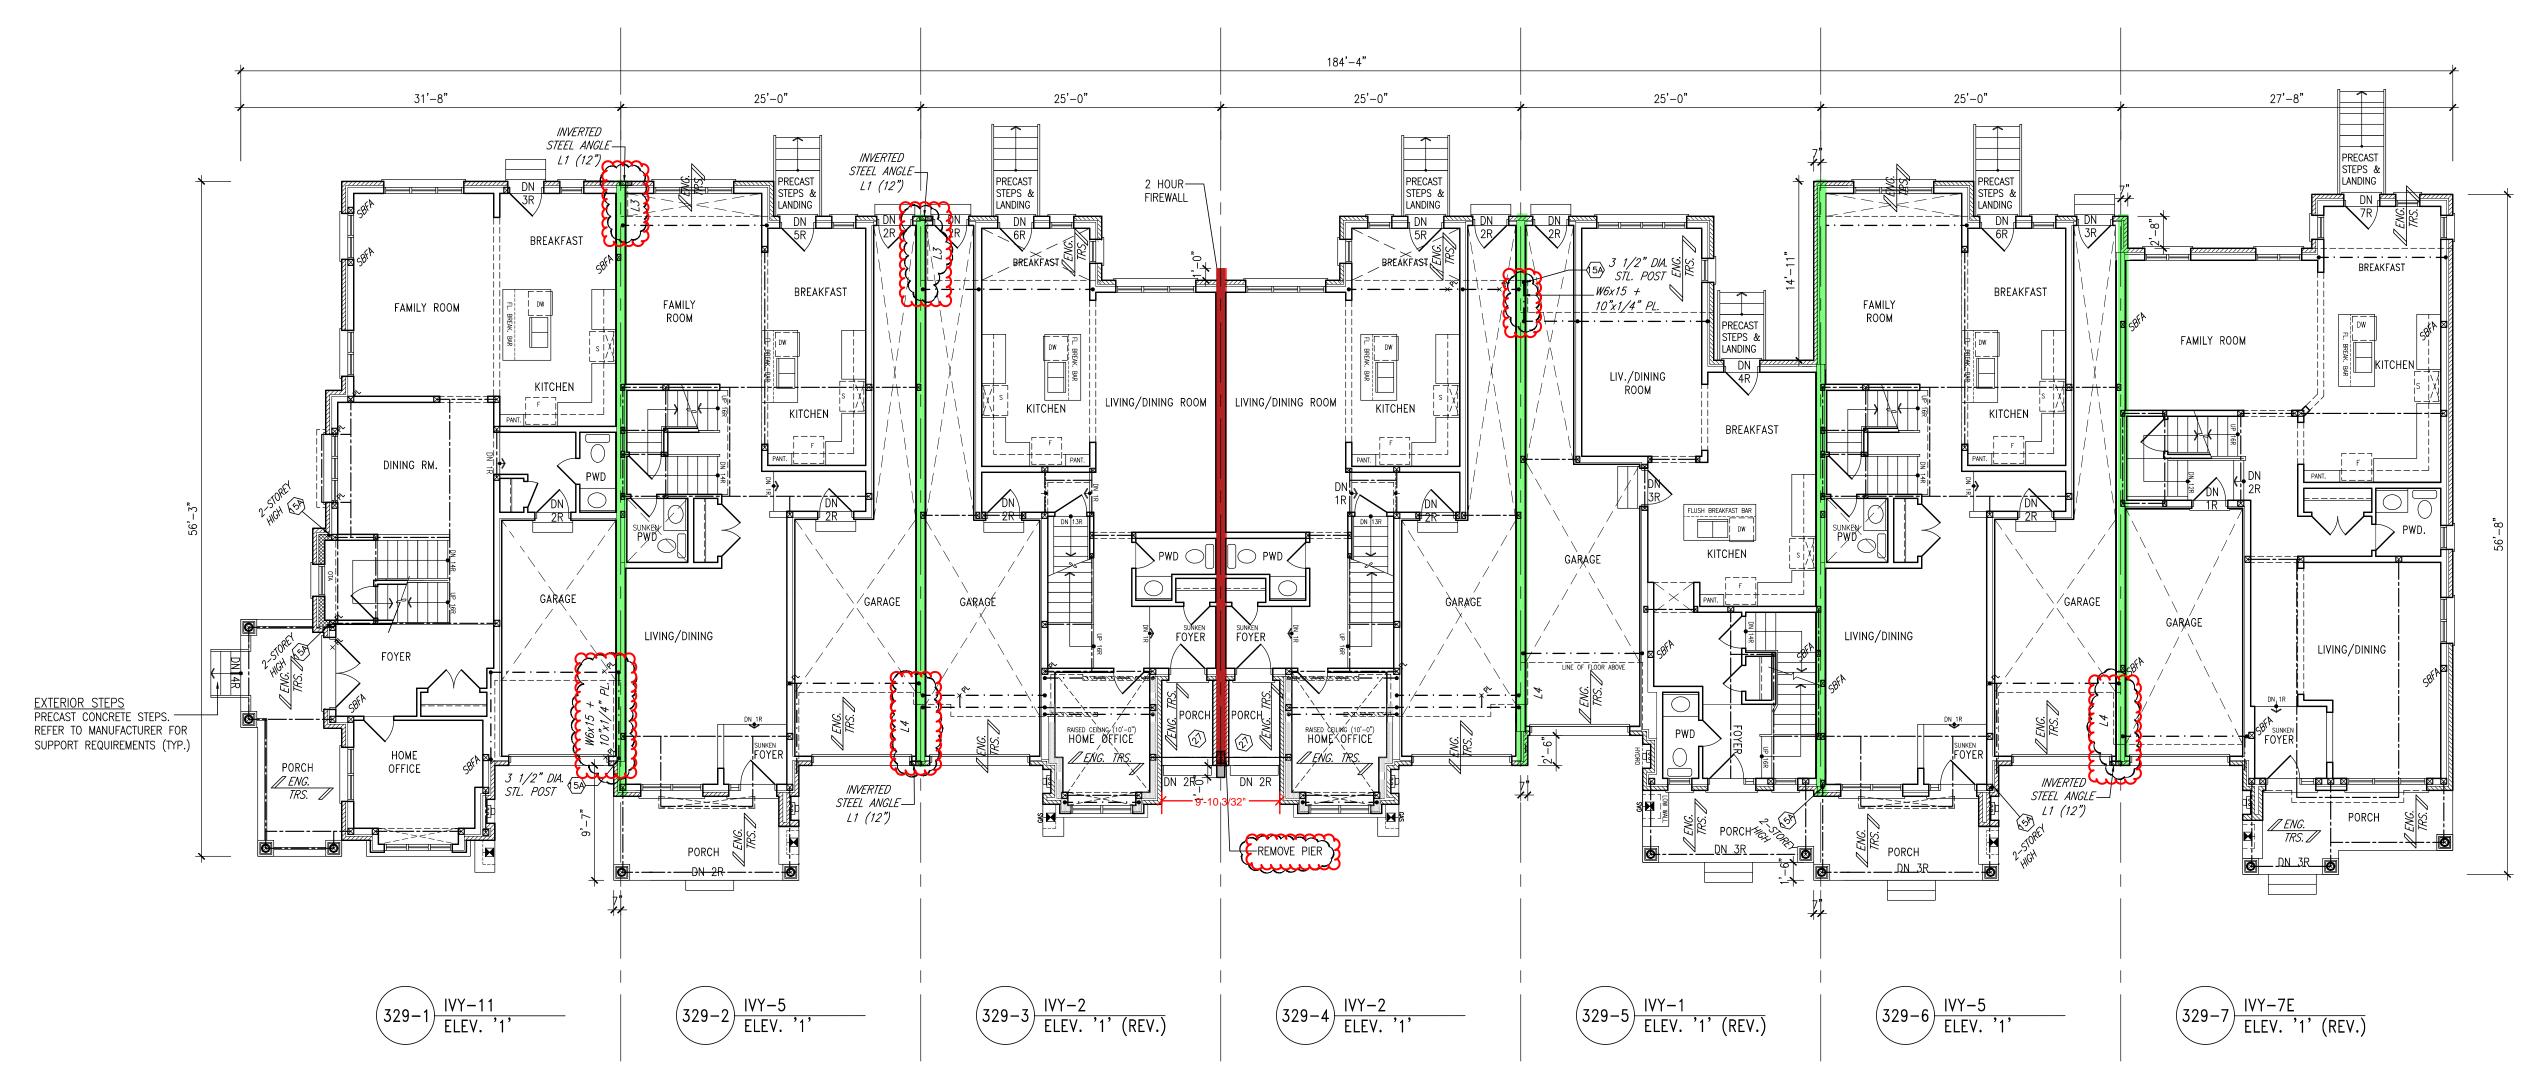

GROUND FLOOR PLAN

MAR 29, 2017 17-5001 SCOTT SHERRIFFS APR 20, 201 **BUILDING DIVISIO** wed townhouse block drawings to be ad in conjunction with reviewed townhouse

del drawings and engineered truss syste

ewed model drawings to be read in junction with reviewed general notes, structions details and specifications = 2 HOUR FIREWALL (NON-COMBUSTIBLE) REWALL DETAILS

= 1 HOUR PARTY WALL (FIRE SEPARATION) PARTY WALL DETAILS See standard details page 4 for standard party wall construction details



BLOCK 329 ELEVATION

BUILDING AREA 8863.29 S.F. (823.42 m2)

PAD FOOTINGS 120 KPa. NATIVE SOIL 90 KPa. ENGINEERED FILL SOIL F1 = 42"x42"x18" CONCRETE PAD $\overline{F1} = 48"x48"x20"$ CONCRETE P F2 = 36"x36"x16" CONCRETE PAD F2 = 40"x40"x16" CONCRETE PAD F3 = 30"x30"x12" CONCRETE PAD F3 = 34"x34"x14" CONCRETE PAD

F4 = 24"x24"x12" CONCRETE PAD F4 = 28"x28"x12" CONCRETE PAD F5 = 16"x16"x8" CONCRETE PAD F5 = 18"x18"x8" CONCRETE PAD REFER TO FLOOR PLAN FOR UNUSUAL SIZE PADS NOT ON CHART.) STRIP FOOTINGS - FOR 2 STOREY TOWNHOUSES

FOOTINGS ON NATIVE SOIL (120 kPa.)

20"x6" CONCRETE STRIP FOOTINGS AS NOTED ON PLAN 24"x8" CONCRETE STRIP FOOTINGS BELOW EXTERIOR WALLS (UNLESS

24"x8" CONCRETE STRIP FOOTINGS (with REINF.) BELOW PARTY WALLS. 32"x8" CONCRETE STRIP FOOTINGS (with REINF.) BELOW FIRE WALLS. FOOTINGS ON ENGINEERED FILL (90 kPa.)

24"x8" CONCRETE STRIP FOOTINGS-with REINFOREMENT, AS NOTED ON PLAN 32"x8" CONCRETE STRIP FOOTINGS BELOW EXTERIOR WALLS-with REINFORCEMENT (UNLESS OTHERWISE NOTED). 32"x8" CONCRETE STRIP FOOTINGS- with REINFORCEMENT BELOW PARTY WALLS. 44"x8" CONCRETE STRIP FOOTINGS — with REINFORCEMENT BELOW FIRE WALLS. (REFER TO FOOTING DETAIL FOR REINFORCEMENT)

ASSUME 120kPa/17.4psi SOIL BEARING CAPACITY FOR NATIVE SOIL OR 90kPa/ 13.0psi FOR ENGINEERED FILL. SOIL BEARING TO BE VERIFIED ON—SITE BY SOILS ENGINEER.

<u>VENEER CUT</u>

WHEN VENEER CUT IS GREATER THAN 26", A 10" POURED CONCRETE FOUNDATION WALL IS REQUIRED.

<u>REFER TO INDIVIDUAL UNITS</u> FOR THE FOLLOWING -GROUND FLOOR ROOF

STRUCTURE

-BASEMENT AND GROUND FLOOR LINTELS

-GROUND FLOOR AND

SECOND FLOOR STRUCTURE -DOUBLE VOLUME WALL

LOCATION AND DETAILS -CONCRETE SLABS

ROOF TRUSSES AND SECOND FLOOR LINTELS SHOWN ON BLOCK PLANS

SOFFIT VENTING

NO SOFFIT VENTING AT ROOF OVERLAP OF DEMISING LINE/ PARTY WALL.



10				
9				
8				
7				
6				
5	ISSUED FOR PERMIT.	MAR.	01/17	G
4	SUMP PUMP LOCATIONS ADDED.	FEB.	02/17	G
3	ISSUED FOR PRICING.	JAN.	17/17	G
2	REV. AS PER ENG. COMMENTS & TRUSS LAYOUTS	DEC.	13/16	G/
1	ISSUED FOR CLIENT REVIEW			
no.	description	date		b
Des ins	ntractor must verify all dimensions on the job and report any discrey signer before proceeding with the work. All drawings and specification truments of service and the property of the architect which must be completion of the work. Drawings are not to be scaled.	s are		



t 416.630.2255 f 416.630.4782

All drawings specifications, related documents and design are the copyright property of VA3 DESIGN. Reproduction of this property in whole or in part is strictly prohibited without VA3 DESIGN's written permission.

***Greenpark.**

BLOCK 329

BLOCK 329 PLAN 1/8" = 1'-0" drawing no.
16015-BLOCK-329 B2

