


This is to certify that these plans comply with the applicable Architectural Design Guidelines approved by the City of BRAMPTON

JOHN G. WILLIAMS LTD., ARCHITECT  
ARCHITECTURAL CONTROL REVIEW  
AND APPROVAL

APPROVED BY: \_\_\_\_\_  
DATE: FEB. 27, 2020

This stamp certifies compliance with the applicable  
Design Guidelines only and bears no further  
professional responsibility.

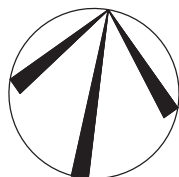

(PER UNIT)  
INTERNAL GARAGE WIDTH: 3.07 m  
INTERNAL GARAGE LENGTH: 6.10 m  
GARAGE DOOR WIDTH: 1 - 2.44 m

NOTE: BUILDER TO VERIFY LOCATION OF ALL HYDRANTS, STREET LIGHTS, TRANSFORMERS AND OTHER SERVICES. IF MIN. DIMENSIONS ARE NOT MAINTAINED BUILDER IS TO RELOCATE AT HIS OWN EXPENSE.

## BUILDING STATISTICS

REG. PLAN No.	43M-2039
ZONE	R2E-7.2-2203
LOT NUMBER	LOT 75 L-R
LOT AREA(m) <sup>2</sup>	L=492.6 / R=795.7
BLDG AREA(m) <sup>2</sup>	N/A
LOT COVERAGE(%)	N/A
No. OF STOREYS	2
MEAN HEIGHT(m)	9.2 L & R
PEAK HEIGHT(m)	N/A
DECK LINE(m)	N/A

### LEGEND

FFE	FINISHED FLOOR ELEVATION		SUMP PUMP
TFW	TOP OF FOUNDATION WALL		BELL PEDESTAL
TBS	TOP OF BASEMENT SLAB		CABLE PEDESTAL
USF	UNDER SIDE FOOTING		CATCH BASIN
USFR	UNDER SIDE FOOTING @ REAR		DBL. CATCH BASIN
USFG	UNDER SIDE FOOTING @ GARAGE		ENGINEERED FILL
TEF	TOP OF ENGINEERED FILL		HYDRO CONNECTION
R	NUMBER OF RISERS TO GRADE		FIRE HYDRANT
WOD	WALKOUT DECK		STREET LIGHT
LOB	LOOKOUT BASEMENT		MAIL BOX
WOB	WALK OUT BASEMENT		TRANSFORMER
WUB	WALK UP BASEMENT		SEWER CONNECTIONS LOT
REV	REVERSE PLAN		SEWER CONNECTIONS LOT
STD	STANDARD PLAN		WATER CONNECTION
△	DOOR		WATER VALVE CHAMBER
○	WINDOW		HYDRANT AND VALVE
	AIR CONDITIONING		HYDRO METER
	DOWN SPOUT TO SPLASH PAD		GAS METER
	DOWNSPOUT CONNECTED TO STM		MANHOLE - STORM
	SWALE DIRECTION		MANHOLE - SANITARY

NOTE: USF IS BASED ON 150mm (6") FOOTING DEPTH. CONTRACTOR TO CONFIRM WITH WORKING DRAWINGS FOR SPECIFIC SIZES THAT MAY SUPERSEDE THIS SIZE.

## ISSUED OR REVISION COMMENTS

[illegible]

**IMPORTANT FOOTING NOTE:**

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- LOT GRADING PLANS ASSUME A TBS TO USF DISTANCE OF 0.23, BASED ON FOOTING THICKNESS UP TO 6".
- IF ADDITIONAL FOOTING THICKNESS IS REQUIRED THE USF IS TO BE LOWERED BY THE FOLLOWING AMOUNTS:
  - UP TO 9" FOOTING, LOWER USF BY 0.07
  - 10" FOOTING, LOWER USF BY 0.10
  - 11" FOOTING, LOWER USF BY 0.13
  - 12" FOOTING, LOWER USF BY 0.15
  - 13" FOOTING, LOWER USF BY 0.18
  - 14" FOOTING, LOWER USF BY 0.20



WWW.RNDESIGN.COM  
T:905-738-3177  
WWW.THEPLUSGROUP.CA

I, DANIEL HANNINEN DECLARE THAT I HAVE REVIEWED AND TAKEN DESIGN RESPONSIBILITY FOR THE DESIGN WORK ON BEHALF OF **RN DESIGN LTD** UNDER DIVISION C,PART-3 SUBSECTION-3.2.4 OF THE BUILDING CODE. I AM QUALIFIED AND THE FIRM IS REGISTERED IN THE APPROPRIATE CLASSES / CATEGORIES.

QUALIFIED DESIGNER BCIN:	20888
FIRM BCIN:	26995
DATE:	<b>Feb-24-2020</b>

SIGNATURE: \_\_\_\_\_

GOLD PARK HOMES

PROJECT/LOCATION  
McLAUGHLIN AND MAYFIELD-PH2  
BRAMPTON, ON

DRAWING

## SITE PLAN

DRAWN BY  
DJH

SCALE

PROJECT No.  
19037 (13098 Ph.2)

LOT NUMBER  
LOT 75 L-R

URBANTECH NOTES:

- 1) No final utility location information at this time. Urbantech will not be responsible for future changes to design. Builder should notify purchaser's that street hardware and above ground utility furniture may be added or removed from their frontages.
- 2) Builder to lower underside of footings where adjacent to RLCB leads. Exact depth to be determined on site during footing excavation.
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- 4) Builder to verify location of all hydrants, street lights, transformers and all other services. If min. dimensions are not maintained as per City standards, builder is to relocate at his own expense.
- 5) Builder to confirm service connection elevations and review for absence of conflict prior to footing excavation.
- 6) Final fence design have not been provided at this time. Purchaser to be advised that actual fencing details may not be as shown on this plan.

URBANTECH CONSULTING

We certify that the proposed grades at the lot corners are correct, and that the lot grading of the subject lot is in conformity to the approved subdivision grading plans and City standards.

REVIEWED BY: mw DATE: Feb 27/20

This is to certify that these plans comply with the applicable Architectural Design Guidelines approved by the City of BRAMPTON

**JOHN G. WILLIAMS LTD., ARCHITECT**  
ARCHITECTURAL CONTROL REVIEW  
AND APPROVAL

**APPROVED BY:** \_\_\_\_\_

DATE: FEB. 27, 2020

This stamp certifies compliance with the applicable Design Guidelines only and bears no further professional responsibility.



(PER UNIT)  
INTERNAL GARAGE WIDTH: 3.04 m  
INTERNAL GARAGE LENGTH: 6.10 m  
GARAGE DOOR WIDTH: 1 - 2.44 m

NOTE: BUILDER TO VERIFY LOCATION OF ALL HYDRANTS, STREET LIGHTS, TRANSFORMERS AND OTHER SERVICES. IF MIN. DIMENSIONS ARE NOT MAINTAINED BUILDER IS TO RELOCATE AT HIS OWN EXPENSE.

## BUILDING STATISTICS


REG. PLAN No.	43M-2039
ZONE	R2E-7.2-2203
LOT NUMBER	LOT 76 L-R
LOT AREA(m) <sup>2</sup>	L=508.3 / R=323.7
BLDG AREA(m) <sup>2</sup>	N/A
LOT COVERAGE(%)	N/A
No. OF STOREYS	2
MEAN HEIGHT(m)	8.8 L & R
PEAK HEIGHT(m)	N/A
DECK LINE(m)	N/A

### LEGEND

FFE	FINISHED FLOOR ELEVATION	SP	SUMP PUMP
TFW	TOP OF FOUNDATION WALL		BELL PEDESTAL
TBS	TOP OF BASEMENT SLAB		CABLE PEDESTAL
USF	UNDER SIDE FOOTING		CATCH BASIN
USFR	UNDER SIDE FOOTING @ REAR		DBL. CATCH BASIN
USFG	UNDER SIDE FOOTING @ GARAGE		ENGINEERED FILL
TEF	TOP OF ENGINEERED FILL		FIRE HYDRANT
R	NUMBER OF RISERS TO GRADE		STREET LIGHT
WOD	WALKOUT DECK		MAIL BOX
LOB	LOOKOUT BASEMENT		TRANSFORMER
WOB	WALK OUT BASEMENT		SEWER CONNECTIONS LOTS
WUB	WALK UP BASEMENT		SEWER CONNECTIONS LOT
REV	REVERSE PLAN		WATER CONNECTION
STD	STANDARD PLAN		WATER VALVE CHAMBER
△	DOOR		HYDRANT AND VALVE
○	WINDOW		HYDRO METER
AC	AIR CONDITIONING		GAS METER
	DOWN SPOUT TO SPLASH PAD		MANHOLE - STORM
	DOWNSPOUT CONNECTED TO STM		MANHOLE - SANITARY
→	SWALE DIRECTION		

NOTE: USE IS BASED ON 150mm (6") FOOTING DEPTH. CONTRACTOR TO CONFIRM WITH WORKING DRAWINGS FOR SPECIFIC SIZES THAT MAY SUPERSEDE THIS SIZE.

## ISSUED OR REVISION COMMENTS

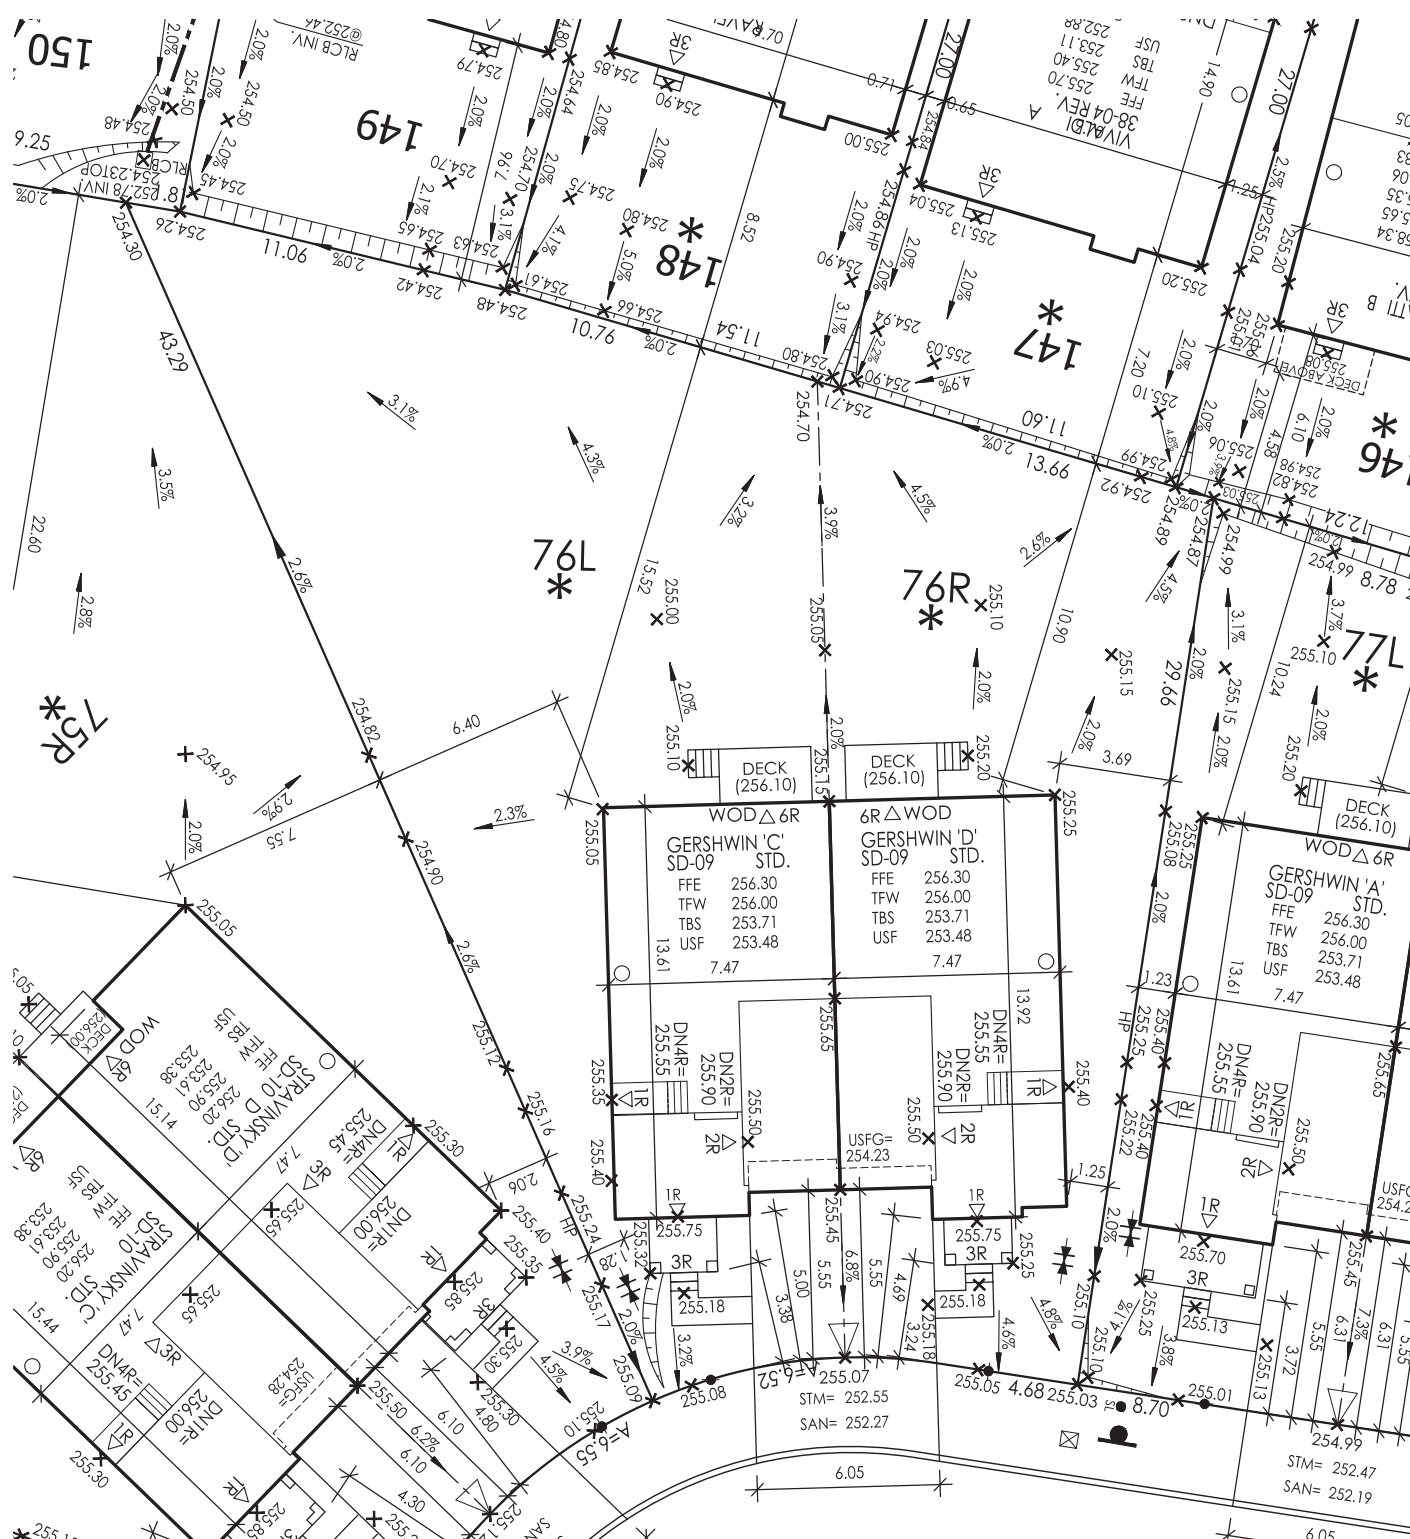[illegible]

## DOLOBRAM TRAIL

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## URBANTECH CONSULTING

We certify that the proposed grades at the lot corners are correct, and that the lot grading of the subject lot is in conformity to the approved subdivision grading plans and City standards.

REVIEWED BY: mw DATE: Feb 27/20

WWW.RNDESIGN.COM  
T:905-738-3177  
WWW.THEPLUSGROUP.CA

I, DANIEL HANNINEN DECLARE THAT I HAVE REVIEWED AND TAKEN DESIGN RESPONSIBILITY FOR THE DESIGN WORK ON BEHALF OF **RN DESIGN LTD.** UNDER DIVISION C, PART-3 SUBSECTION-3.2.4 OF THE BUILDING CODE. I AM QUALIFIED AND THE FIRM IS REGISTERED IN THE APPROPRIATE CLASSES / CATEGORIES.

DATE: **Feb-24-2020**

SIGNATURE \_\_\_\_\_

CLIENT \_\_\_\_\_

GOLD PARK HOMES

PROJECT/LOCATION  
McLAUGHLIN AND MAYFIELD-PH2  
BRAMPTON, ON

DRAWING

## SITE PLAN

DRAWN BY  
DJH

SCALE

PROJECT No.	19037 (13098 Ph.2)
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LOT NUMBER  
LOT 76 L-R












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JOHN G. WILLIAMS LTD., ARCHITECT  
ARCHITECTURAL CONTROL REVIEW  
AND APPROVAL

APPROVED BY:

DATE: FEB 10, 2020

This stamp certifies compliance with the applicable Design Guidelines only and bears no further professional responsibility.

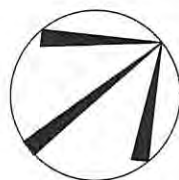

(PER UNIT)	
INTERNAL GARAGE WIDTH:	5.48 m
INTERNAL GARAGE LENGTH:	6.10 m
GARAGE DOOR WIDTH:	2 - 2.44 m

NOTE: BUILDER TO VERIFY LOCATION OF ALL HYDRANTS, STREET LIGHTS, TRANSFORMERS AND OTHER SERVICES. IF MIN. DIMENSIONS ARE NOT MAINTAINED BUILDER IS TO RELOCATE AT HIS OWN EXPENSE.

## BUILDING STATISTICS

REG. PLAN No.	43M-2039
ZONE	R1F-9.0-2452
LOT NUMBER	LOT 123
LOT AREA(m) <sup>2</sup>	313.2
BLDG AREA(m) <sup>2</sup>	N/A
LOT COVERAGE(%)	N/A
No. OF STOREYS	3
MEAN HEIGHT(m)	10.9
PEAK HEIGHT(m)	N/A
DECK LINE(m)	N/A

### LEGEND

FFE	FINISHED FLOOR ELEVATION		SUMP PUMP
TFW	TOP OF FOUNDATION WALL		BELL PEDESTAL
TBS	TOP OF BASEMENT SLAB		CABLE PEDESTAL
USF	UNDER SIDE FOOTING		CATCH BASIN
USFR	UNDER SIDE FOOTING @ REAR		DBL. CATCH BASIN
USFG	UNDER SIDE FOOTING @ GARAGE		ENGINEERED FILL
TEF	TOP OF ENGINEERED FILL		HYDRO CONNECTION
R	NUMBER OF RISERS TO GRADE		FIRE HYDRANT
WOD	WALKOUT DECK		STREET LIGHT
LOB	LOOKOUT BASEMENT		MAIL BOX
WOB	WALK OUT BASEMENT		TRANSFORMER
WUB	WALK UP BASEMENT		SEWER CONNECTIONS 2 LOTS
REV	REVERSE PLAN		SEWER CONNECTIONS 1 LOT
STD	STANDARD PLAN		WATER CONNECTION
△	DOOR		WATER VALVE CHAMBER
○	WINDOW		HYDRANT AND VALVE
	AIR CONDITIONING		HYDRO METER
	DOWN SPOUT TO SPLASH PAD		GAS METER
	DOWNSPOUT CONNECTED TO STM		MANHOLE - STORM
→	SWALE DIRECTION		MANHOLE - SANITARY

NOTE: USF IS BASED ON 150mm (6") FOOTING DEPTH. CONTRACTOR TO CONFIRM WITH WORKING DRAWINGS FOR SPECIFIC SIZES THAT MAY SUPERSEDE THIS SIZE.

## ISSUED OR REVISION COMMENTS

[illegible]

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  - UP TO 9" FOOTING, LOWER USF BY 0.07
  - 10" FOOTING, LOWER USF BY 0.10
  - 11" FOOTING, LOWER USF BY 0.13
  - 12" FOOTING, LOWER USF BY 0.15
  - 13" FOOTING, LOWER USF BY 0.18
  - 14" FOOTING, LOWER USF BY 0.20



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WWW.THEPLUSGROUP.CA

## DANIEL HANNINEN

I, \_\_\_\_\_, DECLARE THAT I HAVE REVIEWED AND TAKEN DESIGN RESPONSIBILITY FOR THE DESIGN WORK ON BEHALF OF RN DESIGN LTD. UNDER DIVISION C, PART-3 SUBSECTION-3.2.4 OF THE BUILDING CODE. I AM QUALIFIED AND THE FIRM IS REGISTERED IN THE APPROPRIATE CLASSES / CATEGORIES.

QUALIFIED DESIGNER BCIN: 20888  
FIRM BCIN: 26995  
DATE: Feb-6-2020

SIGNATURE: \_\_\_\_\_

CLIENT

GOLD PARK HOMES

PROJECT/LOCATION

McLAUGHLIN AND MAYFIELD-PH2  
BRAMPTON, ON

DRAWING

## SITE PLAN

DRAWN BY

DJH

SCALE

1:250

PROJECT No. \_\_\_\_\_

19037 (13098 Ph.2)

LOT NUMBER

LOT 123

URBANTECH NOTES:

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URBANTECH CONSULTING

We certify that the proposed grades at the lot corners are correct, and that the lot grading of the subject lot is in conformity to the approved subdivision grading plans and City standards.

REVIEWED BY: mw DATE: Feb 7/20






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JOHN G. WILLIAMS LTD., ARCHITECT  
ARCHITECTURAL CONTROL REVIEW  
AND APPROVAL

APPROVED BY:

DATE: FEB 27, 2020

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## BUILDING STATISTICS

REG. PLAN No.	43M-2039
ZONE	R1F-9.0-2452
LOT NUMBER	LOT 124
LOT AREA(m) <sup>2</sup>	313.2
BLDG AREA(m) <sup>2</sup>	N/A
LOT COVERAGE(%)	N/A
No. OF STOREYS	3
MEAN HEIGHT(m)	10.7
PEAK HEIGHT(m)	N/A
DECK LINE(m)	N/A

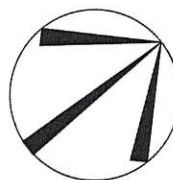(PER UNIT)	
INTERNAL GARAGE WIDTH:	5.48 m
INTERNAL GARAGE LENGTH:	6.10 m
GARAGE DOOR WIDTH:	2 - 2.44 m

### LEGEND

FFE	FINISHED FLOOR ELEVATION	SP	SUMP PUMP
TFW	TOP OF FOUNDATION WALL		BELL PEDESTAL
TBS	TOP OF BASEMENT SLAB		CABLE PEDESTAL
USF	UNDER SIDE FOOTING		CATCH BASIN
USFR	UNDER SIDE FOOTING @ REAR		DBL. CATCH BASIN
USFG	UNDER SIDE FOOTING @ GARAGE		ENGINEERED FILL
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R	NUMBER OF RISERS TO GRADE		FIRE HYDRANT
WOD	WALKOUT DECK	SL	STREET LIGHT
LOB	LOOKOUT BASEMENT		MAIL BOX
WOB	WALK OUT BASEMENT		TRANSFORMER
WUB	WALK UP BASEMENT		SEWER CONNECTIONS LOTS
REV	REVERSE PLAN		SEWER CONNECTIONS LOT
STD	STANDARD PLAN		WATER CONNECTION
△	DOOR		WATER VALVE CHAMBER
□	WINDOW		HYDRANT AND VALVE
AC	AIR CONDITIONING		HYDRO METER
	DOWN SPOUT TO SPLASH PAD		GAS METER
	DOWNSPOUT CONNECTED TO SIM		MANHOLE - STORM
			MANHOLE - SANITARY

NOTE: USF IS BASED ON 150mm (6") FOOTING DEPTH. CONTRACTOR TO CONFIRM WITH WORKING DRAWINGS FOR SPECIFIC SIZES THAT MAY SUPERSEDE THIS SIZE

## ISSUED OR REVISION COMMENTS

[illegible]

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REVIEWED BY: mw DATE: Feb 27/20

CLIENT

GOLD PARK HOMES

## PROJECT/LOCATION

McLAUGHLIN AND MAYFIELD-PH2  
BRAMPTON, ON

## DRAWING

## SITE PLAN

DRAWN BY

D.H.

SCALE

1:250

PROJECT No. \_\_\_\_\_

19037 (13098 Ph.2)

LOT NUMBER

LOT 124






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JOHN G. WILLIAMS LTD., ARCHITECT  
ARCHITECTURAL CONTROL REVIEW  
AND APPROVAL

APPROVED BY:

DATE: OCT 28, 2019

This stamp certifies compliance with the applicable Design Guidelines only and bears no further professional responsibility.



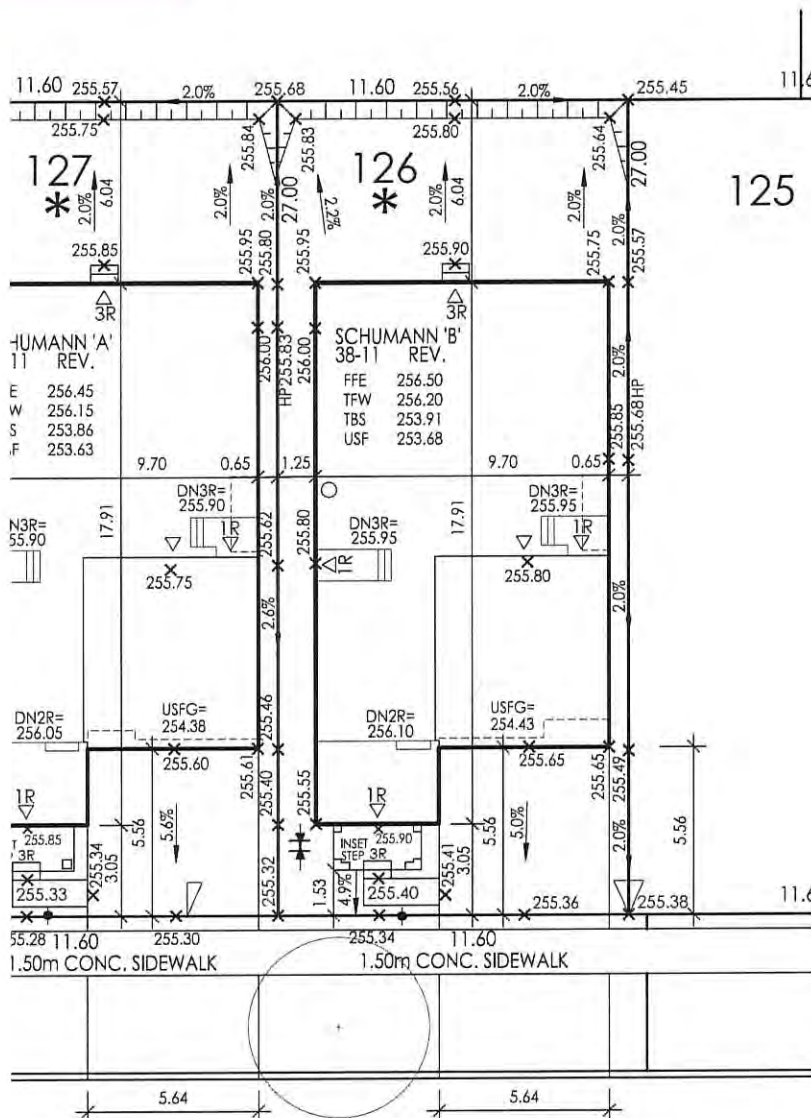



















WAINWRIGHT DRIVE

NOTE: BUILDER TO VERIFY LOCATION OF ALL HYDRANTS, STREET LIGHTS, TRANSFORMERS AND OTHER SERVICES. IF MIN. DIMENSIONS ARE NOT MAINTAINED BUILDER IS TO RELOCATE AT HIS OWN EXPENSE.

## BUILDING STATISTICS

REG. PLAN No.	43M-2039
ZONE	R1F-9.0-2452
LOT NUMBER	LOT 126
LOT AREA(m) <sup>2</sup>	313.2
BLDG AREA(m) <sup>2</sup>	N/A
LOT COVERAGE(%)	N/A
No. OF STOREYS	2
MEAN HEIGHT(m)	8.9
PEAK HEIGHT(m)	N/A
DECK LINE(m)	N/A

### LEGEND

FFE	FINISHED FLOOR ELEVATION		SUMP PUMP
TFW	TOP OF FOUNDATION WALL		BELL PEDESTAL
TBS	TOP OF BASEMENT SLAB		CABLE PEDESTAL
USF	UNDER SIDE FOOTING		CATCH BASIN
USFR	UNDER SIDE FOOTING @ REAR		DBL. CATCH BASIN
USFG	UNDER SIDE FOOTING @ GARAGE		ENGINEERED FILL
TEF	TOP OF ENGINEERED FILL		HYDRO CONNECTION
R	NUMBER OF RISERS TO GRADE		FIRE HYDRANT
WOD	WALKOUT DECK		STREET LIGHT
LOB	LOOKOUT BASEMENT		MAIL BOX
WOB	WALK OUT BASEMENT		TRANSFORMER
WUB	WALK UP BASEMENT		SEWER CONNECTIONS 2 LOITS
REV	REVERSE PLAN		SEWER CONNECTIONS 1 LOT
STD	STANDARD PLAN		WATER CONNECTION
△	DOOR		WATER VALVE CHAMBER
○	WINDOW		HYDRANT AND VALVE
AC	AIR CONDITIONING		HYDRO METER
↓	DOWN SPOUT TO SPLASH PAD		GAS METER
□	DOWNSPOUT CONNECTED TO STM		MANHOLE - STORM
			MANHOLE - SANITARY

NOTE: USF IS BASED ON 150mm (6") FOOTING DEPTH. CONTRACTOR TO CONFIRM WITH WORKING DRAWINGS FOR SPECIFIC SIZES THAT MAY SUPERSEDE THIS SIZE.

## ISSUED OR REVISION COMMENTS

[illegible]

**IMPORTANT FOOTING NOTES:**

**IMPORTANT FOOTING RULES:**

- IT IS THE RESPONSIBILITY OF THE BUILDER TO VERIFY FROM THE ARCHITECTURAL DRAWINGS BEFORE CONSTRUCTION, WHETHER ADDITIONAL THICKNESS MAY BE REQUIRED.
- LOT GRADING PLANS ASSUME A TBS TO USF DISTANCE OF 0.23, BASED ON FOOTING THICKNESS UP TO 6'.
- IF ADDITIONAL FOOTING THICKNESS IS REQUIRED THE USF IS TO BE LOWERED BY THE FOLLOWING AMOUNTS:
  - UP TO 9" FOOTING, LOWER USF BY 0.07
  - 10" FOOTING, LOWER USF BY 0.10
  - 11" FOOTING, LOWER USF BY 0.13
  - 12" FOOTING, LOWER USF BY 0.15
  - 13" FOOTING, LOWER USF BY 0.18
  - 14" FOOTING, LOWER USF BY 0.20



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URBANTECH NOTES:

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- 2) Builder to lower underside of footings where adjacent to RLCB leads. Exact depth to be determined on site during footing excavation.
- 3) Builder to stake out driveway curb depressions at time of curb installation.
- 4) Builder to verify location of all hydrants, street lights, transformers and all other services. If min. dimensions are not maintained as per City standards, builder is to relocate at his own expense.
- 5) Builder to confirm service connection elevations and review for absence of conflict prior to footing excavation.
- 6) Final fence design have not been provided at this time. Purchaser to be advised that actual fencing details may not be as shown on this plan.

URBANTECH CONSULTING

We certify that the proposed grades at the lot corners are correct, and that the lot grading of the subject lot is in conformity to the approved subdivision grading plans and City standards.

REVIEWED BY: m.w. DATE: Oct 25/19



CLIENT

GOLD PARK HOMES

## PROJECT/LOCATION

McLAUGHLIN AND MAYFIELD-PH2  
BRAMPTON, ON

**DRAWING**

## SITE PLAN

DRAWN BY DJH	SCALE 1:250
PROJECT No. 19037 (13098 Ph.2)	LOT NUMBER LOT 126






This is to certify that these plans comply with the applicable Architectural Design Guidelines approved by the City of BRAMPTON.

APPROVED BY:

DATE: OCT 29, 2019

This stamp certifies compliance with the applicable Design Guidelines only and bears no further professional responsibility.

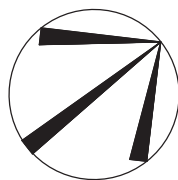



























(PER UNIT)	
INTERNAL GARAGE WIDTH:	5.53 m
INTERNAL GARAGE LENGTH:	6.10 m
GARAGE DOOR WIDTH:	2 - 2.44 m

NOTE: BUILDER TO VERIFY LOCATION OF ALL HYDRANTS, STREET LIGHTS, TRANSFORMERS AND OTHER SERVICES. IF MIN. DIMENSIONS ARE NOT MAINTAINED BUILDER IS TO RELOCATE AT HIS OWN EXPENSE.

## BUILDING STATISTICS

REG. PLAN No.	43M-2039
ZONE	RIF-9.0-2452
LOT NUMBER	LOT 128
LOT AREA(m) <sup>2</sup>	313.2
BLDG AREA(m) <sup>2</sup>	N/A
LOT COVERAGE(%)	N/A
No. OF STOREYS	2
MEAN HEIGHT(m)	8.8
PEAK HEIGHT(m)	N/A
DECK LINE(m)	N/A

LEGEND

FFE	FINISHED FLOOR ELEVATION		SUMP PUMP
TFW	TOP OF FOUNDATION WALL		BELL PEDESTAL
TBS	TOP OF BASEMENT SLAB		CABLE PEDESTAL
USF	UNDER SIDE FOOTING		CATCH BASIN
USFR	UNDER SIDE FOOTING @ REAR		DBL. CATCH BASIN
USFG	UNDER SIDE FOOTING @ GARAGE		ENGINEERED FILL
TEF	TOP OF ENGINEERED FILL		HYDRO CONNECTION
R	NUMBER OF RISERS TO GRADE		FIRE HYDRANT
WOD	WALKOUT DECK		STREET LIGHT
LOB	LOOKOUT BASEMENT		MAIL BOX
WOB	WALK OUT BASEMENT		TRANSFORMER
WUB	WALK UP BASEMENT		SEWER CONNECTIONS 2 LOTS
REV	REVERSE PLAN		SEWER CONNECTIONS 1 LOT
STD	STANDARD PLAN		WATER CONNECTION
	DOOR		WATER VALVE CHAMBER
	WINDOW		HYDRANT AND VALVE
	AIR CONDITIONING		HYDRO METER
	DOWN SPOUT TO SPLASH PAD		GAS METER
	DOWNSPOUT CONNECTED TO STM		MANHOLE - STORM
	SWAIF DIRECTION		MANHOLE - SANITARY

NOTE: USF IS BASED ON 150mm (6") FOOTING DEPTH. CONTRACTOR TO CONFIRM WITH WORKING DRAWINGS FOR SPECIFIC SIZES THAT MAY SUPERSEDE THIS SIZE.

## ISSUED OR REVISION COMMENTS

[illegible]

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  - UP TO 9" FOOTING, LOWER USF BY 0.07
  - 10" FOOTING, LOWER USF BY 0.10
  - 11" FOOTING, LOWER USF BY 0.13
  - 12" FOOTING, LOWER USF BY 0.15
  - 13" FOOTING, LOWER USF BY 0.18
  - 14" FOOTING, LOWER USF BY 0.20



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WWW.THEPLUSGROUP.CA

I, DANIEL HANNINEN DECLARE THAT I HAVE REVIEWED AND TAKEN DESIGN RESPONSIBILITY FOR THE DESIGN WORK ON BEHALF OF **RN DESIGN LTD**, UNDER DIVISION C, PART-3 SUBSECTION-3.2.4 OF THE BUILDING CODE. I AM QUALIFIED AND THE FIRM IS REGISTERED IN THE APPROPRIATE CLASSES / CATEGORIES.

QUALIFIED DESIGNER BCIN: 20888  
FIRM BCIN: 26995  
DATE: Oct 30, 2019

SIGNATURE:

CLIENT

GOLD PARK HOMES

PROJECT/LOCATION

McLAUGHLIN AND MAYFIELD-PH2  
BRAMPTON, ON

DRAWING

## SITE PLAN

DRAWN BY

D IH

SCALE

1.250

PROJECT No. \_\_\_\_\_

19037 (13098 Ph 2)

LOT NUMBER

LOT 100

URBANTECH NOTES:

1) No final utility location information at this time. Urbantech will not be responsible for future changes to design. Builder should notify purchaser's that street hardware and above ground utility furniture may be added or removed from their frontages.

2) Builder to lower underside of footings where adjacent to RLCB leads. Exact depth to be determined on site during footing excavation.

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6) Final fence design have not been provided at this time. Purchaser to be advised that actual fencing details may not be as shown on this plan.

## URBANTECH CONSULTING

We certify that the proposed grades at the lot corners are correct, and that the lot grading of the subject lot is in conformity to the approved subdivision grading plans and City standards.

REVIEWED BY: **m.w.** DATE: **Oct 29/19**




This is to certify that these plans comply with the applicable Architectural Design Guidelines approved by the City of BRAMPTON.

JOHN G. WILLIAMS LTD., ARCHITECT  
ARCHITECTURAL CONTROL REVIEW  
AND APPROVAL

APPROVED BY:

DATE: NOV 18, 2019

This stamp certifies compliance with the applicable Design Guidelines only and bears no further professional responsibility.

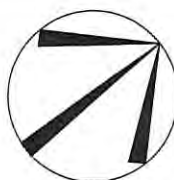

(PER UNIT)  
INTERNAL GARAGE WIDTH: 5.48 m  
INTERNAL GARAGE LENGTH: 5.79 m  
GARAGE DOOR WIDTH: 2 - 2.44 m

NOTE: BUILDER TO VERIFY LOCATION OF ALL HYDRANTS, STREET LIGHTS, TRANSFORMERS AND OTHER SERVICES. IF MIN. DIMENSIONS ARE NOT MAINTAINED BUILDER IS TO RELOCATE AT HIS OWN EXPENSE

## BUILDING STATISTICS

REG. PLAN No.	43M-2039
ZONE	R1F-9.0-2452
LOT NUMBER	LOT 129
LOT AREA(m) <sup>2</sup>	313.2
BLDG AREA(m) <sup>2</sup>	N/A
LOT COVERAGE(%)	N/A
No. OF STOREYS	2
MEAN HEIGHT(m)	8.3
PEAK HEIGHT(m)	N/A
DECK LINF(m)	N/A

### LEGEND

FFE	FINISHED FLOOR ELEVATION		SUMP PUMP
TFW	TOP OF FOUNDATION WALL		BELL PEDESTAL
TBS	TOP OF BASEMENT SLAB		CABLE PEDESTAL
USF	UNDER SIDE FOOTING		CATCH BASIN
USFR	UNDER SIDE FOOTING @ REAR		DBL. CATCH BASIN
USFG	UNDER SIDE FOOTING @ GARAGE		ENGINEERED FILL
TEF	TOP OF ENGINEERED FILL		HYDRO CONNECTION
R	NUMBER OF RISERS TO GRADE		FIRE HYDRANT
WOD	WALKOUT DECK		STREET LIGHT
LOB	LOOKOUT BASEMENT		MAIL BOX
WOB	WALK OUT BASEMENT		TRANSFORMER
WUB	WALK UP BASEMENT		SEWER CONNECTIONS 2 LOTS
REV	REVERSE PLAN		SEWER CONNECTIONS 1 LOT
STD	STANDARD PLAN		WATER CONNECTION
△	DOOR		WATER VALVE CHAMBER
○	WINDOW		HYDRANT AND VALVE
AC	AIR CONDITIONING		HYDRO METER
	DOWN SPOUT TO SPLASH PAD		GAS METER
	DOWNSPOUT CONNECTED TO STM		MANHOLE - STORM
→	SWALE DIRECTION		MANHOLE - SANITARY

NOTE: USF IS BASED ON 150mm (6") FOOTING DEPTH. CONTRACTOR TO CONFIRM WITH WORKING DRAWINGS FOR SPECIFIC SIZES THAT MAY SUPERSEDE THIS SIZE.

ISSUED OR REVISION COMMENTS

[illegible]

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DANIEL HANNINEN

I. DECLARE THAT I HAVE REVIEWED AND TAKEN DESIGN RESPONSIBILITY FOR THE DESIGN WORK ON BEHALF OF **RN DESIGN LTD.** UNDER DIVISION C, PART-3 SUBSECTION-3.2.4 OF THE BUILDING CODE. I AM QUALIFIED AND THE FIRM IS REGISTERED IN THE APPROPRIATE CLASSES / CATEGORIES.

QUALIFIED DESIGNER BCIN: 20888  
FIRM BCIN: 26995  
DATE: Nov 14, 2019

SIGNATURE:

CLIENT

GOLD PARK HOMES

PROJECT/LOCATION

McLAUGHLIN AND MAYFIELD-PH2  
BRAMPTON, ON

DRAWING

## SITE PLAN

DRAWN BY

DJH

SCALE

1:250

PROJECT No. \_\_\_\_\_

19037 (13098 Ph.2)

LOT NUMBER

LOT 129

URBANTECH NOTES:

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- 6) Final fence design have not been provided at this time. Purchaser to be advised that actual fencing details may not be as shown on this plan.

URBANTECH CONSULTING

We certify that the proposed grades at the lot corners are correct, and that the lot grading of the subject lot is in conformity to the approved subdivision grading plans and City standards.

REVIEWED BY: m.w. DATE: Nov 14/19





It is the builder's complete responsibility to ensure that all plans submitted for approval fully comply with the Architectural Guidelines and all applicable regulations and requirements including zoning provisions and any provisions in the subdivision agreement. The Control Architect is not responsible in any way for examining or approving site (lotting) plans or working drawings with respect to any zoning or building code or permit matter or that any house can be properly built or located on its lot.

This is to certify that these plans comply with the applicable Architectural Design Guidelines approved by the City of BRAMPTON.

JOHN G. WILLIAMS LTD., ARCHITECT  
ARCHITECTURAL CONTROL REVIEW  
AND APPROVAL

APPROVED BY:

DATE: FEB 10, 2020

This stamp certifies compliance with the applicable Design Guidelines only and bears no further professional responsibility.


(PER UNIT)  
INTERNAL GARAGE WIDTH: 5.48 m  
INTERNAL GARAGE LENGTH: 6.10 m  
GARAGE DOOR WIDTH: 2-2.44 m

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#### BUILDING STATISTICS

REG. PLAN No.	43M-2039
ZONE	R1F-9.0-2452
LOT NUMBER	LOT 130
LOT AREA(m) <sup>2</sup>	313.2
BLDG AREA(m) <sup>2</sup>	N/A
LOT COVERAGE(%)	N/A
No. OF STOREYS	2
MEAN HEIGHT(m)	8.4
PEAK HEIGHT(m)	N/A
DECK LINE(m)	N/A

LEGEND	
FFE	FINISHED FLOOR ELEVATION
TFW	TOP OF FOUNDATION WALL
TBS	TOP OF BASEMENT SLAB
USF	UNDER SIDE FOOTING
USFR	UNDER SIDE FOOTING @ REAR
USFG	UNDER SIDE FOOTING @ GARAGE
TEF	TOP OF ENGINEERED FILL
R	NUMBER OF RISERS TO GRADE
WOD	WALKOUT DECK
LOB	LOOKOUT BASEMENT
WOB	WALK OUT BASEMENT
WUB	WALK UP BASEMENT
REV	REVERSE PLAN
STD	STANDARD PLAN
△	DOOR
○	WINDOW
AC	AIR CONDITIONING
DS	DOWN SPOUT TO SPLASH PAD
DS*	DOWNSPOUT CONNECTED TO STM
→	SWALE DIRECTION
X	CHAINLINK FENCE
XX	PRIVACY FENCE
XXX	SOUND BARRIER
---	FOOTING TO BE EXTENDED TO 1.22 (MIN) BELOW GRADE TO CONFIRM WITH WORKING DRAWINGS FOR SPECIFIC SIZES THAT MAY SUPERSEDE THIS SIZE.
SP	SUMP PUMP
BP	BELL PEDESTAL
CP	CABLE PEDESTAL
CB	CATCH BASIN
DBL CB	DBL. CATCH BASIN
EF	ENGINEERED FILL
HC	HYDRO CONNECTION
FD	FIRE HYDRANT
SL	STREET LIGHT
MB	MAIL BOX
TR	TRANSFORMER
SC2	SEWER CONNECTIONS 2 LOTS
SC1	SEWER CONNECTIONS 1 LOT
WC	WATER CONNECTION
VC	WATER VALVE CHAMBER
HA	HYDRANT AND VALVE
HM	HYDRO METER
GM	GAS METER
MS	MANHOLE - STORM
MS*	MANHOLE - SANITARY

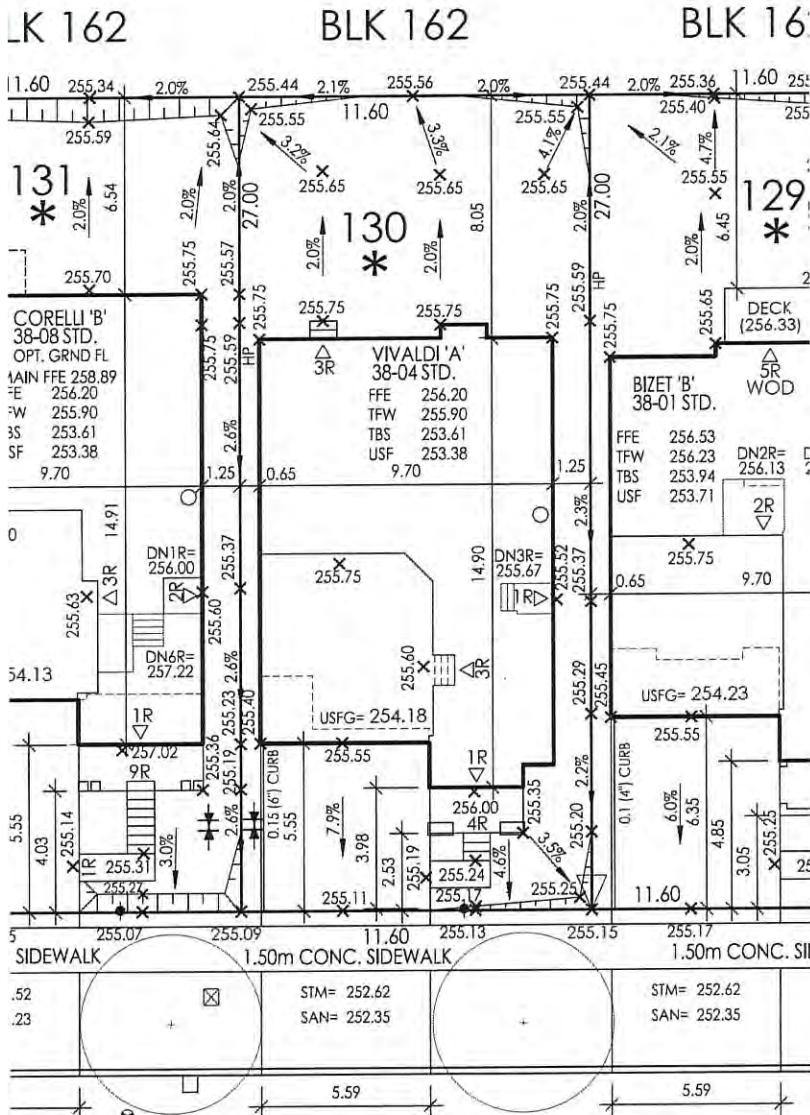

WAINWRIGHT DRIVE

#### URBANTECH NOTES:

- 1) No final utility location information at this time. Urbantech will not be responsible for future changes to design. Builder should notify purchaser's that street hardware and above ground utility furniture may be added or removed from their frontages.
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- 4) Builder to verify location of all hydrants, street lights, transformers and all other services. If min. dimensions are not maintained as per City standards, builder is to relocate at his own expense.
- 5) Builder to confirm service connection elevations and review for absence of conflict prior to footing excavation.
- 6) Final fence design have not been provided at this time. Purchaser to be advised that actual fencing details may not be as shown on this plan.

#### URBANTECH CONSULTING

We certify that the proposed grades at the lot corners are correct, and that the lot grading of the subject lot is in conformity to the approved subdivision grading plans and City standards.

REVIEWED BY: MW DATE: Feb 7/20



WWW.RNDESIGN.COM  
T:905-738-3177  
WWW.THEPLUSGROUP.CA

#### DANIEL HANINEN

I, DANIEL HANINEN, DECLARE THAT I HAVE REVIEWED AND TAKEN DESIGN RESPONSIBILITY FOR THE DESIGN WORK ON BEHALF OF RN DESIGN LTD. UNDER DIVISION C, PART-3 SUBSECTION-3.2.4 OF THE BUILDING CODE. I AM QUALIFIED AND THE FIRM IS REGISTERED IN THE APPROPRIATE CLASSES / CATEGORIES.

QUALIFIED DESIGNER BCIN: 20888  
FIRM BCIN: 26995  
DATE: Feb-6-2020

SIGNATURE:

CLIENT

GOLD PARK HOMES

PROJECT/LOCATION

McLAUGHLIN AND MAYFIELD-PH2  
BRAMPTON, ON

DRAWING

SITE PLAN

DRAWN BY

DJH

SCALE

1:250

PROJECT No.

19037 (13098 Ph.2)

LOT NUMBER

LOT 130











