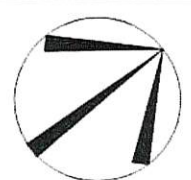


REG. PLAN No.	21T-1100988b
ZONE	R1F-9.0-2452
LOT NUMBER	LOT 99
LOT AREA(m) ²	326.00
BLDG AREA(m) ²	N/A
LOT COVERAGE(%)	N/A
No. OF STOREYS	2
MEAN HEIGHT(m)	8.82
PEAK HEIGHT(m)	N/A
DECK LINE(m)	N/A


LEGEND

FFE	FINISHED FLOOR ELEVATION		BELL PEDESTAL
FTW	TOP OF FOUNDATION WALL		CABLE PEDESTAL
TBS	TOP OF BASEMENT SLAB		CATCH BASIN
USF	UNDER SIDE FOOTING		DBL. CATCH BASIN
USFR	UNDER SIDE FOOTING - REAR		ENGINEERED FILL
USFG	UNDER SIDE FOOTING - GARAGE		HYDRO CONNECTION
TEF	TOP OF ENGINEERED FILL		FIRE HYDRANT
R	NUMBER OF RISERS TO GRADE		STREET LIGHT
WOD	WALKOUT DECK		MAIL BOX
LOB	LOOKOUT BASEMENT		TRANSFORMER
WOB	WALK OUT BASEMENT		SEWER CONNECTIONS 2 LOTS
REV	REVERSE PLAN		SEWER CONNECTIONS 1 LOT
STD	STANDARD PLAN		WATER CONNECTION
	DOOR		WATER VALVE CHAMBER
	WINDOW		HYDRANT AND VALVE
	AIR CONDITIONING		HYDRO METER
	DOWN SPOUT TO SPLASH PAD		GAS METER
	SWALE DIRECTION		MANHOLE - STORM
	SUMP PUMP		MANHOLE - SANITARY
<p>—X— CHAINLINK FENCE</p> <p>—XX— PRIVACY FENCE</p> <p>—XXX— SOUND BARRIER</p> <p>— — — — — FOOTING TO BE EXTENDED TO 1'22 (MIN) BELOW GRADE</p>			


[illegible]

Imagery • Inquiry • Create **RN DESIGN LTD.**
8395 JANE STREET, SUITE 203
VAUGHAN, ONTARIO. L4K 5Y2
T:905-738-3177 | F: 905-738-5449

I, DANIEL HANNINEN DECLARE THAT I HAVE REVIEWED AND
TAKEN DESIGN RESPONSIBILITY FOR THE DESIGN WORK ON
BEHALF OF IN DESIGN LTD UNDER DIVISION C PART-3
SUBSECTION 3-2.4 OF THE BUILDING CODE. I AM QUALIFIED
AND THE FIRM IS REGISTERED IN THE APPROPRIATE CLASSES /
CATEGORIES
QUALIFIED DESIGNER BCIN: 20888
FIRM BCIN: 26995
DATE: JUN 19/19

SIGNATURE: 

CLIENT		GOLD PARK HOMES	
PROJECT/LOCATION			
McLAUGHLIN AND MAYFIELD-PH2 BRAMPTON, ON			
DRAWING		SITE PLAN	
DRAWN BY RP		SCALE 1:250	
PROJECT No. 13098-PH-2		LOT NUMBER LOT 99	

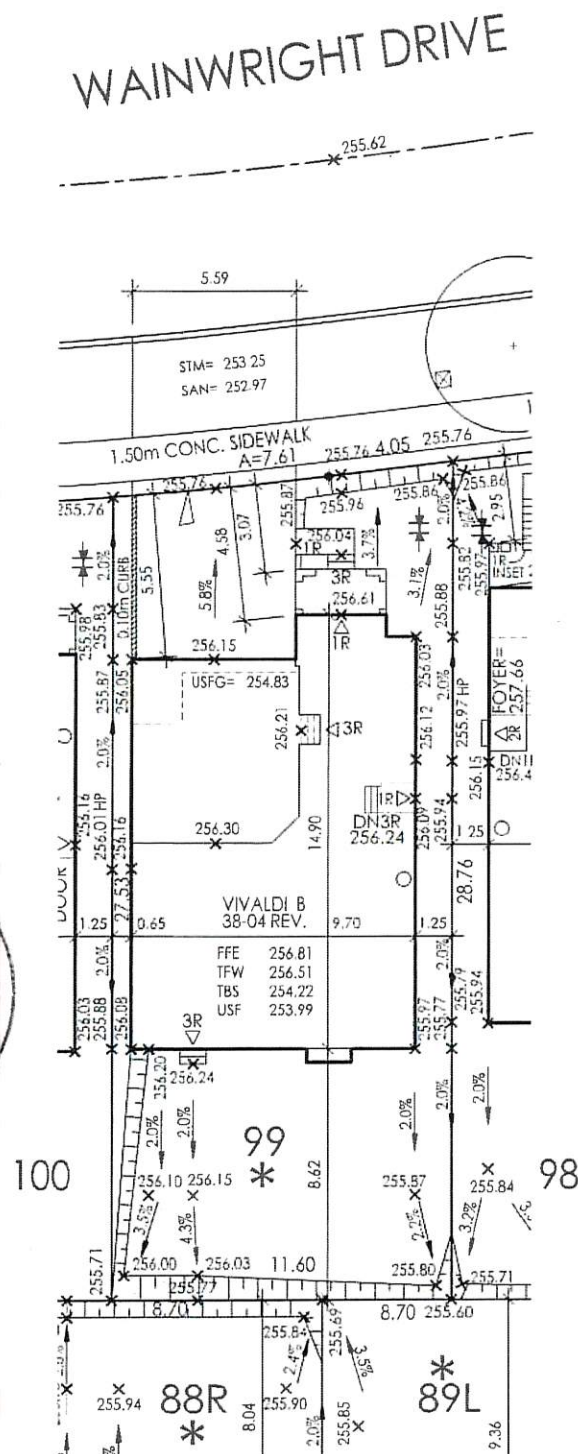

- 1) No final utility location information at this time. UrbanTech will not be responsible for future changes to design. Builder should notify purchaser's that street hardware and above ground utility furniture may be added or removed from their frontages
- 2) Builder to lower underside of footings where adjacent to RLCB leads. Exact depth to be determined on site during facing excavation.
- 3) Builder to stake out driveway curb depressions at time of curb installation
- 4) Builder to verify location of all hydrants, street lights, transformers and all other services. If min. dimensions are not maintained as per City standards, builder is to relocate at his own expense.

5) Builder to confirm service connection elevations and review for absence of conflict prior to footing excavation

6) Final fence design have not been provided at this time. Purchaser to be advised that actual fencing details may not be as shown on this plan.

We certify that the proposed grades at the lot corners are correct, and that the lot grading of the subject lot is in conformity to the approved subdivision grading plans and City standards.

REVIEWED BY: M.W DATE: Jul 3/19

It is the builder's complete responsibility to ensure that all plans submitted for approval fully comply with the Architectural Guidelines and all applicable regulations and requirements including zoning provisions and any provisions in the subdivision agreement. The Control Architect is not responsible in any way for examining or approving site (lotting) plans or working drawings with respect to any zoning or building code or permit matter or that any house can be properly built or located on its lot.

This is to certify that these plans comply with the applicable Architectural Design Guidelines approved by the City of BRAMPTON

JOHN G. WILLIAMS LTD., ARCHITECT
ARCHITECTURAL CONTROL REVIEW
AND APPROVAL

APPROVED BY: _____
DATE: JUL 11, 2019

This stamp certifies compliance with the applicable Design Guidelines only and bears no further professional responsibility.