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This is to certify that these plans comply with the applicable Architectural Design Guidelines approved by the BRADFORD / WEST GWILLIMBURY.

JOHN G. WILLIAMS LTD., ARCHITECT
ARCHITECTURAL CONTROL REVIEW
AND APPROVAL
APPROVED BY: *[Signature]*
DATE: **MAR 15, 2022**
This stamp certifies compliance with the applicable Design Guidelines only and bears no further professional responsibility.


TOWN OF BRADFORD WEST GWILLIMBURY - BUILDING DEPARTMENT
REVIEWED
INSPECTOR: *[Signature]*
DATE: **Sept. 1, 2022**
PERMIT NO.: **MODEL CERT.**
ALL CONSTRUCTION SHALL COMPLY WITH THE ONTARIO BUILDING CODE AND ALL OTHER APPLICABLE STATUTORY REGULATIONS. THE REVIEWED DOCUMENTS MUST BE KEPT ON SITE AT ALL TIMES.
INSPECTION REQUEST EMAIL: BUILDINGSPECTIONS@TOWNOFBWG.COM
INSPECTION REQUEST FAX: (905) 778-2035
INSPECTION REQUEST TELEPHONE: (905) 778-2035 EXT. 1500



MAR 8, 2022

NOTE:
ALL LVL'S SUPPORTING FLOOR LOADS ARE TO BE SPECIFIED BY THE FLOOR TRUSS MANUFACTURER.

NOTE:
FLOOR FRAMING INFO REFER TO ENG SHOP DRAWINGS FOR ALL TRUSS-JOIST INFORMATION AND DETAILS. UNLESS OTHERWISE NOTED.

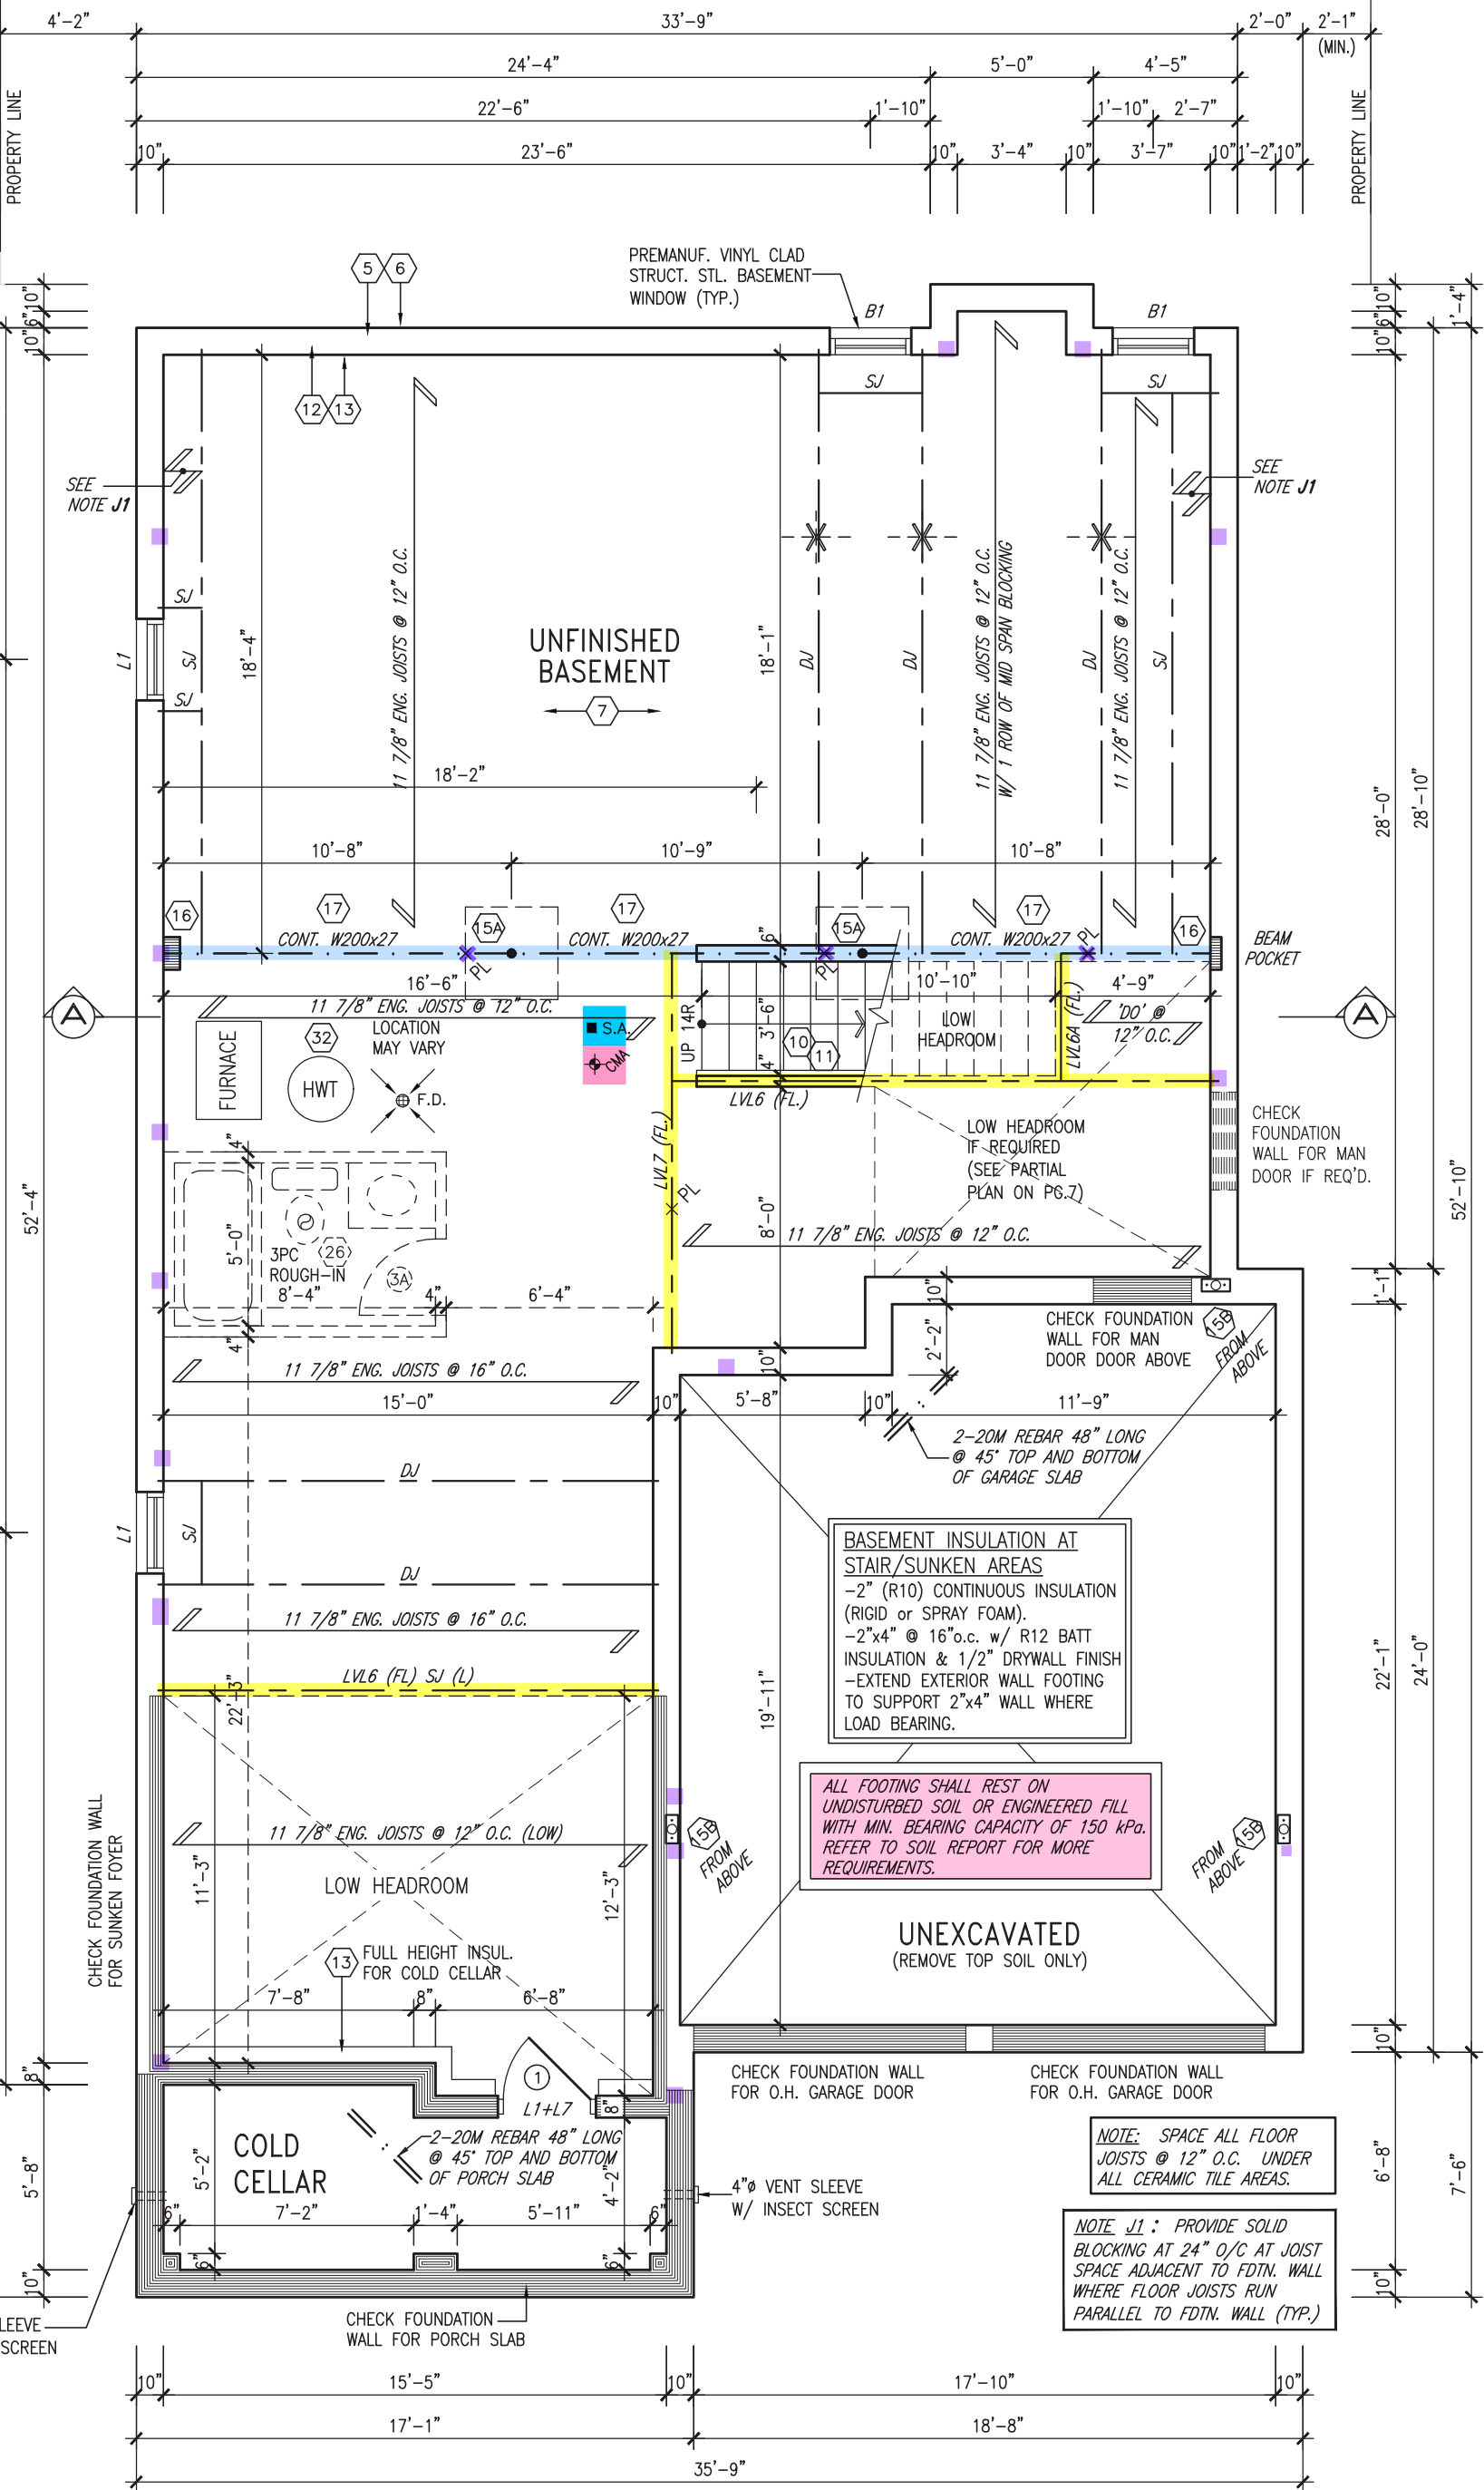

BASEMENT PLAN 'A'

AREA CHART ON PAGE 18

9	REVIEWED
8	
7	
6	
5	
4	
3	REVISED AS PER ENG COMMENTS
2	REVISED AS PER FLOOR / ROOF LAYOUT
1	ISSUED FOR CLIENT REVIEW
no.	description

The undersigned has reviewed and takes responsibility for this design and has the qualifications and meets the requirements set out in the Ontario Building Code to be a Designer.		
qualification information		
Wellington Jno-Baptiste	signature	25591
name		BCIN
registration information		42658
VA3 Design Inc.		
Contractor must verify all dimensions on the job and report any discrepancy to the Designer before proceeding with the work. All drawings and specifications are instruments of service and the property of the Designer which must be returned at the completion of the work. Drawings are not to be scaled.		
no.	description	date


VA3 DESIGN
255 Consumers Rd Suite 120
Toronto ON M2J 1R4
t 416.630.2255 f 416.630.4782
va3design.com

BAYVIEW WELLINGTON		S42-19	
project name	GREEN VALLEY EAST	municipality	BRADFORD, ONTARIO
date	OCTOBER 2021	checked by	JWM
drawn by	TP	scale	3/16" = 1'-0"
BASEMENT PLAN 'A'		file name	16023-S42-19
RICHARD - H:\ARCHIVE\WORKING\2016\16023.BW\Units\42\16023-S42-19.dwg - Tue - Mar 8 2022 - 1:00 PM		project no.	16023
		drawing no.	1

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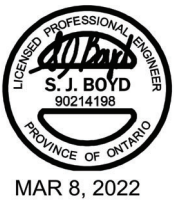
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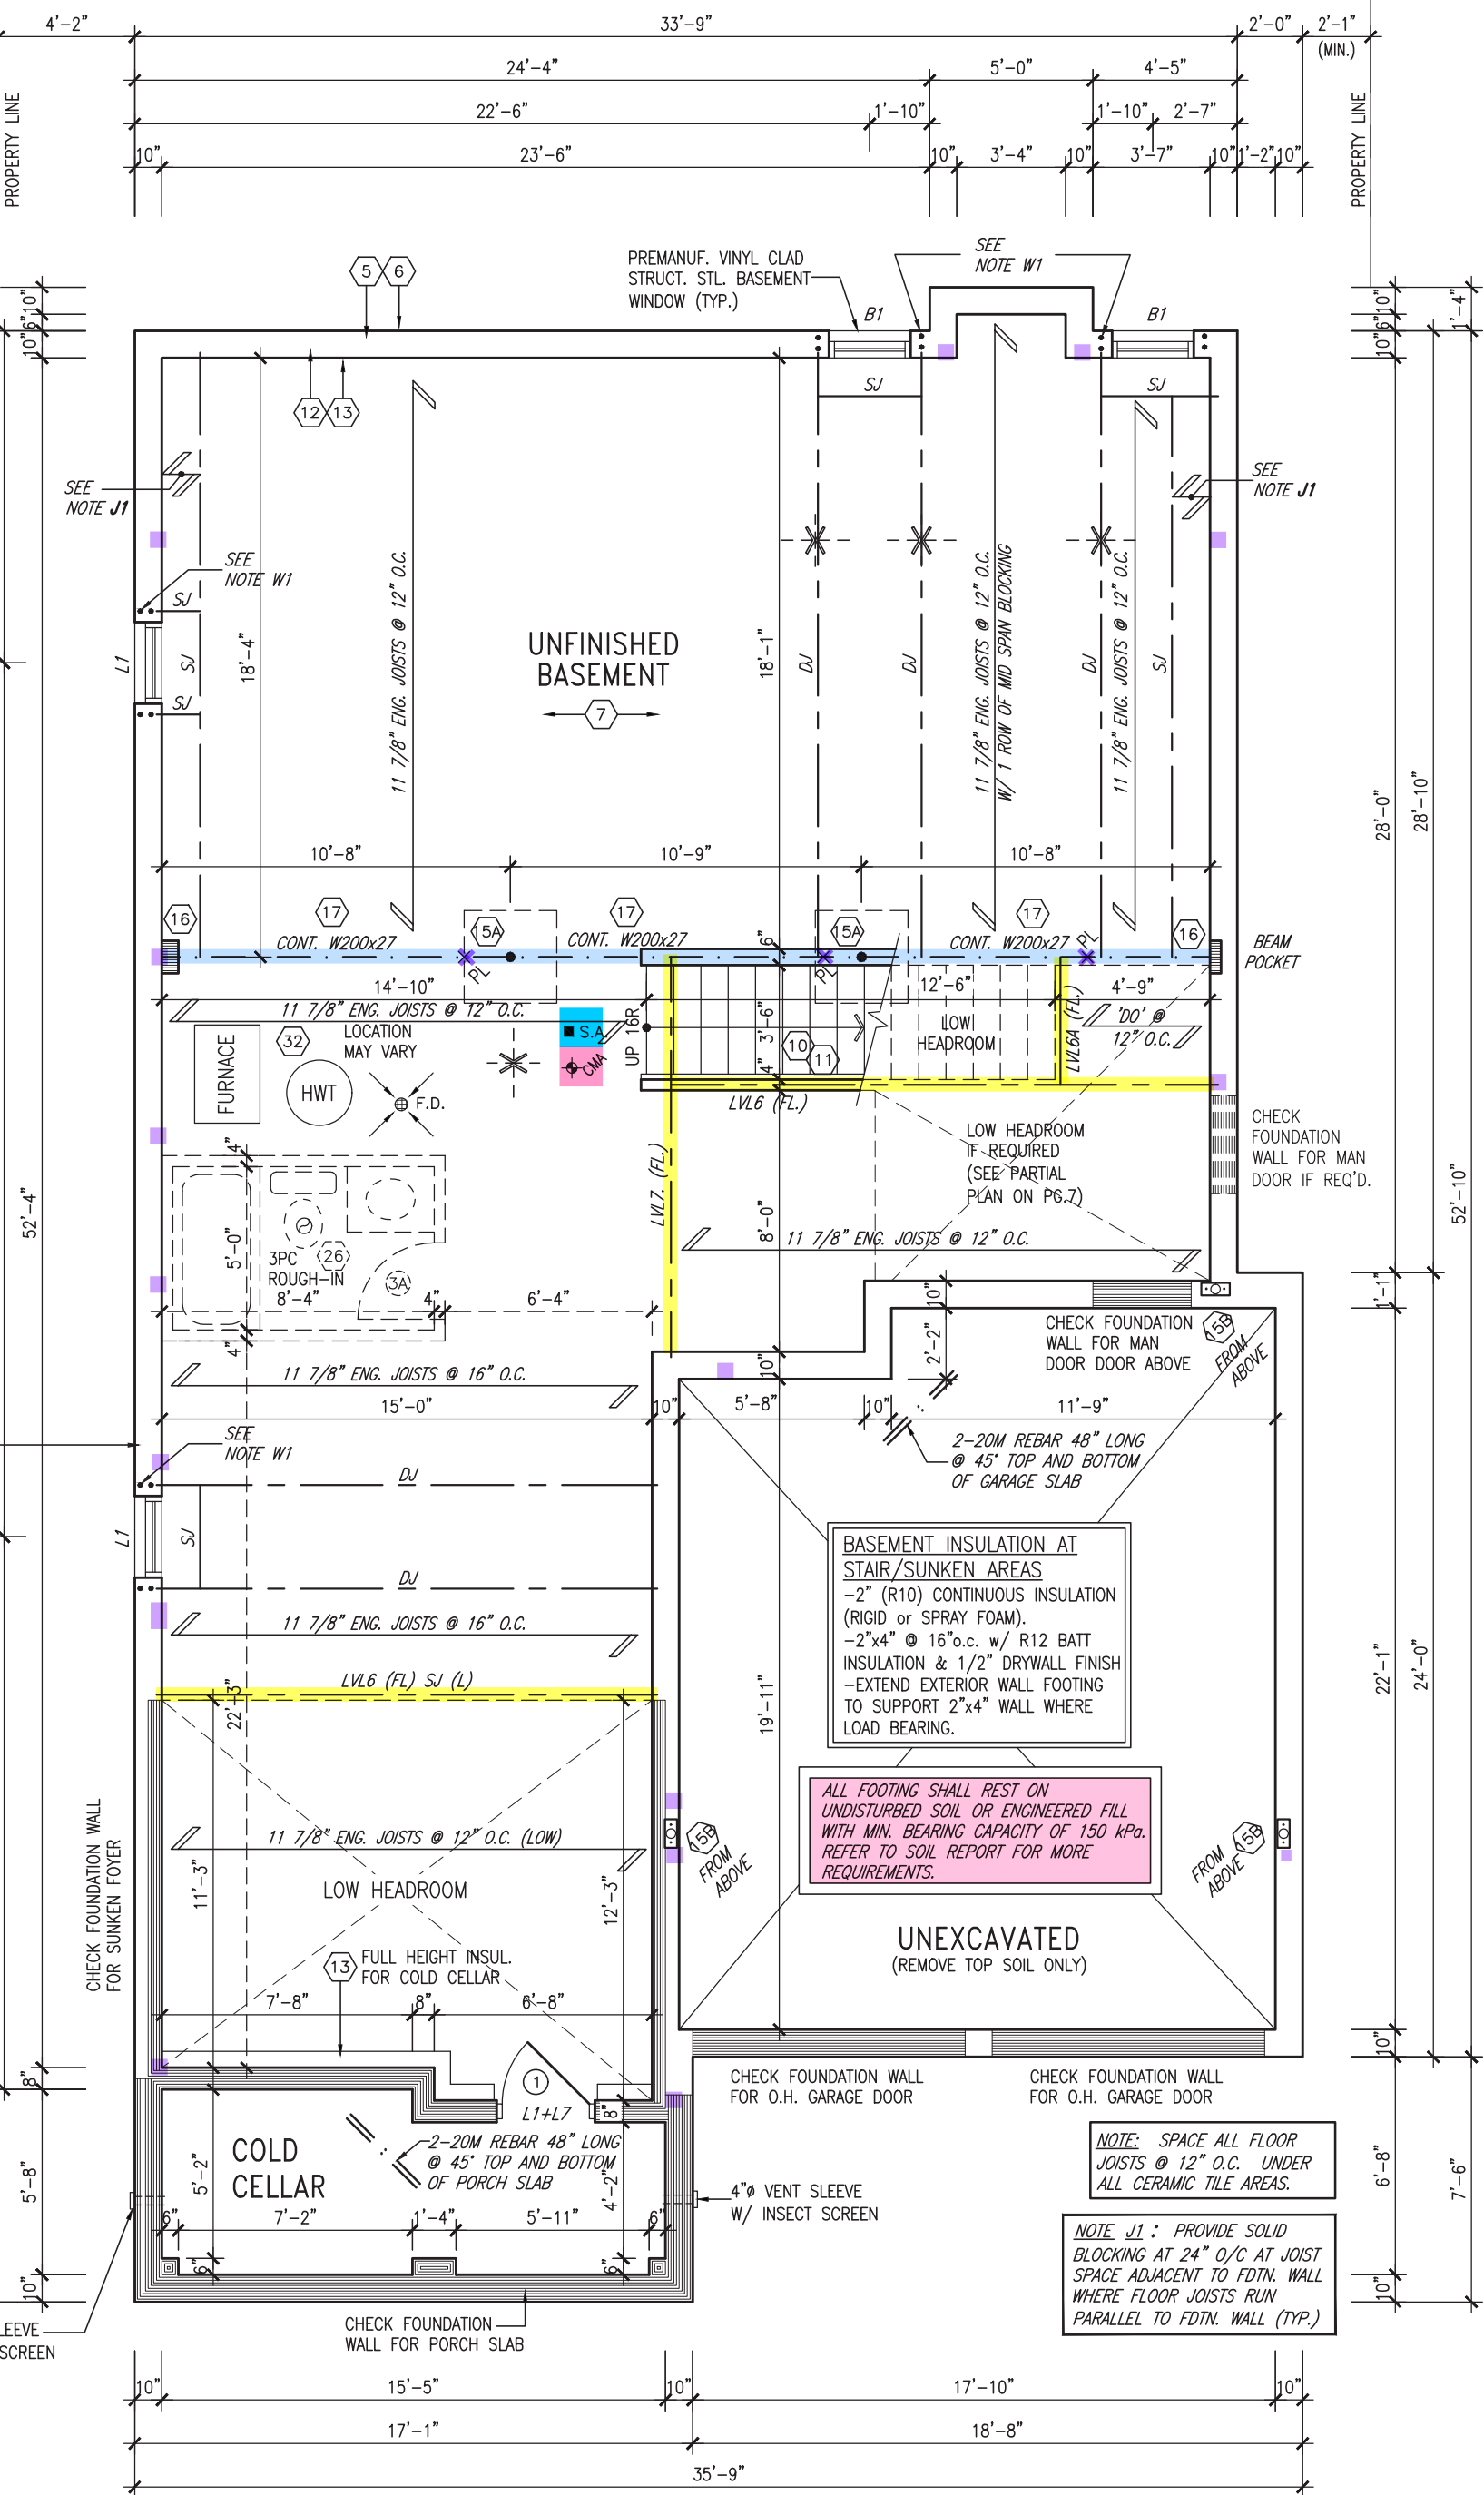
NOTE W1
PROVIDE 2-15M FULL
HEIGHT VERTICAL REBARS
EACH SIDE OF OPENING
+ 2-15M HORIZ. REBARS
BELOW AND EXTEND 24"
BEYOND OPENING
PROVIDE 3" CLEAR COVER
FROM SOIL SIDE

SEE DETAIL S4
FOR 9'-0"
BASEMENT COND



NOTE:
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ARE TO BE SPECIFIED BY THE FLOOR
TRUSS MANUFACTURER.

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SHOP DRAWINGS FOR ALL TRUSS-JOIST
INFORMATION AND DETAILS. UNLESS
OTHERWISE NOTED.




OPT. 9'-0" BASEMENT PLAN 'A'

AREA CHART ON PAGE 18

9	REVIEWED		
8			
7			
6			
5			
4			
3	REVISED AS PER ENG COMMENTS	MAR 03-22	RC
2	REVISED AS PER FLOOR / ROOF LAYOUT	FEB 24-22	RC
1	ISSUED FOR CLIENT REVIEW	NOV 26-21	VA3
no.	description	date	by

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qualification information
Wellington Jno-Baptiste  25591
name BCIN
registration information
VA3 Design Inc. 42658

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VA3 DESIGN

255 Consumers Rd Suite 120
Toronto ON M2J 1R4
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va3design.com

BAYVIEW WELLINGTON		S42-19	
project name	GREEN VALLEY EAST	municipality	BRADFORD, ONTARIO
date	OCTOBER 2021	checked by	JWM
drawn by	TP	scale	3/16" = 1'-0"
file name	16023-S42-19	drawing no.	1A
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JOHN G. WILLIAMS LTD., ARCHITECT
ARCHITECTURAL CONTROL REVIEW
AND APPROVAL

APPROVED BY:

DATE: MAR 15, 2022

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MAR 8, 2022

NOTE:
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NOTE:
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NOTE:
SPACE ALL FLOOR JOISTS @ 12" O.C. UNDER ALL CERAMIC TILE AREAS.

DOOR HEIGHTS	
CEILING HEIGHT	DOOR HEIGHT
11'0" or greater	8'0" (96")
10'0"	8'0" (96")
9'0"	6'8" (80")
8'0" or lower	6'8" (80")

CONTRACTOR TO CONFIRM HEIGHTS WITH BUILDER

9	REVIEWED		
8			
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5			
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signature
BCIN
VA3 Design Inc. 42658
registration information

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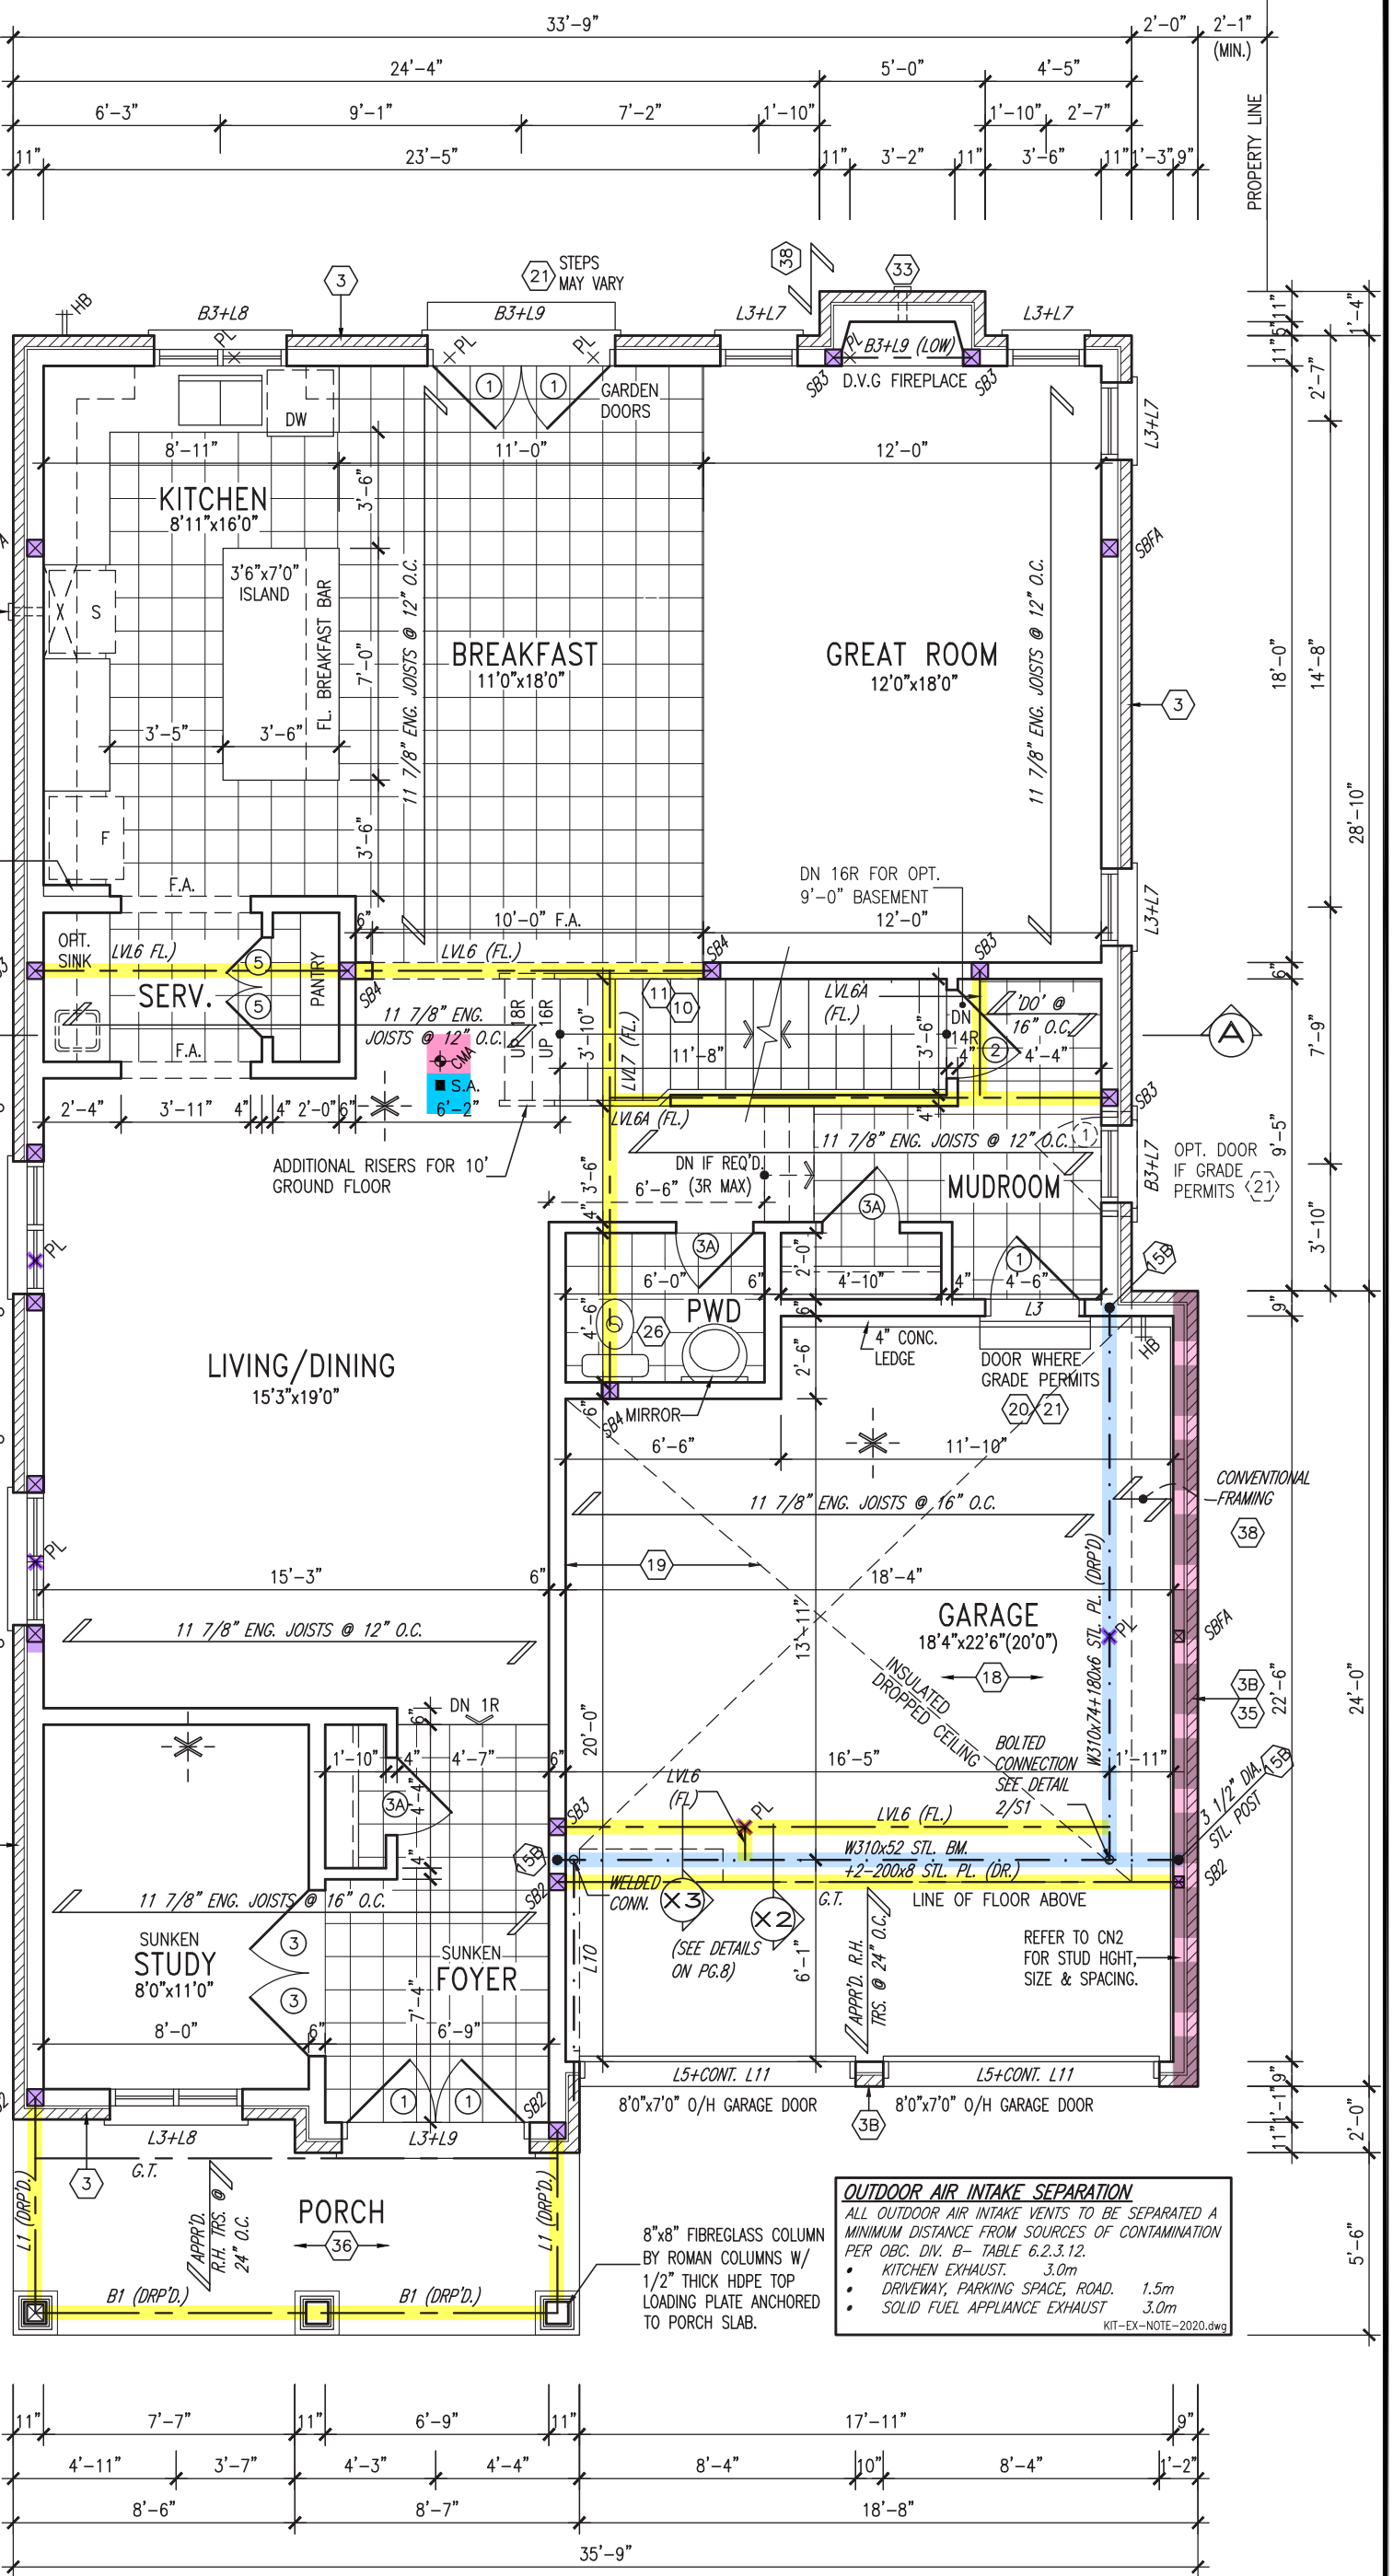
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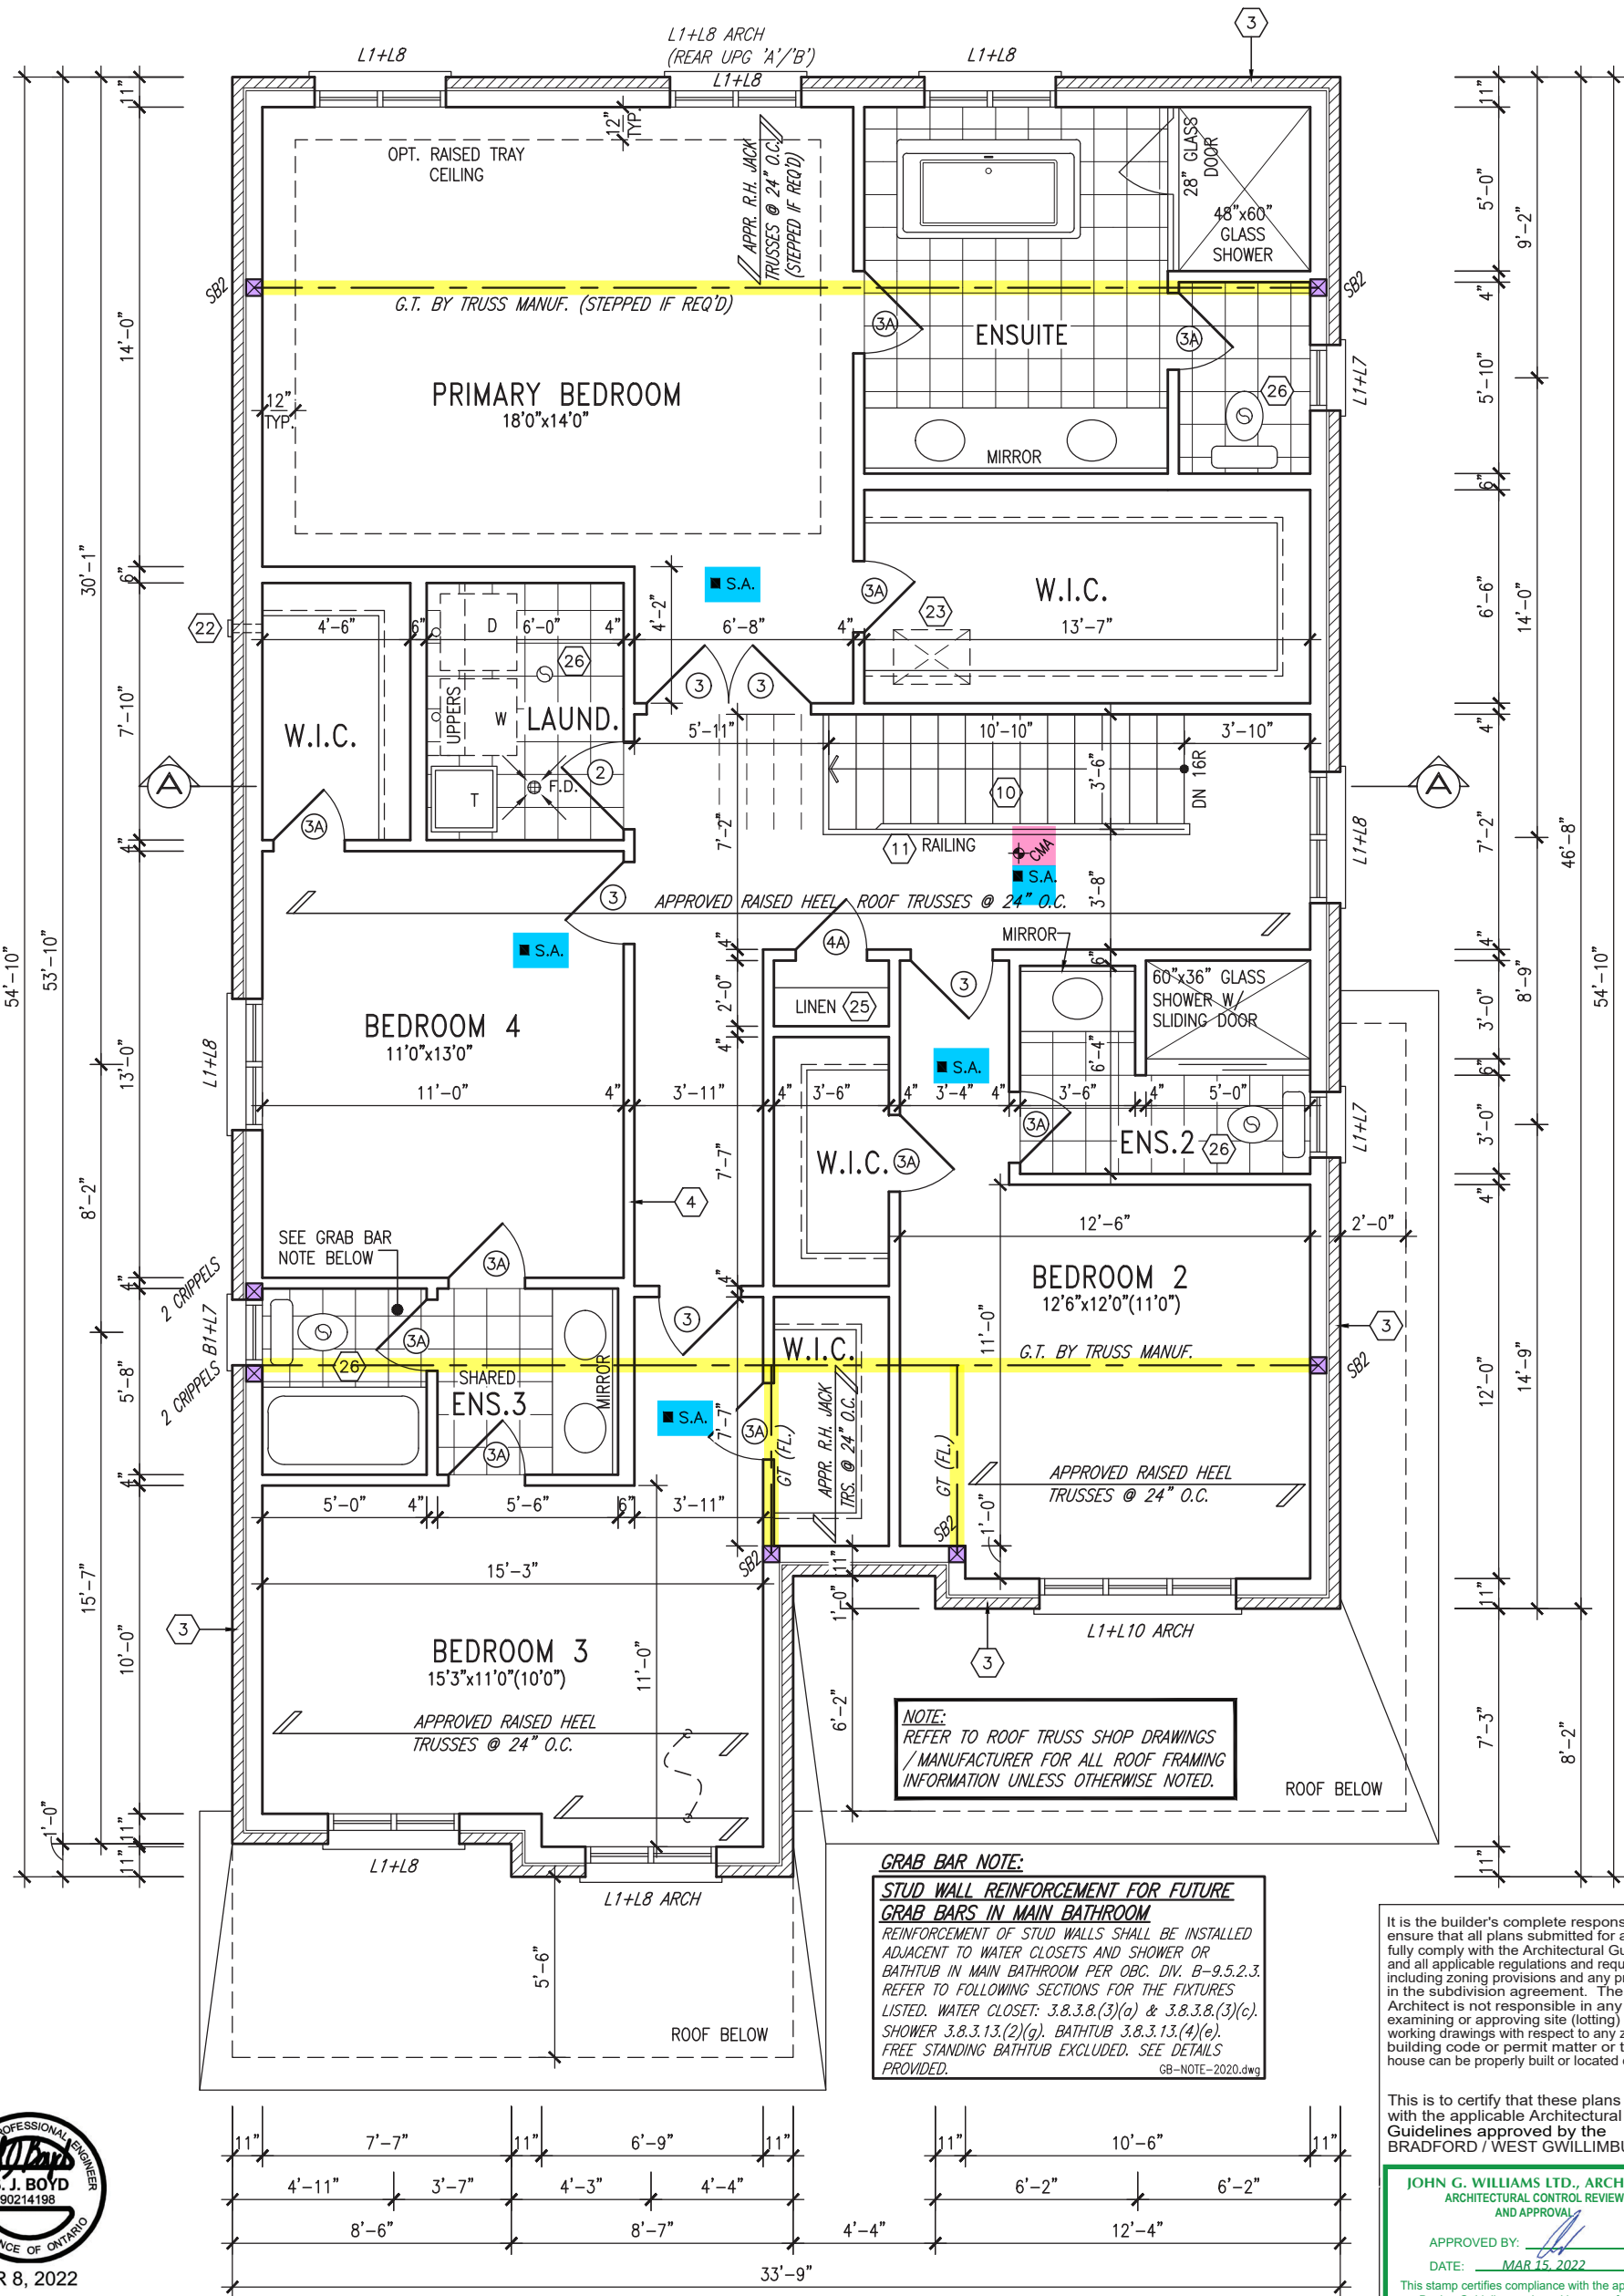
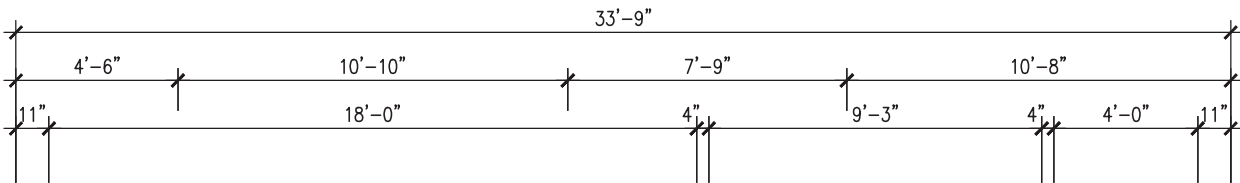
255 Consumers Rd Suite 120
Toronto ON M2J 1R4
t 416.630.2255 f 416.630.4782
va3design.com

BAYVIEW WELLINGTON		S42-19	
project name	GREEN VALLEY EAST	municipality	BRADFORD, ONTARIO
date	OCTOBER 2021	project no.	16023
drawn by	TP	checked by	JWM
scale	3/16" = 1'-0"	file name	16023-S42-19
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GROUND FLOOR PLAN 'A'		drawing no.	
		2	

GROUND FLOOR PLAN 'A'

INDICATES REDUCED SIDE YARD





MAR 8, 2022

SECOND FLOOR PLAN 'A'

9	REVIEWED
8	
7	
6	
5	
4	
3	REVISED AS PER ENG COMMENTS
2	REVISED AS PER FLOOR / ROOF LAYOUT
1	ISSUED FOR CLIENT REVIEW
no.	description

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qualification information		
Wellington Jno-Baptiste	signature	25591
name		BCIN
VA3 Design Inc.		42658
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no.	description	date


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t 416.630.2255 f 416.630.4782
va3design.com

BAYVIEW WELLINGTON			S42-19		
project name GREEN VALLEY EAST			municipality BRADFORD, ONTARIO		
date OCTOBER 2021			project no. 16023		
drawing no.			SECOND FLOOR PLAN 'A'		
drawn by TP		checked by JWM		scale 3/16" = 1'-0"	
file name 16023-S42-19					
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APPROVED RAISED HEEL ROOF TRUSSES @ 24" O.C.



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ARCHITECTURAL CONTROL REVIEW
AND APPROVAL

APPROVED BY:
DATE: MAR 15, 2022
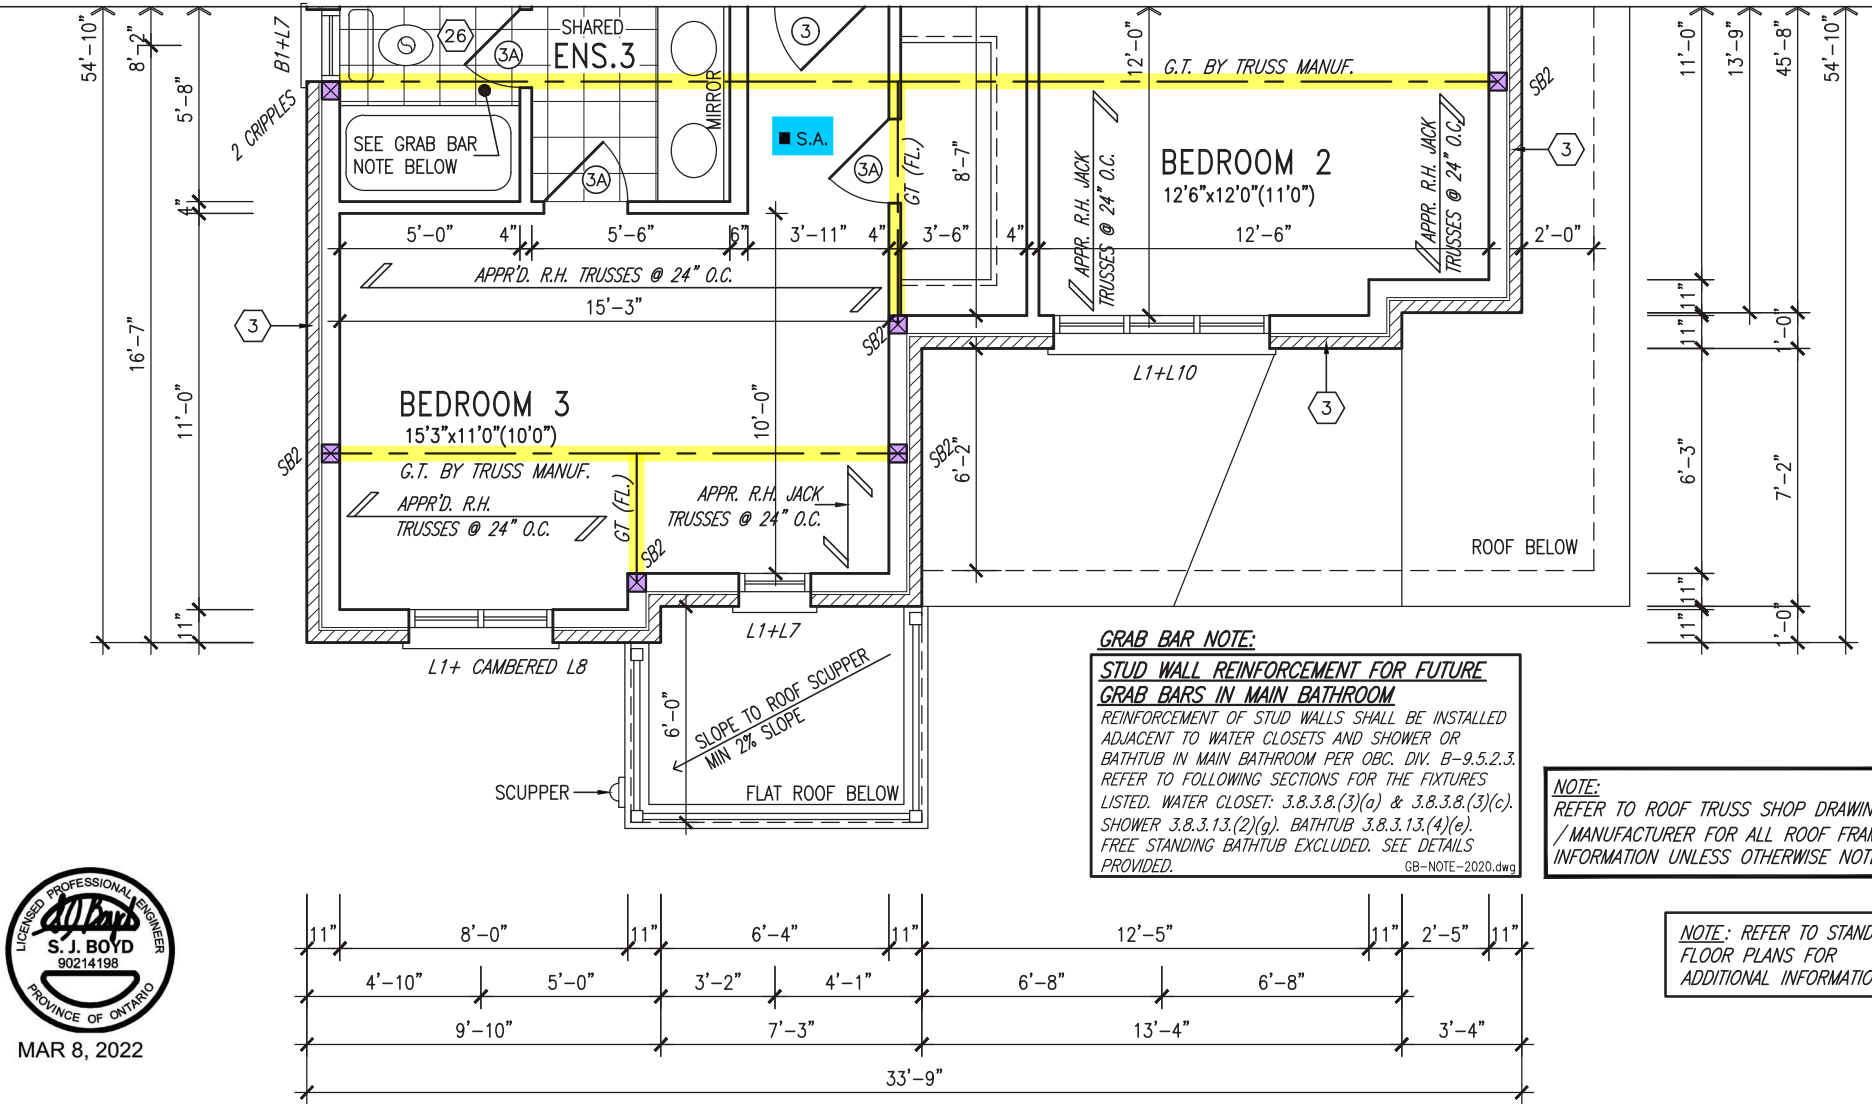
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PART. SECOND FLOOR PLAN 'B'

15C = 3 1/2"x3 1/2"x 1/4" SQUARE
H.S.S. 6x6x3/8" TOP AND BOTTOM
PL. BASE PLATE 4 1/2"x10 1/2"x
1/2" WITH 2- 1/2"x12"x2" HOOK
ANCHORS. FIELD WELD COLUMN TO
BASE PLATE

OUTDOOR AIR INTAKE SEPARATION

ALL OUTDOOR AIR INTAKE VENTS TO BE SEPARATED A MINIMUM DISTANCE FROM SOURCES OF CONTAMINATION PER OBC, DIV. B- TABLE 6.2.3.12.

- KITCHEN EXHAUST. 3.0m
- DRIVEWAY, PARKING SPACE, ROAD. 1.5m
- SOLID FUEL APPLIANCE EXHAUST. 3.0m


KIT-EX-NOTE-2020.dwg

NOTE:
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NOTE:
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NOTE:
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DOOR HEIGHTS	
CEILING HEIGHT	DOOR HEIGHT
11'0" or greater	8'0" (96")
10'0"	8'0" (96")
9'0"	6'8" (80")
8'0" or lower	6'8" (80")
CONTRACTOR TO CONFIRM HEIGHTS WITH BUILDER	



PART. GROUND FLOOR PLAN 'B'

9	REVIEWED	25591
8		BCIN
7		42658
6		
5		
4		
3	REVISED AS PER ENG COMMENTS	MAR 03-22 RC
2	REVISED AS PER FLOOR / ROOF LAYOUT	FEB 24-22 RC
1	ISSUED FOR CLIENT REVIEW	NOV 26-21 VA3
no.	description	date by
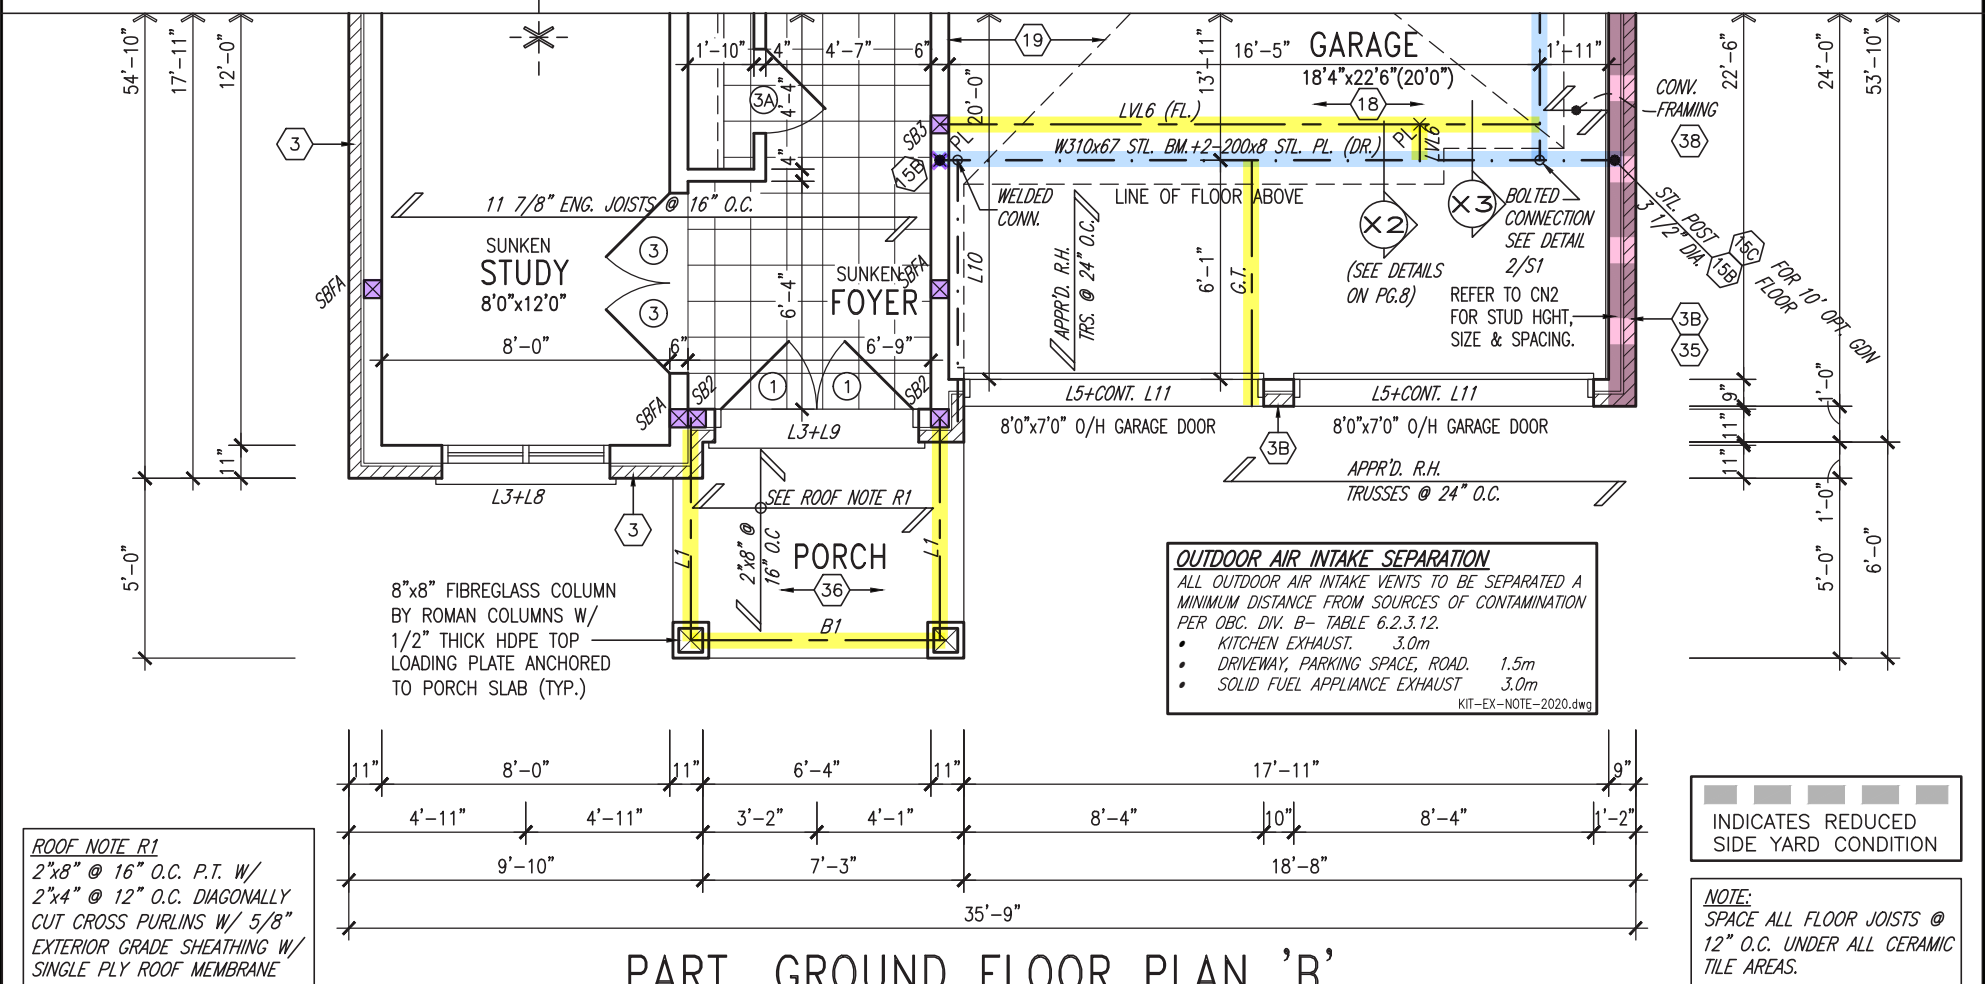
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qualification information
Wellington Jno-Baptiste 25591
signature
name
registration information
VA3 Design Inc. 42658

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VA3
DESIGN


255 Consumers Rd Suite 120
Toronto ON M2J 1R4
t 416.630.2255 f 416.630.4782
va3design.com

BAYVIEW WELLINGTON

S42-19

project name	GREEN VALLEY EAST	municipality	BRADFORD, ONTARIO	project no.	16023
date	OCTOBER 2021	checked by	JWM	scale	3/16" = 1'-0"
drawn by	TP	file name	16023-S42-19	drawing no.	4
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APPROVED RAISED HEEL ROOF TRUSSES @ 24" O.C.

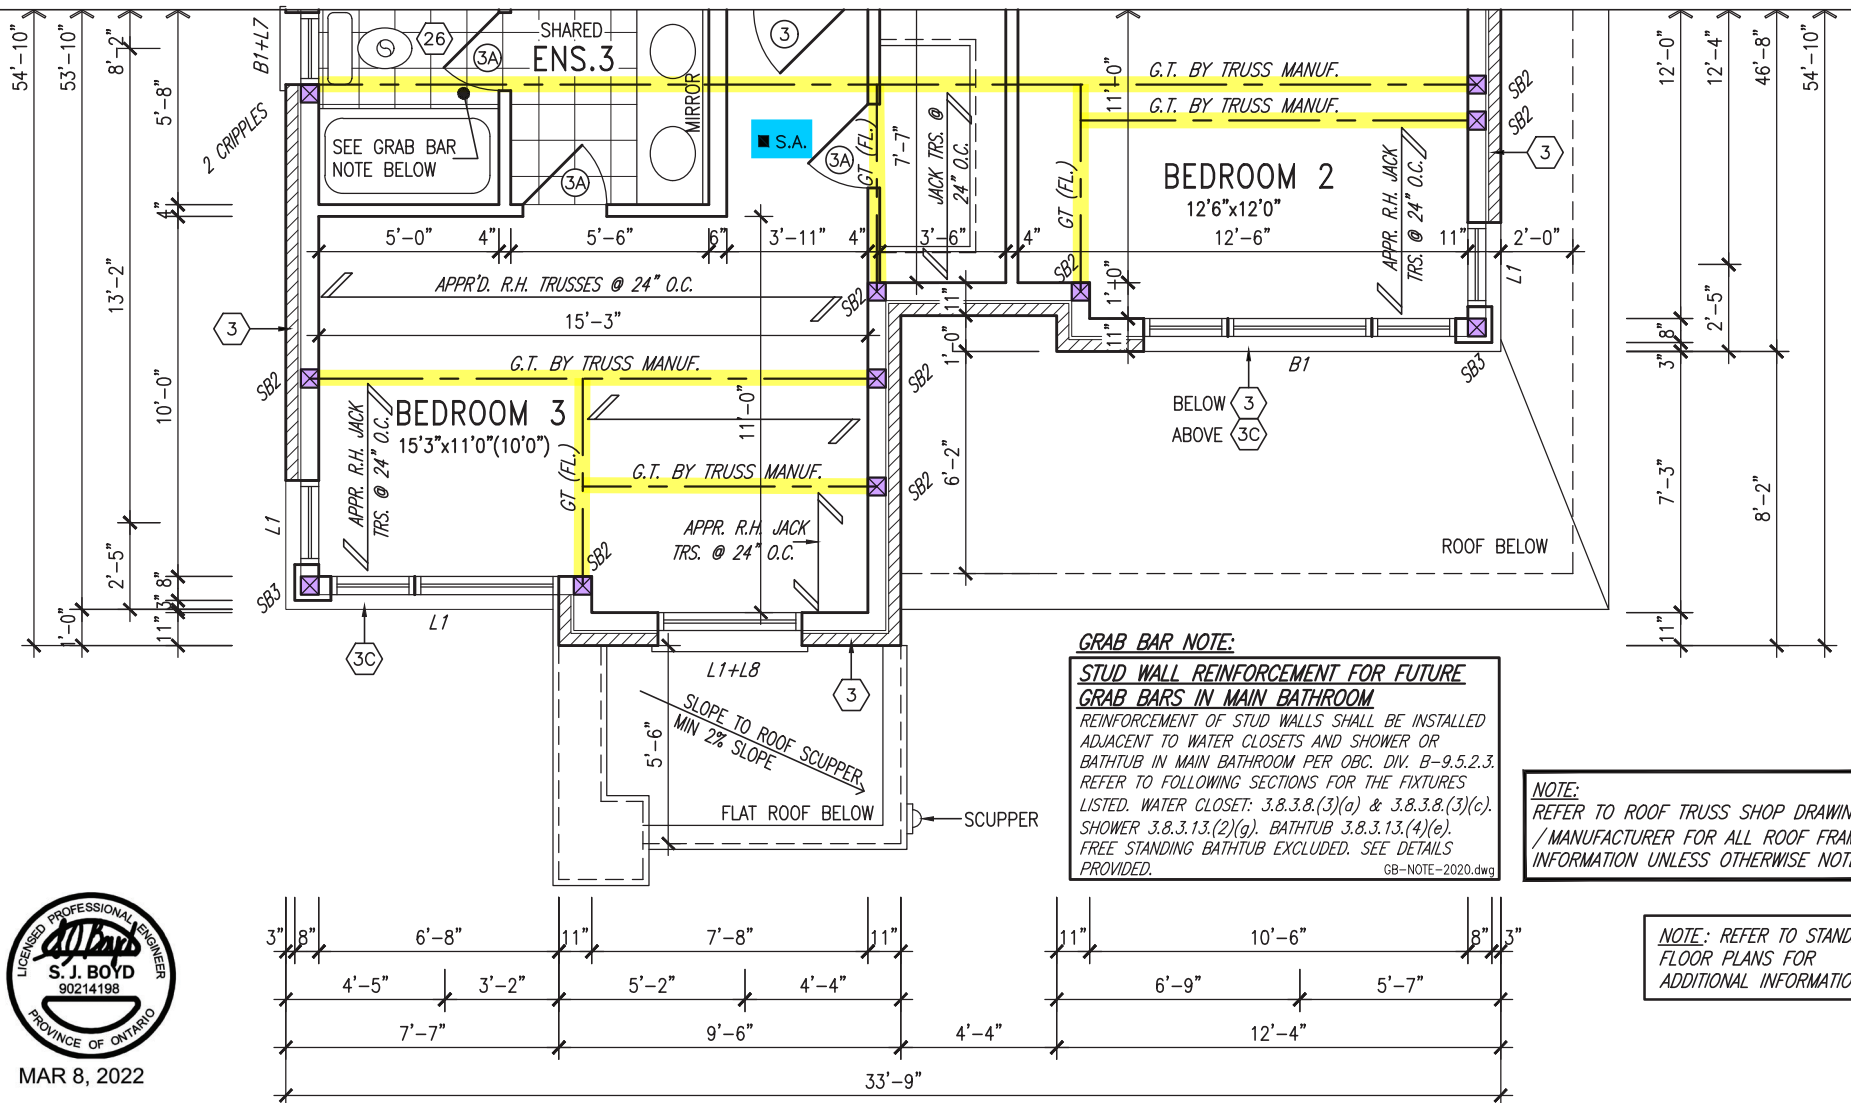

PART. SECOND FLOOR PLAN 'C'

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ARCHITECTURAL CONTROL REVIEW
AND APPROVAL

APPROVED BY:

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- KITCHEN EXHAUST: 3.0m
- DRIVEWAY, PARKING SPACE, ROAD: 1.5m
- SOLID FUEL APPLIANCE EXHAUST: 3.0m

KIT-EX-NOTE-2020.dwg


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9'0"	6'8" (80")
8'0" or lower	6'8" (80")

CONTRACTOR TO CONFIRM HEIGHTS WITH BUILDER



ROOF NOTE R1
2"x8" @ 16" O.C. P.T. W/
2"x4" @ 12" O.C. DIAGONALLY
CUT CROSS PURLINS W/ 5/8"
EXTERIOR GRADE SHEATHING W/
SINGLE PLY ROOF MEMBRANE

INDICATES REDUCED
SIDE YARD CONDITION

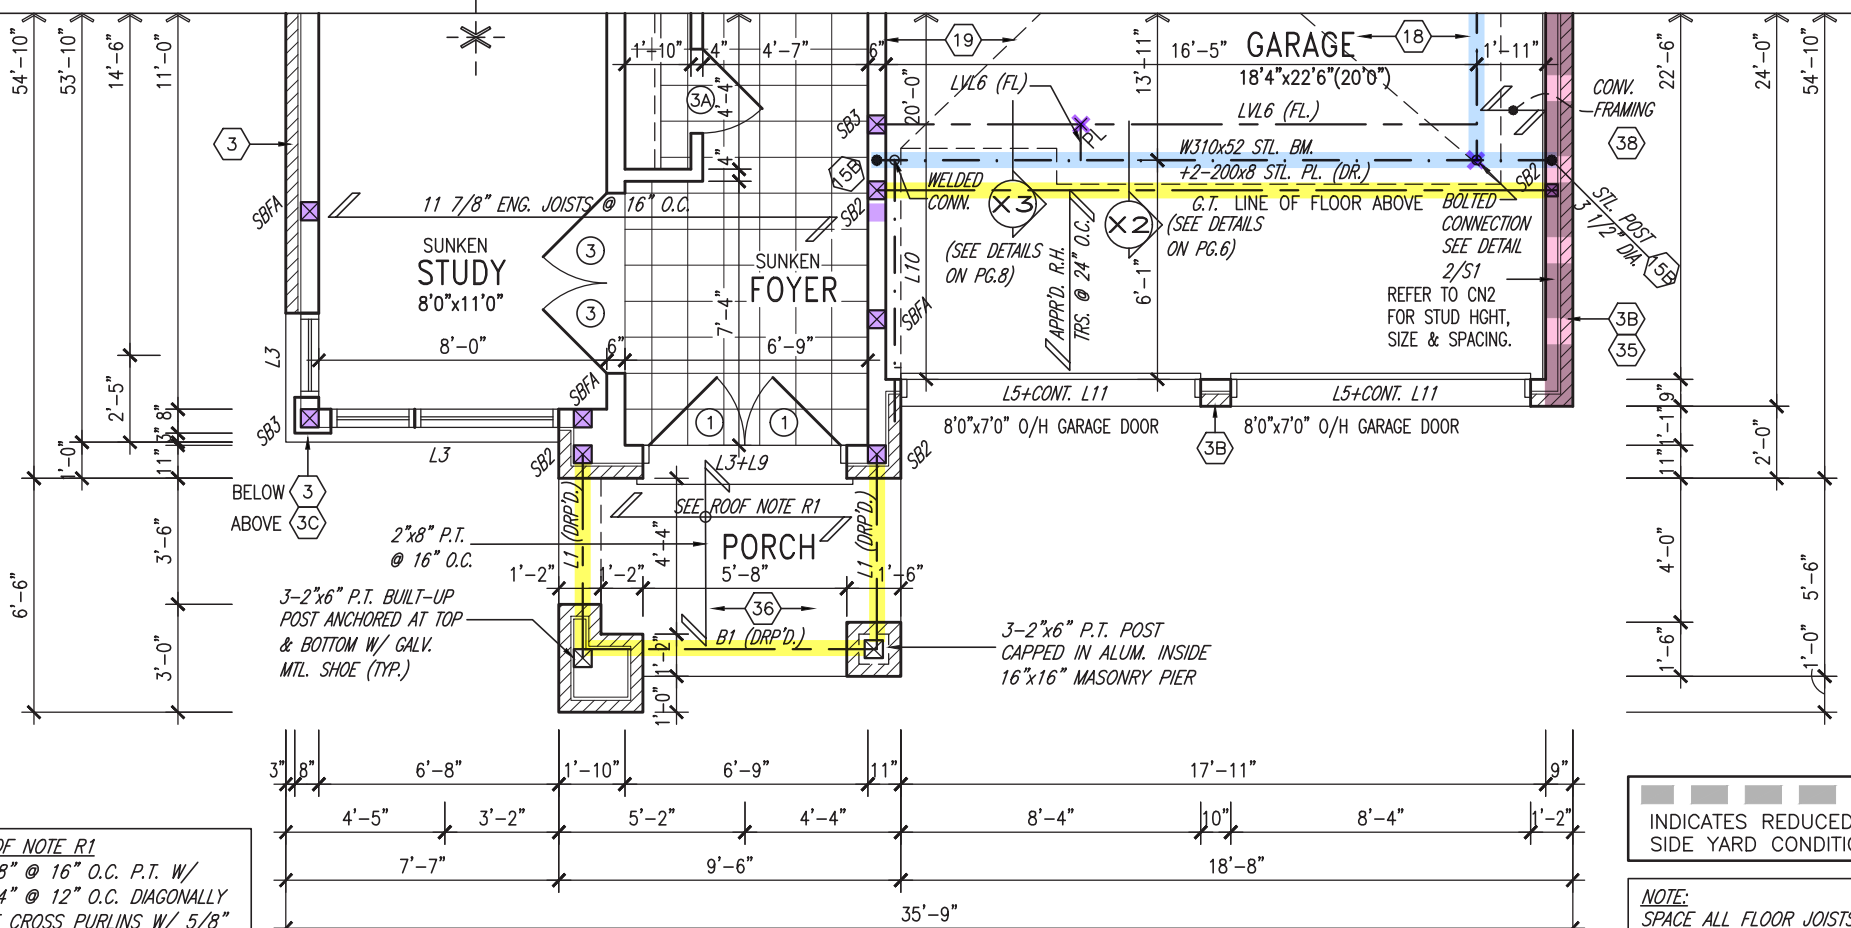NOTE:
SPACE ALL FLOOR JOISTS @
12" O.C. UNDER ALL CERAMIC
TILE AREAS.

PART. GROUND FLOOR PLAN 'C'

9	REVIEWED	25591
8		
7		
6		
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4		
3	REVISED AS PER ENG COMMENTS	MAR 03-22 RC
2	REVISED AS PER FLOOR / ROOF LAYOUT	FEB 24-22 RC
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qualification information
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signature
name
registration information
VA3 Design Inc.
42658

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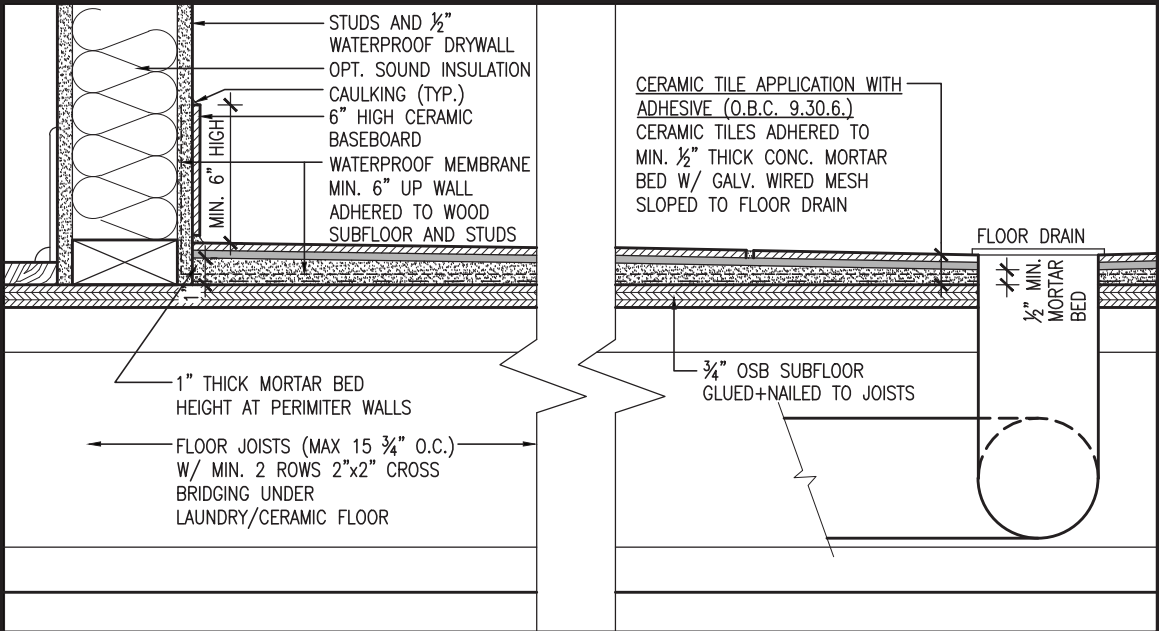
VA3
DESIGN

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t 416.630.2255 f 416.630.4782
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BAYVIEW WELLINGTON

S42-19

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date	OCTOBER 2021	checked by	JWM	scale	3/16" = 1'-0"
drawn by	TP	file name	16023-S42-19	drawing no.	5
PART. FLOOR PLANS 'C'					
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DETAIL THRU SLOPED CERAMIC FLOOR IN LAUNDRY


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APPROVED BY:
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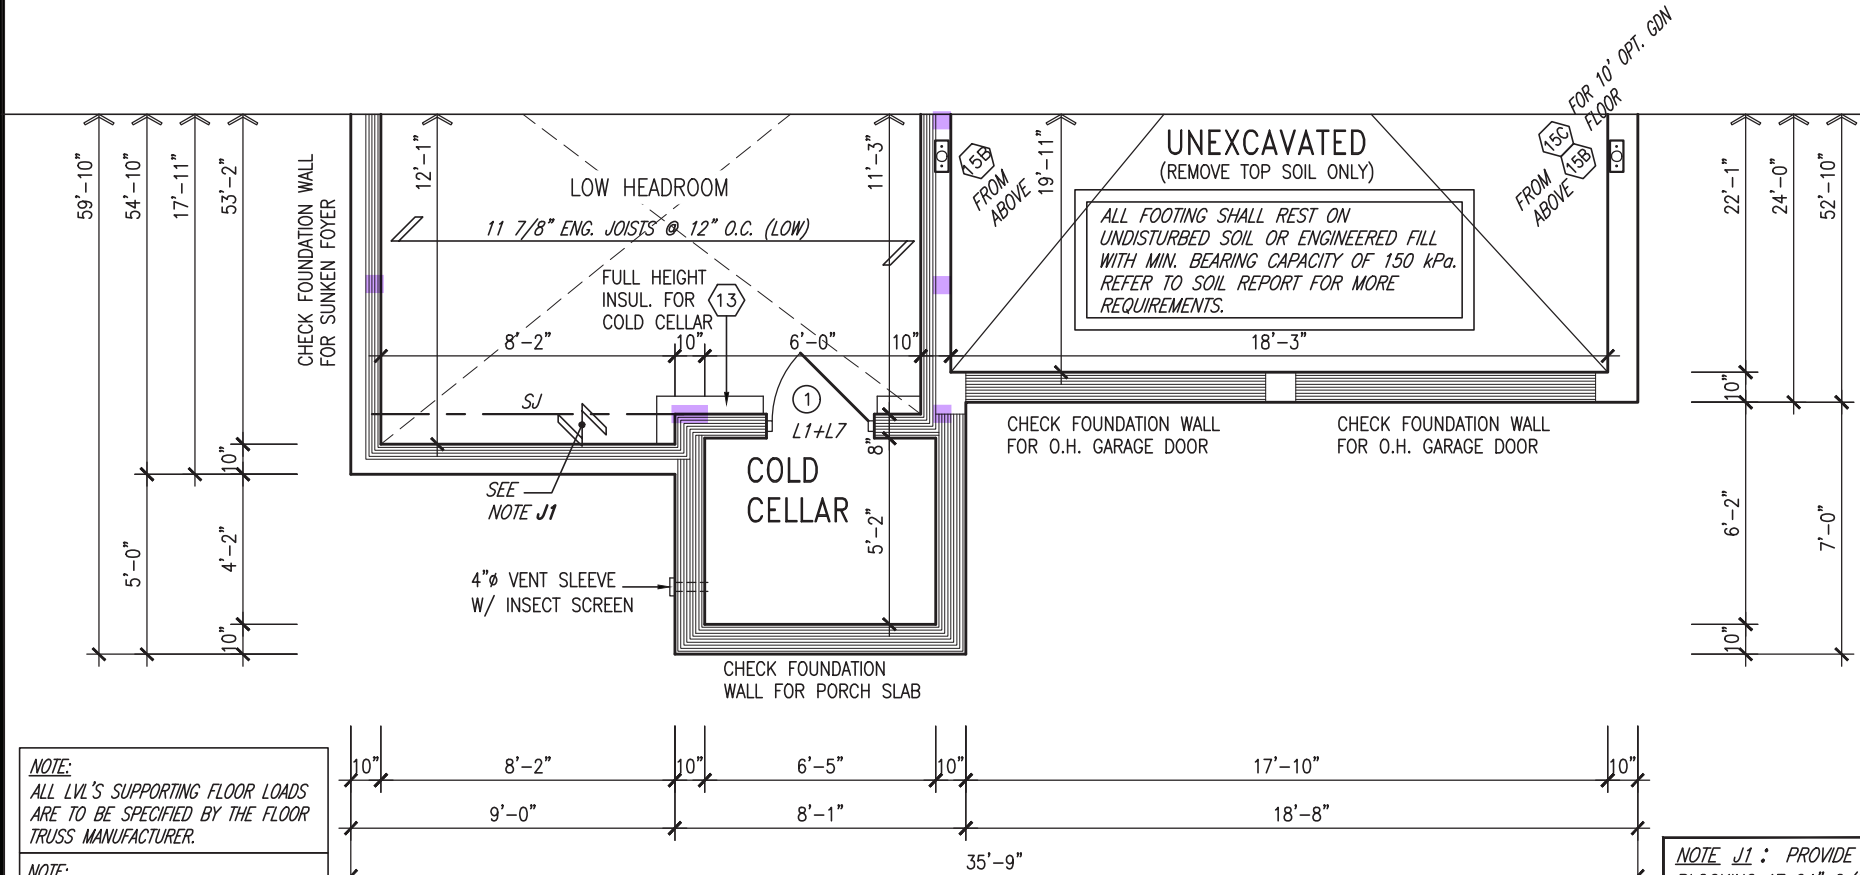
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PARTIAL BASEMENT PLAN 'C'



MAR 8, 2022



PARTIAL BASEMENT PLAN 'B'

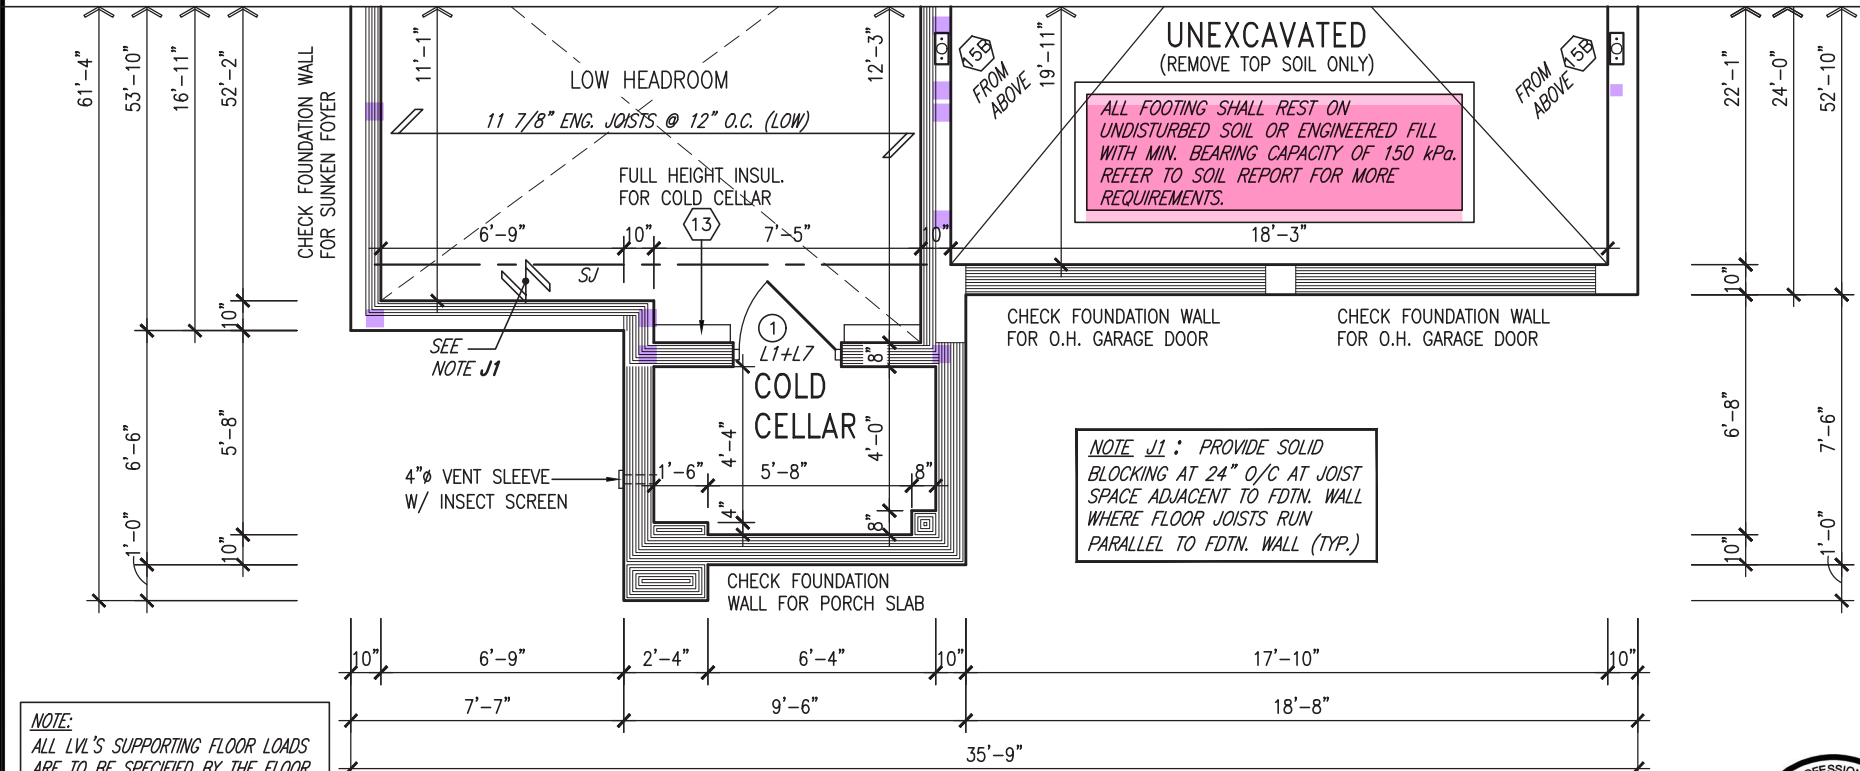
NOTE J1: PROVIDE SOLID BLOCKING AT 24" O/C AT JOIST SPACE ADJACENT TO FDTN. WALL WHERE FLOOR JOISTS RUN PARALLEL TO FDTN. WALL (TYP.)

9	REVIEWED	25591	42658
8			
7			
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1	ISSUED FOR CLIENT REVIEW	NOV 26-21	VA3
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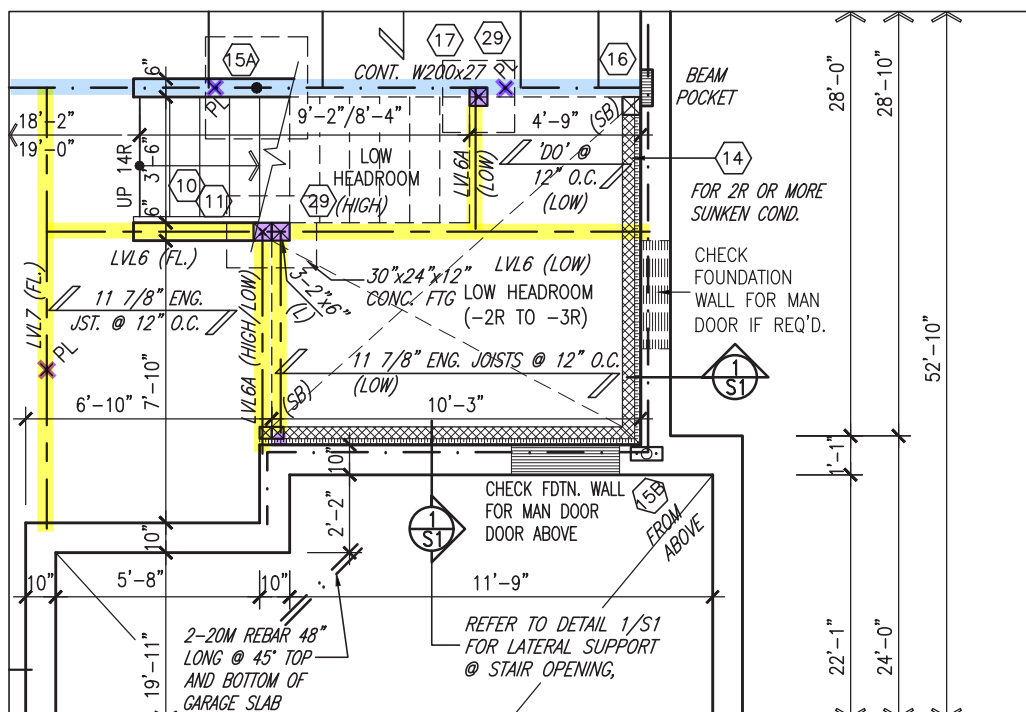
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BAYVIEW WELLINGTON		S42-19	
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GREEN VALLEY EAST		16023	
municipality		project no.	
BRADFORD, ONTARIO		16023	
date		drawing no.	
OCTOBER 2021		6	
drawn by		file name	
TP		16023-S42-19	
checked by		scale	
JWM		3/16" = 1'-0"	
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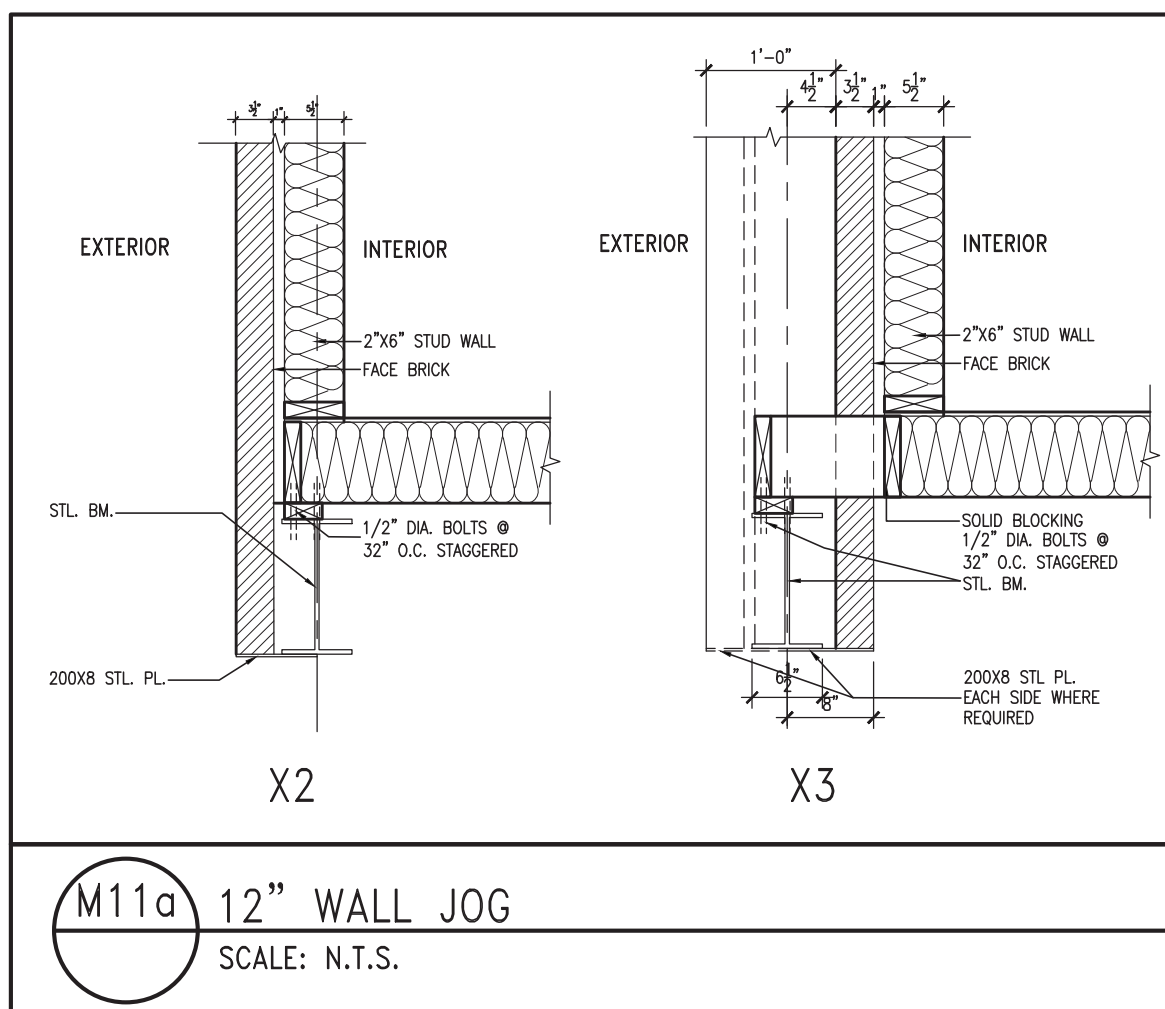
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ARCHITECTURAL CONTROL REVIEW
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REVIEW

9	REVIEW				The undersigned has reviewed and takes responsibility for this design and has the qualifications and meets the requirements set out in the Ontario Building Code to be a Designer.	
8					qualification information	
7					Wellington -no-Baptiste	25591
6					name	BCIN
5					signature	
4					registration information	
3	REVISED AS PER ENG COMMENTS	MAR 03-22	RC		VA3 Design Inc.	42658
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255 Consumers Rd Suite 120
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t 416.630.2255 f 416.630.4782
vg3design.com

BAYVIEW WELLINGTON

S42-19

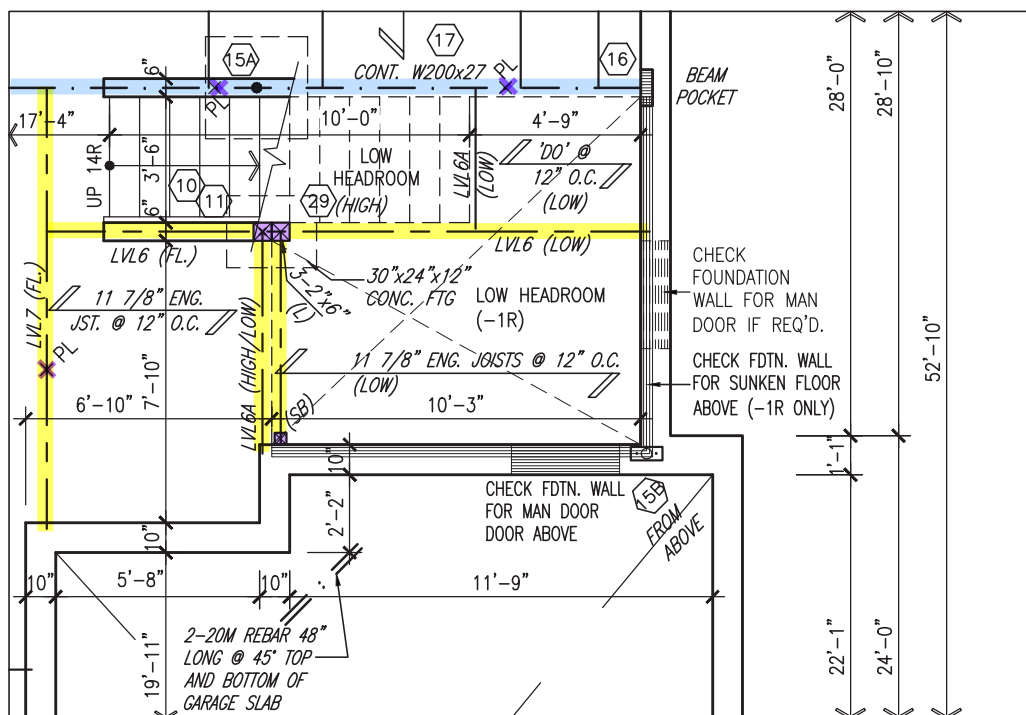project name	municipality
GREEN VALLEY EAST	BRADFORD, ONTARIO

Project no.	6023
-------------	------

date OCTOBER 2021 PART. BASEMENT PLANS & DETAILS

PART. BASEMENT PLANS & DETAILS

file name
16023-S42-19

awing no.

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NOTE: REFER TO FRONT
ELEVATION FOR TYPICAL
NOTE INFORMATION

This is to certify that these plans comply with the applicable Architectural Design Guidelines approved by the Town of BRADFORD WEST GWILLIMBURY.

APPROVED BY: _____

DATE: MAR 15, 2022

This stamp certifies compliance with the applicable Design Guidelines only and bears no further professional responsibility.

TOP OF PLATE

TOP OF WINDOW

JM. CLAD

— PREFIN. MTL. FLASHING,
W/ CAULKING TO MATCH
MASONRY COLOUR (TYP.)

FIN SECOND FLOOR

TOP OF TRANSOM

TOP OF WINDOW

8"x8" FIBREGLASS COLUMN BY
— ROMAN COLUMNS W/ 1/2"
THICK HDPE TOP LOADING
PLATE ANCHORED TO 16"x16"
MASONRY PIER. (TYP.)

FIN GROUND FLOOR

FIN GRADE

POURED CONC. FOUNDATION
WALLS AND FOOTINGS (TYP.)

TOP OF SLAB

LEFT SIDE ELEVATION 'A'

REVIEWED

he undersigned has reviewed and takes responsibility for this design and has the qualifications and meets the requirements set out in the Ontario Building Code to be a Designer.

Wellington Jno-Baptiste	signature	BCIN
25591		

0 registration information
VA3 Design Inc. 42658

drawings and specifications are instruments of service and the property of the Designer which must be returned at the completion of the work. All drawings are not to be scaled.

All draw

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S42-19

BAYVIEW WELLINGTON



255 Consumers Rd Suite 120
Toronto ON M2J 1R4
t 416.630.2255 f 416.630.4782
va3design.com

is specifications, related documents and d

BAYVIEW WELLINGTON	S42-19
project name GREEN VALLEY EAST	project no. 16023
municipality BRADFORD, ONTARIO	

code OCTOBER 2021 LEFT SIDE ELEVATION 'A' file name
 drawn by JWN 3/16" = 1'-0" 16023-S42-19
 title TP

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I, the undersigned has reviewed and takes responsibility for this design and has the qualifications and meets the requirements set out in the Ontario Building Code to be a Designer.

qualification information
Wellington Jno-Baptiste
signature
25591
BCIN

IA3 Design Inc. 426558

Drawings and not to be shown.	All draw/
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9	.	.
8	.	.
7	.	.
6	.	.
5	.	.
4	.	.

revision	description	date	by
1	ISSUED FOR CLIENT REVIEW	NOV 26-21	VA3
2	REVISED AS PER FLOOR / ROOF LAYOUT	FEB 24-22	RC
3	REVISED AS PER ENG COMMENTS	MAR 03-22	RC

no.	description	date	by
-----	-------------	------	----

(FOR WALLS LESS THAN 1.2M (3'-11") FROM THE LOT LINE)
45 MINUTE FIRE RATED WALL
 PROVIDE A CONTINUOUS LAYER OF 12.7mm (1/2") TYPE 'X' GYPSUM BOARD (INTERIOR SIDE) INSTALLED SO THAT ALL EDGES ARE SUPPORTED, TAPED AND FILLED. SPACE BETWEEN WOOD STUDS TO BE FILLED WITH INSULATION CONFORMING TO CAN/ULC-S702, "MINERAL FIBRE THERMAL INSULATION FOR BUILDINGS" WITH A MASS OF NOT LESS THAN 1.22 Kg/SQ.M. AND MUST FILL AT LEAST 90% OF THE CAVITY THICKNESS. THE TYPE 'X' & INSULATION MUST BE RUN CONTINUOUSLY BEHIND ALL INTERSECTING PARTITIONS, MECHANICAL CHASES, BATHTUBS, SHOWERS, ETC. ENSURE INSULATION & TYPE 'X' IS INSTALLED IN GARAGE EXTERIOR WALLS. (REFER TO SECTION SB-2 OF OBC 2012-SUPPLEMENTARY STANDARDS)



NOTE: REFER TO FRONT
ELEVATION FOR TYPICAL
NOTE INFORMATION

This is to certify that these plans comply with the applicable Architectural Design Guidelines approved by the Town of BRADFORD WEST GWILLIMBURY.

APPROVED BY: [Signature]
DATE: MAR 15, 2022

Valley Flashing
for Repair
Upgrade Only

This stamp certifies compliance with the applicable Design Guidelines only and bears no further professional responsibility.

REFIN. MTL. FLASHING,
W/ CAULKING TO MATCH
MASONRY COLOUR (TYP.)

← FACE BRICK (TYP.) →

PRECAST CONC. SILL
W/ 1/2" PROJ. (TYP.)

— TOP OF PLATE

— TOP OF WINDOW

— 1"x6" ALUM. CLAD
FRIEZE BOARD FOR
REAR UPGRADE ONLY

FIN GRADE


** GLASS AREA ONLY **

WALL AREA	1001.75 SQ. FT.
LIMITING DISTANCE	1.2 M (7%)
OPENING ALLOWED	70.12 SQ. FT.
OPENING PROVIDED	45.17 SQ. FT.
	59.76 SQ. FT. (OPT. DOOR)


RIGHT SIDE ELEVATION 'A'

REVIEWED

9	-	-	-	The undersigned has reviewed and takes responsibility for this design and has the qualifications and meets the requirements set out in the Ontario Building Code to be a Designer.	25591	BCON	42658		
8	-	-	-	qualification information	Wellington Jno-Baptiste		signature		
7	-	-	-	name	Wellington Jno-Baptiste				
6	-	-	-	registration information	VA3 Design Inc.				
5	-	-	-	contractor registration information	VA3 Design Inc.				
4	-	-	-	contractor name	VA3 Design Inc.				
3	REVISED AS PER ENG COMMENTS	MAR 03-22	RC	Contractor must verify all dimensions on the job and report any discrepancy to the Designer before proceeding with the work. All drawings and specifications are instruments of service and the property of VA3 Design Inc. and shall be returned at the completion of the work. Drawings are not to be scaled.					
2	REVISED AS PER FLOOR / ROOF LAYOUT	FEB 24-22	RC						
1	ISSUED FOR CLIENT REVIEW	NOV 26-21	VA3						
no.	description	date	by						

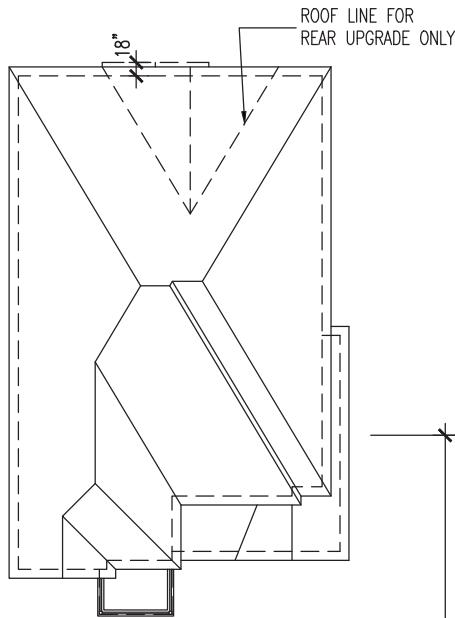

ROOF PLAN 'B'
N.T.S.

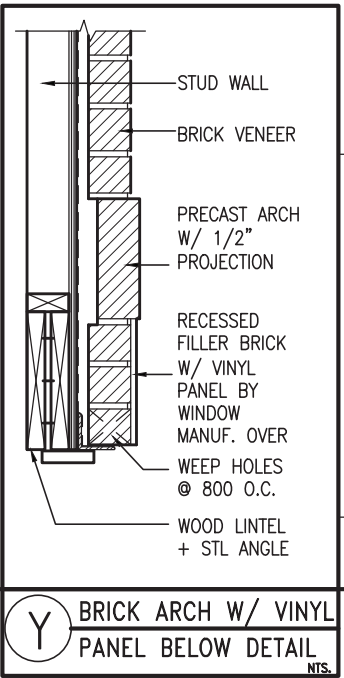

8" PRECAST CONC. ARCH OVER VINYL PANEL BY WINDOW MANUF. ON 8" PRECAST CONC. SURROUND W/ 1/2" PROJ. (TYP.)

CONT. PRECAST CONC. BAND W/ 1/2" PROJ. (TYP.)

24" HIGH PREFIN. DECORATIVE METAL RAILING

ROOF SCUPPER

PREFIN. ALUM. CAP OVER BUILT-UP STUCCO TRIMS (TYP.)

8" PRECAST CONC. SURROUND ON 4" PRECAST CONC. SILL W/ 1/2" PROJ. (TYP.)

8"x8" FIBREGLASS COLUMN BY ROMAN COLUMNS W/ 1/2" THICK HDPE TOP LOADING PLATE ANCHORED TO PORCH SLAB.

STONE VENEER (TYP.)

SUNKEN FOYER (~1R)

POURED CONC. PORCH SLAB AND DOOR SILL



FRONT ELEVATION 'B'

It is the builder's complete responsibility to ensure that all plans submitted for approval fully comply with the Architectural Guidelines and all applicable regulations and requirements including zoning provisions and any provisions in the subdivision agreement. The Control Architect is not responsible in any way for examining or approving site (lotting) plans or working drawings with respect to any zoning or building code or permit matter or that any house can be properly built or located on its lot.

This is to certify that these plans comply with the applicable Architectural Design Guidelines approved by the Town of BRADFORD WEST GWILLIMBURY.

JOHN G. WILLIAMS LTD., ARCHITECT
ARCHITECTURAL CONTROL REVIEW
AND APPROVAL
APPROVED BY:
DATE: MAR 15, 2022
This stamp certifies compliance with the applicable Design Guidelines only and bears no further professional responsibility.



ASPHALT SHINGLES (TYP.)
VALLEY FLASHING (TYP.)
PREFIN. ALUM. R.W.L.,
FASCIA, GUTTER &
VENTED SOFFIT (TYP.)

FACE BRICK (TYP.)

PREFIN. MTL. FLASHING,
W/ CAULKING TO MATCH
MASONRY COLOUR (TYP.)

1"x6" ALUM. CLAD
FRIEZE BD. (TYP.)

MUNICIPAL ADDRESS
PLAQUE (TYP.)

8" PRECAST CONC. HEADER
W/ 1/2" PROJ. (TYP.)

POURED CONC. FOUNDATION
WALLS AND FOOTINGS (TYP.)

TOP OF PLATE

TOP OF WINDOW

FIN SECOND FLOOR

TOP OF TRANSOM

TOP OF WINDOW

FIN GROUND FLOOR

FIN GRADE

U/S OF FOOTING

TOP OF SLAB

S42-19

BAYVIEW WELLINGTON



The undersigned has reviewed and takes responsibility for this design and has the qualifications and meets the requirements set out in the Ontario Building Code to be a Designer.
qualification information
Wellington Jno-Baptiste 25591 BCN
name registration information
VA3 Design Inc. 42658
Contractor must verify all dimensions on the job and report any discrepancy to the Designer before proceeding with the work. All drawings and specifications are instruments of service and the property of the Designer which must be returned at the completion of the work. Drawings are not to be scaled.

no.	description	date	by
3	REVISED AS PER ENG COMMENTS	MAR 03-22	RC
2	REVISED AS PER FLOOR / ROOF LAYOUT	FEB 24-22	RC
1	ISSUED FOR CLIENT REVIEW	NOV 26-21	VA3

project no. 16023
drawing no. 12
project name GREEN VALLEY EAST
municipality BRADFORD, ONTARIO
date OCTOBER 2021
checked by JMW
drawn by TP
scale 3/16" = 1'-0"
file name 16023-S42-19
drawn by JMW
date MAR 8 2022 - 1:00 PM
RICHARD - H:\ARCHIVE WORKING\2016\16023-BW\Units\42\16023-S42-19.dwg - Tue - Mar 8 2022 - 1:00 PM

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REVIEWED

10:12 This stamp certifies compliance with the applicable Design Guidelines only and bears no further professional responsibility.


MAR 8, 2022

REVIEWED

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This is to certify that these plans comply with the applicable Architectural Design Guidelines approved by the Town of Bradford West Gwillimbury.

JOHN G. WILLIAMS LTD., ARCHITECT
ARCHITECTURAL CONTROL REVIEW
AND APPROVAL

APPROVED BY: 
DATE: MAR 15, 2022

This stamp certifies compliance with the applicable Design Guidelines only and bears no further professional responsibility.

BRICK VENEER CONSTRUCTION

(FOR WALLS LESS THAN 1.2M (3'-11") FROM THE LOT LINE)

45 MINUTE FIRE RATED WALL

PROVIDE A CONTINUOUS LAYER OF 12.7mm (1/2") TYPE 'X' GYPSUM BOARD (INTERIOR SIDE) INSTALLED SO THAT ALL EDGES ARE SUPPORTED, TAPED AND FILLED. SPACE BETWEEN WOOD STUDS TO BE FILLED WITH INSULATION CONFORMING TO CAN/ULC-S702, "MINERAL FIBRE THERMAL INSULATION FOR BUILDINGS" WITH A MASS OF NOT LESS THAN 1.22 Kg/SQ.M. AND MUST FILL AT LEAST 90% OF THE CAVITY THICKNESS. THE TYPE 'X' & INSULATION MUST BE RUN CONTINUOUSLY BEHIND ALL INTERSECTING PARTITIONS, MECHANICAL CHASES, BATHTUBS, SHOWERS, ETC. ENSURE INSULATION & TYPE 'X' IS INSTALLED IN GARAGE EXTERIOR WALLS. (REFER TO SECTION SB-2 OF OBC 2012-SUPPLEMENTARY STANDARDS)

R.W.L. AS REQUIRED &
AS PER MUNICIPALITY

NOTE: REFER TO FRONT
ELEVATION FOR TYPICAL
NOTE INFORMATION



MAR 8, 2022

VALLEY FLASHING (TYP.)

PREFIN. ALUM. R.W.L.,
FASCIA, GUTTER &
VENTED SOFFIT (TYP.)

1"x6" ALUM. CLAD
FRIEZE BOARD (TYP.)

PREFIN. MTL. FLASHING,
W/ CAULKING TO MATCH
MASONRY COLOUR (TYP.)

STONE VENEER (TYP.)

ASPHALT SHINGLES (TYP.)

FACE BRICK (TYP.)

BRICK SOLDIER HEADER
W/ 1/2" PROJ. (TYP.)

12" FG TRANSOM

PRECAST CONC. SILL
W/ 1/2" PROJ. (TYP.)

TOP OF PLATE

TOP OF WINDOW

1"x6" ALUM. CLAD
FRIEZE BOARD FOR
REAR UPGRADE ONLY

CONT. PRECAST CONC.
BAND W/ 1/2" PROJ.
FOR REAR UPGRADE ONLY

FIN SECOND FLOOR

TOP OF TRANSOM

TOP OF WINDOW/
DOOR

FIN GROUND FLOOR

FIN GRADE

TOP OF SLAB

(2) OPT. DOOR IF
GRADE PERMITS

** GLASS AREA ONLY **

WALL AREA	991.42 SQ. FT.
LIMITING DISTANCE	1.2 M (7%)
OPENING ALLOWED	69.40 SQ. FT.
OPENING PROVIDED	45.17 SQ. FT.
	59.76 SQ. FT. (OPT. DOOR)

RIGHT SIDE ELEVATION 'B'

REVIEWED

S42-19

BAYVIEW WELLINGTON

VA3
DESIGN

The undersigned has reviewed and takes responsibility for this design and has the qualifications and meets the requirements set out in the Ontario Building Code to be a Designer.

Wellington Jno-Baptiste
signature 25591 BCIN
signature 42658

3 REVISED AS PER ENG COMMENTS
2 REVISED AS PER FLOOR / ROOF LAYOUT
1 ISSUED FOR CLIENT REVIEW


project no. 16023
drawing no. 14
project name GREEN VALLEY EAST
municipality BRADFORD, ONTARIO
date OCTOBER 2021
drawn by TP
checked by JWM
scale 3/16" = 1'-0"

255 Consumers Rd. Suite 120
Toronto, ON M2J 1P4
t 416.630.2255 f 416.630.4782
vo3design.com

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no. description
date by

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ROOF PLAN 'C'
N.T.S.

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This is to certify that these plans comply with the applicable Architectural Design Guidelines approved by the Town of BRADFORD WEST GWILLIMBURY.

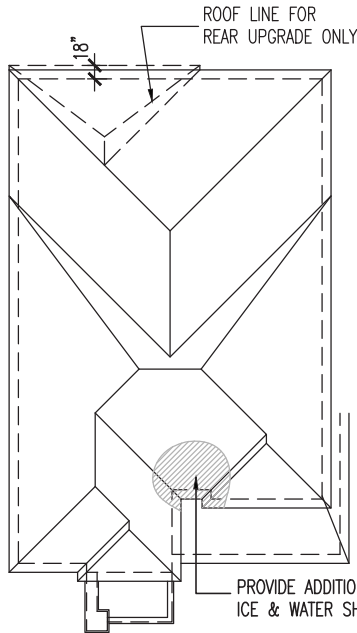JOHN G. WILLIAMS LTD., ARCHITECT
ARCHITECTURAL CONTROL REVIEW
AND APPROVAL

APPROVED BY: [Signature]
DATE: MAR 15, 2022

This stamp certifies compliance with the applicable Design Guidelines only and bears no further professional responsibility.

23'-3" [7.09M]

5'-1" [1.55M]
MID-POINT OF ROOF
5'-1" [1.55M]

1"x6" ALUM. CLAD
FRIEZE BD. (TYP.)

1"x6" STUCCO FRIEZE
BD. & TRIM (TYP.)

PREFIN. ALUM CAPPED
CORNER TRIM (TYP.)

PREC. CONC. CAP (TYP.)

STUCCO FINISH (TYP.)

PREFIN. ALUM. CAP OVER
ALUM. CLAD TRIM (TYP.)

CONT. PREC. CONC. SILLS
OVER BRAMPTON BRICK
FINESSE LINE OR SIMILAR

SUNKEN FOYER (-1R)

POURED CONC. PORCH
SLAB AND DOOR SILL


1'-0"

1'-0"


1'-0"

1'-0"

1'-0"

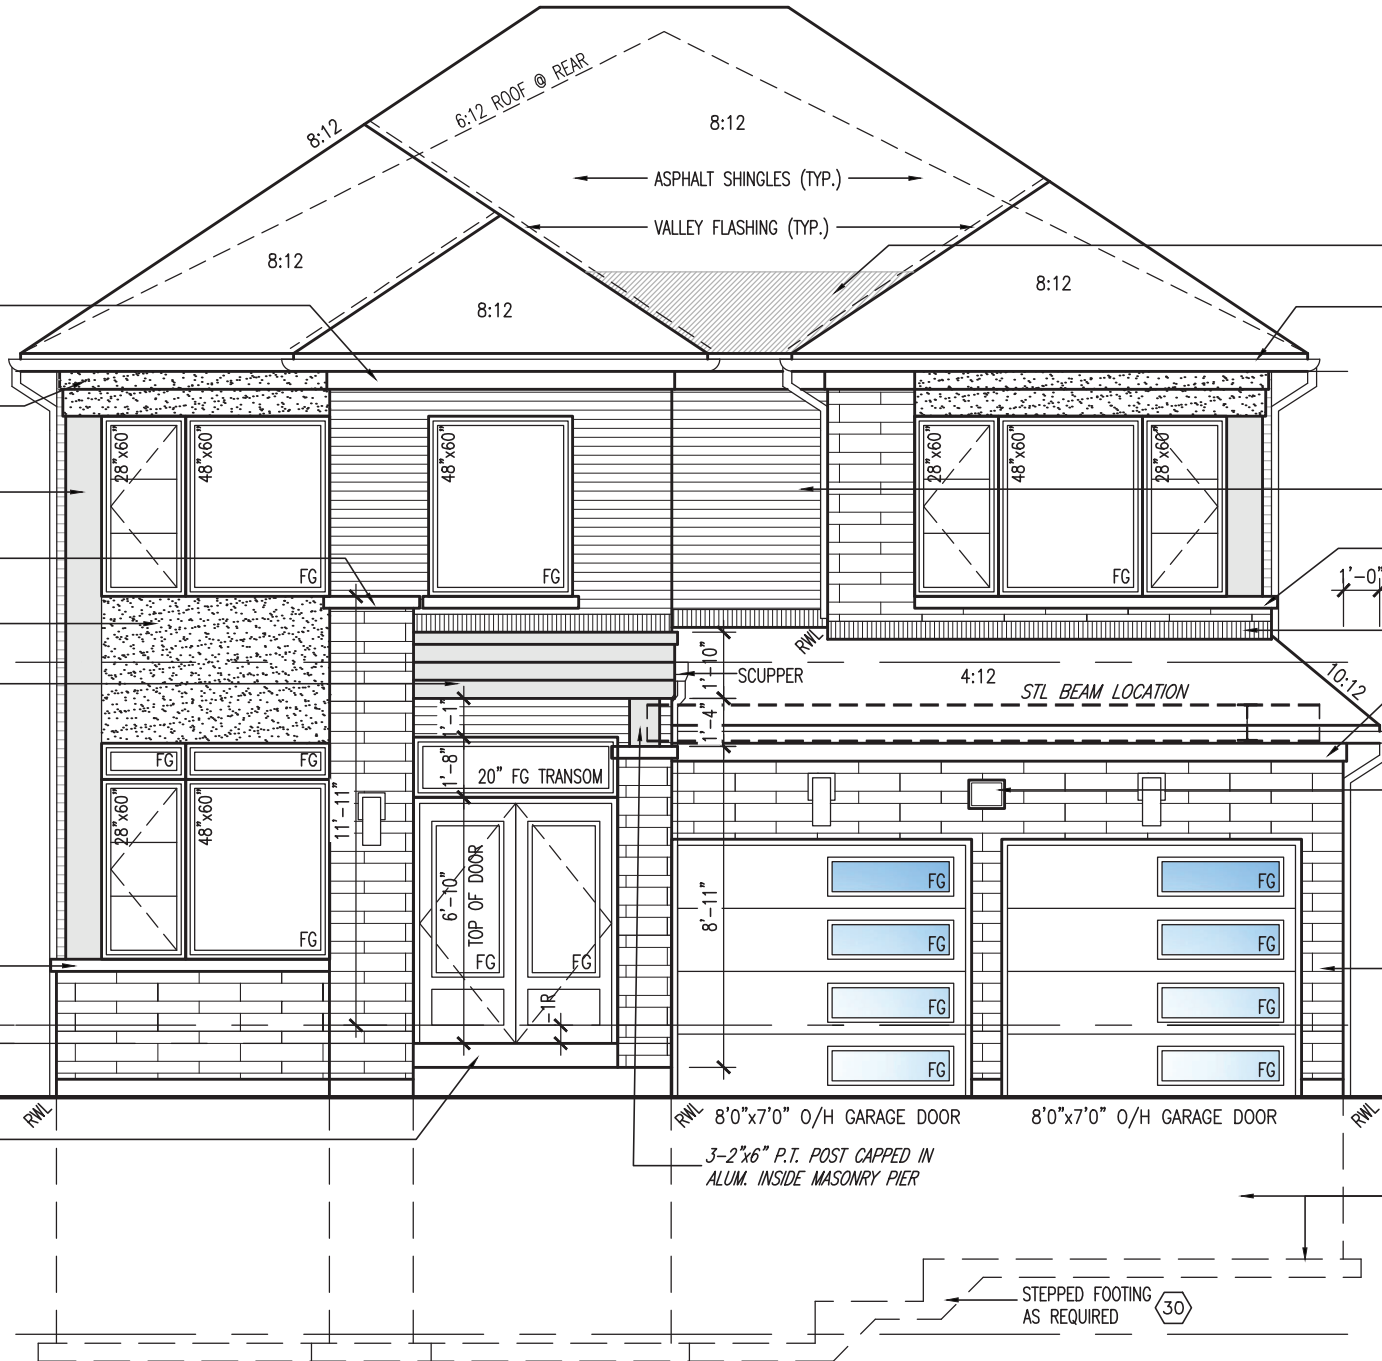

FRONT ELEVATION 'C'

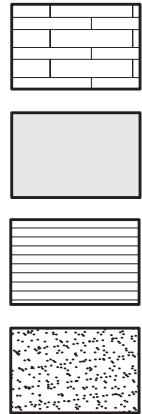

STONE BY BRAMPTON BRICK
FINESSE LINE OR SIMILAR

ALUMINUM PANEL

FACE BRICK

STUCCO FINISH

PROVIDE ADDITIONAL
ICE & WATER SHIELD
PREFIN. ALUM. R.W.L.,
FASCIA, GUTTER &
VENTED SOFFIT (TYP.)

FACE BRICK (TYP.)
CONT. PRECAST CONC. BAND
W/ 1/2" PROJ. (TYP.)
PREFIN. MTL. FLASHING,
W/ CAULKING TO MATCH
MASONRY COLOUR (TYP.)

1"x6" ALUM. CLAD
FRIEZE BD. (TYP.)
MUNICIPAL ADDRESS
PLAQUE (TYP.)

STONE BY BRAMPTON
BRICK FINESSE LINE
OR SIMILAR

POURED CONC. FOUNDATION
WALLS AND FOOTINGS (TYP.)

TOP OF PLATE

TOP OF WINDOW

FIN SECOND FLOOR

TOP OF TRANSOM

TOP OF WINDOW

FIN GROUND FLOOR

FIN GRADE

U/S OF FOOTING

TOP OF SLAB

REVIEWED

S42-19

BAYVIEW WELLINGTON



25591 BCN
42658
Wellington Jno-Baptiste
V3 Design Inc.

3 REVISED AS PER ENG COMMENTS
2 REVISED AS PER FLOOR / ROOF LAYOUT
1 ISSUED FOR CLIENT REVIEW

project no. 16023
drawing no. 15
file name 16023-S42-19
scale 3/16" = 1'-0"

checked by JWM
drawn by TP
date OCTOBER 2021

255 Consumers Rd. Suite 120
Toronto, ON M2J 1P4
t 416.630.2255 f 416.630.4782
vo3design.com

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qualification information

name Jno-Baptiste

registration information BCN

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no. description
3 REVISED AS PER ENG COMMENTS
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
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JOHN G. WILLIAMS LTD., ARCHITECT
ARCHITECTURAL CONTROL REVIEW
AND APPROVAL

APPROVED BY: 
DATE: MAR 15, 2022

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BRICK VENEER CONSTRUCTION

(FOR WALLS LESS THAN 1.2M (3'-11") FROM THE LOT LINE)

45 MINUTE FIRE RATED WALL

PROVIDE A CONTINUOUS LAYER OF 12.7mm (1/2") TYPE 'X' GYPSUM BOARD (INTERIOR SIDE) INSTALLED SO THAT ALL EDGES ARE SUPPORTED, TAPED AND FILLED. SPACE BETWEEN WOOD STUDS TO BE FILLED WITH INSULATION CONFORMING TO CAN/ULC-S702, "MINERAL FIBRE THERMAL INSULATION FOR BUILDINGS" WITH A MASS OF NOT LESS THAN 1.22 Kg/SQ.M. AND MUST FILL AT LEAST 90% OF THE CAVITY THICKNESS. THE TYPE 'X' & INSULATION MUST BE RUN CONTINUOUSLY BEHIND ALL INTERSECTING PARTITIONS, MECHANICAL CHASES, BATHTUBS, SHOWERS, ETC. ENSURE INSULATION & TYPE 'X' IS INSTALLED IN GARAGE EXTERIOR WALLS. (REFER TO SECTION SB-2 OF OBC 2012-SUPPLEMENTARY STANDARDS)



MAR 8, 2022

R.W.L. AS REQUIRED &
AS PER MUNICIPALITY

NOTE: REFER TO FRONT
ELEVATION FOR TYPICAL
NOTE INFORMATION



PREFIN. ALUM. R.W.L.,
FASCIA, GUTTER &
VENTED SOFFIT (TYP.)

1"x6" STUCCO FRIEZE
BD. & TRIM (TYP.)

PREFIN. ALUM CAPPED
CORNER TRIM (TYP.)

SCUPPER

STONE BY
BRAMPTON BRICK
FINESSE LINE OR
SIMILAR

8:12
ASPHALT SHINGLES (TYP.)

VALLEY FLASHING (TYP.)

ROOF LINE FOR
REAR UPGRADE ONLY

VALLEY FLASHING
FOR REAR
UPGRADE ONLY

TOP OF PLATE

TOP OF WINDOW

1"x6" ALUM. CLAD
FRIEZE BOARD FOR
REAR UPGRADE ONLY

FIN SECOND FLOOR

TOP OF TRANSOM

TOP OF WINDOW/
DOOR

CONT. PRECAST CONC.
SILL W/ 1/2" PROJ. FOR
REAR UPGRADE ONLY

FIN GROUND FLOOR

FIN GRADE

TOP OF SLAB

STL BEAM LOCATION

FACE BRICK (TYP.)

BRICK SOLDIER HEADER
W/ 1/2" PROJ. (TYP.)

12" FG TRANSOM

PRECAST CONC. SILL
W/ 1/2" PROJ. (TYP.)

(2) OPT. DOOR IF
GRADE PERMITS

** GLASS AREA ONLY **

WALL AREA	1001.75 SQ. FT.
LIMITING DISTANCE	1.2 M (7%)
OPENING ALLOWED	70.12 SQ. FT.
OPENING PROVIDED	45.17 SQ. FT.
	59.76 SQ. FT. (OPT. DOOR)

RIGHT SIDE ELEVATION 'C'

REVIEWED

S42-19

BAYVIEW WELLINGTON

VA3
DESIGN

255 Consumers Rd, Suite 120
Toronto, ON M2J 1P4
t 416.630.2255 f 416.630.4782
va3design.com

Wellington Jno-Baptiste
VA3 Design Inc.
signature

name
registration information
BCIN 25591
42658

3 REVISED AS PER ENG COMMENTS
2 REVISED AS PER FLOOR / ROOF LAYOUT
1 ISSUED FOR CLIENT REVIEW


no. description
date by

project no. 16023
drawing no. 17
project name GREEN VALLEY EAST
municipality BRADFORD, ONTARIO
date OCTOBER 2021
checked by JMW
drawn by TP
scale 3/16" = 1'-0"

RIGHT SIDE ELEVATION 'C'
file name 16023-S42-19
date 16023-S42-19.dwg
drawn by TP
checked by JMW
scale 3/16" = 1'-0"

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AREA CALCULATIONS			
	ELEV. A	ELEV. B	ELEV. C
GROUND FLOOR AREA	1428.2 SF	1429.4 SF	1429.1 SF
SECOND FLOOR AREA	1701.7 SF	1703.9 SF	1702.6 SF
SUBTOTAL	3129.8 SF	3133.3 SF	3131.7 SF
DEDUCT ALL OPENINGS	0 SF	0 SF	0 SF
TOTAL NET AREA	3130 SF	3133 SF	3132 SF
	290.8 m2	291.1 m2	290.9 m2
FINISHED BSMT AREA	0 SF	0 SF	0 SF
TOTAL NET AREA W/ FIN BSMT	3130 SF	3133 SF	3132 SF
	290.8 m2	291.1 m2	290.9 m2
COVERAGE W/O PORCH	1863.5 SF	1864.7 SF	1864.4 SF
	173.1 m2	173.2 m2	173.2 m2
COVERAGE W/PORCH	1965.9 SF	1912.4 SF	1919.0 SF
	182.6 m2	177.7 m2	178.3 m2

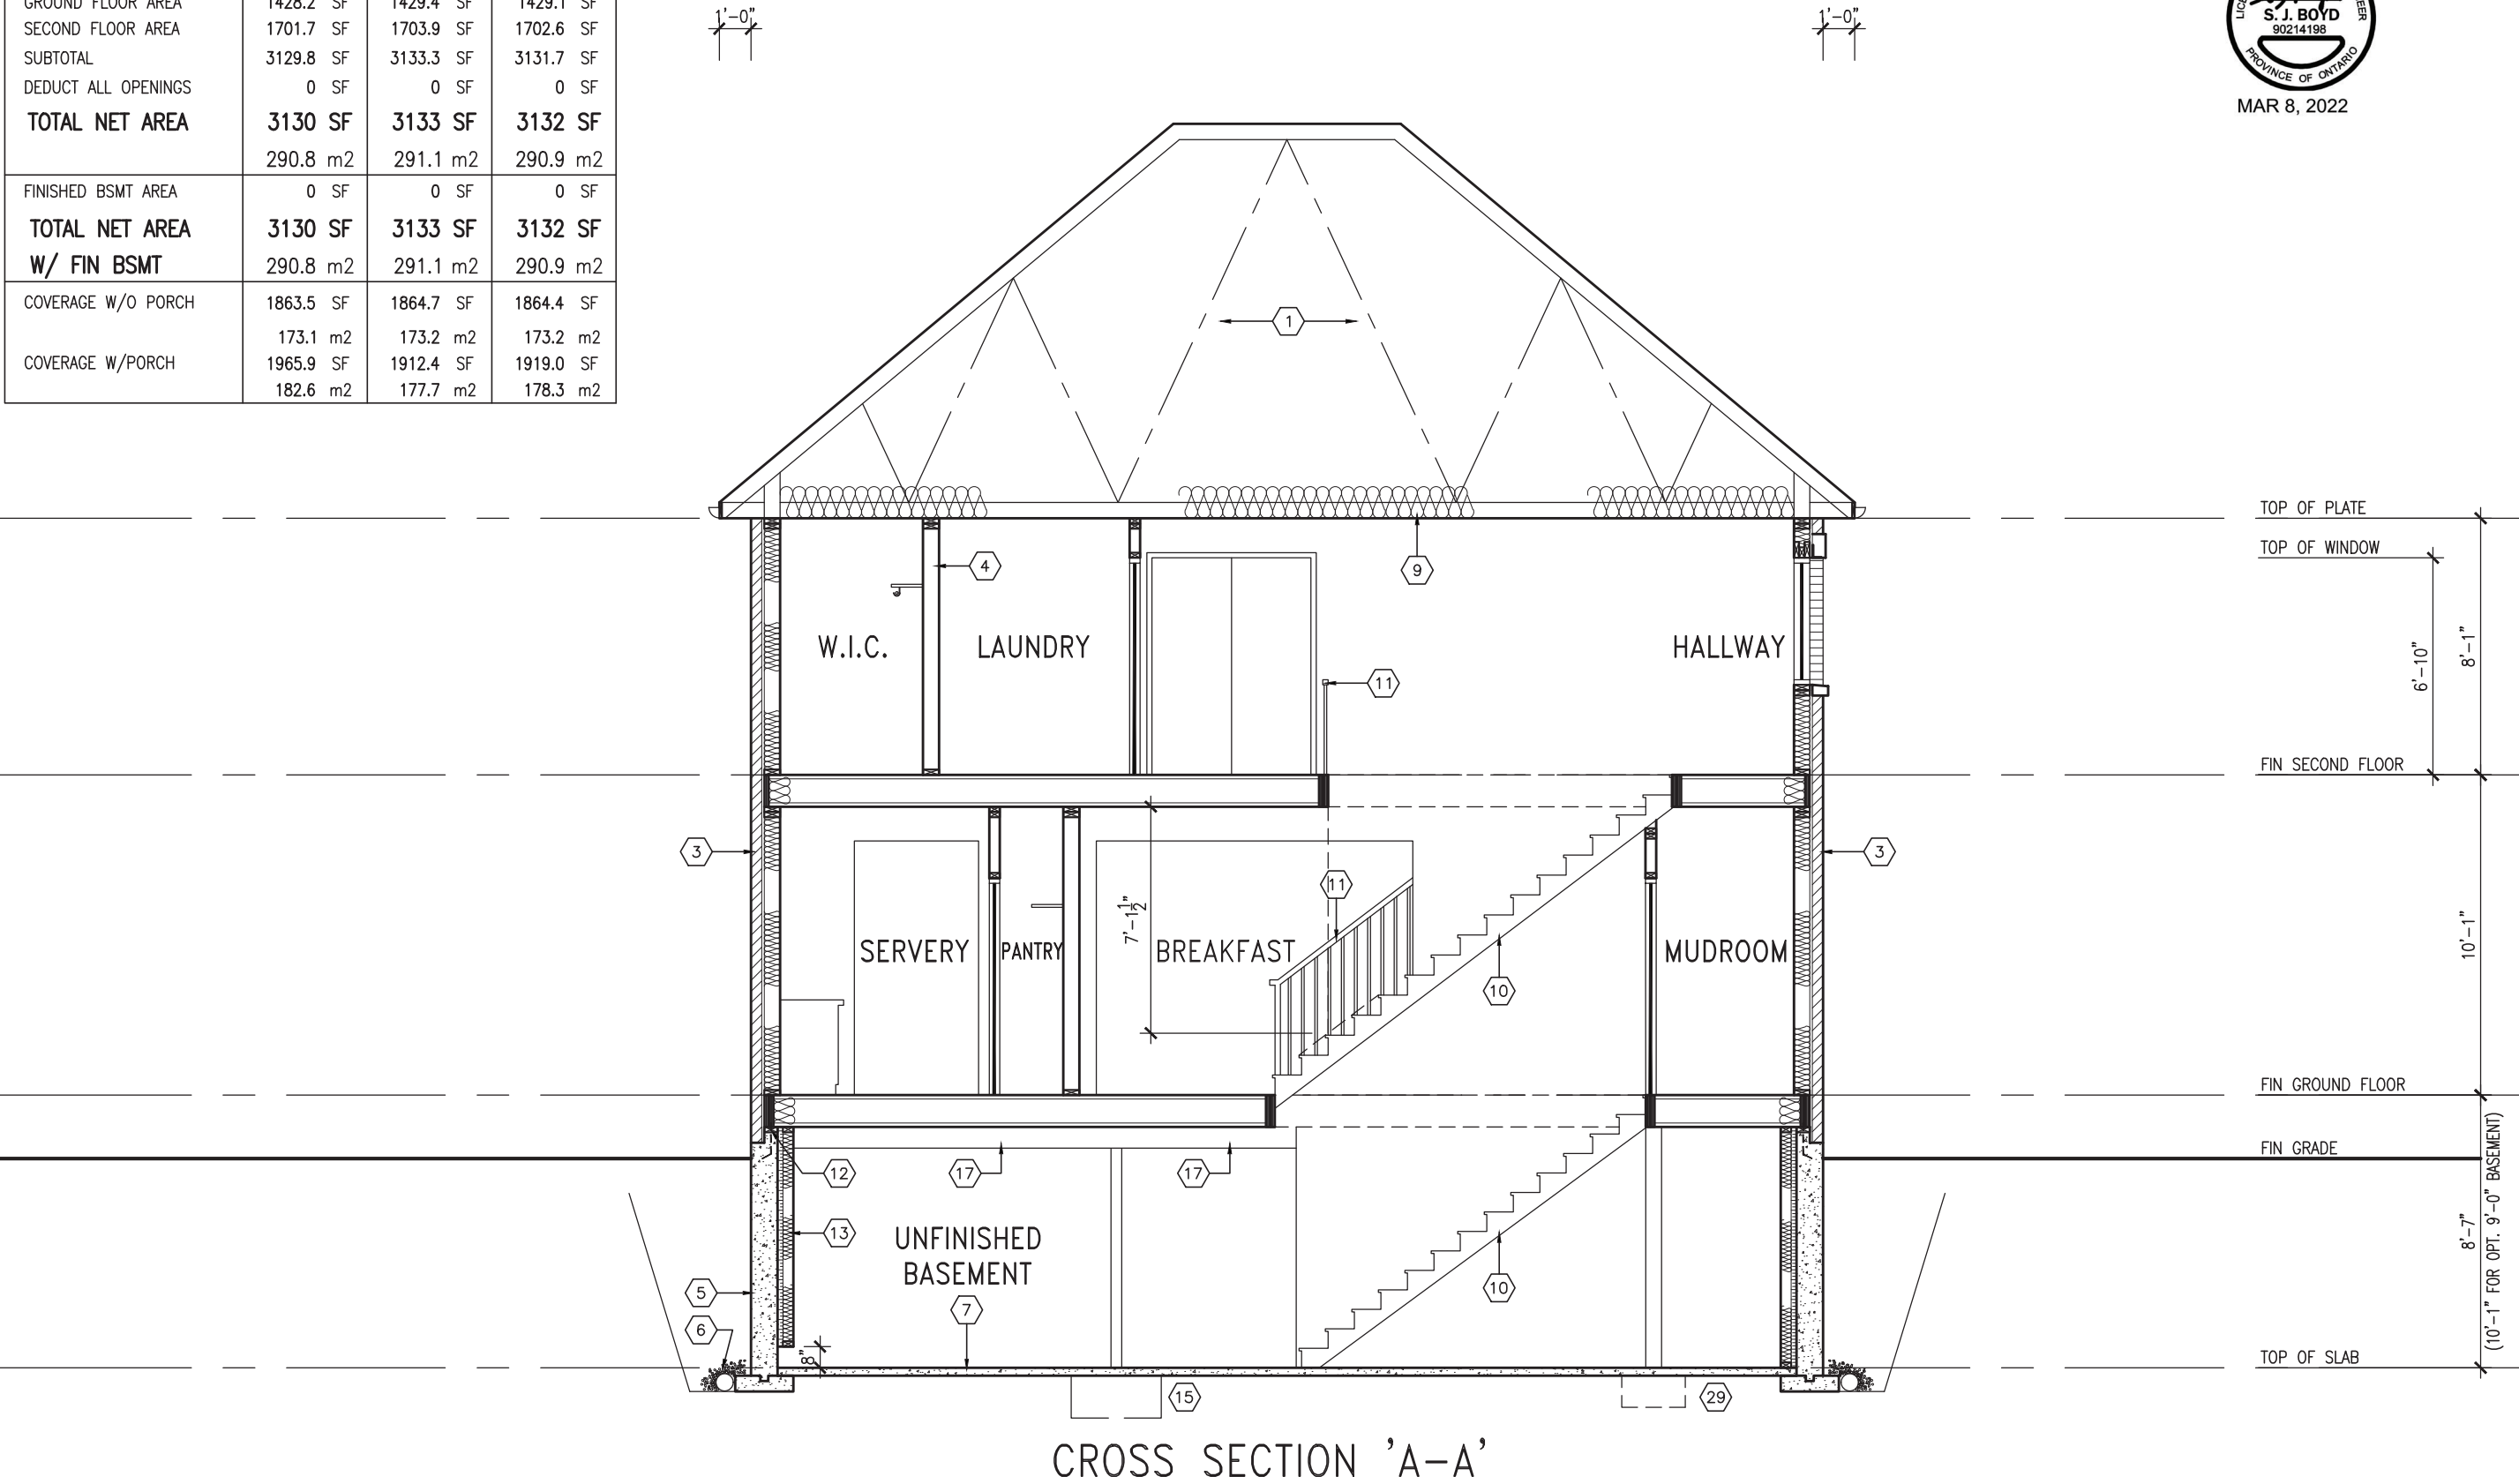

project name		project no.	
BAYVIEW WELLINGTON		16023	
GREEN VALLEY EAST		drawing no.	
BRADFORD, ONTARIO		18	
date		CROSS SECTION 'A-A'	
OCTOBER 2021		file name	
checked by		16023-S42-19	
JWM		scale	
drawn by		3/16" = 1'-0"	
TP		RICHARD - H:\ARCHIVE WORKING\2016\16023.BW\Units\42\16023-S42-19.dwg - Tue - Mar 8 2022 - 1:00 PM	

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Toronto, ON M2J 1R4
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Wellington Jno-Baptiste		25591		42658	
name		registration information		date	
VA3 Design Inc.		MAR 03-22 RC		NOV 26-21 VA3	
Contractor must verify all dimensions on the job and report any discrepancy to the Designer before proceeding with the work. All drawings and specifications are instruments of service and the property of the Designer which must be returned at the completion of the work. Drawings are not to be scaled.		no. description		by	
3 REVISED AS PER ENG COMMENTS		MAR 03-22 RC		NOV 26-21 VA3	
2 REVISED AS PER FLOOR / ROOF LAYOUT		FEB 24-22 RC		NOV 26-21 VA3	
1 ISSUED FOR CLIENT REVIEW		NOV 26-21 VA3		NOV 26-21 VA3	

REVIEWED

This is to certify that these plans comply with the applicable Architectural Design Guidelines approved by the
BRADFORD / WEST GWILLIMBURY.

JOHN G. WILLIAMS LTD., ARCHITECT
ARCHITECTURAL CONTROL REVIEW
AND APPROVAL


APPROVED BY:

DATE: MAR 15, 2022

This stamp certifies compliance with the applicable Design Guidelines only and bears no further professional responsibility.




MAR 8, 2022

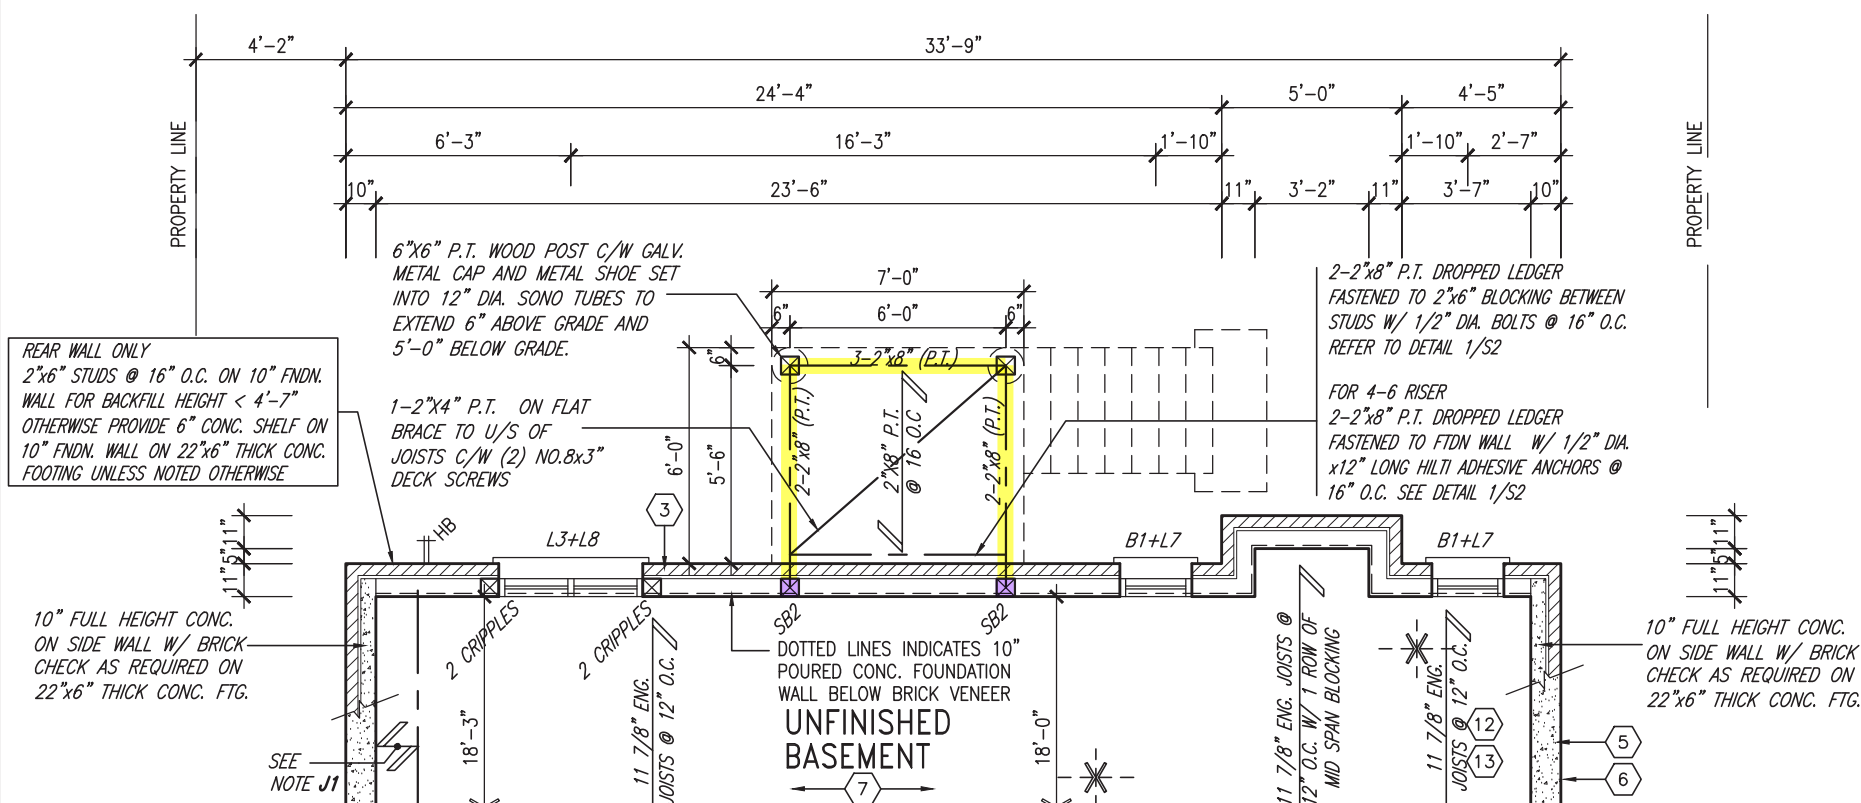

PARTIAL BASEMENT PLAN 'A' - W.O.D. CONDITION
(ELEV. 'B' & 'C' SIMILAR)

NOTE: REFER TO STANDARD
FLOOR PLANS FOR
ADDITIONAL INFORMATION

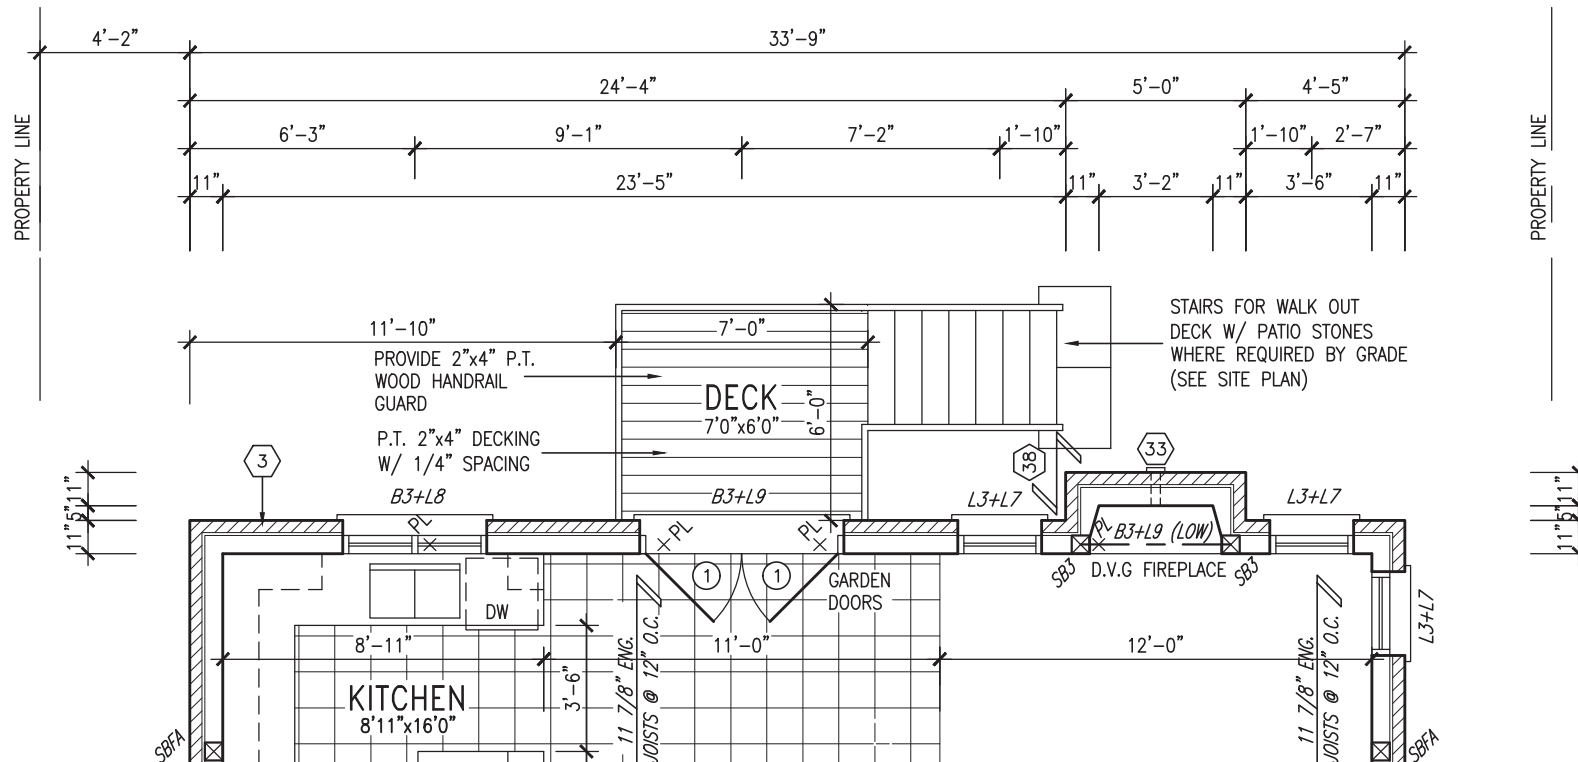

PARTIAL GROUND FLOOR PLAN 'A' – W.O.D. CONDITION
(ELEV. 'B' & 'C' SIMILAR)

9	.	.	<div>The undersigned has reviewed and takes responsibility for this design and has the qualifications and meets the requirements set out in the Ontario Building Code to be a Designer.</div> <div>qualification information</div> <div>Wellington Jno-Baptiste 25591</div> <div><div>name</div><div>BCIN</div></div> <div><div>registration information</div><div>VA3 Design Inc. 42658</div></div>	<div><div>VA3</div><div>DESIGN</div></div> <div>255 Consumers Rd Suite 120 Toronto ON M2J 1R4 t 416.630.2255 f 416.630.4782 va3design.com</div>	<div>BAYVIEW WELLINGTON</div>	<div>S42-19</div>
8	.	.				
7	.	.				
6	.	.				
5	.	.	<div><div>project name</div><div>GREEN VALLEY EAST</div></div>	<div><div>municipality</div><div>BRADFORD, ONTARIO</div></div>	<div><div>project no.</div><div>16023</div></div>	
4	.	.	<div><div>date</div><div>OCTOBER 2021</div></div>	<div><div>PARTIAL PLANS - W.O.D. CONDITION</div></div>	<div><div>drawing no.</div><div>19</div></div>	
3	REVISED AS PER ENG COMMENTS	MAR 03-22	RC	<div><div>drawn by</div><div>checked by</div><div>scale</div><div>file name</div></div> <div><div>TP</div><div>JWM</div><div>3/16" = 1'-0"</div><div>16023-S42-19</div></div> <div><div>RICHARD - H:\ARCHIVE\WORKING\2016\16023.BW\Units\42\16023-S42-19.dwg - Tue - Mar 8 2022 - 1:00 PM</div></div>		
2	REVISED AS PER FLOOR / ROOF LAYOUT	FEB 24-22	RC			
1	ISSUED FOR CLIENT REVIEW	NOV 26-21	VA3			
no.	description	date	by			
<div>Contractor must verify all dimensions on the job and report any discrepancy to the Designer before proceeding with the work. All drawings and specifications are instruments of service and the property of the Designer which must be returned at the completion of the work. Drawings are not to be scaled.</div>						

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This is to certify that these plans comply with the applicable Architectural Design Guidelines approved by the Town of BRADFORD WEST GWILLIMBURY.

JOHN G. WILLIAMS LTD., ARCHITECT
ARCHITECTURAL CONTROL REVIEW
AND APPROVAL

APPROVED BY: _____
DATE: MAR 15, 2022

This stamp certifies compliance with the applicable
Design Guidelines only and bears no further
professional responsibility.

R.W.L. AS REQUIRED &
AS PER MUNICIPALITY

NOTE: REFER TO FRONT
ELEVATION FOR TYPICAL
NOTE INFORMATION



MAR 8, 2022

PREFIN. ALUM. R.W.L.,
FASCIA, GUTTER &
VENTED SOFFIT (TYP.)

FACE BRICK (TYP.)

BRICK SOLDIER HEADER
W/ 1/2" PROJ. (TYP.)

12" FG TRANSOM

PREFIN. MTL. FLASHING,
W/ CAULKING TO MATCH
MASONRY COLOUR (TYP.)

PRECAST CONC. SILL
W/ 1/2" PROJ. (TYP.)

— DASHED LINE INDICATES ROOF
LINE FOR ELEV. 'B' @ FRONT

— DASHED LINE INDICATES ROOF
LINE FOR ELEV. 'C'

TOP OF PLATE

TOP OF WINDOW

FIN SECOND FLOOR

TOP OF TRANSOM

TOP OF DOOR/WINDOW

PROVIDE 2"x4" P.T. WOOD
— HANDRAIL GUARD W/ 2"x2" P.T.
WOOD PICKETS @ 4" MAX.

FIN GROUND FLOOR

TOP OF WINDOW

FIN GRADE

POURED CONC. FOUNDATION
WALLS AND FOOTINGS (TYP.)

REAR ELEVATION 'A'/'B'/'C' - W.O.D. CONDITION

BASEMENT WINDOW SIZES
4R-8R USE 30"x24" VINYL
CLAD STRUCTURAL STEEL
FRAME BASEMENT WINDOWS

REVIEWED

S42-19

BAYVIEW WELLINGTON

project name	project no.
GREEN VALLEY EAST	16023
BRADFORD, ONTARIO	

date drawn by checked by scale file name
OCTOBER 2021 REAR ELEVATION 'A' - W.O.D. COND.
TP JWM 3/16" = 1'-0" 16023-S42-19

V3
DESIGN
255 Consumers Rd Suite 120
Toronto ON M2J 1R4
416.630.2255 f 416.630.4782
va3design.com

he undersigned has reviewed and takes responsibility for this design and has the qualifications and meets the requirements set out in the Ontario Building Code to be a Designer.

Qualification Information

Wesley J. Baptiste 25591
signature

BCIN

42658

Contractor must verify all dimensions on the job and report any discrepancy to the Designer before proceeding with the work. All drawings and specifications are instruments of service and the property of the Designer which must be returned at the completion of the work.

FA3 Design Inc. 42658

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[illegible]

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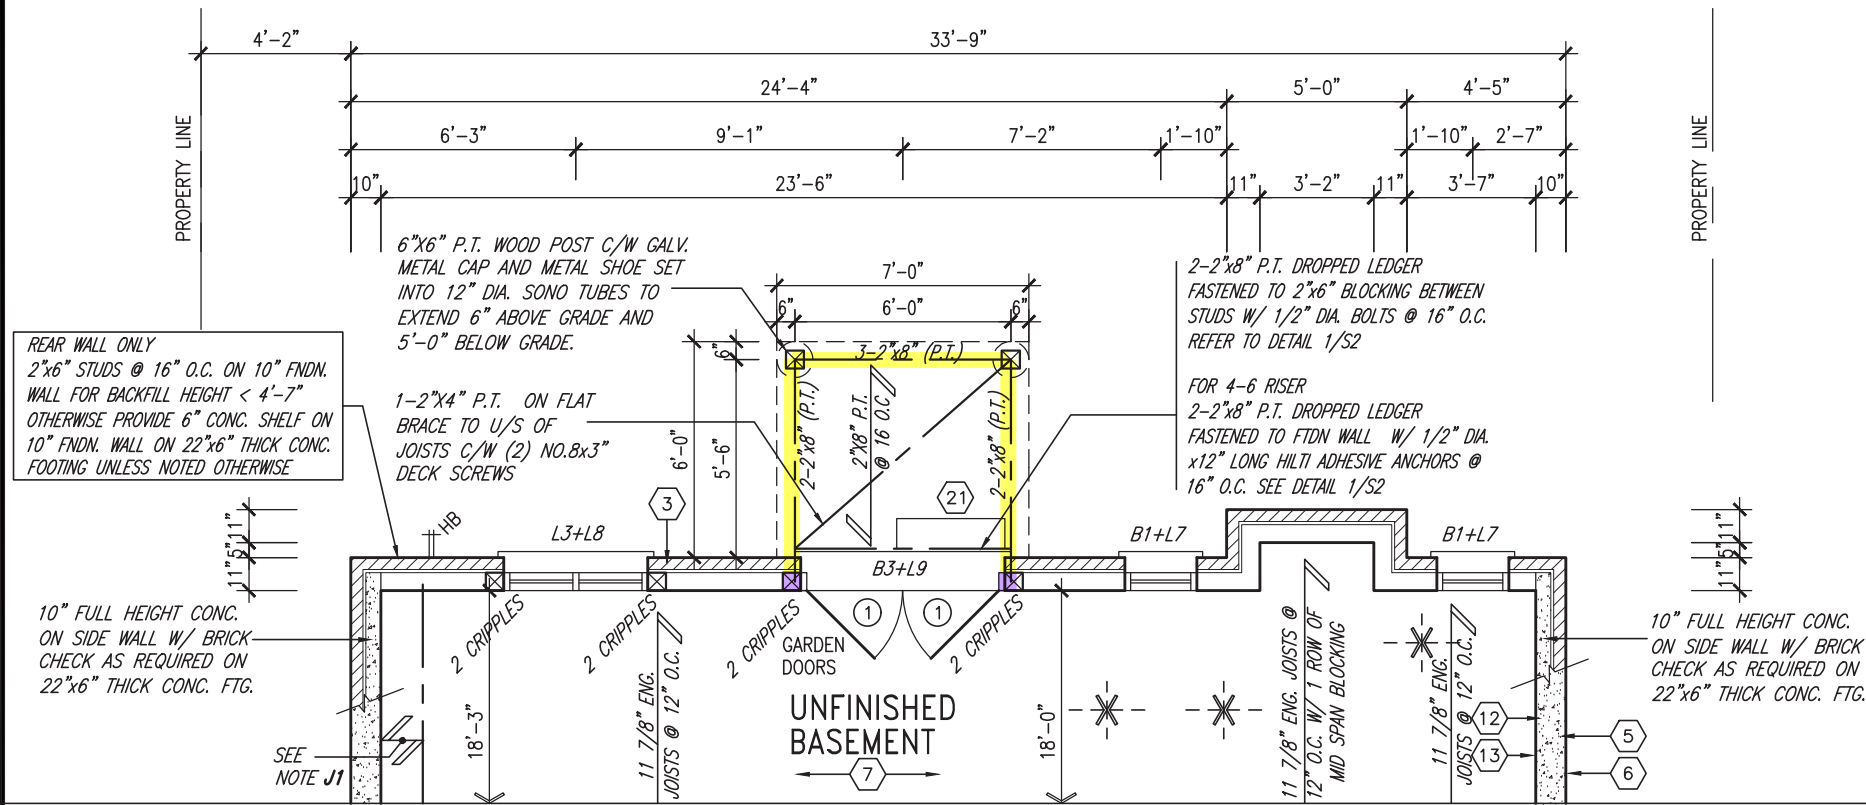
This is to certify that these plans comply with the applicable Architectural Design Guidelines approved by the BRADFORD / WEST GWILLIMBURY.

JOHN G. WILLIAMS LTD., ARCHITECT
ARCHITECTURAL CONTROL REVIEW
AND APPROVAL

APPROVED BY:


DATE: MAR 15, 2022

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PARTIAL BASEMENT PLAN 'A' - W.O.B. CONDITION
(ELEV. 'B' & 'C' SIMILAR)

NOTE: REFER TO STANDARD FLOOR PLANS FOR ADDITIONAL INFORMATION



PARTIAL GROUND FLOOR PLAN 'A' - W.O.B. CONDITION
(ELEV. 'B' & 'C' SIMILAR)

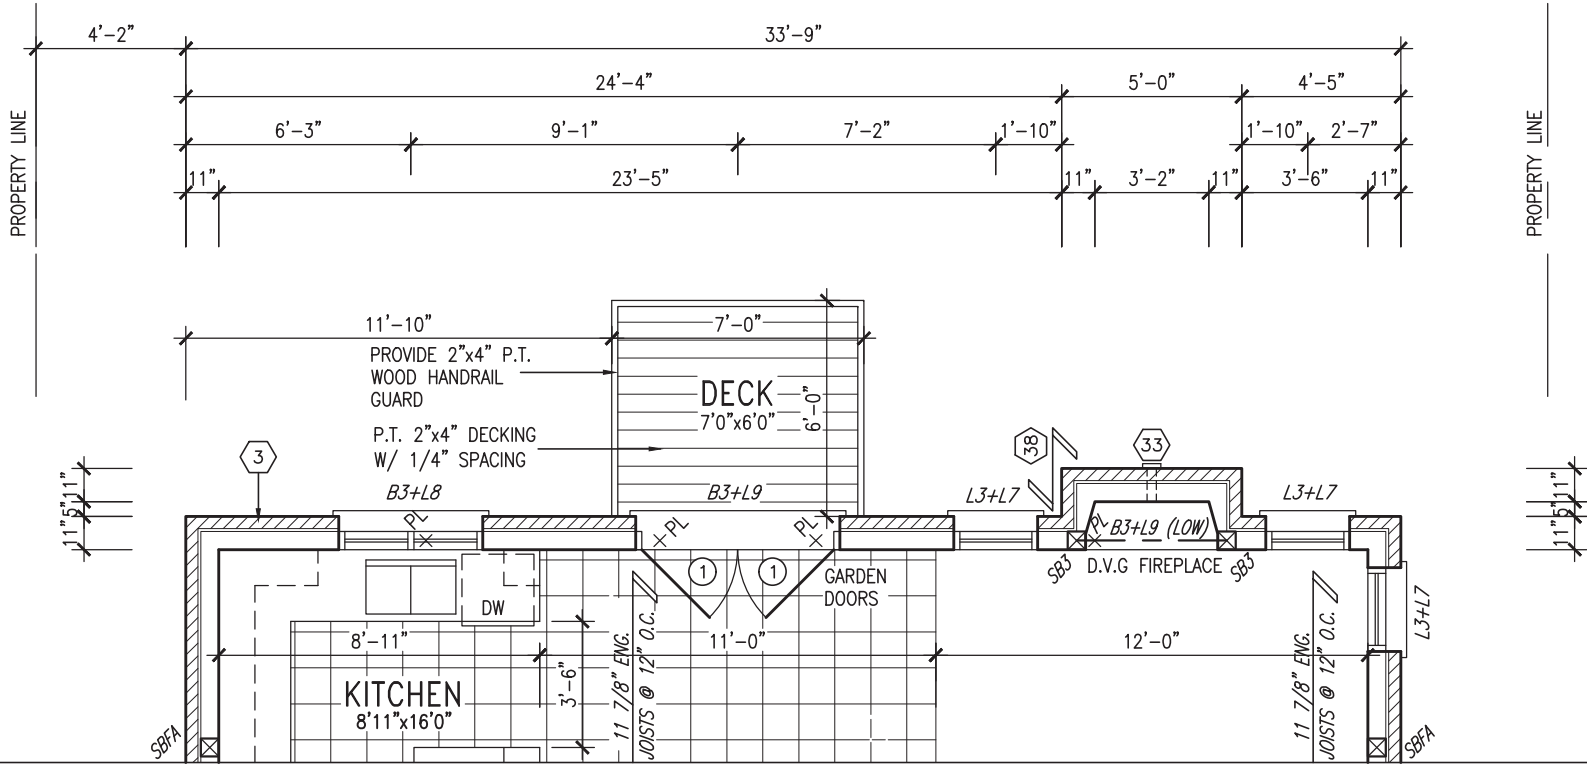

MAR 8, 2022

9		REVIEWED		The undersigned has reviewed and takes responsibility for this design and has the qualifications and meets the requirements set out in the Ontario Building Code to be a Designer.		VA3 DESIGN		BAYVIEW WELLINGTON		S42-19	
8				qualification information		25591		project name		project no.	
7				Wellington Jno-Baptiste		BCIN		GREEN VALLEY EAST		16023	
6				name		42658		BRADFORD, ONTARIO		drawing no.	
5				registration information				date		file name	
4				VA3 Design Inc.				OCTOBER 2021		16023-S42-19	
3		REVISED AS PER ENG COMMENTS		MAR 03-22		RC		drawn by		21	
2		REVISED AS PER FLOOR / ROOF LAYOUT		FEB 24-22		RC		checked by			
1		ISSUED FOR CLIENT REVIEW		NOV 26-21		VA3		JWM			
no.		description		date		by		scale			
								3/16" = 1'-0"			
								TP			
								RICHARD - H:\ARCHIVE\WORKING\2016\16023.BW\Units\42\16023-S42-19.dwg - Tue - Mar 8 2022 - 1:00 PM			

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JOHN G. WILLIAMS LTD., ARCHITECT
ARCHITECTURAL CONTROL REVIEW
AND APPROVAL

APPROVED BY:

DATE: MAR 15, 2022

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R.W.L. AS REQUIRED &
AS PER MUNICIPALITY

NOTE: REFER TO FRONT
ELEVATION FOR TYPICAL
NOTE INFORMATION



MAR 8, 2022

DASHED LINE INDICATES ROOF
LINE FOR ELEV. 'B' @ FRONT

DASHED LINE INDICATES ROOF
LINE FOR ELEV. 'C'

PREFIN. ALUM. R.W.L.,
FASCIA, GUTTER &
VENTED SOFFIT (TYP.)

FACE BRICK (TYP.)

BRICK SOLDIER HEADER
W/ 1/2" PROJ. (TYP.)

12" FG TRANSOM

PREFIN. MTL. FLASHING,
W/ CAULKING TO MATCH
MASONRY COLOUR (TYP.)

PRECAST CONC. SILL
W/ 1/2" PROJ. (TYP.)

PROVIDE 2"x4" P.T. WOOD
HANDRAIL GUARD W/ 2"x2" P.T.
WOOD PICKETS @ 4" MAX.

2"x6" P.T.
CROSS BRACING

6"x6" P.T. WOOD POST C/W
GALV. METAL CAP AND METAL
SHOE SET INTO 12" DIA. SONO
TUBES TO EXTEND 6" ABOVE
GRADE AND 5'-0" BELOW GRADE.

POURED CONC. FOUNDATION
WALLS AND FOOTINGS (TYP.)

REAR ELEVATION 'A'/'B'/'C' - W.O.B. CONDITION

REVIEWED

S42-19

BAYVIEW WELLINGTON

VA3
DESIGN

Wellington Jno-Baptiste
signature
BCIN 25591
42658

3. REVISED AS PER ENG. COMMENTS
2. REVISED AS PER FLOOR / ROOF LAYOUT
1. ISSUED FOR CLIENT REVIEW

project no. 16023
drawing no. 22

project name GREEN VALLEY EAST
municipality BRADFORD, ONTARIO
date OCTOBER 2021
checked by JWM
drawn by TP
scale 3/16" = 1'-0"


file name 16023-S42-19
RICHARD - H:\ARCHIVE WORKING\2016\16023.BW\Units\42\16023-S42-19.dwg - Tue - Mar 8 2022 - 1:00 PM

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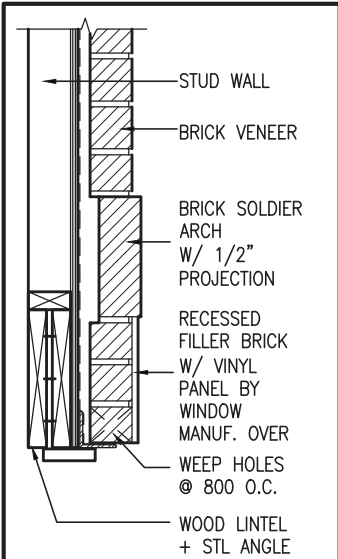
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JOHN G. WILLIAMS LTD., ARCHITECT
ARCHITECTURAL CONTROL REVIEW
AND APPROVAL

APPROVED BY: 
DATE: MAR 15, 2022

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Y BRICK ARCH W/ VINYL
PANEL BELOW DETAIL
NTS.

PREFIN. ALUM. R.W.L.,
FASCIA, GUTTER &
VENTED SOFFIT (TYP.)

BRICK SOLDIER COURSE
ON BRICK STACK BOND
W/ 1/2" PROJ. (TYP.)

FACE BRICK (TYP.)

BRICK SOLDIER COURSE
HEADER C/W KEYSTONE W/
1/2" PROJ. (TYP.)

12" FG TRANSOM

PREFIN. MTL. FLASHING,
W/ CAULKING TO MATCH
MASONRY COLOUR (TYP.)

RWL

RWL

30"x16"

30"x16"

POURED CONC. DOOR
SILL & PRECAST
CONC. STEP (21)

RWL

POURED CONC. FOUNDATION
WALLS AND FOOTINGS (TYP.)

TOP OF SLAB

REAR UPGRADE ELEVATION 'A'

R.W.L. AS REQUIRED &
AS PER MUNICIPALITY

NOTE: REFER TO FRONT
ELEVATION FOR TYPICAL
NOTE INFORMATION



MAR 8, 2022

STUCCO FINISH W/ 6"
STUCCO FRIEZE BOARD

6"x16" STUCCO IMPOST

PREFIN. MTL. FLASHING, W/
CAULKING BEHIND STUCCO
CLADDING (TYP.)

BRICK SOLDIER COURSE ARCH
C/W PRECAST CONC.
KEYSTONE ON BRICK STACK
BOND W/ 1/2" PROJ. (TYP.)

PRECAST CONC. SILL ON BRICK
ROWLOCK W/ 1/2" PROJ. (TYP.)

BRICK SOLDIER COURSE HEAR
C/W KEYSTONE ON BRICK STACK
BOND W/ 1/2" PROJ. (TYP.)

TOP OF PLATE

TOP OF WINDOW

FIN SECOND FLOOR

TOP OF TRANSOM

TOP OF DOOR/WINDOW

FIN GROUND FLOOR

FIN GRADE

8'-7"
(10'-1" FOR OPT. 9'-0" BASEMENT)

6'-10"
10'-1"

6'-10"
8'-1"

The undersigned has reviewed and takes responsibility for this design and has the qualifications and meets the requirements set out in the Ontario Building Code to be a Designer.

qualification information

Wellington Jno-Baptiste 25591 BCIN

name registration information VAS Design Inc. 42658

Contractor must verify all dimensions on the job and report any discrepancy to the Designer before proceeding with the work. All drawings and specifications are instruments of service and the property of the Designer which must be returned at the completion of the work. Drawings are not to be scaled.

3 REVISED AS PER ENG COMMENTS MAR 03-22 RC

2 REVISED AS PER FLOOR / ROOF LAYOUT FEB 24-22 RC

1 ISSUED FOR CLIENT REVIEW NOV 26-21 VAS

no. description date by

VA3
DESIGN

255 Consumers Rd, Suite 120
Toronto, ON M2J 1P4
t 416.630.2255 f 416.630.4782
vas3design.com

BAYVIEW WELLINGTON

S42-19

project name GREEN VALLEY EAST BRADFORD, ONTARIO project no. 16023

date OCTOBER 2021 municipality REAR UPGRADE ELEVATION 'A' drawing no. 23

checked by JMW scale 3/16" = 1'-0" file name 16023-S42-19


drawn by RICHARD - H: \ARCHIVE\WORKING\2016\16023.BW\Units\42\16023-S42-19.dwg - Tue - Mar 8 2022 - 1:00 PM

REVIEWED


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JOHN G. WILLIAMS LTD., ARCHITECT
ARCHITECTURAL CONTROL REVIEW
AND APPROVAL

APPROVED BY: 
DATE: MAR 15, 2022

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Y BRICK ARCH W/ VINYL
PANEL BELOW DETAIL
NTS.

6"x16" STONE IMPOST

PREFIN. ALUM. R.W.L.,
FASCIA, GUTTER &
VENTED SOFFIT (TYP.)

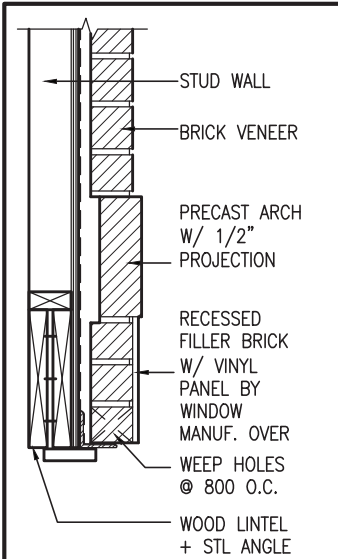
FACE BRICK (TYP.)

8" PRECAST CONC. HEADER
W/ 1/2" PROJ. (TYP.)

12" FG TRANSOM

PREFIN. MTL. FLASHING,
W/ CAULKING TO MATCH
MASONRY COLOUR (TYP.)

PRECAST CONC. SILL
W/ 1/2" PROJ. (TYP.)

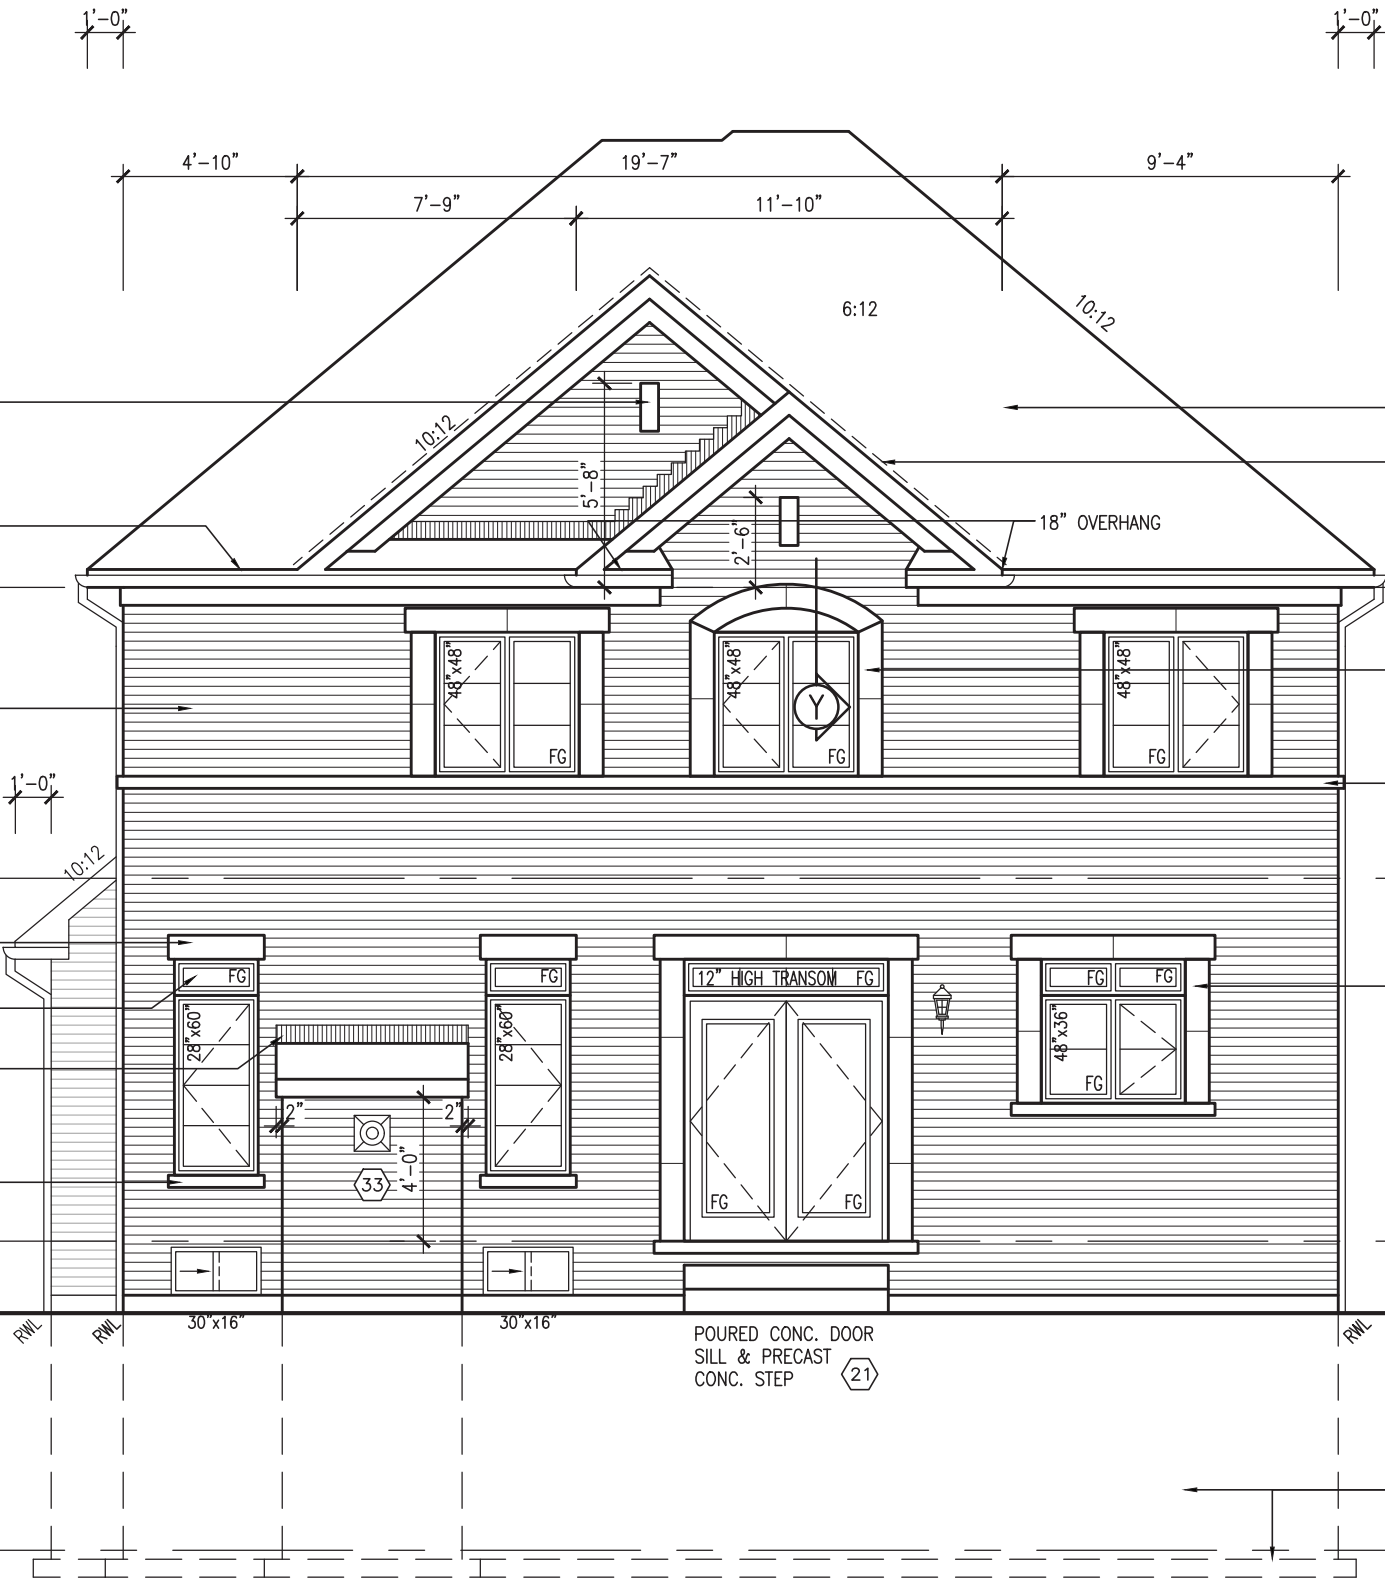

R.W.L. AS REQUIRED &
AS PER MUNICIPALITY

NOTE: REFER TO FRONT
ELEVATION FOR TYPICAL
NOTE INFORMATION



MAR 8, 2022

ASPHALT SHINGLES (TYP.)

VALLEY FLASHING (TYP.)

TOP OF PLATE

TOP OF WINDOW

8" PRECAST CONC. ARCH OVER
VINYL PANEL BY WINDOW MANUF.
ON 8" PRECAST CONC. SURROUND
W/ 1/2" PROJ. (TYP.)

CONT. PRECAST CONC. BAND
W/ 1/2" PROJ. (TYP.)

FIN SECOND FLOOR

TOP OF TRANSOM

8" PRECAST CONC. SURROUND
ON 4" PRECAST CONC. SILL
W/ 1/2" PROJ. (TYP.)

TOP OF DOOR/WINDOW

FIN GROUND FLOOR

FIN GRADE

POURED CONC. FOUNDATION
WALLS AND FOOTINGS (TYP.)

TOP OF SLAB

REAR UPGRADE ELEVATION 'B'

REVIEWED

S42-19

BAYVIEW WELLINGTON

VA3
DESIGN

The undersigned has reviewed and takes responsibility for this design and has the qualifications and meets the requirements set out in the Ontario Building Code to be a Designer.
qualification information
Wellington Jno-Baptiste 25591 BCIN
name
VA3 Design Inc. 42658
registration information
Contractor must verify all dimensions on the job and report any discrepancy to the Designer before proceeding with the work. All drawings and specifications are instruments of service and the property of the Designer which must be returned at the completion of the work. Drawings are not to be scaled.

no.	description	date	by
9			
8			
7			
6			
5			
4			
3	REVISED AS PER ENG COMMENTS	MAR 03-22	RC
2	REVISED AS PER FLOOR / ROOF LAYOUT	FEB 24-22	RC
1	ISSUED FOR CLIENT REVIEW	NOV 26-21	VA3

project no. 16023
drawing no. 24
project name GREEN VALLEY EAST
municipality BRADFORD, ONTARIO
date OCTOBER 2021
checked by JMW
drawn by TP
scale 3/16" = 1'-0"

REAR UPGRADE ELEVATION 'B'

16023-S42-19
RICHARD - H:\ARCHIVE\WORKING\2016\16023.BW\Units\42\16023-S42-19.dwg - Tue - Mar 8 2022 - 1:00 PM


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JOHN G. WILLIAMS LTD., ARCHITECT
ARCHITECTURAL CONTROL REVIEW
AND APPROVAL

APPROVED BY: 
DATE: MAR 15, 2022

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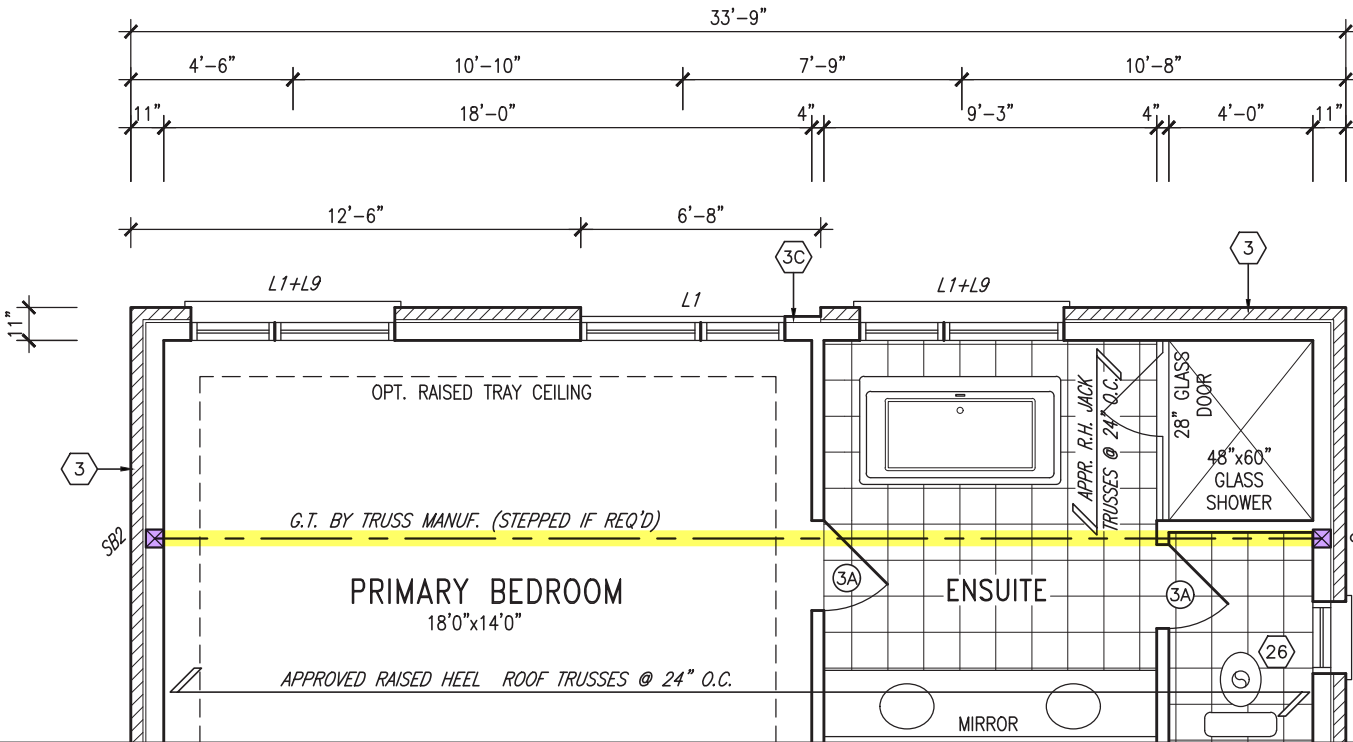
GRAB BAR NOTE:

STUD WALL REINFORCEMENT FOR FUTURE GRAB BARS IN MAIN BATHROOM
REINFORCEMENT OF STUD WALLS SHALL BE INSTALLED ADJACENT TO WATER CLOSETS AND SHOWER OR BATHTUB IN MAIN BATHROOM PER OBC. DIV. B-9.5.2.3. REFER TO FOLLOWING SECTIONS FOR THE FIXTURES LISTED. WATER CLOSET: 3.8.3.8.(3)(a) & 3.8.3.8.(3)(c). SHOWER 3.8.3.13.(2)(g). BATHTUB 3.8.3.13.(4)(e). FREE STANDING BATHTUB EXCLUDED. SEE DETAILS PROVIDED.
GB-NOTE-2020.dwg

PARTIAL SECOND FLOOR PLAN 'C'
W/ REAR UPGRADE

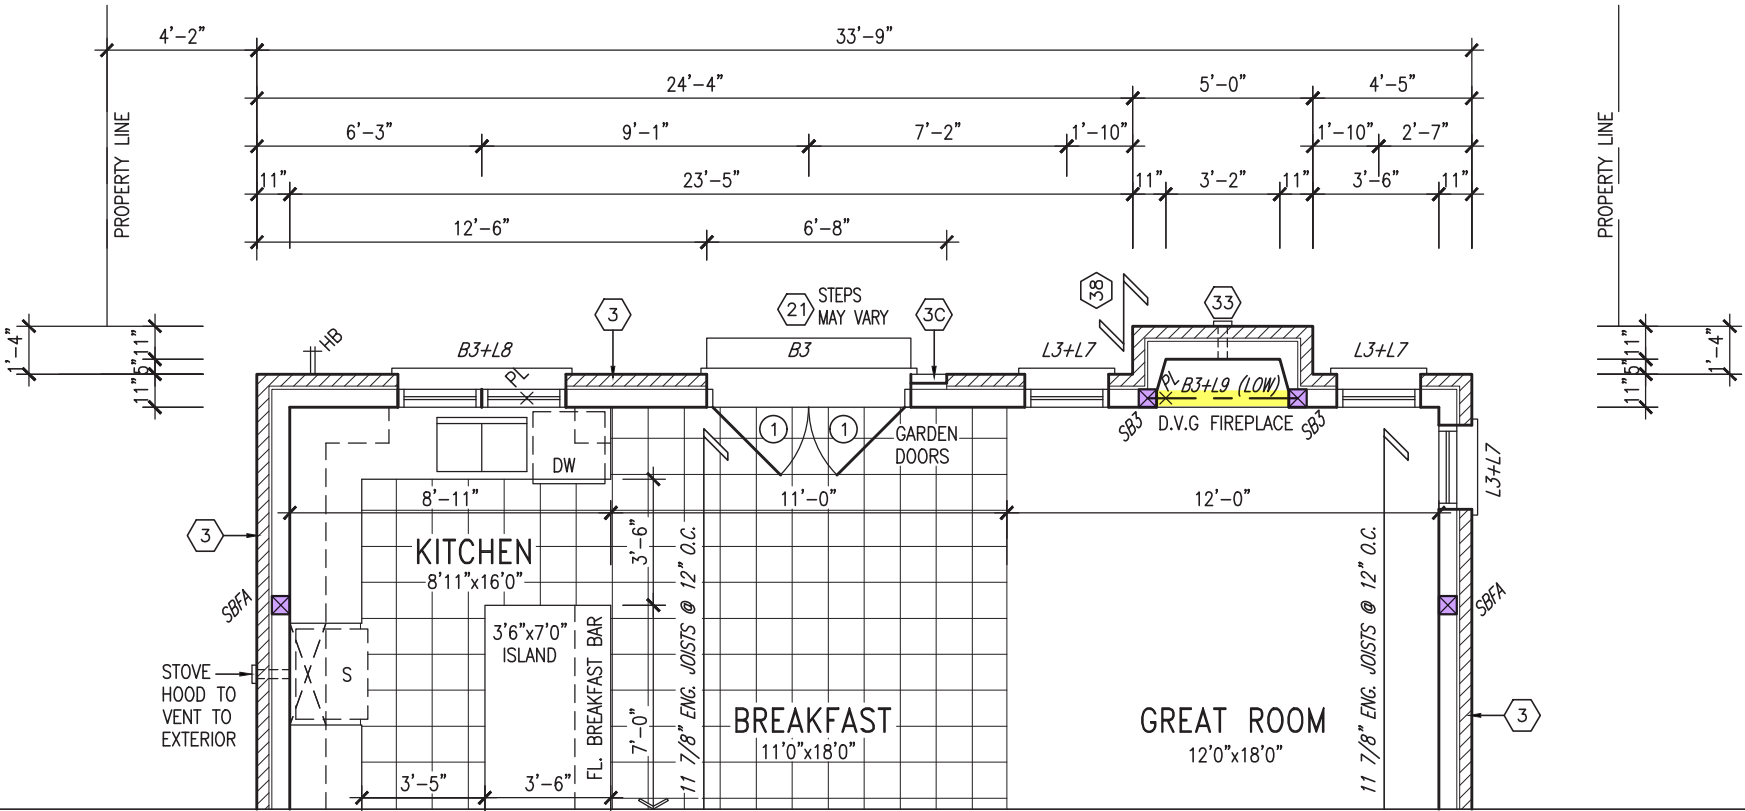NOTE:
REFER TO ROOF TRUSS SHOP DRAWINGS / MANUFACTURER FOR ALL ROOF FRAMING INFORMATION UNLESS OTHERWISE NOTED.

NOTE: REFER TO STANDARD FLOOR PLANS FOR ADDITIONAL INFORMATION



PARTIAL GROUND FLOOR PLAN 'C'
W/ REAR UPGRADE

NOTE:
ALL LVL'S SUPPORTING FLOOR LOADS ARE TO BE SPECIFIED BY THE FLOOR TRUSS MANUFACTURER.

NOTE:
FLOOR FRAMING INFO REFER TO ENG SHOP DRAWINGS FOR ALL TRUSS-JOIST INFORMATION AND DETAILS. UNLESS OTHERWISE NOTED.

NOTE:
SPACE ALL FLOOR JOISTS @ 12" O.C. UNDER ALL CERAMIC TILE AREAS.

NOTE: REFER TO STANDARD FLOOR PLANS FOR ADDITIONAL INFORMATION

OUTDOOR AIR INTAKE SEPARATION
ALL OUTDOOR AIR INTAKE VENTS TO BE SEPARATED A MINIMUM DISTANCE FROM SOURCES OF CONTAMINATION PER OBC. DIV. B- TABLE 6.2.3.12.
• KITCHEN EXHAUST. 3.0m
• DRIVEWAY, PARKING SPACE, ROAD. 1.5m
• SOLID FUEL APPLIANCE EXHAUST 3.0m
KIT-EX-NOTE-2020.dwg

9	REVIEWED
8	
7	
6	
5	
4	
3	REVISED AS PER ENG COMMENTS
2	REVISED AS PER FLOOR / ROOF LAYOUT
1	ISSUED FOR CLIENT REVIEW
no.	description

The undersigned has reviewed and takes responsibility for this design and has the qualifications and meets the requirements set out in the Ontario Building Code to be a Designer.			
qualification information			
Wellington Jno-Baptiste	signature	25591	BCIN
name			
registration information			
VA3 Design Inc.		42658	
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VA3 DESIGN


255 Consumers Rd Suite 120
Toronto ON M2J 1R4
t 416.630.2255 f 416.630.4782
va3design.com

BAYVIEW WELLINGTON		S42-19	
project name		project no.	
GREEN VALLEY EAST		16023	
municipality		drawing no.	
BRADFORD, ONTARIO		25	
date		PARTIAL PLANS 'C' W/ REAR UPGRADE	
OCTOBER 2021		file name	
drawn by		16023-S42-19	
TP		checked by	
JWM		scale	
3/16" = 1'-0"		TUE - MAR 8 2022 - 1:00 PM	

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JOHN G. WILLIAMS LTD., ARCHITECT
ARCHITECTURAL CONTROL REVIEW
AND APPROVAL

APPROVED BY: 
DATE: MAR 15, 2022

This stamp certifies compliance with the applicable Design Guidelines only and bears no further professional responsibility.

R.W.L. AS REQUIRED &
AS PER MUNICIPALITY

NOTE: REFER TO FRONT
ELEVATION FOR TYPICAL
NOTE INFORMATION



REAR UPGRADE ELEVATION 'C'


REVIEWED

BAYVIEW WELLINGTON		S42-19	
GREEN VALLEY EAST		BRADFORD, ONTARIO	
project name		project no.	
16023-S42-19		16023	
drawing no.		26	
date		checked by	
OCTOBER 2021		JWM	
drawn by		scale	
TP		3/16" = 1'-0"	
municipality		REAR UPGRADE ELEVATION 'C'	
BRADFORD, ONTARIO		16023-S42-19	
file name		16023-S42-19	
RICHARD - H:\ARCHIVE\WORKING\2016\16023.BW\Units\42\16023-S42-19.dwg		date	
Tue - Mar 8 2022 - 1:00 PM		description	
1		ISSUED FOR CLIENT REVIEW	
2		REVISED AS PER FLOOR / ROOF LAYOUT	
3		REVISED AS PER ENG COMMENTS	
4		MAR 03-22 RC	
5		FEB 24-22 RC	
6		NOV 26-21 VA3	
7		NOV 26-21 VA3	
8		NOV 26-21 VA3	
9		NOV 26-21 VA3	


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This is to certify that these plans comply with the applicable Architectural Design Guidelines approved by the Town of BRADFORD WEST GWILLIMBURY.

JOHN G. WILLIAMS LTD., ARCHITECT
ARCHITECTURAL CONTROL REVIEW
AND APPROVAL

APPROVED BY: 
DATE: MAR 15, 2022

This stamp certifies compliance with the applicable Design Guidelines only and bears no further professional responsibility.

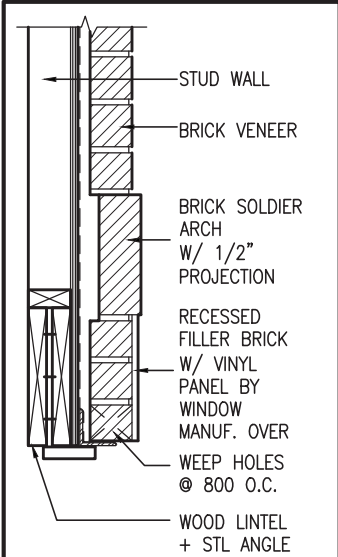

Y BRICK ARCH W/ VINYL
PANEL BELOW DETAIL
NTS.

PREFIN. ALUM. R.W.L.,
FASCIA, GUTTER &
VENTED SOFFIT (TYP.)

BRICK SOLDIER COURSE
ON BRICK STACK BOND
W/ 1/2" PROJ. (TYP.)

FACE BRICK (TYP.)

BRICK SOLDIER COURSE
HEADER C/W KEYSTONE W/
1/2" PROJ. (TYP.)

12" FG TRANSOM

PREFIN. MTL. FLASHING,
W/ CAULKING TO MATCH
MASONRY COLOUR (TYP.)

1'-0"

1'-0"

R.W.L.

R.W.L.



R.W.L. AS REQUIRED &
AS PER MUNICIPALITY

NOTE: REFER TO FRONT
ELEVATION FOR TYPICAL
NOTE INFORMATION



MAR 8, 2022

STUCCO FINISH W/ 6"
STUCCO FRIEZE BOARD

6"x16" STUCCO IMPOST

PREFIN. MTL. FLASHING, W/
CAULKING BEHIND STUCCO
CLADDING (TYP.)

TOP OF PLATE

TOP OF WINDOW

BRICK SOLDIER COURSE ARCH
C/W PRECAST CONC.
KEYSTONE ON BRICK STACK
BOND W/ 1/2" PROJ. (TYP.)

PRECAST CONC. SILL ON BRICK
ROWLOCK W/ 1/2" PROJ. (TYP.)

FIN SECOND FLOOR

BRICK SOLDIER COURSE HEAR
C/W KEYSTONE ON BRICK STACK
BOND W/ 1/2" PROJ. (TYP.)

TOP OF TRANSOM

TOP OF DOOR/WINDOW

PROVIDE 2"x4" P.T. WOOD
HANDRAIL GUARD W/ 2"x2" P.T.
WOOD PICKETS @ 4" MAX.

FIN GROUND FLOOR

6"x6" P.T. WOOD POST C/W
GALV. METAL CAP AND METAL
SHOE SET INTO 12" DIA. SONO
TUBES TO EXTEND 6" ABOVE
GRADE AND 5'-0" BELOW GRADE.

TOP OF WINDOW

FIN GRADE

POURED CONC. FOUNDATION
WALLS AND FOOTINGS (TYP.)

TOP OF SLAB

REAR UPGRADE ELEVATION 'A' - W.O.D. CONDITION

REVIEWED

S42-19

BAYVIEW WELLINGTON

VA3
DESIGN

The undersigned has reviewed and takes responsibility for this design and has the qualifications and meets the requirements set out in the Ontario Building Code to be a Designer.
qualification information
Wellington Jno-Baptiste 25591 BCIN
name
signature
VA3 Design Inc.
42658
Contractor must verify all dimensions on the job and report any discrepancy to the Designer before proceeding with the work. All drawings and specifications are instruments of service and the property of the Designer which must be returned at the completion of the work. Drawings are not to be scaled.

no.	description	date	by
9			
8			
7			
6			
5			
4			
3	REVISED AS PER ENG COMMENTS	MAR 03-22	RC
2	REVISED AS PER FLOOR / ROOF LAYOUT	FEB 24-22	RC
1	ISSUED FOR CLIENT REVIEW	NOV 26-21	VA3

project no. 16023
drawing no. 27
project name GREEN VALLEY EAST
municipality BRADFORD, ONTARIO
date OCTOBER 2021
checked by JMW
drawn by TP
scale 3/16" = 1'-0"

16023-S42-19
file name
RICHARD - H:\ARCHIVE\WORKING\2016\16023.BW\Units\42\16023-S42-19.dwg - Tue - Mar 8 2022 - 1:00 PM


255 Consumers Rd, Suite 120
Toronto, ON M2J 1P4
t 416.630.2255 f 416.630.4782
va3design.com

This is to certify that these plans comply with the applicable Architectural Design Guidelines approved by the Town of BRADFORD WEST GWILLIMBURY.

JOHN G. WILLIAMS LTD., ARCHITECT
ARCHITECTURAL CONTROL REVIEW
AND APPROVAL

APPROVED BY: _____
DATE: MAR 15, 2022

This stamp certifies compliance with the applicable
Design Guidelines only and bears no further
professional responsibility.

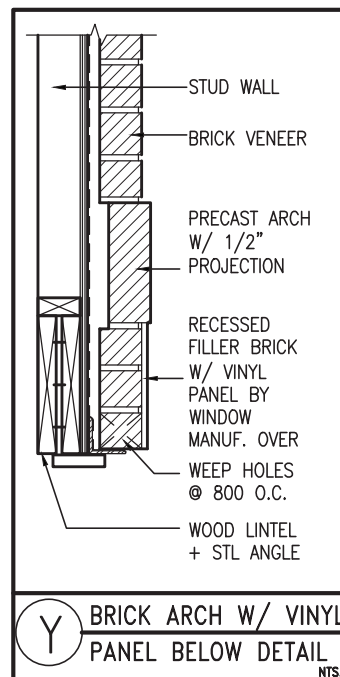

6"x16" STONE IMPOST

PREFIN. ALUM. R.W.L.,
FASCIA, GUTTER &
VENTED SOFFIT (TYP.)

FACE BRICK (TYP.)

8" PRECAST CONC. HEADER
W/ 1/2" PROJ. (TYP.)

12" FG TRANSOM

PREFIN. MTL. FLASHING,
W/ CAULKING TO MATCH
MASONRY COLOUR (TYP.)

PRECAST CONC. SILL
W/ 1/2" PROJ. (TYP.)

REAR UPGRADE ELEVATION 'B' - W.O.D. CONDITION

R.W.L. AS REQUIRED &
AS PER MUNICIPALITY

NOTE: REFER TO FRONT
ELEVATION FOR TYPICAL
NOTE INFORMATION



MAR 8, 2022

— ASPHALT SHINGLES (TYP.)

— VALLEY FLASHING (TYP.)

TOP OF PLATF

TOP OF WINDOW

8" PRECAST CONC. ARCH OVER
— VINYL PANEL BY WINDOW MANUF.
ON 8" PRECAST CONC. SURROUND
W/ 1/2" PROJ. (TYP.)

CONT. PRECAST CONC. BAND
W/ 1/2" PROJ. (TYP.)

FIN SECOND FLOOR

TOP OF TRANSOM

TOP OF DOOR/WINDOW

PROVIDE 2"x4" P.T. WOOD
— HANDRAIL GUARD W/ 2"x2" P.T.
WOOD PICKETS @ 4" MAX.

FIN GROUND FLOOR

TOP OF WINDOW

6"X6" P.T. WOOD POST C/W
GALV. METAL CAP AND METAL
— SHOE SET INTO 12" DIA. SONO
TUBES TO EXTEND 6" ABOVE
GRADE AND 5'-0" BELOW GRADE.

FIN GRADE

POURED CONC. FOUNDATION
WALLS AND FOOTINGS (TYP.)

REVIEWED

S42-19

BAYVIEW WELLINGTON

project name	project no.
GREEN VALLEY EAST	16023
BRADFORD, ONTARIO	
municipality	

date **OCTOBER 2021** REAR UPGRADE ELEVATION 'B' - W.O.D. COND. file name
 drawn by **JWM** checked by **JWM** scale **3/16" = 1'-0"** 16023-S42-19
 TP

VA3 REGION

DESIGN
255 Consumers Rd Suite 120
Toronto ON M2J 1R4
416.630.2255 f 416.630.4782
info@design.com

The undersigned has reviewed and takes responsibility for this design and has the qualifications and meets the requirements set out in the Ontario Building Code to be a Designer.

Wellington Jno-Baptiste	25591
signature	BCIN

42658
VA3 Design Inc.

Drawings and specifications are instruments of service and the property of the Designer which must be returned at the completion of the work.


Drawings are not to be scaled.

no.	description
-----	-------------

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JOHN G. WILLIAMS LTD., ARCHITECT
ARCHITECTURAL CONTROL REVIEW
AND APPROVAL

APPROVED BY: 
DATE: MAR 15, 2022


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R.W.L. AS REQUIRED &
AS PER MUNICIPALITY

NOTE: REFER TO FRONT
ELEVATION FOR TYPICAL
NOTE INFORMATION



MAR 8, 2022

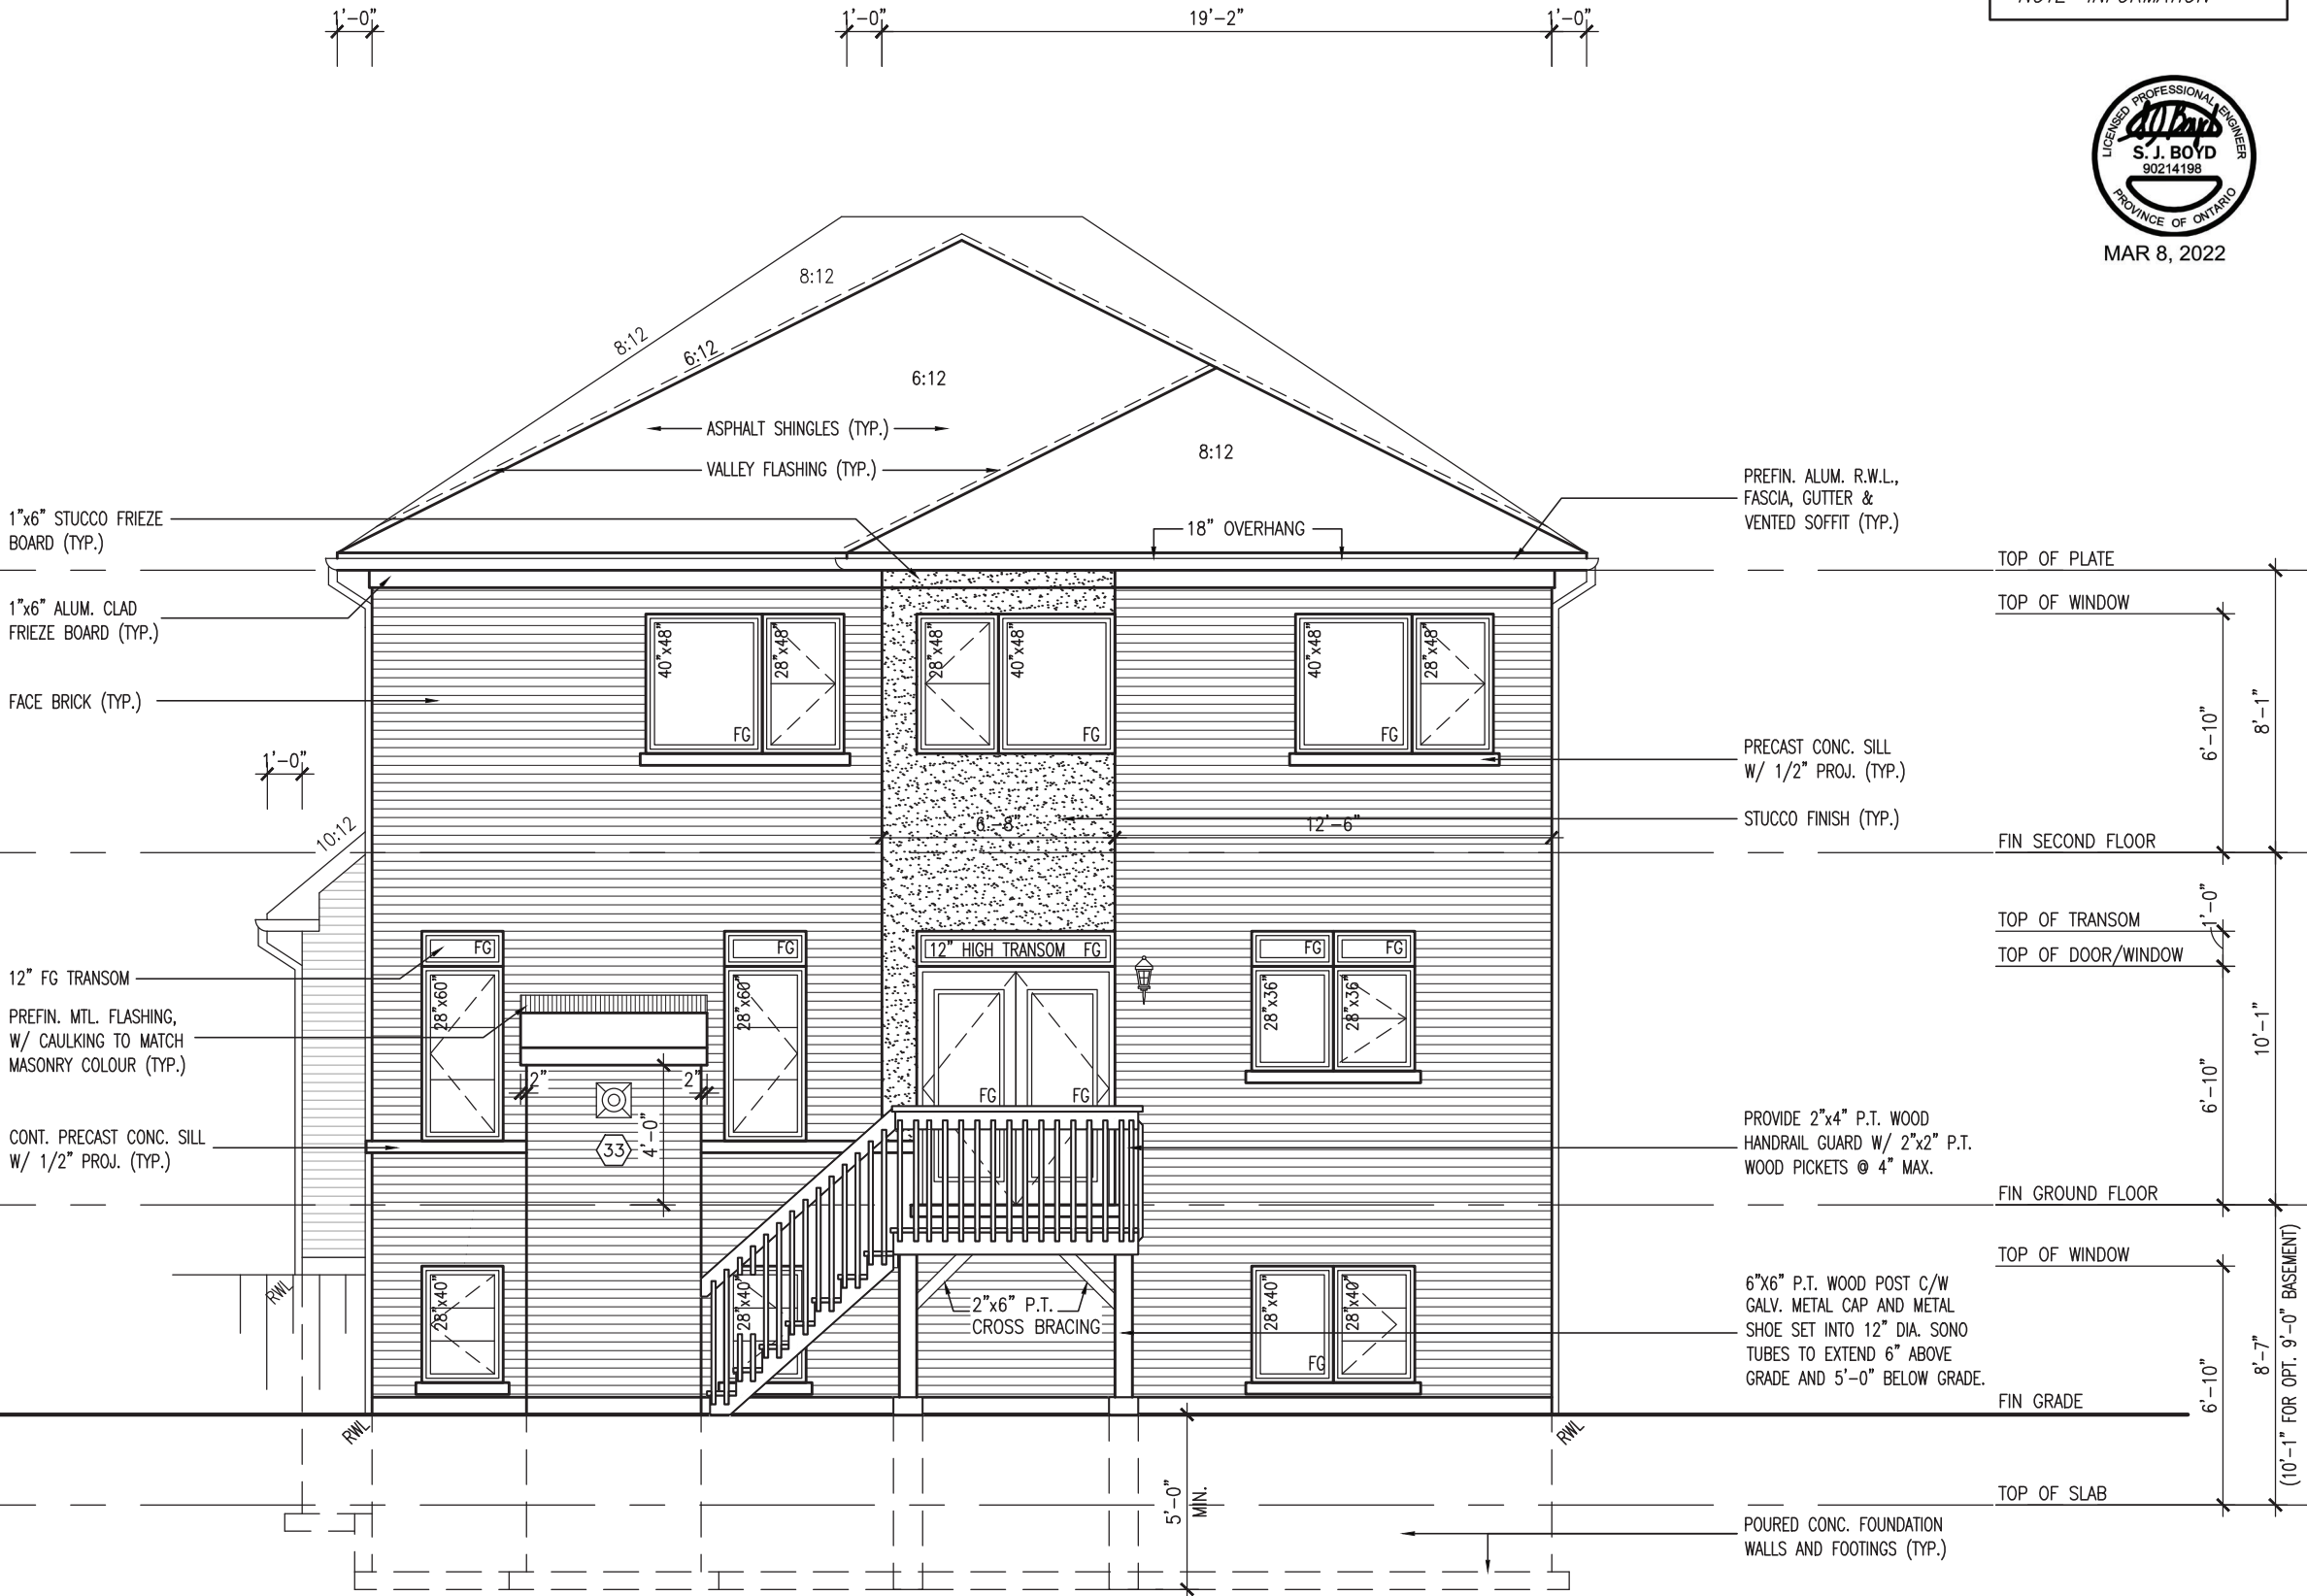

REAR UPGRADE ELEVATION 'C' - W.O.D. CONDITION

REVIEWED

S42-19

BAYVIEW WELLINGTON

VA3
DESIGN

The undersigned has reviewed and takes responsibility for this design and has the qualifications and meets the requirements set out in the Ontario Building Code to be a Designer.
qualification information
Wellington Jno-Baptiste 25591 BCN
name
registration information
VA3 Design Inc. 42658
Contractor must verify all dimensions on the job and report any discrepancy to the Designer before proceeding with the work. All drawings and specifications are instruments of service and the property of the Designer which must be returned at the completion of the work. Drawings are not to be scaled.

no.	description	date	by
9			
8			
7			
6			
5			
4			
3	REVISED AS PER ENG COMMENTS	MAR 03-22	RC
2	REVISED AS PER FLOOR / ROOF LAYOUT	FEB 24-22	RC
1	ISSUED FOR CLIENT REVIEW	NOV 26-21	VA3

project no. 16023
drawing no. 29
project name GREEN VALLEY EAST
municipality BRADFORD, ONTARIO
date OCTOBER 2021
checked by JWM
drawn by TP
scale 3/16" = 1'-0"

REAR UPGRADE ELEVATION 'C' - W.O.D. COND.
16023-S42-19
RICHARD - H:\ARCHIVE WORKING\2016\16023.BW\Units\42\16023-S42-19.dwg - Tue - Mar 8 2022 - 1:01 PM

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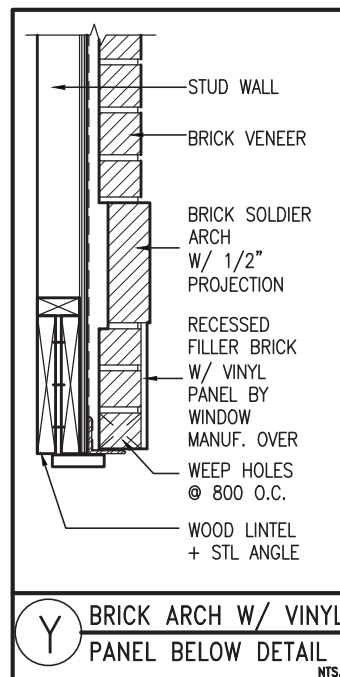
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JOHN G. WILLIAMS LTD., ARCHITECT
ARCHITECTURAL CONTROL REVIEW
AND APPROVAL

APPROVED BY: _____

DATE: MAR 15, 2022

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Design Guidelines only and bears no further
professional responsibility.



PREFIN. ALUM. R.W.L.,
FASCIA, GUTTER &
VENTED SOFFIT (TYP.)

BRICK SOLDIER COURSE
ON BRICK STACK BOND
W/ 1/2" PROJ. (TYP.)

FACE BRICK (TYP.)

BRICK SOLDIER COURSE
HEADER C/W KEYSTONE W/
1/2" PROJ. (TYP.)

12" FG TRANSOM

PREFIN. MTL. FLASHING,
W/ CAULKING TO MATCH
MASONRY COLOUR (TYP.)

R.W.L. AS REQUIRED &
AS PER MUNICIPALITY

NOTE: REFER TO FRONT
ELEVATION FOR TYPICAL
NOTE INFORMATION



MAR 8, 2022

STUCCO FINISH W/ 6"
STUCCO FRIEZE BOARD

— 6"x16" STUCCO IMPOST

PREFIN. MTL. FLASHING, W/
— CAULKING BEHIND STUCCO
CLADDING (TYP.)

BRICK SOLDIER COURSE ARCH
C/W PRECAST CONC.
KEYSTONE ON BRICK STACK
BOND W/ 1/2" PROJ. (TYP.)

— PRECAST CONC. SILL ON BRICK
ROWLOCK W/ 1/2" PROJ. (TYP.)

BRICK SOLDIER COURSE HEAR
C/W KEYSTONE ON BRICK STACK
BOND W/ 1/2" PROJ. (TYP.)

PROVIDE 2"x4" P.T. WOOD
— HANDRAIL GUARD W/ 2"x2" P.T.
WOOD PICKETS @ 4" MAX.

2"x6" P.T.
CROSS BRACING

6"X6" P.T. WOOD POST C/W
GALV. METAL CAP AND METAL
SHOE SET INTO 12" DIA. SONO
TUBES TO EXTEND 6" ABOVE
GRADE AND 5'-0" BELOW GRAD

POURED CONC. FOUNDATION
WALLS AND FOOTINGS (TYP.)

REAR UPGRADE ELEVATION 'A' - W.O.B. CONDITION

REVIEWED

S42-19

BAYVIEW WELLINGTON

project name	project no.
GREEN VALLEY EAST	16023
BRADFORD, ONTARIO	

GREEN VALLEY CRAFT	BRANDFORD, CONNECTICUT	100023
DATE OCTOBER 2021		DRAWING NO. 30
REAR UPGRADE ELEVATION 'A' - W.O.D. COND.		FILE NAME 16023-S42-19
CHECKED BY JWM	SCALE 3/16" = 1'-0"	

VA3

DESIGN
5 Consumers Rd Suite 120
Toronto ON M2J 1R4
16.630.2255 f 416.630.4782
www.idealcan.com

he undersigned has reviewed and takes responsibility for this design and has the qualifications and meets the requirements set out in the Ontario Building Code to be a Designer.

Wellington Jno-Baptiste	signature	25591
name	BCIN	

contractor must verify all dimensions on the job and report any discrepancy to the Designer before proceeding with the work. All drawings and specifications are instruments of service and the property of the Designer which must be returned at the completion of the work.

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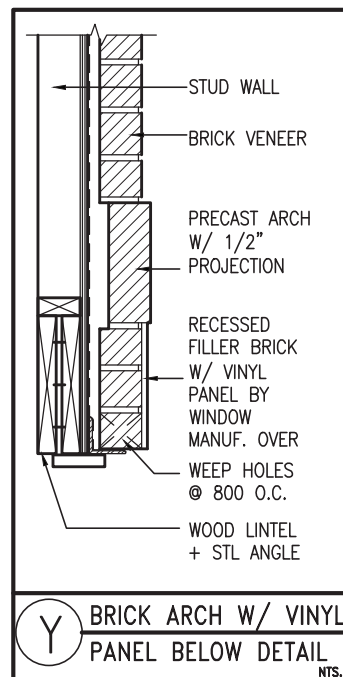
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vujdesig11.com

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JOHN G. WILLIAMS LTD., ARCHITECT
ARCHITECTURAL CONTROL REVIEW
AND APPROVAL

APPROVED BY: _____
DATE: MAR 15, 2022

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6"x16" STONE IMPOST

PREFIN. ALUM. R.W.L.,
FASCIA, GUTTER &
VENTED SOFFIT (TYP.)

FACE BRICK (TYP.)

8" PRECAST CONC. HEADER
W/ 1/2" PROJ. (TYP.)

12" FG TRANSOM

PREFIN. MTL. FLASHING,
W/ CAULKING TO MATCH
MASONRY COLOUR (TYP.)

PRECAST CONC. SILL
W/ 1/2" PROJ. (TYP.)

R.W.L. AS REQUIRED &
AS PER MUNICIPALITY

NOTE: REFER TO FRONT
ELEVATION FOR TYPICAL
NOTE INFORMATION



MAR 8, 2022

TOP OF PLATF

TOP OF WINDOW

— ASPHALT SHINGLES (TYP.)

— VALLEY FLASHING (TYP.)

8" PRECAST CONC. ARCH OVER
— VINYL PANEL BY WINDOW MANUF.
ON 8" PRECAST CONC. SURROUND
W/ 1/2" PROJ. (TYP.)

CONT. PRECAST CONC. BAND
W/ 1/2" PROJ. (TYP.)

FIN SECOND FLOOR

TOP OF TRANSOM

TOP OF DOOR/WINDOW

8" PRECAST CONC. SURROUND
— ON 4" PRECAST CONC. SILL
W/ 1/2" PROJ. (TYP.)

PROVIDE 2"x4" P.T. WOOD
— HANDRAIL GUARD W/ 2"x2" P.T.
WOOD PICKETS @ 4" MAX.

FIN GROUND FLOOR

TOP OF DOOR/WINDOW

2 x 6 P.I.
CROSS BRACING

6"X6" P.T. WOOD POST C/W
GALV. METAL CAP AND METAL
SHOE SET INTO 12" DIA. SONO
TUBES TO EXTEND 6" ABOVE
GRADE AND 5'-0" BELOW GRAD

TOP OF SLAB
FIN GRADE

POURED CONC. FOUNDATION
WALLS AND FOOTINGS (TYP.)

REAR UPGRADE ELEVATION 'B' – W.O.B. CONDITION

REVIEWED

S42-19

BAYVIEW WELLINGTON

VA3
DESIGN

The undersigned has reviewed and takes responsibility for this design and has the qualifications and meets the requirements set out in the Minimum Building Code to be a Designer.

signature

name

registration information

V33 Design Inc.

Wellington Jno-Baptiste 25591

BON 42658

contractor must verify all dimensions on the job and report any discrepancy to the Designer before proceeding with the work. All drawings and specifications are instruments of service and the property of the Designer which must be returned at the completion of the work. Drawings are not to be scaled.


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JOHN G. WILLIAMS LTD., ARCHITECT
ARCHITECTURAL CONTROL REVIEW
AND APPROVAL

APPROVED BY: 
DATE: MAR 15, 2022

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R.W.L. AS REQUIRED &
AS PER MUNICIPALITY

NOTE: REFER TO FRONT
ELEVATION FOR TYPICAL
NOTE INFORMATION



MAR 8, 2022

1"x6" STUCCO FRIEZE
BOARD (TYP.)

1"x6" ALUM. CLAD
FRIEZE BOARD (TYP.)

FACE BRICK (TYP.)

12" FG TRANSOM

PREFIN. MTL. FLASHING,
W/ CAULKING TO MATCH
MASONRY COLOUR (TYP.)

CONT. PRECAST CONC. SILL
W/ 1/2" PROJ. (TYP.)

PREFIN. ALUM. R.W.L.,
FASCIA, GUTTER &
VENTED SOFFIT (TYP.)

PRECAST CONC. SILL
W/ 1/2" PROJ. (TYP.)

STUCCO FINISH (TYP.)

PROVIDE 2"x4" P.T. WOOD
HANDRAIL GUARD W/ 2"x2" P.T.
WOOD PICKETS @ 4" MAX.

2"x6" P.T.
CROSS BRACING

6"x6" P.T. WOOD POST C/W
GALV. METAL CAP AND METAL
SHOE SET INTO 12" DIA. SONO
TUBES TO EXTEND 6" ABOVE
GRADE AND 5'-0" BELOW GRADE.

POURED CONC. FOUNDATION
WALLS AND FOOTINGS (TYP.)

TOP OF PLATE
TOP OF WINDOW
6'-10"
8'-1"
FIN SECOND FLOOR
TOP OF TRANSOM
TOP OF DOOR/WINDOW
1'-0"
10'-1"
6'-10"
FIN GROUND FLOOR
TOP OF DOOR/WINDOW
8'-7"
6'-10"
(10'-1" FOR OPT. 9'-0" BASEMENT)
TOP OF SLAB
FIN GRADE

REAR UPGRADE ELEVATION 'C' - W.O.B. CONDITION

REVIEWED

S42-19

BAYVIEW WELLINGTON

VA3
DESIGN

Wellington Jno-Baptiste
Signature
BCIN 25591
42658

name
registration information
VA3 Design Inc.

3. REVISED AS PER ENG. COMMENTS
2. REVISED AS PER FLOOR / ROOF LAYOUT
1. ISSUED FOR CLIENT REVIEW

no. description

9 .
8 .
7 .
6 .
5 .
4 .

date

by

description

project no. 16023
drawing no. 32
project name GREEN VALLEY EAST
municipality BRADFORD, ONTARIO
date OCTOBER 2021
drawn by JWM
checked by JWM
scale 3/16" = 1'-0"

REAR UPGRADE ELEVATION 'C' - W.O.D. COND.

255 Consumers Rd. Suite 120
Toronto, ON M2J 1P4
t 416.630.2255 f 416.630.4782
va3design.com

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UNINSULATED OPENINGS (PER OBC. SB-12,3.1.1(7))				
STANDARD & REAR UPGRADE-9' GDN. FL.	S42-19 ELEVATION A	ENERGY EFFICIENCY – OBC SB12		
	ELEVATION	WALL AREA S.F.	OPENING S.F.	PERCENTAGE
	FRONT	664 S.F.	134.86 S.F.	20.31 %
	LEFT SIDE	1106 S.F.	77.33 S.F.	6.99 %
	RIGHT SIDE	1106 S.F.	71.33 S.F.	6.45 %
	REAR	681 S.F.	143.05 S.F.	21.01 %
	* OPENINGS OMITTED AS PER SB-12 3.1.1.9(4) MAX 19.9 S.F. REFER TO ELEVATION FOR LOCATION		0.00 S.F.	
	TOTAL SQ. FT.	3557.00 S.F.	426.57 S.F.	11.99 %
	TOTAL SQ. M.	330.45 S.M.	39.63 S.M.	11.99 %
UNINSULATED OPENINGS (PER OBC. SB-12,3.1.1(7))				
STANDARD & REAR UPGRADE W/ SIDE DOOR 9' GDN. FL.	S42-19 ELEVATION A	ENERGY EFFICIENCY – OBC SB12		
	ELEVATION	WALL AREA S.F.	OPENING S.F.	PERCENTAGE
	FRONT	664 S.F.	134.86 S.F.	20.31 %
	LEFT SIDE	1106 S.F.	77.33 S.F.	6.99 %
	RIGHT SIDE	1106 S.F.	80.83 S.F.	7.31 %
	REAR	681 S.F.	143.05 S.F.	21.01 %
	* OPENINGS OMITTED AS PER SB-12 3.1.1.9(4) MAX 19.9 S.F. REFER TO ELEVATION FOR LOCATION		0.00 S.F.	
	TOTAL SQ. FT.	3557.00 S.F.	436.07 S.F.	12.26 %
	TOTAL SQ. M.	330.45 S.M.	40.51 S.M.	12.26 %

UNINSULATED OPENINGS (PER OBC. SB-12,3.1.1(7))				
STANDARD & REAR UPGRADE 9' GDN. FL.	S42-19 ELEVATION A -W.O.D.		ENERGY EFFICIENCY - OBC SB12	
	ELEVATION	WALL AREA S.F.	OPENING S.F.	PERCENTAGE
	FRONT	664 S.F.	134.86 S.F.	20.31 %
	LEFT SIDE	1106 S.F.	77.33 S.F.	6.99 %
	RIGHT SIDE	1106 S.F.	71.33 S.F.	6.45 %
	REAR	816 S.F.	165.28 S.F.	20.25 %
	* OPENINGS OMITTED AS PER SB-12 3.1.1.9(4) MAX 19.9 S.F. REFER TO ELEVATION FOR LOCATION		0.00 S.F.	
	TOTAL SQ. FT.	3692.00 S.F.	448.80 S.F.	12.16 %
	TOTAL SQ. M.	343.00 S.M.	41.69 S.M.	12.16 %
UNINSULATED OPENINGS (PER OBC. SB-12,3.1.1(7))				
STANDARD & REAR UPGRADE W/ SIDE DOOR 9' GDN. FL.	S42-19 ELEVATION A -W.O.D.		ENERGY EFFICIENCY - OBC SB12	
	ELEVATION	WALL AREA S.F.	OPENING S.F.	PERCENTAGE
	FRONT	664 S.F.	134.86 S.F.	20.31 %
	LEFT SIDE	1106 S.F.	77.33 S.F.	6.99 %
	RIGHT SIDE	1106 S.F.	80.83 S.F.	7.31 %
	REAR	816 S.F.	165.28 S.F.	20.25 %
	* OPENINGS OMITTED AS PER SB-12 3.1.1.9(4) MAX 19.9 S.F. REFER TO ELEVATION FOR LOCATION		0.00 S.F.	
	TOTAL SQ. FT.	3692.00 S.F.	458.30 S.F.	12.41 %
	TOTAL SQ. M.	343.00 S.M.	42.58 S.M.	12.41 %

UNINSULATED OPENINGS (PER OBC. SB-12,3.1.1(7))				
STANDARD & REAR UPGRADE 9' GDN. FL.	S42-19 ELEVATION A -W.O.B.		ENERGY EFFICIENCY - OBC SB12	
	ELEVATION	WALL AREA S.F.	OPENING S.F.	PERCENTAGE
	FRONT	664 S.F.	134.86 S.F.	20.31 %
	LEFT SIDE	1106 S.F.	77.33 S.F.	6.99 %
	RIGHT SIDE	1106 S.F.	71.33 S.F.	6.45 %
	REAR	925 S.F.	218.44 S.F.	23.62 %
	* OPENINGS OMITTED AS PER SB-12 3.1.1.9(4) MAX 19.9 S.F. REFER TO ELEVATION FOR LOCATION		0.00 S.F.	
	TOTAL SQ. FT.	3801.00 S.F.	501.96 S.F.	13.21 %
	TOTAL SQ. M.	353.12 S.M.	46.63 S.M.	13.21 %
UNINSULATED OPENINGS (PER OBC. SB-12,3.1.1(7))				
STANDARD & REAR UPGRADE W/ SIDE DOOR 9' GDN. FL.	S42-19 ELEVATION A -W.O.B.		ENERGY EFFICIENCY - OBC SB12	
	ELEVATION	WALL AREA S.F.	OPENING S.F.	PERCENTAGE
	FRONT	664 S.F.	134.86 S.F.	20.31 %
	LEFT SIDE	1106 S.F.	77.33 S.F.	6.99 %
	RIGHT SIDE	1106 S.F.	80.83 S.F.	7.31 %
	REAR	925 S.F.	218.44 S.F.	23.62 %
	* OPENINGS OMITTED AS PER SB-12 3.1.1.9(4) MAX 19.9 S.F. REFER TO ELEVATION FOR LOCATION		0.00 S.F.	
	TOTAL SQ. FT.	3801.00 S.F.	511.46 S.F.	13.46 %
	TOTAL SQ. M.	353.12 S.M.	47.52 S.M.	13.46 %

UNINSULATED OPENINGS (PER OBC. SB-12,3.1.1(7))				
STANDARD & REAR UPGRADE 9' GDN. FL.	S42-19 ELEVATION B	ENERGY EFFICIENCY – OBC SB12		
	ELEVATION	WALL AREA S.F.	OPENING S.F.	PERCENTAGE
	FRONT	664 S.F.	125.53 S.F.	18.91 %
	LEFT SIDE	1106 S.F.	77.33 S.F.	6.99 %
	RIGHT SIDE	1106 S.F.	71.33 S.F.	6.45 %
	REAR	681 S.F.	143.05 S.F.	21.01 %
	* OPENINGS OMITTED AS PER SB-12 3.1.1.9(4) MAX 19.9 S.F. REFER TO ELEVATION FOR LOCATION		0.00 S.F.	
	TOTAL SQ. FT.	3557.00 S.F.	417.24 S.F.	11.73 %
	TOTAL SQ. M.	330.45 S.M.	38.76 S.M.	11.73 %
UNINSULATED OPENINGS (PER OBC. SB-12,3.1.1(7))				
STANDARD & REAR UPGRADE W/ SIDE DOOR 9' GDN. FL.	S42-19 ELEVATION B	ENERGY EFFICIENCY – OBC SB12		
	ELEVATION	WALL AREA S.F.	OPENING S.F.	PERCENTAGE
	FRONT	664 S.F.	125.53 S.F.	18.91 %
	LEFT SIDE	1106 S.F.	77.33 S.F.	6.99 %
	RIGHT SIDE	1106 S.F.	80.83 S.F.	7.31 %
	REAR	681 S.F.	143.05 S.F.	21.01 %
	* OPENINGS OMITTED AS PER SB-12 3.1.1.9(4) MAX 19.9 S.F. REFER TO ELEVATION FOR LOCATION		0.00 S.F.	
	TOTAL SQ. FT.	3557.00 S.F.	426.74 S.F.	12.00 %
	TOTAL SQ. M.	330.45 S.M.	39.65 S.M.	12.00 %

<u>UNINSULATED OPENINGS</u> (PER OBC. SB-12,3.1.1(7))				
STANDARD & REAR UPGRADE 9' GDN. FL.	S42-19 ELEVATION B -W.O.D.	ENERGY EFFICIENCY – OBC SB12		
	ELEVATION	WALL AREA S.F.	OPENING S.F.	PERCENTAGE
	FRONT	664 S.F.	125.53 S.F.	18.91 %
	LEFT SIDE	1106 S.F.	77.33 S.F.	6.99 %
	RIGHT SIDE	1106 S.F.	71.33 S.F.	6.45 %
	REAR	816 S.F.	165.28 S.F.	20.25 %
	* OPENINGS OMITTED AS PER SB-12 3.1.1.9(4) MAX 19.9 S.F. REFER TO ELEVATION FOR LOCATION		0.00 S.F.	
	TOTAL SQ. FT.	3692.00 S.F.	439.47 S.F.	11.90 %
	TOTAL SQ. M.	343.00 S.M.	40.83 S.M.	11.90 %
<u>UNINSULATED OPENINGS</u> (PER OBC. SB-12,3.1.1(7))				
STANDARD & REAR UPGRADE W/ SIDE DOOR 9' GDN. FL.	S42-19 ELEVATION B -W.O.D.	ENERGY EFFICIENCY – OBC SB12		
	ELEVATION	WALL AREA S.F.	OPENING S.F.	PERCENTAGE
	FRONT	664 S.F.	125.53 S.F.	18.91 %
	LEFT SIDE	1106 S.F.	77.33 S.F.	6.99 %
	RIGHT SIDE	1106 S.F.	80.83 S.F.	7.31 %
	REAR	816 S.F.	165.28 S.F.	20.25 %
	* OPENINGS OMITTED AS PER SB-12 3.1.1.9(4) MAX 19.9 S.F. REFER TO ELEVATION FOR LOCATION		0.00 S.F.	
	TOTAL SQ. FT.	3692.00 S.F.	448.97 S.F.	12.16 %
	TOTAL SQ. M.	343.00 S.M.	41.71 S.M.	12.16 %

UNINSULATED OPENINGS (PER OBC. SB-12,3.1.1(7))				
STANDARD & REAR UPGRADE 9' GDN. FL.	S42-19 ELEVATION B -W.O.B.		ENERGY EFFICIENCY - OBC SB12	
	ELEVATION	WALL AREA S.F.	OPENING S.F.	PERCENTAGE
	FRONT	664 S.F.	125.53 S.F.	18.91 %
	LEFT SIDE	1106 S.F.	77.33 S.F.	6.99 %
	RIGHT SIDE	1106 S.F.	71.33 S.F.	6.45 %
	REAR	925 S.F.	218.44 S.F.	23.62 %
	* OPENINGS OMITTED AS PER SB-12 3.1.1.9(4) MAX 19.9 S.F. REFER TO ELEVATION FOR LOCATION		0.00 S.F.	
	TOTAL SQ. FT.	3801.00 S.F.	492.63 S.F.	12.96 %
TOTAL SQ. M.	353.12 S.M.	45.77 S.M.	12.96 %	
UNINSULATED OPENINGS (PER OBC. SB-12,3.1.1(7))				
STANDARD & REAR UPGRADE W/ SIDE DOOR 9' GDN. FL.	S42-19 ELEVATION B -W.O.B.		ENERGY EFFICIENCY - OBC SB12	
	ELEVATION	WALL AREA S.F.	OPENING S.F.	PERCENTAGE
	FRONT	664 S.F.	125.53 S.F.	18.91 %
	LEFT SIDE	1106 S.F.	77.33 S.F.	6.99 %
	RIGHT SIDE	1106 S.F.	80.83 S.F.	7.31 %
	REAR	925 S.F.	218.44 S.F.	23.62 %
	* OPENINGS OMITTED AS PER SB-12 3.1.1.9(4) MAX 19.9 S.F. REFER TO ELEVATION FOR LOCATION		0.00 S.F.	
	TOTAL SQ. FT.	3801.00 S.F.	502.13 S.F.	13.21 %
TOTAL SQ. M.	353.12 S.M.	46.65 S.M.	13.21 %	

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3	REVISED AS PER ENG COMMENTS	MAR 03-22	RC
2	REVISED AS PER FLOOR / ROOF LAYOUT	FEB 24-22	RC
1	ISSUED FOR CLIENT REVIEW	NOV 26-21	VAS3
no.	description	date	by

The undersigned has reviewed and takes responsibility for this design and has the qualifications and meets the requirements set out in the Ontario Building Code to be a Designer. qualification information Wellington Jno-Baptiste <i>Jno Baptiste</i> 25591 name registration information signature BCIN VAS3 Design Inc. <i>[Signature]</i> 42658			
Contractor must verify all dimensions on the job and report any discrepancy to the Designer before proceeding with the work and the property of the Designer which must be returned at the completion of the work. Drawings are not to be scaled.			

VAS3 DESIGN 255 Consumers Rd Suite 120 Toronto ON M2J 1R4 t 416.630.2255 f 416.630.4782 va3design.com		S42-19	
		BAYVIEW WELLINGTON	
		GREEN VALLEY EAST BRADFORD, ONTARIO	
project name		municipality	
OCTOBER 2021		drawing no.	
drawn by TP		file name	
checked by JWM		scale	
3/16" = 1'-0"		SB-12 CHARTS	
RICHARD - H:\ARCHIVE\WORKING\2016\16023-S42-19.dwg - Tue - Mar 8 2022 - 1:01 PM		16023-S42-19	
project no.		33	
16023			

UNINSULATED OPENINGS (PER OBC. SB-12,3.1.1(7))				
STANDARD g' GDN. FL.	S42-19 ELEVATION C	ENERGY EFFICIENCY – OBC SB12		
	ELEVATION	WALL AREA S.F.	OPENING S.F.	PERCENTAGE
	FRONT	664 S.F.	182.31 S.F.	27.46 %
	LEFT SIDE	1106 S.F.	103.00 S.F.	9.31 %
	RIGHT SIDE	1106 S.F.	83.00 S.F.	7.50 %
	REAR	681 S.F.	143.05 S.F.	21.01 %
	* OPENINGS OMITTED AS PER SB-12 3.1.1.9(4) MAX 19.9 S.F. REFER TO ELEVATION FOR LOCATION		0.00 S.F.	
	TOTAL SQ. FT.	3557.00 S.F.	511.36 S.F.	14.38 %
TOTAL SQ. M.	330.45 S.M.	47.51 S.M.	14.38 %	
UNINSULATED OPENINGS (PER OBC. SB-12,3.1.1(7))				
STANDARD W/ SIDE DOOR g' GDN. FL.	S42-19 ELEVATION C	ENERGY EFFICIENCY – OBC SB12		
	ELEVATION	WALL AREA S.F.	OPENING S.F.	PERCENTAGE
	FRONT	664 S.F.	182.31 S.F.	27.46 %
	LEFT SIDE	1106 S.F.	103.00 S.F.	9.31 %
	RIGHT SIDE	1106 S.F.	92.50 S.F.	8.36 %
	REAR	681 S.F.	143.05 S.F.	21.01 %
	* OPENINGS OMITTED AS PER SB-12 3.1.1.9(4) MAX 19.9 S.F. REFER TO ELEVATION FOR LOCATION		0.00 S.F.	
	TOTAL SQ. FT.	3557.00 S.F.	520.86 S.F.	14.64 %
TOTAL SQ. M.	330.45 S.M.	48.39 S.M.	14.64 %	

<u>UNINSULATED OPENINGS</u> (PER OBC. SB-12,3.1.1(7))				
STANDARD g' GDN. FL.	S42-19 ELEVATION C -W.O.D.	ENERGY EFFICIENCY – OBC SB12		
	ELEVATION	WALL AREA S.F.	OPENING S.F.	PERCENTAGE
	FRONT	664 S.F.	182.31 S.F.	27.46 %
	LEFT SIDE	1106 S.F.	103.00 S.F.	9.31 %
	RIGHT SIDE	1106 S.F.	83.00 S.F.	7.50 %
	REAR	816 S.F.	165.28 S.F.	20.25 %
	* OPENINGS OMITTED AS PER SB-12 3.1.1.9(4) MAX 19.9 S.F. REFER TO ELEVATION FOR LOCATION		0.00 S.F.	
	TOTAL SQ. FT.	3692.00 S.F.	533.59 S.F.	14.45 %
TOTAL SQ. M.	343.00 S.M.	49.57 S.M.	14.45 %	
<u>UNINSULATED OPENINGS</u> (PER OBC. SB-12,3.1.1(7))				
STANDARD W/ SIDE DOOR g' GDN. FL.	S42-19 ELEVATION C -W.O.D.	ENERGY EFFICIENCY – OBC SB12		
	ELEVATION	WALL AREA S.F.	OPENING S.F.	PERCENTAGE
	FRONT	664 S.F.	182.31 S.F.	27.46 %
	LEFT SIDE	1106 S.F.	103.00 S.F.	9.31 %
	RIGHT SIDE	1106 S.F.	92.50 S.F.	8.36 %
	REAR	816 S.F.	165.28 S.F.	20.25 %
	* OPENINGS OMITTED AS PER SB-12 3.1.1.9(4) MAX 19.9 S.F. REFER TO ELEVATION FOR LOCATION		0.00 S.F.	
	TOTAL SQ. FT.	3692.00 S.F.	543.09 S.F.	14.71 %
TOTAL SQ. M.	343.00 S.M.	50.45 S.M.	14.71 %	

<u>UNINSULATED OPENINGS</u> (PER OBC. SB-12,3.1.1(7))				
STANDARD 9' GDN. FL.	S42-19 ELEVATION C -W.O.B.	ENERGY EFFICIENCY – OBC SB12		
	ELEVATION	WALL AREA S.F.	OPENING S.F.	PERCENTAGE
	FRONT	664 S.F.	182.31 S.F.	27.46 %
	LEFT SIDE	1106 S.F.	103.00 S.F.	9.31 %
	RIGHT SIDE	1106 S.F.	83.00 S.F.	7.50 %
	REAR	925 S.F.	218.44 S.F.	23.62 %
	* OPENINGS OMITTED AS PER SB-12 3.1.1.9(4) MAX 19.9 S.F. REFER TO ELEVATION FOR LOCATION		0.00 S.F.	
	TOTAL SQ. FT.	3801.00 S.F.	586.75 S.F.	15.44 %
TOTAL SQ. M.	353.12 S.M.	54.51 S.M.	15.44 %	
<u>UNINSULATED OPENINGS</u> (PER OBC. SB-12,3.1.1(7))				
STANDARD W/ SIDE DOOR 9' GDN. FL.	S42-19 ELEVATION C -W.O.B.	ENERGY EFFICIENCY – OBC SB12		
	ELEVATION	WALL AREA S.F.	OPENING S.F.	PERCENTAGE
	FRONT	664 S.F.	182.31 S.F.	27.46 %
	LEFT SIDE	1106 S.F.	103.00 S.F.	9.31 %
	RIGHT SIDE	1106 S.F.	92.50 S.F.	8.36 %
	REAR	925 S.F.	218.44 S.F.	23.62 %
	* OPENINGS OMITTED AS PER SB-12 3.1.1.9(4) MAX 19.9 S.F. REFER TO ELEVATION FOR LOCATION		0.00 S.F.	
	TOTAL SQ. FT.	3801.00 S.F.	596.25 S.F.	15.69 %
TOTAL SQ. M.	353.12 S.M.	55.39 S.M.	15.69 %	

UNINSULATED OPENINGS (PER OBC. SB-12,3.1.1(7))				
REAR UPGRADE 9' GDN. FL.	S42-19 ELEVATION C	ENERGY EFFICIENCY – OBC SB12		
	ELEVATION	WALL AREA S.F.	OPENING S.F.	PERCENTAGE
	FRONT	664 S.F.	182.31 S.F.	27.46 %
	LEFT SIDE	1106 S.F.	103.00 S.F.	9.31 %
	RIGHT SIDE	1106 S.F.	83.00 S.F.	7.50 %
	REAR	681 S.F.	165.71 S.F.	24.33 %
	* OPENINGS OMITTED AS PER SB-12 3.1.1.9(4) MAX 19.9 S.F. REFER TO ELEVATION FOR LOCATION		0.00 S.F.	
	TOTAL SQ. FT.	3557.00 S.F.	534.02 S.F.	15.01 %
TOTAL SQ. M.	330.45 S.M.	49.61 S.M.	15.01 %	
UNINSULATED OPENINGS (PER OBC. SB-12,3.1.1(7))				
REAR UPGRADE W/ SIDE DOOR 9' GDN. FL.	S42-19 ELEVATION C	ENERGY EFFICIENCY – OBC SB12		
	ELEVATION	WALL AREA S.F.	OPENING S.F.	PERCENTAGE
	FRONT	664 S.F.	182.31 S.F.	27.46 %
	LEFT SIDE	1106 S.F.	103.00 S.F.	9.31 %
	RIGHT SIDE	1106 S.F.	92.50 S.F.	8.36 %
	REAR	681 S.F.	165.71 S.F.	24.33 %
	* OPENINGS OMITTED AS PER SB-12 3.1.1.9(4) MAX 19.9 S.F. REFER TO ELEVATION FOR LOCATION		0.00 S.F.	
	TOTAL SQ. FT.	3557.00 S.F.	543.52 S.F.	15.28 %
TOTAL SQ. M.	330.45 S.M.	50.49 S.M.	15.28 %	

<u>UNINSULATED OPENINGS</u> (PER OBC. SB-12,3.1.1(7))					
REAR UPGRADE 9' GDN. FL.	S42-19 ELEVATION C -W.O.D.	ENERGY EFFICIENCY – OBC SB12			
	ELEVATION	WALL	AREA S.F.	OPENING S.F.	PERCENTAGE
	FRONT		664 S.F.	182.31 S.F.	27.46 %
	LEFT SIDE		1106 S.F.	103.00 S.F.	9.31 %
	RIGHT SIDE		1106 S.F.	83.00 S.F.	7.50 %
	REAR		816 S.F.	190.17 S.F.	23.31 %
	* OPENINGS OMITTED AS PER SB-12 3.1.1.9(4) MAX 19.9 S.F. REFER TO ELEVATION FOR LOCATION			0.00 S.F.	
	TOTAL SQ. FT.		3692.00 S.F.	558.48 S.F.	15.13 %
TOTAL SQ. M.		343.00 S.M.	51.88 S.M.	15.13 %	
<u>UNINSULATED OPENINGS</u> (PER OBC. SB-12,3.1.1(7))					
REAR UPGRADE W/ SIDE DOOR 9' GDN. FL.	S42-19 ELEVATION C -W.O.D.	ENERGY EFFICIENCY – OBC SB12			
	ELEVATION	WALL	AREA S.F.	OPENING S.F.	PERCENTAGE
	FRONT		664 S.F.	182.31 S.F.	27.46 %
	LEFT SIDE		1106 S.F.	103.00 S.F.	9.31 %
	RIGHT SIDE		1106 S.F.	92.50 S.F.	8.36 %
	REAR		816 S.F.	190.17 S.F.	23.31 %
	* OPENINGS OMITTED AS PER SB-12 3.1.1.9(4) MAX 19.9 S.F. REFER TO ELEVATION FOR LOCATION			0.00 S.F.	
	TOTAL SQ. FT.		3692.00 S.F.	567.98 S.F.	15.38 %
TOTAL SQ. M.		343.00 S.M.	52.77 S.M.	15.38 %	

UNINSULATED OPENINGS (PER OBC. SB-12,3.1.1(7))				
REAR UPGRADE 9' GDN. FL.	S42-19 ELEVATION C -W.O.B.	ENERGY EFFICIENCY - OBC SB12		
	ELEVATION	WALL AREA S.F.	OPENING S.F.	PERCENTAGE
	FRONT	664 S.F.	182.31 S.F.	27.46 %
	LEFT SIDE	1106 S.F.	103.00 S.F.	9.31 %
	RIGHT SIDE	1106 S.F.	83.00 S.F.	7.50 %
	REAR	925 S.F.	244.44 S.F.	26.43 %
	* OPENINGS OMITTED AS PER SB-12 3.1.1.9(4) MAX 19.9 S.F. REFER TO ELEVATION FOR LOCATION		0.00 S.F.	
	TOTAL SQ. FT.	3801.00 S.F.	612.75 S.F.	16.12 %
TOTAL SQ. M.	353.12 S.M.	56.93 S.M.	16.12 %	
UNINSULATED OPENINGS (PER OBC. SB-12,3.1.1(7))				
REAR UPGRADE W/ SIDE DOOR 9' GDN. FL.	S42-19 ELEVATION C -W.O.B.	ENERGY EFFICIENCY - OBC SB12		
	ELEVATION	WALL AREA S.F.	OPENING S.F.	PERCENTAGE
	FRONT	664 S.F.	182.31 S.F.	27.46 %
	LEFT SIDE	1106 S.F.	103.00 S.F.	9.31 %
	RIGHT SIDE	1106 S.F.	92.50 S.F.	8.36 %
	REAR	925 S.F.	244.44 S.F.	26.43 %
	* OPENINGS OMITTED AS PER SB-12 3.1.1.9(4) MAX 19.9 S.F. REFER TO ELEVATION FOR LOCATION		0.00 S.F.	
	TOTAL SQ. FT.	3801.00 S.F.	622.25 S.F.	16.37 %
TOTAL SQ. M.	353.12 S.M.	57.81 S.M.	16.37 %	

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53.12 S.M. 57.81 S.M. 16.37 %

REVIEWED

UNINSULATED OPENINGS (PER OBC. SB-12,3.1.1(7))				
STANDARD & REAR UPGRADE 9' GDN. FL. & 9' BASEMENT	S42-19 ELEVATION A -W.O.B.	ENERGY EFFICIENCY - OBC SB12		
	ELEVATION	WALL AREA S.F.	OPENING S.F.	PERCENTAGE
	FRONT	664 S.F.	134.86 S.F.	20.31 %
	LEFT SIDE	1106 S.F.	77.33 S.F.	6.99 %
	RIGHT SIDE	1106 S.F.	71.33 S.F.	6.45 %
	REAR	959 S.F.	218.44 S.F.	22.78 %
	* OPENINGS OMITTED AS PER SB-12 3.1.1.9(4) MAX 19.9 S.F. REFER TO ELEVATION FOR LOCATION		0.00 S.F.	
	TOTAL SQ. FT.	3835.00 S.F.	501.96 S.F.	13.09 %
	TOTAL SQ. M.	356.28 S.M.	46.63 S.M.	13.09 %
UNINSULATED OPENINGS (PER OBC. SB-12,3.1.1(7))				
STANDARD & REAR UPGRADE W/ SIDE DOOR 9' GDN. FL. & 9' BASEMENT	S42-19 ELEVATION A -W.O.B.	ENERGY EFFICIENCY - OBC SB12		
	ELEVATION	WALL AREA S.F.	OPENING S.F.	PERCENTAGE
	FRONT	664 S.F.	134.86 S.F.	20.31 %
	LEFT SIDE	1106 S.F.	77.33 S.F.	6.99 %
	RIGHT SIDE	1106 S.F.	80.83 S.F.	7.31 %
	REAR	959 S.F.	218.44 S.F.	22.78 %
	* OPENINGS OMITTED AS PER SB-12 3.1.1.9(4) MAX 19.9 S.F. REFER TO ELEVATION FOR LOCATION		0.00 S.F.	
	TOTAL SQ. FT.	3835.00 S.F.	511.46 S.F.	13.34 %
	TOTAL SQ. M.	356.28 S.M.	47.52 S.M.	13.34 %

UNINSULATED OPENINGS (PER OBC. SB-12,3.1.1(7))				
STANDARD & REAR UPGRADE 9' GDN. FL. & 9' BASEMENT	S42-19 ELEVATION B -W.O.B.	ENERGY EFFICIENCY - OBC SB12		
	ELEVATION	WALL AREA S.F.	OPENING S.F.	PERCENTAGE
	FRONT	664 S.F.	125.53 S.F.	18.91 %
	LEFT SIDE	1106 S.F.	77.33 S.F.	6.99 %
	RIGHT SIDE	1106 S.F.	71.33 S.F.	6.45 %
	REAR	959 S.F.	218.44 S.F.	22.78 %
	* OPENINGS OMITTED AS PER SB-12 3.1.1.9(4) MAX 19.9 S.F. REFER TO ELEVATION FOR LOCATION		0.00 S.F.	
	TOTAL SQ. FT.	3835.00 S.F.	492.63 S.F.	12.85 %
	TOTAL SQ. M.	356.28 S.M.	45.77 S.M.	12.85 %
UNINSULATED OPENINGS (PER OBC. SB-12,3.1.1(7))				
STANDARD & REAR UPGRADE W/ SIDE DOOR 9' GDN. FL. & 9' BASEMENT	S42-19 ELEVATION B -W.O.B.	ENERGY EFFICIENCY - OBC SB12		
	ELEVATION	WALL AREA S.F.	OPENING S.F.	PERCENTAGE
	FRONT	664 S.F.	125.53 S.F.	18.91 %
	LEFT SIDE	1106 S.F.	77.33 S.F.	6.99 %
	RIGHT SIDE	1106 S.F.	80.83 S.F.	7.31 %
	REAR	959 S.F.	218.44 S.F.	22.78 %
	* OPENINGS OMITTED AS PER SB-12 3.1.1.9(4) MAX 19.9 S.F. REFER TO ELEVATION FOR LOCATION		0.00 S.F.	
	TOTAL SQ. FT.	3835.00 S.F.	502.13 S.F.	13.09 %
	TOTAL SQ. M.	356.28 S.M.	46.65 S.M.	13.09 %

UNINSULATED OPENINGS (PER OBC. SB-12,3.1.1(7))				
STANDARD 9' GDN. FL. & 9' BASEMENT	S42-19 ELEVATION C -W.O.B.	ENERGY EFFICIENCY - OBC SB12		
	ELEVATION	WALL AREA S.F.	OPENING S.F.	PERCENTAGE
	FRONT	664 S.F.	182.31 S.F.	27.46 %
	LEFT SIDE	1106 S.F.	103.00 S.F.	9.31 %
	RIGHT SIDE	1106 S.F.	83.00 S.F.	7.50 %
	REAR	959 S.F.	218.44 S.F.	22.78 %
	* OPENINGS OMITTED AS PER SB-12 3.1.1.9(4) MAX 19.9 S.F. REFER TO ELEVATION FOR LOCATION		0.00 S.F.	
	TOTAL SQ. FT.	3835.00 S.F.	586.75 S.F.	15.30 %
	TOTAL SQ. M.	356.28 S.M.	54.51 S.M.	15.30 %
UNINSULATED OPENINGS (PER OBC. SB-12,3.1.1(7))				
STANDARD W/ SIDE DOOR 9' GDN. FL. & 9' BASEMENT	S42-19 ELEVATION C -W.O.B.	ENERGY EFFICIENCY - OBC SB12		
	ELEVATION	WALL AREA S.F.	OPENING S.F.	PERCENTAGE
	FRONT	664 S.F.	182.31 S.F.	27.46 %
	LEFT SIDE	1106 S.F.	103.00 S.F.	9.31 %
	RIGHT SIDE	1106 S.F.	92.50 S.F.	8.36 %
	REAR	959 S.F.	218.44 S.F.	22.78 %
	* OPENINGS OMITTED AS PER SB-12 3.1.1.9(4) MAX 19.9 S.F. REFER TO ELEVATION FOR LOCATION		0.00 S.F.	
	TOTAL SQ. FT.	3835.00 S.F.	596.25 S.F.	15.55 %
	TOTAL SQ. M.	356.28 S.M.	55.39 S.M.	15.55 %

UNINSULATED OPENINGS (PER OBC. SB-12,3.1.1(7))				
REAR UPGRADE 9' GDN. FL. & 9' BASEMENT	S42-19 ELEVATION C -W.O.B.	ENERGY EFFICIENCY - OBC SB12		
	ELEVATION	WALL AREA S.F.	OPENING S.F.	PERCENTAGE
	FRONT	664 S.F.	182.31 S.F.	27.46 %
	LEFT SIDE	1106 S.F.	103.00 S.F.	9.31 %
	RIGHT SIDE	1106 S.F.	83.00 S.F.	7.50 %
	REAR	959 S.F.	244.44 S.F.	25.49 %
	* OPENINGS OMITTED AS PER SB-12 3.1.1.9(4) MAX 19.9 S.F. REFER TO ELEVATION FOR LOCATION		0.00 S.F.	
	TOTAL SQ. FT.	3835.00 S.F.	612.75 S.F.	15.98 %
	TOTAL SQ. M.	356.28 S.M.	56.93 S.M.	15.98 %
UNINSULATED OPENINGS (PER OBC. SB-12,3.1.1(7))				
REAR UPGRADE W/ SIDE DOOR 9' GDN. FL. & 9' BASEMENT	S42-19 ELEVATION C -W.O.B.	ENERGY EFFICIENCY - OBC SB12		
	ELEVATION	WALL AREA S.F.	OPENING S.F.	PERCENTAGE
	FRONT	664 S.F.	182.31 S.F.	27.46 %
	LEFT SIDE	1106 S.F.	103.00 S.F.	9.31 %
	RIGHT SIDE	1106 S.F.	92.50 S.F.	8.36 %
	REAR	959 S.F.	244.44 S.F.	25.49 %
	* OPENINGS OMITTED AS PER SB-12 3.1.1.9(4) MAX 19.9 S.F. REFER TO ELEVATION FOR LOCATION		0.00 S.F.	
	TOTAL SQ. FT.	3835.00 S.F.	622.25 S.F.	16.23 %
	TOTAL SQ. M.	356.28 S.M.	57.81 S.M.	16.23 %

REVIEWED

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REVISED AS PER ENG COMMENTS

2

REVISED AS PER FLOOR / ROOF LAYOUT

1

ISSUED FOR CLIENT REVIEW

no.

description

date

by

MAR 03-22

RC

FEB 24-22

RC

NOV 26-21

VA3

The undersigned has reviewed and takes responsibility for this design and has the qualifications and meets the requirements set out in the Ontario Building Code to be a Designer.

qualification information

Wellington Jno-Baptiste

signature

25591

BCIN

42658

VA3 Design Inc.

name

registration information

Contractor must verify all dimensions on the job and report any discrepancy to the Designer before proceeding with the work. All drawings and specifications are instruments of service and the property of the Designer which must be returned at the completion of the work. Drawings are not to be scaled.

project name

GREEN VALLEY EAST

municipality

BRADFORD, ONTARIO

project no.

16023

drawing no.

35

date

OCTOBER 2021

checked by

JWM

drawn by

TP

scale

3/16" = 1'-0"

file name

16023-S42-19

VA3


DESIGN

255 Consumers Rd Suite 120
Toronto, ON M2J 1R4
t 416.630.2255 f 416.630.4782
vo3design.com


BAYVIEW WELLINGTON

S42-19

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ROOF PLAN 'A'
N.T.S.

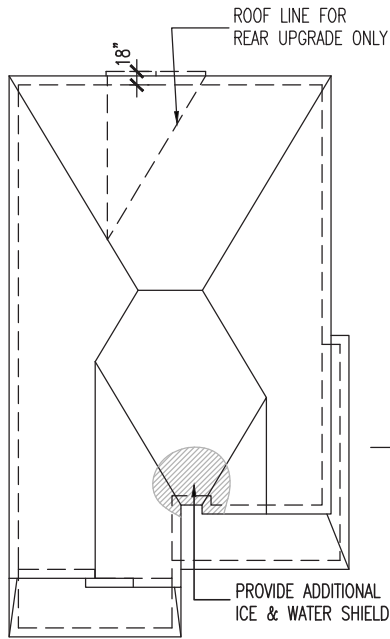


10' GROUND

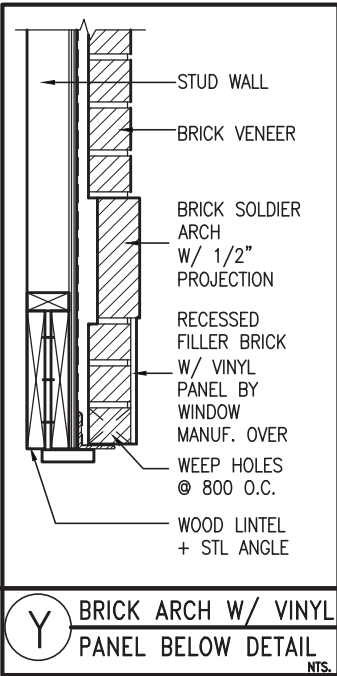6"x16" STUCCO IMPOST
MID-POINT OF ROOF
STUCCO FINISH W/ 6"
STUCCO FRIEZE BOARD
PREFIN. MTL. FLASHING, W/
CAULKING BEHIND STUCCO
CLADDING (TYP.)

1"x6" ALUM. CLAD
FRIEZE BOARD (TYP.)
BRICK SOLDIER COURSE ON BRICK
STACK BOND W/ 1/2" PROJ. (TYP.)
PRECAST CONC. SILL ON BRICK
ROWLOCK W/ 1/2" PROJ. (TYP.)

8"x8" FIBREGLASS COLUMN BY
ROMAN COLUMNS W/ 1/2"
THICK HDPE TOP LOADING
PLATE ANCHORED TO 16"x16"
MASONRY PIER. (TYP.)
SUNKEN FOYER (-1R)

POURED CONC. PORCH
SLAB AND DOOR SILL

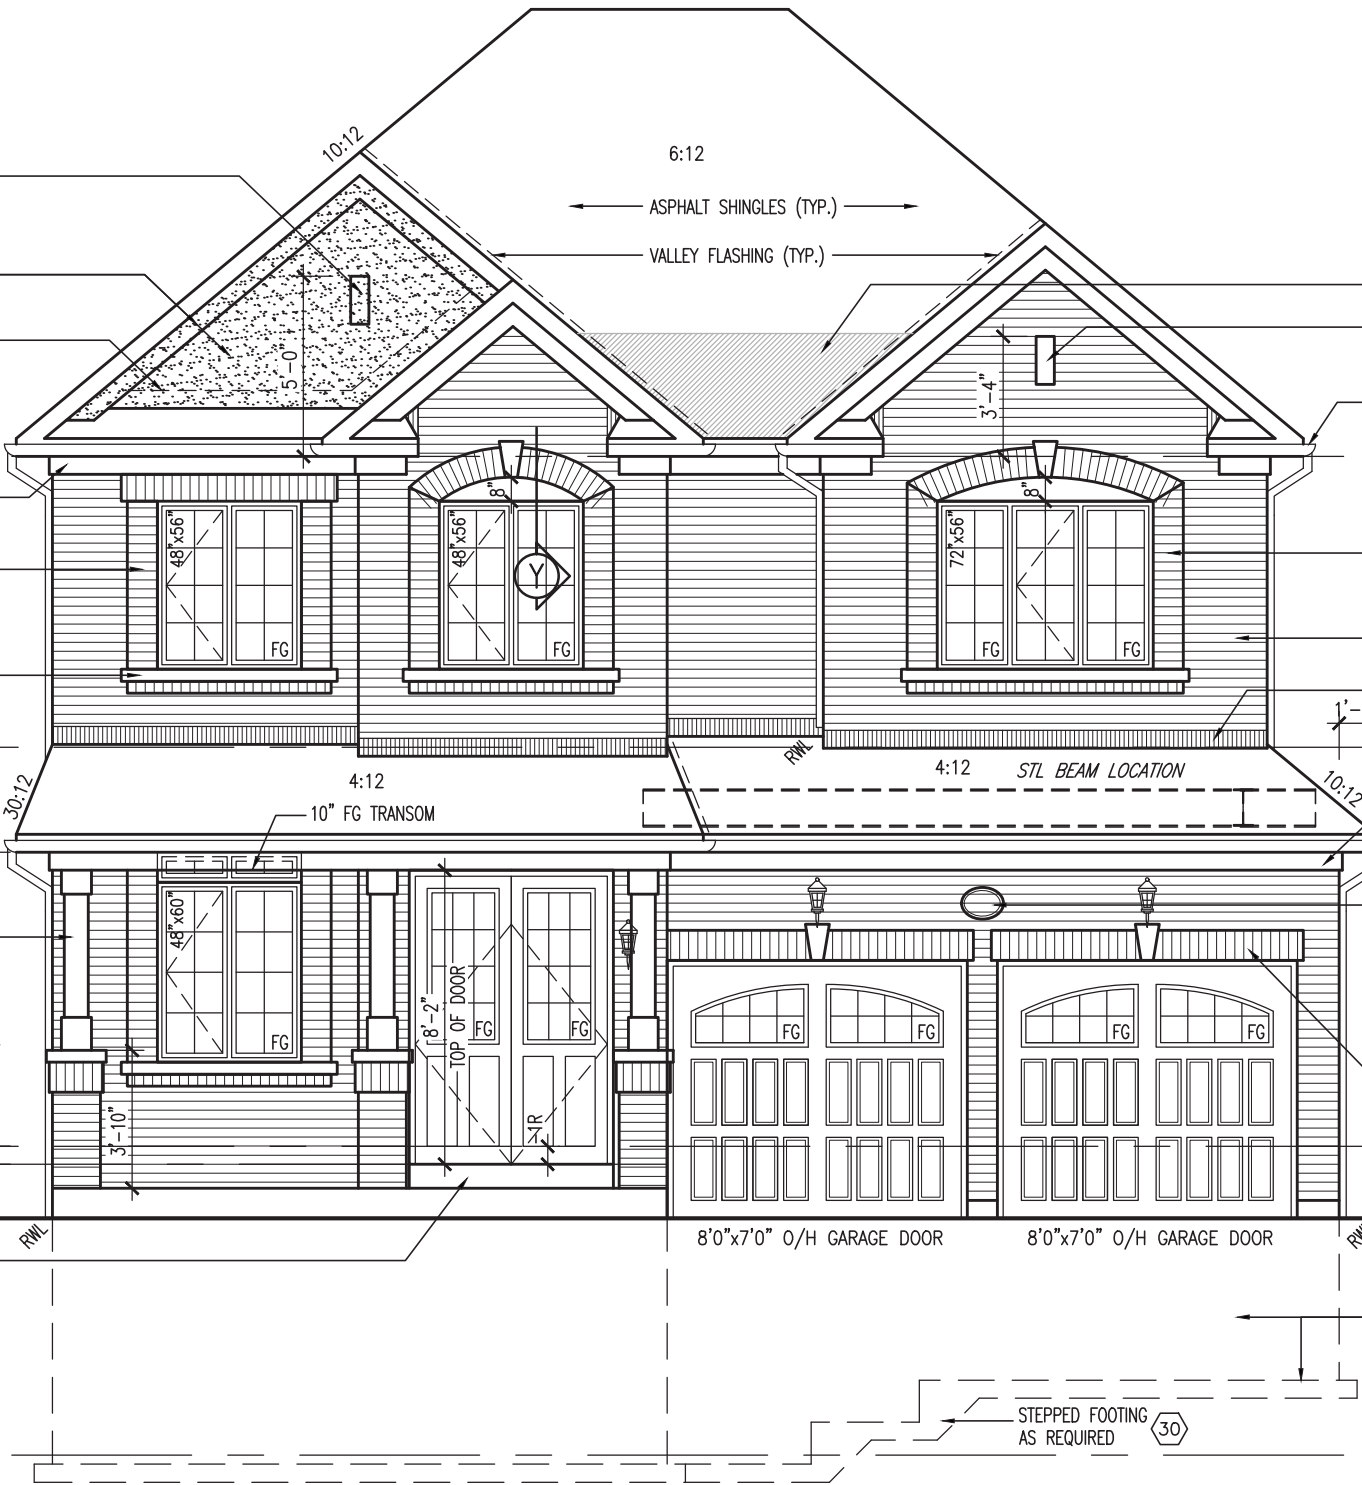

FRONT ELEVATION 'A'

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This is to certify that these plans comply with the applicable Architectural Design Guidelines approved by the Town of BRADFORD WEST GWILLIMBURY.

JOHN G. WILLIAMS LTD., ARCHITECT
ARCHITECTURAL CONTROL REVIEW
AND APPROVAL
APPROVED BY: [Signature]
DATE: MAR 15, 2022
This stamp certifies compliance with the applicable Design Guidelines only and bears no further professional responsibility.



PROVIDE ADDITIONAL
ICE & WATER SHIELD
6"x16" STONE IMPOST
PREFIN. ALUM. R.W.L.,
FASCIA, GUTTER &
VENTED SOFFIT (TYP.)

BRICK SOLDIER COURSE ARCH
C/W PRECAST CONC.
KEYSTONE ON BRICK STACK
BOND W/ 1/2" PROJ. (TYP.)
FACE BRICK (TYP.)
PREFIN. MTL. FLASHING,
W/ CAULKING TO MATCH
MASONRY COLOUR (TYP.)

1"x6" ALUM. CLAD
FRIEZE BD. (TYP.)
MUNICIPAL ADDRESS
PLAQUE (TYP.)
BRICK SOLDIER HEADER
C/W KEYSTONE W/ 1/2"
PROJ. (TYP.)

POURED CONC. FOUNDATION
WALLS AND FOOTINGS (TYP.)

TOP OF PLATE
TOP OF WINDOW
8'-0" SECOND @ 6'-10"
9'-0" SECOND @ 7'-6"
STANDARD 8'-1" SECOND FLOOR
OPT. 9'-1" SECOND FLOOR
FIN SECOND FLOOR
TOP OF TRANSOM
TOP OF WINDOW
10"
7'-4"
11'-1"
FIN GROUND FLOOR
FIN GRADE
5'-0" (MIN.)
8'-7"
(10'-1" FOR OPT. 9'-0" BASEMENT)
U/S OF FOOTING
TOP OF SLAB

project no.		16023	drawing no.		36
project name		GREEN VALLEY EAST	municipality		BRADFORD, ONTARIO
date		OCTOBER 2021	scale		3/16" = 1'-0"
drawn by		JWM	checked by		JWM
drawn by		RICHARD - H: ARCHIVE WORKING\2016\16023\B\Units 42\16023-S42-19.dwg	drawn by		Tue - Mar 8 2022 - 1:01 PM
no.		1	description		ISSUED FOR CLIENT REVIEW
no.		2	description		REVISED AS PER ENG COMMENTS
no.		3	description		REVISED AS PER FLOOR / ROOF LAYOUT
no.		4	description		NOV 26-21 VA3
no.		5	description		DATE
no.		6	description		DATE
no.		7	description		DATE
no.		8	description		DATE
no.		9	description		DATE

REVIEWED

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JOHN G. WILLIAMS LTD., ARCHITECT
ARCHITECTURAL CONTROL REVIEW
AND APPROVAL

APPROVED BY: [Signature]
DATE: MAR 15, 2022

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R.W.L. AS REQUIRED &
AS PER MUNICIPALITY

NOTE: REFER TO FRONT
ELEVATION FOR TYPICAL
NOTE INFORMATION



MAR 8, 2022

PREFIN. ALUM. R.W.L.,
FASCIA, GUTTER &
VENTED SOFFIT (TYP.)

FACE BRICK (TYP.)

BRICK SOLDIER HEADER
W/ 1/2" PROJ. (TYP.)

18" FG TRANSOM

PREFIN. MTL. FLASHING,
W/ CAULKING TO MATCH
MASONRY COLOUR (TYP.)

PRECAST CONC. SILL
W/ 1/2" PROJ. (TYP.)

— DASHED LINE INDICATES ROOF
LINE FOR ELEV. 'B' @ FRONT

— DASHED LINE INDICATES ROOF
LINE FOR ELEV. 'C'

Diagram showing vertical dimensions for a building section:

- TOP OF PLATE
- TOP OF WINDOW
- 8'-0" SECOND @ 6'-10"
- 9'-0" SECOND @ 7'-6"
- STANDARD 8'-1" SECOND FLOOR
- OPT. 9'-1" SECOND FLOOR
- FIN SECOND FLOOR
- TOP OF TRANSOM
- 1'-6"
- TOP OF WINDOW
- 7'-4"
- 11'-1"
- FIN GROUND FLOOR
- FIN GRADE
- (ELEMENT)

8'-7"
(10'-1" FOR OPT. 9'-0" BASEMENT)


REAR ELEVATION 'A'/'B'/'C'

10⁹ GROUND


REVIEWED

[illegible]

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ROOF PLAN 'B'
N.T.S.

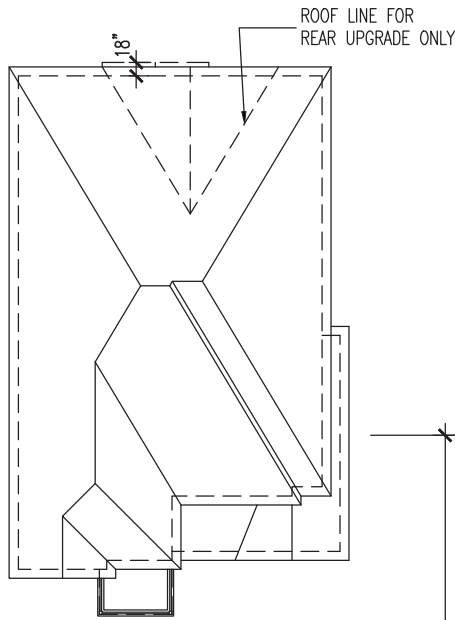

8" PRECAST CONC. ARCH OVER VINYL PANEL BY WINDOW MANUF. ON 8" PRECAST CONC. SURROUND W/ 1/2" PROJ. (TYP.)

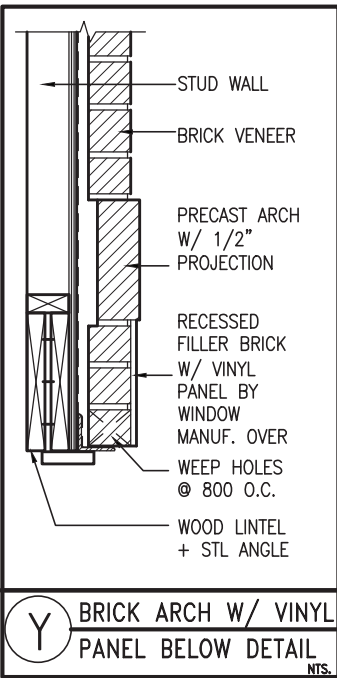CONT. PRECAST CONC. BAND W/ 1/2" PROJ. (TYP.)

24" HIGH PREFIN. DECORATIVE METAL RAILING

ROOF SCUPPER

PREFIN. ALUM. CAP OVER BUILT-UP STUCCO TRIMS (TYP.)

8" PRECAST CONC. SURROUND ON 4" PRECAST CONC. SILL W/ 1/2" PROJ. (TYP.)

8"x8" FIBREGLASS COLUMN BY ROMAN COLUMNS W/ 1/2" THICK HDPE TOP LOADING PLATE ANCHORED TO PORCH SLAB.

STONE VENEER (TYP.)

SUNKEN FOYER (-1R)

POURED CONC. PORCH SLAB AND DOOR SILL

10:12

10:12

6:12

6:12

4:12

STL BEAM LOCATION

8'0"x7'0" O/H GARAGE DOOR

8'0"x7'0" O/H GARAGE DOOR

ASPHALT SHINGLES (TYP.)

VALLEY FLASHING (TYP.)

PREFIN. ALUM. R.W.L., FASCIA, GUTTER & VENTED SOFFIT (TYP.)

FACE BRICK (TYP.)

PREFIN. MTL. FLASHING, W/ CAULKING TO MATCH MASONRY COLOUR (TYP.)

1"x6" ALUM. CLAD FRIEZE BD. (TYP.)

MUNICIPAL ADDRESS PLAQUE (TYP.)

8" PRECAST CONC. HEADER W/ 1/2" PROJ. (TYP.)

POURED CONC. FOUNDATION WALLS AND FOOTINGS (TYP.)

STEPPED FOOTING AS REQUIRED 30

TOP OF PLATE

TOP OF WINDOW

8'-0" SECOND @ 6'-10" 9'-0" SECOND @ 7'-6" STANDARD 8'-1" SECOND FLOOR OPT. 9'-1" SECOND FLOOR

FIN SECOND FLOOR

TOP OF TRANSOM

TOP OF WINDOW

7'-4" 11'-1"

FIN GROUND FLOOR

FIN GRADE

U/S OF FOOTING

TOP OF SLAB

5'-0" (MIN.) 8'-7" (10'-1" FOR OPT. 9'-0" BASEMENT)

FRONT ELEVATION 'B'

10' GROUND

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JOHN G. WILLIAMS LTD., ARCHITECT
ARCHITECTURAL CONTROL REVIEW
AND APPROVAL

APPROVED BY: [Signature]

DATE: MAR 15, 2022

This stamp certifies compliance with the applicable Design Guidelines only and bears no further professional responsibility.



MAR 8, 2022

BAYVIEW WELLINGTON

S42-19

project name GREEN VALLEY EAST municipality BRADFORD, ONTARIO project no. 16023 drawing no. 40

date OCTOBER 2021 checked by JMW scale 3/16" = 1'-0" file name 16023-S42-19

drawn by TP RICHARD - H:\ARCHIVE\WORKING\2016\16023.BW\Units\42\16023-S42-19.dwg - Tue - Mar 8 2022 - 1:01 PM



255 Consumers Rd, Suite 120
Toronto, ON M2J 1P4
t 416.630.2255 f 416.630.4782
vo3design.com

The undersigned has reviewed and takes responsibility for this design and has the qualifications and meets the requirements set out in the Ontario Building Code to be a Designer.

qualification information

Wellington Jno-Baptiste 25591 BCIN

name registration information VAS Design Inc. 42658

Contractor must verify all dimensions on the job and report any discrepancy to the Designer before proceeding with the work. All drawings and specifications are instruments of service and the property of the Designer which must be returned at the completion of the work. Drawings are not to be scaled.

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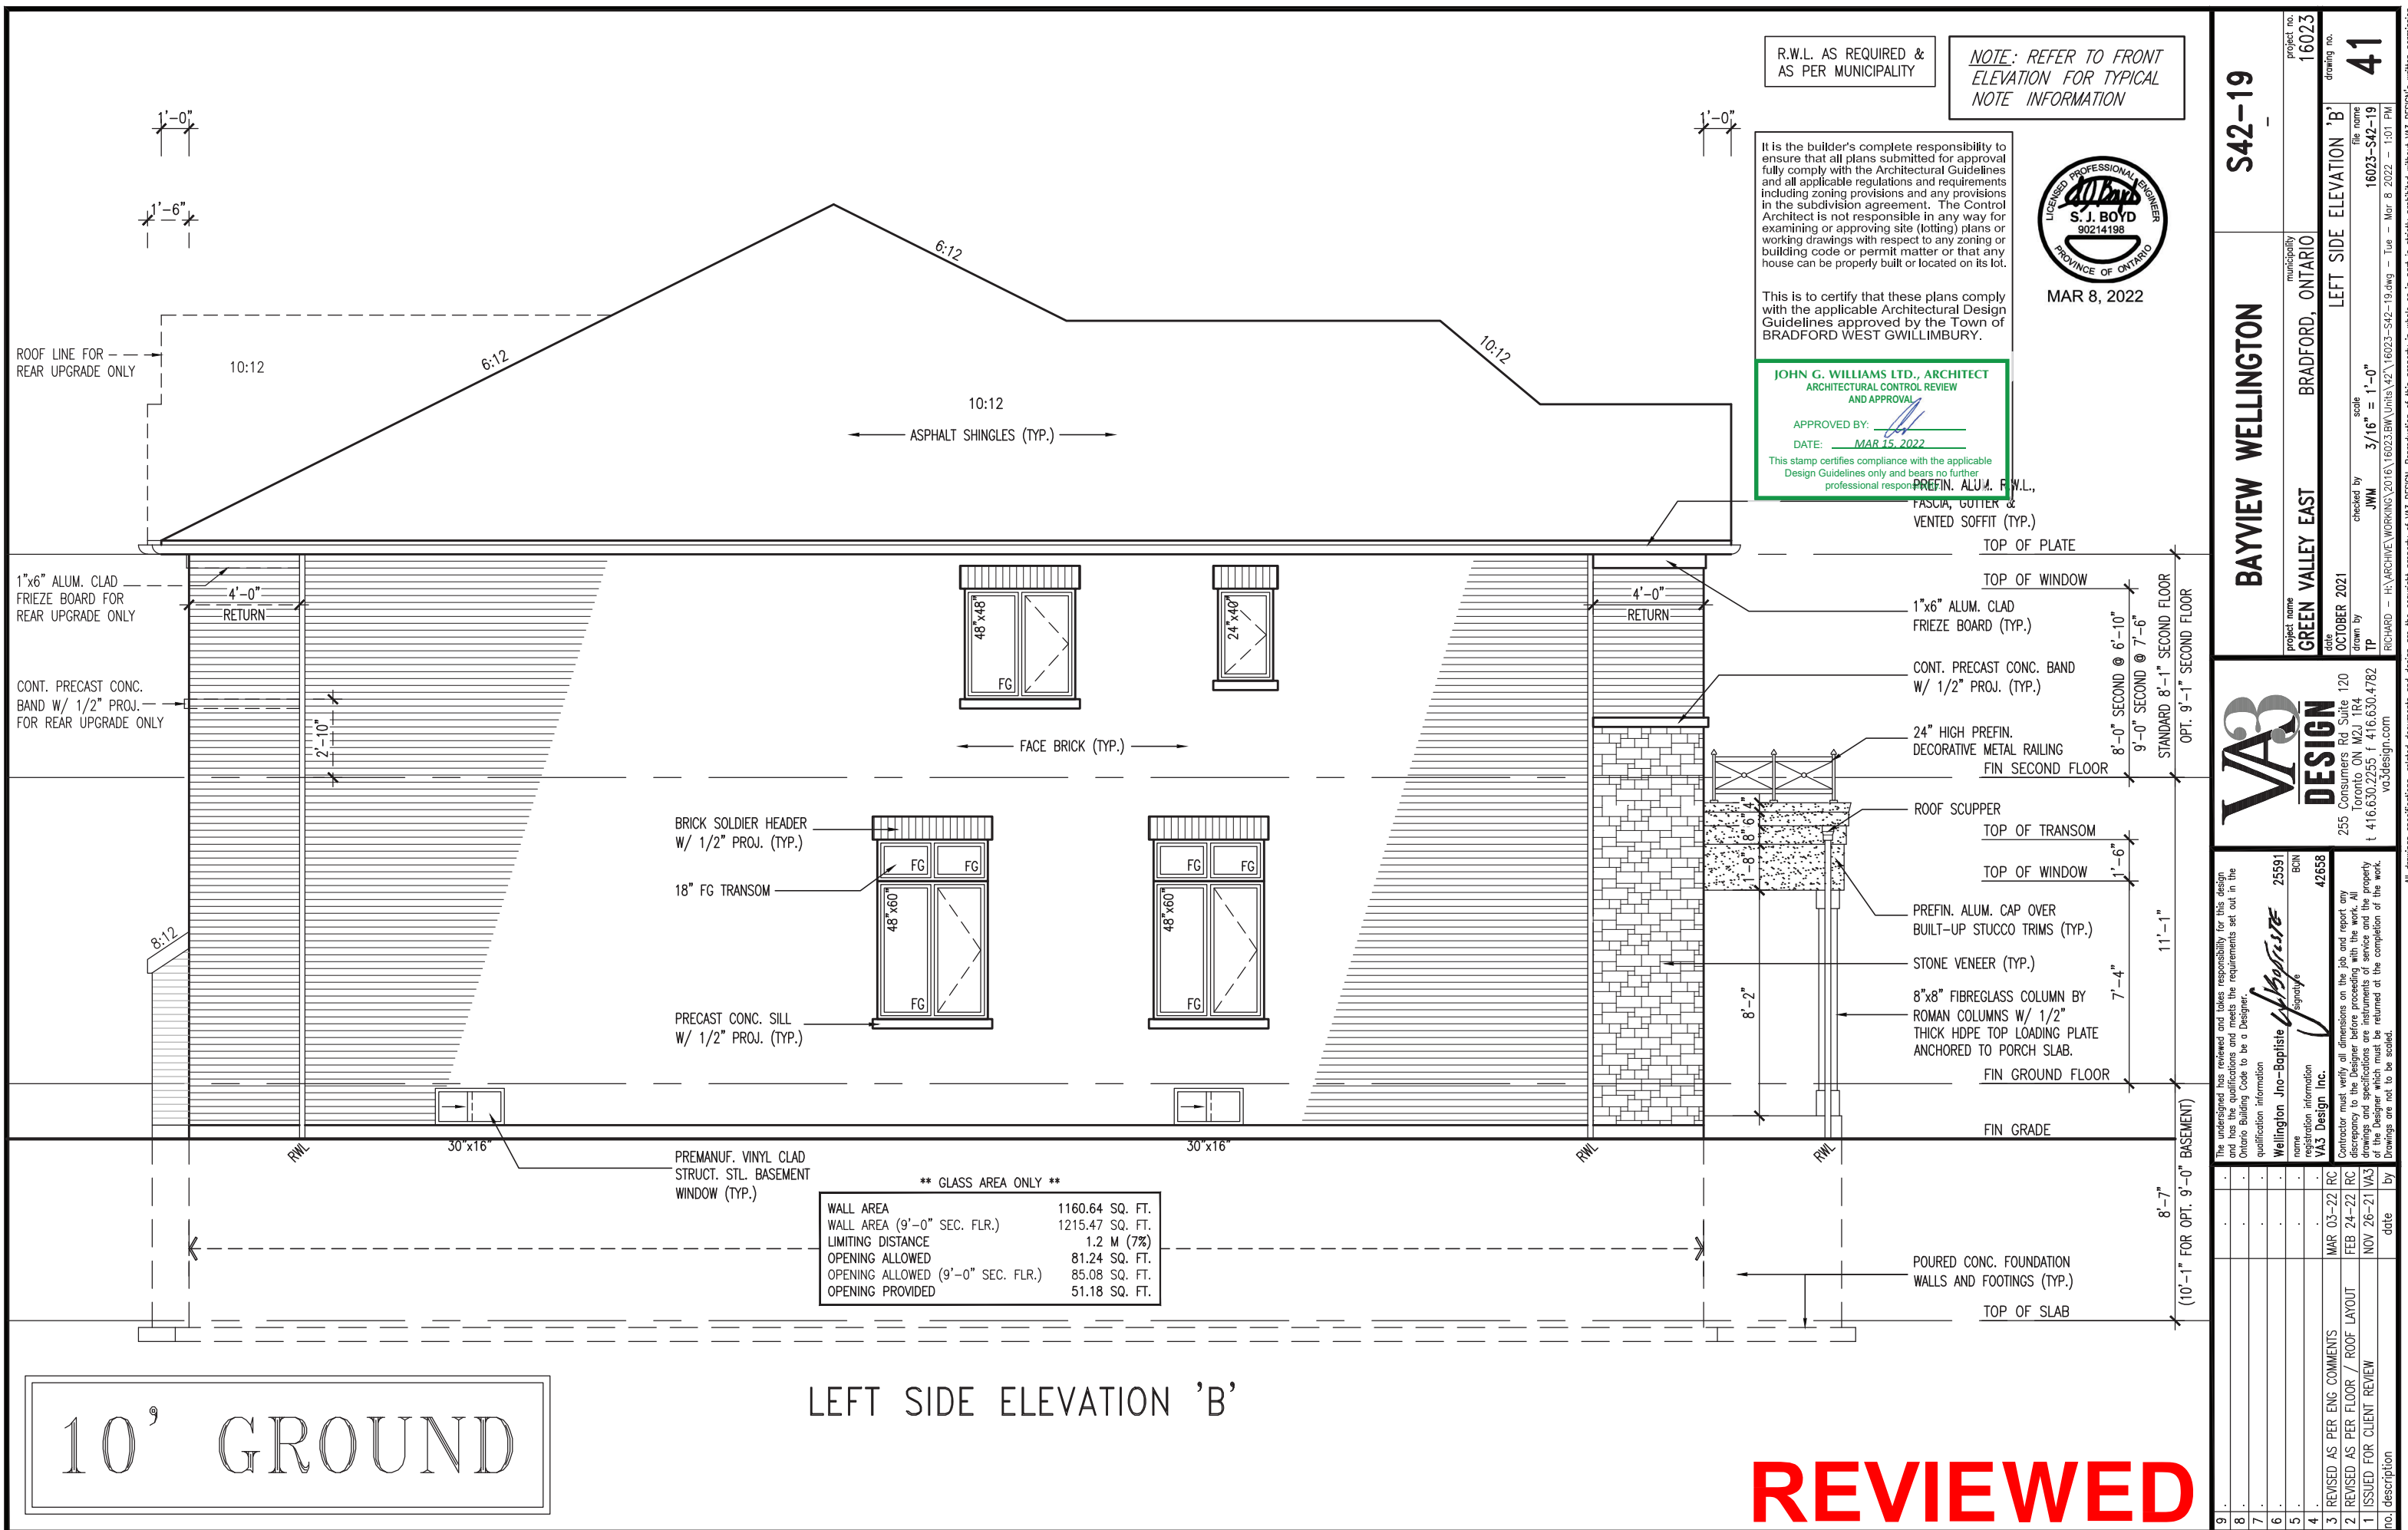
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3 REVISED AS PER ENG COMMENTS MAR 03-22 RC

2 REVISED AS PER FLOOR / ROOF LAYOUT FEB 24-22 RC

1 ISSUED FOR CLIENT REVIEW NOV 26-21 VAS

REVIEWED



This is to certify that these plans comply with the applicable Architectural Design Guidelines approved by the Town of BRADFORD WEST GWILLIMBURY.

JOHN G. WILLIAMS LTD., ARCHITECT
ARCHITECTURAL CONTROL REVIEW
AND APPROVAL

APPROVED BY: 
DATE: MAR 15, 2022

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PROVIDE A CONTINUOUS LAYER OF 12.7mm (1/2") TYPE 'X' GYPSUM BOARD (INTERIOR SIDE) INSTALLED SO THAT ALL EDGES ARE SUPPORTED, TAPED AND FILLED. SPACE BETWEEN WOOD STUDS TO BE FILLED WITH INSULATION CONFORMING TO CAN/ULC-S702, "MINERAL FIBRE THERMAL INSULATION FOR BUILDINGS" WITH A MASS OF NOT LESS THAN 1.22 Kg/SQ.M. AND MUST FILL AT LEAST 90% OF THE CAVITY THICKNESS. THE TYPE 'X' & INSULATION MUST BE RUN CONTINUOUSLY BEHIND ALL INTERSECTING PARTITIONS, MECHANICAL CHASES, BATHTUBS, SHOWERS, ETC. ENSURE INSULATION & TYPE 'X' IS INSTALLED IN GARAGE EXTERIOR WALLS. (REFER TO SECTION SB-2 OF OBC 2012-SUPPLEMENTARY STANDARDS)

NOTE: REFER TO FRONT
ELEVATION FOR TYPICAL
NOTE INFORMATION



MAR 8, 2022

STONE VENEER (TYP.)

— ASPHALT SHINGLES (TYP.)

← FACE BRICK (TYP.)

PRECAST CONC. SILL
W/ 1/2" PROJ. (TYP.)

FIN GRADE

WALL AREA	1039.47	SQ. FT.
WALL AREA (9'-0" SEC. FLR.)	1092.31	SQ. FT.
LIMITING DISTANCE	1.2	M (7%)
OPENING ALLOWED	72.76	SQ. FT.
OPENING ALLOWED (9'-0" SEC. FLR.)	76.46	SQ. FT.
OPENING PROVIDED	47.87	SQ. FT.
	64.56	SQ. FT. (OPT. DOOR)

RIGHT SIDE ELEVATION 'B'

10⁹ GROUND

REVIEWED

BAYVIEW WELLINGTON

VA3
DESIGN

The undersigned has reviewed and takes responsibility for this design and has the qualifications and meets the requirements set out in the Ontario Building Code to be a Designer.


9	*		*
8	*		*
7	*		*

project name	project no.
GREEN VALLEY EAST	16023
municipality	
BRADFORD, ONTARIO	

VA3 Design Inc.
 2551 Consumers Rd Suite 120
 Toronto ON M2J 1R4
 t 416.630.2255 f 416.630.4782
 va3design.com

6	.	.	.	RC
5	.	.	.	
4	.	.	.	
3	REVISED AS PER ENG COMMENTS		MAR 03-22	RC
2	REVISED AS PER FLOOR / ROOF LAYOUT		FEB 24-22	RC
1	ISSUED FOR CLIENT REVIEW		NOV 26-21	WA3
0	description	date	by	

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ROOF PLAN 'C'
N.T.S.
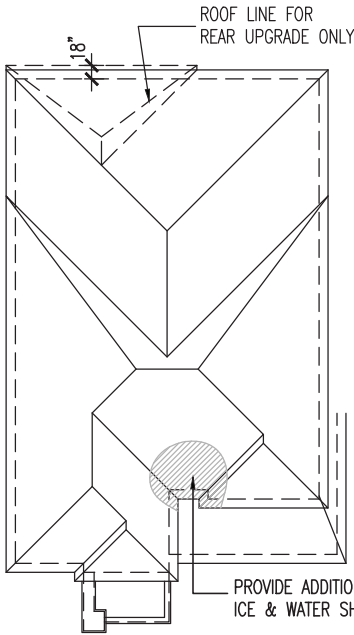
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JOHN G. WILLIAMS LTD., ARCHITECT
ARCHITECTURAL CONTROL REVIEW
AND APPROVAL

APPROVED BY:
DATE: MAR 15, 2022

This stamp certifies compliance with the applicable Design Guidelines only and bears no further professional responsibility.

- 1"x6" ALUM. CLAD FRIEZE BD. (TYP.)
- 1"x6" STUCCO FRIEZE BD. & TRIM (TYP.)
- PREFIN. ALUM CAPPED CORNER TRIM (TYP.)
- PREC. CONC. CAP (TYP.)
- STUCCO FINISH (TYP.)
- PREFIN. ALUM. CAP OVER ALUM. CLAD TRIM (TYP.)
- CONT. PREC. CONC. SILLS OVER BRAMPTON BRICK FINESSE LINE OR SIMILAR

POURED CONC. PORCH SLAB AND DOOR SILL

SUNKEN FOYER (-1R)



- STONE BY BRAMPTON BRICK FINESSE LINE OR SIMILAR
- ALUMINUM PANEL
- FACE BRICK
- STUCCO FINISH



PROVIDE ADDITIONAL ICE & WATER SHIELD
PREFIN. ALUM. R.W.L., FASCIA, GUTTER & VENTED SOFFIT (TYP.)

FACE BRICK (TYP.)
CONT. PRECAST CONC. BAND W/ 1/2" PROJ. (TYP.)
PREFIN. MTL. FLASHING, W/ CAULKING TO MATCH MASONRY COLOUR (TYP.)

1"x6" ALUM. CLAD FRIEZE BD. (TYP.)
MUNICIPAL ADDRESS PLAQUE (TYP.)

STONE BY BRAMPTON BRICK FINESSE LINE OR SIMILAR

- TOP OF PLATE
- TOP OF WINDOW
- 8'-0" SECOND @ 6'-10"
- 9'-0" SECOND @ 7'-6"
- STANDARD 8'-1" SECOND FLOOR
- OPT. 9'-1" SECOND FLOOR
- FIN SECOND FLOOR
- TOP OF TRANSOM
- TOP OF WINDOW
- 7'-4"
- 11'-1"
- FIN GROUND FLOOR
- FIN GRADE
- 5'-0" (MIN.)
- 8'-7"
- (10'-1" FOR OPT. 9'-0" BASEMENT)
- U/S OF FOOTING
- TOP OF SLAB

FRONT ELEVATION 'C'

10' GROUND

REVIEWED

S42-19

BAYVIEW WELLINGTON

project no. 16023

project name GREEN VALLEY EAST

date OCTOBER 2021

checked by JMW

drawn by TP

municipality BRADFORD, ONTARIO

scale 3/16" = 1'-0"

file name 16023-S42-19

drawing no. 43

VA3 DESIGN

255 Consumers Rd, Suite 120
Toronto, ON M2J 1P4
t 416.630.2255 f 416.630.4782
vo3design.com

signature

25591 BCIN 42658

Wellington Jno-Baptiste

VA3 Design Inc.

1. ISSUED FOR CLIENT REVIEW

2. REVISED AS PER FLOOR / ROOF LAYOUT

3. REVISED AS PER ENG COMMENTS

4. MAR 03-22 RC

5. FEB 24-22 RC

6. NOV 26-21 VA3

7. NOV 26-21 VA3

8. NOV 26-21 VA3

9. NOV 26-21 VA3

no. description

date

by

The undersigned has reviewed and takes responsibility for this design and has the qualifications and meets the requirements set out in the Ontario Building Code to be a Designer.


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16023-S42-19.dwg

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Mar 8 2022


Richard



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JOHN G. WILLIAMS LTD., ARCHITECT
ARCHITECTURAL CONTROL REVIEW
AND APPROVAL

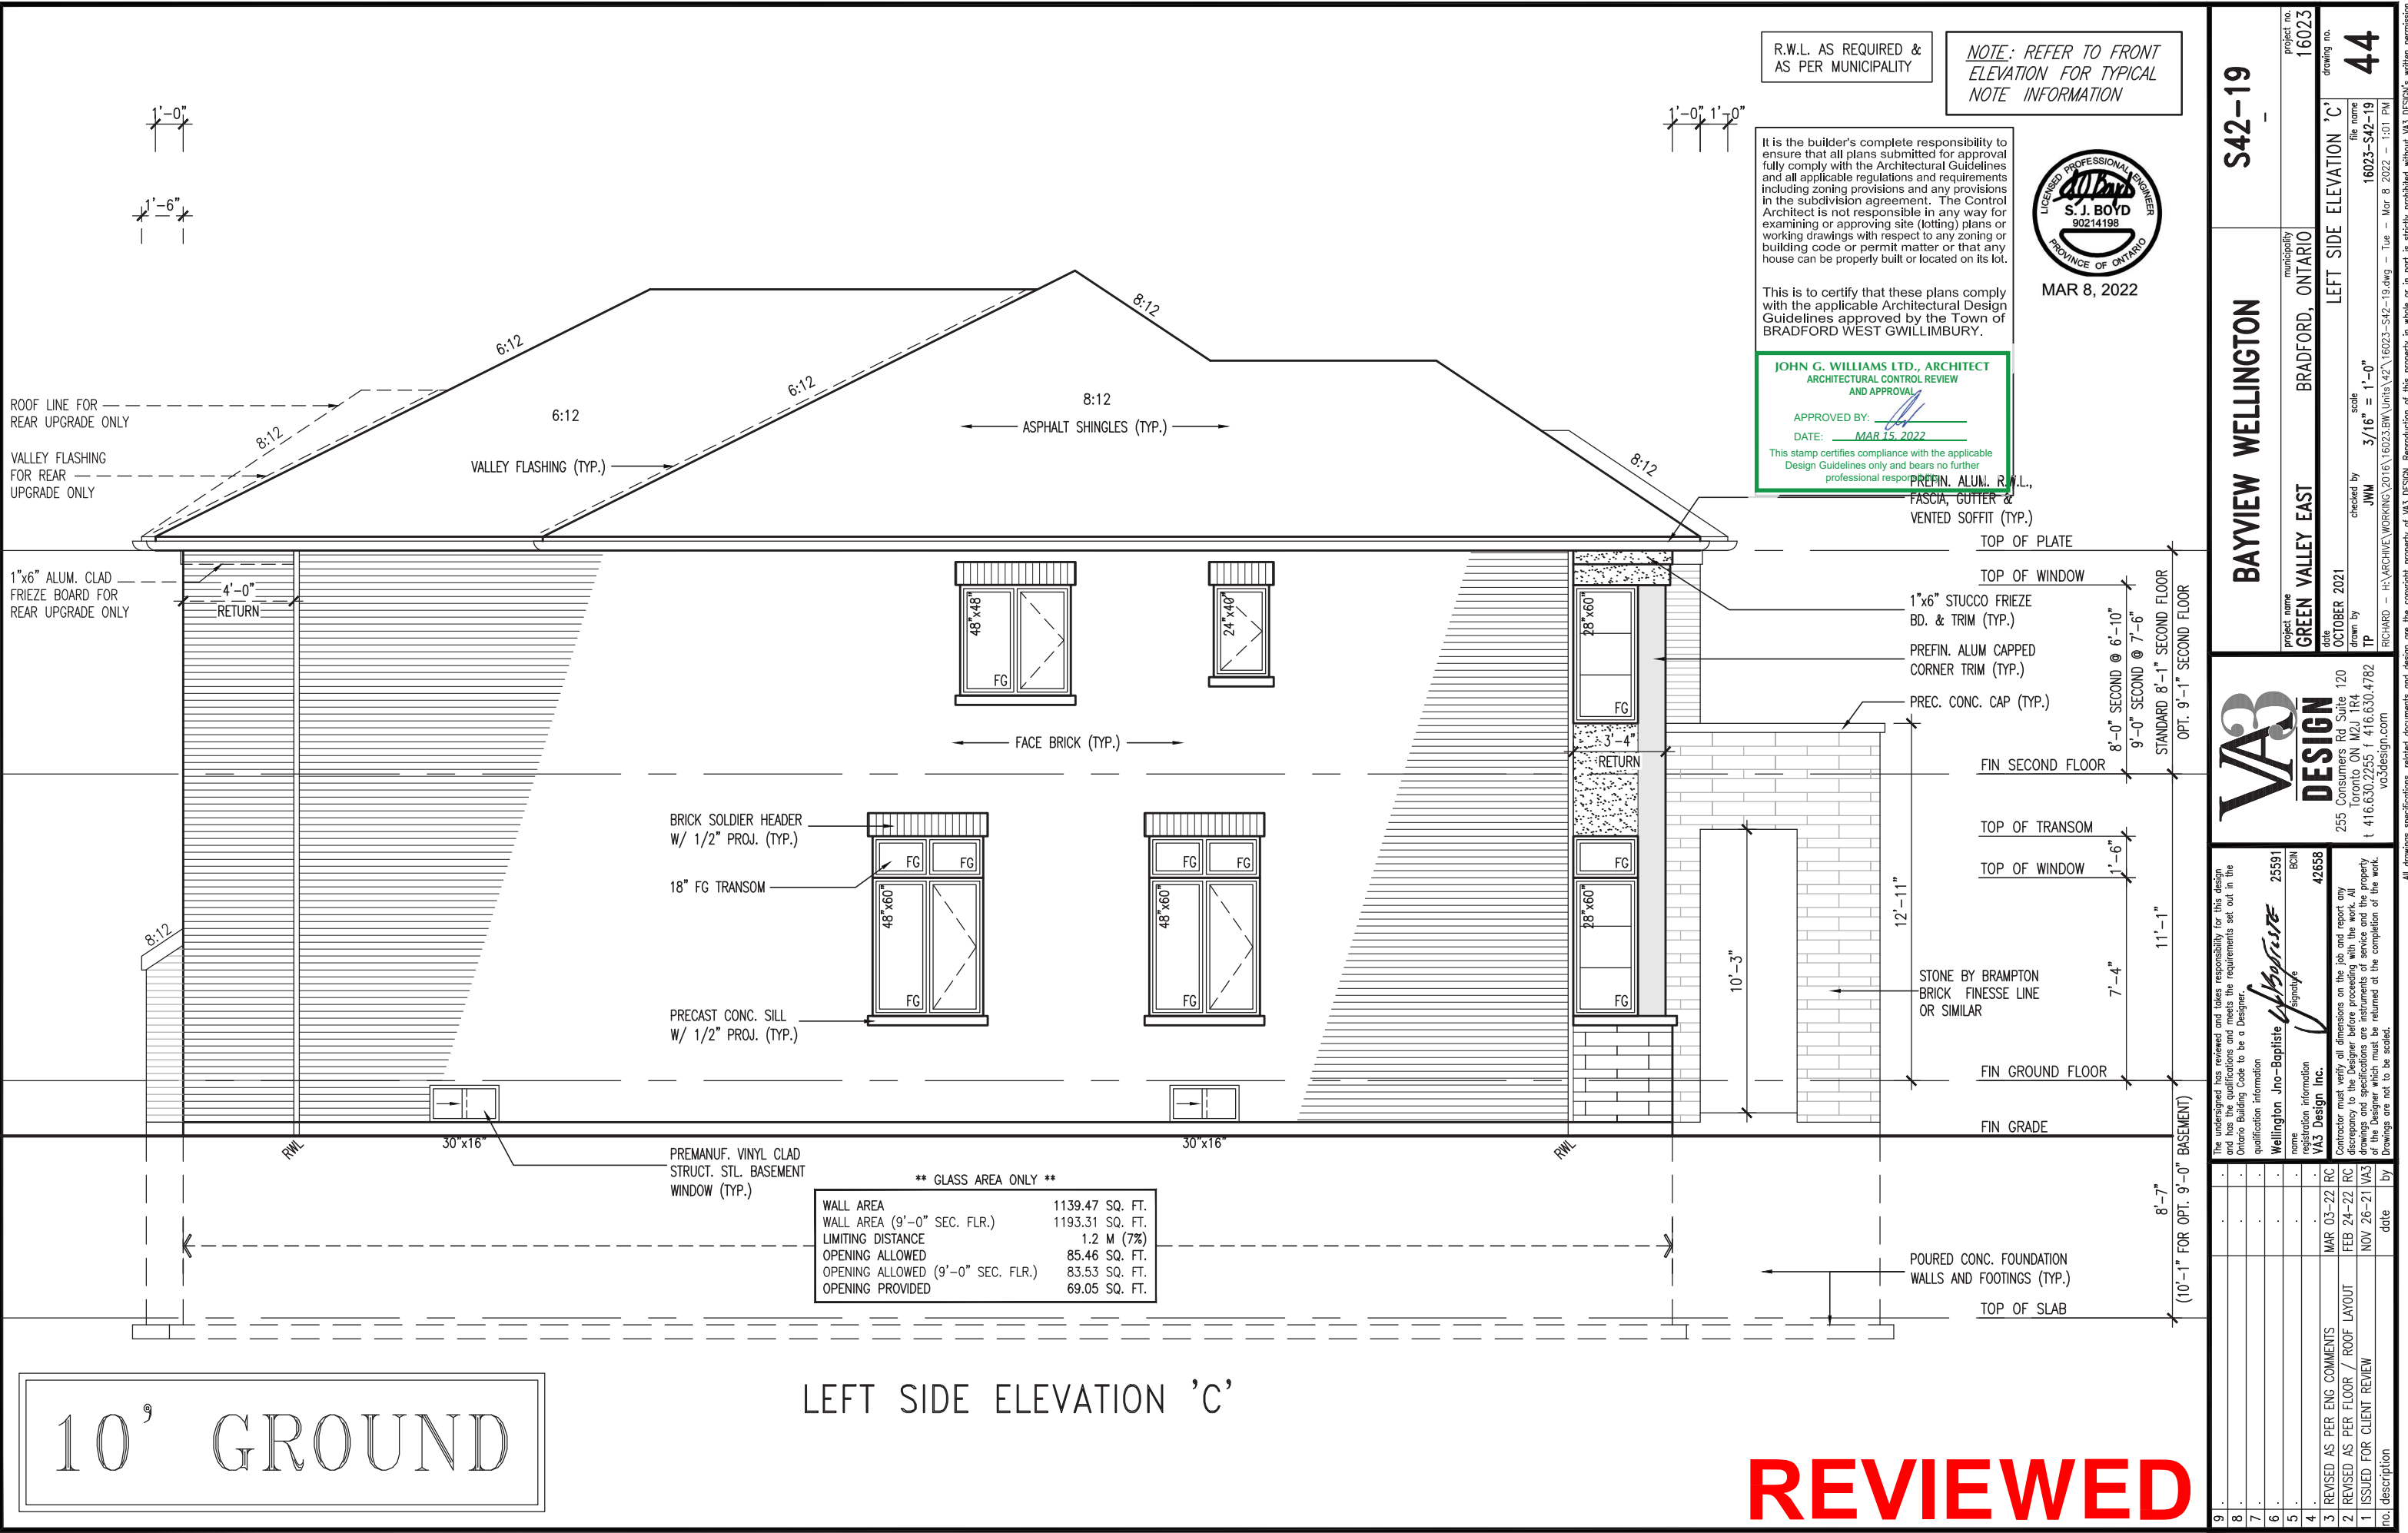APPROVED BY: 
DATE: MAR 15, 2022

This stamp certifies compliance with the applicable Design Guidelines only and bears no further professional responsibility.

BRICK VENEER CONSTRUCTION

(FOR WALLS LESS THAN 1.2M (3'-11") FROM THE LOT LINE)

45 MINUTE FIRE RATED WALL

PROVIDE A CONTINUOUS LAYER OF 12.7mm (1/2") TYPE 'X' GYPSUM BOARD (INTERIOR SIDE) INSTALLED SO THAT ALL EDGES ARE SUPPORTED, TAPED AND FILLED. SPACE BETWEEN WOOD STUDS TO BE FILLED WITH INSULATION CONFORMING TO CAN/ULC-S702, "MINERAL FIBRE THERMAL INSULATION FOR BUILDINGS" WITH A MASS OF NOT LESS THAN 1.22 Kg/SQ.M. AND MUST FILL AT LEAST 90% OF THE CAVITY THICKNESS. THE TYPE 'X' & INSULATION MUST BE RUN CONTINUOUSLY BEHIND ALL INTERSECTING PARTITIONS, MECHANICAL CHASES, BATHTUBS, SHOWERS, ETC. ENSURE INSULATION & TYPE 'X' IS INSTALLED IN GARAGE EXTERIOR WALLS. (REFER TO SECTION SB-2 OF OBC 2012-SUPPLEMENTARY STANDARDS)

R.W.L. AS REQUIRED &
AS PER MUNICIPALITY

NOTE: REFER TO FRONT
ELEVATION FOR TYPICAL
NOTE INFORMATION



MAR 8, 2022

PREFIN. ALUM. R.W.L.,
FASCIA, GUTTER &
VENTED SOFFIT (TYP.)

1"x6" STUCCO FRIEZE
BD. & TRIM (TYP.)

PREFIN. ALUM CAPPED
CORNER TRIM (TYP.)

SCUPPER

STONE BY
BRAMPTON BRICK
FINESSE LINE OR
SIMILAR

ASPHALT SHINGLES (TYP.)

VALLEY FLASHING (TYP.)

ROOF LINE FOR
REAR UPGRADE ONLY

VALLEY FLASHING
FOR REAR
UPGRADE ONLY

TOP OF PLATE

TOP OF WINDOW

1"x6" ALUM. CLAD
FRIEZE BOARD FOR
REAR UPGRADE ONLY

FIN SECOND FLOOR

TOP OF TRANSOM

TOP OF WINDOW

CONT. PRECAST CONC.
SILL W/ 1/2" PROJ. FOR
REAR UPGRADE ONLY

FIN GROUND FLOOR

FIN GRADE

TOP OF SLAB

STL BEAM LOCATION

BRICK SOLDIER HEADER
W/ 1/2" PROJ. (TYP.)

18" FG TRANSOM

PRECAST CONC. SILL
W/ 1/2" PROJ. (TYP.)

(2) OPT. DOOR IF
GRADE PERMITS

** GLASS AREA ONLY **

WALL AREA	1050.47 SQ. FT.
WALL AREA (9'-0" SEC. FLR.)	1103.31 SQ. FT.
LIMITING DISTANCE	1.2 M (7%)
OPENING ALLOWED	73.82 SQ. FT.
OPENING ALLOWED (9'-0" SEC. FLR.)	77.23 SQ. FT.
OPENING PROVIDED	55.93 SQ. FT.
	72.62 SQ. FT. (OPT. DOOR)

10' GROUND

RIGHT SIDE ELEVATION 'C'

REVIEWED

S42-19

BAYVIEW WELLINGTON

VA3
DESIGN

The undersigned has reviewed and takes responsibility for this design and has the qualifications and meets the requirements set out in the Ontario Building Code to be a Designer.

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Wellington Jno-Baptiste
signature
BCIN 25591
42658

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RC

Contractor must verify all dimensions on the job and report any discrepancy to the Designer before proceeding with the work. All drawings and specifications are instruments of service and the property of the Designer which must be returned at the completion of the work. Drawings are not to be scaled.

REVIS AS PER ENG COMMENTS
REVISED AS PER FLOOR / ROOF LAYOUT
ISSUED FOR CLIENT REVIEW

date by

MAR 03-22
FEB 24-22
NOV 26-21

description

project no. 16023
drawing no. 45

project name GREEN VALLEY EAST
municipality BRADFORD, ONTARIO
date OCTOBER 2021
checked by JMW
drawn by TP

scale 3/16" = 1'-0"
file name 16023-S42-19

drawn by TP

16023-S42-19.dwg - Tue - Mar 8 2022 - 1:01 PM

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APPROVED BY: [Signature]
DATE: MAR 15, 2022

This stamp certifies compliance with the applicable Design Guidelines only and bears no further professional responsibility.

NOTE: REFER TO FRONT
ELEVATION FOR TYPICAL
NOTE INFORMATION



MAR 8, 2022

FACE BRICK (TYP.)

BRICK SOLDIER HEADER
W/ 1/2" PROJ. (TYP.)

18" FG TRANSOM

PREFIN. MTL. FLASHING,
W/ CAULKING TO MATCH
MASONRY COLOUR (TYP.)

DASHED LINE INDICATES ROOF
LINE FOR ELEV. 'C'

Diagram illustrating the vertical dimensions of a building facade, showing the relationship between various levels and heights:

- TOP OF PLATE**
- TOP OF WINDOW**
- FIN SECOND FLOOR**
- TOP OF TRANSOM**
- TOP OF WINDOW**
- FIN GROUND FLOOR**
- TOP OF WINDOW**
- FIN GRADE**
- TOP OF SLAB**

Vertical dimensions and offsets:

- 8'-0" SECOND @ 6'-10"
- 9'-0" SECOND @ 7'-6"
- STANDARD 8'-1" SECOND FLOOR
- OPT. 9'-1" SECOND FLOOR
- 1'-6"
- 7'-4"
- 11'-1"
- 6'-10"
- 8'-7"
- (10'-1" FOR OPT. 9'-0" BASEMENT)

PROVIDE 2"x4" P.T. WOOD
— HANDRAIL GUARD W/ 2"x2" P.T.
WOOD PICKETS @ 4" MAX.

6"X6" P.T. WOOD POST C/W
GALV. METAL CAP AND METAL
SHOE SET INTO 12" DIA. SONO
TUBES TO EXTEND 6" ABOVE
GRADE AND 5'-0" BELOW GRADE.

POURED CONC. FOUNDATION
WALLS AND FOOTINGS (TYP.)

REAR ELEVATION 'A'/'B'/'C' - W.O.D. CONDITION

BASEMENT WINDOW SIZES
4R-8R USE 30"x24" VINYL
CLAD STRUCTURAL STEEL
FRAME BASEMENT WINDOWS

REVIEWED

S42-19

BAYVIEW WELLINGTON

project name	GREEN VALLEY EAST	municipality	BRADFORD, ONTARIO	project no.	16023
date	OCTOBER 2021	REAR ELEVATION 'A' - W.O.D. COND.		drawing no.	

PROJECT	DATE	BY	SCALE	FILE NAME
TP	10/20/2021	JWM	3/16" = 1'-0"	16023-S42-19

RICHARD - H:\ARCHIVE\WORKING\2016\16023.BW\Units 42\16023-S42-19.dwg - Tue - Mar 8 2022 - 1:01 PM

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235 Consumers Rd Suite 120
Toronto ON M2J 1R4
t 416.630.2255 f 416.630.4782
va3design.com

and has the qualifications and meets the requirements set out in the Ontario Building Code to be a Designer.

name signature BCIN
 registration information
VA3 Design Inc. 42658

drawings are not to be scaled.

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7	*		*	*

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3	REVISED AS PER ENG COMMENTS		
	MAR 03-22 RC		

2	REVISED AS PER FLOOR / ROOF LAYOUT	FEB 24-22	RC
1	ISSUED FOR CLIENT REVIEW	NOV 26-21	VA3
o.o.	description	date	by

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This is to certify that these plans comply with the applicable Architectural Design Guidelines approved by the Town of BRADFORD WEST GWILLIMBURY.

JOHN G. WILLIAMS LTD., ARCHITECT
ARCHITECTURAL CONTROL REVIEW
AND APPROVAL

APPROVED BY: [Signature]
DATE: MAR 15, 2022

This stamp certifies compliance with the applicable Design Guidelines only and bears no further professional responsibility.

R.W.L. AS REQUIRED &
AS PER MUNICIPALITY

NOTE: REFER TO FRONT
ELEVATION FOR TYPICAL
NOTE INFORMATION



MAR 8, 2022

PREFIN. ALUM. R.W.L.,
FASCIA, GUTTER &
VENTED SOFFIT (TYP.)

FACE BRICK (TYP.)

BRICK SOLDIER HEADER
W/ 1/2" PROJ. (TYP.)

PREFIN. MTL. FLASHING,
W/ CAULKING TO MATCH
MASONRY COLOUR (TYP.)

DASHED LINE INDICATES ROOF
LINE FOR ELEV. 'B' @ FRONT

DASHED LINE INDICATES ROOF
LINE FOR ELEV. 'C'

Diagram showing floor-to-floor heights for the second floor and ground floor.

Second Floor Section:

- TOP OF PLATE
- TOP OF WINDOW
- 8'-0" SECOND @ 6'-10"
- 9'-0" SECOND @ 7'-6"
- STANDARD 8'-1" SECOND FLOOR
- OPT. 9'-1" SECOND FLOOR
- FIN SECOND FLOOR

Ground Floor Section:

- TOP OF TRANSOM
- TOP OF WINDOW
- 7'-4"
- 1'-6"
- 11'-1"
- FIN GROUND FLOOR
- TOP OF WINDOW
- 6'-10"
- 8'-7"
- (10'-1" FOR OPT. 9'-0" BASEMENT)
- TOP OF SLAB
- FIN GRADE

PROVIDE 2"x4" P.T. WOOD
— HANDRAIL GUARD W/ 2"x2" P.T.
WOOD PICKETS @ 4" MAX.

2"x6" P.T.
CROSS BRACING

6"X6" P.T. WOOD POST C/W
GALV. METAL CAP AND METAL
— SHOE SET INTO 12" DIA. SONO
TUBES TO EXTEND 6" ABOVE
GRADE AND 5'-0" BELOW GRADE.

POURED CONC. FOUNDATION
WALLS AND FOOTINGS (TYP.)

REAR ELEVATION 'A'/'B'/'C' - W.O.B. CONDITION

REVIEWED

BAYVIEW WELLINGTON	S42-19
---------------------------	---------------

VA3
DESIGN
2255 Consumers Rd Suite
Toronto ON M2J 1R4
416.630.2255 f 416.630.
va3design.com

The undersigned has reviewed and takes responsibility for this design and has approved the design and the requirements set out in the International Building Code to be a Designer.

Signature *William J. Baptiste* BCIN 25591

Designation Information
Name *William J. Baptiste* 42658
Firm *WJ3 Design Inc.*

Contractor must verify all dimensions on the job and report any discrepancy to the Designer before proceeding with the work. All drawings and specifications are instruments of service and the property of the Designer which must be returned at the completion of the work. Drawings are not to be scaled.


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3.	REVISED AS PER ENG COMMENTS
2.	REVISED AS PER FLOOR / ROOF PLAN
1.	ISSUED FOR CLIENT REVIEW
no.	description

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This is to certify that these plans comply with the applicable Architectural Design Guidelines approved by the Town of BRADFORD WEST GWILLIMBURY.

APPROVED BY: [Signature]
DATE: MAR 15, 2022

This stamp certifies compliance with the applicable
Design Guidelines only and bears no further
professional responsibility.

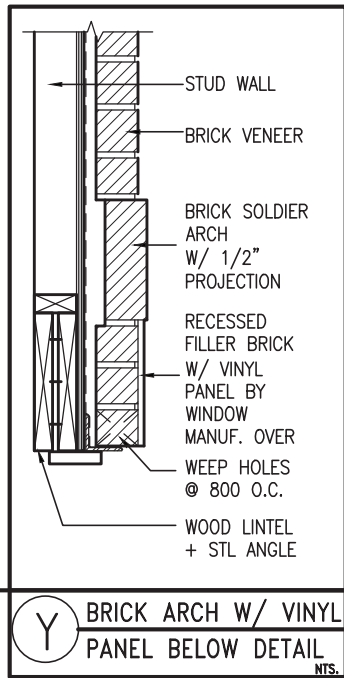

Y BRICK ARCH W/ VINYL
PANEL BELOW DETAIL

10⁹ GROUND

REAR UPGRADE ELEVATION 'A'

R.W.L. AS REQUIRED &
AS PER MUNICIPALITY

NOTE: REFER TO FRONT
ELEVATION FOR TYPICAL
NOTE INFORMATION



MAR 8, 2022

PREFIN. ALUM. R.W.L.,
FASCIA, GUTTER &
VENTED SOFFIT (TYP.)

BRICK SOLDIER COURSE
ON BRICK STACK BOND
W/ 1/2" PROJ. (TYP.)

FACE BRICK (TYP.)

BRICK SOLDIER COURSE
HEADER C/W KEYSTONE W/
1/2" PROJ. (TYP.)

18" FG TRANSOM

PREFIN. MTL. FLASHING,
W/ CAULKING TO MATCH
MASONRY COLOUR (TYP.)

STUCCO FINISH W/ 6"
STUCCO FRIEZE BOARD

— 6"x16" STUCCO IMPOST

— PREFIN. MTL. FLASHING, W/
CAULKING BEHIND STUCCO
CLADDING (TYP.)

BRICK SOLDIER COURSE ARCH
C/W PRECAST CONC.
KEYSTONE ON BRICK STACK
BOND W/ 1/2" PROJ. (TYP.)

— PRECAST CONC. SILL ON BRICK
ROWLOCK W/ 1/2" PROJ. (TYP.)

BRICK SOLDIER COURSE HEAR
C/W KEYSTONE ON BRICK STACK
BOND W/ 1/2" PROJ. (TYP.)

POURED CONC. FOUNDATION
— WALLS AND FOOTINGS (TYP.)

Diagram showing vertical dimensions for a building section:

- TOP OF PLATE
- TOP OF WINDOW
- 8'-0" SECOND @ 6'-10"
- 9'-0" SECOND @ 7'-6"
- FIN SECOND FLOOR
- TOP OF TRANSOM
- TOP OF WINDOW
- 1'-6"
- 7'-4"
- FIN GROUND FLOOR
- FIN GRADE
- 11'-1"
- 11'-1"

TOP OF SLAB

REVIEWED

BAYVIEW WELLINGTON	S42-19
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V3
DESIGN
255 Consumers Rd Suite
Toronto, ON M2J 1R4
t 416.630.2255 f 416.630.
va3design.com

<p>The undersigned has reviewed and takes responsibility for this design and has the qualifications and meets the requirements set out in the Ontario Building Code to be a Designer.</p> <p>qualification information</p> <p>Wellington Jno-Baptiste</p> <p>name</p> <p>signature</p> <p>255391</p> <p>BCIN</p>	<p>Contractor must verify all dimensions on the job and report any discrepancy to the Designer before proceeding with the work. All drawings and specifications are instruments of service and the property of the Designer which must be returned at the completion of the work.</p> <p>Drawings are not to be scaled.</p> <p>24658</p> <p>signature</p> <p>WAZ Design Inc.</p> <p>qualification information</p>
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
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3	REVISED AS PER ENG COMMENTS			MAR 03--22 RC	
2	REVISED AS PER FLOOR / ROOF LAYOUT			FEB 24--22 RC	
1	ISSUED FOR CLIENT REVIEW			NOV 26--21 W3	
o.	description			date	by

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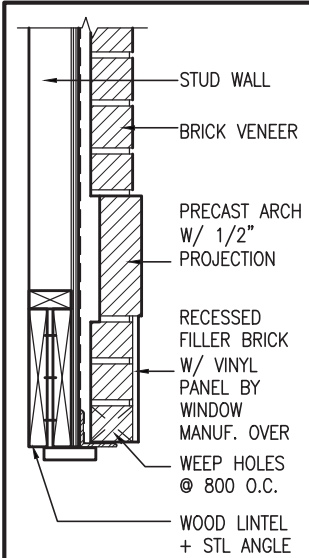
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This is to certify that these plans comply with the applicable Architectural Design Guidelines approved by the Town of BRADFORD WEST GWILLIMBURY.

JOHN G. WILLIAMS LTD., ARCHITECT
ARCHITECTURAL CONTROL REVIEW
AND APPROVAL

APPROVED BY: 
DATE: MAR 15, 2022

This stamp certifies compliance with the applicable Design Guidelines only and bears no further professional responsibility.



BRICK ARCH W/ VINYL
PANEL BELOW DETAIL
NTS.

10' GROUND

6"x16" STONE IMPOST

PREFIN. ALUM. R.W.L.,
FASCIA, GUTTER &
VENTED SOFFIT (TYP.)

FACE BRICK (TYP.)

8" PRECAST CONC. HEADER
W/ 1/2" PROJ. (TYP.)

18" FG TRANSOM

PREFIN. MTL. FLASHING,
W/ CAULKING TO MATCH
MASONRY COLOUR (TYP.)

PRECAST CONC. SILL
W/ 1/2" PROJ. (TYP.)

POURED CONC. DOOR
SILL & PRECAST
CONC. STEP

R.W.L. AS REQUIRED &
AS PER MUNICIPALITY

NOTE: REFER TO FRONT
ELEVATION FOR TYPICAL
NOTE INFORMATION



MAR 8, 2022

ASPHALT SHINGLES (TYP.)

VALLEY FLASHING (TYP.)

8" PRECAST CONC. ARCH OVER
VINYL PANEL BY WINDOW MANUF.
ON 8" PRECAST CONC. SURROUND
W/ 1/2" PROJ. (TYP.)

CONT. PRECAST CONC. BAND
W/ 1/2" PROJ. (TYP.)

8" PRECAST CONC. SURROUND
ON 4" PRECAST CONC. SILL
W/ 1/2" PROJ. (TYP.)

POURED CONC. FOUNDATION
WALLS AND FOOTINGS (TYP.)

TOP OF PLATE
TOP OF WINDOW
8'-0" SECOND @ 6'-10"
9'-0" SECOND @ 7'-6"
STANDARD 8'-1" SECOND FLOOR
OPT. 9'-1" SECOND FLOOR
FIN SECOND FLOOR
TOP OF TRANSOM
TOP OF WINDOW
1'-6"
7'-4"
11'-1"
FIN GROUND FLOOR
FIN GRADE
8'-7"
(10'-1" FOR OPT. 9'-0" BASEMENT)
TOP OF SLAB

REAR UPGRADE ELEVATION 'B'

REVIEWED

S42-19

BAYVIEW WELLINGTON

VA3
DESIGN

25591
BCIN
42658
Wellington Jno-Baptiste
VA3 Design Inc.
name
signature
BCIN
42658

3 REVISED AS PER ENG COMMENTS
2 REVISED AS PER FLOOR / ROOF LAYOUT
1 ISSUED FOR CLIENT REVIEW
no. description

project no. 16023
drawing no. 49
project name GREEN VALLEY EAST
municipality BRADFORD, ONTARIO
date OCTOBER 2021
checked by JWM
drawn by TP
scale 3/16" = 1'-0"

REAR UPGRADE ELEVATION 'B'
file name 16023-S42-19
date OCTOBER 2021
checked by JWM
drawn by TP
scale 3/16" = 1'-0"

120
Suite 104
255 Consumers Rd.
Toronto, ON M2J 1P4
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va3design.com

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
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JOHN G. WILLIAMS LTD., ARCHITECT
ARCHITECTURAL CONTROL REVIEW
AND APPROVAL

APPROVED BY: 
DATE: MAR 15, 2022

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R.W.L. AS REQUIRED &
AS PER MUNICIPALITY

NOTE: REFER TO FRONT
ELEVATION FOR TYPICAL
NOTE INFORMATION



MAR 8, 2022

1"x6" STUCCO FRIEZE
BOARD (TYP.)

1"x6" ALUM. CLAD
FRIEZE BOARD (TYP.)

FACE BRICK (TYP.)

18" FG TRANSOM

PREFIN. MTL. FLASHING,
W/ CAULKING TO MATCH
MASONRY COLOUR (TYP.)

CONT. PRECAST CONC. SILL
W/ 1/2" PROJ. (TYP.)

PREFIN. ALUM. R.W.L.,
FASCIA, GUTTER &
VENTED SOFFIT (TYP.)

PRECAST CONC. SILL
W/ 1/2" PROJ. (TYP.)

STUCCO FINISH (TYP.)

POURED CONC. FOUNDATION
WALLS AND FOOTINGS (TYP.)

TOP OF PLATE
TOP OF WINDOW
FIN SECOND FLOOR
TOP OF TRANSOM
TOP OF WINDOW
FIN GROUND FLOOR
FIN GRADE
TOP OF SLAB

8'-0" SECOND @ 6'-10"
9'-0" SECOND @ 7'-6"
STANDARD 8'-1" SECOND FLOOR
OPT. 9'-1" SECOND FLOOR

7'-4"
11'-1"
8'-7"
(10'-1" FOR OPT. 9'-0" BASEMENT)

REAR UPGRADE ELEVATION 'C'

10' GROUND

REVIEWED

S42-19

BAYVIEW WELLINGTON

VA3
DESIGN

Wellington Jno-Baptiste
Signature
BCIN 25591
42658

name
registration information
VA3 Design Inc.

RC
MAR 03-22
FEB 24-22
NOV 26-21

COMMENTS
REVISED AS PER ENG
REVISED AS PER FLOOR / ROOF LAYOUT
ISSUED FOR CLIENT REVIEW

no. description
date by

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project no. 16023
drawing no. 50
municipality BRADFORD, ONTARIO
project name GREEN VALLEY EAST
date OCTOBER 2021
checked by JWM
drawn by TP

255 Consumers Rd Suite 120
Toronto, ON M2J 1P4
t 416.630.2255 f 416.630.4782
va3design.com

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NOV 26-21

COMMENTS
REVISED AS PER ENG
REVISED AS PER FLOOR / ROOF LAYOUT
ISSUED FOR CLIENT REVIEW

no. description
date by


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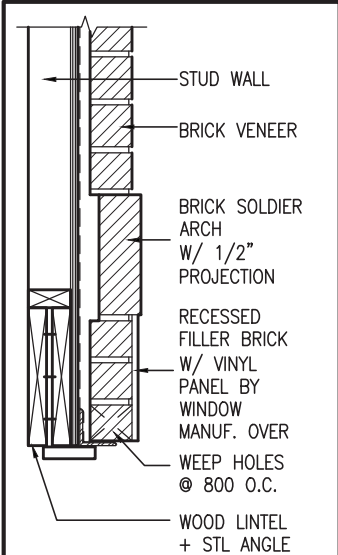
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JOHN G. WILLIAMS LTD., ARCHITECT
ARCHITECTURAL CONTROL REVIEW
AND APPROVAL

APPROVED BY: 
DATE: MAR 15, 2022

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BRICK ARCH W/ VINYL
PANEL BELOW DETAIL
NTS.

10' GROUND

REAR UPGRADE ELEVATION 'A' - W.O.D. CONDITION

R.W.L. AS REQUIRED &
AS PER MUNICIPALITY

NOTE: REFER TO FRONT
ELEVATION FOR TYPICAL
NOTE INFORMATION



MAR 8, 2022

PREFIN. ALUM. R.W.L.,
FASCIA, GUTTER &
VENTED SOFFIT (TYP.)

BRICK SOLDIER COURSE
ON BRICK STACK BOND
W/ 1/2" PROJ. (TYP.)

FACE BRICK (TYP.)

BRICK SOLDIER COURSE
HEADER C/W KEYSTONE W/
1/2" PROJ. (TYP.)

18" FG TRANSOM

PREFIN. MTL. FLASHING,
W/ CAULKING TO MATCH
MASONRY COLOUR (TYP.)

STUCCO FINISH W/ 6"
STUCCO FRIEZE BOARD

6"x16" STUCCO IMPOST

PREFIN. MTL. FLASHING, W/
CAULKING BEHIND STUCCO
CLADDING (TYP.)

BRICK SOLDIER COURSE ARCH
C/W PRECAST CONC.
KEYSTONE ON BRICK STACK
BOND W/ 1/2" PROJ. (TYP.)

PRECAST CONC. SILL ON BRICK
ROWLOCK W/ 1/2" PROJ. (TYP.)

BRICK SOLDIER COURSE HEAR
C/W KEYSTONE ON BRICK STACK
BOND W/ 1/2" PROJ. (TYP.)

PROVIDE 2"x4" P.T. WOOD
HANDRAIL GUARD W/ 2"x2" P.T.
WOOD PICKETS @ 4" MAX.

6"x6" P.T. WOOD POST C/W
GALV. METAL CAP AND METAL
SHOE SET INTO 12" DIA. SONO
TUBES TO EXTEND 6" ABOVE
GRADE AND 5'-0" BELOW GRADE.

POURED CONC. FOUNDATION
WALLS AND FOOTINGS (TYP.)

TOP OF PLATE
TOP OF WINDOW
FIN SECOND FLOOR
TOP OF TRANSOM
TOP OF WINDOW
FIN GROUND FLOOR
TOP OF WINDOW
FIN GRADE
TOP OF SLAB

S42-19

BAYVIEW WELLINGTON

VA3
DESIGN

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Toronto, ON M2J 1P4
t 416.630.2255 f 416.630.4782
va3design.com

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project no. 16023
drawing no. 51
project name GREEN VALLEY EAST
municipality BRADFORD, ONTARIO
date OCTOBER 2021
checked by JMW
drawn by TP
scale 3/16" = 1'-0"
file name 16023-S42-19
RICHARD - H:\ARCHIVE\WORKING\2016\16023.BW\Units\42\16023-S42-19.dwg - Tue - Mar 8 2022 - 1:01 PM

no. description
1 ISSUED FOR CLIENT REVIEW
2 REVISED AS PER FLOOR / ROOF LAYOUT
3 REVISED AS PER ENG COMMENTS
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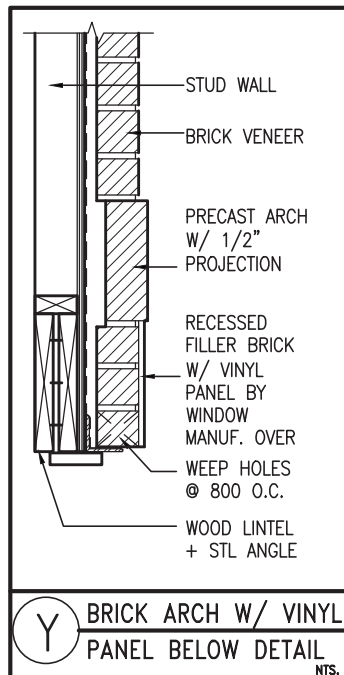
REVIEWED

This is to certify that these plans comply with the applicable Architectural Design Guidelines approved by the Town of BRADFORD WEST GWILLIMBURY.

JOHN G. WILLIAMS LTD., ARCHITECT
ARCHITECTURAL CONTROL REVIEW
AND APPROVAL

APPROVED BY: [Signature]
DATE: MAR 15, 2022

This stamp certifies compliance with the applicable Design Guidelines only and bears no further professional responsibility.



Architectural elevation drawing of a building facade. The drawing includes various dimensions and labels for windows, doors, and structural elements.

Roof and Gable Dimensions:

- Overall width: 19'-7"
- Gable width: 11'-10"
- Gable height: 6:12
- Roof pitch: 10:12
- Overhang: 18" OVERHANG
- Dimensions: 4'-10", 7'-9", 9'-4", 5'-8", 2'-6"

Windows and Doors:

- Windows: 48"x48" FG, 28"x60" FG, 48"x36" FG, 28"x40" FG
- Door: 8" FG TRANSOM, 8'-2" TOP OF DOOR, 2"x6" P.T. CROSS BRACING

Structural and Other Details:

- Staircase: 5'-8" (width), 2'-6" (height)
- Handrail: 33" (height)
- Foundation: 5'-0" MIN.
- Labels: RWL, FG (Finish Grade)

R.W.L. AS REQUIRED &
AS PER MUNICIPALITY

NOTE: REFER TO FRONT
ELEVATION FOR TYPICAL
NOTE INFORMATION



MAR 8, 2022

— ASPHALT SHINGLES (TYP.)

— VALLEY FLASHING (TYP.)

8" PRECAST CONC. ARCH OVER
— VINYL PANEL BY WINDOW MANUF.
ON 8" PRECAST CONC. SURROUND
W/ 1/2" PROJ. (TYP.)

CONT. PRECAST CONC. BAND
W/ 1/2" PROJ. (TYP.)

8" PRECAST CONC. SURROUND
— ON 4" PRECAST CONC. SILL
W/ 1/2" PROJ. (TYP.)

PROVIDE 2"x4" P.T. WOOD
— HANDRAIL GUARD W/ 2"x2" P.T.
WOOD PICKETS @ 4" MAX.

6"X6" P.T. WOOD POST C/W
GALV. METAL CAP AND METAL
SHOE SET INTO 12" DIA. SONO
TUBES TO EXTEND 6" ABOVE
GRADE AND 5'-0" BELOW GRADE.

POURED CONC. FOUNDATION
WALLS AND FOOTINGS (TYP.)

10⁹ GROUND

REAR UPGRADE ELEVATION 'B' – W.O.D. CONDITION

REVIEWED

BAYVIEW WELLINGTON	S42-19
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BAYVIEW WELLINGTON

VA3
DESIGN
5 Consumers Rd Suite
Toronto ON M2J 1R4
16.630.2255 f 416.630.2255
vo3design.com

<p>The undersigned has reviewed and takes responsibility for this design and has the qualifications and meets the requirements set out in the Ontario Building Code to be a Designer.</p> <p>qualification information</p> <p>Wellington Jno-Baptiste</p> <p>name</p> <p>signature</p> <p>255391</p> <p>BCIN</p>	<p>Contractor must verify all dimensions on the job and report any discrepancy to the Designer before proceeding with the work. All drawings and specifications are instruments of service and the property of the Designer which must be returned at the completion of the work.</p> <p>Drawings are not to be scaled.</p> <p>24658</p> <p>signature</p> <p>WAZ Design Inc.</p> <p>qualification information</p>
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
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3	REVISED AS PER ENG COMMENTS			MAR 03--22 RC	
2	REVISED AS PER FLOOR / ROOF LAYOUT			FEB 24--22 RC	
1	ISSUED FOR CLIENT REVIEW			NOV 26--21 W3	
o.	description			date	by

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This is to certify that these plans comply with the applicable Architectural Design Guidelines approved by the Town of BRADFORD WEST GWILLIMBURY.

JOHN G. WILLIAMS LTD., ARCHITECT
ARCHITECTURAL CONTROL REVIEW
AND APPROVAL

APPROVED BY: 
DATE: MAR 15, 2022

This stamp certifies compliance with the applicable Design Guidelines only and bears no further professional responsibility.

R.W.L. AS REQUIRED &
AS PER MUNICIPALITY

NOTE: REFER TO FRONT
ELEVATION FOR TYPICAL
NOTE INFORMATION



REAR UPGRADE ELEVATION 'C' - W.O.D. CONDITION

REVIEWED

S42-19

BAYVIEW WELLINGTON

VA3 DESIGN

The undersigned has reviewed and takes responsibility for this design and has the qualifications and meets the requirements set out in the Ontario Building Code to be a Designer.
qualification information
Wellington Jno-Baptiste 25591 BCN
name registration information
VA3 Design Inc. 42658
Contractor must verify all dimensions on the job and report any discrepancy to the Designer before proceeding with the work. All drawings and specifications are instruments of service and the property of the Designer which must be returned at the completion of the work. Drawings are not to be scaled.

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4	3 REVISED AS PER ENG COMMENTS	MAR 03-22	RC
3	2 REVISED AS PER FLOOR / ROOF LAYOUT	FEB 24-22	RC
2	1 ISSUED FOR CLIENT REVIEW	NOV 26-21	VA3

project no. 16023
drawing no. 53
project name GREEN VALLEY EAST
municipality BRADFORD, ONTARIO
date OCTOBER 2021
file name 16023-S42-19
drawn by JMW
checked by JMW
scale 3/16" = 1'-0"

date OCTOBER 2021
file name 16023-S42-19
drawn by JMW
checked by JMW
scale 3/16" = 1'-0"


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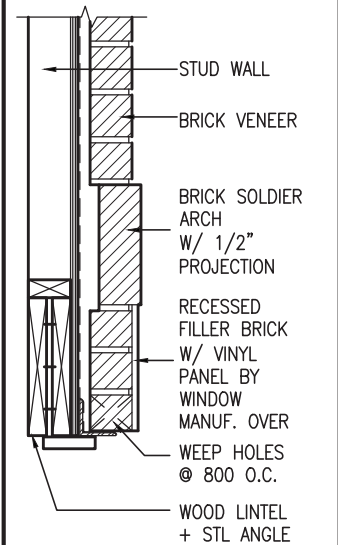
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JOHN G. WILLIAMS LTD., ARCHITECT
ARCHITECTURAL CONTROL REVIEW
AND APPROVAL

APPROVED BY: 
DATE: MAR 15, 2022

This stamp certifies compliance with the applicable Design Guidelines only and bears no further professional responsibility.



Y BRICK ARCH W/ VINYL
PANEL BELOW DETAIL
NTS.

10' GROUND



REAR UPGRADE ELEVATION 'A' - W.O.B. CONDITION

R.W.L. AS REQUIRED &
AS PER MUNICIPALITY

NOTE: REFER TO FRONT
ELEVATION FOR TYPICAL
NOTE INFORMATION



MAR 8, 2022

STUCCO FINISH W/ 6"
STUCCO FRIEZE BOARD

6"x16" STUCCO IMPOST

PREFIN. MTL. FLASHING, W/
CAULKING BEHIND STUCCO
CLADDING (TYP.)

BRICK SOLDIER COURSE ARCH
C/W PRECAST CONC.
KEYSTONE ON BRICK STACK
BOND W/ 1/2" PROJ. (TYP.)

PRECAST CONC. SILL ON BRICK
ROWLOCK W/ 1/2" PROJ. (TYP.)

BRICK SOLDIER COURSE HEAR
C/W KEYSTONE ON BRICK STACK
BOND W/ 1/2" PROJ. (TYP.)

PROVIDE 2"x4" P.T. WOOD
HANDRAIL GUARD W/ 2"x2" P.T.
WOOD PICKETS @ 4" MAX.

2"x6" P.T.
CROSS BRACING

6"x6" P.T. WOOD POST C/W
GALV. METAL CAP AND METAL
SHOE SET INTO 12" DIA. SONO
TUBES TO EXTEND 6" ABOVE
GRADE AND 5'-0" BELOW GRADE.

POURED CONC. FOUNDATION
WALLS AND FOOTINGS (TYP.)

TOP OF PLATE	
TOP OF WINDOW	
8'-0" SECOND @ 6'-10"	
9'-0" SECOND @ 7'-6"	
STANDARD 8'-1" SECOND FLOOR	
OPT. 9'-1" SECOND FLOOR	
FIN SECOND FLOOR	
TOP OF TRANSOM	
TOP OF WINDOW	
7'-4"	
11'-1"	
FIN GROUND FLOOR	
TOP OF WINDOW	
6'-10"	
8'-7"	
(10'-1" FOR OPT. 9'-0" BASEMENT)	
TOP OF SLAB	
FIN GRADE	

S42-19

BAYVIEW WELLINGTON

VA3
DESIGN

255 Consumers Rd. Suite 120
Toronto, ON M2J 1P4
t 416.630.2255 f 416.630.4782
va3design.com

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project no. 16023
drawing no. 54
project name GREEN VALLEY EAST
municipality BRADFORD, ONTARIO
date OCTOBER 2021
checked by JMW
drawn by TP
scale 3/16" = 1'-0"

255 Consumers Rd. Suite 120
Toronto, ON M2J 1P4
t 416.630.2255 f 416.630.4782
va3design.com

no. description
1 ISSUED FOR CLIENT REVIEW
2 REVISED AS PER FLOOR / ROOF LAYOUT
3 REVISED AS PER ENG COMMENTS
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
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REVIEWED


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JOHN G. WILLIAMS LTD., ARCHITECT
ARCHITECTURAL CONTROL REVIEW
AND APPROVAL

APPROVED BY: 
DATE: MAR 15, 2022

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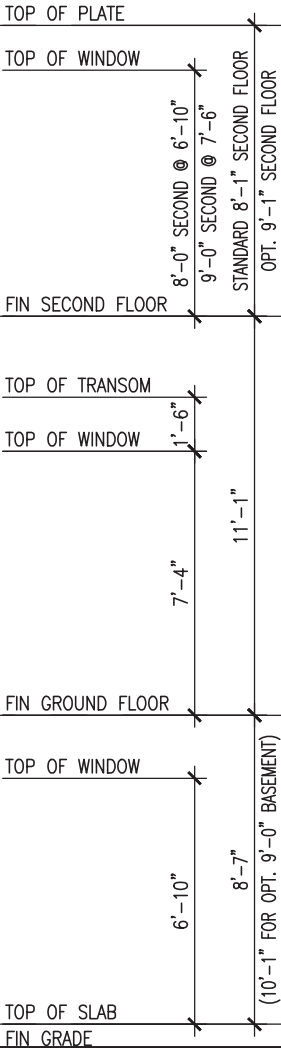


R.W.L. AS REQUIRED &
AS PER MUNICIPALITY

NOTE: REFER TO FRONT
ELEVATION FOR TYPICAL
NOTE INFORMATION

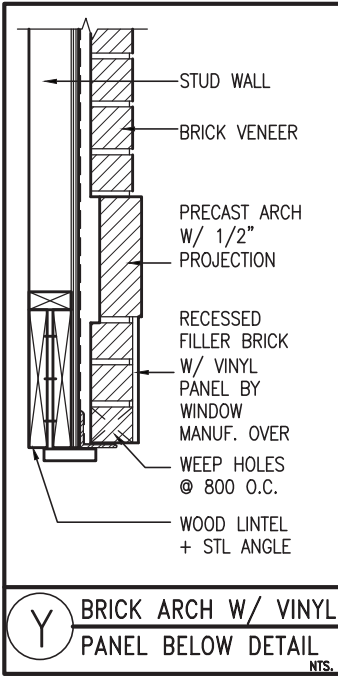

MAR 8, 2022



POURED CONC. FOUNDATION
WALLS AND FOOTINGS (TYP.)

REVIEWED

S42-19

BAYVIEW WELLINGTON

VA3
DESIGN

The undersigned has reviewed and takes responsibility for this design and has the qualifications and meets the requirements set out in the Ontario Building Code to be a Designer.
qualification information
Wellington Jno-Baptiste 25591 BCIN
name
signature
VAS Design Inc.
registration information
BCIN
42658

3 REVISED AS PER ENG COMMENTS
2 REVISED AS PER FLOOR / ROOF LAYOUT
1 ISSUED FOR CLIENT REVIEW

project no. 16023
drawing no. 55
project name GREEN VALLEY EAST
municipality BRADFORD, ONTARIO
date OCTOBER 2021
checked by JMW
drawn by TP

REAR UPGRADE ELEVATION 'B' - W.O.D. COND.
file name 16023-S42-19
scale 3/16" = 1'-0"
checked by JMW
drawn by TP


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JOHN G. WILLIAMS LTD., ARCHITECT
ARCHITECTURAL CONTROL REVIEW
AND APPROVAL

APPROVED BY: 
DATE: MAR 15, 2022

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R.W.L. AS REQUIRED &
AS PER MUNICIPALITY

NOTE: REFER TO FRONT
ELEVATION FOR TYPICAL
NOTE INFORMATION



1"x6" STUCCO FRIEZE
BOARD (TYP.)

1"x6" ALUM. CLAD
FRIEZE BOARD (TYP.)

FACE BRICK (TYP.)

18" FG TRANSOM

PREFIN. MTL. FLASHING,
W/ CAULKING TO MATCH
MASONRY COLOUR (TYP.)

CONT. PRECAST CONC. SILL
W/ 1/2" PROJ. (TYP.)

PREFIN. ALUM. R.W.L.,
FASCIA, GUTTER &
VENTED SOFFIT (TYP.)

PRECAST CONC. SILL
W/ 1/2" PROJ. (TYP.)

STUCCO FINISH (TYP.)

PROVIDE 2"x4" P.T. WOOD
HANDRAIL GUARD W/ 2"x2" P.T.
WOOD PICKETS @ 4" MAX.

2"x6" P.T.
CROSS BRACING

6"x6" P.T. WOOD POST C/W
GALV. METAL CAP AND METAL
SHOE SET INTO 12" DIA. SONO
TUBES TO EXTEND 6" ABOVE
GRADE AND 5'-0" BELOW GRADE.

POURED CONC. FOUNDATION
WALLS AND FOOTINGS (TYP.)

TOP OF PLATE
TOP OF WINDOW
8'-0" SECOND @ 6'-10"
9'-0" SECOND @ 7'-6"
STANDARD 8'-1" SECOND FLOOR
OPT. 9'-1" SECOND FLOOR
FIN SECOND FLOOR
TOP OF TRANSOM
TOP OF WINDOW
1'-6"
7'-4"
11'-1"
FIN GROUND FLOOR
TOP OF WINDOW
6'-10"
8'-7"
(10'-1" FOR OPT. 9'-0" BASEMENT)
TOP OF SLAB
FIN. GRADE

REAR UPGRADE ELEVATION 'C' - W.O.B. CONDITION

REVIEWED

S42-19

BAYVIEW WELLINGTON

VA3
DESIGN

Wellington Jno-Baptiste
Signature
BCIN 25591
42658

name
registration information
VA3 Design Inc.

3. REVISED AS PER ENG COMMENTS
4. MAR 03-22 RC

2. REVISED AS PER FLOOR / ROOF LAYOUT
FEB 24-22 RC

1. ISSUED FOR CLIENT REVIEW
NOV 26-21 VA3

no. description
date by

project no. 16023
drawing no. 56
project name GREEN VALLEY EAST
municipality BRADFORD, ONTARIO

date OCTOBER 2021
checked by JMW
drawn by TP
scale 3/16" = 1'-0"

file name 16023-S42-19
RICHARD - H:\ARCHIVE\WORKING\2016\16023.BW\Units\42\16023-S42-19.dwg - Tue - Mar 8 2022 - 1:01 PM

255 Consumers Rd Suite 120
Toronto, ON M2J 1P4
t 416.630.2255 f 416.630.4782
va3design.com

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UNINSULATED OPENINGS (PER OBC. SB-12,3.1.1(7))				
STANDARD & REAR UPGRADE 10' GDN. FL.	S42-19 ELEVATION A	ENERGY EFFICIENCY – OBC SB12		
	ELEVATION	WALL AREA S.F.	OPENING S.F.	PERCENTAGE
	FRONT	714 S.F.	132.31 S.F.	18.53 %
	LEFT SIDE	1161 S.F.	81.33 S.F.	7.01 %
	RIGHT SIDE	1161 S.F.	74.83 S.F.	6.45 %
	REAR	714 S.F.	153.05 S.F.	21.44 %
	* OPENINGS OMITTED AS PER SB-12 3.1.1.9(4) MAX 19.9 S.F. REFER TO ELEVATION FOR LOCATION		0.00 S.F.	
	TOTAL SQ. FT.	3750.00 S.F.	441.52 S.F.	11.77 %
	TOTAL SQ. M.	348.38 S.M.	41.02 S.M.	11.77 %
UNINSULATED OPENINGS (PER OBC. SB-12,3.1.1(7))				
STANDARD & REAR UPGRADE W/ SIDE DOOR 10' GDN. FL.	S42-19 ELEVATION A	ENERGY EFFICIENCY – OBC SB12		
	ELEVATION	WALL AREA S.F.	OPENING S.F.	PERCENTAGE
	FRONT	714 S.F.	132.31 S.F.	18.53 %
	LEFT SIDE	1161 S.F.	81.33 S.F.	7.01 %
	RIGHT SIDE	1161 S.F.	86.17 S.F.	7.42 %
	REAR	714 S.F.	153.05 S.F.	21.44 %
	* OPENINGS OMITTED AS PER SB-12 3.1.1.9(4) MAX 19.9 S.F. REFER TO ELEVATION FOR LOCATION		0.00 S.F.	
	TOTAL SQ. FT.	3750.00 S.F.	452.86 S.F.	12.08 %
	TOTAL SQ. M.	348.38 S.M.	42.07 S.M.	12.08 %

UNINSULATED OPENINGS (PER OBC. SB-12,3.1.1(7))				
STANDARD & REAR UPGRADE 10' GDN. FL.	S42-19 ELEVATION A -W.O.D.	ENERGY EFFICIENCY - OBC SB12		
	ELEVATION	WALL AREA S.F.	OPENING S.F.	PERCENTAGE
	FRONT	714 S.F.	132.31 S.F.	18.53 %
	LEFT SIDE	1161 S.F.	81.33 S.F.	7.01 %
	RIGHT SIDE	1161 S.F.	74.83 S.F.	6.45 %
	REAR	849 S.F.	175.28 S.F.	20.65 %
	* OPENINGS OMITTED AS PER SB-12 3.1.1.9(4) MAX 19.9 S.F. REFER TO ELEVATION FOR LOCATION		0.00 S.F.	
	TOTAL SQ. FT.	3885.00 S.F.	463.75 S.F.	11.94 %
	TOTAL SQ. M.	360.93 S.M.	43.08 S.M.	11.94 %
UNINSULATED OPENINGS (PER OBC. SB-12,3.1.1(7))				
STANDARD & REAR UPGRADE W/ SIDE DOOR 10' GDN. FL.	S42-19 ELEVATION A -W.O.D.	ENERGY EFFICIENCY - OBC SB12		
	ELEVATION	WALL AREA S.F.	OPENING S.F.	PERCENTAGE
	FRONT	714 S.F.	132.31 S.F.	18.53 %
	LEFT SIDE	1161 S.F.	81.33 S.F.	7.01 %
	RIGHT SIDE	1161 S.F.	86.17 S.F.	7.42 %
	REAR	849 S.F.	175.28 S.F.	20.65 %
	* OPENINGS OMITTED AS PER SB-12 3.1.1.9(4) MAX 19.9 S.F. REFER TO ELEVATION FOR LOCATION		0.00 S.F.	
	TOTAL SQ. FT.	3885.00 S.F.	475.09 S.F.	12.23 %
	TOTAL SQ. M.	360.93 S.M.	44.14 S.M.	12.23 %

UNINSULATED OPENINGS (PER OBC. SB-12,3.1.1(7))				
STANDARD & REAR UPGRADE 10' GDN. FL.	S42-19 ELEVATION A -W.O.B.	ENERGY EFFICIENCY - OBC SB12		
	ELEVATION	WALL AREA S.F.	OPENING S.F.	PERCENTAGE
	FRONT	714 S.F.	132.31 S.F.	18.53 %
	LEFT SIDE	1161 S.F.	81.33 S.F.	7.01 %
	RIGHT SIDE	1161 S.F.	74.83 S.F.	6.45 %
	REAR	959 S.F.	228.44 S.F.	23.82 %
	* OPENINGS OMITTED AS PER SB-12 3.1.1.9(4) MAX 19.9 S.F. REFER TO ELEVATION FOR LOCATION		0.00 S.F.	
	TOTAL SQ. FT.	3995.00 S.F.	516.91 S.F.	12.94 %
	TOTAL SQ. M.	371.14 S.M.	48.02 S.M.	12.94 %
UNINSULATED OPENINGS (PER OBC. SB-12,3.1.1(7))				
STANDARD & REAR UPGRADE W/ SIDE DOOR 10' GDN. FL.	S42-19 ELEVATION A -W.O.B.	ENERGY EFFICIENCY - OBC SB12		
	ELEVATION	WALL AREA S.F.	OPENING S.F.	PERCENTAGE
	FRONT	714 S.F.	132.31 S.F.	18.53 %
	LEFT SIDE	1161 S.F.	81.33 S.F.	7.01 %
	RIGHT SIDE	1161 S.F.	86.17 S.F.	7.42 %
	REAR	959 S.F.	228.44 S.F.	23.82 %
	* OPENINGS OMITTED AS PER SB-12 3.1.1.9(4) MAX 19.9 S.F. REFER TO ELEVATION FOR LOCATION		0.00 S.F.	
	TOTAL SQ. FT.	3995.00 S.F.	528.25 S.F.	13.22 %
	TOTAL SQ. M.	371.14 S.M.	49.08 S.M.	13.22 %

UNINSULATED OPENINGS (PER OBC. SB-12,3.1.1(7))				
STANDARD & REAR UPGRADE 10' GDN. FL.	S42-19 ELEVATION B	ENERGY EFFICIENCY – OBC SB12		
	ELEVATION	WALL AREA S.F.	OPENING S.F.	PERCENTAGE
	FRONT	714 S.F.	124.31 S.F.	17.41 %
	LEFT SIDE	1161 S.F.	81.33 S.F.	7.01 %
	RIGHT SIDE	1161 S.F.	74.83 S.F.	6.45 %
	REAR	714 S.F.	153.05 S.F.	21.44 %
	* OPENINGS OMITTED AS PER SB-12 3.1.1.9(4) MAX 19.9 S.F. REFER TO ELEVATION FOR LOCATION		0.00 S.F.	
	TOTAL SQ. FT.	3750.00 S.F.	433.52 S.F.	11.56 %
	TOTAL SQ. M.	348.38 S.M.	40.27 S.M.	11.56 %
UNINSULATED OPENINGS (PER OBC. SB-12,3.1.1(7))				
STANDARD & REAR UPGRADE W/ SIDE DOOR 10' GDN. FL.	S42-19 ELEVATION B	ENERGY EFFICIENCY – OBC SB12		
	ELEVATION	WALL AREA S.F.	OPENING S.F.	PERCENTAGE
	FRONT	714 S.F.	124.31 S.F.	17.41 %
	LEFT SIDE	1161 S.F.	81.33 S.F.	7.01 %
	RIGHT SIDE	1161 S.F.	86.17 S.F.	7.42 %
	REAR	714 S.F.	153.05 S.F.	21.44 %
	* OPENINGS OMITTED AS PER SB-12 3.1.1.9(4) MAX 19.9 S.F. REFER TO ELEVATION FOR LOCATION		0.00 S.F.	
	TOTAL SQ. FT.	3750.00 S.F.	444.86 S.F.	11.86 %
	TOTAL SQ. M.	348.38 S.M.	41.33 S.M.	11.86 %

UNINSULATED OPENINGS (PER OBC. SB-12,3.1.1(7))				
STANDARD & REAR UPGRADE 10' GDN. FL.	S42-19 ELEVATION B -W.O.D.	ENERGY EFFICIENCY - OBC SB12		
	ELEVATION	WALL AREA S.F.	OPENING S.F.	PERCENTAGE
	FRONT	714 S.F.	124.31 S.F.	17.41 %
	LEFT SIDE	1161 S.F.	81.33 S.F.	7.01 %
	RIGHT SIDE	1161 S.F.	74.83 S.F.	6.45 %
	REAR	849 S.F.	175.28 S.F.	20.65 %
	* OPENINGS OMITTED AS PER SB-12 3.1.1.9(4) MAX 19.9 S.F. REFER TO ELEVATION FOR LOCATION		0.00 S.F.	
	TOTAL SQ. FT.	3885.00 S.F.	455.75 S.F.	11.73 %
	TOTAL SQ. M.	360.93 S.M.	42.34 S.M.	11.73 %
UNINSULATED OPENINGS (PER OBC. SB-12,3.1.1(7))				
STANDARD & REAR UPGRADE W/ SIDE DOOR 10' GDN. FL.	S42-19 ELEVATION B -W.O.D.	ENERGY EFFICIENCY - OBC SB12		
	ELEVATION	WALL AREA S.F.	OPENING S.F.	PERCENTAGE
	FRONT	714 S.F.	124.31 S.F.	17.41 %
	LEFT SIDE	1161 S.F.	81.33 S.F.	7.01 %
	RIGHT SIDE	1161 S.F.	86.17 S.F.	7.42 %
	REAR	849 S.F.	175.28 S.F.	20.65 %
	* OPENINGS OMITTED AS PER SB-12 3.1.1.9(4) MAX 19.9 S.F. REFER TO ELEVATION FOR LOCATION		0.00 S.F.	
	TOTAL SQ. FT.	3885.00 S.F.	467.09 S.F.	12.02 %
	TOTAL SQ. M.	360.93 S.M.	43.39 S.M.	12.02 %

<u>UNINSULATED OPENINGS</u> (PER OBC. SB-12,3.1.1(7))				
STANDARD & REAR UPGRADE 10' GDN. FL.	S42-19 ELEVATION B -W.O.B.	ENERGY EFFICIENCY - OBC SB12		
	ELEVATION	WALL AREA S.F.	OPENING S.F.	PERCENTAGE
	FRONT	714 S.F.	124.31 S.F.	17.41 %
	LEFT SIDE	1161 S.F.	81.33 S.F.	7.01 %
	RIGHT SIDE	1161 S.F.	74.83 S.F.	6.45 %
	REAR	959 S.F.	228.44 S.F.	23.82 %
	* OPENINGS OMITTED AS PER SB-12 3.1.1.9(4) MAX 19.9 S.F. REFER TO ELEVATION FOR LOCATION		0.00 S.F.	
	TOTAL SQ. FT.	3995.00 S.F.	508.91 S.F.	12.74 %
	TOTAL SQ. M.	371.14 S.M.	47.28 S.M.	12.74 %
<u>UNINSULATED OPENINGS</u> (PER OBC. SB-12,3.1.1(7))				
STANDARD & REAR UPGRADE W/ SIDE DOOR 10' GDN. FL.	S42-19 ELEVATION B -W.O.B.	ENERGY EFFICIENCY - OBC SB12		
	ELEVATION	WALL AREA S.F.	OPENING S.F.	PERCENTAGE
	FRONT	714 S.F.	124.31 S.F.	17.41 %
	LEFT SIDE	1161 S.F.	81.33 S.F.	7.01 %
	RIGHT SIDE	1161 S.F.	86.17 S.F.	7.42 %
	REAR	959 S.F.	228.44 S.F.	23.82 %
	* OPENINGS OMITTED AS PER SB-12 3.1.1.9(4) MAX 19.9 S.F. REFER TO ELEVATION FOR LOCATION		0.00 S.F.	
	TOTAL SQ. FT.	3995.00 S.F.	520.25 S.F.	13.02 %
	TOTAL SQ. M.	371.14 S.M.	48.33 S.M.	13.02 %

FOOTING

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<div> <div>BAYVIEW WELLINGTON</div> <div>S42-19</div> </div>			
<div> <div>project name</div> <div>GREEN VALLEY EAST</div> </div>	<div> <div>municipality</div> <div>BRADFORD, ONTARIO</div> </div>	<div> <div>project no.</div> <div>16023</div> </div>	
<div> <div>date</div> <div>OCTOBER 2021</div> </div>	<div> <div>checked by</div> <div>JWM</div> </div>	<div> <div>scale</div> <div>3/16" = 1'-0"</div> </div>	<div> <div>SB-12 CHARTS</div> <div>file name</div> <div>16023-S42-19</div> </div>
<div> <div>drawn by</div> <div>TP</div> </div>	<div> <div>drawing no.</div> <div>57</div> </div>		
<div> <div>RICHARD</div> <div>— I:\ARCHIVE\WORKING\2016\16023-BW\Units\42\16023-S42-19.dwg</div> <div>— Tue — Mar 8 2022 — 1:01 PM</div> </div>			

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UNINSULATED OPENINGS (PER OBC. SB-12,3.1.1(7))					
STANDARD 10' GDN. FL.	S42-19 ELEVATION C	ENERGY EFFICIENCY – OBC SB12			
	ELEVATION	WALL AREA S.F.	OPENING S.F.	PERCENTAGE	
	FRONT	714 S.F.	179.81 S.F.	25.18 %	
	LEFT SIDE	1161 S.F.	108.17 S.F.	9.32 %	
	RIGHT SIDE	1161 S.F.	86.50 S.F.	7.45 %	
	REAR	714 S.F.	153.05 S.F.	21.44 %	
	* OPENINGS OMITTED AS PER SB-12 3.1.1.9(4) MAX 19.9 S.F. REFER TO ELEVATION FOR LOCATION		0.00 S.F.		
	TOTAL SQ. FT.	3750.00 S.F.	527.53 S.F.	14.07 %	
TOTAL SQ. M.	348.38 S.M.	49.01 S.M.	14.07 %		
UNINSULATED OPENINGS (PER OBC. SB-12,3.1.1(7))					
STANDARD W/ SIDE DOOR 10' GDN. FL.	S42-19 ELEVATION C	ENERGY EFFICIENCY – OBC SB12			
	ELEVATION	WALL AREA S.F.	OPENING S.F.	PERCENTAGE	
	FRONT	714 S.F.	179.81 S.F.	25.18 %	
	LEFT SIDE	1161 S.F.	108.17 S.F.	9.32 %	
	RIGHT SIDE	1161 S.F.	97.83 S.F.	8.43 %	
	REAR	714 S.F.	153.05 S.F.	21.44 %	
	* OPENINGS OMITTED AS PER SB-12 3.1.1.9(4) MAX 19.9 S.F. REFER TO ELEVATION FOR LOCATION		0.00 S.F.		
	TOTAL SQ. FT.	3750.00 S.F.	538.86 S.F.	14.37 %	
TOTAL SQ. M.	348.38 S.M.	50.06 S.M.	14.37 %		

<u>UNINSULATED OPENINGS</u> (PER OBC. SB-12,3.1.1(7))									
STANDARD 10' GDN. FL.	S42-19 ELEVATION C -W.O.D.	ENERGY EFFICIENCY - OBC SB12							
	ELEVATION	WALL	AREA	S.F.	OPENING	S.F.	PERCENTAGE		
	FRONT	714		S.F.	179.81		S.F.	25.18 %	
	LEFT SIDE	1161		S.F.	108.17		S.F.	9.32 %	
	RIGHT SIDE	1161		S.F.	86.50		S.F.	7.45 %	
	REAR	849		S.F.	175.28		S.F.	20.65 %	
	* OPENINGS OMITTED AS PER SB-12 3.1.1.9(4) MAX 19.9 S.F. REFER TO ELEVATION FOR LOCATION					0.00		S.F.	
	TOTAL SQ. FT.	3885.00		S.F.	549.76		S.F.	14.15 %	
	TOTAL SQ. M.	360.93		S.M.	51.07		S.M.	14.15 %	
<u>UNINSULATED OPENINGS</u> (PER OBC. SB-12,3.1.1(7))									
STANDARD W/ SIDE DOOR 10' GDN. FL.	S42-19 ELEVATION C -W.O.D.	ENERGY EFFICIENCY - OBC SB12							
	ELEVATION	WALL	AREA	S.F.	OPENING	S.F.	PERCENTAGE		
	FRONT	714		S.F.	179.81		S.F.	25.18 %	
	LEFT SIDE	1161		S.F.	108.17		S.F.	9.32 %	
	RIGHT SIDE	1161		S.F.	97.83		S.F.	8.43 %	
	REAR	849		S.F.	175.28		S.F.	20.65 %	
	* OPENINGS OMITTED AS PER SB-12 3.1.1.9(4) MAX 19.9 S.F. REFER TO ELEVATION FOR LOCATION					0.00		S.F.	
	TOTAL SQ. FT.	3885.00		S.F.	561.09		S.F.	14.44 %	
	TOTAL SQ. M.	360.93		S.M.	52.13		S.M.	14.44 %	

<u>UNINSULATED OPENINGS</u> (PER OBC. SB-12,3.1.1(7))				
STANDARD 10' GDN. FL.	S42-19 ELEVATION C -W.O.B.	ENERGY EFFICIENCY - OBC SB12		
	ELEVATION	WALL AREA S.F.	OPENING S.F.	PERCENTAGE
	FRONT	714 S.F.	179.81 S.F.	25.18 %
	LEFT SIDE	1161 S.F.	108.17 S.F.	9.32 %
	RIGHT SIDE	1161 S.F.	86.50 S.F.	7.45 %
	REAR	959 S.F.	228.44 S.F.	23.82 %
	* OPENINGS OMITTED AS PER SB-12 3.1.1.9(4) MAX 19.9 S.F. REFER TO ELEVATION FOR LOCATION		0.00 S.F.	
	TOTAL SQ. FT.	3995.00 S.F.	602.92 S.F.	15.09 %
TOTAL SQ. M.	371.14 S.M.	56.01 S.M.	15.09 %	
<u>UNINSULATED OPENINGS</u> (PER OBC. SB-12,3.1.1(7))				
STANDARD W/ SIDE DOOR 10' GDN. FL.	S42-19 ELEVATION C -W.O.B.	ENERGY EFFICIENCY - OBC SB12		
	ELEVATION	WALL AREA S.F.	OPENING S.F.	PERCENTAGE
	FRONT	714 S.F.	179.81 S.F.	25.18 %
	LEFT SIDE	1161 S.F.	108.17 S.F.	9.32 %
	RIGHT SIDE	1161 S.F.	97.83 S.F.	8.43 %
	REAR	959 S.F.	228.44 S.F.	23.82 %
	* OPENINGS OMITTED AS PER SB-12 3.1.1.9(4) MAX 19.9 S.F. REFER TO ELEVATION FOR LOCATION		0.00 S.F.	
	TOTAL SQ. FT.	3995.00 S.F.	614.25 S.F.	15.38 %
TOTAL SQ. M.	371.14 S.M.	57.07 S.M.	15.38 %	

UNINSULATED OPENINGS (PER OBC. SB-12,3.1.1(7))					
REAR UPGRADE 10' GDN. FL.	S42-19 ELEVATION C	ENERGY EFFICIENCY – OBC SB12			
	ELEVATION	WALL	AREA S.F.	OPENING S.F.	PERCENTAGE
	FRONT	714 S.F.		179.81 S.F.	25.18 %
	LEFT SIDE	1161 S.F.		108.17 S.F.	9.32 %
	RIGHT SIDE	1161 S.F.		86.50 S.F.	7.45 %
	REAR	714 S.F.		176.05 S.F.	24.66 %
	* OPENINGS OMITTED AS PER SB-12 3.1.1.9(4) MAX 19.9 S.F. REFER TO ELEVATION FOR LOCATION			0.00 S.F.	
	TOTAL SQ. FT.	3750.00 S.F.		550.53 S.F.	14.68 %
TOTAL SQ. M.	348.38 S.M.		51.15 S.M.	14.68 %	
UNINSULATED OPENINGS (PER OBC. SB-12,3.1.1(7))					
REAR UPGRADE W/ SIDE DOOR 10' GDN. FL.	S42-19 ELEVATION C	ENERGY EFFICIENCY – OBC SB12			
	ELEVATION	WALL	AREA S.F.	OPENING S.F.	PERCENTAGE
	FRONT	714 S.F.		179.81 S.F.	25.18 %
	LEFT SIDE	1161 S.F.		108.17 S.F.	9.32 %
	RIGHT SIDE	1161 S.F.		97.83 S.F.	8.43 %
	REAR	714 S.F.		176.05 S.F.	24.66 %
	* OPENINGS OMITTED AS PER SB-12 3.1.1.9(4) MAX 19.9 S.F. REFER TO ELEVATION FOR LOCATION			0.00 S.F.	
	TOTAL SQ. FT.	3750.00 S.F.		561.86 S.F.	14.98 %
TOTAL SQ. M.	348.38 S.M.		52.20 S.M.	14.98 %	

UNINSULATED OPENINGS (PER OBC. SB-12,3.1.1(7))								
REAR UPGRADE 10' GDN. FL.	S42-19 ELEVATION C -W.O.D.	ENERGY EFFICIENCY - OBC SB12						
	ELEVATION	WALL	AREA	S.F.	OPENING	S.F.	PERCENTAGE	
	FRONT	714		S.F.	179.81		S.F.	25.18 %
	LEFT SIDE	1161		S.F.	108.17		S.F.	9.32 %
	RIGHT SIDE	1161		S.F.	86.50		S.F.	7.45 %
	REAR	849		S.F.	200.50		S.F.	23.62 %
	* OPENINGS OMITTED AS PER SB-12 3.1.1.9(4) MAX 19.9 S.F. REFER TO ELEVATION FOR LOCATION			0.00		S.F.		
	TOTAL SQ. FT.	3885.00		S.F.	574.98		S.F.	14.80 %
TOTAL SQ. M.	360.93		S.M.	53.42		S.M.	14.80 %	
UNINSULATED OPENINGS (PER OBC. SB-12,3.1.1(7))								
REAR UPGRADE W/ SIDE DOOR 10' GDN. FL.	S42-19 ELEVATION C -W.O.D.	ENERGY EFFICIENCY - OBC SB12						
	ELEVATION	WALL	AREA	S.F.	OPENING	S.F.	PERCENTAGE	
	FRONT	714		S.F.	179.81		S.F.	25.18 %
	LEFT SIDE	1161		S.F.	108.17		S.F.	9.32 %
	RIGHT SIDE	1161		S.F.	97.83		S.F.	8.43 %
	REAR	849		S.F.	200.50		S.F.	23.62 %
	* OPENINGS OMITTED AS PER SB-12 3.1.1.9(4) MAX 19.9 S.F. REFER TO ELEVATION FOR LOCATION			0.00		S.F.		
	TOTAL SQ. FT.	3885.00		S.F.	586.31		S.F.	15.09 %
TOTAL SQ. M.	360.93		S.M.	54.47		S.M.	15.09 %	

UNINSULATED OPENINGS (PER OBC. SB-12,3.1.1(7))					
REAR UPGRADE 10' GDN. FL.	S42-19 ELEVATION C -W.O.B.	ENERGY EFFICIENCY - OBC SB12			
	ELEVATION	WALL AREA S.F.	OPENING S.F.	PERCENTAGE	
	FRONT	714 S.F.	179.81 S.F.	25.18 %	
	LEFT SIDE	1161 S.F.	108.17 S.F.	9.32 %	
	RIGHT SIDE	1161 S.F.	86.50 S.F.	7.45 %	
	REAR	959 S.F.	254.78 S.F.	26.57 %	
	* OPENINGS OMITTED AS PER SB-12 3.1.1.9(4) MAX 19.9 S.F. REFER TO ELEVATION FOR LOCATION		0.00 S.F.		
	TOTAL SQ. FT.	3995.00 S.F.	629.26 S.F.	15.75 %	
TOTAL SQ. M.	371.14 S.M.	58.46 S.M.	15.75 %		
UNINSULATED OPENINGS (PER OBC. SB-12,3.1.1(7))					
REAR UPGRADE W/ SIDE DOOR 10' GDN. FL.	S42-19 ELEVATION C -W.O.B.	ENERGY EFFICIENCY - OBC SB12			
	ELEVATION	WALL AREA S.F.	OPENING S.F.	PERCENTAGE	
	FRONT	714 S.F.	179.81 S.F.	25.18 %	
	LEFT SIDE	1161 S.F.	108.17 S.F.	9.32 %	
	RIGHT SIDE	1161 S.F.	97.83 S.F.	8.43 %	
	REAR	959 S.F.	254.78 S.F.	26.57 %	
	* OPENINGS OMITTED AS PER SB-12 3.1.1.9(4) MAX 19.9 S.F. REFER TO ELEVATION FOR LOCATION		0.00 S.F.		
	TOTAL SQ. FT.	3995.00 S.F.	640.59 S.F.	16.03 %	
TOTAL SQ. M.	371.14 S.M.	59.51 S.M.	16.03 %		

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<u>UNINSULATED OPENINGS</u> (PER OBC. SB-12,3.1.1(7))				
STANDARD & REAR UPGRADE 10' GDN. FL. & 9' BASEMENT	S42-19 ELEVATION A -W.O.B.	ENERGY EFFICIENCY - OBC SB12		
	ELEVATION	WALL AREA S.F.	OPENING S.F.	PERCENTAGE
	FRONT	714 S.F.	132.31 S.F.	18.53 %
	LEFT SIDE	1161 S.F.	81.33 S.F.	7.01 %
	RIGHT SIDE	1161 S.F.	74.83 S.F.	6.45 %
	REAR	993 S.F.	228.44 S.F.	23.01 %
	* OPENINGS OMITTED AS PER SB-12 3.1.1.9(4) MAX 19.9 S.F. REFER TO ELEVATION FOR LOCATION		0.00 S.F.	
	TOTAL SQ. FT.	4029.00 S.F.	516.91 S.F.	12.83 %
TOTAL SQ. M.	374.30 S.M.	48.02 S.M.	12.83 %	
<u>UNINSULATED OPENINGS</u> (PER OBC. SB-12,3.1.1(7))				
STANDARD & REAR UPGRADE W/ SIDE DOOR 10' GDN. FL. & 9' BASEMENT	S42-19 ELEVATION A -W.O.B.	ENERGY EFFICIENCY - OBC SB12		
	ELEVATION	WALL AREA S.F.	OPENING S.F.	PERCENTAGE
	FRONT	714 S.F.	132.31 S.F.	18.53 %
	LEFT SIDE	1161 S.F.	81.33 S.F.	7.01 %
	RIGHT SIDE	1161 S.F.	86.17 S.F.	7.42 %
	REAR	993 S.F.	228.44 S.F.	23.01 %
	* OPENINGS OMITTED AS PER SB-12 3.1.1.9(4) MAX 19.9 S.F. REFER TO ELEVATION FOR LOCATION		0.00 S.F.	
	TOTAL SQ. FT.	4029.00 S.F.	528.25 S.F.	13.11 %
TOTAL SQ. M.	374.30 S.M.	49.08 S.M.	13.11 %	

UNINSULATED OPENINGS (PER OBC. SB-12,3.1.1(7))				
STANDARD & REAR UPGRADE 10' GDN. FL. & 9' BASEMENT	S42-19 ELEVATION B -W.O.B.	ENERGY EFFICIENCY - OBC SB12		
	ELEVATION	WALL AREA S.F.	OPENING S.F.	PERCENTAGE
	FRONT	714 S.F.	124.31 S.F.	17.41 %
	LEFT SIDE	1161 S.F.	81.33 S.F.	7.01 %
	RIGHT SIDE	1161 S.F.	74.83 S.F.	6.45 %
	REAR	993 S.F.	228.44 S.F.	23.01 %
	* OPENINGS OMITTED AS PER SB-12 3.1.1.9(4) MAX 19.9 S.F. REFER TO ELEVATION FOR LOCATION		0.00 S.F.	
	TOTAL SQ. FT.	4029.00 S.F.	508.91 S.F.	12.63 %
	TOTAL SQ. M.	374.30 S.M.	47.28 S.M.	12.63 %
UNINSULATED OPENINGS (PER OBC. SB-12,3.1.1(7))				
STANDARD & REAR UPGRADE W/ SIDE DOOR 10' GDN. FL. & 9' BASEMENT	S42-19 ELEVATION B -W.O.B.	ENERGY EFFICIENCY - OBC SB12		
	ELEVATION	WALL AREA S.F.	OPENING S.F.	PERCENTAGE
	FRONT	714 S.F.	124.31 S.F.	17.41 %
	LEFT SIDE	1161 S.F.	81.33 S.F.	7.01 %
	RIGHT SIDE	1161 S.F.	86.17 S.F.	7.42 %
	REAR	993 S.F.	228.44 S.F.	23.01 %
	* OPENINGS OMITTED AS PER SB-12 3.1.1.9(4) MAX 19.9 S.F. REFER TO ELEVATION FOR LOCATION		0.00 S.F.	
	TOTAL SQ. FT.	4029.00 S.F.	520.25 S.F.	12.91 %
	TOTAL SQ. M.	374.30 S.M.	48.33 S.M.	12.91 %

UNINSULATED OPENINGS (PER OBC. SB-12,3.1.1(7))				
STANDARD 10' GDN. FL. & 9' BASEMENT	S42-19 ELEVATION C -W.O.B.		ENERGY EFFICIENCY - OBC SB12	
	ELEVATION	WALL AREA S.F.	OPENING S.F.	PERCENTAGE
	FRONT	714 S.F.	179.81 S.F.	25.18 %
	LEFT SIDE	1161 S.F.	108.17 S.F.	9.32 %
	RIGHT SIDE	1161 S.F.	86.50 S.F.	7.45 %
	REAR	993 S.F.	228.44 S.F.	23.01 %
	* OPENINGS OMITTED AS PER SB-12 3.1.1.9(4) MAX 19.9 S.F. REFER TO ELEVATION FOR LOCATION		0.00 S.F.	
	TOTAL SQ. FT.	4029.00 S.F.	602.92 S.F.	14.96 %
TOTAL SQ. M.	374.30 S.M.	56.01 S.M.	14.96 %	
UNINSULATED OPENINGS (PER OBC. SB-12,3.1.1(7))				
STANDARD W/ SIDE DOOR 10' GDN. FL. & 9' BASEMENT	S42-19 ELEVATION C -W.O.B.		ENERGY EFFICIENCY - OBC SB12	
	ELEVATION	WALL AREA S.F.	OPENING S.F.	PERCENTAGE
	FRONT	714 S.F.	179.81 S.F.	25.18 %
	LEFT SIDE	1161 S.F.	108.17 S.F.	9.32 %
	RIGHT SIDE	1161 S.F.	97.83 S.F.	8.43 %
	REAR	993 S.F.	228.44 S.F.	23.01 %
	* OPENINGS OMITTED AS PER SB-12 3.1.1.9(4) MAX 19.9 S.F. REFER TO ELEVATION FOR LOCATION		0.00 S.F.	
	TOTAL SQ. FT.	4029.00 S.F.	614.25 S.F.	15.25 %
	TOTAL SQ. M.	374.30 S.M.	57.07 S.M.	15.25 %

UNINSULATED OPENINGS (PER OBC. SB-12,3.1.1(7))				
REAR UPGRADE 10' GDN. FL. & 9' BASEMENT	S42-19 ELEVATION C -W.O.B.	ENERGY EFFICIENCY - OBC SB12		
	ELEVATION	WALL AREA S.F.	OPENING S.F.	PERCENTAGE
	FRONT	714 S.F.	179.81 S.F.	25.18 %
	LEFT SIDE	1161 S.F.	108.17 S.F.	9.32 %
	RIGHT SIDE	1161 S.F.	86.50 S.F.	7.45 %
	REAR	993 S.F.	254.78 S.F.	25.66 %
	* OPENINGS OMITTED AS PER SB-12 3.1.1.9(4) MAX 19.9 S.F. REFER TO ELEVATION FOR LOCATION		0.00 S.F.	
	TOTAL SQ. FT.	4029.00 S.F.	629.26 S.F.	15.62 %
TOTAL SQ. M.	374.30 S.M.	58.46 S.M.	15.62 %	
UNINSULATED OPENINGS (PER OBC. SB-12,3.1.1(7))				
REAR UPGRADE W/ SIDE DOOR 10' GDN. FL. & 9' BASEMENT	S42-19 ELEVATION C -W.O.B.	ENERGY EFFICIENCY - OBC SB12		
	ELEVATION	WALL AREA S.F.	OPENING S.F.	PERCENTAGE
	FRONT	714 S.F.	179.81 S.F.	25.18 %
	LEFT SIDE	1161 S.F.	108.17 S.F.	9.32 %
	RIGHT SIDE	1161 S.F.	97.83 S.F.	8.43 %
	REAR	993 S.F.	254.78 S.F.	25.66 %
	* OPENINGS OMITTED AS PER SB-12 3.1.1.9(4) MAX 19.9 S.F. REFER TO ELEVATION FOR LOCATION		0.00 S.F.	
	TOTAL SQ. FT.	4029.00 S.F.	640.59 S.F.	15.90 %
TOTAL SQ. M.	374.30 S.M.	59.51 S.M.	15.90 %	

GROUND, 9th BASEMENT

[illegible]

UNINSULATED OPENINGS (PER OBC. SB-12,3.1.1(7))				
STANDARD 10' GDN. FL. & 9' SEC. FL.	S42-19 ELEVATION C	ENERGY EFFICIENCY – OBC SB12		
	ELEVATION	WALL AREA S.F.	OPENING S.F.	PERCENTAGE
	FRONT	748 S.F.	179.81 S.F.	24.04 %
	LEFT SIDE	1215 S.F.	108.17 S.F.	8.90 %
	RIGHT SIDE	1215 S.F.	86.50 S.F.	7.12 %
	REAR	748 S.F.	153.05 S.F.	20.46 %
	* OPENINGS OMITTED AS PER SB-12 3.1.1.9(4) MAX 19.9 S.F. REFER TO ELEVATION FOR LOCATION		0.00 S.F.	
	TOTAL SQ. FT.	3926.00 S.F.	527.53 S.F.	13.44 %
	TOTAL SQ. M.	364.73 S.M.	49.01 S.M.	13.44 %
UNINSULATED OPENINGS (PER OBC. SB-12,3.1.1(7))				
STANDARD W/ SIDE DOOR 10' GDN. FL. & 9' SEC. FL.	S42-19 ELEVATION C	ENERGY EFFICIENCY – OBC SB12		
	ELEVATION	WALL AREA S.F.	OPENING S.F.	PERCENTAGE
	FRONT	748 S.F.	179.81 S.F.	24.04 %
	LEFT SIDE	1215 S.F.	108.17 S.F.	8.90 %
	RIGHT SIDE	1215 S.F.	97.83 S.F.	8.05 %
	REAR	748 S.F.	153.05 S.F.	20.46 %
	* OPENINGS OMITTED AS PER SB-12 3.1.1.9(4) MAX 19.9 S.F. REFER TO ELEVATION FOR LOCATION		0.00 S.F.	
	TOTAL SQ. FT.	3926.00 S.F.	538.86 S.F.	13.73 %
	TOTAL SQ. M.	364.73 S.M.	50.06 S.M.	13.73 %

UNINSULATED OPENINGS (PER OBC. SB-12,3.1.1(7))				
STANDARD 10' GDN. FL. & 9' SEC. FL.	S42-19 ELEVATION C -W.O.D.	ENERGY EFFICIENCY – OBC SB12		
	ELEVATION	WALL AREA S.F.	OPENING S.F.	PERCENTAGE
	FRONT	748 S.F.	179.81 S.F.	24.04 %
	LEFT SIDE	1215 S.F.	108.17 S.F.	8.90 %
	RIGHT SIDE	1215 S.F.	86.50 S.F.	7.12 %
	REAR	883 S.F.	175.28 S.F.	19.85 %
	* OPENINGS OMITTED AS PER SB-12 3.1.1.9(4) MAX 19.9 S.F. REFER TO ELEVATION FOR LOCATION		0.00 S.F.	
	TOTAL SQ. FT.	4061.00 S.F.	549.76 S.F.	13.54 %
	TOTAL SQ. M.	377.28 S.M.	51.07 S.M.	13.54 %
UNINSULATED OPENINGS (PER OBC. SB-12,3.1.1(7))				
STANDARD W/ SIDE DOOR 10' GDN. FL. & 9' SEC. FL.	S42-19 ELEVATION C -W.O.D.	ENERGY EFFICIENCY – OBC SB12		
	ELEVATION	WALL AREA S.F.	OPENING S.F.	PERCENTAGE
	FRONT	748 S.F.	179.81 S.F.	24.04 %
	LEFT SIDE	1215 S.F.	108.17 S.F.	8.90 %
	RIGHT SIDE	1215 S.F.	97.83 S.F.	8.05 %
	REAR	883 S.F.	175.28 S.F.	19.85 %
	* OPENINGS OMITTED AS PER SB-12 3.1.1.9(4) MAX 19.9 S.F. REFER TO ELEVATION FOR LOCATION		0.00 S.F.	
	TOTAL SQ. FT.	4061.00 S.F.	561.09 S.F.	13.82 %
	TOTAL SQ. M.	377.28 S.M.	52.13 S.M.	13.82 %

UNINSULATED OPENINGS (PER OBC. SB-12,3.1.1(7))				
STANDARD 10' GDN. FL. & 9' SEC. FL.	S42-19 ELEVATION C -W.O.B.	ENERGY EFFICIENCY – OBC SB12		
	ELEVATION	WALL AREA S.F.	OPENING S.F.	PERCENTAGE
	FRONT	748 S.F.	179.81 S.F.	24.04 %
	LEFT SIDE	1215 S.F.	108.17 S.F.	8.90 %
	RIGHT SIDE	1215 S.F.	86.50 S.F.	7.12 %
	REAR	993 S.F.	228.44 S.F.	23.01 %
	* OPENINGS OMITTED AS PER SB-12 3.1.1.9(4) MAX 19.9 S.F. REFER TO ELEVATION FOR LOCATION		0.00 S.F.	
	TOTAL SQ. FT.	4171.00 S.F.	602.92 S.F.	14.46 %
TOTAL SQ. M.	387.50 S.M.	56.01 S.M.	14.46 %	
UNINSULATED OPENINGS (PER OBC. SB-12,3.1.1(7))				
STANDARD W/ SIDE DOOR 10' GDN. FL. & 9' SEC. FL.	S42-19 ELEVATION C -W.O.B.	ENERGY EFFICIENCY – OBC SB12		
	ELEVATION	WALL AREA S.F.	OPENING S.F.	PERCENTAGE
	FRONT	748 S.F.	179.81 S.F.	24.04 %
	LEFT SIDE	1215 S.F.	108.17 S.F.	8.90 %
	RIGHT SIDE	1215 S.F.	97.83 S.F.	8.05 %
	REAR	993 S.F.	228.44 S.F.	23.01 %
	* OPENINGS OMITTED AS PER SB-12 3.1.1.9(4) MAX 19.9 S.F. REFER TO ELEVATION FOR LOCATION		0.00 S.F.	
	TOTAL SQ. FT.	4171.00 S.F.	614.25 S.F.	14.73 %
TOTAL SQ. M.	387.50 S.M.	57.07 S.M.	14.73 %	

UNINSULATED OPENINGS (PER OBC. SB-12,3.1.1(7))				
REAR UPGRADE 10' GDN. FL. & 9' SEC. FL.	S42-19 ELEVATION C	ENERGY EFFICIENCY – OBC SB12		
	ELEVATION	WALL AREA S.F.	OPENING S.F.	PERCENTAGE
	FRONT	748 S.F.	179.81 S.F.	24.04 %
	LEFT SIDE	1215 S.F.	108.17 S.F.	8.90 %
	RIGHT SIDE	1215 S.F.	86.50 S.F.	7.12 %
	REAR	748 S.F.	176.05 S.F.	23.54 %
	* OPENINGS OMITTED AS PER SB-12 3.1.1.9(4) MAX 19.9 S.F. REFER TO ELEVATION FOR LOCATION		0.00 S.F.	
	TOTAL SQ. FT.	3926.00 S.F.	550.53 S.F.	14.02 %
TOTAL SQ. M.	364.73 S.M.	51.15 S.M.	14.02 %	
UNINSULATED OPENINGS (PER OBC. SB-12,3.1.1(7))				
REAR UPGRADE W/ SIDE DOOR 10' GDN. FL. & 9' SEC. FL.	S42-19 ELEVATION C	ENERGY EFFICIENCY – OBC SB12		
	ELEVATION	WALL AREA S.F.	OPENING S.F.	PERCENTAGE
	FRONT	748 S.F.	179.81 S.F.	24.04 %
	LEFT SIDE	1215 S.F.	108.17 S.F.	8.90 %
	RIGHT SIDE	1215 S.F.	97.83 S.F.	8.05 %
	REAR	748 S.F.	176.05 S.F.	23.54 %
	* OPENINGS OMITTED AS PER SB-12 3.1.1.9(4) MAX 19.9 S.F. REFER TO ELEVATION FOR LOCATION		0.00 S.F.	
	TOTAL SQ. FT.	3926.00 S.F.	561.86 S.F.	14.31 %
TOTAL SQ. M.	364.73 S.M.	52.20 S.M.	14.31 %	

UNINSULATED OPENINGS (PER OBC. SB-12,3.1.1(7))				
REAR UPGRADE 10' GDN. FL. & 9' SEC. FL.	S42-19 ELEVATION C -W.O.D.	ENERGY EFFICIENCY - OBC SB12		
	ELEVATION	WALL AREA S.F.	OPENING S.F.	PERCENTAGE
	FRONT	748 S.F.	179.81 S.F.	24.04 %
	LEFT SIDE	1215 S.F.	108.17 S.F.	8.90 %
	RIGHT SIDE	1215 S.F.	86.50 S.F.	7.12 %
	REAR	883 S.F.	200.50 S.F.	22.71 %
	* OPENINGS OMITTED AS PER SB-12 3.1.1.9(4) MAX 19.9 S.F. REFER TO ELEVATION FOR LOCATION		0.00 S.F.	
	TOTAL SQ. FT.	4061.00 S.F.	574.98 S.F.	14.16 %
	TOTAL SQ. M.	377.28 S.M.	53.42 S.M.	14.16 %
UNINSULATED OPENINGS (PER OBC. SB-12,3.1.1(7))				
REAR UPGRADE W/ SIDE DOOR 10' GDN. FL. & 9' SEC. FL.	S42-19 ELEVATION C -W.O.D.	ENERGY EFFICIENCY - OBC SB12		
	ELEVATION	WALL AREA S.F.	OPENING S.F.	PERCENTAGE
	FRONT	748 S.F.	179.81 S.F.	24.04 %
	LEFT SIDE	1215 S.F.	108.17 S.F.	8.90 %
	RIGHT SIDE	1215 S.F.	97.83 S.F.	8.05 %
	REAR	883 S.F.	200.50 S.F.	22.71 %
	* OPENINGS OMITTED AS PER SB-12 3.1.1.9(4) MAX 19.9 S.F. REFER TO ELEVATION FOR LOCATION		0.00 S.F.	
	TOTAL SQ. FT.	4061.00 S.F.	586.31 S.F.	14.44 %
	TOTAL SQ. M.	377.28 S.M.	54.47 S.M.	14.44 %

UNINSULATED OPENINGS (PER OBC. SB-12,3.1.1(7))				
REAR UPGRADE 10' GDN. FL. & 9' SEC. FL.	S42-19 ELEVATION C -W.O.B.	ENERGY EFFICIENCY - OBC SB12		
	ELEVATION	WALL AREA S.F.	OPENING S.F.	PERCENTAGE
	FRONT	748 S.F.	179.81 S.F.	24.04 %
	LEFT SIDE	1215 S.F.	108.17 S.F.	8.90 %
	RIGHT SIDE	1215 S.F.	86.50 S.F.	7.12 %
	REAR	993 S.F.	254.78 S.F.	25.66 %
	* OPENINGS OMITTED AS PER SB-12 3.1.1.9(4) MAX 19.9 S.F. REFER TO ELEVATION FOR LOCATION		0.00 S.F.	
	TOTAL SQ. FT.	4171.00 S.F.	629.26 S.F.	15.09 %
TOTAL SQ. M.	387.50 S.M.	58.46 S.M.	15.09 %	
UNINSULATED OPENINGS (PER OBC. SB-12,3.1.1(7))				
REAR UPGRADE W/ SIDE DOOR 10' GDN. FL. & 9' SEC. FL.	S42-19 ELEVATION C -W.O.B.	ENERGY EFFICIENCY - OBC SB12		
	ELEVATION	WALL AREA S.F.	OPENING S.F.	PERCENTAGE
	FRONT	748 S.F.	179.81 S.F.	24.04 %
	LEFT SIDE	1215 S.F.	108.17 S.F.	8.90 %
	RIGHT SIDE	1215 S.F.	97.83 S.F.	8.05 %
	REAR	993 S.F.	254.78 S.F.	25.66 %
	* OPENINGS OMITTED AS PER SB-12 3.1.1.9(4) MAX 19.9 S.F. REFER TO ELEVATION FOR LOCATION		0.00 S.F.	
	TOTAL SQ. FT.	4171.00 S.F.	640.59 S.F.	15.36 %
TOTAL SQ. M.	387.50 S.M.	59.51 S.M.	15.36 %	

SECOND GROUND

9	.	.	.	The undersigned has reviewed and takes responsibility for this design and has the qualifications and meets the requirements set out in the Ontario Building Code to be a Designer.
8	.	.	.	qualification information
7	.	.	.	Wellington Jno-Baptiste 25591
6	.	.	.	name
5	.	.	.	BCIN
4	.	.	.	signature
3	REVISED AS PER ENG COMMENTS	MAR 03-22	RC	registration information
2	REVISED AS PER FLOOR / ROOF LAYOUT	FEB 24-22	RC	VA3 Design Inc. 42658
1	ISSUED FOR CLIENT REVIEW	NOV 26-21	VA3	Contractor must verify all dimensions on the job and report any discrepancy to the Designer before proceeding with the work. All drawings and specifications are instruments of service and the property of the Designer which must be returned at the completion of the work. Drawings are not to be scaled.
no.	description	date	by	

UNINSULATED OPENINGS (PER OBC. SB-12,3.1.1(7))				
STANDARD & REAR UPGRADE 10' GDN. FL., 9' SEC. FL. & 9' BASEMENT	S42-19 ELEVATION A -W.O.B.	ENERGY EFFICIENCY – OBC SB12		
	ELEVATION	WALL AREA S.F.	OPENING S.F.	PERCENTAGE
	FRONT	748 S.F.	132.31 S.F.	17.69 %
	LEFT SIDE	1215 S.F.	81.33 S.F.	6.69 %
	RIGHT SIDE	1215 S.F.	74.83 S.F.	6.16 %
	REAR	1026 S.F.	228.44 S.F.	22.27 %
	* OPENINGS OMITTED AS PER SB-12 3.1.1.9(4) MAX 19.9 S.F. REFER TO ELEVATION FOR LOCATION		0.00 S.F.	
	TOTAL SQ. FT.	4204.00 S.F.	516.91 S.F.	12.30 %
TOTAL SQ. M.	390.56 S.M.	48.02 S.M.	12.30 %	
UNINSULATED OPENINGS (PER OBC. SB-12,3.1.1(7))				
STANDARD & REAR UPGRADE W/ SIDE DOOR 10' GDN. FL., 9' SEC. FL. & 9' BASEMENT	S42-19 ELEVATION A -W.O.B.	ENERGY EFFICIENCY – OBC SB12		
	ELEVATION	WALL AREA S.F.	OPENING S.F.	PERCENTAGE
	FRONT	748 S.F.	132.31 S.F.	17.69 %
	LEFT SIDE	1215 S.F.	81.33 S.F.	6.69 %
	RIGHT SIDE	1215 S.F.	86.17 S.F.	7.09 %
	REAR	1026 S.F.	228.44 S.F.	22.27 %
	* OPENINGS OMITTED AS PER SB-12 3.1.1.9(4) MAX 19.9 S.F. REFER TO ELEVATION FOR LOCATION		0.00 S.F.	
	TOTAL SQ. FT.	4204.00 S.F.	528.25 S.F.	12.57 %
TOTAL SQ. M.	390.56 S.M.	49.08 S.M.	12.57 %	

<u>UNINSULATED OPENINGS</u> (PER OBC. SB-12,3.1.1(7))				
STANDARD & REAR UPGRADE 10' GDN. FL., 9' SEC. FL. & 9' BASEMENT	S42-19 ELEVATION B -W.O.B.	ENERGY EFFICIENCY – OBC SB12		
	ELEVATION	WALL AREA S.F.	OPENING S.F.	PERCENTAGE
	FRONT	748 S.F.	124.31 S.F.	16.62 %
	LEFT SIDE	1215 S.F.	81.33 S.F.	6.69 %
	RIGHT SIDE	1215 S.F.	74.83 S.F.	6.16 %
	REAR	1026 S.F.	228.44 S.F.	22.27 %
	* OPENINGS OMITTED AS PER SB-12 3.1.1.9(4) MAX 19.9 S.F. REFER TO ELEVATION FOR LOCATION		0.00 S.F.	
	TOTAL SQ. FT.	4204.00 S.F.	508.91 S.F.	12.11 %
TOTAL SQ. M.	390.56 S.M.	47.28 S.M.	12.11 %	
<u>UNINSULATED OPENINGS</u> (PER OBC. SB-12,3.1.1(7))				
STANDARD & REAR UPGRADE W/ SIDE DOOR 10' GDN. FL., 9' SEC. FL. & 9' BASEMENT	S42-19 ELEVATION B -W.O.B.	ENERGY EFFICIENCY – OBC SB12		
	ELEVATION	WALL AREA S.F.	OPENING S.F.	PERCENTAGE
	FRONT	748 S.F.	124.31 S.F.	16.62 %
	LEFT SIDE	1215 S.F.	81.33 S.F.	6.69 %
	RIGHT SIDE	1215 S.F.	86.17 S.F.	7.09 %
	REAR	1026 S.F.	228.44 S.F.	22.27 %
	* OPENINGS OMITTED AS PER SB-12 3.1.1.9(4) MAX 19.9 S.F. REFER TO ELEVATION FOR LOCATION		0.00 S.F.	
	TOTAL SQ. FT.	4204.00 S.F.	520.25 S.F.	12.38 %
TOTAL SQ. M.	390.56 S.M.	48.33 S.M.	12.38 %	

UNINSULATED OPENINGS (PER OBC. SB-12,3.1.1(7))				
STANDARD 10' GDN. FL., 9' SEC. FL. & 9' BASEMENT	S42-19 ELEVATION C -W.O.B.	ENERGY EFFICIENCY – OBC SB12		
	ELEVATION	WALL AREA S.F.	OPENING S.F.	PERCENTAGE
	FRONT	748 S.F.	179.81 S.F.	24.04 %
	LEFT SIDE	1215 S.F.	108.17 S.F.	8.90 %
	RIGHT SIDE	1215 S.F.	86.50 S.F.	7.12 %
	REAR	1026 S.F.	228.44 S.F.	22.27 %
	* OPENINGS OMITTED AS PER SB-12 3.1.1.9(4) MAX 19.9 S.F. REFER TO ELEVATION FOR LOCATION		0.00 S.F.	
	TOTAL SQ. FT.	4204.00 S.F.	602.92 S.F.	14.34 %
TOTAL SQ. M.	390.56 S.M.	56.01 S.M.	14.34 %	
UNINSULATED OPENINGS (PER OBC. SB-12,3.1.1(7))				
STANDARD W/ SIDE DOOR 10' GDN. FL., SEC. FL. & 9' BASEMENT	S42-19 ELEVATION C -W.O.B.	ENERGY EFFICIENCY – OBC SB12		
	ELEVATION	WALL AREA S.F.	OPENING S.F.	PERCENTAGE
	FRONT	748 S.F.	179.81 S.F.	24.04 %
	LEFT SIDE	1215 S.F.	108.17 S.F.	8.90 %
	RIGHT SIDE	1215 S.F.	97.83 S.F.	8.05 %
	REAR	1026 S.F.	228.44 S.F.	22.27 %
	* OPENINGS OMITTED AS PER SB-12 3.1.1.9(4) MAX 19.9 S.F. REFER TO ELEVATION FOR LOCATION		0.00 S.F.	
	TOTAL SQ. FT.	4204.00 S.F.	614.25 S.F.	14.61 %
TOTAL SQ. M.	390.56 S.M.	57.07 S.M.	14.61 %	


<u>UNINSULATED OPENINGS</u> (PER OBC. SB-12,3.1.1(7))				
REAR UPGRADE 10' GDN. FL., 9' SEC. FL. & 9' BASEMENT	S42-19 ELEVATION C -W.O.B.	ENERGY EFFICIENCY - OBC SB12		
	ELEVATION	WALL AREA S.F.	OPENING S.F.	PERCENTAGE
	FRONT	748 S.F.	179.81 S.F.	24.04 %
	LEFT SIDE	1215 S.F.	108.17 S.F.	8.90 %
	RIGHT SIDE	1215 S.F.	86.50 S.F.	7.12 %
	REAR	1026 S.F.	254.78 S.F.	24.83 %
	* OPENINGS OMITTED AS PER SB-12 3.1.1.9(4) MAX 19.9 S.F. REFER TO ELEVATION FOR LOCATION		0.00 S.F.	
	TOTAL SQ. FT.	4204.00 S.F.	629.26 S.F.	14.97 %
TOTAL SQ. M.	390.56 S.M.	58.46 S.M.	14.97 %	
<u>UNINSULATED OPENINGS</u> (PER OBC. SB-12,3.1.1(7))				
REAR UPGRADE W/ SIDE DOOR 10' GDN. FL., 9' SEC. FL. & 9' BASEMENT	S42-19 ELEVATION C -W.O.B.	ENERGY EFFICIENCY - OBC SB12		
	ELEVATION	WALL AREA S.F.	OPENING S.F.	PERCENTAGE
	FRONT	748 S.F.	179.81 S.F.	24.04 %
	LEFT SIDE	1215 S.F.	108.17 S.F.	8.90 %
	RIGHT SIDE	1215 S.F.	97.83 S.F.	8.05 %
	REAR	1026 S.F.	254.78 S.F.	24.83 %
	* OPENINGS OMITTED AS PER SB-12 3.1.1.9(4) MAX 19.9 S.F. REFER TO ELEVATION FOR LOCATION		0.00 S.F.	
	TOTAL SQ. FT.	4204.00 S.F.	640.59 S.F.	15.24 %
TOTAL SQ. M.	390.56 S.M.	59.51 S.M.	15.24 %	

10⁹ GROUND, 9⁹ SECOND, 9⁹ BASEMENT

[illegible]

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REVIEWED


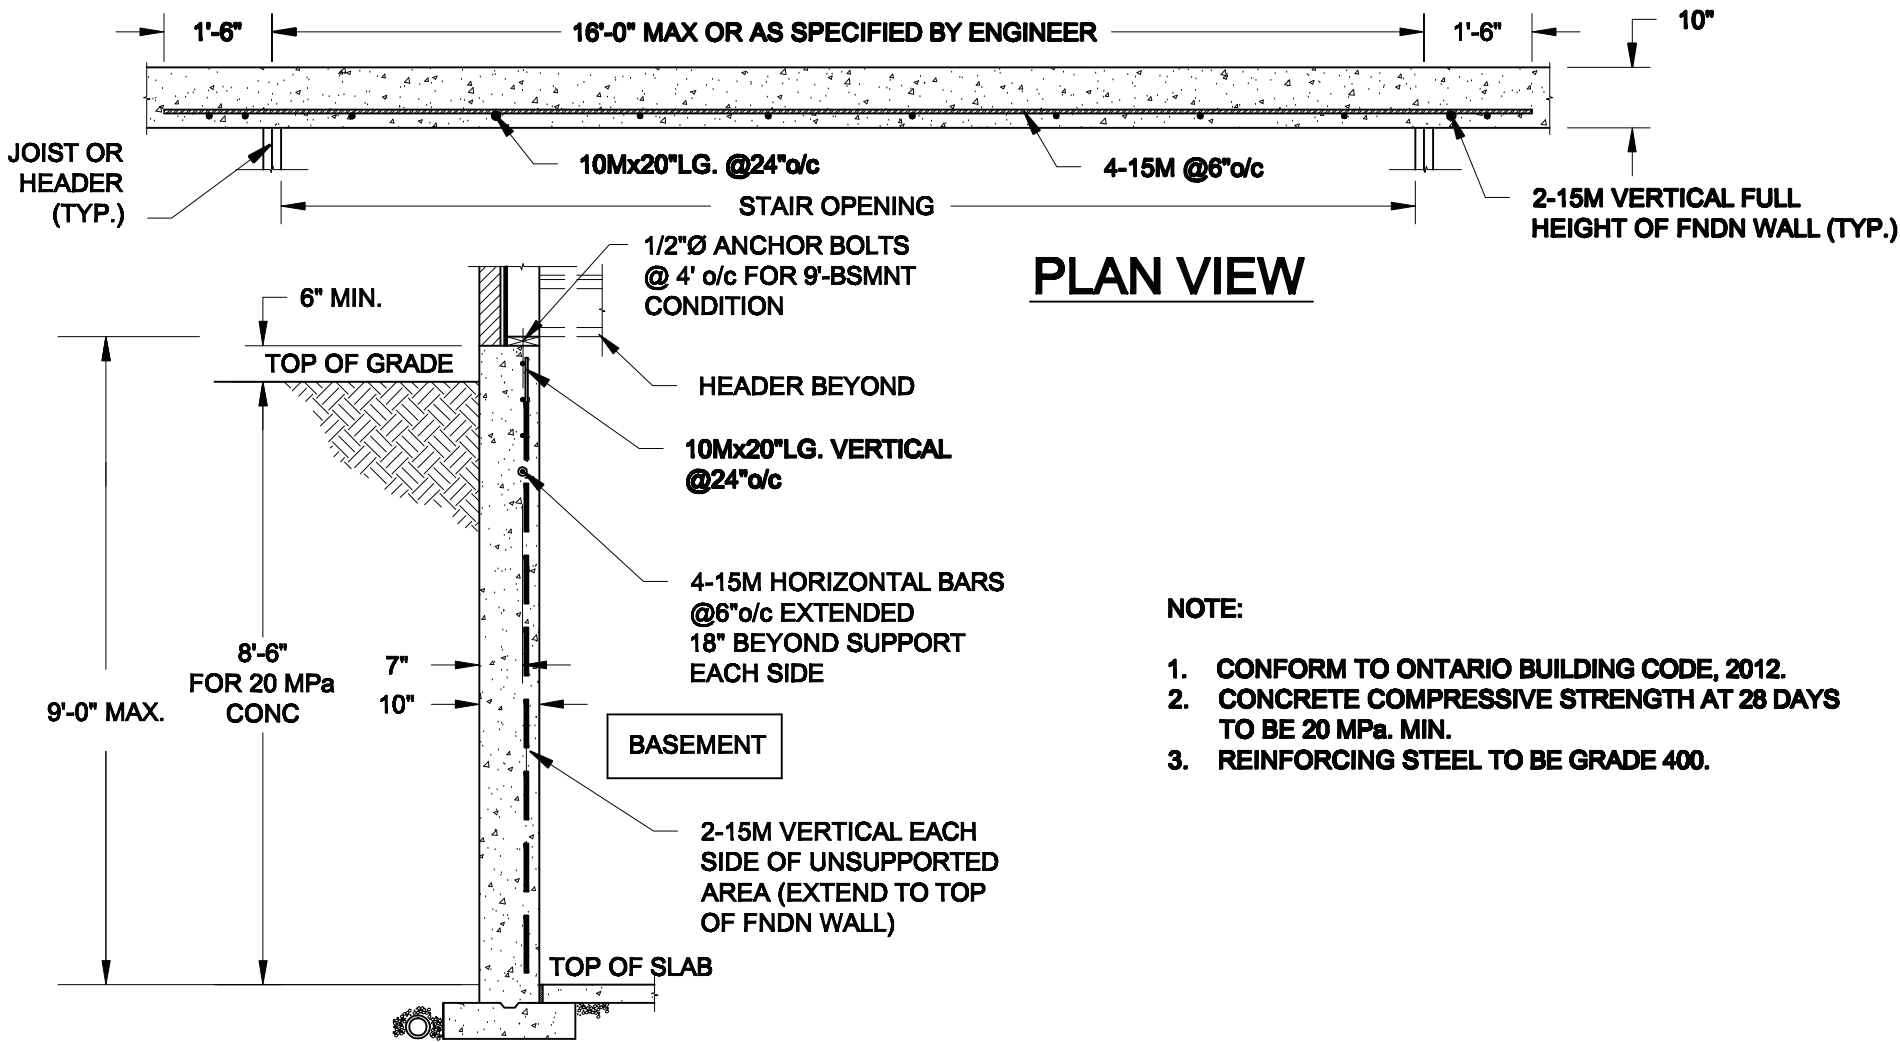


PLAN VIEW

- NOTE:
1. CONFORM TO ONTARIO BUILDING CODE, 2012.
 2. CONCRETE COMPRESSIVE STRENGTH AT 28 DAYS TO BE 20 MPa. MIN.
 3. REINFORCING STEEL TO BE GRADE 400.


1 LATERALLY UNSUPPORTED WALL

SCALE: 3/8" = 1'-0"

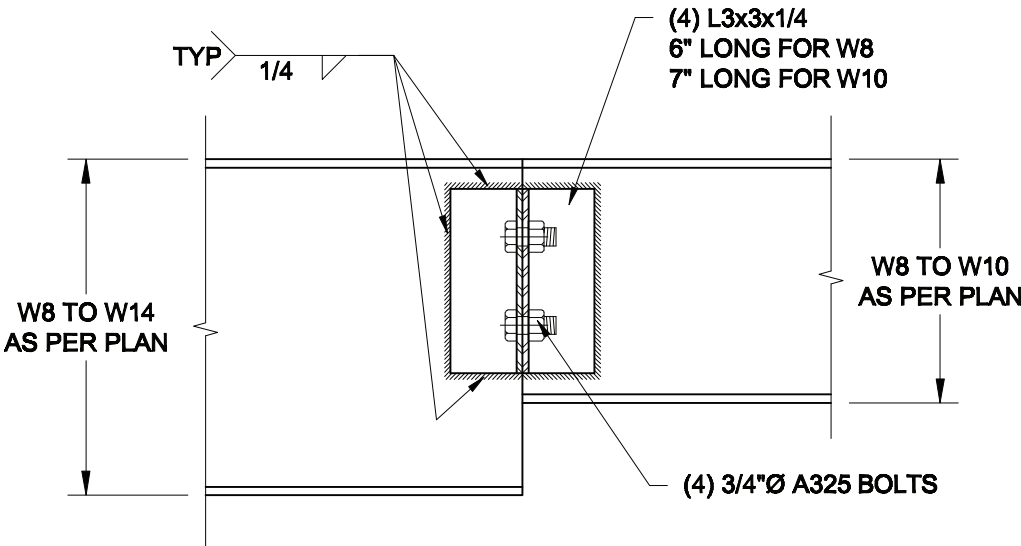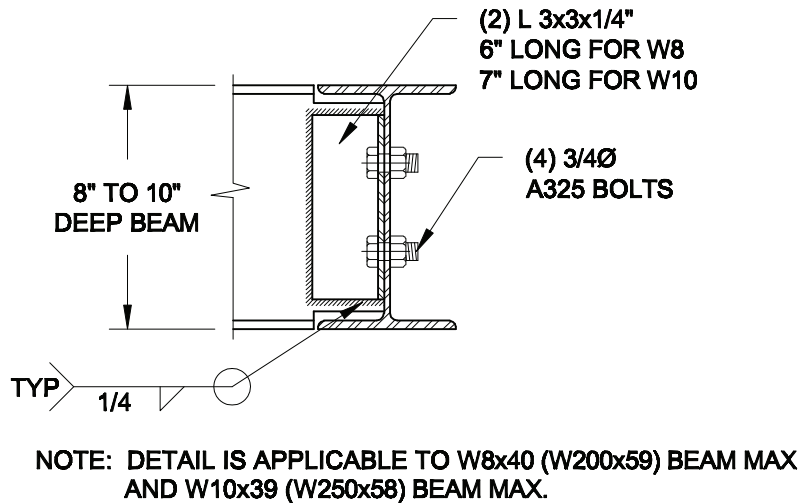

NOTE: DETAIL IS APPLICABLE TO W8x40 (W200x59) BEAM MAX AND W10x39 (W250x58) BEAM MAX.

2 STEEL BEAM CONNECTION DETAILS

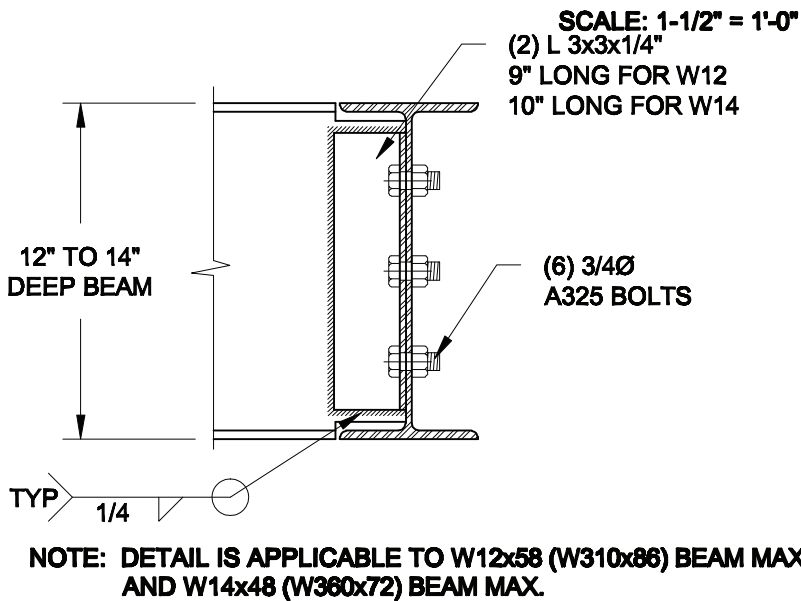

Scale:
AS NOTED
Date:
FEB-17-2022
Drawn:
SC
Checked:
SJB

QUAILE ENGINEERING LTD.




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Engineer's Seal
S.J. BOYD
90214198
PROVINCE OF ONTARIO
FEB 17, 2022

Project:
BAYVIEW WELLINGTON HOMES - GREEN VALLEY ESTATES - SINGLES
BRADFORD, ONTARIO
Project No.:
21-038
Drawing No.:
S1


FOR 9 1/2" JOIST DEPTH

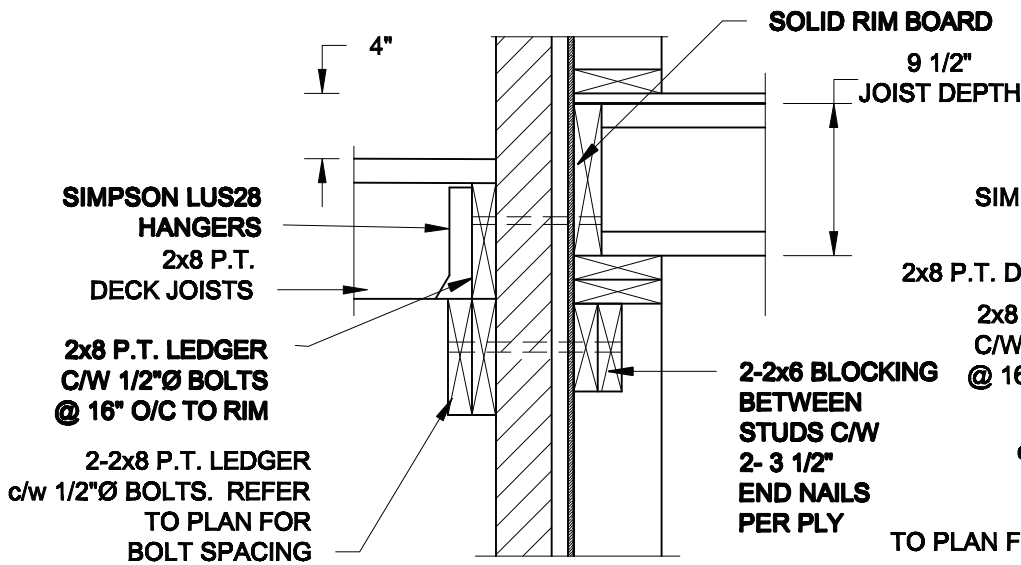

1A
S2

DECK FASTENING DETAIL

SCALE: 1" = 1'-0"

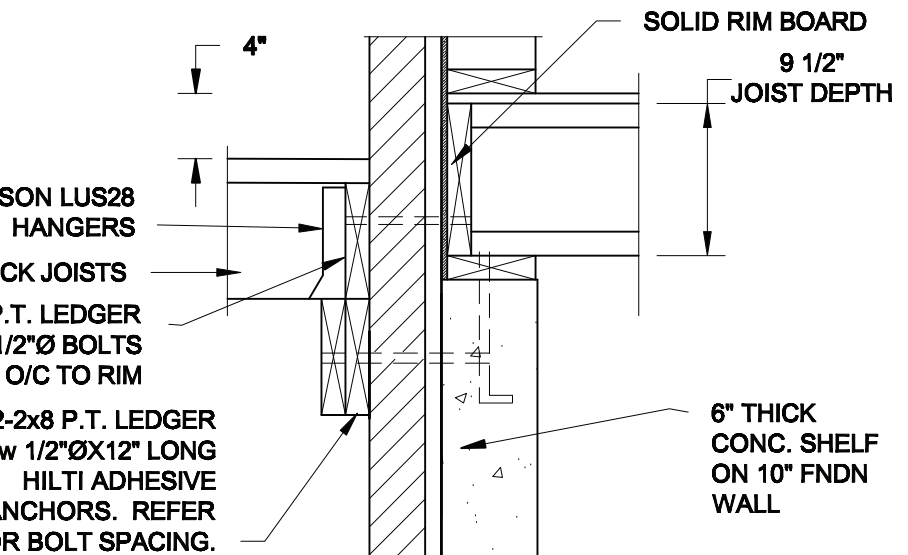


1B
S2

DECK FASTENING DETAIL

SCALE: 1" = 1'-0"


FOR 11 7/8" JOIST DEPTH

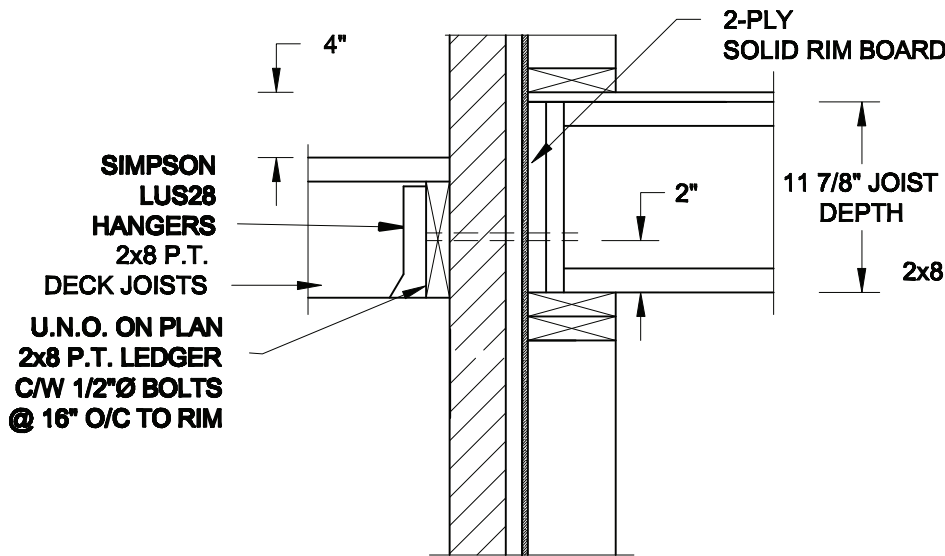

1C
S2

DECK FASTENING DETAIL

SCALE: 1" = 1'-0"

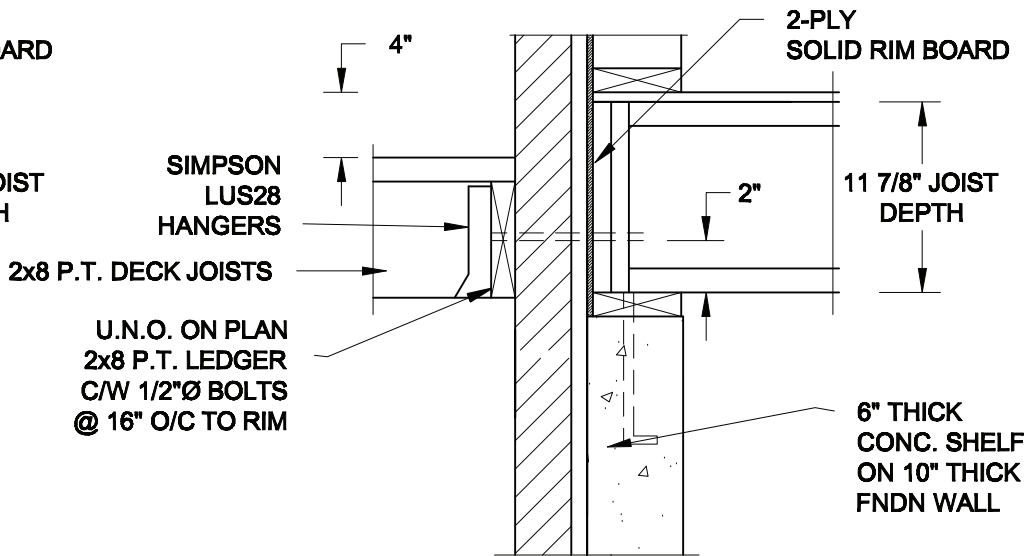


1D
S2

DECK FASTENING DETAIL

SCALE: 1" = 1'-0"

- NOTE: 1. WHERE BACKFILL HEIGHT < 4'-7", PROVIDE 2x6 @ 16" o/c KNEEWALL ON 10" THICK CONC FNDN WALL
2. WHERE BACKFILL HEIGHT > 4'-7", PROVIDE 6" CONC SHELF FOR BRICK VENEER ON 10" THICK CONC FNDN WALL
3. FOOTING TO BE 22"x6" THICK UNLESS NOTED OTHERWISE ON PLAN.

FOR 9 1/2" JOIST DEPTH

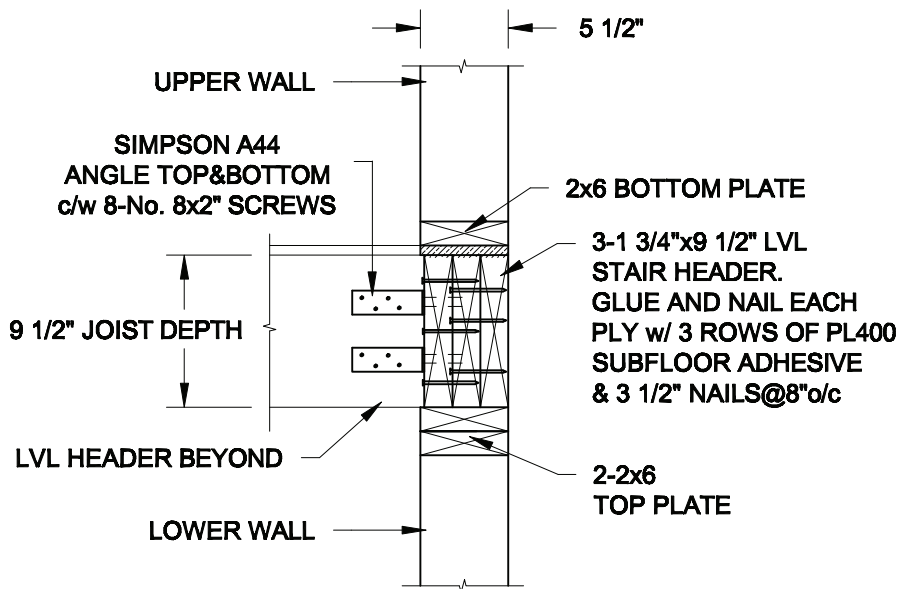


2A
S2

STAIR HEADER

SCALE: 1" = 1'-0"

FOR 11 7/8" JOIST DEPTH

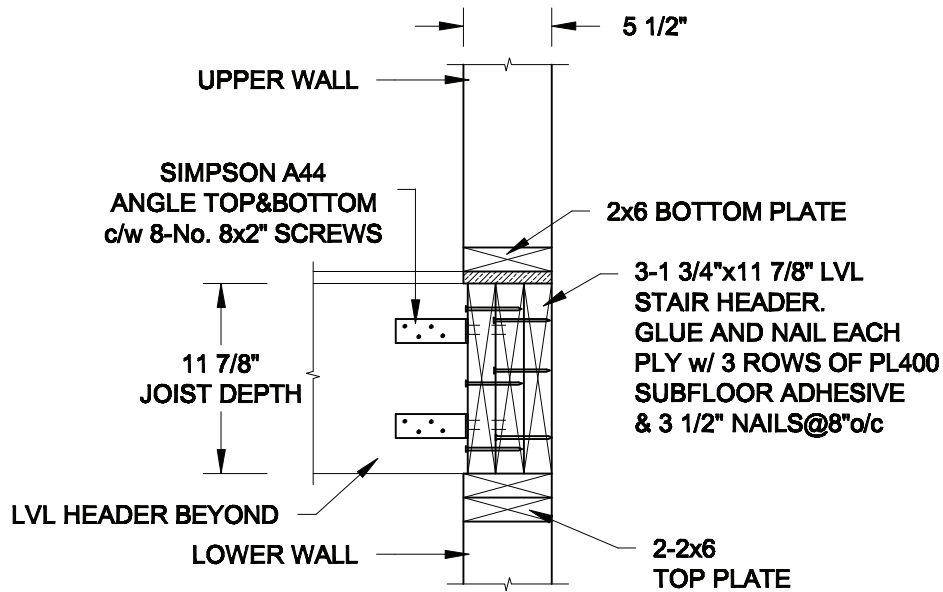

2B
S2

STAIR HEADER

SCALE: 1" = 1'-0"

Scale:

AS NOTED

Date:

MAR-15-2021

Drawn:

SC

Checked:


SJB

QUAILE ENGINEERING LTD.



38 Parkside Drive, UNIT 7
Newmarket, ON
L3Y 8J9
T: 905-853-8547
E: quaille.eng@rogers.com

Engineer's Seal

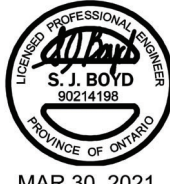

MAR 30, 2021

Project:

BAYVIEW WELLINGTON HOMES - GREEN VALLEY ESTATES - SINGLES
BRADFORD, ONTARIO


TYPICAL STRUCTURAL DETAILS

Project No.:


21-038

Drawing No.:


S2

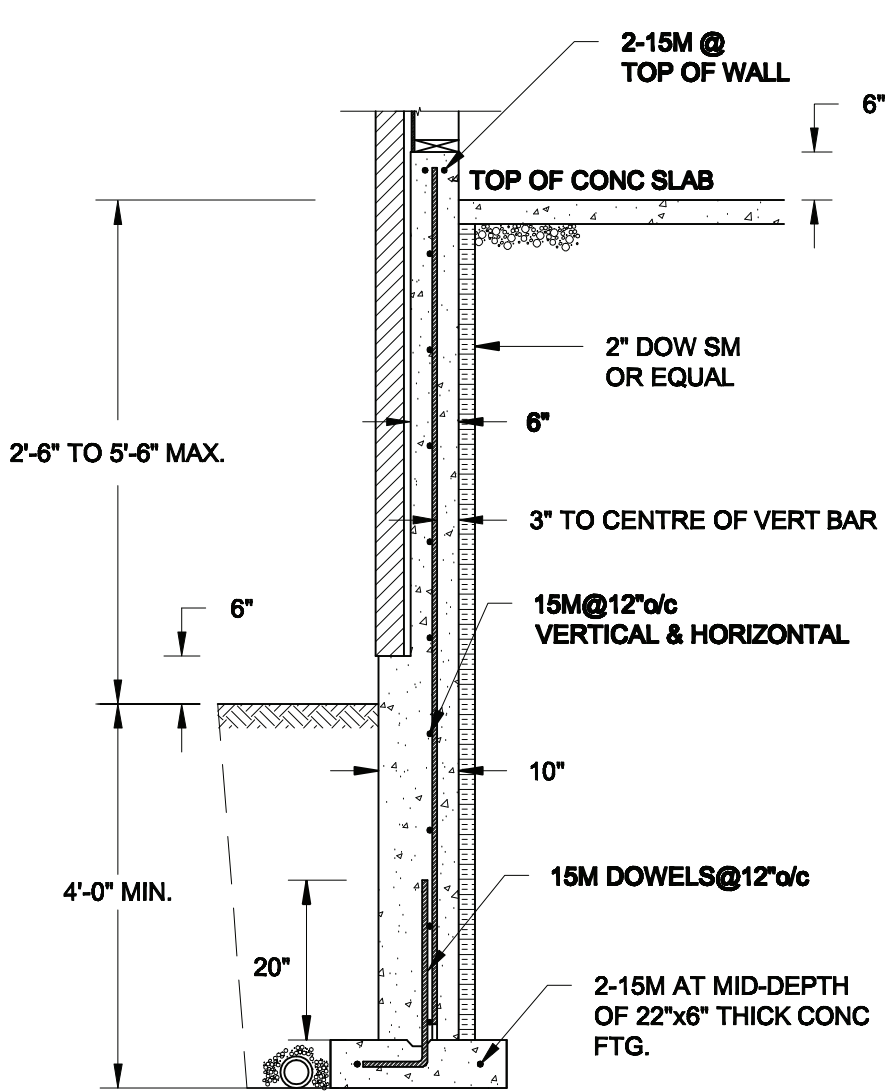

1A
S3 **REINFORCED BRICKSHEFF**
SCALE: 1/2" = 1' - 0"

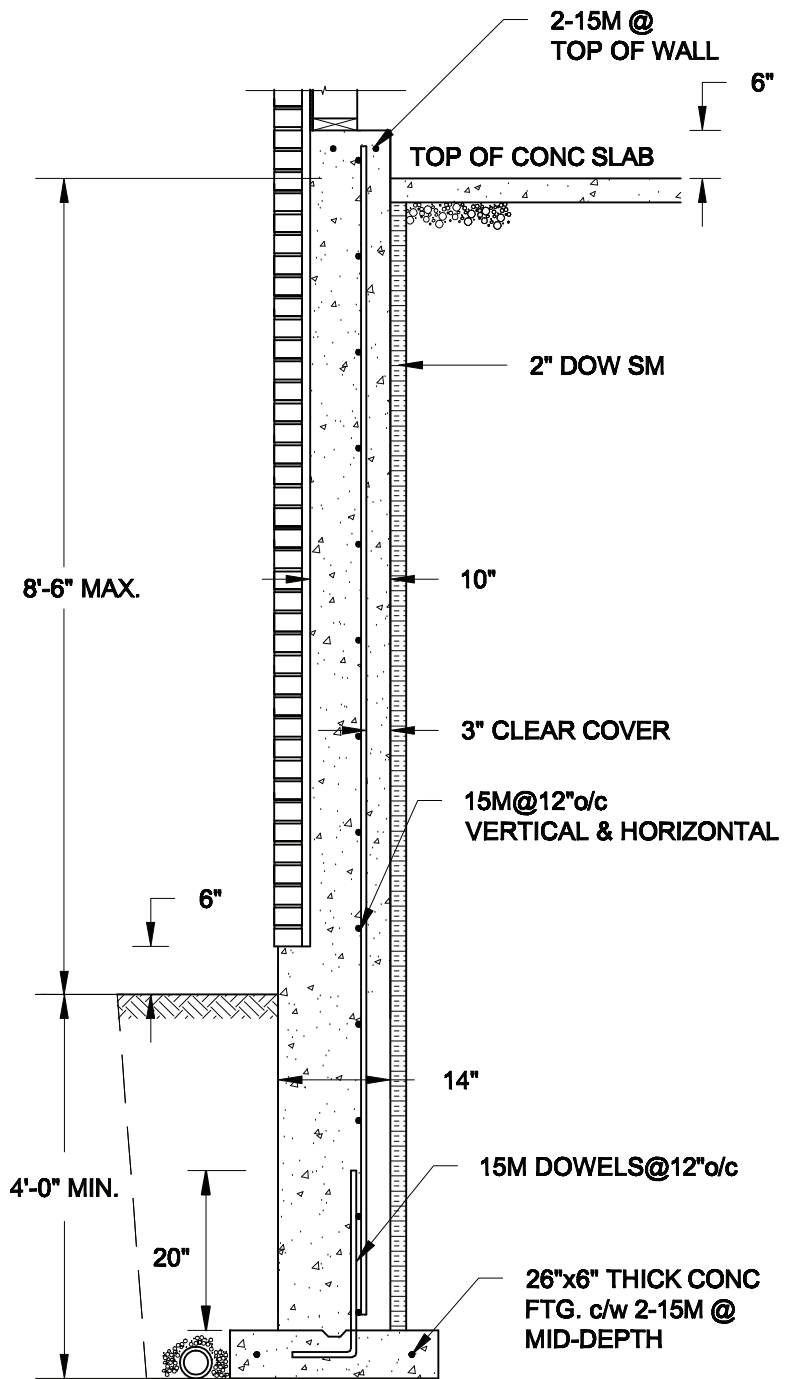


1B
S3 **REINFORCED BRICKSHEFF**
SCALE: 1/2" = 1' - 0"

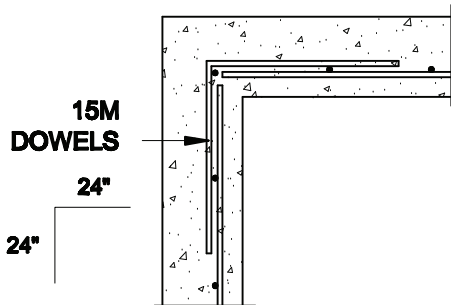

1C
S3 **PLAN VIEW AT CORNER**
SCALE: 1/2" = 1' - 0"

NOTES:

1. CONFORM TO THE ONTARIO BUILDING CODE, 2012.
2. CONCRETE TO HAVE A 28-DAY COMPRESSIVE STRENGTH OF 20 MPa.
3. REINFORCING STEEL TO BE GRADE 400.
4. LAP REINFORCING STEEL 24" AT SPLICES. PROVIDE 24"x24" L-SHAPE BARS AT ALL CORNERS - SEE DETAIL 1C/S3.
5. PROVIDE 3" COVER TO SOIL MINIMUM.
6. BACKFILL ASSUMED TO BE FREE-DRAINING MATERIAL AS PER PART 9 OF THE OBC.

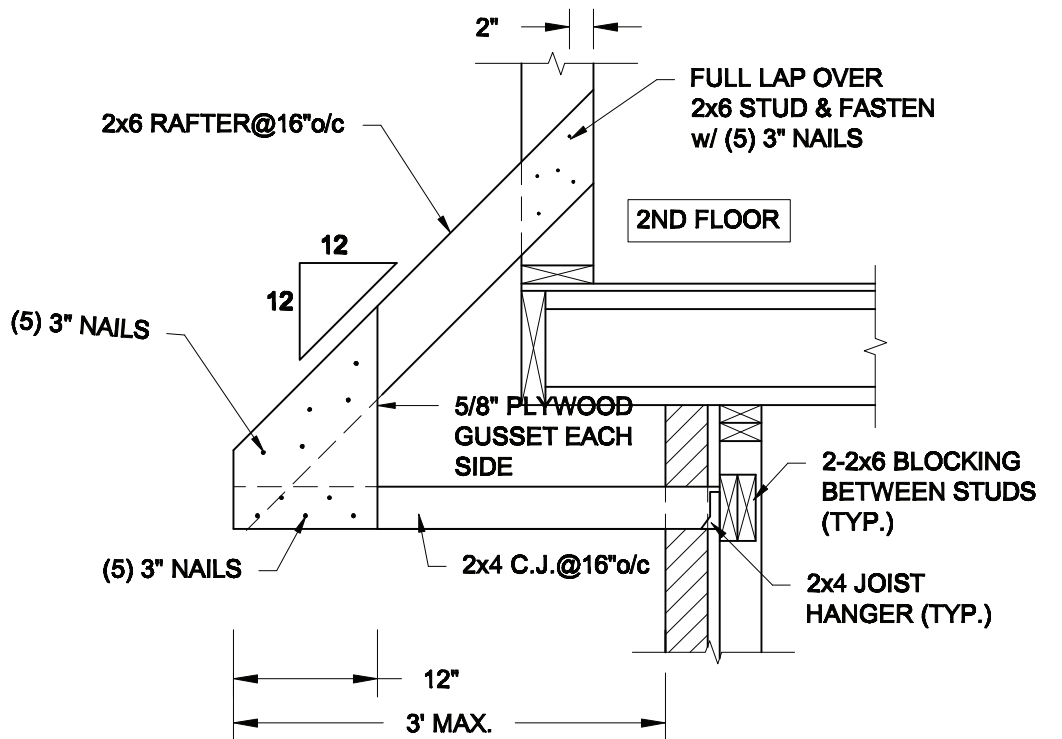

2
S3 **CANOPY ROOF OVER GARAGE**
SCALE: 3/4" = 1' - 0"

Scale:

AS NOTED

Date:

FEB-24-2022

Drawn:

SC

Checked:

SJB

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38 Parkside Drive, UNIT 7
Newmarket, ON
L3Y 8J9
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Engineer's Seal



FEB 24, 2022

Project:

BAYVIEW WELLINGTON HOMES - GREEN VALLEY ESTATES - SINGLES
BRADFORD, ONTARIO


TYPICAL STRUCTURAL DETAILS

Project No.:


21-038

Drawing No.:


S3

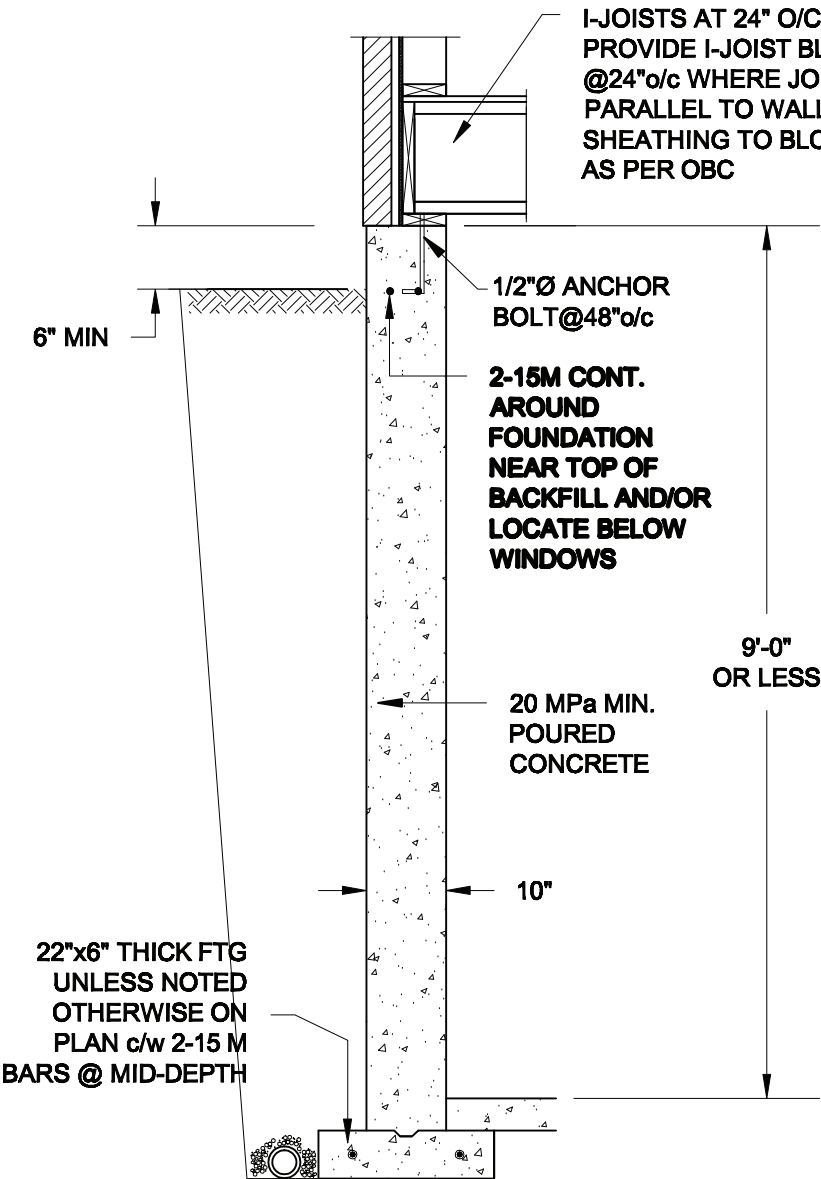

1A
S4 **FOUNDATION WALL**
SCALE: 1/2" = 1'-0"

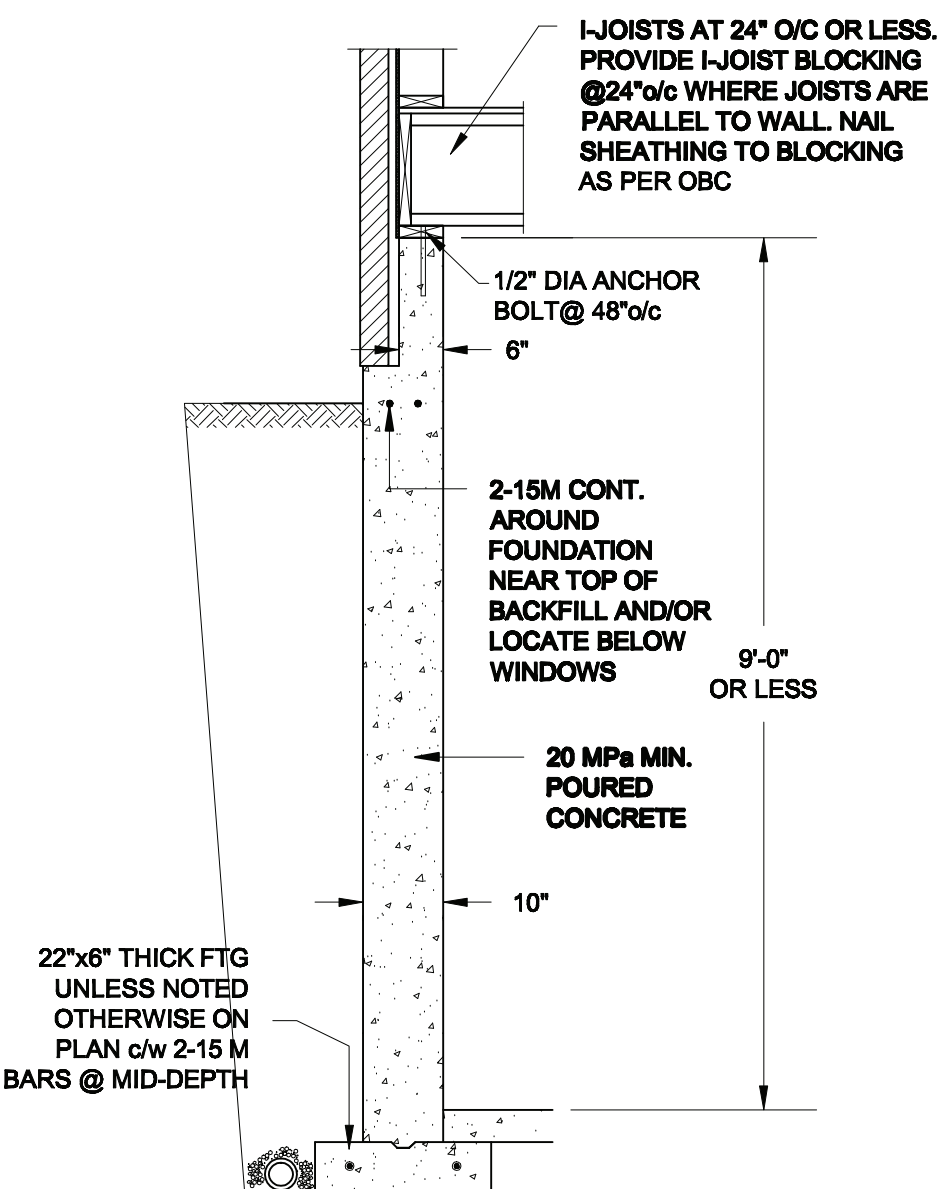

1B
S4 **DROPPED VENEER**
SCALE: 1/2" = 1'-0"

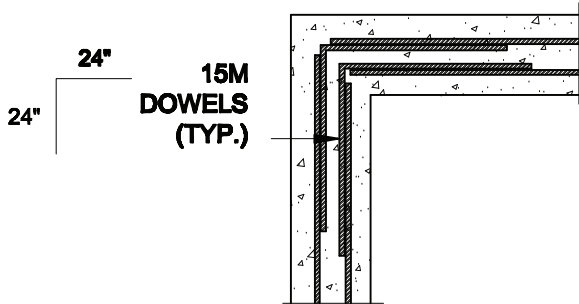




1C
S4 **TYP. PLAN VIEW AT CORNER**
SCALE: 1/2" = 1'-0"

NOTE:
AT ALL WINDOW OPENINGS,
PROVIDE 2-15M VERTICALLY
AT EACH SIDE + 2-15M
HORIZONTALLY 2" BELOW &
EXTEND 24" BEYOND OPENING

NOTES:

1. CONFORM TO THE ONTARIO BUILDING CODE, 2012.
2. CONCRETE TO HAVE A 28 DAY COMPRESSIVE STRENGTH OF 20 MPa.
3. REINFORCING STEEL TO BE GRADE 400.
4. LAP REINFORCING STEEL 24" AT SPLICES. PROVIDE 24"x24" L-SHAPE BARS AT ALL CORNERS - SEE DETAIL 1C/S4.
5. BACKFILL ASSUMED TO BE FREE-DRAINING MATERIAL AS PER PART 9 OF THE OBC.
6. FOUNDATION IS FOR A PART 9 RESIDENTIAL BUILDING.
7. DETAIL IS APPLICABLE TO SITE CLASSES A TO D ONLY AS GIVEN IN TABLE 4.1.8.4.A OF THE OBC (TO BE CONFIRMED BY GEOTECHNICAL ENGINEER).

Scale: AS NOTED		 QUAILE ENGINEERING LTD. 38 Parkside Drive, UNIT 7 Newmarket, ON L3Y 8J9 T: 905-853-8547 E: quaille.eng@rogers.com	Engineer's Seal:  MAR 30, 2021		Project: BAYVIEW WELLINGTON HOMES - GREEN VALLEY ESTATES - SINGLES BRADFORD, ONTARIO	
Date: MAR-16-2021			TYPICAL STRUCTURAL DETAILS			
Drawn: SC	Checked: SJB		Project No.: 21-038		Drawing No.: S4	

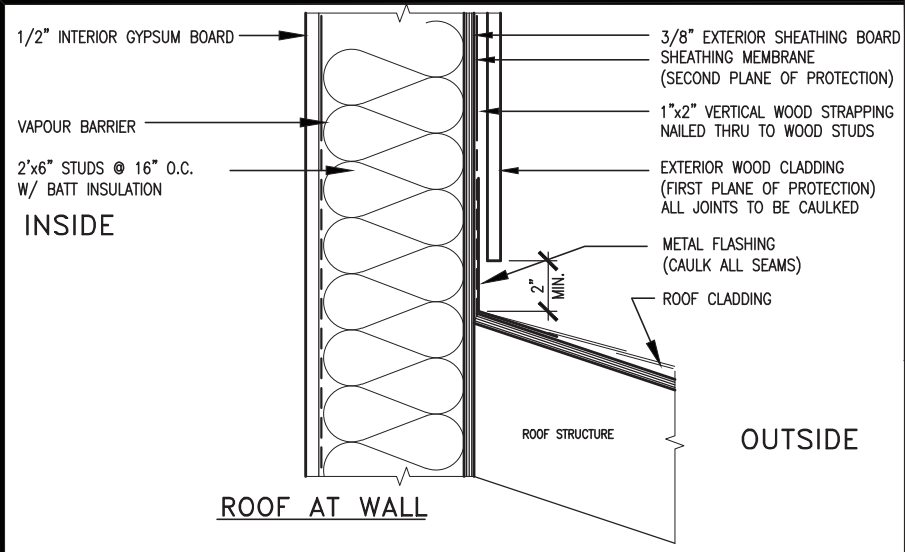

MAX. HEIGHT FOR 2"x4" GARAGE WALL IS AS FOLLOW:

2"x4" @ 16" O.C. - 9'-10"

2-2"x4" @ 12" O.C. - 10'-9"

3-2"x4" @ 16" O.C. - 11'-2"

3-2"x4" @ 12" O.C. - 12'-4"

NOTES:

- FOR ROOF DESIGN SNOW LOAD OF UP TO 2.5 KPa. SUPPORTED ROOF TRUSS LENGTH OF 6.0m AND FLOOR JOIST LENGTH OF 2.5m OF ONE FLOOR.
- PROVIDE HORIZONTAL SOLID BLOCKING @ 1200 O.C. (4'-0")
- PROVIDE A MINIMUM OF 9.5mm (3/8") PLYWOOD OR OSB EXTERIOR SHEATHING ON THE EXTERIOR FACE.
- FOR A 1/50 YEAR REFERENCE WIND PRESSURE OF 0.6 KPa.
- STUDS GREATER THAN 9'-10" HIGH TO BE No. 2 SPF.
- STUD SPECIFICATION IS SUITABLE FOR BRICK VENEER OR SIDING.

** MAX. HEIGHT FOR 2"x6" EXTERIOR WALL IS AS FOLLOW:

2"x6" @ 16" O.C. - 12'-6"

2"x6" @ 12" O.C. - 13'-10"

2-2"x6" @ 16" O.C. - 15'-0"

2-2"x6" @ 12" O.C. - 17'-4"

MAX. HEIGHT FOR 2"x8" EXTERIOR WALL IS AS FOLLOWS:

2"x8" @ 16" O.C. - 16'-0"

2"x8" @ 12" O.C. - 17'-9"




2-2"x8" @ 16" O.C. - 20'-4"

2-2"x8" @ 12" O.C. - 22'-4"

NOTES:

- FOR ROOF DESIGN SNOW LOAD OF UP TO 2.5 KPa
- SUPPORTED ROOF TRUSS LENGTH OF 6.0m ONLY.
- PROVIDE HORIZONTAL SOLID BLOCKING @ 1200 O.C. (4'-0")
- PROVIDE A MINIMUM OF 9.5mm (3/8") PLYWOOD OR OSB EXTERIOR SHEATHING ON THE EXTERIOR FACE AND 12.5mm (1/2") GYPSUM BOARD ON THE INTERIOR FACE.
- WALL FRAMING SHALL CONFORM TO OBC 9.23.10.1.(2)
- FOR A 1/50 YEAR REFERENCE WIND PRESSURE OF 0.6 KPa
- STUDS GREATER THAN 9'-10" HIGH TO BE No. 2 SPF.
- STUD SPECIFICATION IS SUITABLE FOR BRICK VENEER OR SIDING.

** STUD INFORMATION TAKEN FROM OBC TABLE A-30

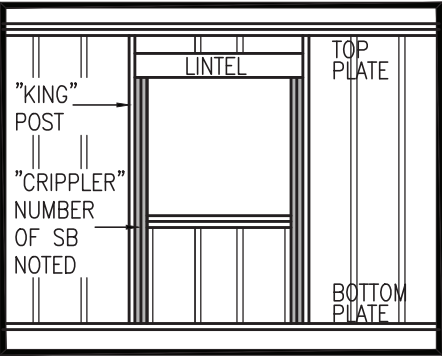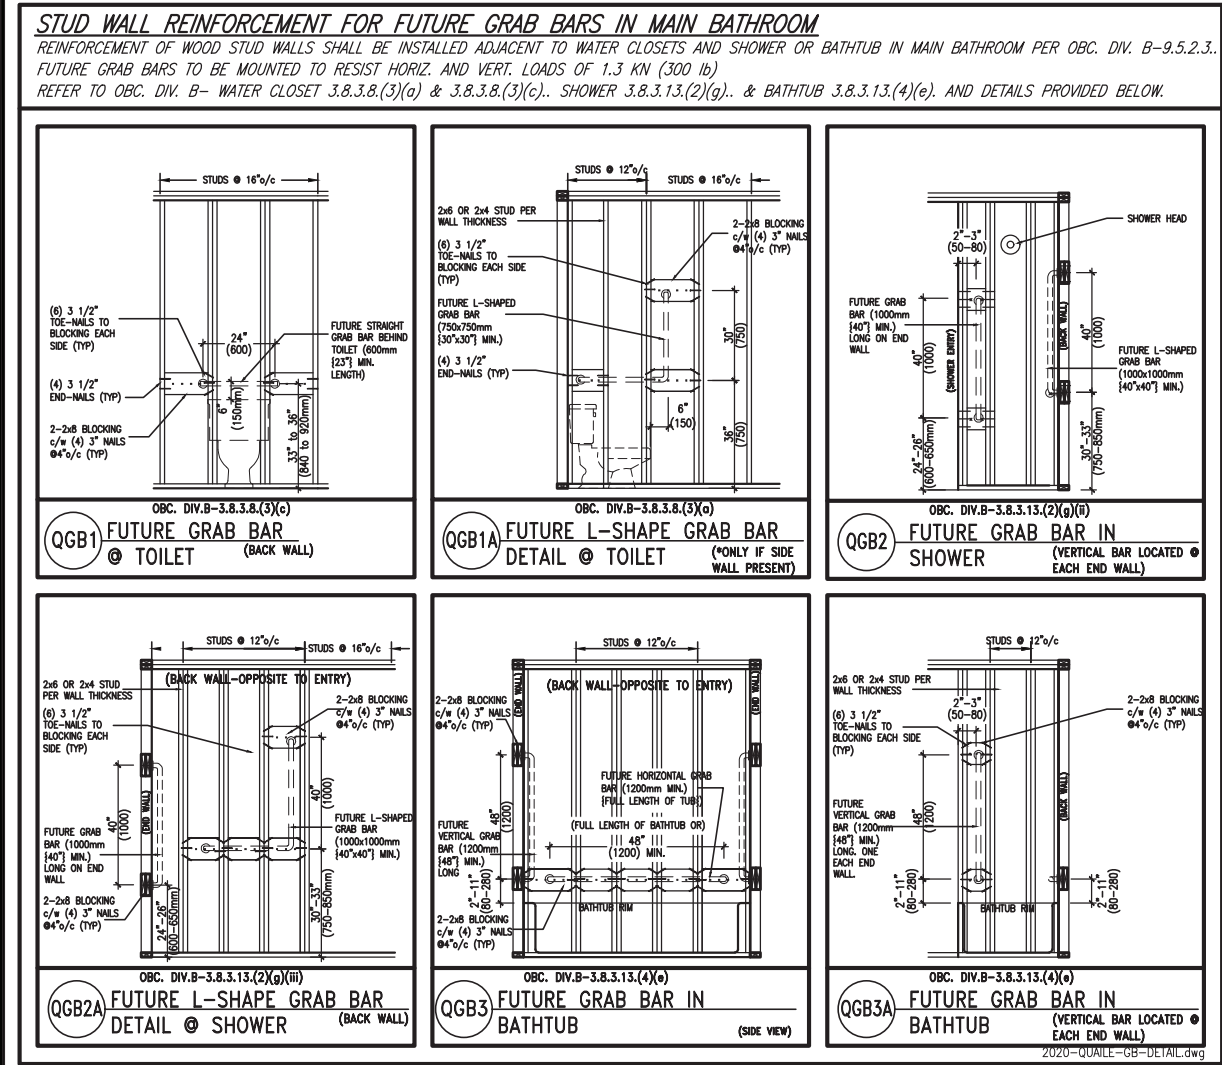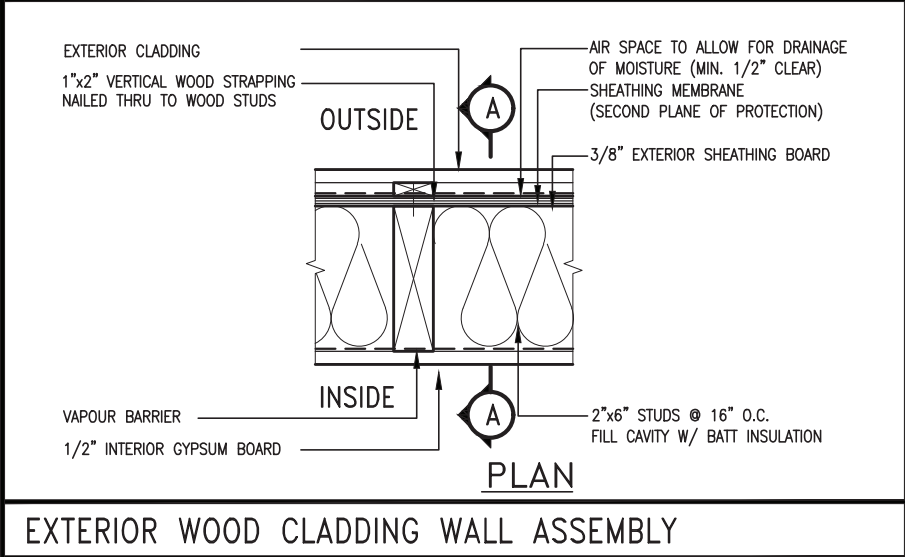


9	REVIEWED	25591
8		BCIN
7		42658
6		
5		
4	UPDATE TO 2022	JAN 11-22 RC
3	UPDATE TO 2020	FEB 24-20 RC
2	UPDATE TO 2018	JAN 11-18 RC
1	ISSUE FOR CLIENT REVIEW	AUG 04-17 RC
no.	description	date by


VA3 DESIGN

255 Consumers Rd Suite 120
Toronto ON M2J 1R4
t 416.630.2255 f 416.630.4782
va3design.com

BAYVIEW WELLINGTON			CONST NOTE	
project name			municipality	
GREEN VALLEY EAST			BRADFORD	
date			project no.	
MAY 2016			16023	
CONSTRUCTION NOTES			drawing no.	
drawn by			file name	
RC			16023-CN-2022-A1	
checked by			scale	
-			3/16" = 1'-0"	
RICHARD - H:\ARCHIVE\WORKING\2016\16023.BW\Units\CN NOTES\16023-CN-2022-A1.dwg - Wed - Jan 26 2022 - 12:05 PM				

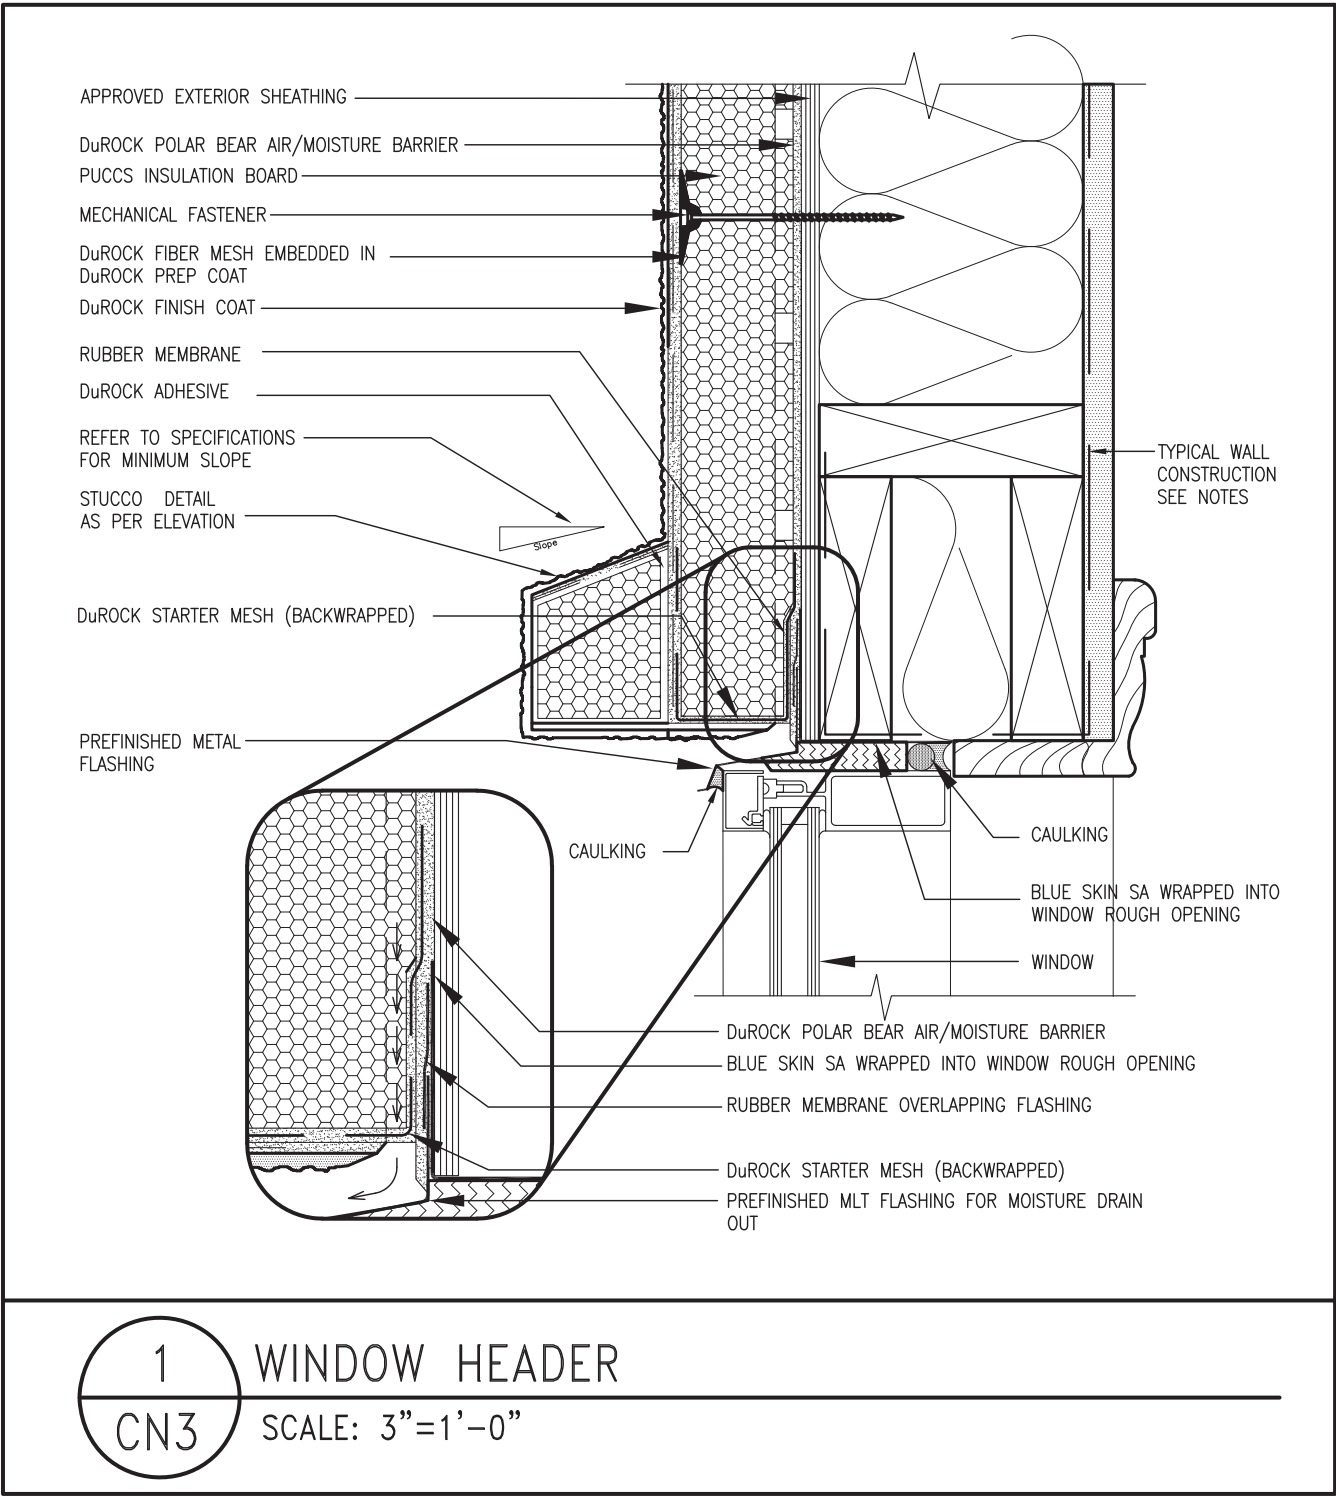


ALL STUCCO WALLS TO HAVE A MINIMUM 10mm AIR SPACE BEHIND THE CLADDING WITH POSITIVE DRAINAGE TO THE EXTERIOR. THE EXTERIOR SHEATHING MUST NOT BE GYPSUM BASED. ALL STUCCO TO BE INSTALLED AS PER MANUFACTURERS SPECIFICATIONS.
DETAILS ARE BASED ON DuROCK PUCCS SYSTEM

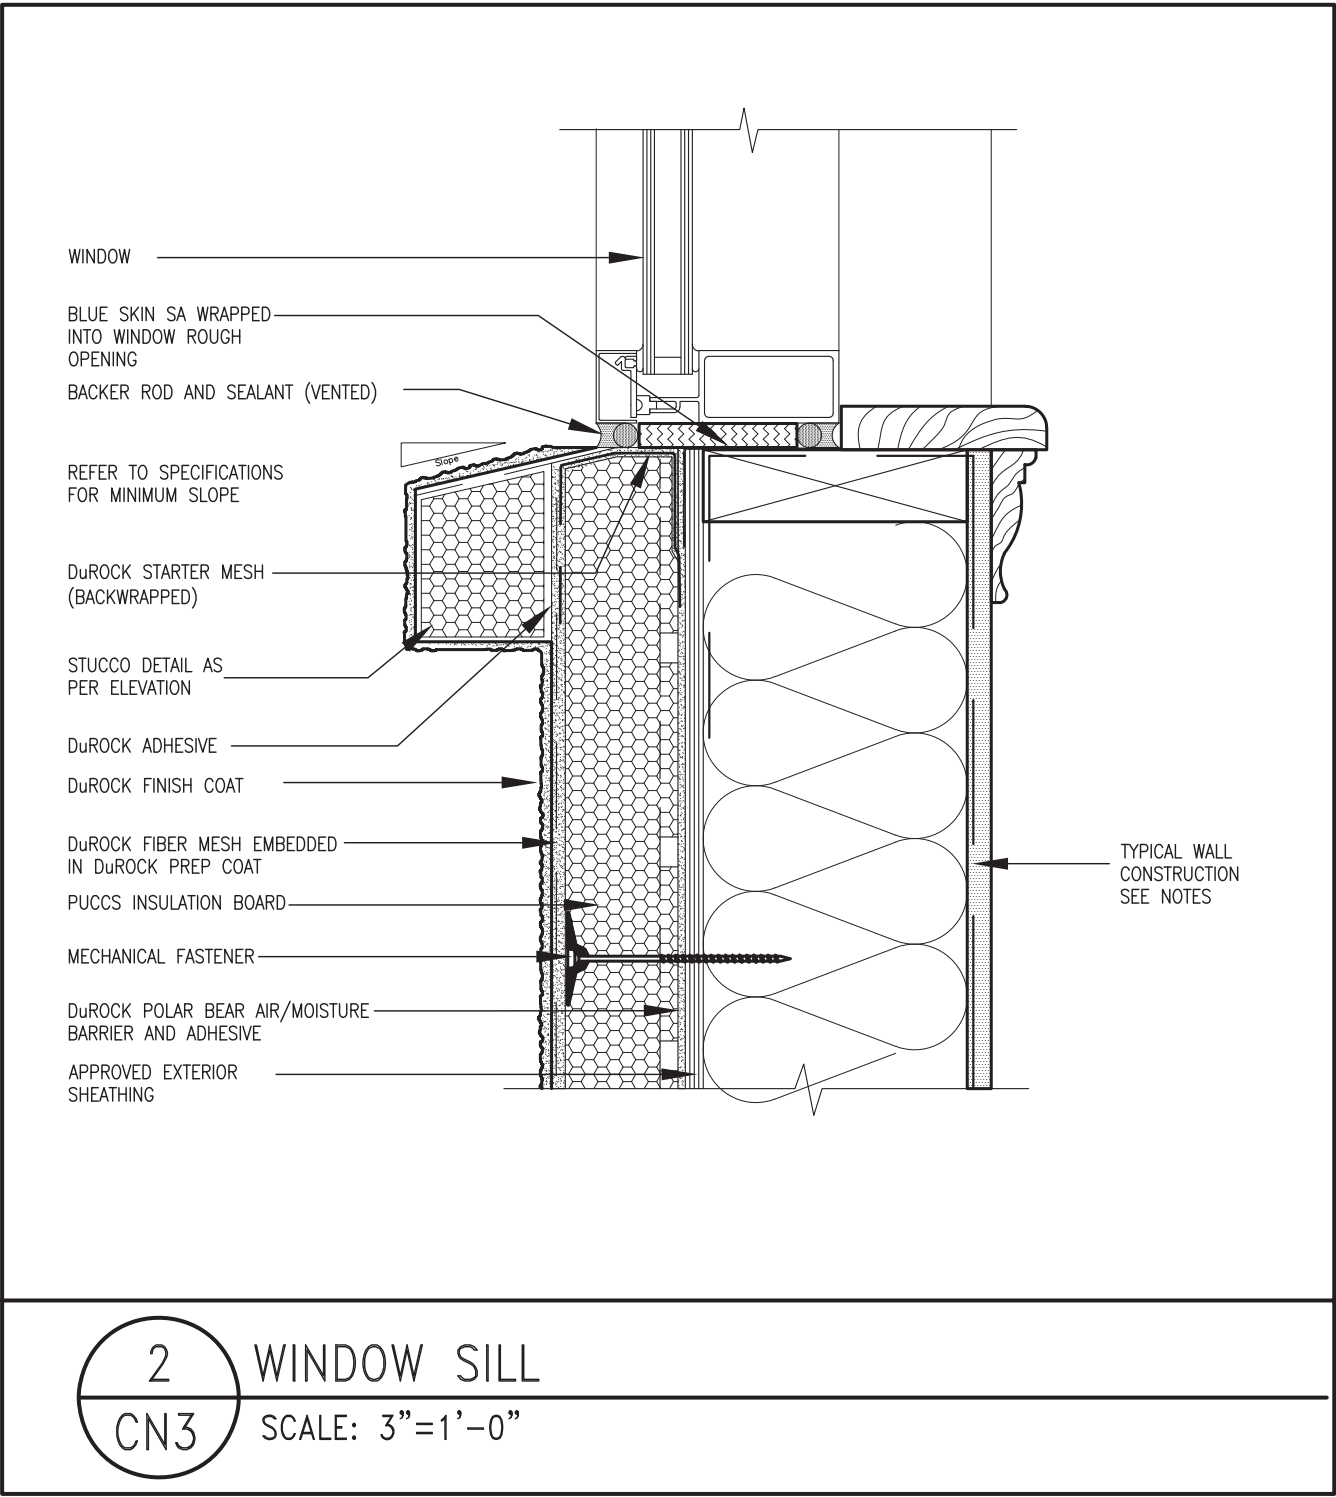

REVIEWED


											
				255 Consumers Rd, Suite 120 Toronto, ON M2J 1R4 t 416.630.2265 f 416.630.4782 vo3design.com							
				CONST NOTE							
				BAYVIEW WELLINGTON							
				GREEN VALLEY EAST				BRADFORD			
				project name				project no.			
				MAY 2016				16023			
				date				drawing no.			
				drawn by				CONSTRUCTION NOTES			
				checked by				file name			
				RC				16023-CN-2022-A1			
				scale				3/16" = 1'-0"			
				date				16023-CN-2022-A1.dwg - Wed - Jan 26 2022 - 12:07 PM			
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				The undersigned has reviewed and takes responsibility for this design and has the qualifications and meets the requirements set out in the Ontario Building Code to be a Designer.							
				qualification information							
				Wellington Jno-Baptiste				25591			
				name				BCIN			
				registration information				signature			
				VAS Design Inc.				42658			
				JAN 11-22				RC			
				FEB 24-20				RC			
				JAN 11-18				RC			
				AUG 04-17				RC			
				date				by			
				no. description							

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3 STUCCO TERMINATION @ ROOF
CN4 SCALE: 3"=1'-0"

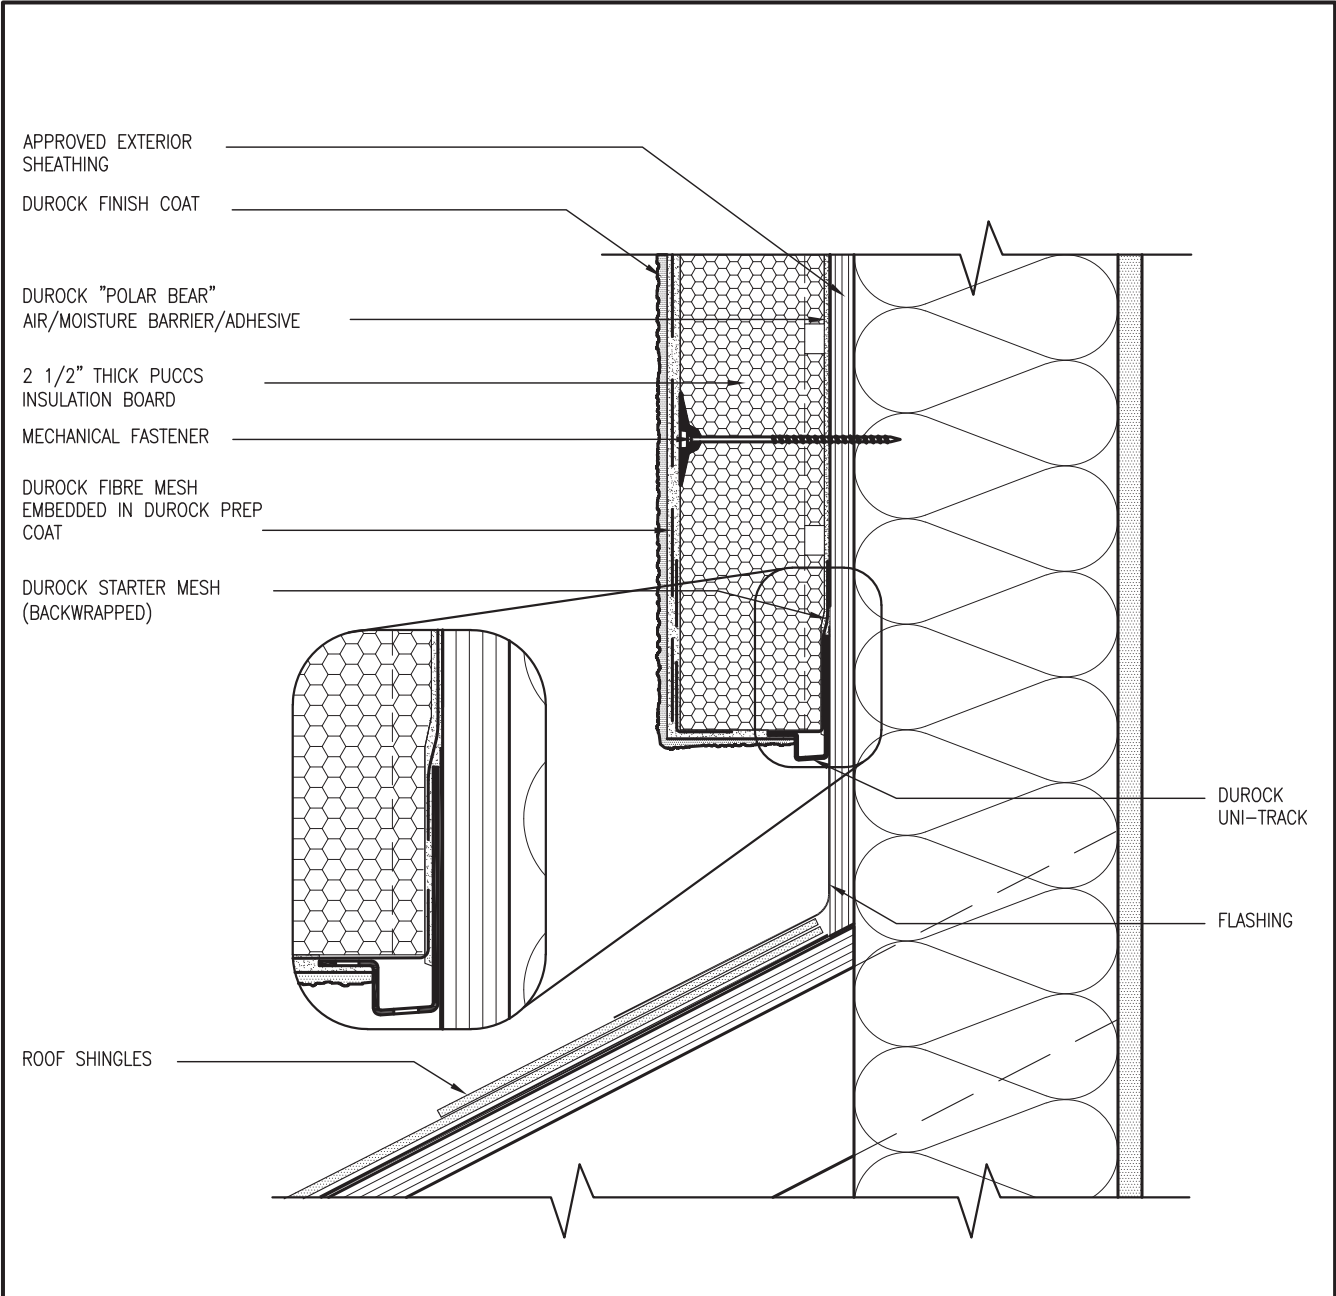ALL STUCCO WALLS TO HAVE A MINIMUM 10mm AIR SPACE BEHIND THE CLADDING WITH POSITIVE DRAINAGE TO THE EXTERIOR. THE EXTERIOR SHEATHING MUST NOT BE GYPSUM BASED. ALL STUCCO TO BE INSTALLED AS PER MANUFACTURERS SPECIFICATIONS.
DETAILS ARE BASED ON DuROCK PUCCS SYSTEM



4 HORIZONTAL EXPANSION JOINT
CN4 SCALE: 3"=1'-0"

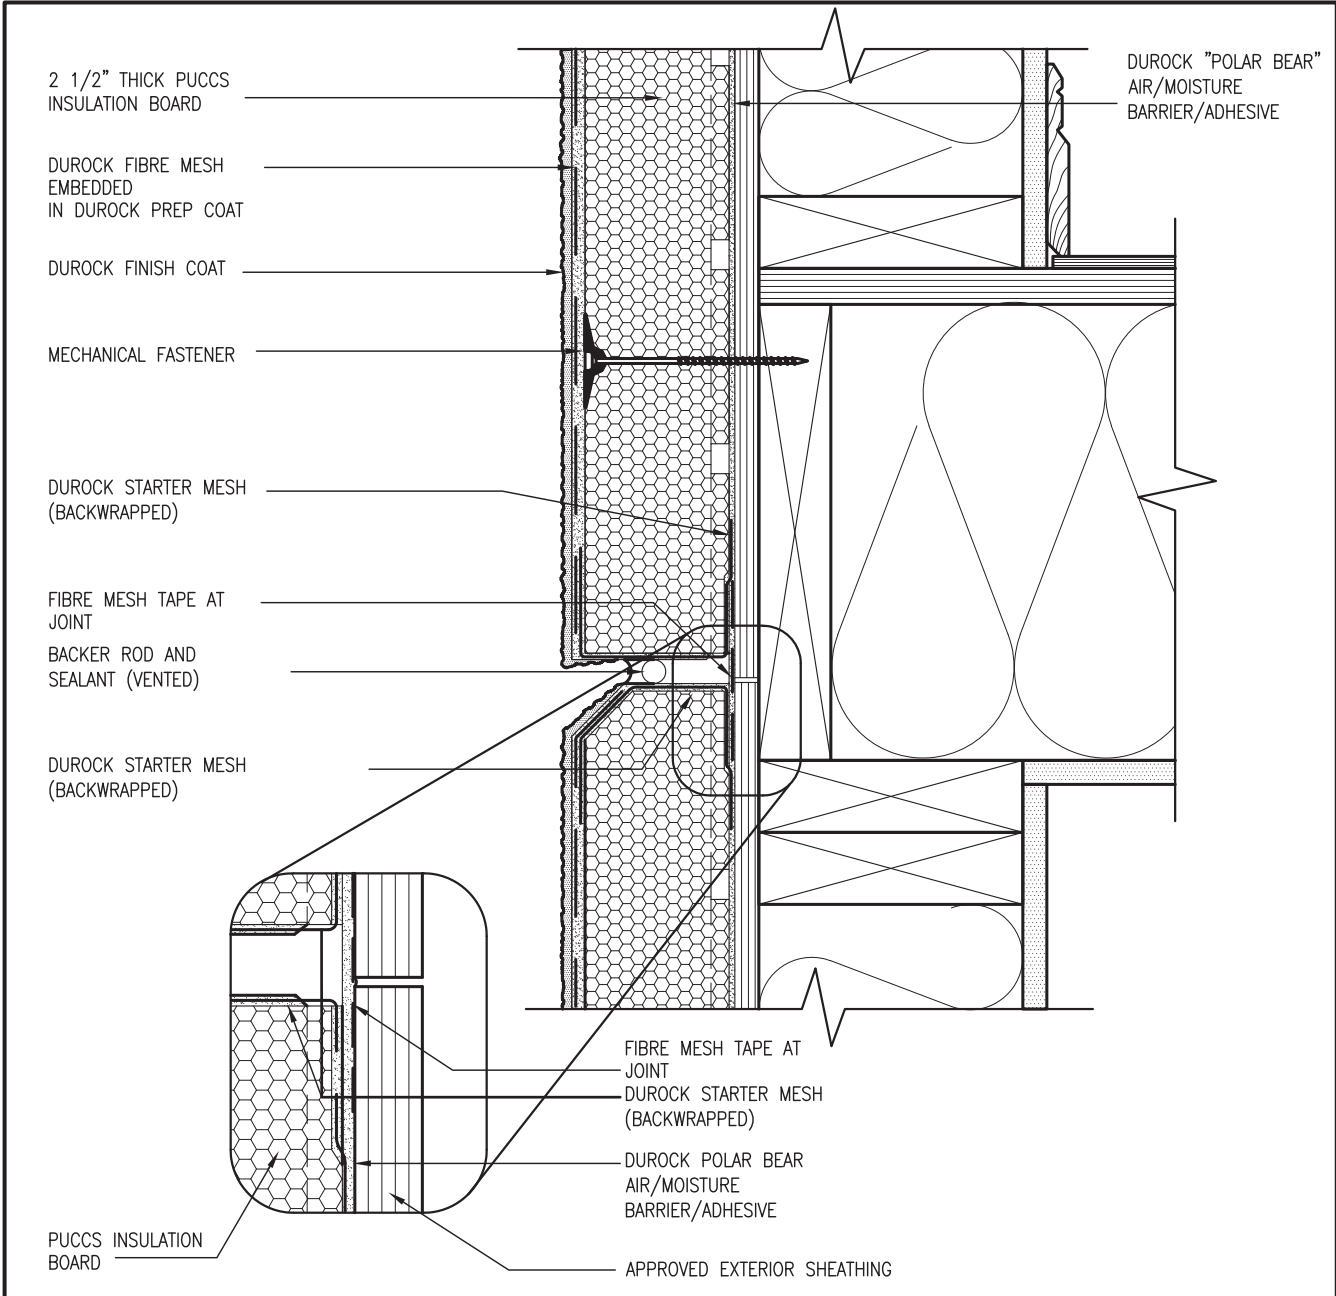REVIEWED


The undersigned has reviewed and takes responsibility for this design and has the qualifications and meets the requirements set out in the Ontario Building Code to be a Designer.										Wellington Jno-Baptiste										25591									
qualification information										signature										BCIN									
name										registration information										BCIN									
5										JAN 11-22										RC									
4										UPDATE TO 2022										RC									
3										UPDATE TO 2020										RC									
2										UPDATE TO 2018										RC									
1										ISSUE FOR CLIENT REVIEW										RC									
no.										description										date									
by										date										by									
drawings are not to be scaled.										Contractor must verify all dimensions on the job and report any discrepancy to the Designer before proceeding with the work. All drawings and specifications are instruments of service and the property of the Designer which must be returned at the completion of the work.										Drawings are not to be scaled.									
VO3 DESIGN										255 Consumers Rd, Suite 120 Toronto, ON M2J 1R4 t 416.630.2265 f 416.630.4782 vo3design.com										CN4									
VA3										CONST NOTE										CN4									
BAYVIEW WELLINGTON										GREEN VALLEY EAST										BRADFORD									
project name										project no.										16023									
date										drawing no.										16023									
drawn by										checked by										scale									
RC										RC										3/16" = 1'-0"									
MAY 2016										CONSTRUCTION NOTES										16023-CN-2022-A1									
RC										file name										16023-CN-2022-A1									
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REVIEWED

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SB12-COMPLIANCE PACKAGE 'A1'



REFER TO ADDITIONAL
DETAILS FOR STRUCTURAL
COMPONENTS


EW TYPICAL EXT. WALL AIR BARRIER CONTINUITY
SECTION w/ BRICK VENEER (PACKAGE A1)
10" FOUNDATION WALL SCALE: N.T.S.

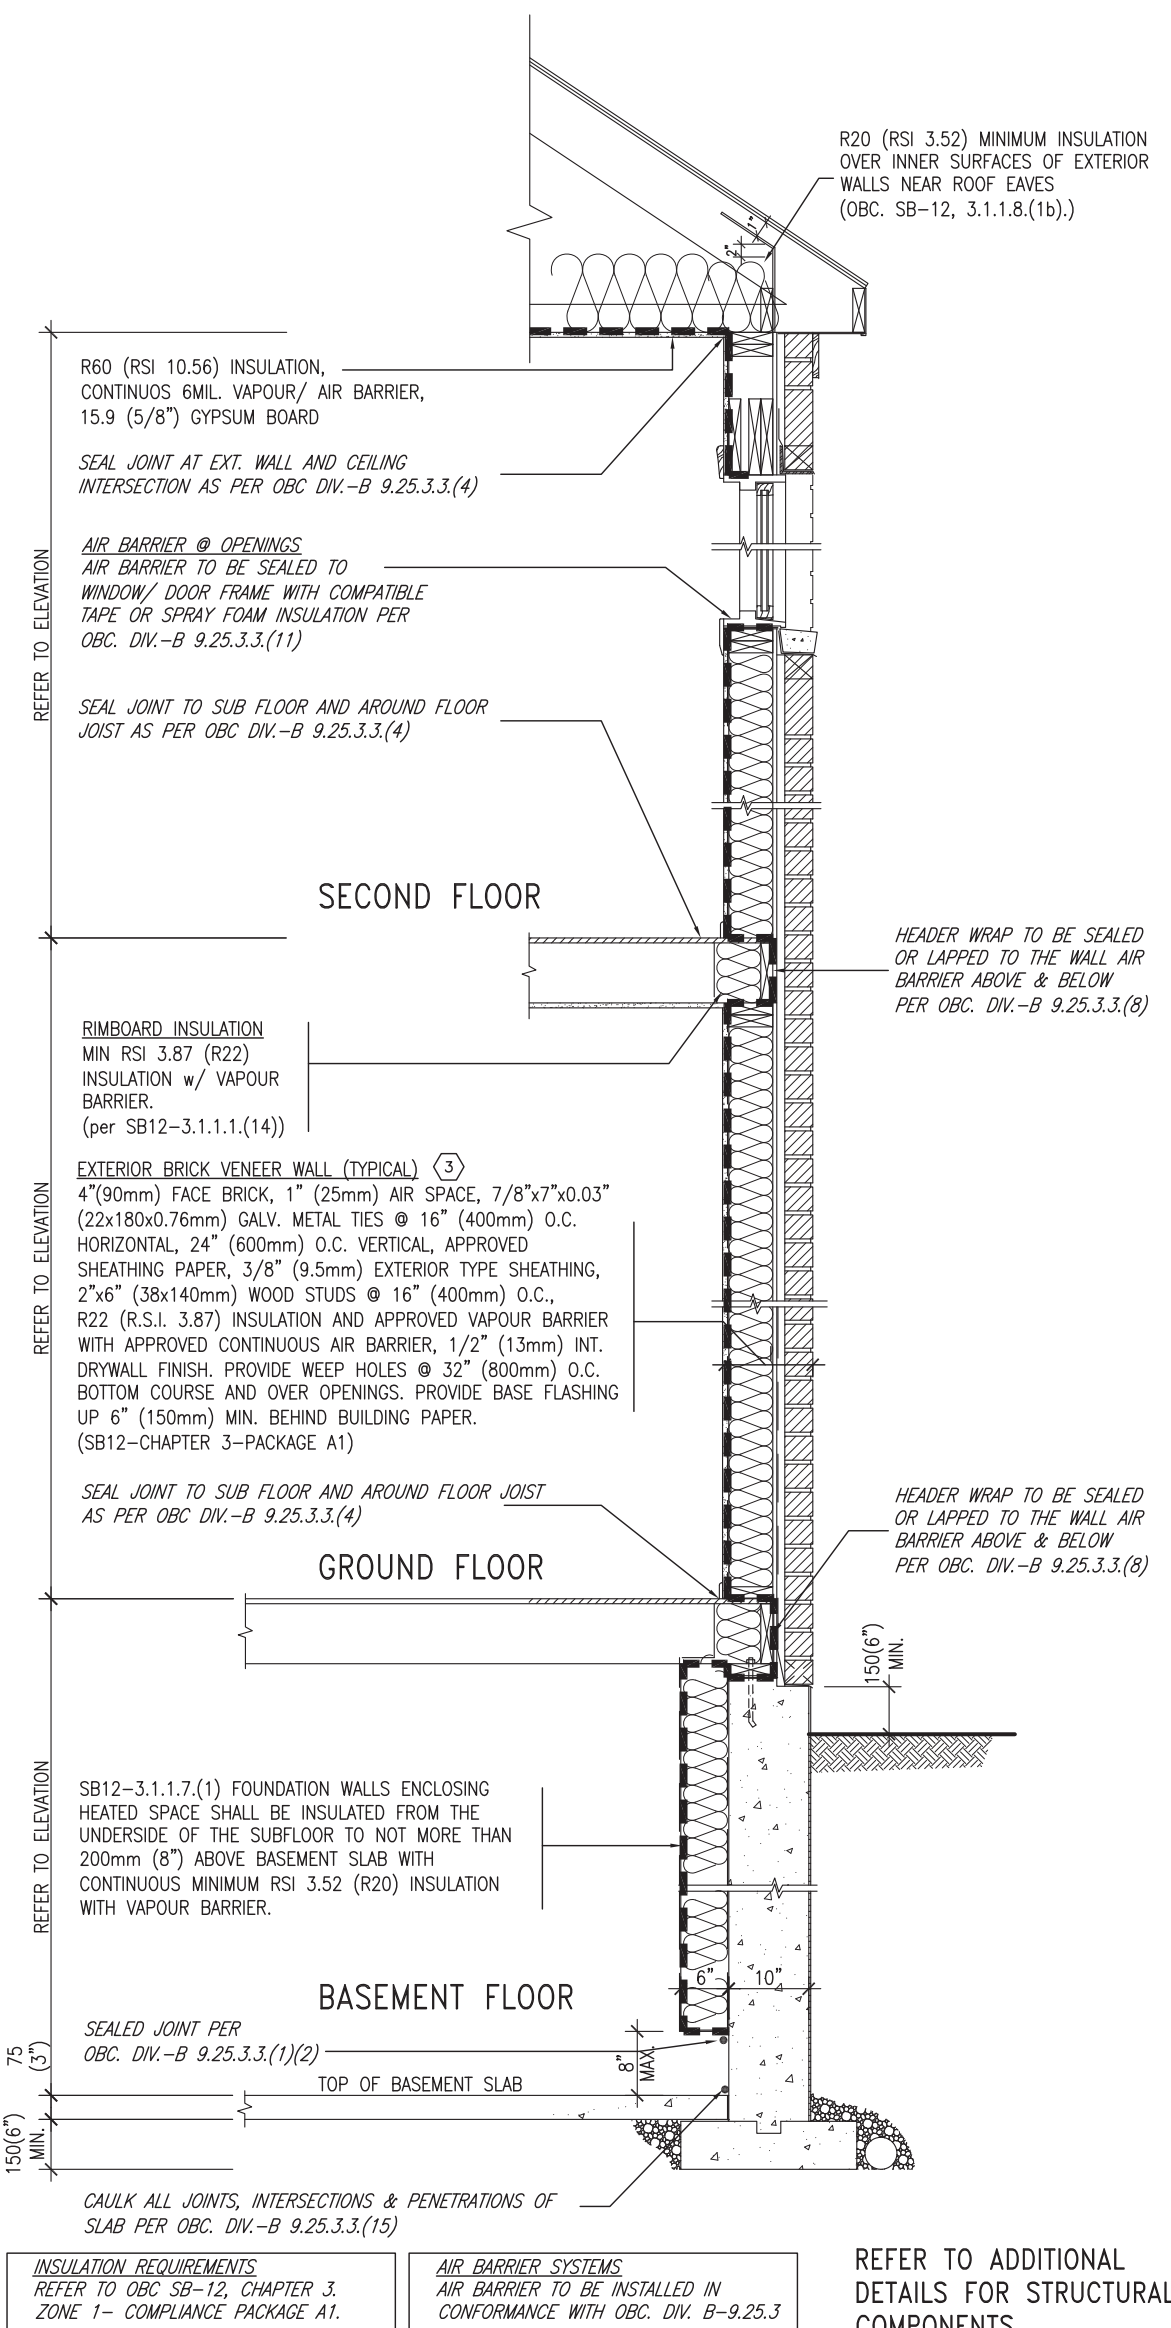THE MINIMAL THERMAL PERFORMANCE OF BUILDING ENVELOPE AND EQUIPMENT SHALL CONFORM TO THE FOLLOWING SB-12 COMPLIANCE PACKAGE AS PER OBC SUPPLEMENTARY STANDARD SB-12, SECTION 3.1.1.1.

USE SB-12 COMPLIANCE PACKAGE (A1):

COMPONENT	A1	Notes:
Ceiling with Attic Space Minimum RSI (R) value	10.56 (R60)	R20 at inner face of exterior walls
Ceiling without Attic Space Minimum RSI (R) value	5.46 (R31)	BATT or SPRAY
Exposed Floor Minimum RSI (R) value	5.46 (R31)	BATT or SPRAY
Walls Above Grade Minimum RSI (R) value	3.87 (R22)	6" R22 BATT
Basement Walls Minimum RSI (R) value	3.52ci (R20ci)	OPTION TO USE R12+R10ci.
Edge of Below Grade Slab ≤600mm below grade Minimum RSI (R) value	1.76 (R10)	RIGID INSUL
Windows & Sliding glass Doors Maximum U-value	1.6	
Skylights Maximum U-value	2.8U	
Space Heating Equipment Minimum AFUE	96% Min.	NATURAL GAS
Hot Water Heater Minimum EF	0.8	NATURAL GAS
HRV Minimum Efficiency	75%	—
Drain Water Heat Recovery Unit (DWHR)	Minimum 1 OR Maximum 2 Required. Dependent on number of showers installed. Refer to SB12-3.1.1.12 for information	

ci- Denotes Continuous Insulation without framing interruption.

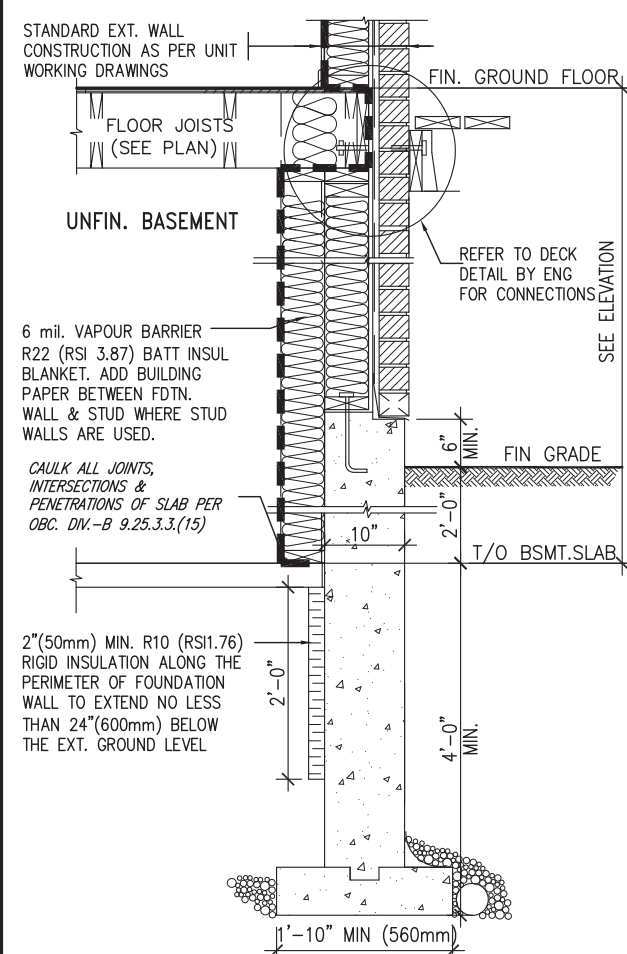

* REVISED—FEB 2017

SECTION AT W.O.D/W.O.B.


9	REVIEWED				The undersigned has reviewed and takes responsibility for this design and has the qualifications and meets the requirements set out in the Ontario Building Code to be a Designer.	
8					qualification information	
7					Wellington Jno-Baptiste	25591
6					name	BCIN
5					registration information	42658
4	UPDATE TO 2022	JAN 11-22	RC	VA3 Design Inc.		
3	UPDATE TO 2020	FEB 24-20	RC			
2	UPDATE TO 2018	JAN 11-18	RC			
1	ISSUE FOR CLIENT REVIEW	AUG 04-17	RC			
no.	description	date	by	Contractor must verify all dimensions on the job and report any discrepancy to the Designer before proceeding with the work. All drawings and specifications are instruments of service and the property of the Designer which must be returned at the completion of the work. Drawings are not to be scaled.		

VA3
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BAYVIEW WELLINGTON		CONST NOTE	
project name GREEN VALLEY EAST		municipality BRADFORD	
date MAY 2016		project no. 1602	
drawing no.		drawing no.	
checked by RC		scale 3/16" = 1'-0"	
file name 16023-CN-2022-A1		CN6	
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SB12-COMPLIANCE PACKAGE 'A1'




EW STR TYPICAL EXT. WALL AIR BARRIER CONTINUITY SECTION w/ BRICK VENEER AT STAIR AND SUNKEN COND (PACKAGE A1) 10" FOUNDATION WALL SCALE: N.T.S.

9				The undersigned has reviewed and takes responsibility for this design and has the qualifications and meets the requirements set out in the Ontario Building Code to be a Designer.				VA3				BAYVIEW WELLINGTON				CONST NOTE											
8				qualification information				signature				project name				municipality				project no.							
7				Wellington-Duro-Baptiste				25591				GREEN VALLEY EAST				BRADFORD				16023							
6				name				BCIN				date				CONSTRUCTION NOTES				drawing no.							
5				registration information				42658				MAY 2016				RC				CN7							
4				UPDATE TO 2022				JAN 11-22 RC				255 Consumers Rd Suite 120				checked by				scale				file name			
3				UPDATE TO 2020				FEB 24-20 RC				Toronto ON M2J 1R4				-				3/16" = 1'-0"				16023-CN-2022-A1			
2				UPDATE TO 2018				JAN 11-18 RC				t 416.630.2255 f 416.634.4782				RICHARD - H:\ARCHIVE\WORKING\2016\16023.BW\Units\CN NOTES\16023-CN-2022-A1.dwg - Wed - Jan 26 2022 - 12:09 PM											
1				ISSUE FOR CLIENT REVIEW				AUG 04-17 RC				va3design.com															
no.				description				date				by															

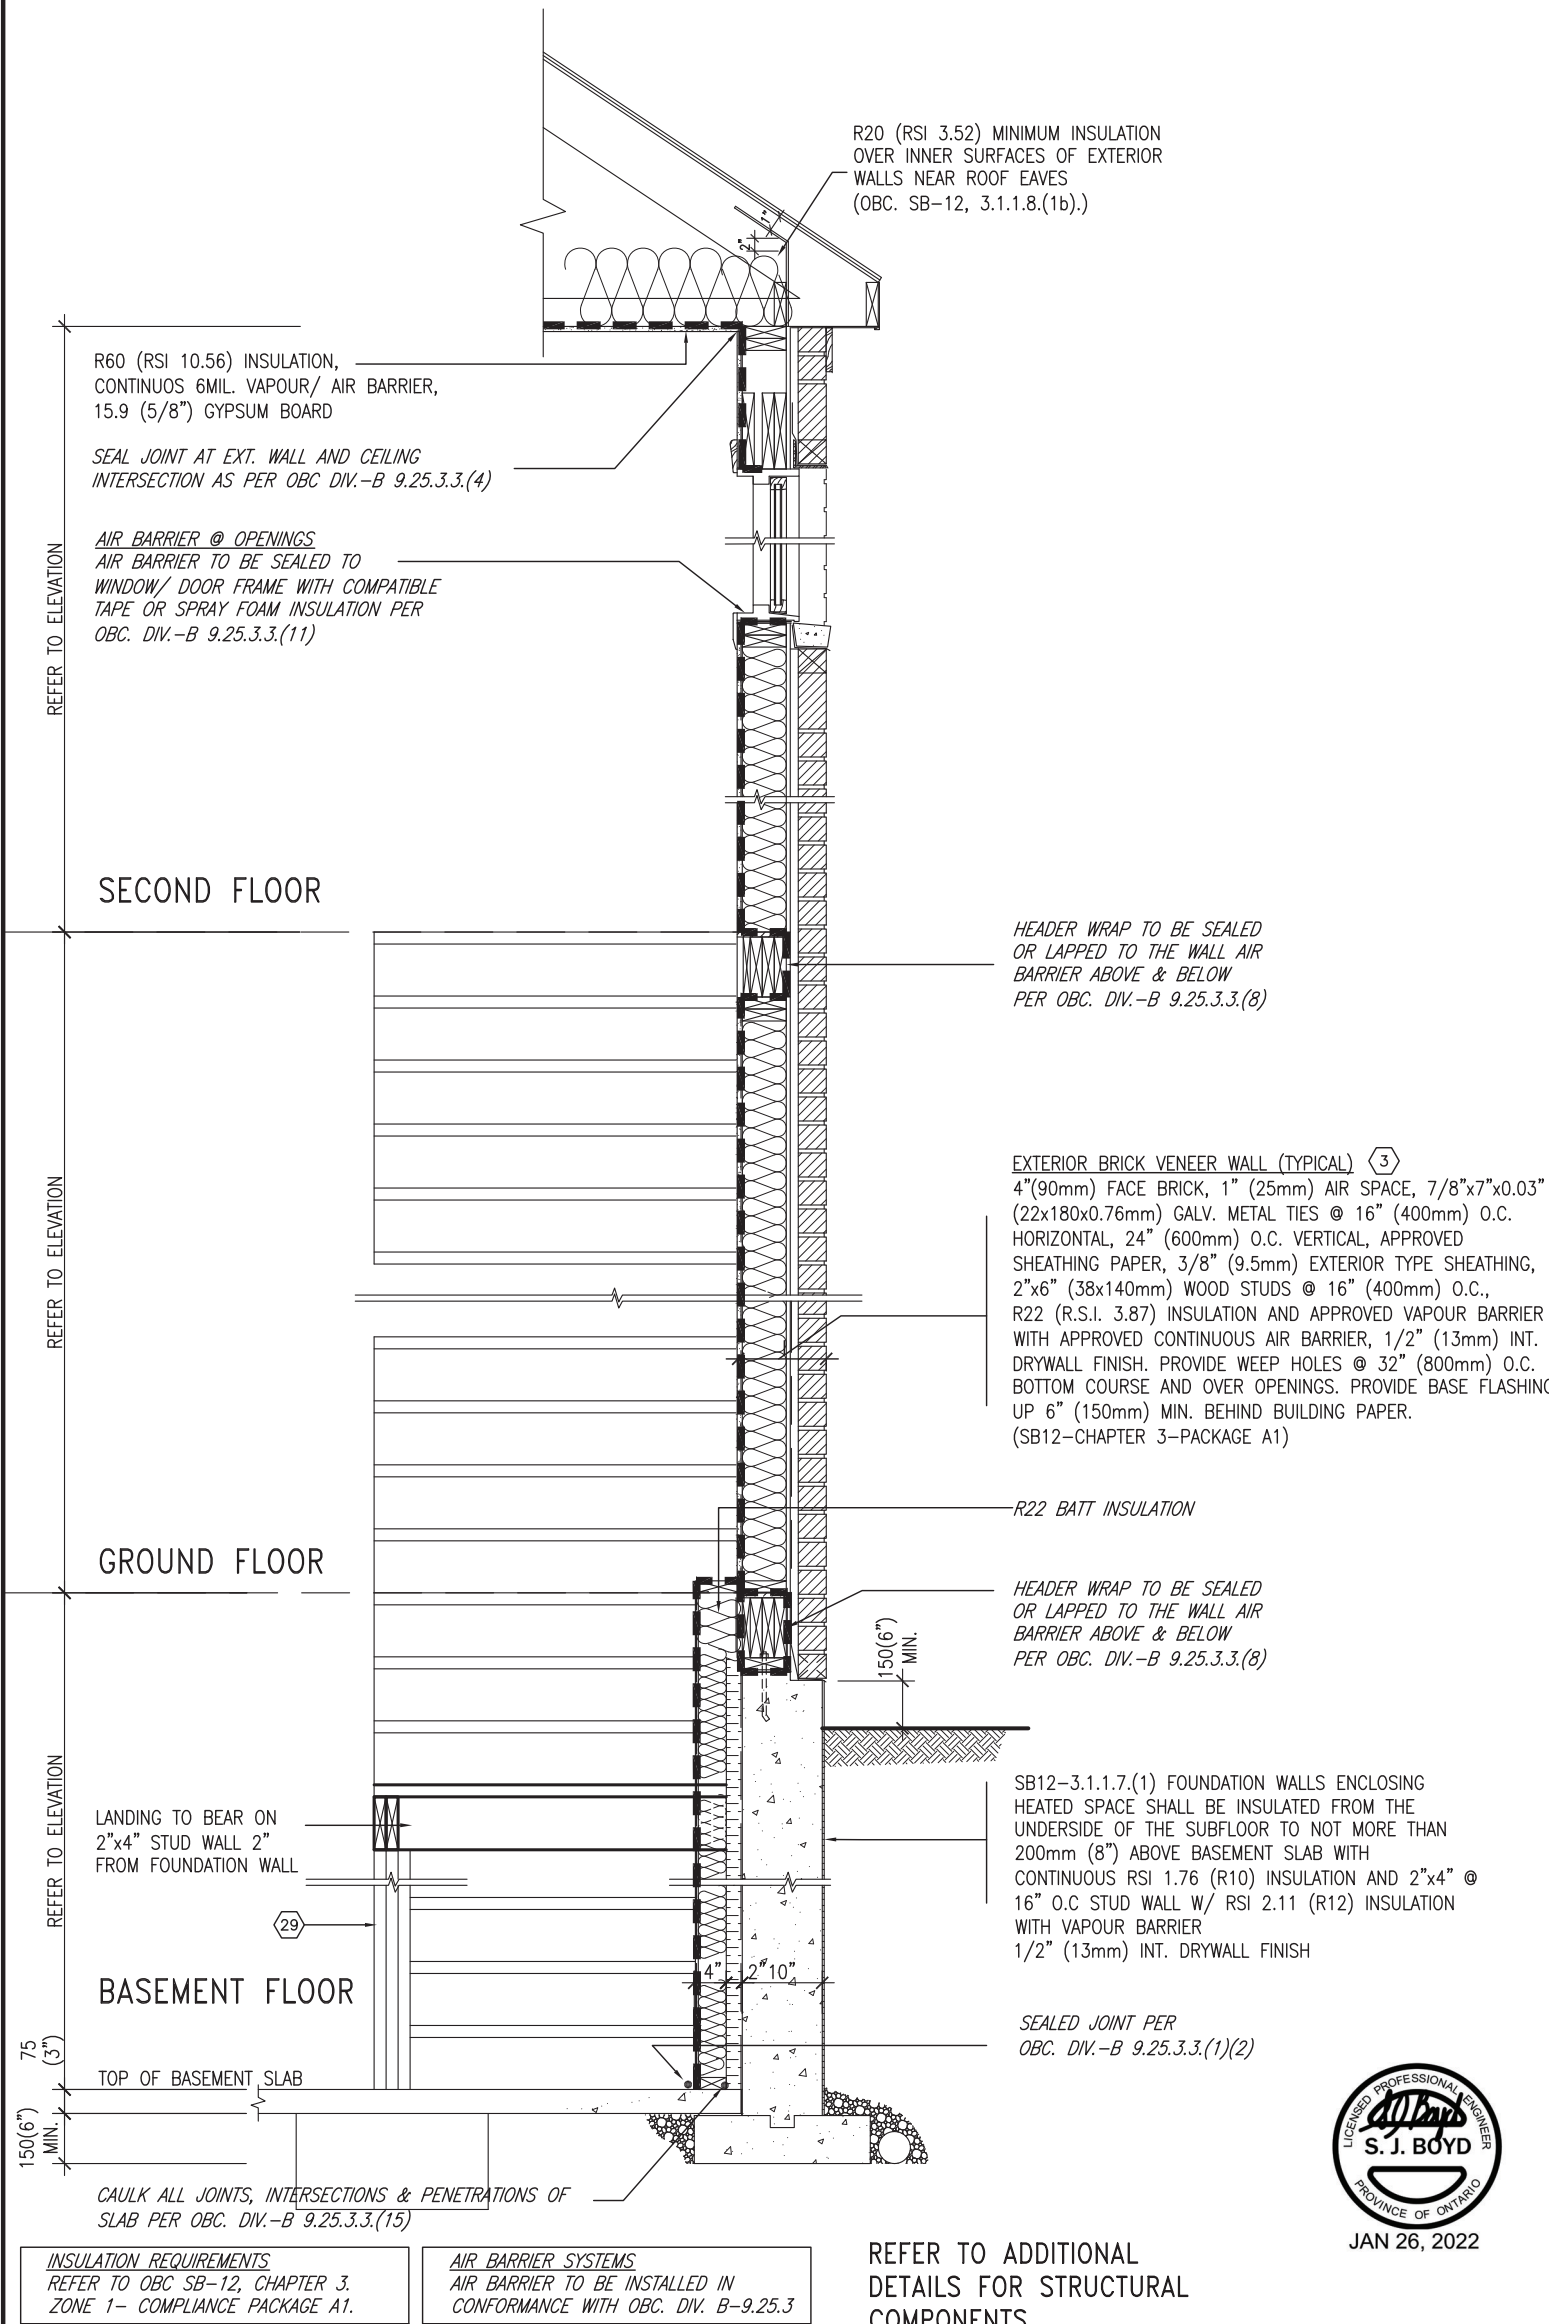COMPLIANCE TO OGC SB-12 2.1.1.1(11)

WOB PLAN

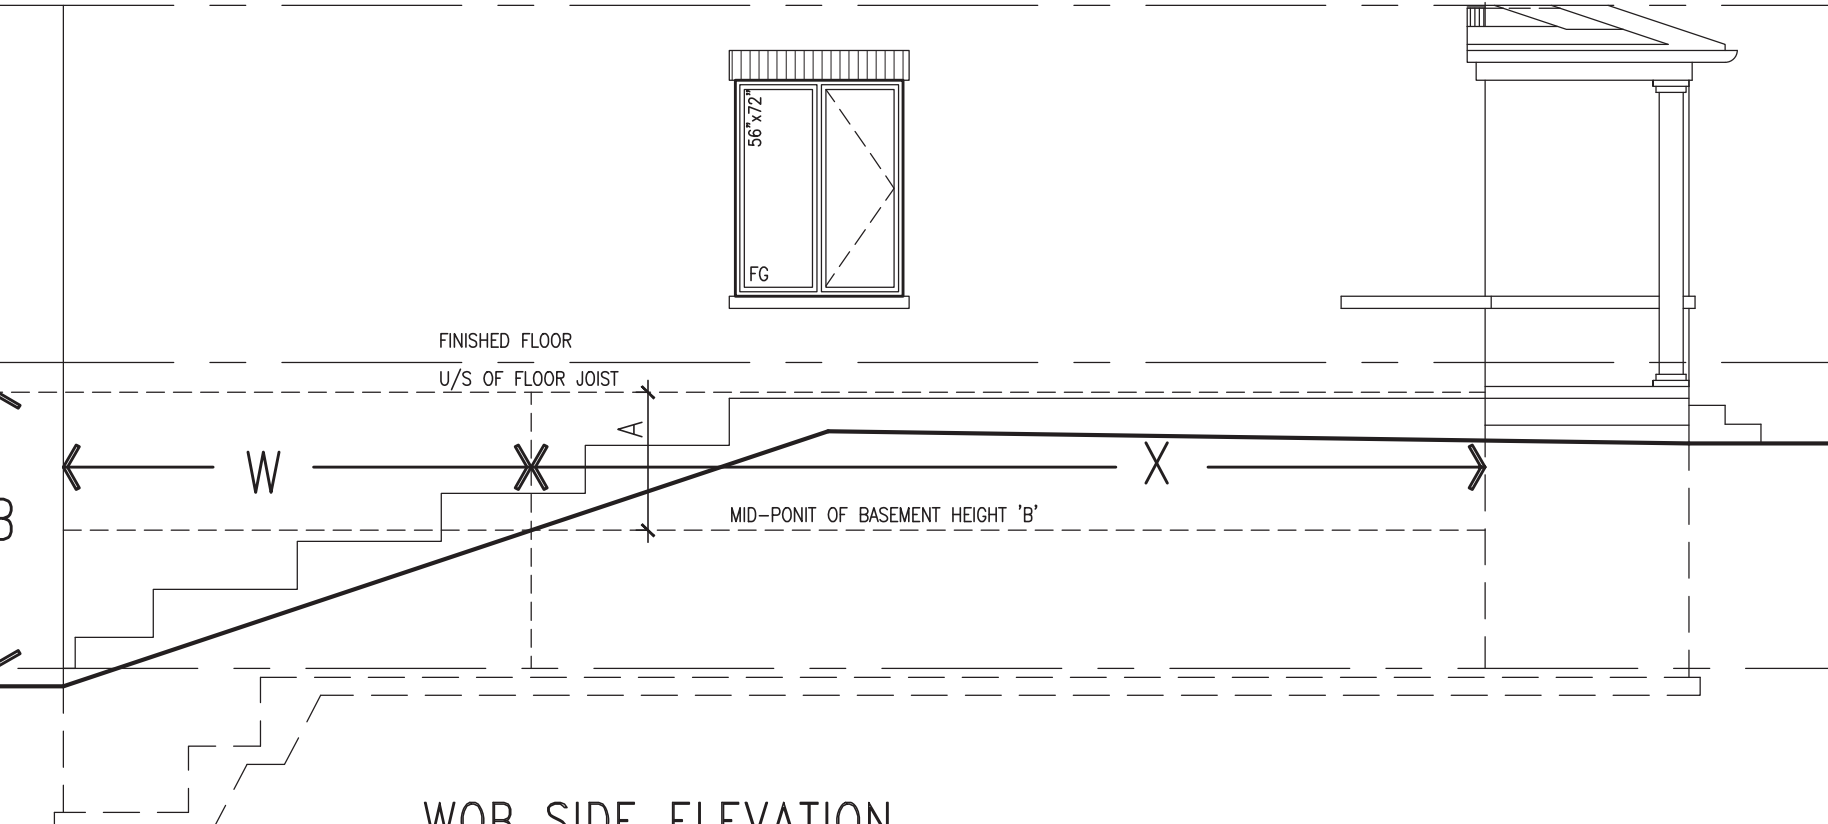

WOB SIDE ELEVATION


WHEN EXPOSED WALL "A" IS GREATER THAN 50%
OF BASEMENT WALL HEIGHT "B"
INSULATION VALUE FOR WALL IN SECTION "W"
IS NOT LESS THAN IS REQUIRED FOR ABOVE
GRADE WALL AS REQUIRED BY TABLE 2.1.1.2A

WHEN EXPOSED WALL "A" IS LESS THAN 50%
OF BASEMENT WALL HEIGHT "B"
INSULATION VALUE FOR WALL IN SECTION "X"
IS NOT LESS THAN BASEMENT WALL AS
REQUIRED BY TABLE 2.1.1.2A




REVIEWED

[illegible]

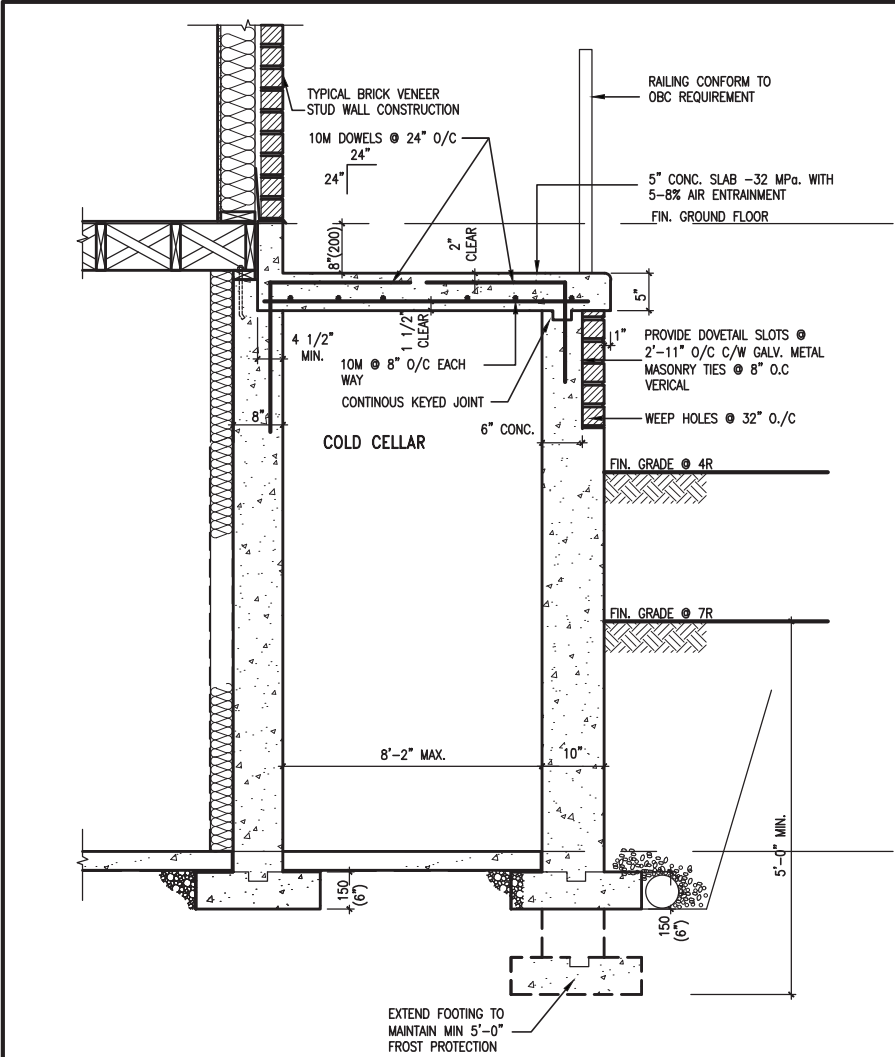

X1 SECTION AT PORCH FOR 4-7R CONDITION
SCALE: N.T.S.

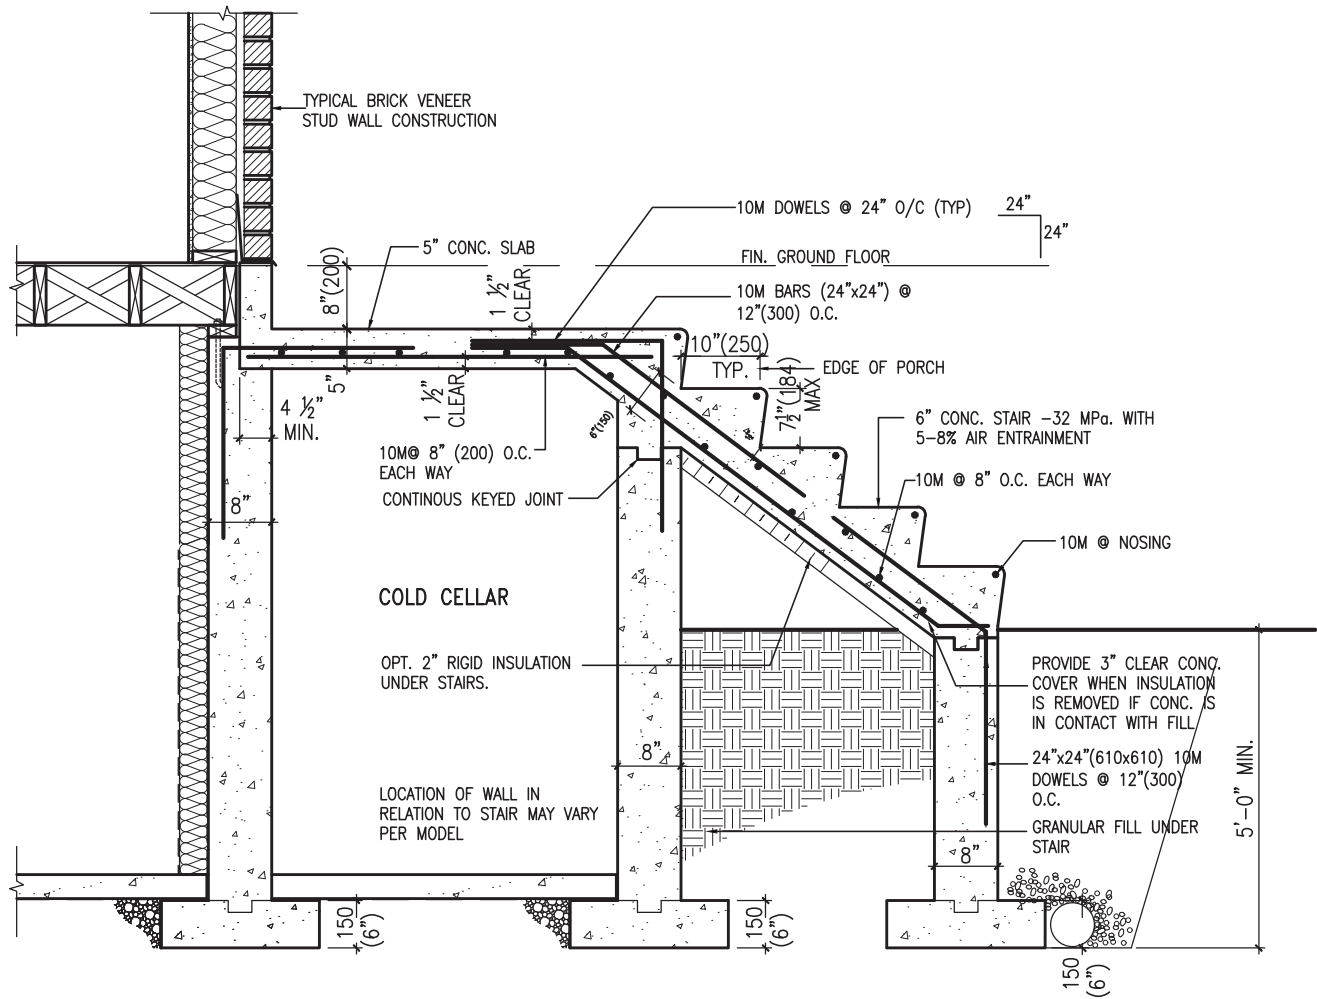

X2 EXTERIOR CONC. STAIR DETAIL (6 RISERS/ 7 RISERS SIMILAR)
SCALE: N.T.S.



JAN 26, 2022

REVIEWED

no.	description	date	by
9			
8			
7			
6			
5			
4	UPDATE TO 2022	JAN 11-22	RC
3	UPDATE TO 2020	FEB 24-20	RC
2	UPDATE TO 2018	JAN 11-18	RC
1	ISSUE FOR CLIENT REVIEW	AUG 04-17	RC

The undersigned has reviewed and takes responsibility for this design and has the qualifications and meets the requirements set out in the Ontario Building Code to be a Designer.

Wellington Jno-Baptiste 25591 BCIN
Signature
VAS Design Inc. 42658
Contractor must verify all dimensions on the job and report any discrepancy to the Designer before proceeding with the work. All drawings and specifications are instruments of service and the property of the Designer which must be returned at the completion of the work. Drawings are not to be scaled.


VAS3 DESIGN
255 Consumers Rd Suite 120
Toronto, ON M2J 1P4
t 416.630.2255 f 416.630.4782
vas3design.com

project name	municipality	project no.	drawing no.
GREEN VALLEY EAST	BRADFORD	16023	CN9
date	checked by	scale	checked by
MAY 2016	RC	3/16" = 1'-0"	
drawn by	checked by	scale	checked by
RC			

CONST NOTE


CONSTRUCTION NOTES

16023-CN-2022-A1
16023-CN-2022-A1.dwg - Wed - Jan 26 2022 - 12:06 PM

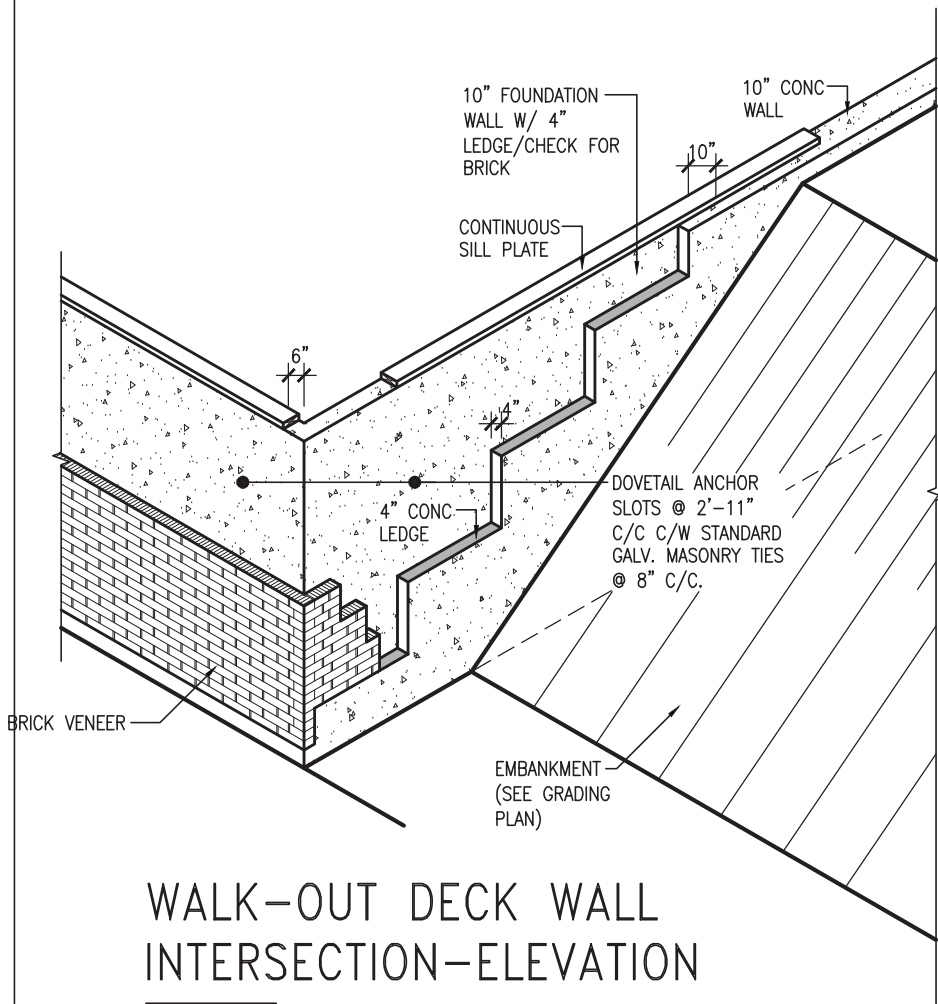

WALK-OUT DECK WALL INTERSECTION-ELEVATION


NOT TO SCALE

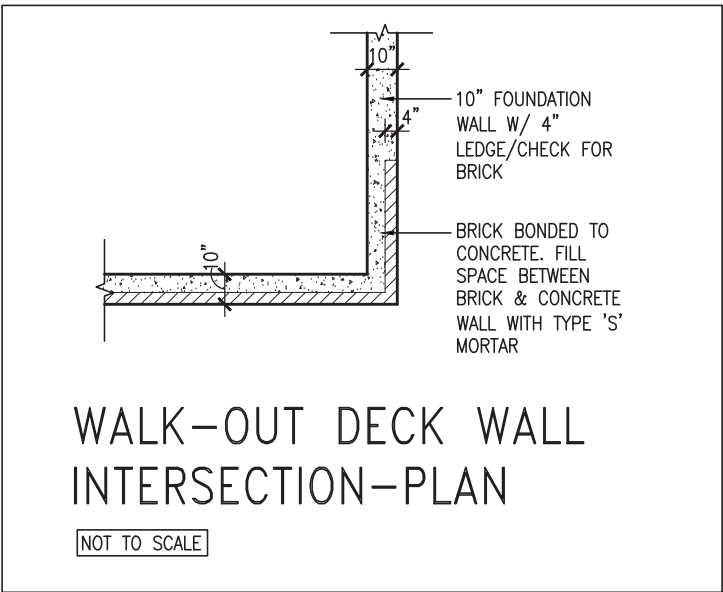

WALK-OUT DECK WALL INTERSECTION-PLAN


NOT TO SCALE

(10" FOUNDATION WALL)

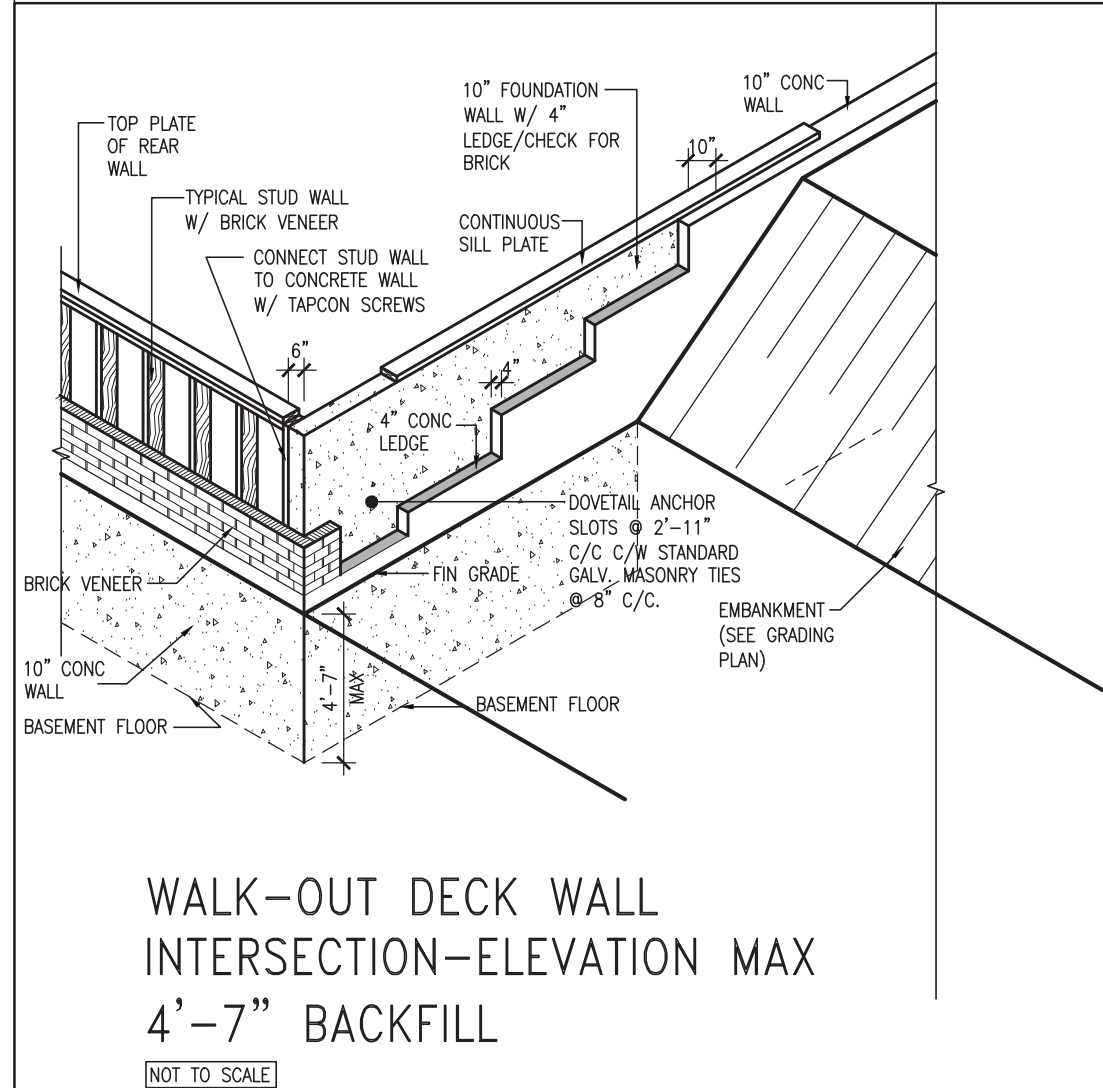

WALK-OUT DECK WALL INTERSECTION-ELEVATION MAX 4'-7" BACKFILL

NOT TO SCALE

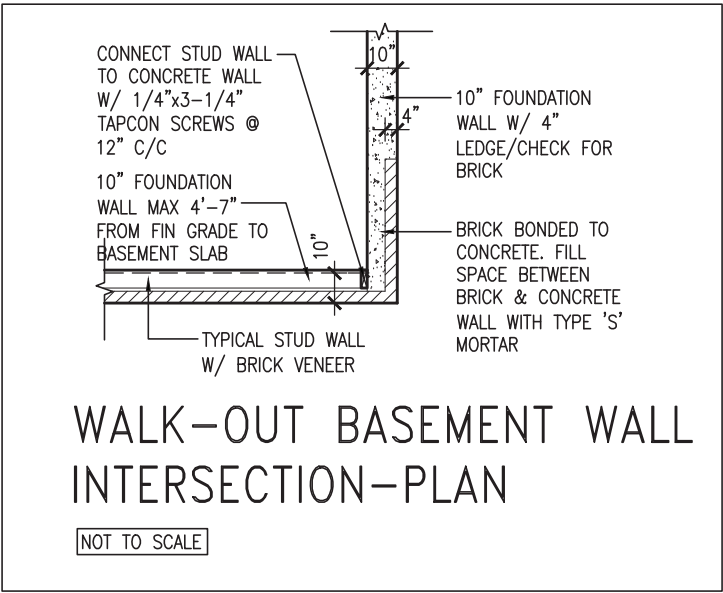

WALK-OUT BASEMENT WALL INTERSECTION-PLAN

NOT TO SCALE

(10" FOUNDATION WALL)



9	REVIEWED
8	
7	
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4	UPDATE TO 2022
3	UPDATE TO 2020
2	UPDATE TO 2018
1	ISSUE FOR CLIENT REVIEW
no.	description


The undersigned has reviewed and takes responsibility for this design and has the qualifications and meets the requirements set out in the Ontario Building Code to be a Designer.		
qualification information		
Wellington Jno-Baptiste	signature	25591
name	BCIN	
registration information		42658
VA3 Design Inc.		
Contractor must verify all dimensions on the job and report any discrepancy to the Designer before proceeding with the work. All drawings and specifications are instruments of service and the property of the Designer which must be returned at the completion of the work. Drawings are not to be scaled.		
date	by	

VA3 DESIGN

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Toronto ON M2J 1R4
t 416.630.2255 f 416.630.4782
va3design.com


BAYVIEW WELLINGTON	
project name	municipality
GREEN VALLEY EAST	BRADFORD
date	scale
MAY 2016	3/16" = 1'-0"
drawn by	checked by
RC	
RICHARD - H:\ARCHIVE\WORKING\2016\16023.BW\Units\CN NOTES\16023-CN-2022-A1.dwg - Wed - Jan 26 2022 - 12:06 PM	

CONST NOTE	
-	
project no.	16023
file name	CN10
drawing no.	

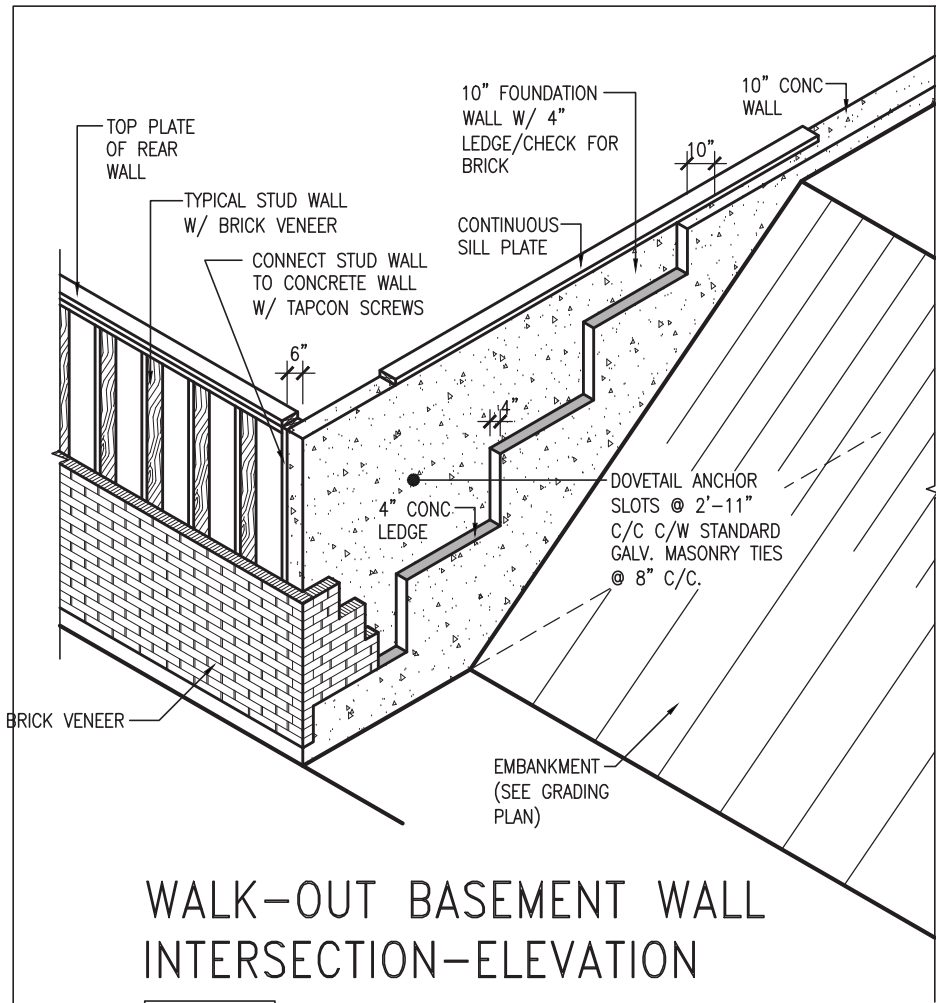

WALK-OUT BASEMENT WALL
INTERSECTION-ELEVATION


NOT TO SCALE

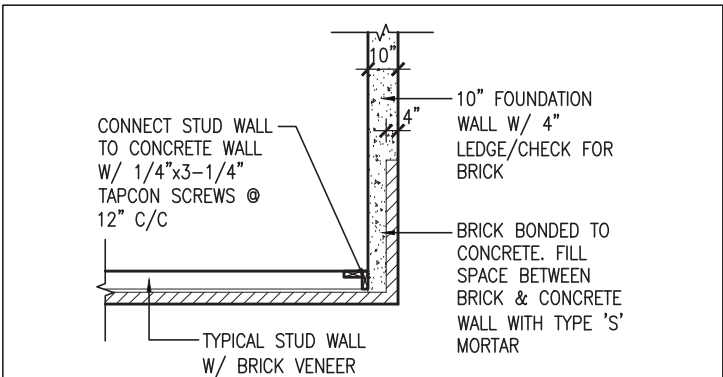

WALK-OUT BASEMENT WALL
INTERSECTION-PLAN


NOT TO SCALE

(10" FOUNDATION WALL)

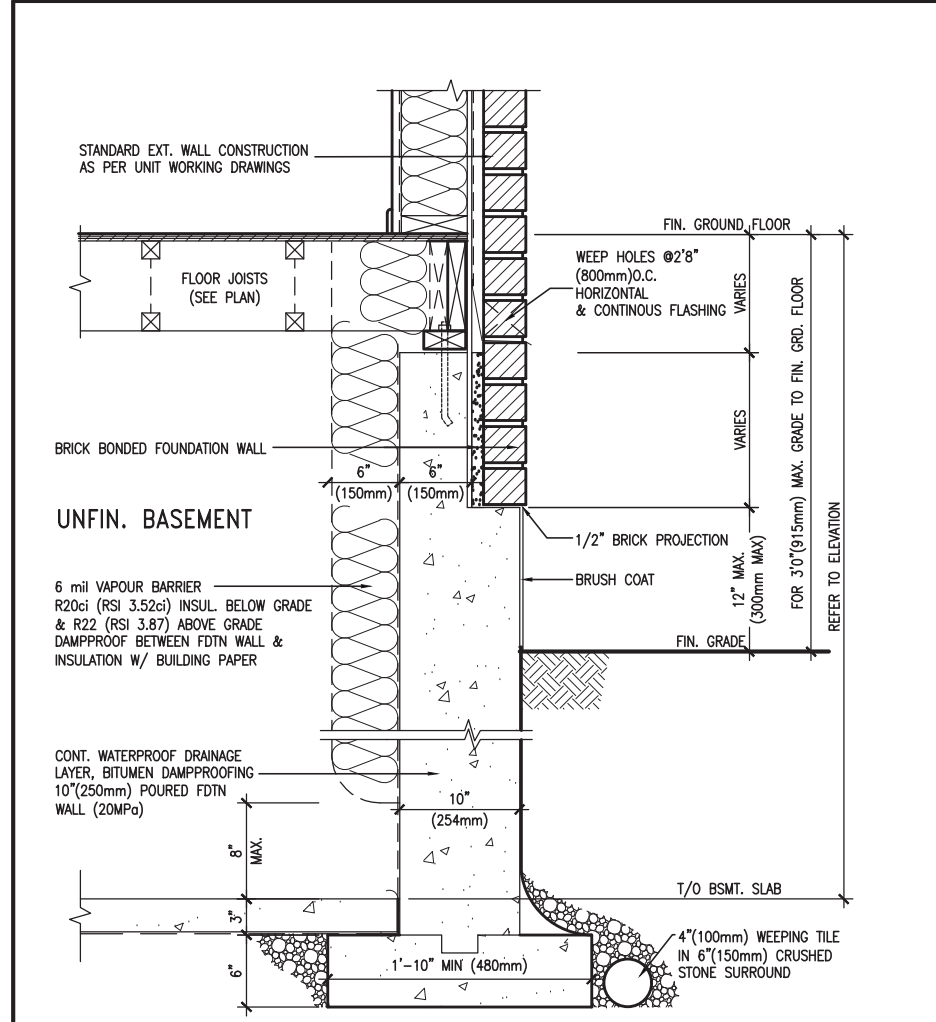

WALL SECTION FOR GRADE TO FIN.
FLOOR MORE THAN 4'7" (1400mm)
HEIGHT DIFFERENCE

SCALE: N.T.S.

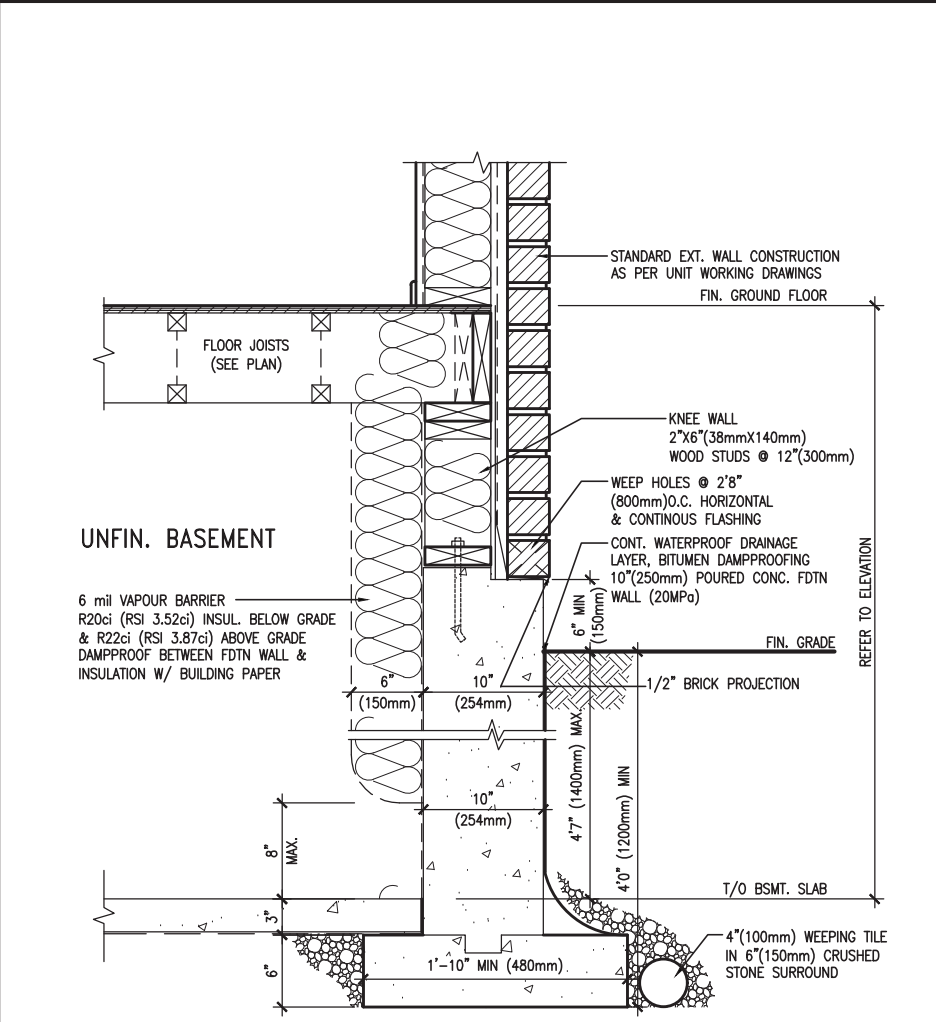

WALL SECTION FOR GRADE TO BASEMENT
SLAB 4'7"(1400mm)
MAX. HEIGHT DIFFERENCE

SCALE: N.T.S.



9	REVIEWED
8	
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3	UPDATE TO 2020
2	UPDATE TO 2018
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no.	description

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name	BCIN	
registration information		42658
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BAYVIEW WELLINGTON			CONST NOTE	
project name			project no.	
GREEN VALLEY EAST			16023	
municipality				
BRADFORD				
date			drawing no.	
MAY 2016			CONSTRUCTION NOTES	
drawn by		checked by	scale	file name
RC		-	3/16" = 1'-0"	16023-CN-2022-A1
RICHARD - H:\ARCHIVE\WORKING\2016\16023.BW\Units\CN NOTES\16023-CN-2022-A1.dwg - Wed - Jan 26 2022 - 12:06 PM				

PREFIN. METAL ROOF
CAP OVER WATERPROOF
MEMBRANE

5/8" T&G PLYWOOD
SHEATHING ON 2"x4"
SLOPED TO FRONT

2"x12" LEDGER

2"x12" @ HEADER

3"x3"x1 1/16" GALVANIZED
STANLEY CORNER BRACE
C/W (4) No. 10x1 1/2"
SCREWS AT 4'-0" O.C.

PREFIN. ALUM. FASCIA
AND SOFFIT AT U/S

DRIP EDGE

STL. LINTEL

TYPICAL BRICK VENEER
WALL CONSTRUCTION

HEATED SPACE

ENG. FLOOR JOIST

SECOND FLOOR

MIN. 6" PREFIN. METAL FLASHING W/
CAULKING TO MATCH BRICK/STONE

BUILT-UP CANOPY BOLTED THRU
LVL/WOOD BEAM (SEE UNIT PLANS) W/
1/2" Ø BOLTS STAGGERED @ 24" O.C.
W/ SOLID WD. BLK. BETWEEN STUDS

1

CN12

SECTION THROUGH CANOPY

SCALE 1/2" = 1'-0"



REVIEWED

The undersigned has reviewed and takes responsibility for this design and has the qualifications and meets the requirements set out in the Ontario Building Code to be a Designer.			
qualification information			
Wellington-Denis-Baptiste	signature	25591	BCIN
name registration information		42658	
VA3 Design Inc.			
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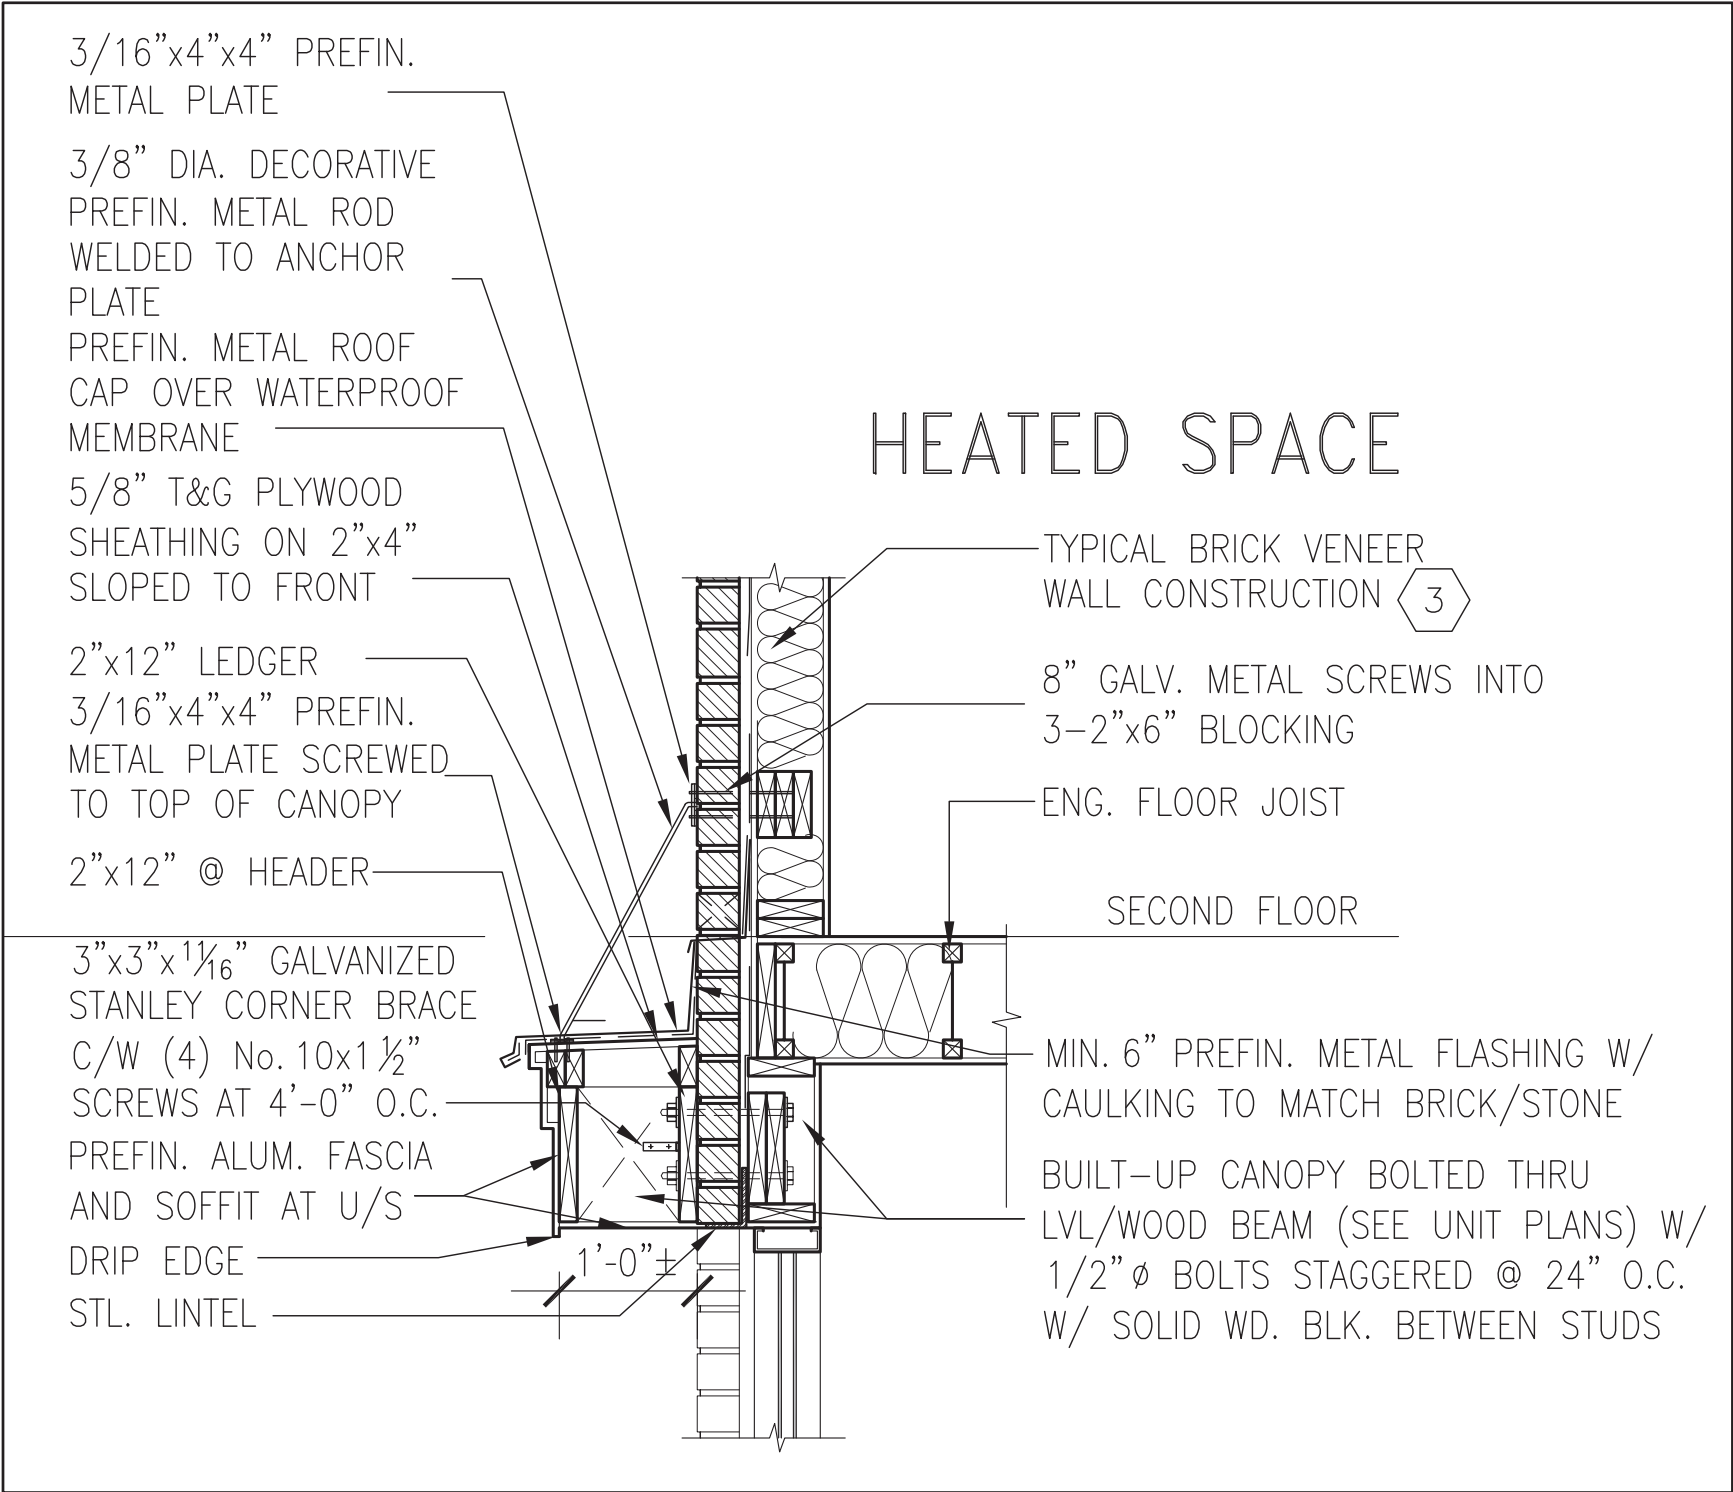
VA3
DESIGN

255 Consumers Rd Suite 120
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va3design.com

BAYVIEW WELLINGTON

CONST NOTE

project name		municipality		project no.	
GREEN VALLEY EAST		BRADFORD		16023	
date				drawing no.	
MAY 2016				CONSTRUCTION NOTES	
drawn by		checked by		scale	
RC		-		3/16" = 1'-0"	
				file name	
				16023-CN-2022-A1	
RICHARD - H:\ARCHIVE\WORKING\2016\16023.BW\Units\CN NOTES\16023-CN-2022-A1.dwg - Wed - Jan 26 2022 - 12:09 PM					



1 SECTION THROUGH CANOPY
CN13 W/ DECORATIVE ROD
SCALE 1/2" = 1'-0"



9			The undersigned has reviewed and takes responsibility for this design and has the qualifications and meets the requirements set out in the Ontario Building Code to be a Designer.			VA3			BAYVIEW WELLINGTON			CONST NOTE		
8			qualification information			signature			municipality			project no.		
7			Wellington-Duro-Baptiste			25591			BRADFORD			16023		
6			name			BCIN			project name			drawing no.		
5			registration information			42658			GREEN VALLEY EAST			CN13		
4			VA3 Design Inc.			Contractor must verify all dimensions on the job and report any discrepancy to the Designer before proceeding with the work. All drawings and specifications are instruments of service and the property of the Designer which must be returned at the completion of the work. Drawings are not to be scaled.			date			CONSTRUCTION NOTES		
3			UPDATE TO 2022			JAN 11-22			RC			MAY 2016		
2			UPDATE TO 2020			FEB 24-20			RC			drawn by		
1			UPDATE TO 2018			JAN 11-18			RC			checked by		
no.			description			date			by			scale		
no.			description			date			by			file name		
no.			description			date			by			16023-CN-2022-A1		
no.			description			date			by			RICHARD - H:\ARCHIVE\WORKING\2016\16023.BW\Units\CN NOTES\16023-CN-2022-A1.dwg - Wed - Jan 26 2022 - 12:09 PM		

3/16"x4"x4" PREFIN.
METAL PLATE

3/8" DIA. DECORATIVE
PREFIN. METAL ROD
WELDED TO ANCHOR
PLATE

PREFIN. METAL ROOF
CAP OVER WATERPROOF
MEMBRANE

5/8" T&G PLYWOOD
SHEATHING ON 2"x4"
SLOPED TO FRONT

2"x12" LEDGER

3/16"x4"x4" PREFIN.
METAL PLATE SCREWED
TO TOP OF CANOPY

2"x12" @ HEADER

3"x3"x1 1/16" GALVANIZED
STANLEY CORNER BRACE
C/W (4) No. 10x1 1/2"
SCREWS AT 4'-0" O.C.

PREFIN. ALUM. FASCIA
AND SOFFIT AT U/S

DRIP EDGE

STL. LINTEL

8" GALV. METAL SCREWS INTO
3-2"x6" BLOCKING

PREFINISHED METAL FLASHING
OVER WATERPROOF MEMBRANE

2"x6" @ 12" O.C. NAILED TO
2"x8" JOIST BELOW

CANT STRIP

ROOF NOTE R1

SINGLE PLY ROOF MEMBRANE
W/5/8" EXTERIOR GRADE

SHEATHING W/ 2"x4" @ 12"
O.C. DIAGONALLY CUT CROSS
PURLINS 2"x8" @ 16" O.C. W/

MIN. 6" PREFIN. METAL FLASHING W/
CAULKING TO MATCH BRICK/STONE

BUILT-UP CANOPY BOLTED THRU
LVL/WOOD BEAM (SEE UNIT PLANS) W/
1/2" Ø BOLTS STAGGERED @ 24" O.C.
W/ SOLID WD. BLK. BETWEEN STUDS

1

CN14

SECTION THROUGH CANOPY

W/ DECORATIVE ROD

SCALE 1/2" = 1'-0"



REVIEWED			The undersigned has reviewed and takes responsibility for this design and has the qualifications and meets the requirements set out in the Ontario Building Code to be a Designer.			VA3 DESIGN			BAYVIEW WELLINGTON			CONST NOTE								
			Wellington-Duro-Baptiste			signature			25591			project name			municipality			project no.		
			name			signature			BCIN			GREEN VALLEY EAST			BRADFORD			16023		
			registration information			VA3 Design Inc.			42658			date			CONSTRUCTION NOTES			drawing no.		
4			UPDATE TO 2022			JAN 11-22			RC			MAY 2016								
3			UPDATE TO 2020			FEB 24-20			RC			drawn by			checked by			scale		
2			UPDATE TO 2018			JAN 11-18			RC			RC			-			3/16" = 1'-0"		
1			ISSUE FOR CLIENT REVIEW			AUG 04-17			RC									file name		
no.			description			date			by			Contractor must verify all dimensions on the job and report any discrepancy to the Designer before proceeding with the work. All drawings and specifications are instruments of service and the property of the Designer which must be returned at the completion of the work. Drawings are not to be scaled.			16023-CN-2022-A1			CN14		
												255 Consumers Rd Suite 120 Toronto ON M2J 1R4 t 416.630.2255 f 416.630.4782 va3design.com			RICHARD - H:\ARCHIVE\WORKING\2016\16023.BW\Units\CN NOTES\16023-CN-2022-A1.dwg - Wed - Jan 26 2022 - 12:09 PM					