


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This is to certify that these plans comply with the applicable Architectural Design Guidelines approved by the Town of Bradford / West Gwillimbury.

JOHN G. WILLIAMS LTD., ARCHITECT
ARCHITECTURAL CONTROL REVIEW
AND APPROVAL

APPROVED BY: 
DATE: MAR 03, 2022

This stamp certifies compliance with the applicable Design Guidelines only and bears no further professional responsibility.

REVIEWED

BASEMENT INSULATION AT STAIR/SUNKEN AREA

- 2" (R10) CONTINUOUS INSULATION (RIGID OR SPRAY FOAM)
- 2"x4" @ 16" O.C. W/ R12 BATT INSULATION & 1/2" DRYWALL FINISH
- EXTENDED EXTERIOR WALL FT'G. TO SUPPORT 2"x4" WALL WHERE LOAD BEARING



NOTE J1
PROVIDE SOLID BLOCKING @ 24" O.C. @ FIRST JOIST SPACE FOR FLOOR JOISTS RUNNING PARALLEL TO FOUNDATION WALL (TYPICAL)

NOTE: FLOOR FRAMING INFO REFER TO SHOP DRAWINGS FOR ALL TRUSS-JOIST INFORMATION AND DETAILS, UNLESS OTHERWISE NOTED.

MIN. SOIL BEARING CAPACITY OF 150KPa

BASEMENT PLAN 'A'

AREA CHART ON PAGE 6

NOTE: SPACE ALL FLOOR JOISTS @ 12" O.C. UNDER ALL CERAMIC TILE AREAS.

NOTE: ALL LVL'S SUPPORTING FLOOR LOADS ARE TO BE SPECIFIED BY FLOOR TRUSS MANUFACTURER.

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2.	REVISED AS PER ENG'S COMMENTS	FEB 25-22	RC	.
1.	ISSUED FOR CLIENT REVIEW	NOV 23-21	VA3	.
no.	description	date	by	.

The undersigned has reviewed and takes responsibility for this design and has the qualifications and meets the requirements set out in the Ontario Building Code to be a Designer.

qualification information
Wellington Jno-Baptiste 25591
name
registration information BCIN
VA3 Design Inc. 42658

Contractor must verify all dimensions on the job and report any discrepancy to the Designer before proceeding with the work. All drawings and specifications are instruments of service and the property of the Designer which must be returned at the completion of the work. Drawings are not to be scaled.

VA3 DESIGN

255 Consumers Rd Suite 120
Toronto ON M2J 1R4
t 416.630.2255 f 416.630.4782
va3design.com

BAYVIEW WELLINGTON			S38-19	
project name GREEN VALLEY EAST		municipality BRADFORD		project no. 16023
date OCTOBER 2021		BASEMENT PLAN 'A'		drawing no.
drawn by NS	checked by JWM	scale 3/16" = 1'-0"	file name 16023-S38-19	1
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JOHN G. WILLIAMS LTD., ARCHITECT
ARCHITECTURAL CONTROL REVIEW
AND APPROVAL

APPROVED BY:
DATE: MAR 03, 2022

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NOTE W1
PROVIDE 2-15M FULL HEIGHT VERTICAL REBARS EACH SIDE OF OPENING + 2-15M HORIZ. REBARS BELOW AND EXTEND 24" BEYOND OPENING PROVIDE 3" CLEAR COVER FROM SOIL SIDE

SEE DETAIL S4 FOR 9'-0" BASEMENT COND

REVIEWED




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- 2"x4" @ 16" O.C. W/ R12 BATT INSULATION & 1/2" DRYWALL FINISH
- EXTENDED EXTERIOR WALL FT'G. TO SUPPORT 2"x4" WALL WHERE LOAD BEARING

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NOTE J1
PROVIDE SOLID BLOCKING @ 24" O.C. @ FIRST JOIST SPACE FOR FLOOR JOISTS RUNNING PARALLEL TO FOUNDATION WALL (TYPICAL)



BASEMENT PLAN 'A' (9'0" BASEMENT)

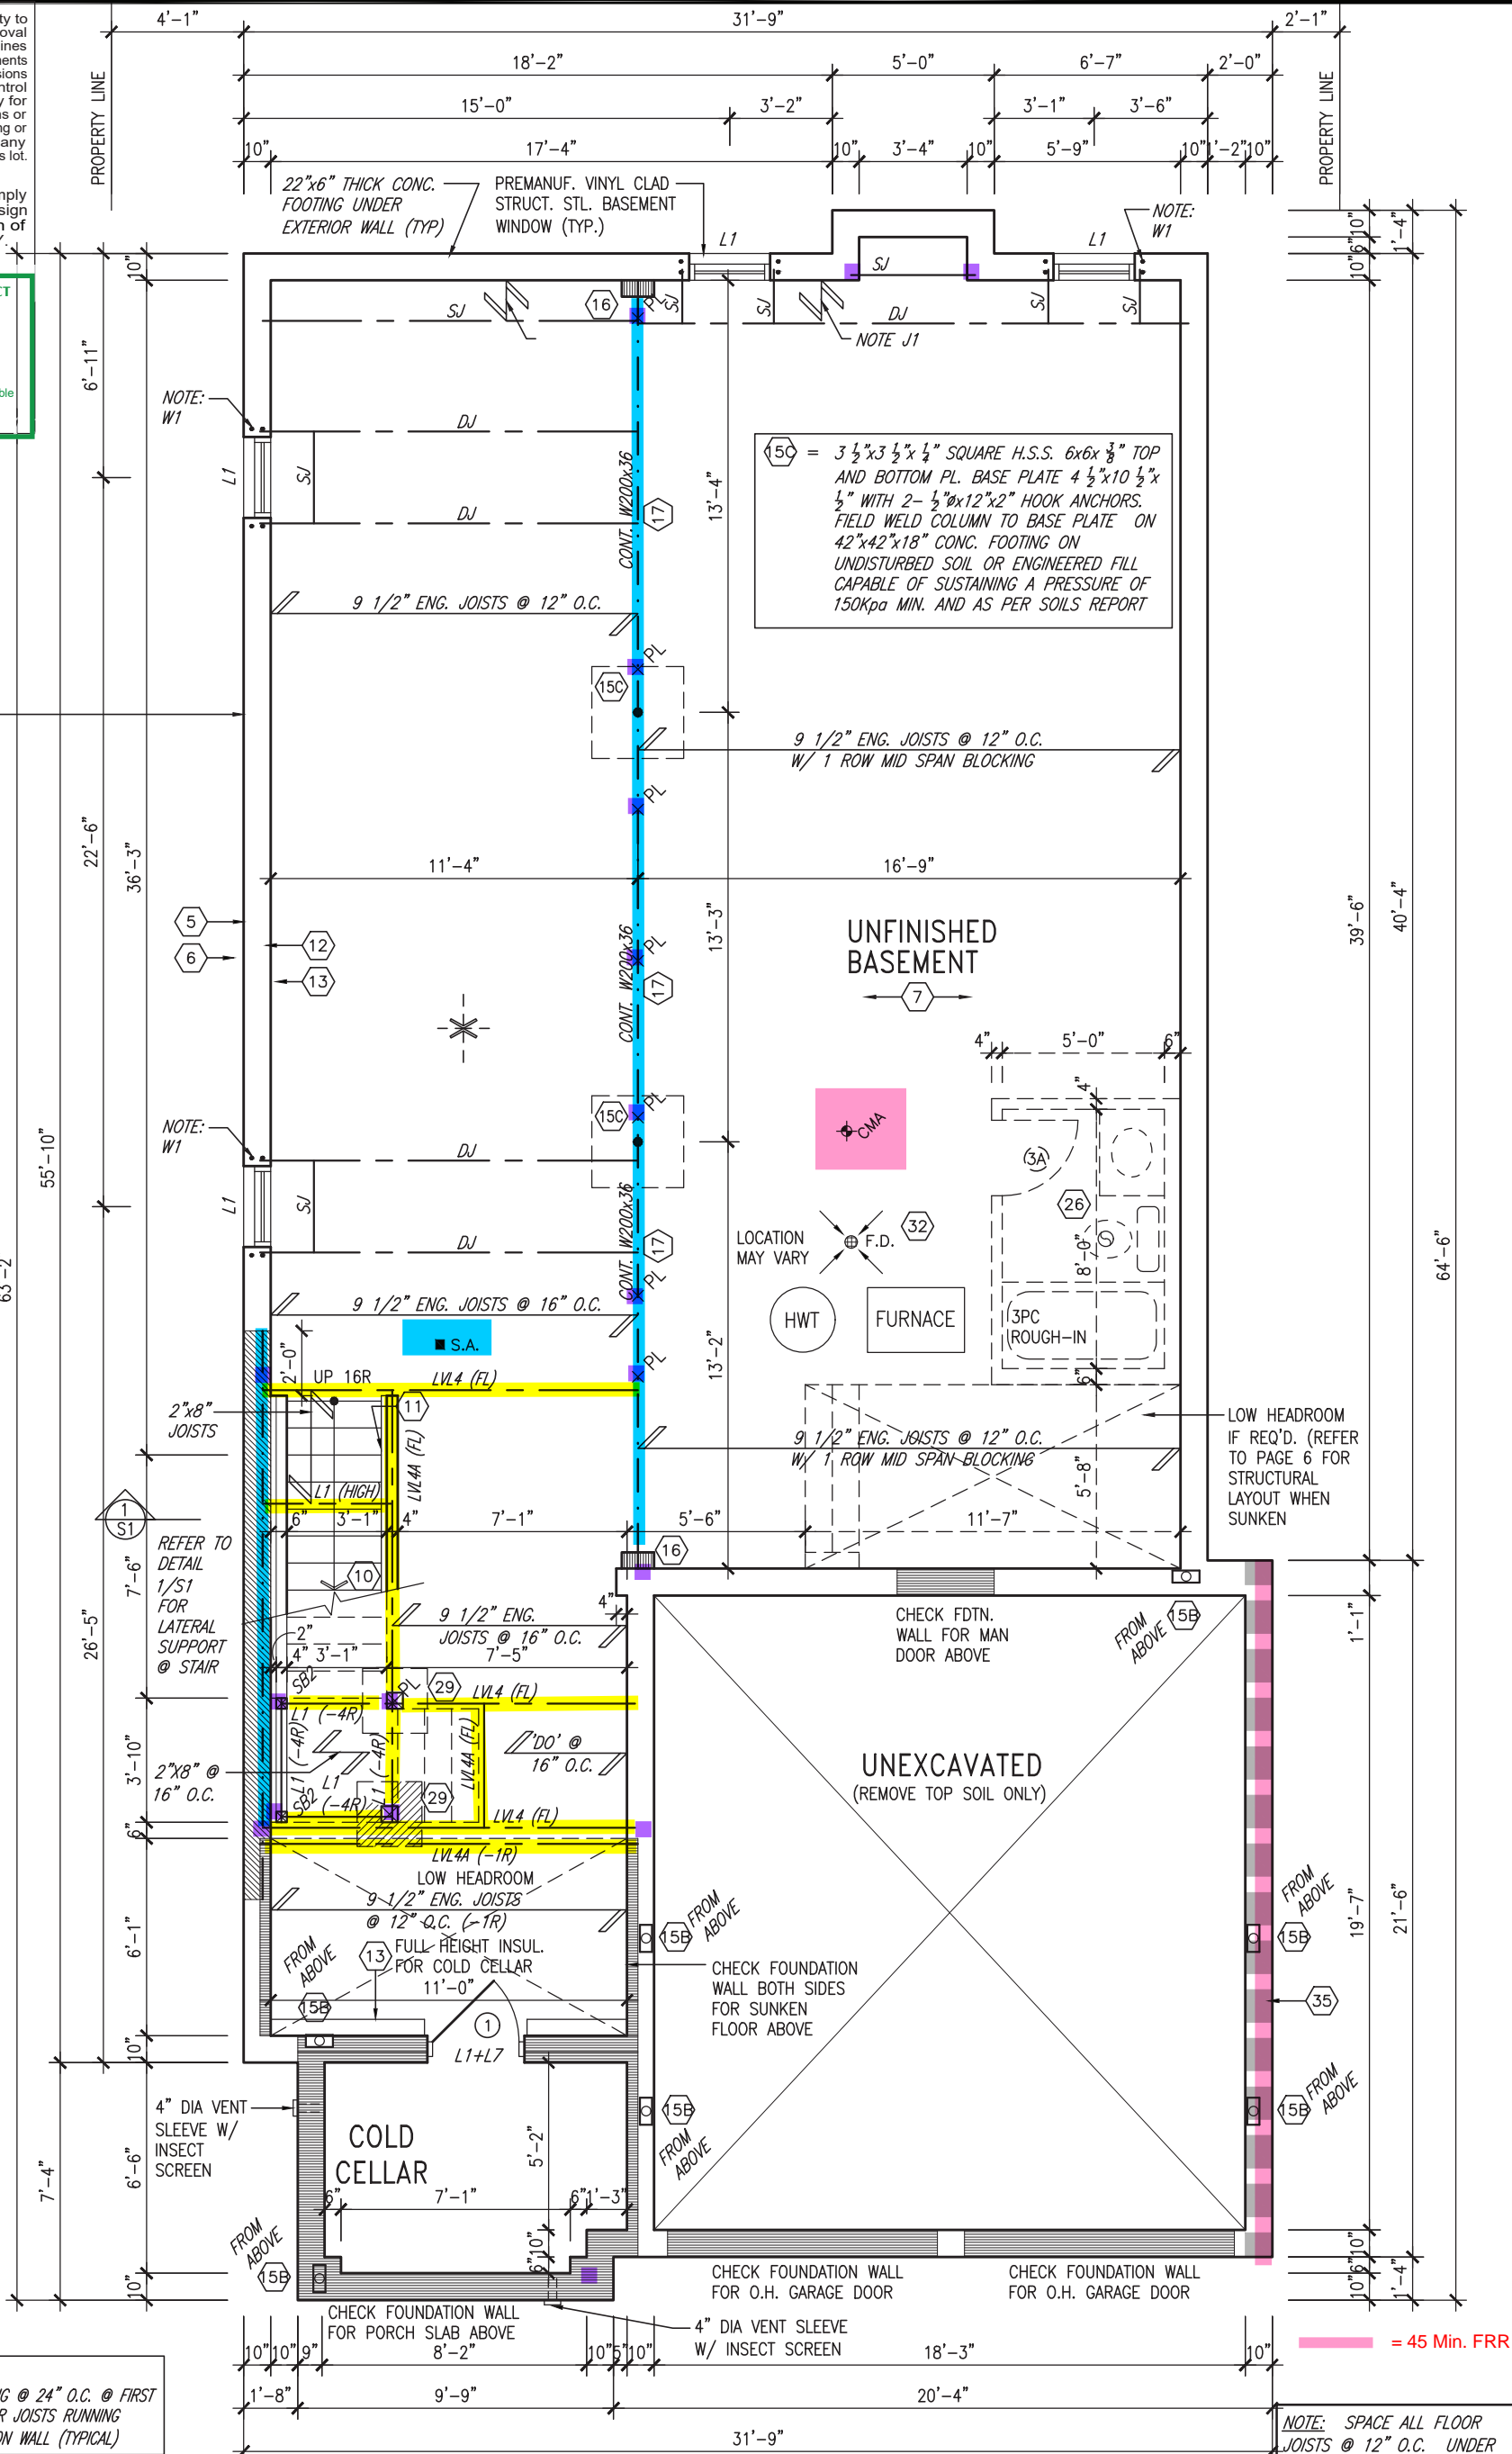NOTE: SPACE ALL FLOOR JOISTS @ 12" O.C. UNDER ALL CERAMIC TILE AREAS.

NOTE: ALL LVL'S SUPPORTING FLOOR LOADS ARE TO BE SPECIFIED BY FLOOR TRUSS MANUFACTURER.

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2.	REVISED AS PER ENG'S COMMENTS	FEB 25-22	RC
1.	ISSUED FOR CLIENT REVIEW	NOV 23-21	VA3
no.	description	date	by

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qualification information
Wellington Jno-Baptiste 25591
name
signature
registration information
VA3 Design Inc. 42658

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BAYVIEW WELLINGTON		S38-19	
project name GREEN VALLEY EAST	municipality BRADFORD	project no. 16023	
date OCTOBER 2021	checked by JWM	scale 3/16" = 1'-0"	file name 16023-S38-19
drawing no. 1A			
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JOHN G. WILLIAMS LTD., ARCHITECT
ARCHITECTURAL CONTROL REVIEW
AND APPROVAL

APPROVED BY:

DATE: MAR 03, 2022

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MAR 1, 2022

OUTDOOR AIR INTAKE SEPARATION
ALL OUTDOOR AIR INTAKE VENTS TO BE SEPARATED A MINIMUM DISTANCE FROM SOURCES OF CONTAMINATION PER OBC, DIV. B- TABLE 6.2.3.12.
• KITCHEN EXHAUST: 3.0m
• DRIVEWAY, PARKING SPACE, ROAD: 1.5m
• SOLID FUEL APPLIANCE EXHAUST: 3.0m
KIT-EX-NOTE-2020.dwg

REVIEWED

ROOF NOTE R1
2"x8" @ 16" O.C. P.T. W/ 2"x4" @ 12" O.C. DIAGONALLY CUT CROSS PURLINS W/ 5/8" EXTERIOR GRADE SHEATHING W/ SINGLE PLY ROOF MEMBRANE

DOOR HEIGHTS	
CEILING HEIGHT	DOOR HEIGHT
11'0" or greater	8'0" (96")
10'0"	8'0" (96")
9'0"	6'8" (80")
8'0" or lower	6'8" (80")

CONTRACTOR TO CONFIRM HEIGHTS WITH BUILDER

9.
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2.	REVISED AS PER ENG'S COMMENTS	FEB 25-22	RC	.	.
1.	ISSUED FOR CLIENT REVIEW	NOV 23-21	VA3	.	.
no.	description	date	by	.	.

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BAYVIEW WELLINGTON		S38-19	
project name	GREEN VALLEY EAST	municipality	BRADFORD
date	OCTOBER 2021	project no.	16023
drawn by	NS	checked by	JWM
scale	3/16" = 1'-0"	file name	16023-S38-19
RICHARD - H:\ARCHIVE\WORKING\2016\16023.BW\Units\38\16023-S38-19.dwg - Tue - Mar 1 2022 - 9:33 AM			

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JOHN G. WILLIAMS LTD., ARCHITECT
ARCHITECTURAL CONTROL REVIEW
AND APPROVAL

APPROVED BY: 
DATE: MAR 03, 2022

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REVIEWED



MAR 1, 2022

GRAB BAR NOTE:


STUD WALL REINFORCEMENT FOR FUTURE GRAB BARS IN MAIN BATHROOM

REINFORCEMENT OF STUD WALLS SHALL BE INSTALLED ADJACENT TO WATER CLOSETS AND SHOWER OR BATHTUB IN MAIN BATHROOM PER OBC, DIV. B-9.5.2.3. REFER TO FOLLOWING SECTIONS FOR THE FIXTURES LISTED. WATER CLOSET: 3.8.3.8.(3)(a) & 3.8.3.8.(3)(c). SHOWER 3.8.3.13.(2)(g). BATHTUB 3.8.3.13.(4)(e). FREE STANDING BATHTUB EXCLUDED. SEE DETAILS PROVIDED.

GB-NOTE-2020.dwg

NOTE:

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SECOND FLOOR PLAN 'A'
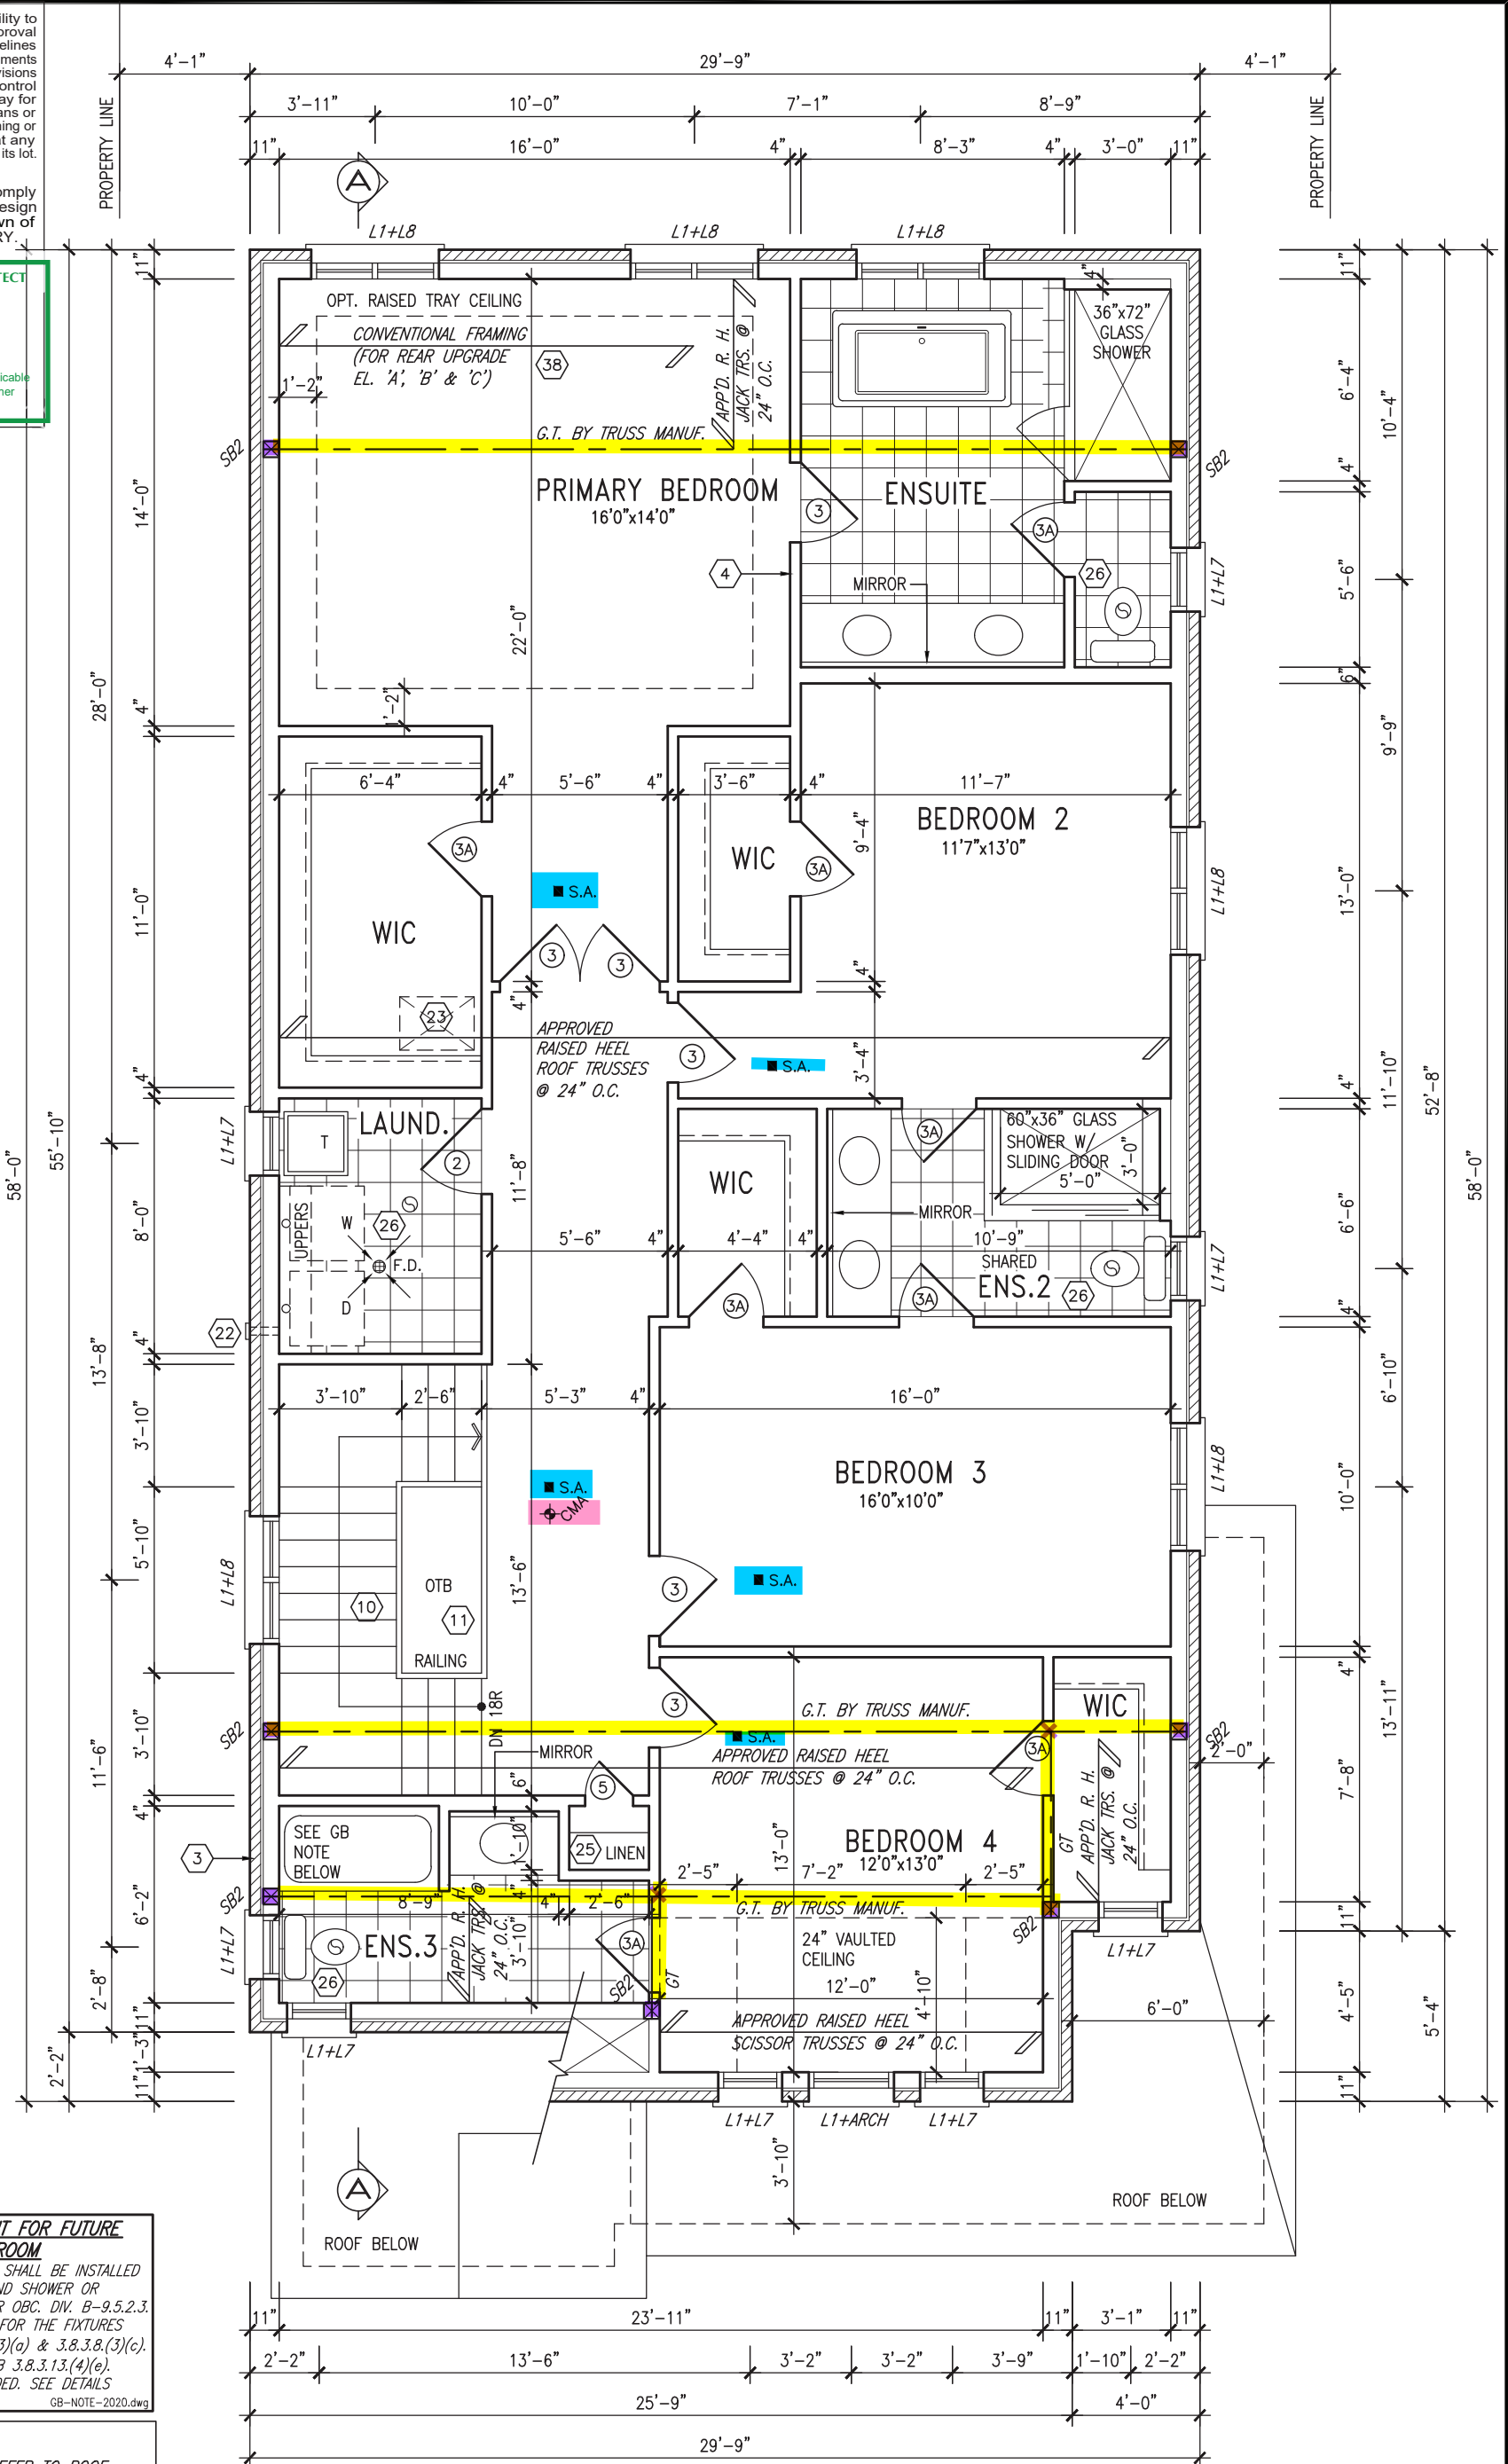
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signature
name
registration information
VA3 Design Inc. 42658
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BAYVIEW WELLINGTON

S38-19

project name	GREEN VALLEY EAST	municipality	BRADFORD	project no.	16023
date	OCTOBER 2021	checked by	JWM	scale	3/16" = 1'-0"
drawn by	NS	file name	16023-S38-19	drawing no.	3
SECOND FLOOR PLAN 'A'					
RICHARD - H:\ARCHIVE\WORKING\2016\16023.BW\Units\38\16023-S38-19.dwg - Tue - Mar 1 2022 - 9:33 AM					

REVIEWED

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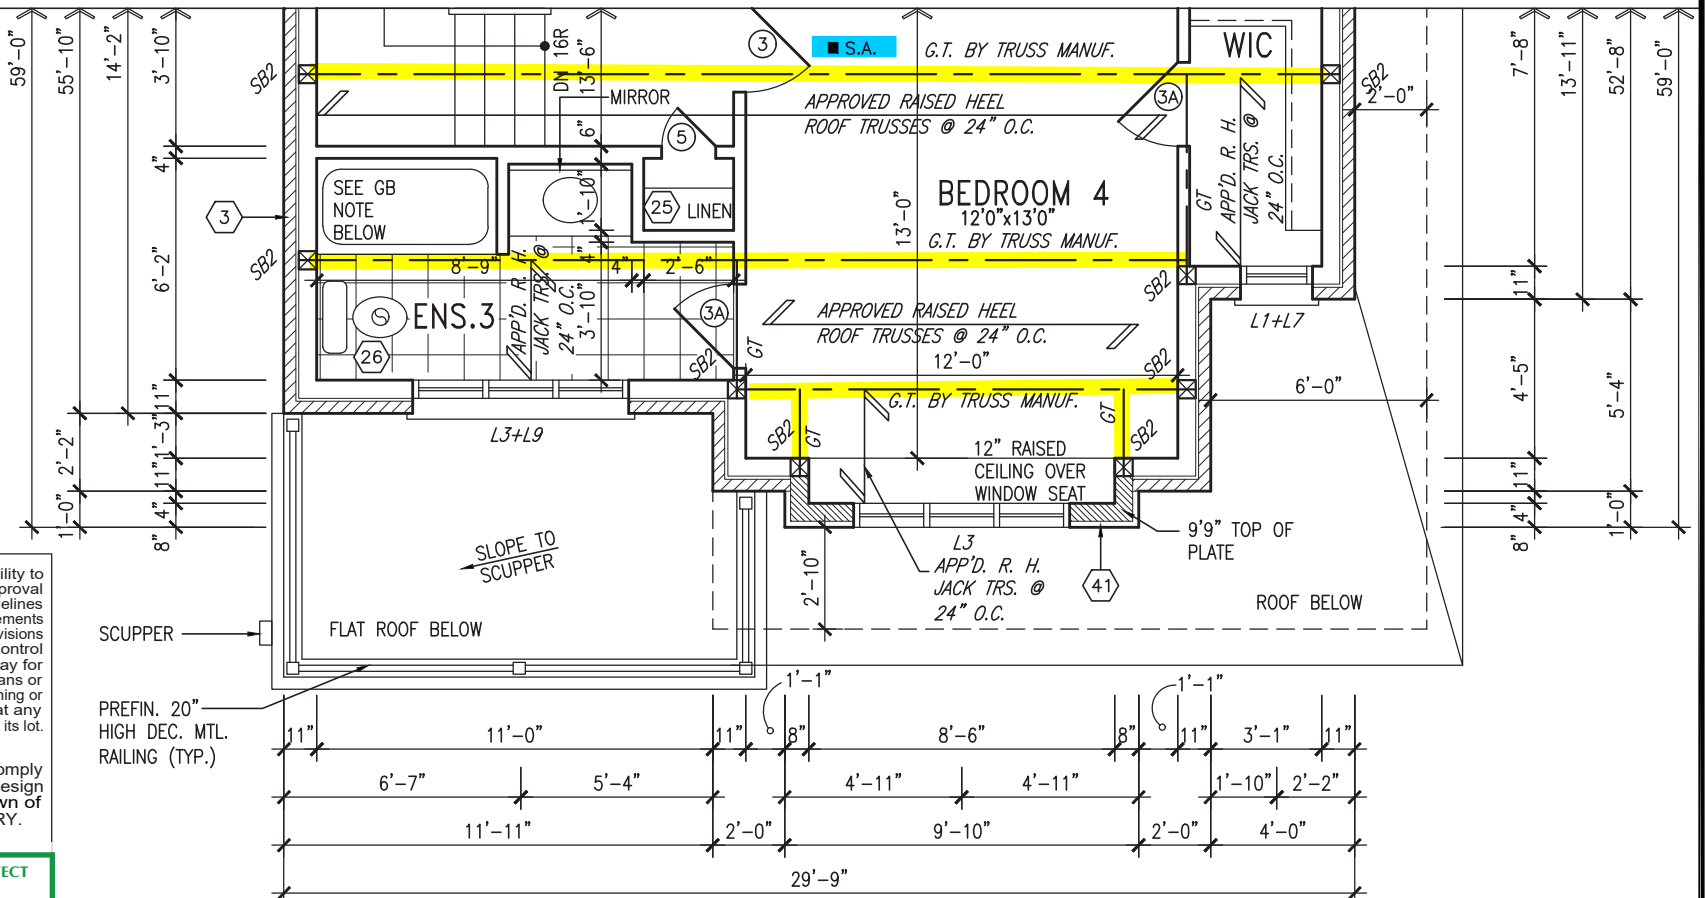
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AND APPROVAL

APPROVED BY:


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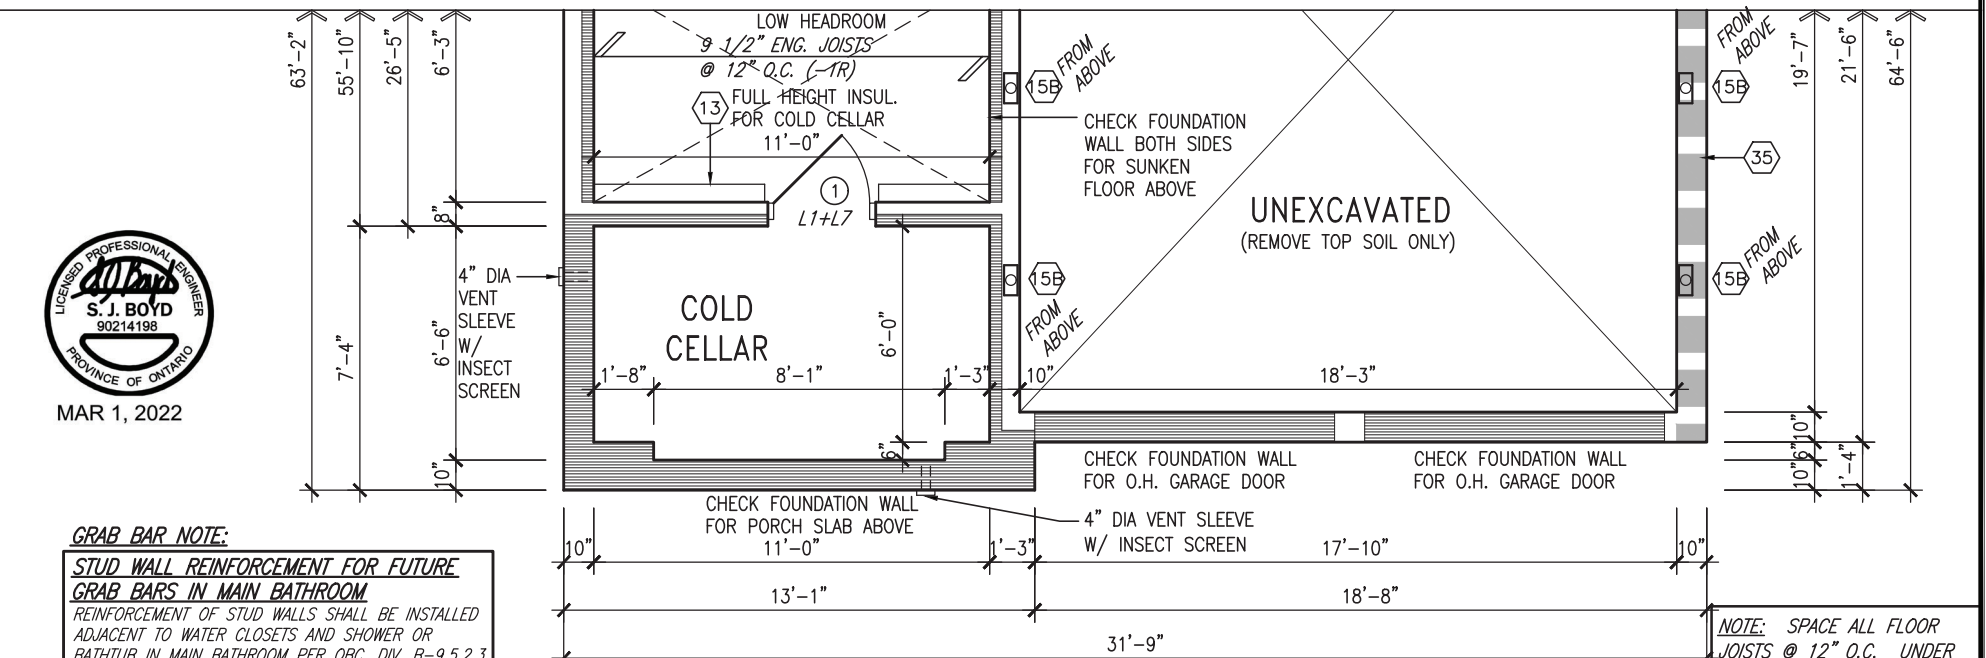


PARTIAL SECOND FLOOR PLAN 'B'

NOTE:
ROOF TRUSS INFORMATION REFER TO ROOF TRUSS SHOP DRAWINGS FOR ALL ROOF FRAMING INFORMATION UNLESS OTHERWISE NOTED.



PARTIAL GROUND FLOOR PLAN 'B'

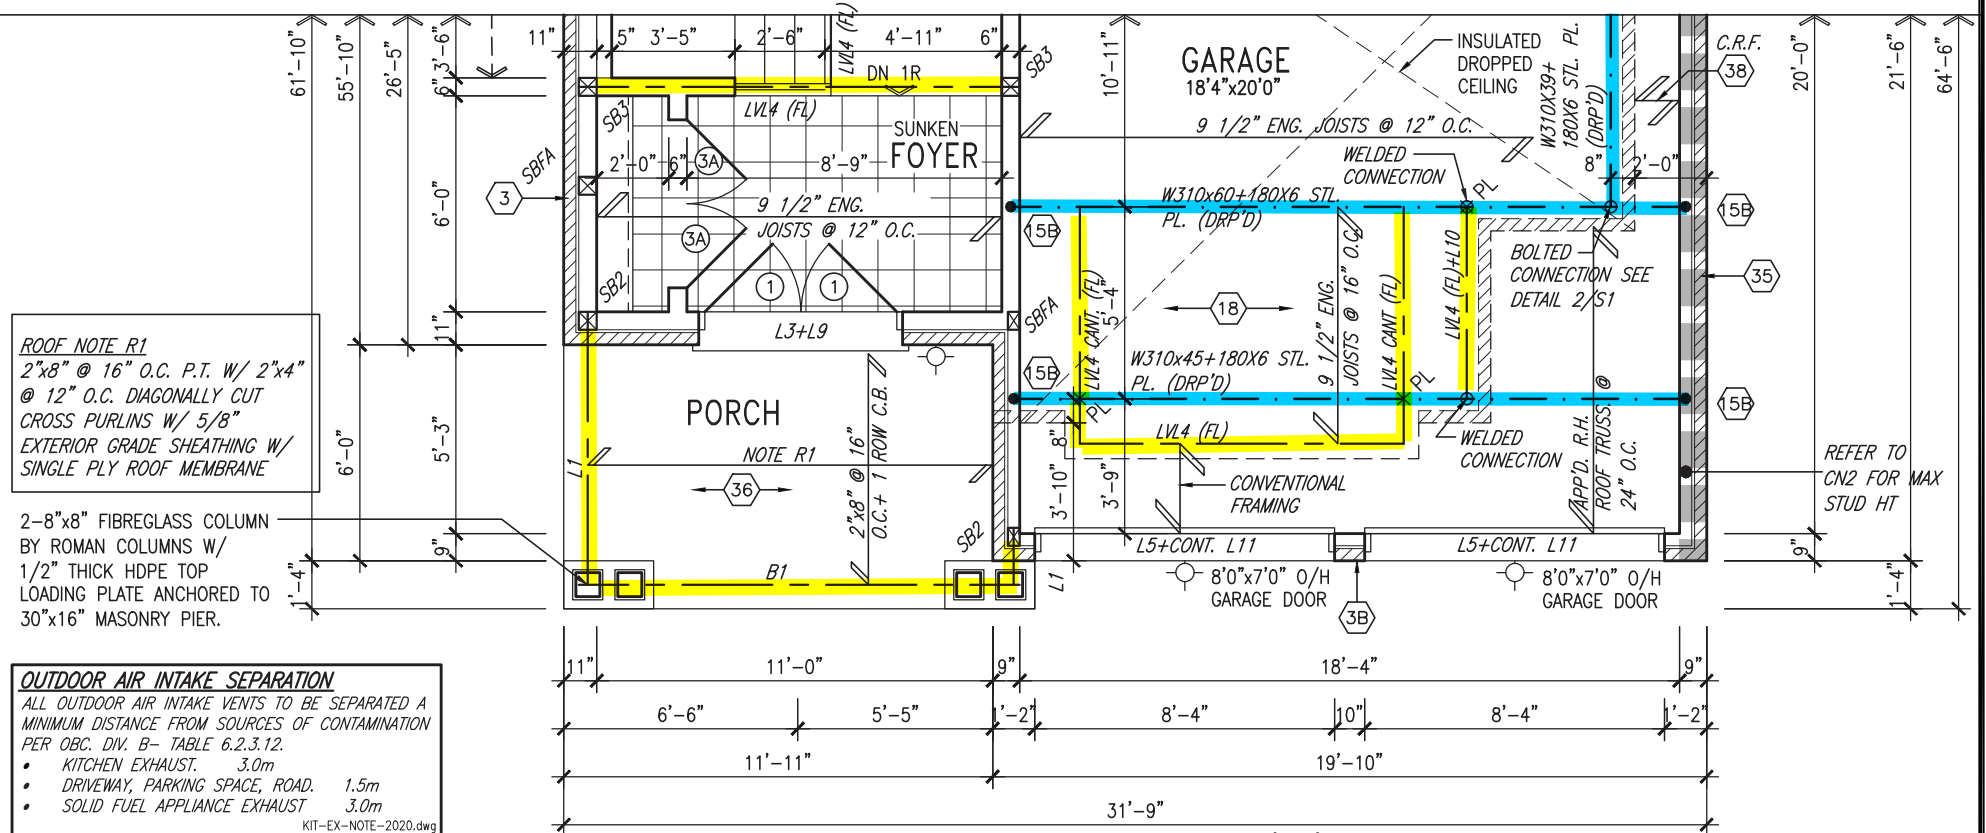

PARTIAL BASEMENT PLAN 'B'

NOTE: REFER TO STANDARD FLOOR PLANS FOR ADDITIONAL INFORMATION

NOTE: SPACE ALL FLOOR JOISTS @ 12" O.C. UNDER ALL CERAMIC TILE AREAS.

NOTE: ALL LVL'S SUPPORTING FLOOR LOADS ARE TO BE SPECIFIED BY FLOOR TRUSS MANUFACTURER.



MAR 1, 2022

GRAB BAR NOTE:

STUD WALL REINFORCEMENT FOR FUTURE GRAB BARS IN MAIN BATHROOM

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GB-NOTE-2020.dwg

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qualification information

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name registration information BCIN

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DESIGN

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t 416.630.2255 f 416.630.4782
va3design.com

BAYVIEW WELLINGTON

S38-19

project name
GREEN VALLEY EAST

municipality
BRADFORD

project no.
16023

date
JAN. 2017

drawn by
SB

checked by
JWM

scale
3/16" = 1'-0"

PARTIAL PLANS 'B'

file name
16023-S38-19

drawing no.
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1.	ISSUED FOR CLIENT REVIEW	NOV 23-21	VA3
no.	description	date	by

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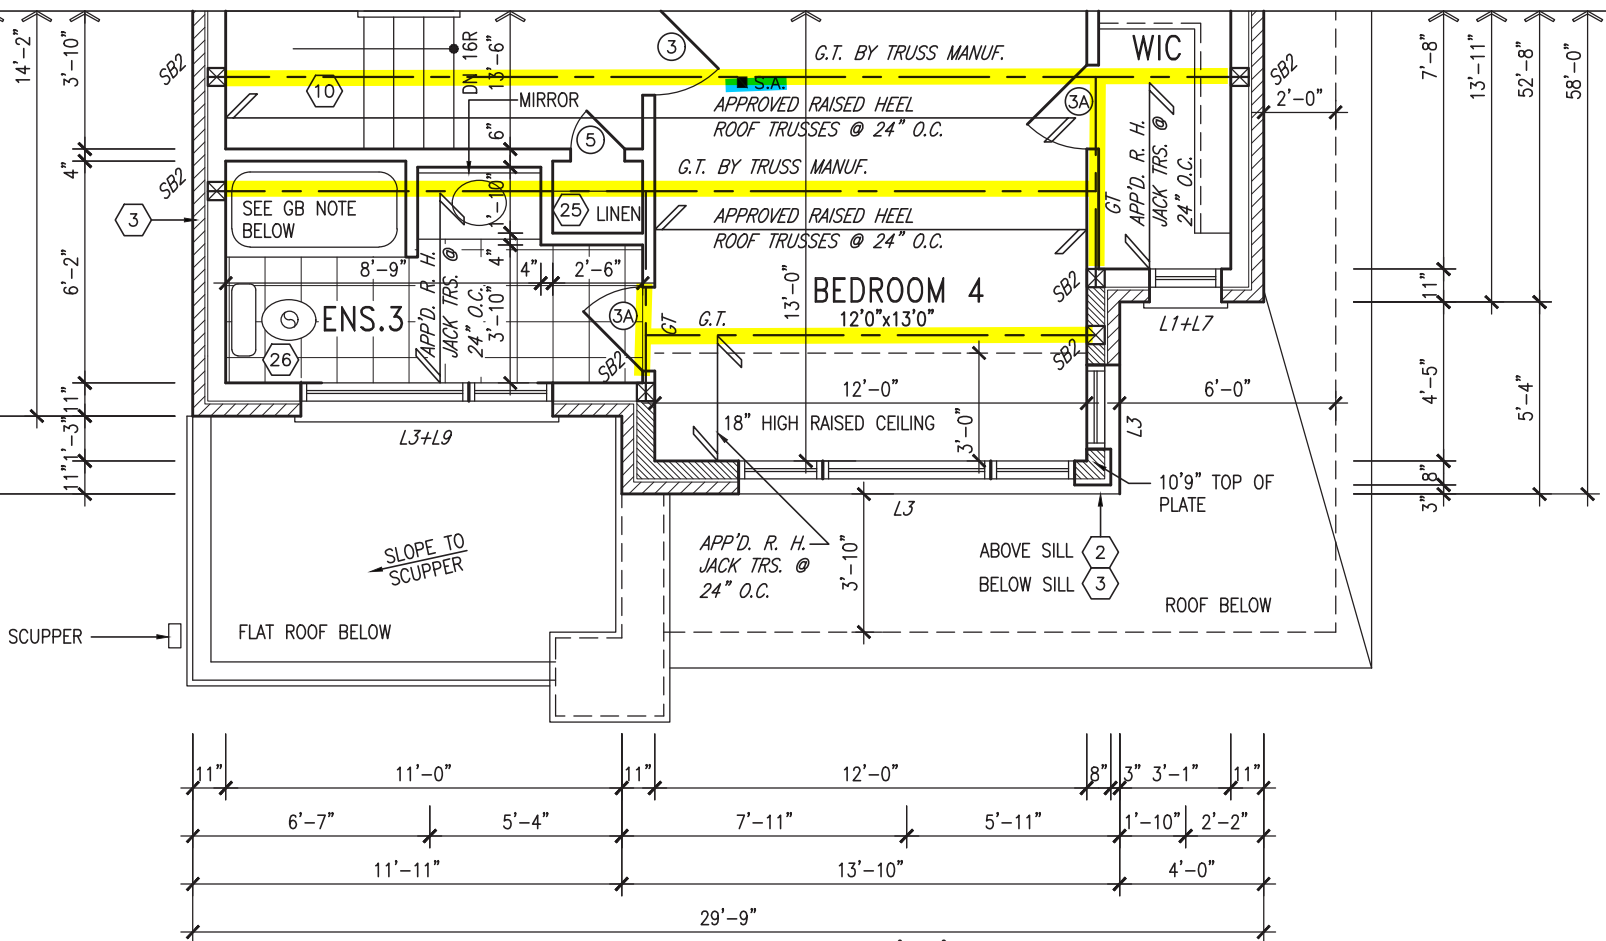
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AND APPROVAL

APPROVED BY:


DATE: MAR 03, 2022

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PARTIAL SECOND FLOOR PLAN 'C'

REVIEWED



PARTIAL GROUND FLOOR PLAN 'C'

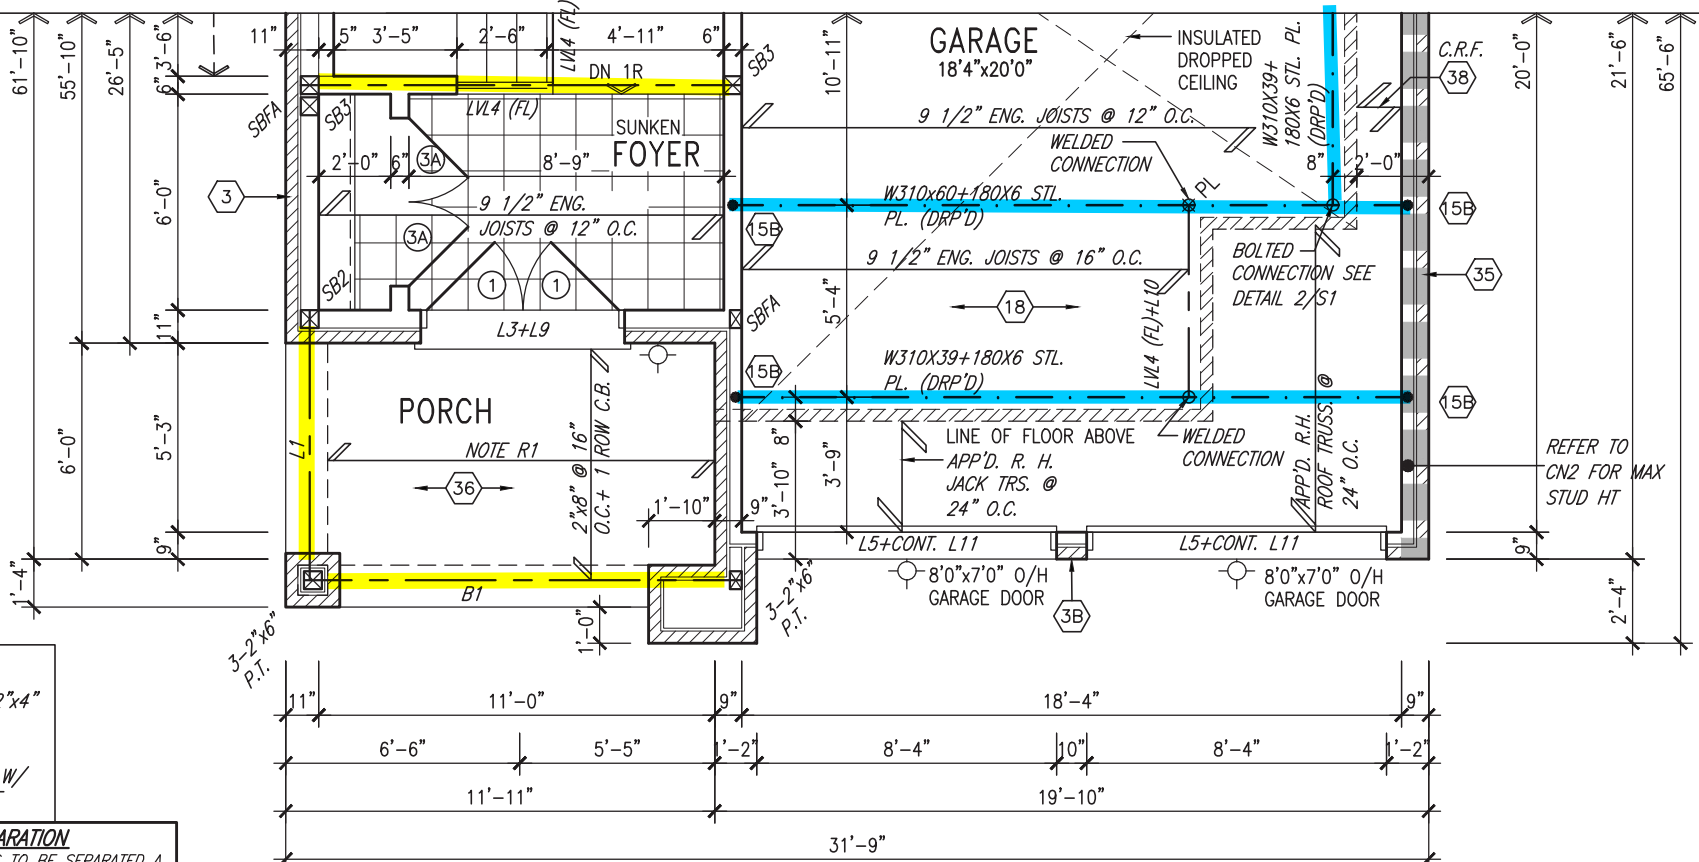ROOF NOTE R1
2"x8" @ 16" O.C. P.T. W/ 2"x4"
@ 12" O.C. DIAGONALLY CUT
CROSS PURLINS W/ 5/8"
EXTERIOR GRADE SHEATHING W/
SINGLE PLY ROOF MEMBRANE

OUTDOOR AIR INTAKE SEPARATION
ALL OUTDOOR AIR INTAKE VENTS TO BE SEPARATED A
MINIMUM DISTANCE FROM SOURCES OF CONTAMINATION
PER OBC, DIV. B- TABLE 6.2.3.12.
• KITCHEN EXHAUST. 3.0m
• DRIVEWAY, PARKING SPACE, ROAD. 1.5m
• SOLID FUEL APPLIANCE EXHAUST 3.0m
KIT-EX-NOTE-2020.dwg

NOTE:
ROOF TRUSS INFORMATION REFER TO ROOF
TRUSS SHOP DRAWINGS FOR ALL ROOF FRAMING
INFORMATION UNLESS OTHERWISE NOTED.




MAR 1, 2022

GRAB BAR NOTE:

**STUD WALL REINFORCEMENT FOR FUTURE
GRAB BARS IN MAIN BATHROOM**

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REFER TO FOLLOWING SECTIONS FOR THE FIXTURES
LISTED. WATER CLOSET: 3.8.3.8.(3)(a) & 3.8.3.8.(3)(c).
SHOWER 3.8.3.13.(2)(g). BATHTUB 3.8.3.13.(4)(e).
FREE STANDING BATHTUB EXCLUDED. SEE DETAILS
PROVIDED.
GB-NOTE-2020.dwg

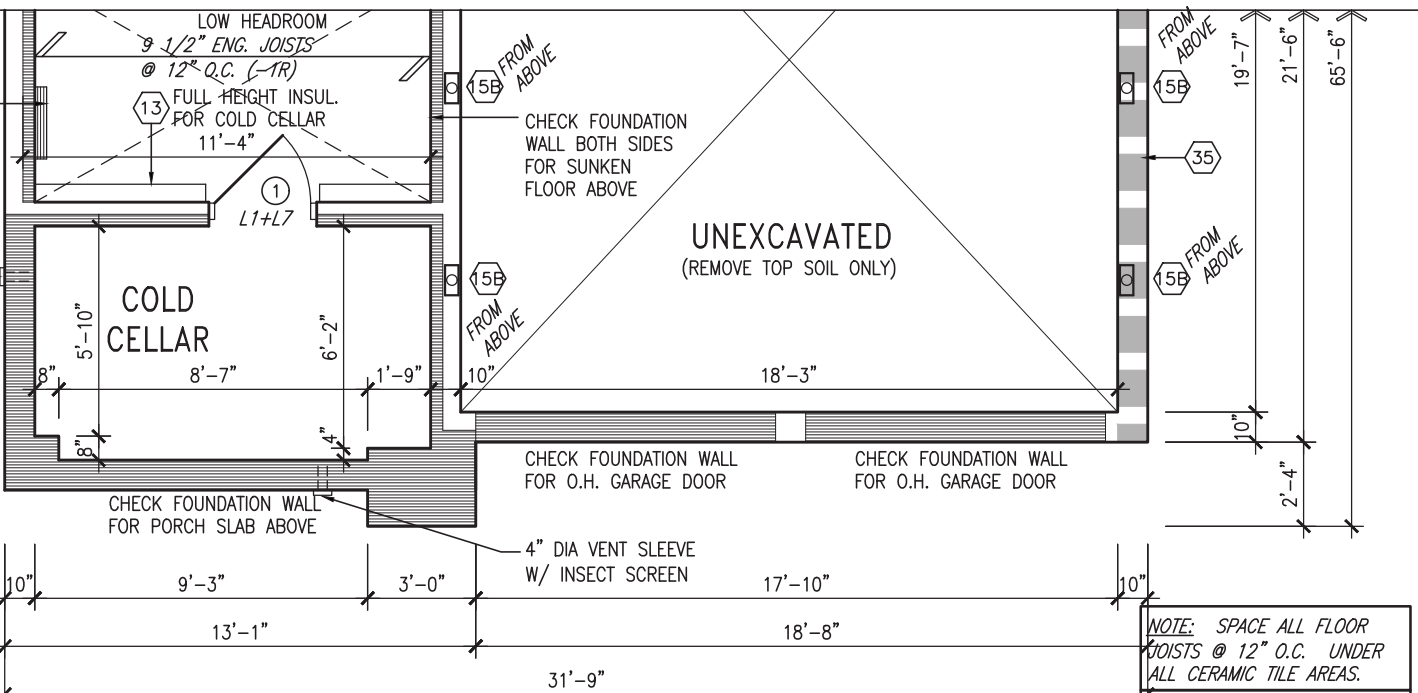

PARTIAL BASEMENT PLAN 'C'

NOTE: REFER TO STANDARD
FLOOR PLANS FOR
ADDITIONAL INFORMATION

NOTE: SPACE ALL FLOOR
JOISTS @ 12" O.C. UNDER
ALL CERAMIC TILE AREAS.

NOTE: ALL LVL'S SUPPORTING
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MANUFACTURER.

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qualification information
Wellington Jno-Baptiste 25591
name
registration information BCIN
VA3 Design Inc. 42658
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DESIGN**
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t 416.630.2255 f 416.630.4782
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BAYVIEW WELLINGTON

S38-19

project name	GREEN VALLEY EAST	municipality	BRADFORD	project no.	16023
date	JAN. 2017	checked by	JWM	scale	3/16" = 1'-0"
drawn by	SB	file name	16023-S38-19	drawing no.	5
RICHARD - H:\ARCHIVE\WORKING\2016\16023.BW\Units\38\16023-S38-19.dwg - Tue - Mar 1 2022 - 9:33 AM					


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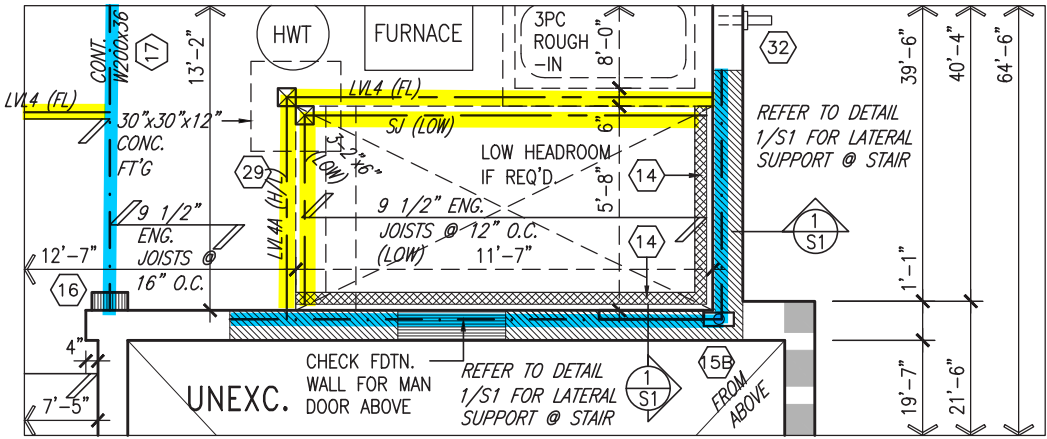
APPROVED BY: _____
DATE: MAR 03, 2022

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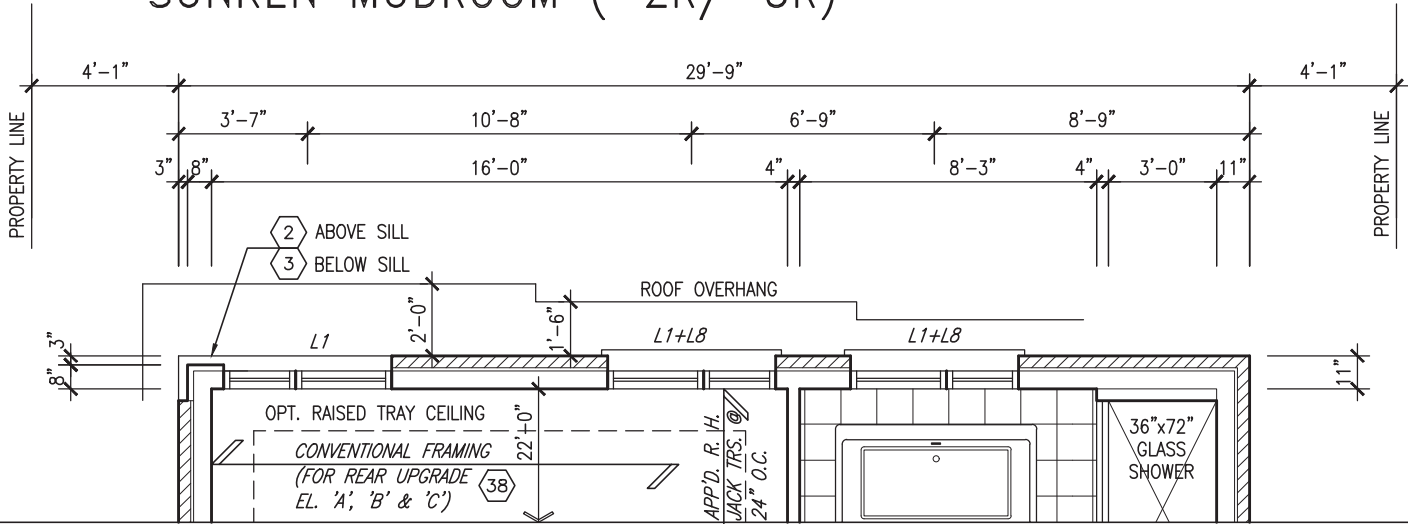


BASEMENT PLAN 'A','B' & 'C'
SUNKEN MUDROOM (-1R)


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BASEMENT PLAN 'A','B' & 'C'
SUNKEN MUDROOM (-2R/-3R)

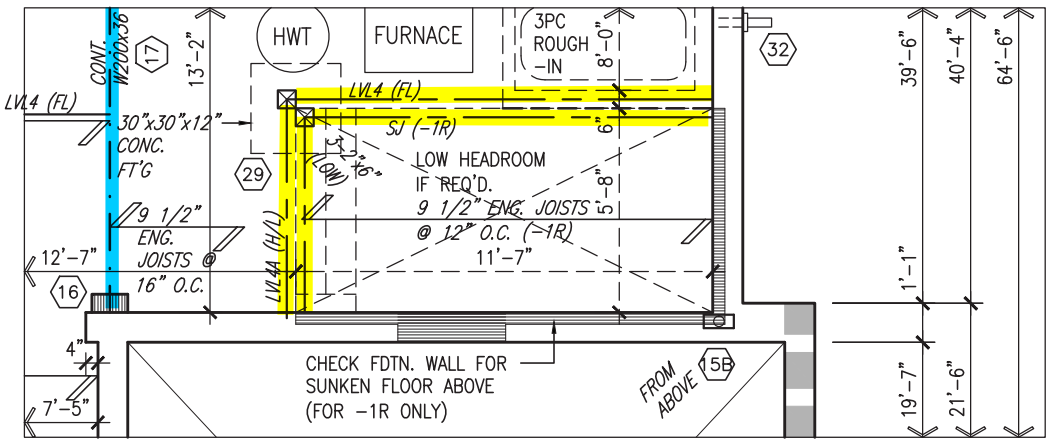

PARTIAL SECOND FLOOR PLAN 'C'
W/ REAR UPGRADE



PARTIAL GROUND FLOOR PLAN 'C'
W/ REAR UPGRADE

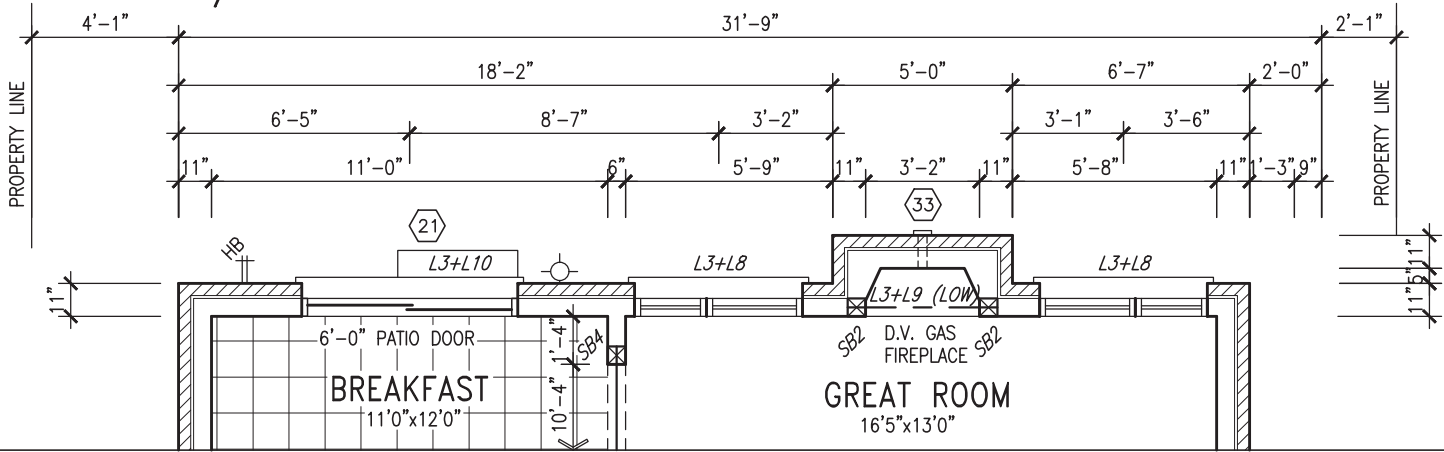AREA CALCULATIONS			
	ELEV. A	ELEV. B	ELEV. C
GROUND FLOOR AREA	1409.1 SF	1409.1 SF	1409.1 SF
SECOND FLOOR AREA	1678.3 SF	1688.2 SF	1678.3 SF
SUBTOTAL	3087.4 SF	3097.2 SF	3087.4 SF
DEDUCT ALL OPENINGS	14.6 SF	14.6 SF	14.6 SF
TOTAL NET AREA	3073 SF	3083 SF	3073 SF
	285.5 m2	286.4 m2	285.5 m2
FINISHED BSMT AREA	0 SF	0 SF	0 SF
TOTAL NET AREA W/ FIN BSMT	3073 SF	3083 SF	3073 SF
	285.5 m2	286.4 m2	285.5 m2
COVERAGE W/O PORCH	1817.7 SF	1817.7 SF	1817.7 SF
	168.9 m2	168.9 m2	168.9 m2
COVERAGE W/PORCH	1892.2 SF	1906.7 SF	1909.7 SF
	175.8 m2	177.1 m2	177.4 m2

NOTE: REFER TO STANDARD FLOOR PLANS FOR ADDITIONAL INFORMATION



MAR 1, 2022

DOOR HEIGHTS	
CEILING HEIGHT	DOOR HEIGHT
11'0" or greater	8'0" (96")
10'0"	8'0" (96")
9'0"	6'8" (80")
8'0" or lower	6'8" (80")
CONTRACTOR TO CONFIRM HEIGHTS WITH BUILDER	

9	.	.	.	The undersigned has reviewed and takes responsibility for this design and has the qualifications and meets the requirements set out in the Ontario Building Code to be a Designer.
8	.	.	.	qualification information
7	.	.	.	Wellington Jno-Baptiste 25591
6	.	.	.	name
5	.	.	.	registration information
4	.	.	.	VA3 Design Inc. 42658
3	.	.	.	
2	REVISED AS PER ENG'S COMMENTS	FEB 25-22	RC	Contractor must verify all dimensions on the job and report any discrepancy to the Designer before proceeding with the work. All drawings and specifications are instruments of service and the property of the Designer which must be returned at the completion of the work. Drawings are not to be scaled.
1	ISSUED FOR CLIENT REVIEW	NOV 23-21	VA3	
no.	description	date	by	

VA3 DESIGN

255 Consumers Rd Suite 120
Toronto ON M2J 1R4
t 416.630.2255 f 416.630.4782
va3design.com

BAYVIEW WELLINGTON

S38-19

project name: **GREEN VALLEY EAST** municipality: **BRADFORD** project no.: **16023**

date: **OCTOBER 2021** PARTIAL PLANS 'A', 'B' & 'C' drawing no.: **6**

drawn by: **NS** checked by: **JWM** scale: **3/16" = 1'-0"** file name: **16023-S38-19**

RICHARD - H:\ARCHIVE\WORKING\2016\16023.BW\Units\38\16023-S38-19.dwg - Tue - Mar 1 2022 - 9:33 AM

REFER TO FRONT ELEVATION FOR
TYPICAL NOTES.



It is the builder's complete responsibility to ensure that all plans submitted for approval fully comply with the Architectural Guidelines and all applicable regulations and requirements including zoning provisions and any provisions in the subdivision agreement. The Control Architect is not responsible in any way for examining or approving site (lotting) plans or working drawings with respect to any zoning or building code or permit matter or that any house can be properly built or located on its lot.

This is to certify that these plans comply with the applicable Architectural Design Guidelines approved by the Town of BRADFORD / WEST GWILLIMBURY.



WALL AREA	1116.67 SQ. FT.
LIMITING DISTANCE	1.2 M (7%)
OPENING ALLOWED	78.17 SQ. FT.
OPENING PROVIDED	55.30 SQ. FT. (GLASS AREA ONLY)

BAYVIEW WELLINGTON		S38-19	
project name	GREEN VALLEY EAST	municipality	BRADFORD
project no.	16023	drawing no.	8
date	OCTOBER 2021	scale	3/16" = 1'-0"
checked by	JWM	checked by	JWM
down by	NS	down by	NS
RICHARD - H:\ARCHIVE\WORKING\2016\16023.BW\Units\38\16023-S38-19.dwg - Tue - Mar 1 2022 - 9:33 AM			
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JOHN G. WILLIAMS LTD., ARCHITECT ARCHITECTURAL CONTROL REVIEW AND APPROVAL			
APPROVED BY: [Signature] DATE: MAR 03, 2022			
This stamp certifies compliance with the applicable Design Guidelines only and bears no further professional responsibility.			
The undersigned has reviewed and takes responsibility for this design and has the qualifications and meets the requirements set out in the Ontario Building Code to be a Designer.			
Contractor must verify all dimensions on the job and report any discrepancy to the Designer before proceeding with the work. All drawings and specifications are instruments of service and the property of the Designer which must be returned at the completion of the work. Drawings are not to be scaled.			
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2	REVISED AS PER ENG'S COMMENTS	FEB 25-22	RC
1	ISSUED FOR CLIENT REVIEW	NOV 23-21	VA3
no.	description	date	by

BRICK VENEER CONSTRUCTION

(FOR WALLS LESS THAN 1.2M (3'-11") FROM THE LOT LINE)

45 MINUTE FIRE RATED WALL

PROVIDE A CONTINUOUS LAYER OF 12.7mm (1/2") TYPE 'X' GYPSUM BOARD (INTERIOR SIDE) INSTALLED SO THAT ALL EDGES ARE SUPPORTED, TAPED AND FILLED. SPACE BETWEEN WOOD STUDS TO BE FILLED WITH INSULATION CONFORMING TO CAN/ULC-S702, "MINERAL FIBRE THERMAL INSULATION FOR BUILDINGS" WITH A MASS OF NOT LESS THAN 1.22 Kg/SQ.M. AND MUST FILL AT LEAST 90% OF THE CAVITY THICKNESS. THE TYPE 'X' & INSULATION MUST BE RUN CONTINUOUSLY BEHIND ALL INTERSECTING PARTITIONS, MECHANICAL CHASES, BATHTUBS, SHOWERS, ETC. ENSURE INSULATION & TYPE 'X' IS INSTALLED IN GARAGE EXTERIOR WALLS.

(REFER TO SECTION SB-2 OF OBC 2012-SUPPLEMENTARY STANDARDS)

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JOHN G. WILLIAMS LTD., ARCHITECT
ARCHITECTURAL CONTROL REVIEW
AND APPROVAL

APPROVED BY: _____
DATE: MAR 03, 2022

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S38-19

BAYVIEW WELLINGTON

project name **GREEN VALLEY EAST** municipality **BRADFORD** project no. **16023** date **JAN 2017** drawing no. **RIGHT SIDE ELEVATION 'A'**

UNIT, 2017	drawn by	checked by	scale	file name
SB		JWM	3/16" = 1'-0"	16023-S38-19

RICHARD - H:\ARCHIVE, WORKING\16023\16023.DWG Units:38' 16023-S38-19.dwg - Tue - Mar 1 2022 - 9:33 AM



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5 Consumers Rd Suite
Toronto ON M2J 1R4
16.630.2255 f 416.630.
va3design.com

and has the qualifications and meets the requirements set out in the Ontario Building Code to be a Designer.

Wellington Jno-Baptiste	signature	BCIN	25591
registration information			
VA3 Design Inc.			42658

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REVIEWED

RIGHT SIDE ELEVATION 'A'

HEADER/RIM JOIST LEVEL

(FOR WALLS LESS THAN 1.2M (3'-11") FROM THE LOT LINE)45 MINUTE
FIRE RATING @ HEADER

PROVIDE 15.9mm (5/8") TYPE 'X' GYPSUM BOARD BETWEEN FLOOR JOIST AT THE HEADER OR CONTINUOUSLY ALONG THE RIM JOIST WHEN FLOOR JOISTS ARE PARALLEL TO RIM JOIST TO MAINTAIN 45 MINUTE FIRE RATING.

WALL AREA	1143.47 SQ. FT.
LIMITING DISTANCE	1.2 M (7%)
OPENING ALLOWED	80.04 SQ. FT.
OPENING PROVIDED	68.19 SQ. FT. (GLASS AREA ONLY)

TOP OF PLATE

TOP OF WINDOW

4'-0" FRIEZE BD.
RETURN FOR UPGRADE
ONLY

FIN SECOND FLOOR

TOP OF TRANSOM

TOP OF WINDOW

FIN GROUND FLOOR

FIN GRADE

TOP OF SLAB

2	REVISED AS
1	ISSUED FOR
no.	description

JOHN G. WILLIAMS LTD., ARCHITECT
ARCHITECTURAL CONTROL REVIEW
AND APPROVAL

APPROVED BY: 

DATE: MAR 03, 2022

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V3
DESIGN

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Toronto ON M2J 1R4
t 416.630.2255 f 416.630.4782
vo3design.com

FACE BRICK

STUCCO FINISH

RENAISSANCE STONE

ALUMINUM PANEL

FRONT ELEVATION 'B'

TOP OF SLAB

Diagram illustrating the elevation of the exterior wall of the second floor, showing various levels and dimensions:

- TOP OF PLATE
- TOP OF WINDOW
- FIN SECOND FLOOR
- TOP OF TRANSOM
- TOP OF DOOR
- FIN GROUND FLOOR
- FIN. SUNKEN FOYER
- FIN GRADE

Dimensions (vertical measurements):


- 6'-10"
- 8'-1"
- 1'-0"
- 9'-1"
- 6'-10"

REVIEWED

REFER TO FRONT ELEVATION FOR
TYPICAL NOTES.



MAR 1, 2022

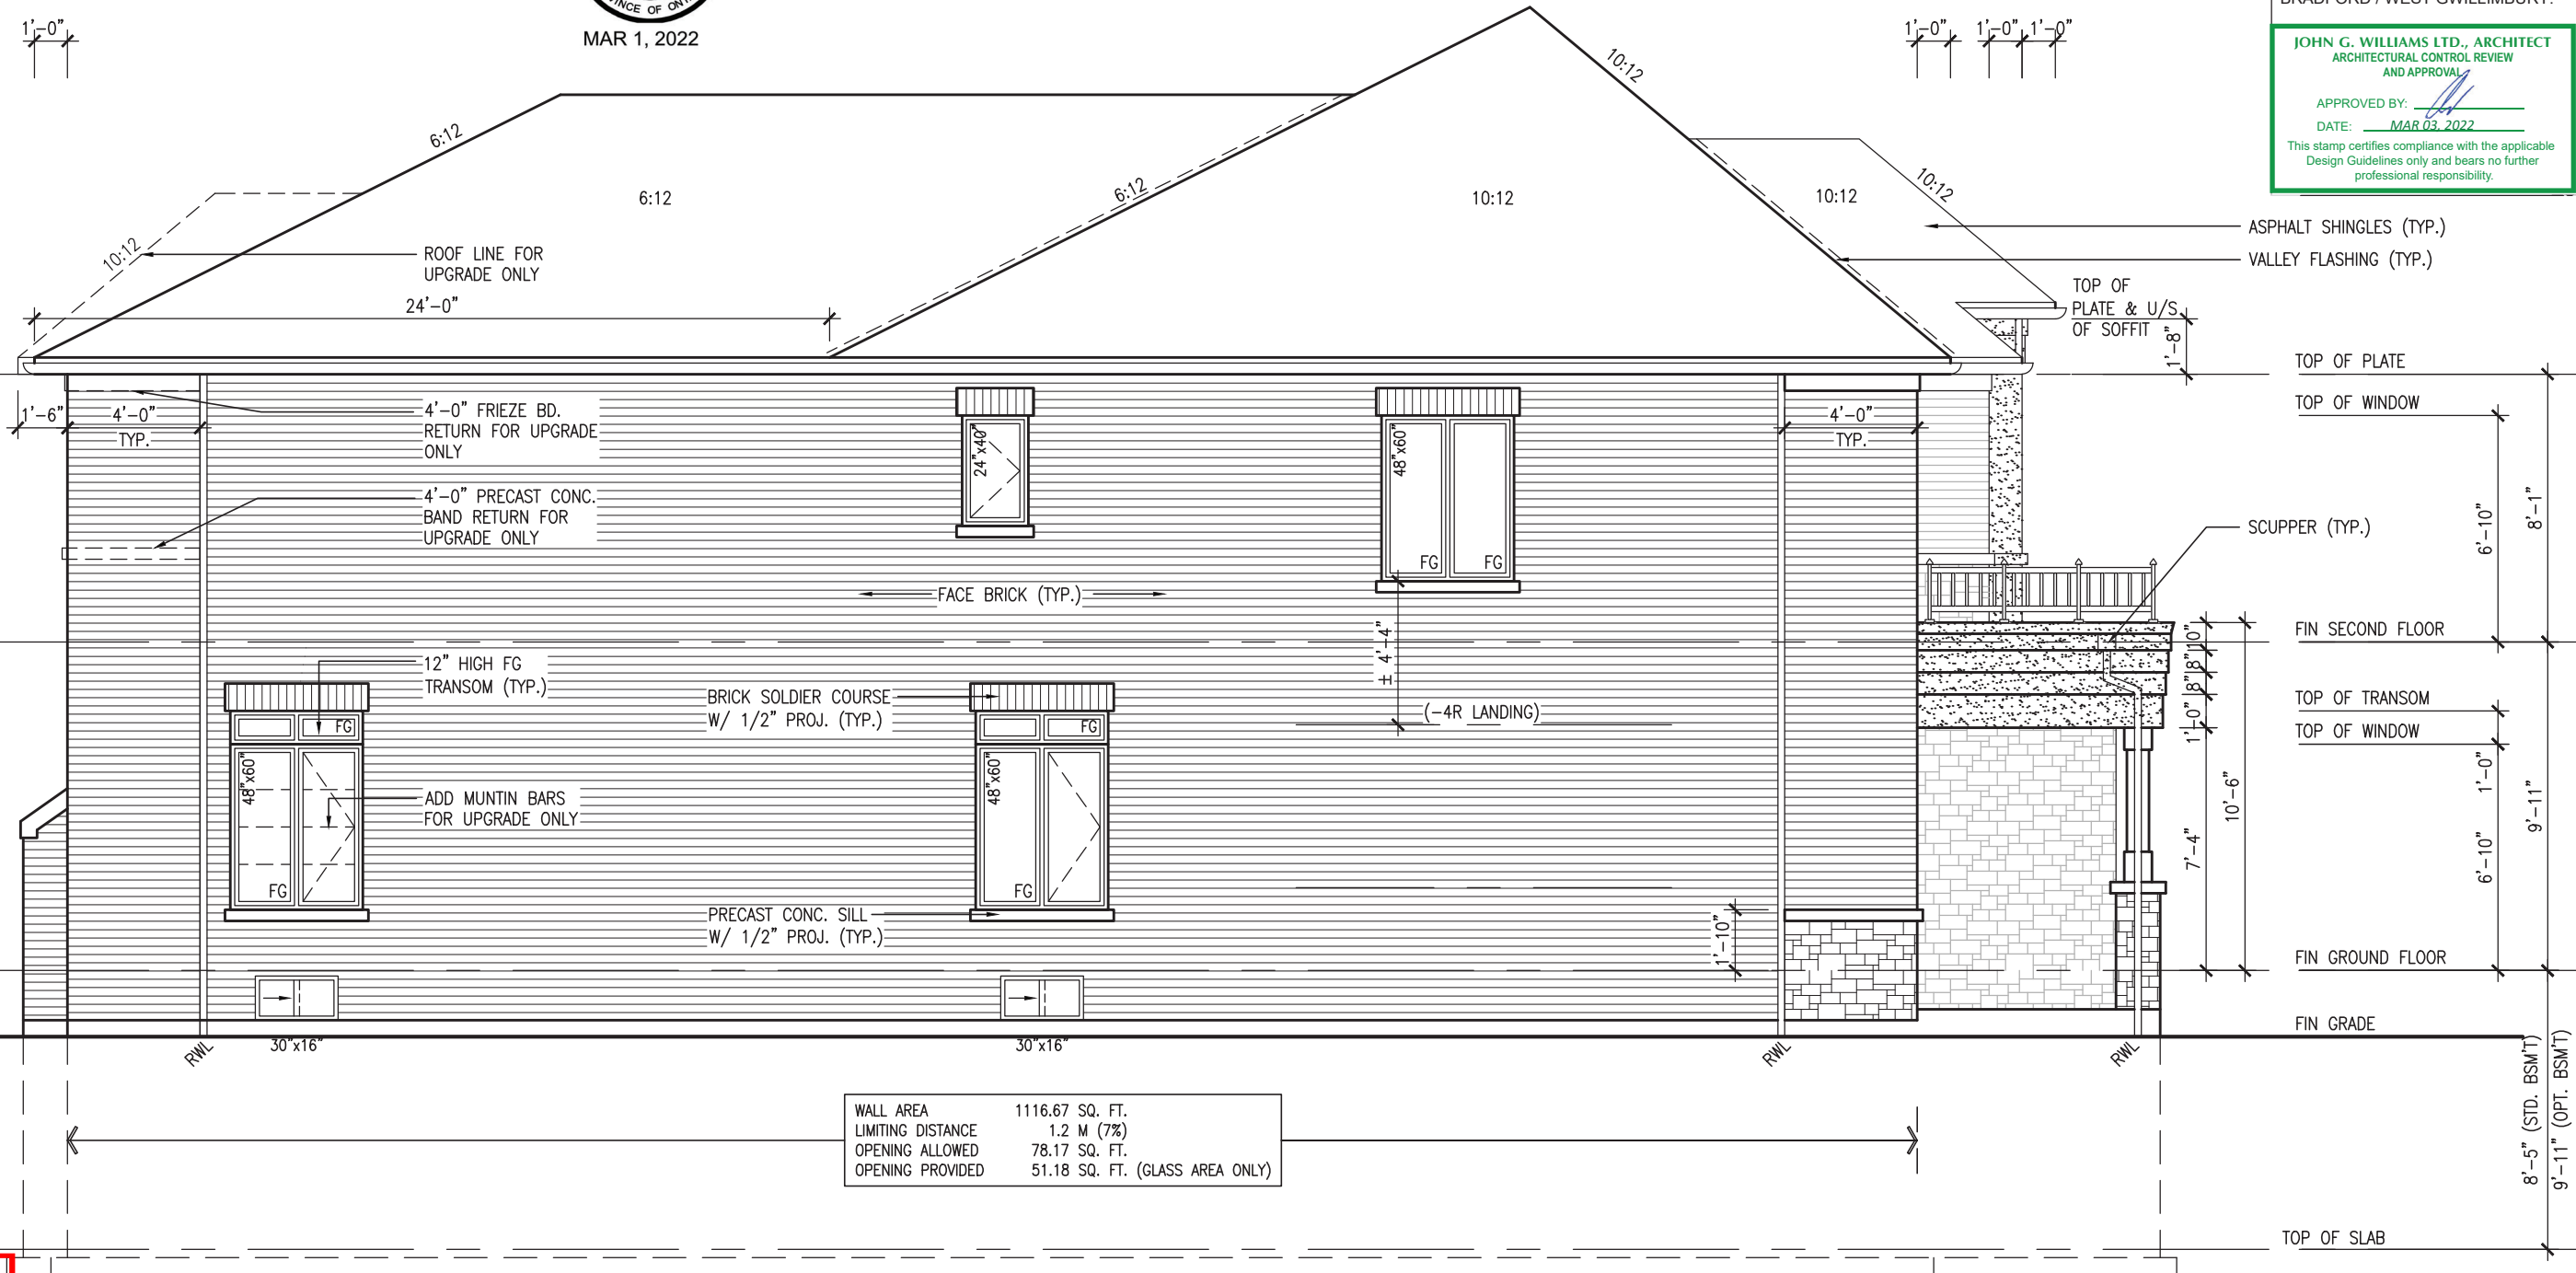

LEFT SIDE ELEVATION 'B'

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ARCHITECTURAL CONTROL REVIEW
AND APPROVAL

APPROVED BY:

DATE: MAR 03, 2022

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S38-19

BAYVIEW WELLINGTON

project no.

16023

municipality

BRADFORD

project name

GREEN VALLEY EAST

date

OCTOBER 2021

checked by

JWM

scale

3/16" = 1'-0"

drawn by

NS

file name

16023-S38-19

drawing no.

12

VAS3
DESIGN

120
255 Consumers Rd. Suite 114
Toronto, ON M2J 1R4
t 416.630.2255 f 416.630.4782
vas3design.com

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qualification information

Wellington Jno-Baptiste

25591 BCN 42658

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no. description

date

by

date

no.

description

date

no.

description

REFER TO FRONT ELEVATION FOR
TYPICAL NOTES.

BRICK VENEER CONSTRUCTION

(FOR WALLS LESS THAN 1.2M (3'-11") FROM THE LOT LINE)


45 MINUTE FIRE RATED WALL

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(REFER TO SECTION SB-2 OF OBC 2012-SUPPLEMENTARY STANDARDS)

PROVIDE A CONTINUOUS LAYER OF 12.7mm (1/2") TYPE 'X' GYPSUM BOARD (INTERIOR SIDE) INSTALLED SO THAT ALL EDGES ARE SUPPORTED, TAPED AND FILLED. SPACE BETWEEN WOOD STUDS TO BE FILLED WITH INSULATION CONFORMING TO CAN/ULC-S702, "MINERAL FIBRE THERMAL INSULATION FOR BUILDINGS" WITH A MASS OF NOT LESS THAN 1.22 Kg/SQ.M. AND MUST FILL AT LEAST 90% OF THE CAVITY THICKNESS. THE TYPE 'X' & INSULATION MUST BE RUN CONTINUOUSLY BEHIND ALL INTERSECTING PARTITIONS, MECHANICAL CHASES, BATHTUBS, SHOWERS, ETC. ENSURE INSULATION & TYPE 'X' IS INSTALLED IN GARAGE EXTERIOR WALLS.
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APPROVED BY: 
DATE: MAR 03, 2022

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name	Wellington Jno-Baptiste	25591
registration information	signature	BCIN
VAA3 Design Inc.		42658

DESIGN

255 Consumers Rd Suite 120
Toronto ON M2J 1R4
416.630.2255 f 416.630.4782
www.zedco.com

Downloaded from <http://ajph.org/> on November 10, 2015

REVIEWED

RIGHT SIDE ELEVATION 'B'

HEADER/RIM JOIST LEVEL
(FOR WALLS LESS THAN 1.2M (3'-11") FROM THE LOT LINE)45 MINUTE
FIRE RATING @ HEADER
PROVIDE 15.9mm (5/8") TYPE 'X' GYPSUM BOARD BETWEEN FLOOR JOIST
AT THE HEADER OR CONTINUOUSLY ALONG THE RIM JOIST WHEN FLOOR
JOISTS ARE PARALLEL TO RIM JOIST TO MAINTAIN 45 MINUTE FIRE RATING.

WALL AREA	1143.47 SQ. FT.
LIMITING DISTANCE	1.2 M (7%)
OPENING ALLOWED	80.04 SQ. FT.
OPENING PROVIDED	68.19 SQ. FT. (GLASS AREA ONLY)



MAR 1, 2022

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qualification information

Wellington Jno-Baptiste	25591
-------------------------	-------

name	signature	BCIN
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42658
VA3 Design Inc.

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discrepancy to the Designer before proceeding with the work. All drawings and specifications are instruments of service and the property

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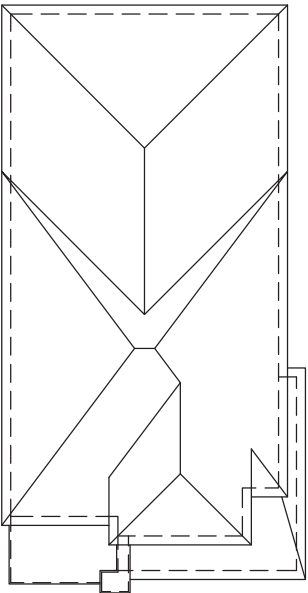
drawings are not to be scored.

ANDREW LAM



MAR 1, 2022

ROOF PLAN 'C'



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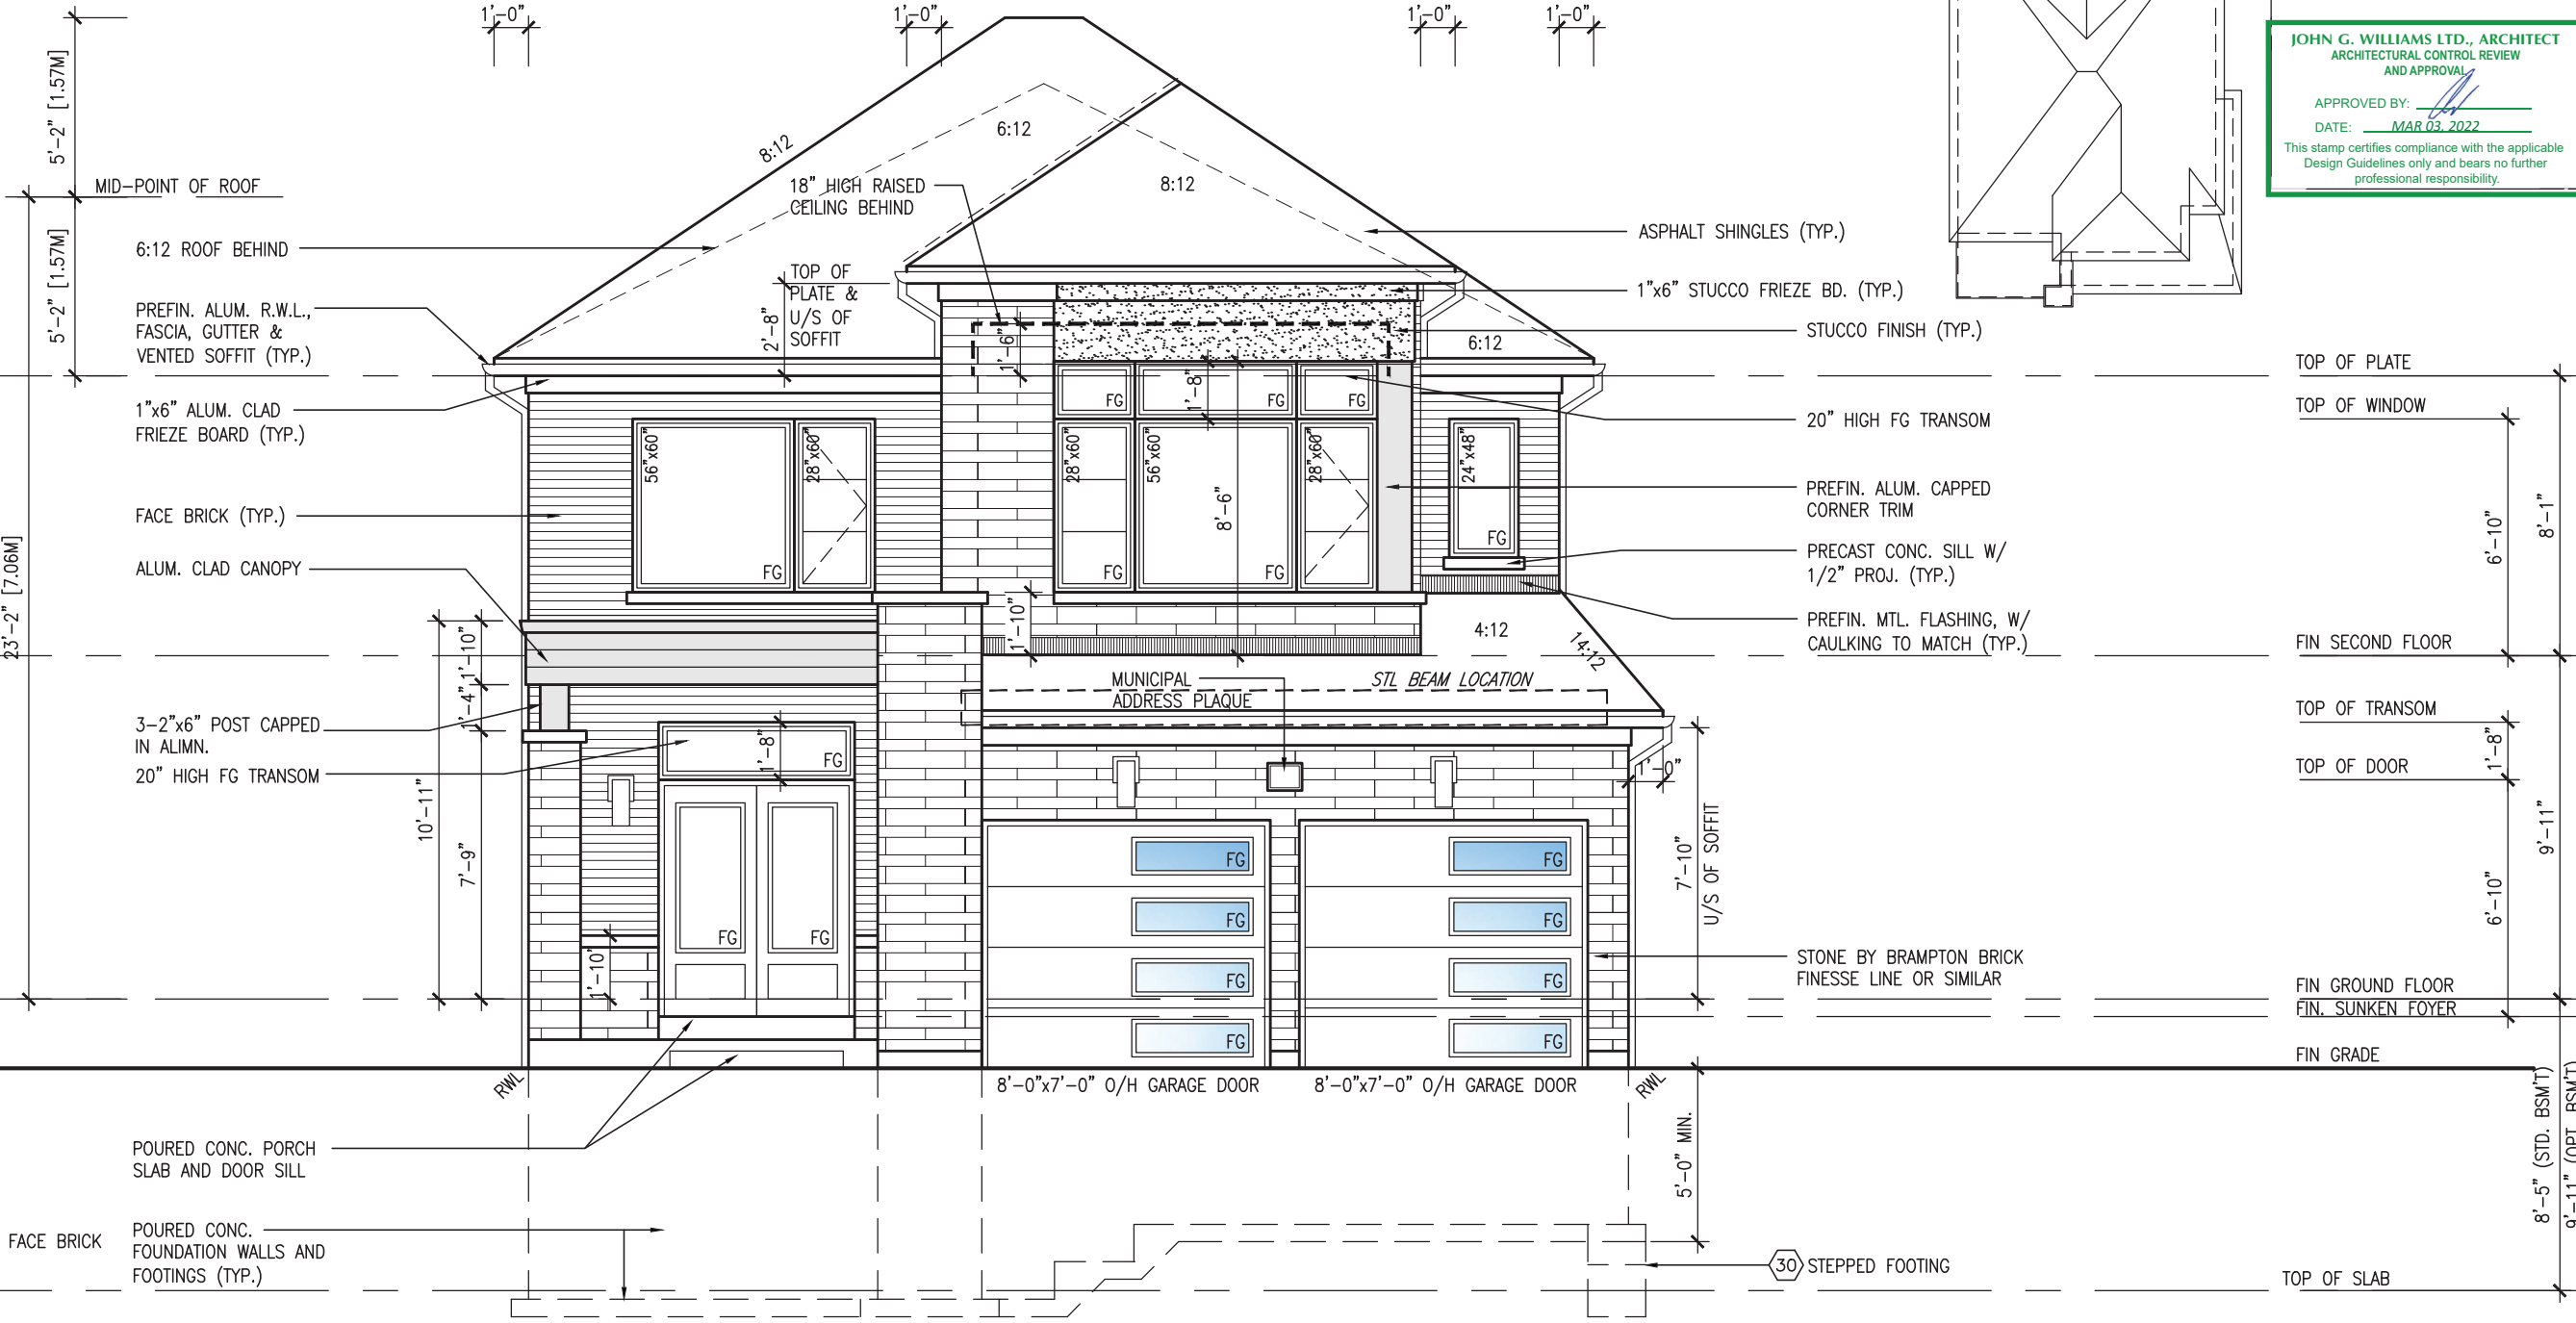
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JOHN G. WILLIAMS LTD., ARCHITECT
ARCHITECTURAL CONTROL REVIEW
AND APPROVAL

APPROVED BY:
DATE: MAR 03, 2022

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REVIEWED



FRONT ELEVATION 'C'

S38-19

BAYVIEW WELLINGTON

GREEN VALLEY EAST

BRADFORD

16023

14

project no. 16023

drawing no. 14

project name FRONT ELEVATION 'C'

file name 16023-S38-19

scale 3/16" = 1'-0"

checked by JWM

date OCTOBER 2021

down by NS

checked by JWM

date OCTOBER 2021

down by NS

checked by JWM

date OCTOBER 2021

down by NS

project no. 16023

drawing no. 14

project name FRONT ELEVATION 'C'

file name 16023-S38-19

scale 3/16" = 1'-0"

checked by JWM

date OCTOBER 2021

down by NS

checked by JWM

date OCTOBER 2021

down by NS

project no. 16023

drawing no. 14

project name FRONT ELEVATION 'C'

file name 16023-S38-19

scale 3/16" = 1'-0"

checked by JWM

date OCTOBER 2021

down by NS

checked by JWM

date OCTOBER 2021

down by NS

VA3 DESIGN

255 Consumers Rd. Suite 120

Toronto, ON M2J 1R4

T 416.630.2255 F 416.630.4782

va3design.com

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qualification information

Wellington Jno-Baptiste 25591 BCN

name registration information

VA3 Design Inc. 42658

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2. REVISED AS PER ENG'S COMMENTS

1. ISSUED FOR CLIENT REVIEW

no. description

date

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REVIEWED

REFER TO FRONT ELEVATION FOR
TYPICAL NOTES.



BRICK VENEER CONSTRUCTION

(FOR WALLS LESS THAN 1.2M (3'-11") FROM THE LOT LINE)

45 MINUTE FIRE RATED WALL

PROVIDE A CONTINUOUS LAYER OF 12.7mm (1/2") TYPE 'X' GYPSUM BOARD (INTERIOR SIDE) INSTALLED SO THAT ALL EDGES ARE SUPPORTED, TAPED AND FILLED. SPACE BETWEEN WOOD STUDS TO BE FILLED WITH INSULATION CONFORMING TO CAN/ULC-S702, "MINERAL FIBRE THERMAL INSULATION FOR BUILDINGS" WITH A MASS OF NOT LESS THAN 1.22 Kg/SQ.M. AND MUST FILL AT LEAST 90% OF THE CAVITY THICKNESS. THE TYPE 'X' & INSULATION MUST BE RUN CONTINUOUSLY BEHIND ALL INTERSECTING PARTITIONS, MECHANICAL CHASES, BATHTUBS, SHOWERS, ETC. ENSURE INSULATION & TYPE 'X' IS INSTALLED IN GARAGE EXTERIOR WALLS.
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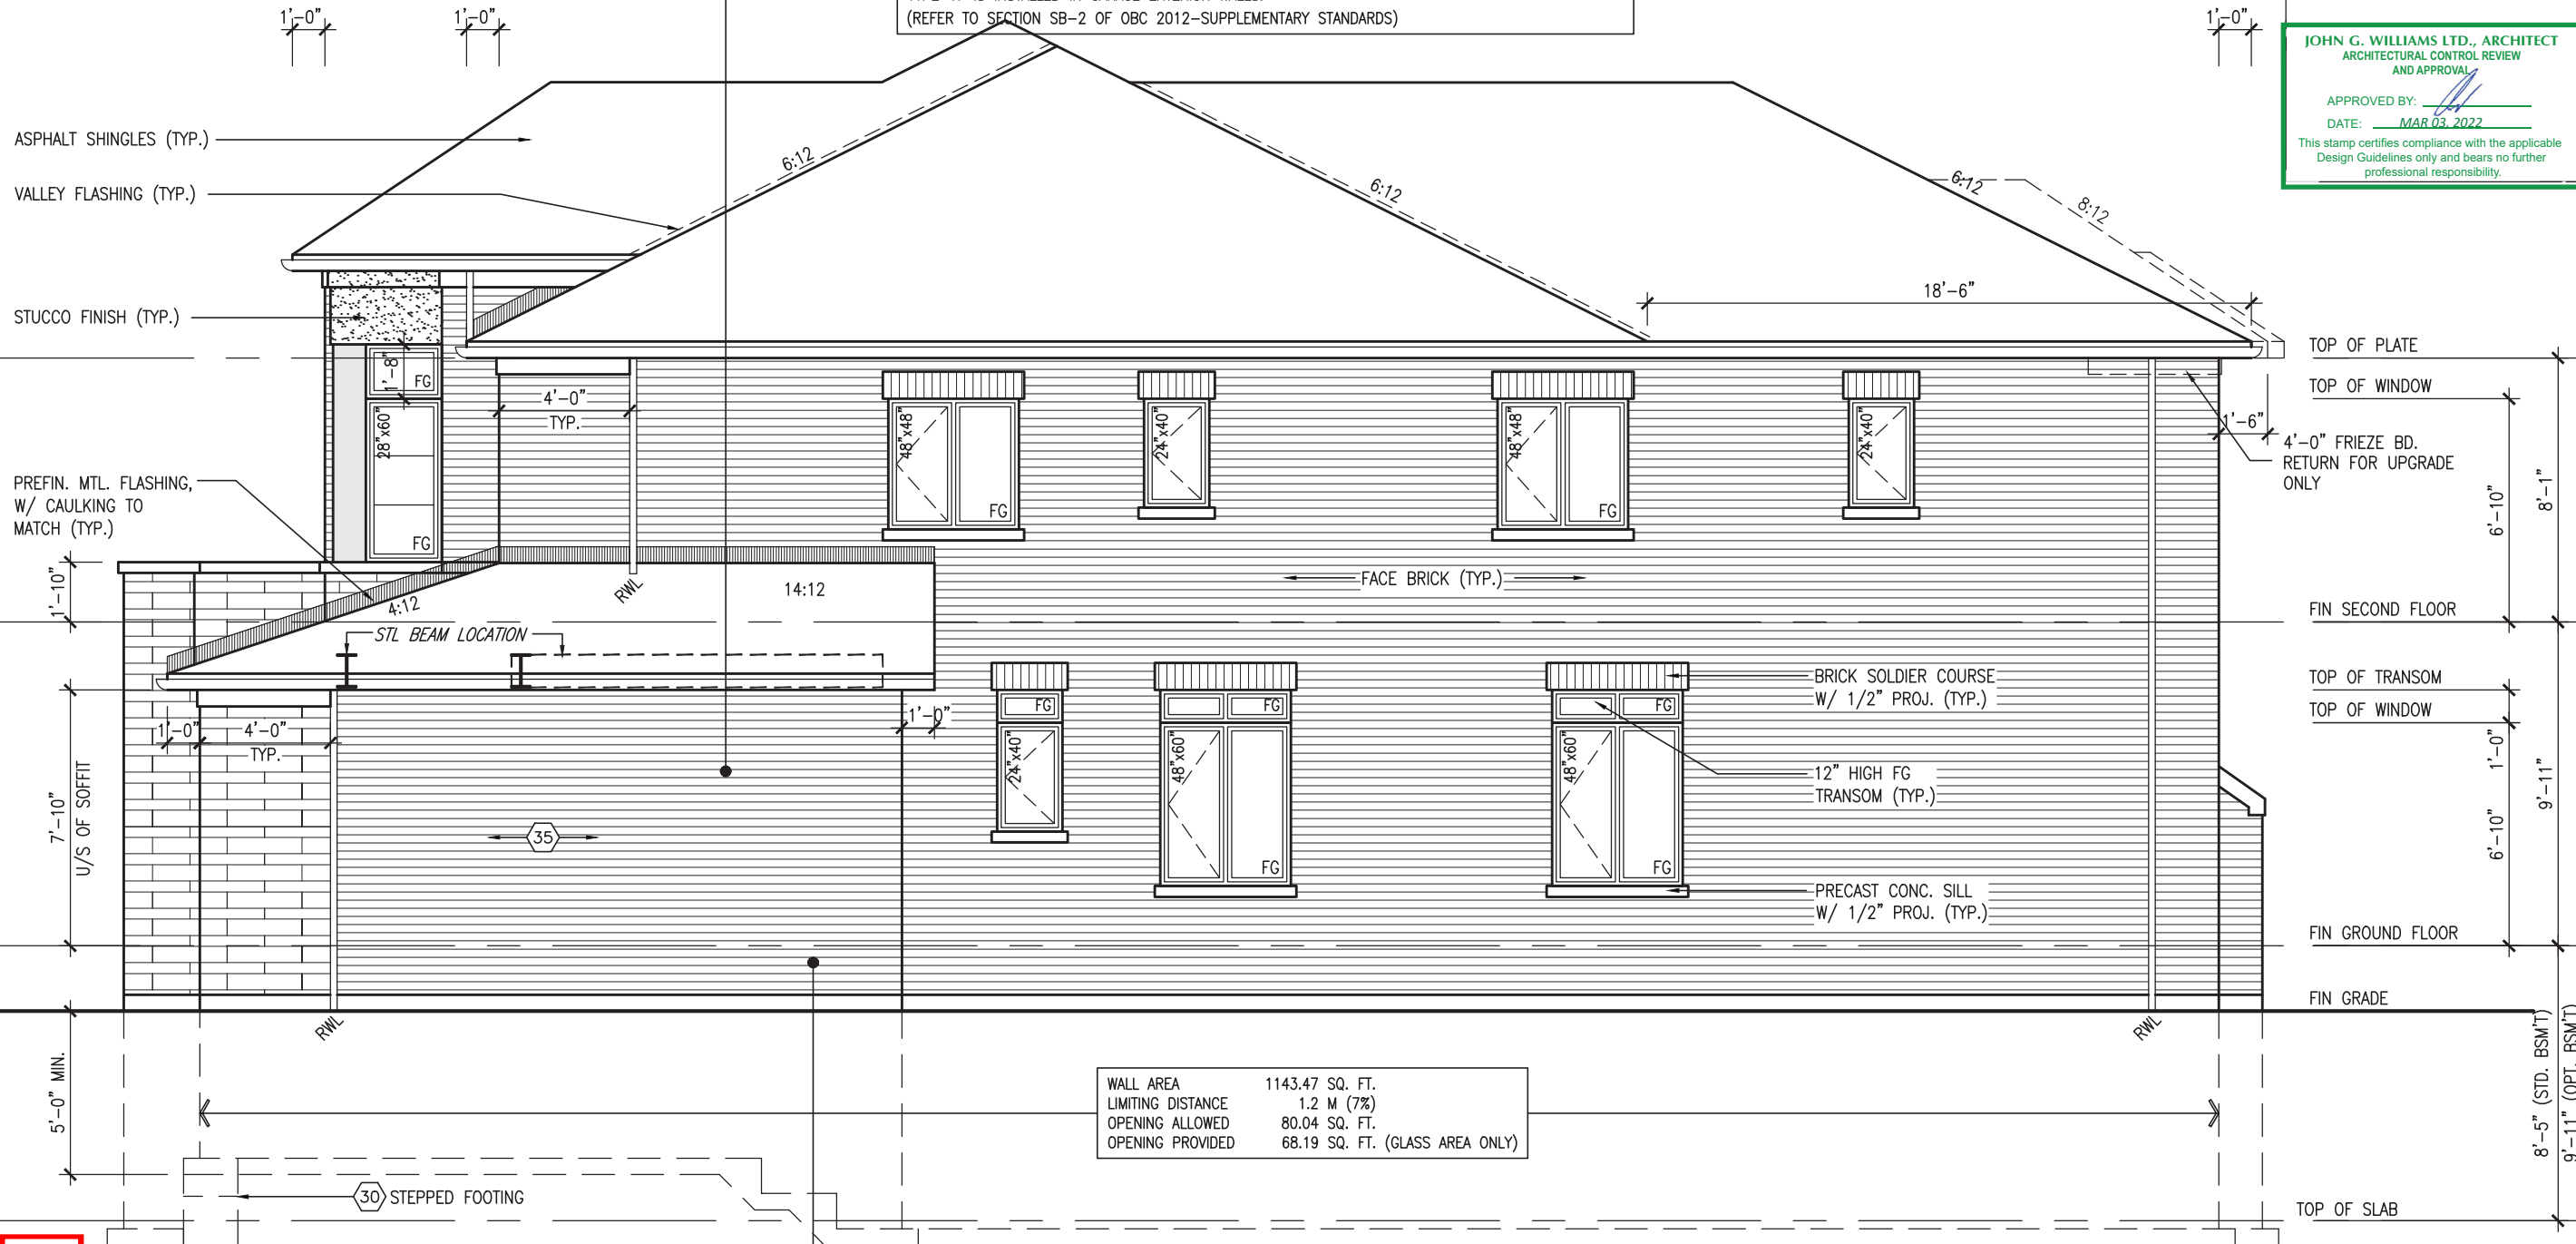
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JOHN G. WILLIAMS LTD., ARCHITECT
ARCHITECTURAL CONTROL REVIEW
AND APPROVAL

APPROVED BY:

DATE: MAR 03, 2022

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WALL AREA	1143.47 SQ. FT.
LIMITING DISTANCE	1.2 M (7%)
OPENING ALLOWED	80.04 SQ. FT.
OPENING PROVIDED	68.19 SQ. FT. (GLASS AREA ONLY)

RIGHT SIDE ELEVATION 'C'

HEADER/RIM JOIST LEVEL

(FOR WALLS LESS THAN 1.2M (3'-11") FROM THE LOT LINE) 45 MINUTE
FIRE RATING @ HEADER

PROVIDE 15.9mm (5/8") TYPE 'X' GYPSUM BOARD BETWEEN FLOOR JOIST
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qualification information
name: Wellington Jno-Baptiste
BCIN: 25591
registration information
VA3 Design Inc.
42658

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2	REVISED AS PER ENG'S COMMENTS	FEB 25-22	RC
1	ISSUED FOR CLIENT REVIEW	NOV 23-21	VA3

project name	BAYVIEW WELLINGTON	project no.	16023
project name	GREEN VALLEY EAST	project no.	16023-S38-19
date	OCTOBER 2021	scale	3/16" = 1'-0"
checked by	JWM	checked by	JWM
drawn by	NS	drawn by	NS
date	OCTOBER 2021	date	MAR 1 2022
file name	16023-S38-19	file name	16023-S38-19
drawing no.	16	drawing no.	16

S38-19

BAYVIEW WELLINGTON

VA3 DESIGN

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BAYVIEW WELLINGTON

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S38-19

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no.	description	date	by
9			
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3			
2	REVISED AS PER ENG'S COMMENTS	FEB 25-22	RC
1	ISSUED FOR CLIENT REVIEW	NOV 23-21	VA3

project name	BAYVIEW WELLINGTON	project no.	16023
project name	GREEN VALLEY EAST	project no.	16023-S38-19
date	OCTOBER 2021	scale	3/16" = 1'-0"
checked by	JWM	checked by	JWM
drawn by	NS	drawn by	NS
date	OCTOBER 2021	date	MAR 1 2022
file name	16023-S38-19	file name	16023-S38-19
drawing no.	16	drawing no.	16

S38-19

BAYVIEW WELLINGTON

VA3 DESIGN

The undersigned has reviewed and takes responsibility for this design and has the qualifications and meets the requirements set out in the Ontario Building Code to be a Designer.

qualification information
name: Wellington Jno-Baptiste
BCIN: 25591
registration information
VA3 Design Inc.
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BAYVIEW WELLINGTON

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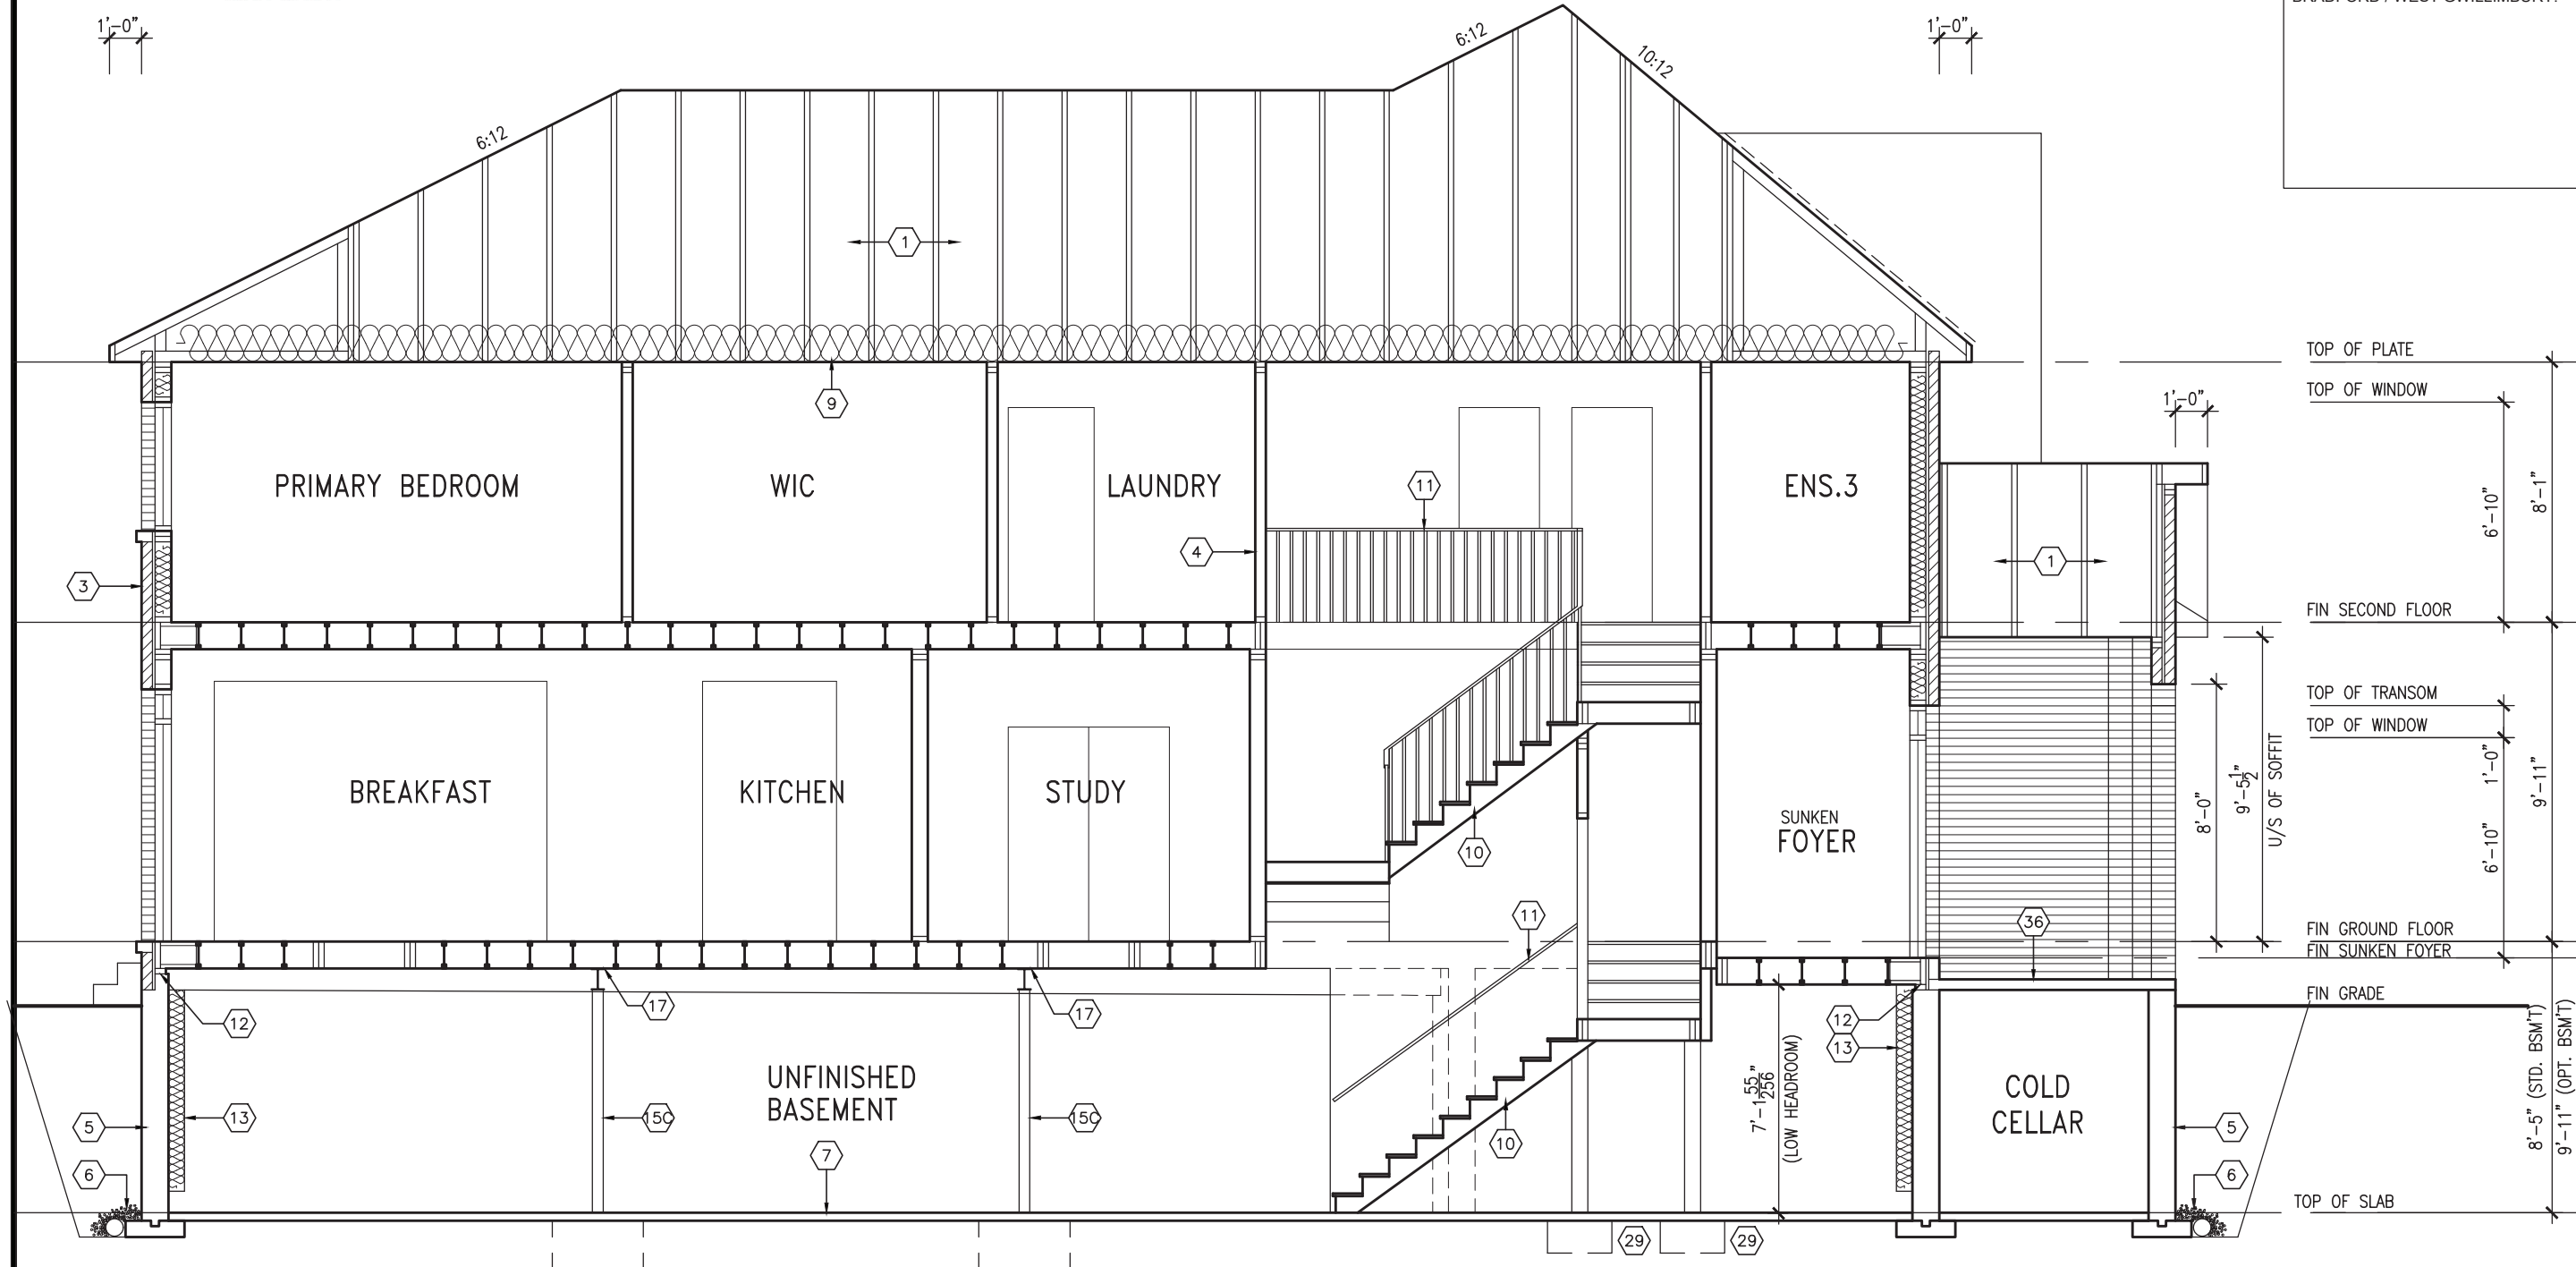
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checked by	JWM	checked by	JWM
drawn by	NS	drawn by	NS
date	OCTOBER 2021	date	MAR 1 2022



MAR 1, 2022



CROSS SECTION 'A-A'

REVIEWED

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BAYVIEW WELLINGTON		S38-19	
project name	GREEN VALLEY EAST	municipality	BRADFORD
project no.	16023	cross section	'A-A'
date	OCTOBER 2021	checked by	JWM
drawn by	NS	scale	3/16" = 1'-0"
file name	16023-S38-19	drawing no.	17
RICHARD - H:\ARCHIVE\WORKING\2016\16023-S38-19.dwg - Tue - Mar 1 2022 - 9:33 AM			
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Wellington Jno-Baptiste			
signature			
BCIN 25591			
42658			
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2. REVISED AS PER ENG'S COMMENTS	FEB 25-22	RC	
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no.	description	date	by

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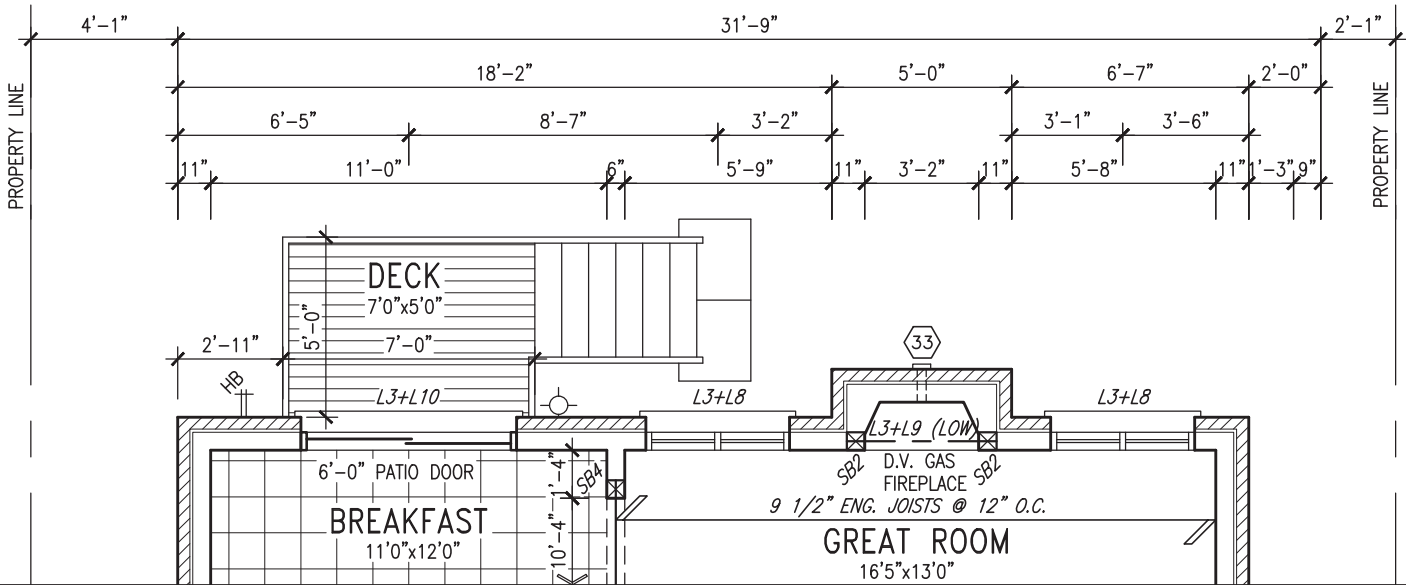
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JOHN G. WILLIAMS LTD., ARCHITECT
ARCHITECTURAL CONTROL REVIEW
AND APPROVAL

APPROVED BY:

DATE: MAR 03, 2022


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GROUND FLOOR PLAN 'A' - W.O.D. CONDITION
ELEV. 'B' & 'C' SIMILAR


NOTE: REFER TO STANDARD FLOOR PLANS FOR ADDITIONAL INFORMATION

REVIEWED



BASEMENT PLAN 'A' - W.O.D. CONDITION
ELEV. 'B' & 'C' SIMILAR

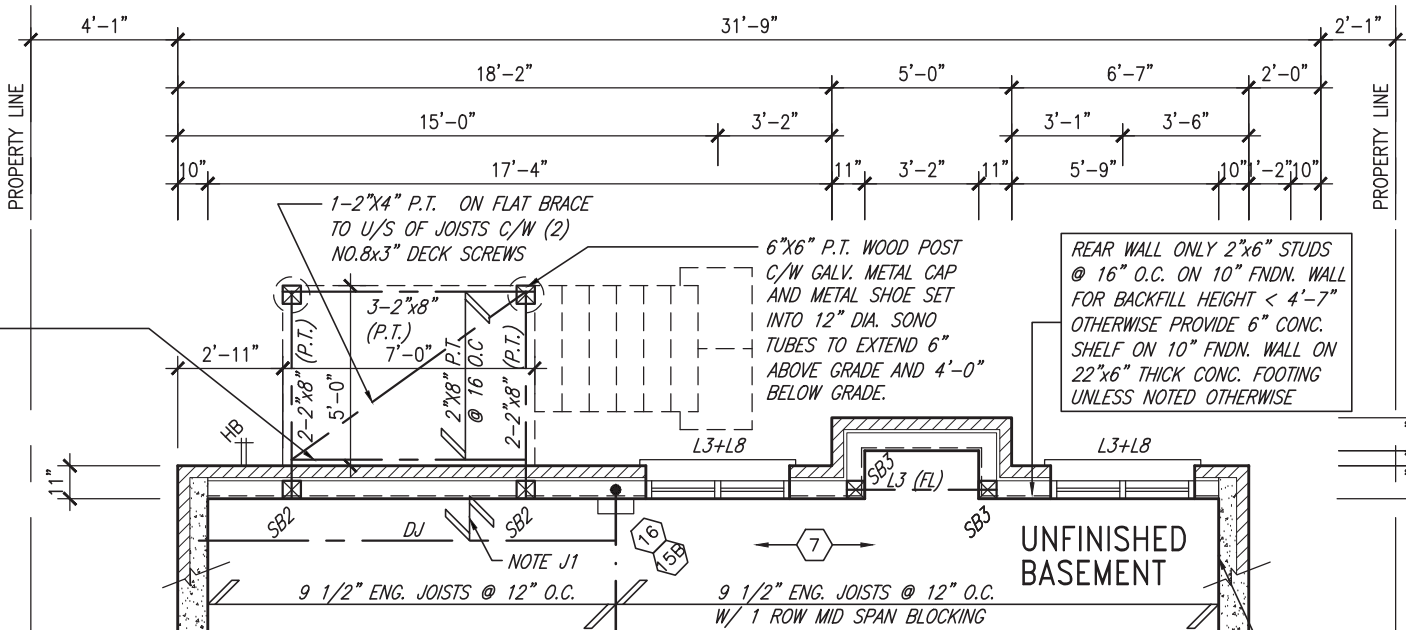10" FULL HEIGHT CONC. ON SIDE WALL W/ BRICK CHECK AS REQUIRED ON 22"x6" THICK CONC. FTG.

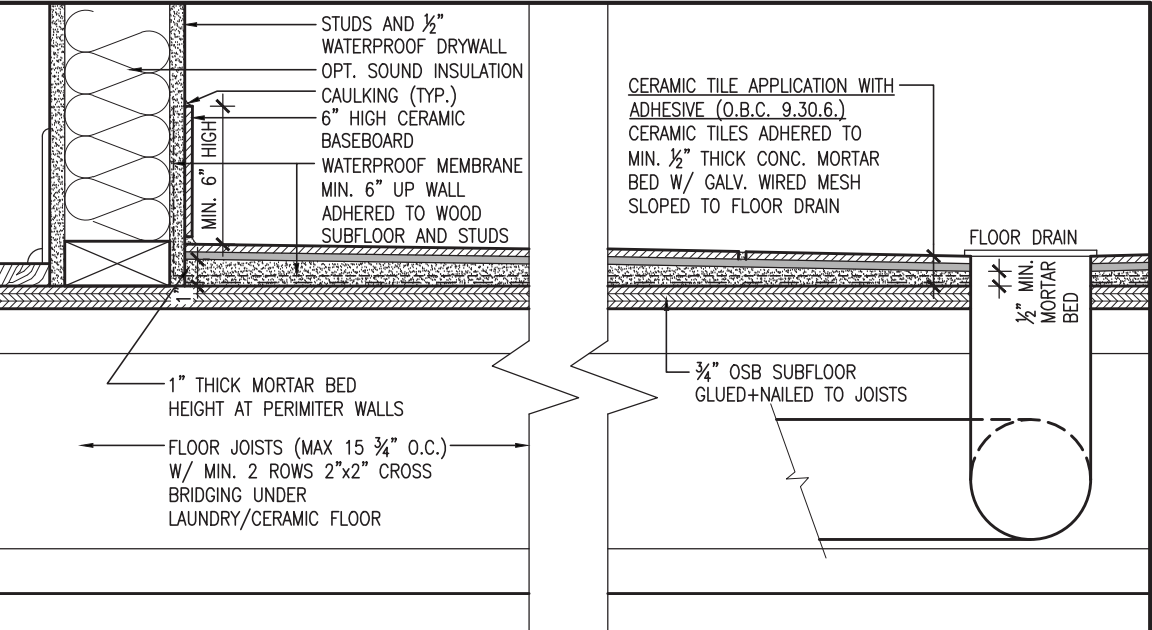

DETAIL THRU SLOPED CERAMIC FLOOR IN LAUNDRY



MAR 1, 2022

NOTE: SPACE ALL FLOOR JOISTS @ 12" O.C. UNDER ALL CERAMIC TILE AREAS.

NOTE: ALL LVL'S SUPPORTING FLOOR LOADS ARE TO BE SPECIFIED BY FLOOR TRUSS MANUFACTURER.

NOTE: FLOOR FRAMING INFO REFER TO SHOP DRAWINGS FOR ALL TRUSS-JOIST INFORMATION AND DETAILS. UNLESS OTHERWISE NOTED.

NOTE J1: PROVIDE SOLID BLOCKING @ 24" O.C. WHERE FLOOR JOISTS ARE PARALLEL TO FOUNDATION WALL (TYP.)

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6.	.	.	name registration information BCIN
5.	.	.	VA3 Design Inc. 42658
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no.	description	date	by



255 Consumers Rd Suite 120
Toronto ON M2J 1R4
t 416.630.2255 f 416.630.4782
va3design.com

BAYVIEW WELLINGTON

S38-19


project name	GREEN VALLEY EAST	municipality	BRADFORD	project no.	16023
date	OCTOBER 2021	checked by	JWM	scale	3/16" = 1'-0"
drawn by	NS	file name	16023-S38-19	drawing no.	18
RICHARD - H:\ARCHIVE\WORKING\2016\16023.BW\Units\38\16023-S38-19.dwg - Tue - Mar 1 2022 - 9:33 AM					

UNINSULATED OPENINGS (PER OBC. SB-12,3.1.1(7))				
S38-19 ELEVATION A/A REAR UPG WOD	ENERGY EFFICIENCY - OBC SB12			
ELEVATION	WALL AREA S.F.	OPENING S.F.	PERCENTAGE	
FRONT	614 S.F.	114.79 S.F.	18.70 %	
LEFT SIDE	1136 S.F.	88.00 S.F.	7.75 %	
RIGHT SIDE	1134 S.F.	102.00 S.F.	8.99 %	
REAR	714 S.F.	169.67 S.F.	23.76 %	
* OPENINGS OMITTED AS PER SB-12 3.1.1.9(4) MAX 19.9 S.F. REFER TO ELEVATION FOR LOCATION		0.00 S.F.		
TOTAL SQ. FT.	3598.00 S.F.	474.46 S.F.	13.19 %	
TOTAL SQ. M.	334.26 S.M.	44.08 S.M.	13.19 %	

UNINSULATED OPENINGS (PER OBC. SB-12,3.1.1(7))				
S38-19 ELEVATION B/B REAR UPG WOD	ENERGY EFFICIENCY - OBC SB12			
ELEVATION	WALL AREA S.F.	OPENING S.F.	PERCENTAGE	
FRONT	602 S.F.	136.89 S.F.	22.74 %	
LEFT SIDE	1145 S.F.	81.33 S.F.	7.10 %	
RIGHT SIDE	1142 S.F.	102.00 S.F.	8.93 %	
REAR	714 S.F.	169.67 S.F.	23.76 %	
* OPENINGS OMITTED AS PER SB-12 3.1.1.9(4) MAX 19.9 S.F. REFER TO ELEVATION FOR LOCATION		0.00 S.F.		
TOTAL SQ. FT.	3603.00 S.F.	489.89 S.F.	13.60 %	
TOTAL SQ. M.	334.73 S.M.	45.51 S.M.	13.60 %	

UNINSULATED OPENINGS (PER OBC. SB-12,3.1.1(7))				
S38-19 ELEVATION C WOD	ENERGY EFFICIENCY - OBC SB12			
ELEVATION	WALL AREA S.F.	OPENING S.F.	PERCENTAGE	
FRONT	613 S.F.	170.11 S.F.	27.75 %	
LEFT SIDE	1136 S.F.	81.33 S.F.	7.16 %	
RIGHT SIDE	1144 S.F.	117.56 S.F.	10.28 %	
REAR	714 S.F.	169.67 S.F.	23.76 %	
* OPENINGS OMITTED AS PER SB-12 3.1.1.9(4) MAX 19.9 S.F. REFER TO ELEVATION FOR LOCATION		0.00 S.F.		
TOTAL SQ. FT.	3607.00 S.F.	538.67 S.F.	14.93 %	
TOTAL SQ. M.	335.10 S.M.	50.04 S.M.	14.93 %	

REFER TO FRONT ELEVATION FOR TYPICAL NOTES.

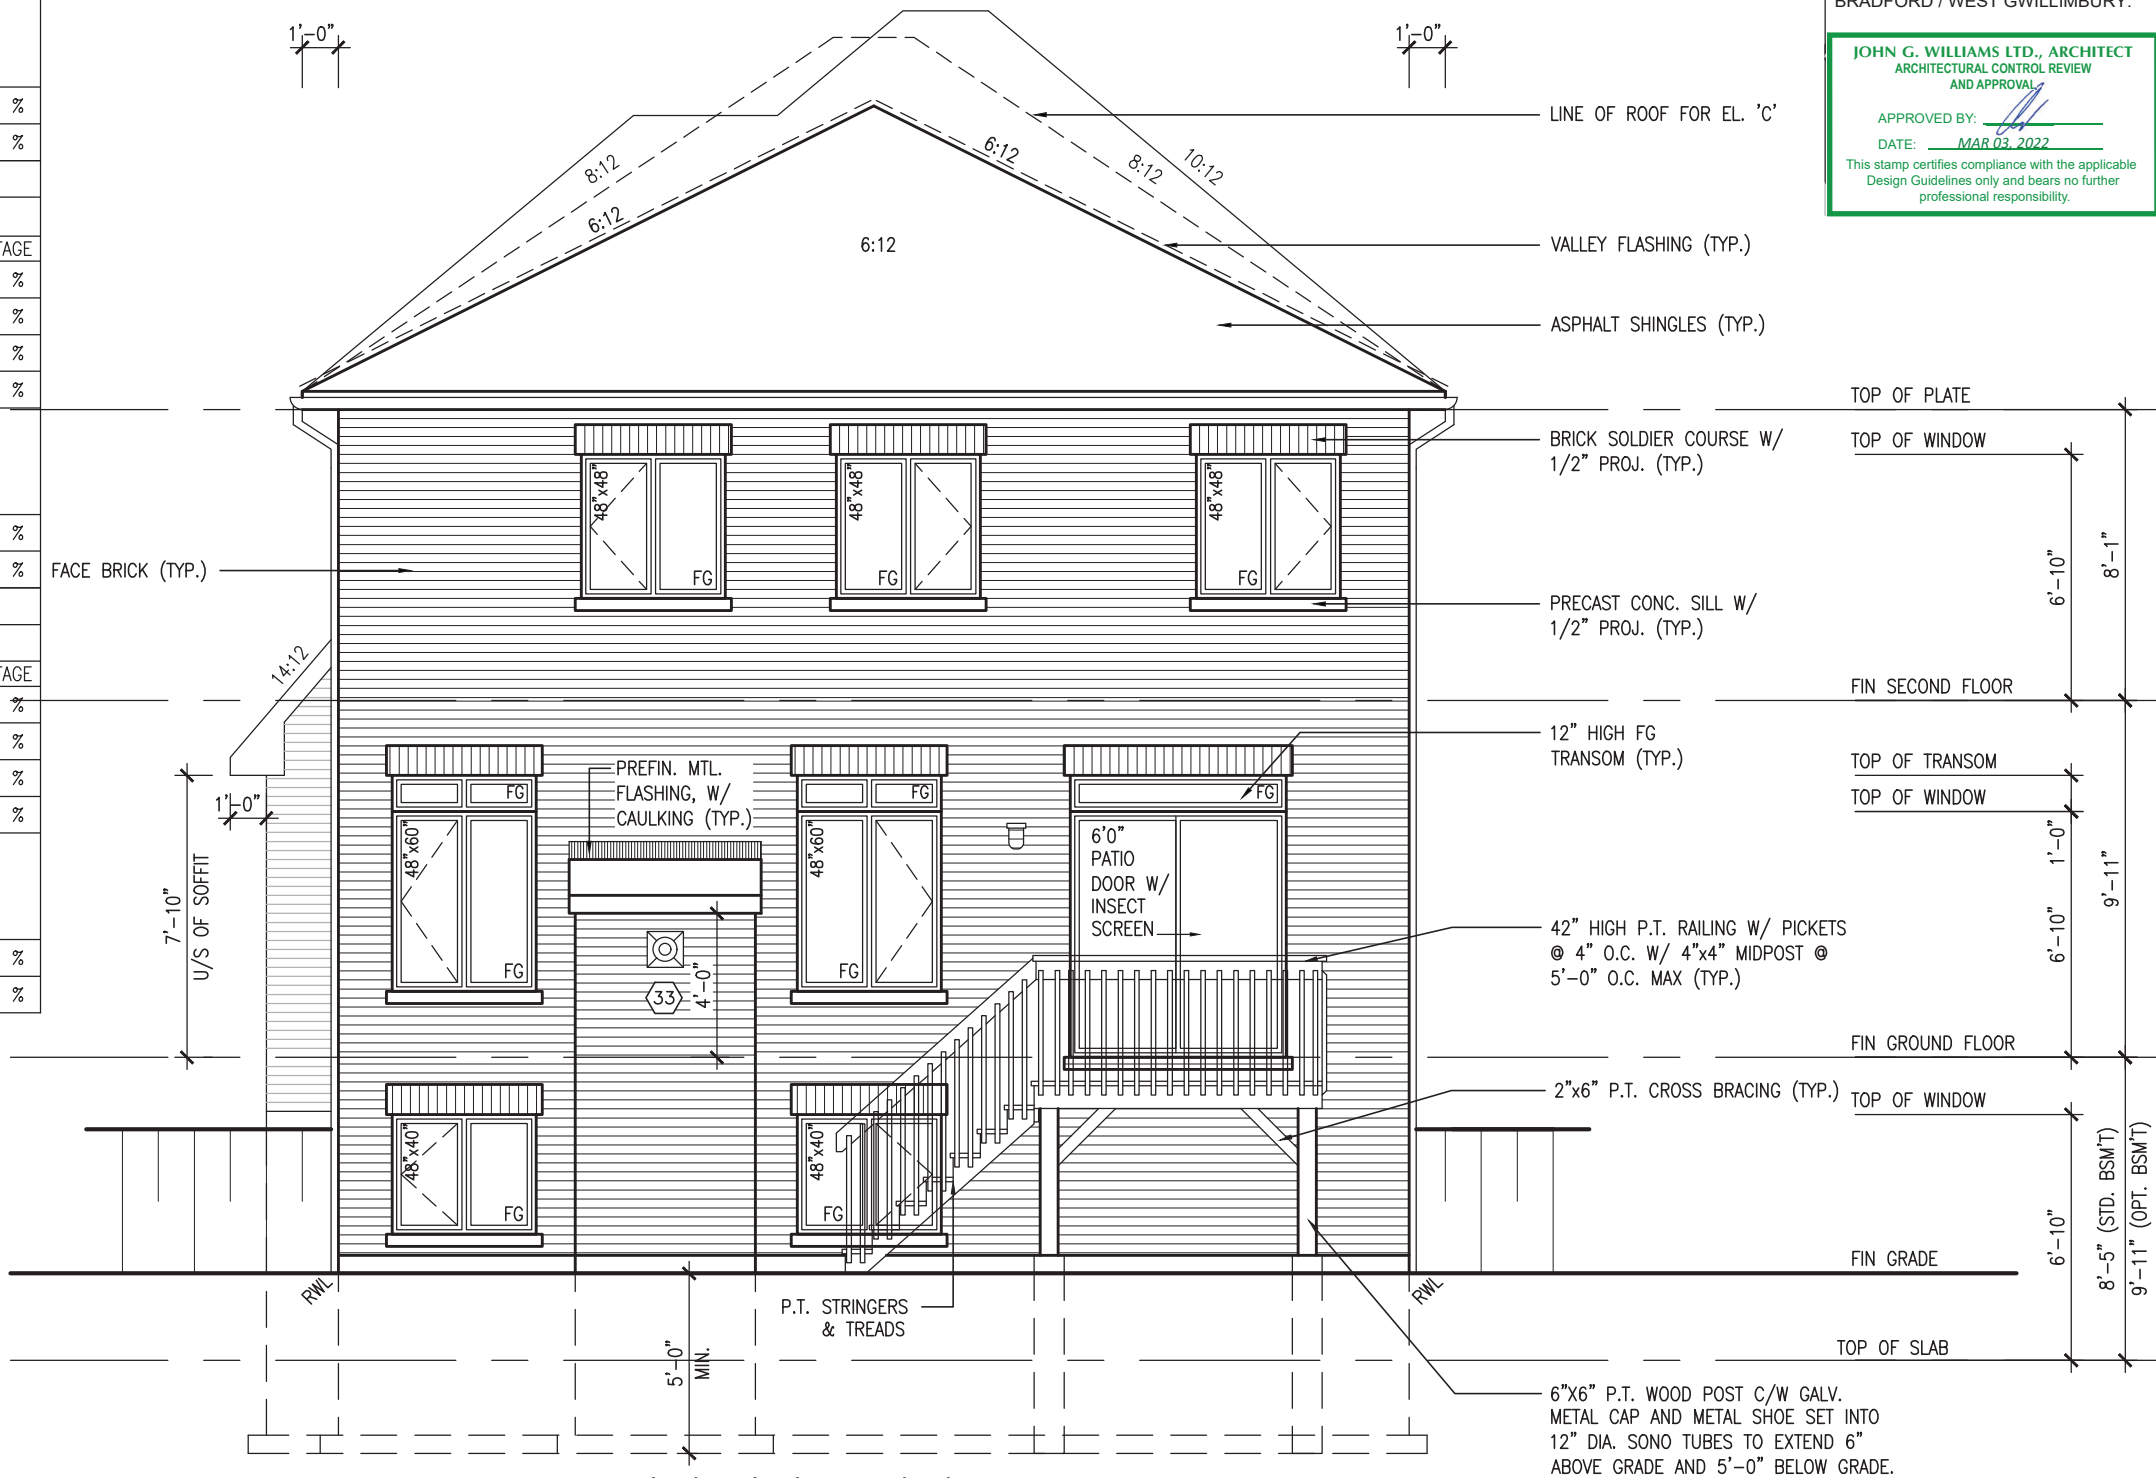

REAR ELEVATION 'A', 'B' & 'C' - WOD COND.

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JOHN G. WILLIAMS LTD., ARCHITECT
ARCHITECTURAL CONTROL REVIEW
AND APPROVAL
APPROVED BY: [Signature]
DATE: MAR 03, 2022
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S38-19		BAYVIEW WELLINGTON		GREEN VALLEY EAST		BRADFORD		16023		19	
project no.		municipality		project name		date		checked by		scale	
16023		BRADFORD		REAR ELEVATION 'A', 'B' & 'C' - WOD COND.		OCTOBER 2021		JWM		3/16" = 1'-0"	
drawing no.		file name		checked by		date		checked by		scale	
19		16023-S38-19		JWM		OCTOBER 2021		JWM		3/16" = 1'-0"	
project no.		municipality		project name		date		checked by		scale	
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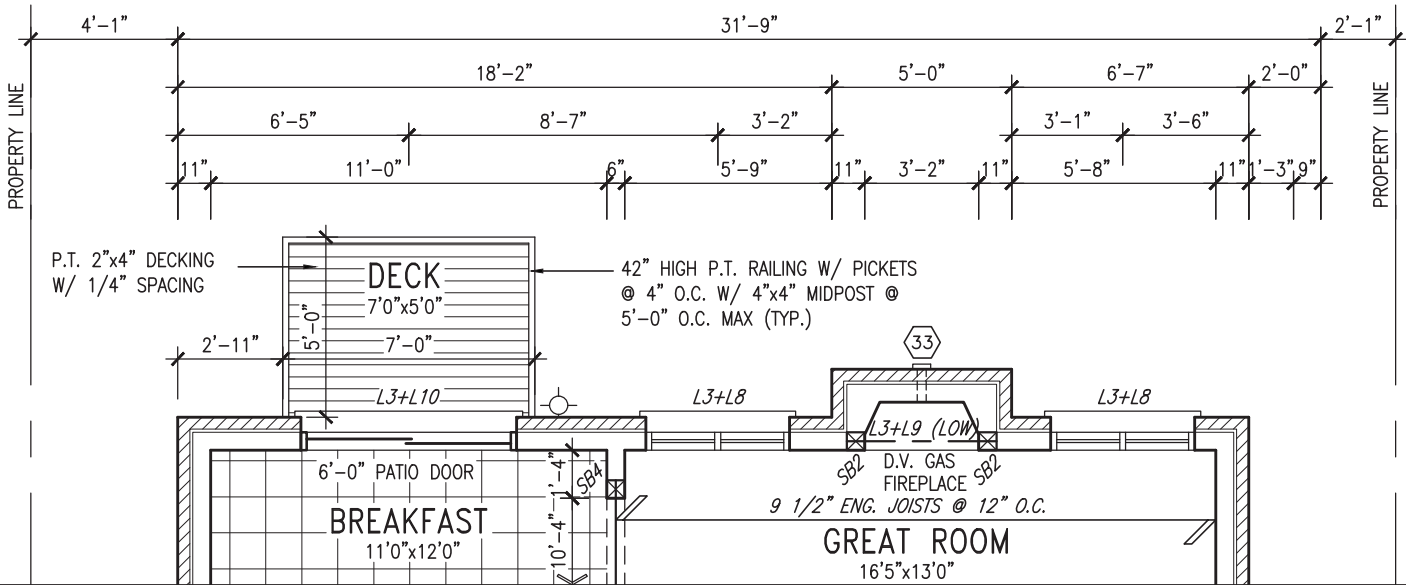
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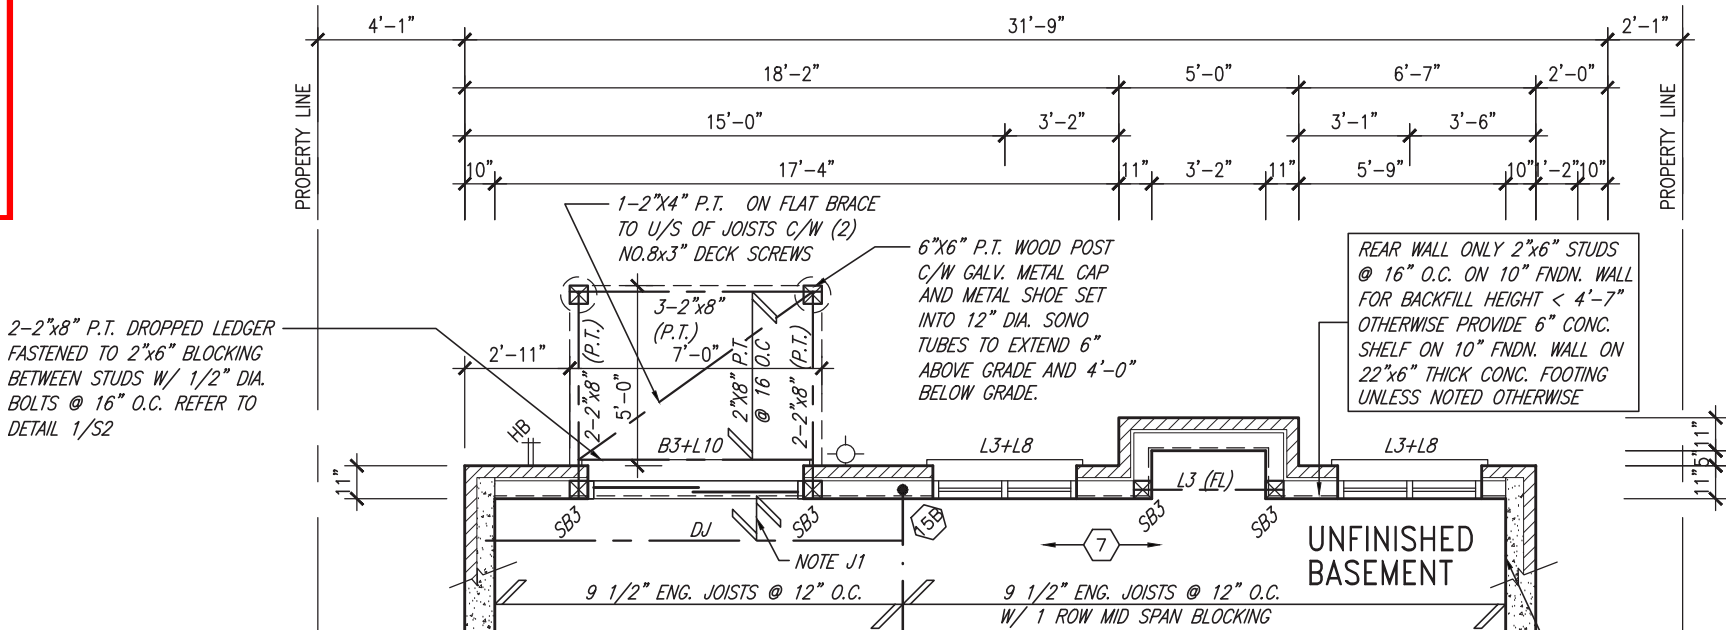
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GROUND FLOOR PLAN 'A' – W.O.B. CONDITION
ELEV. 'B' & 'C' SIMILAR

NOTE: REFER TO STANDARD FLOOR PLANS FOR ADDITIONAL INFORMATION

REVIEWED



BASEMENT PLAN 'A' – W.O.B. CONDITION
ELEV. 'B' & 'C' SIMILAR

10" FULL HEIGHT CONC. ON SIDE WALL W/ BRICK CHECK AS REQUIRED ON 22"x6" THICK CONC. FTG.



MAR 1, 2022

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1.	ISSUED FOR CLIENT REVIEW	NOV 23-21	VA3
no.	description	date	by

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Wellington Jno-Baptiste 25591
signature BCIN

VA3 Design Inc. 42658
name registration information

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BAYVIEW WELLINGTON


S38-19

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drawn by	NS	checked by	JWM	drawing no.	20
RICHARD - H:\ARCHIVE\WORKING\2016\16023.BW\Units\38\16023-S38-19.dwg - Tue - Mar 1 2022 - 9:33 AM					


UNINSULATED OPENINGS (PER OBC. SB-12,3.1.1(7))				
S38-19 ELEVATION A/A REAR UPG WOB	ENERGY EFFICIENCY - OBC SB12			
ELEVATION	WALL AREA S.F.	OPENING S.F.	PERCENTAGE	
FRONT	614 S.F.	114.79 S.F.	18.70 %	
LEFT SIDE	1136 S.F.	88.00 S.F.	7.75 %	
RIGHT SIDE	1134 S.F.	102.00 S.F.	8.99 %	
REAR	801 S.F.	224.00 S.F.	27.97 %	
* OPENINGS OMITTED AS PER SB-12 3.1.1.9(4) MAX 19.9 S.F. REFER TO ELEVATION FOR LOCATION		0.00 S.F.		
TOTAL SQ. FT.	3685.00 S.F.	528.79 S.F.	14.35 %	
TOTAL SQ. M.	342.34 S.M.	49.13 S.M.	14.35 %	

UNINSULATED OPENINGS (PER OBC. SB-12,3.1.1(7))				
S38-19 ELEVATION B/B REAR UPG WOB	ENERGY EFFICIENCY - OBC SB12			
ELEVATION	WALL AREA S.F.	OPENING S.F.	PERCENTAGE	
FRONT	602 S.F.	136.89 S.F.	22.74 %	
LEFT SIDE	1145 S.F.	81.33 S.F.	7.10 %	
RIGHT SIDE	1142 S.F.	102.00 S.F.	8.93 %	
REAR	801 S.F.	224.00 S.F.	27.97 %	
* OPENINGS OMITTED AS PER SB-12 3.1.1.9(4) MAX 19.9 S.F. REFER TO ELEVATION FOR LOCATION		0.00 S.F.		
TOTAL SQ. FT.	3690.00 S.F.	544.22 S.F.	14.75 %	
TOTAL SQ. M.	342.81 S.M.	50.56 S.M.	14.75 %	

UNINSULATED OPENINGS (PER OBC. SB-12,3.1.1(7))				
S38-19 ELEVATION C WOB	ENERGY EFFICIENCY - OBC SB12			
ELEVATION	WALL AREA S.F.	OPENING S.F.	PERCENTAGE	
FRONT	613 S.F.	170.11 S.F.	27.75 %	
LEFT SIDE	1136 S.F.	81.33 S.F.	7.16 %	
RIGHT SIDE	1144 S.F.	117.56 S.F.	10.28 %	
REAR	801 S.F.	224.00 S.F.	27.97 %	
* OPENINGS OMITTED AS PER SB-12 3.1.1.9(4) MAX 19.9 S.F. REFER TO ELEVATION FOR LOCATION		0.00 S.F.		
TOTAL SQ. FT.	3694.00 S.F.	593.00 S.F.	16.05 %	
TOTAL SQ. M.	343.18 S.M.	55.09 S.M.	16.05 %	

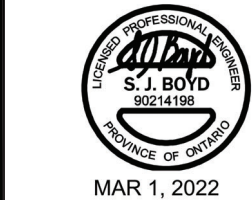

REVIEWED

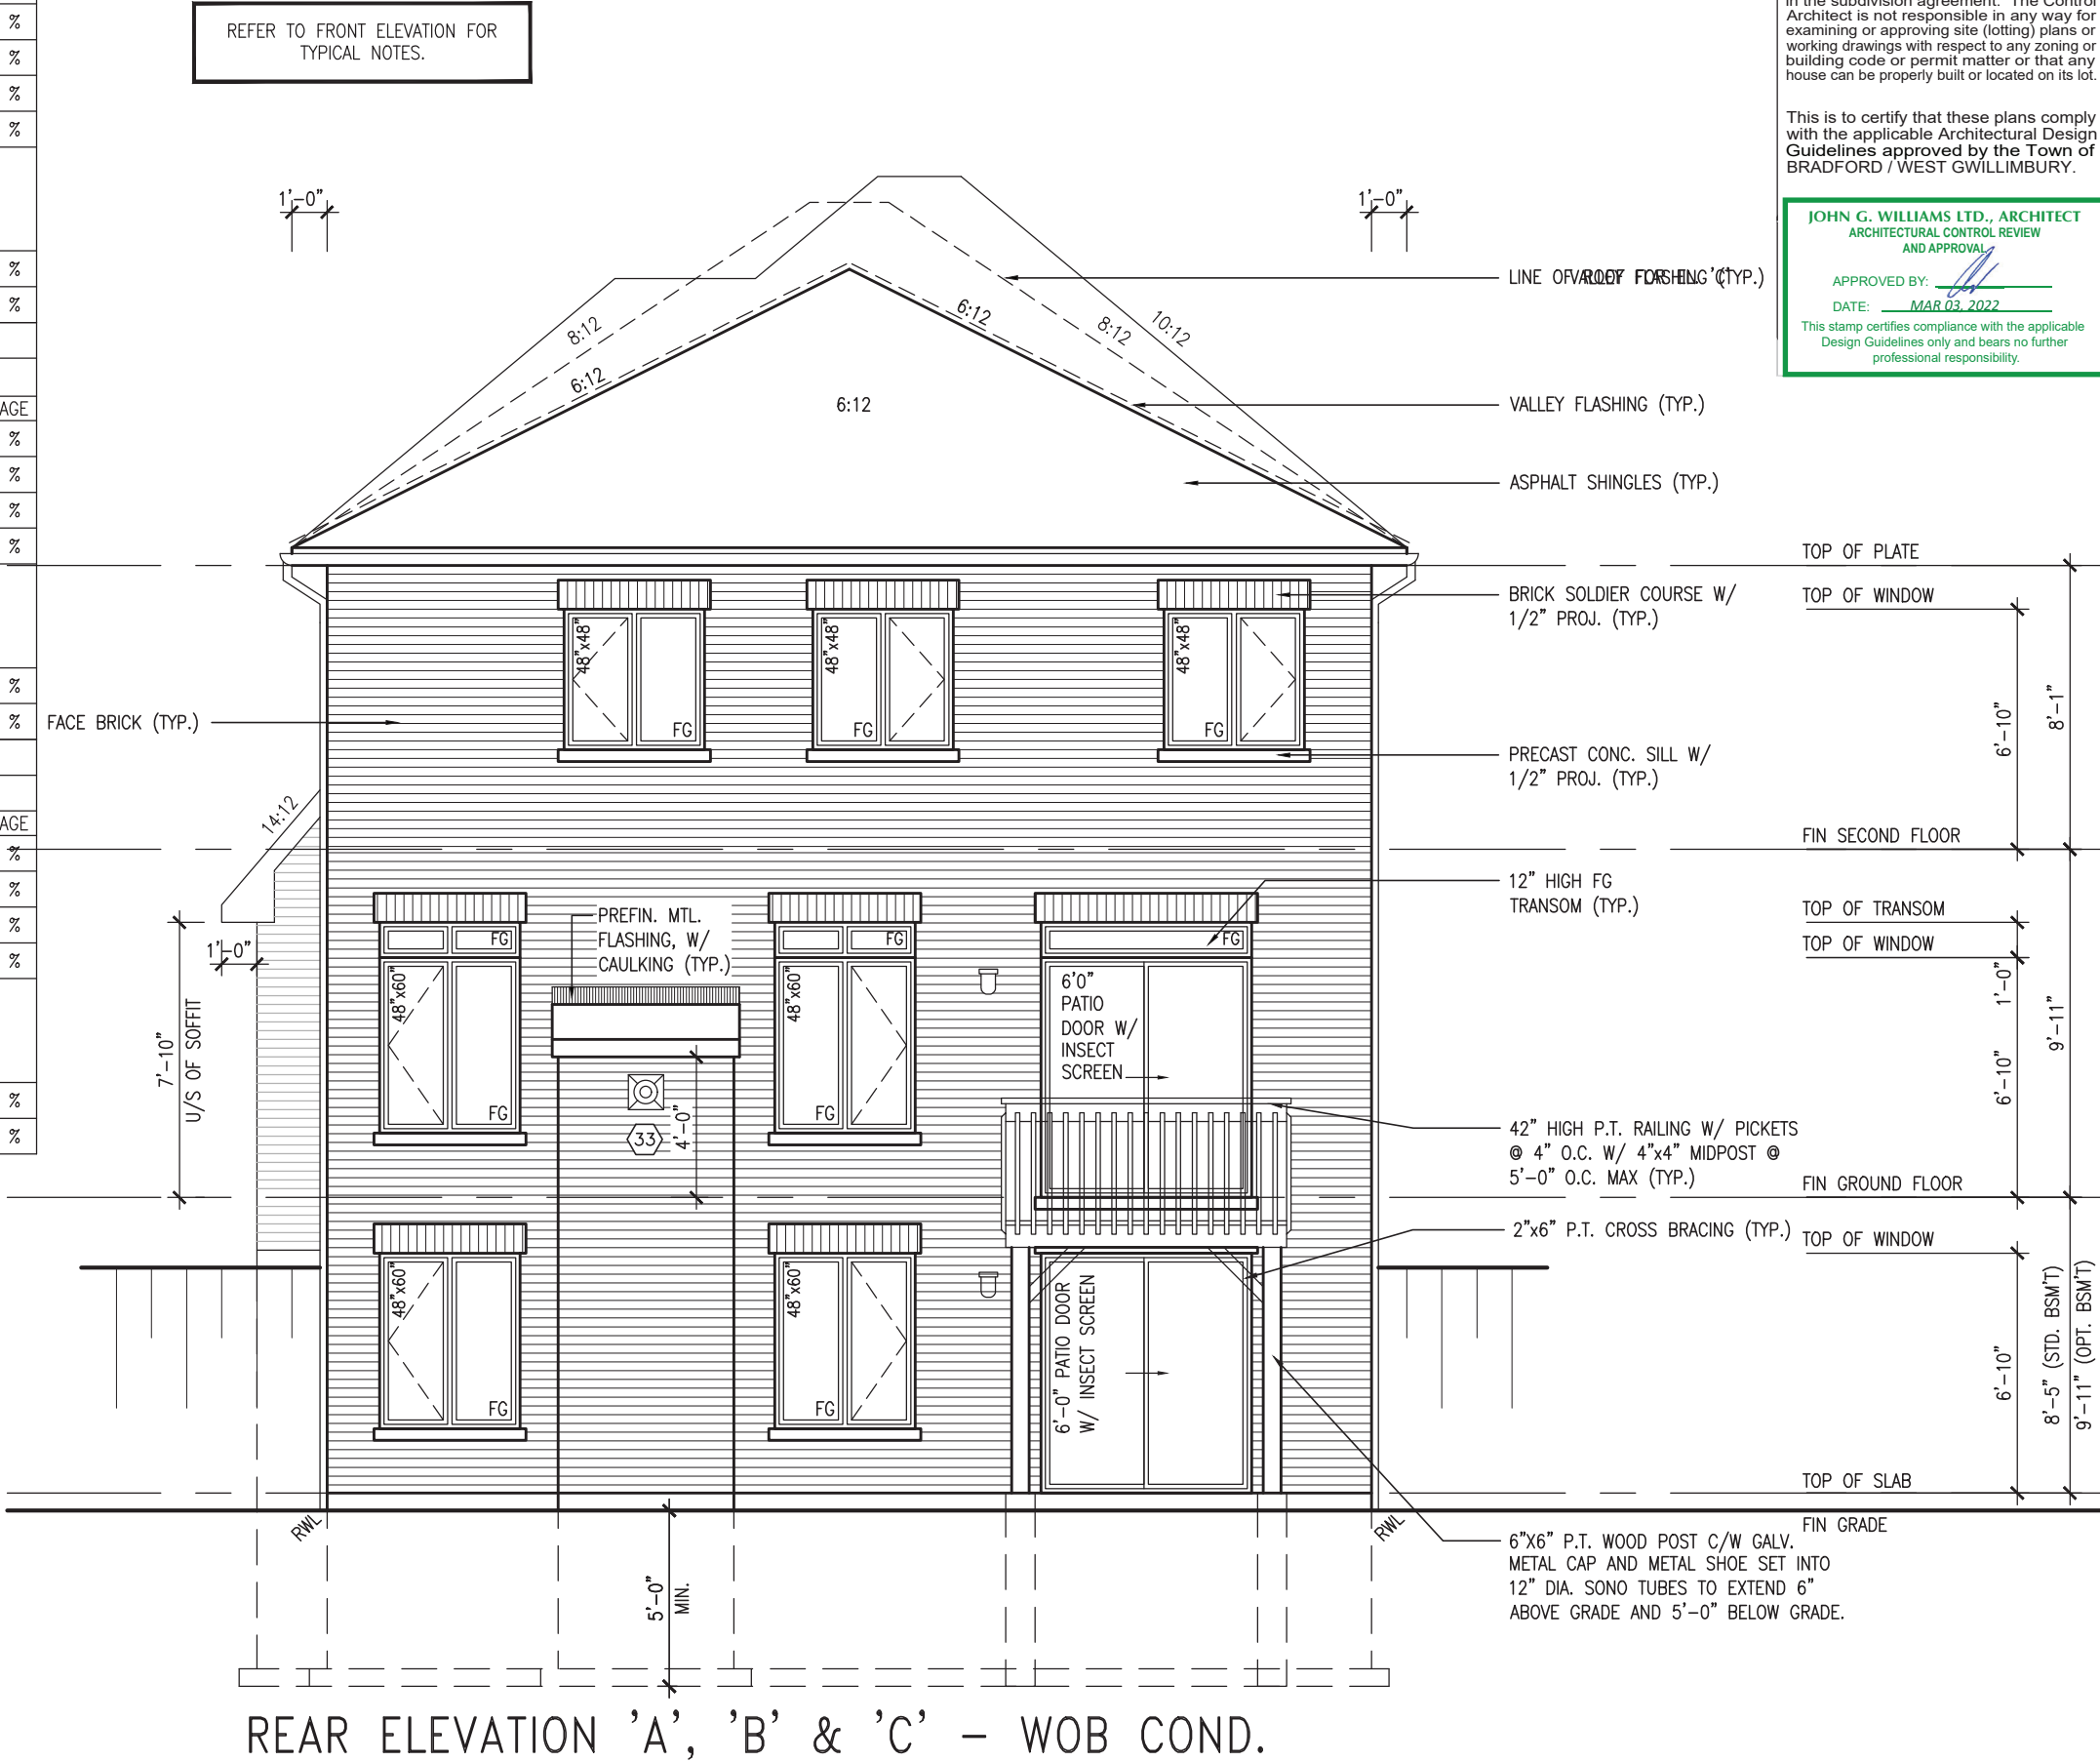

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JOHN G. WILLIAMS LTD., ARCHITECT
ARCHITECTURAL CONTROL REVIEW
AND APPROVAL
APPROVED BY: [Signature]
DATE: MAR 03, 2022
This stamp certifies compliance with the applicable Design Guidelines only and bears no further professional responsibility.

S38-19		BAYVIEW WELLINGTON		GREEN VALLEY EAST		BRADFORD		project no. 16023		drawing no. 21	
project name		municipality		date		checked by		scale		file name	
OCTOBER 2021		BRADFORD		OCTOBER 2021		JWM		3/16" = 1'-0"		16023-S38-19	
drawn by		checked by		drawn by		checked by		drawn by		checked by	
NS		NS		NS		JWM		NS		NS	
RICHARD - H:\ARCHIVE\WORKING\2016\16023.BW\Units\38\16023-S38-19.dwg - Tue - Mar 1 2022 - 9:33 AM		RICHARD - H:\ARCHIVE\WORKING\2016\16023.BW\Units\38\16023-S38-19.dwg - Tue - Mar 1 2022 - 9:33 AM		RICHARD - H:\ARCHIVE\WORKING\2016\16023.BW\Units\38\16023-S38-19.dwg - Tue - Mar 1 2022 - 9:33 AM		RICHARD - H:\ARCHIVE\WORKING\2016\16023.BW\Units\38\16023-S38-19.dwg - Tue - Mar 1 2022 - 9:33 AM		RICHARD - H:\ARCHIVE\WORKING\2016\16023.BW\Units\38\16023-S38-19.dwg - Tue - Mar 1 2022 - 9:33 AM		RICHARD - H:\ARCHIVE\WORKING\2016\16023.BW\Units\38\16023-S38-19.dwg - Tue - Mar 1 2022 - 9:33 AM	

VA3 DESIGN		255 Consumers Rd Suite 120 Toronto ON M2J 1R4 t 416.630.2255 f 416.630.4782 va3design.com							
The undersigned has reviewed and takes responsibility for this design and has the qualifications and meets the requirements set out in the Ontario Building Code to be a Designer.		Wellington Jno-Baptiste		25591		BCN		42658	
qualification information		name		registration information		signature		date	
		Wellington Jno-Baptiste		VAS Design Inc.		[Signature]			
Contractor must verify all dimensions on the job and report any discrepancy to the Designer before proceeding with the work. All drawings and specifications are instruments of service and the property of the Designer which must be returned at the completion of the work. Drawings are not to be scaled.		FEB 25-22 RC		NOV 23-21 VAS					
2. REVISED AS PER ENG'S COMMENTS									
1. ISSUED FOR CLIENT REVIEW									
no. description									

UNINSULATED OPENINGS (PER OBC. SB-12.3.1.1(7))			
S38-19 ELEVATION C REAR UPG	ENERGY EFFICIENCY - OBC SB12		
ELEVATION	WALL AREA S.F.	OPENING S.F.	PERCENTAGE
FRONT	613 S.F.	170.11 S.F.	27.75 %
LEFT SIDE	1136 S.F.	81.33 S.F.	7.16 %
RIGHT SIDE	1144 S.F.	117.56 S.F.	10.28 %
REAR	595 S.F.	165.62 S.F.	27.84 %
* OPENINGS OMITTED AS PER SB-12 3.1.1.9(4) MAX 19.9 S.F. REFER TO ELEVATION FOR LOCATION		0.00 S.F.	
TOTAL SQ. FT.	3488.00 S.F.	534.62 S.F.	15.33 %
TOTAL SQ. M.	324.04 S.M.	49.67 S.M.	15.33 %

9'-0" GROUND FLOOR

REVIEWED




MAR 1, 2022

UPGRADED REAR ELEVATION 'C'



REFER TO FRONT ELEVATION FOR TYPICAL NOTES.

UPGRADED ROOF PLAN 'C'

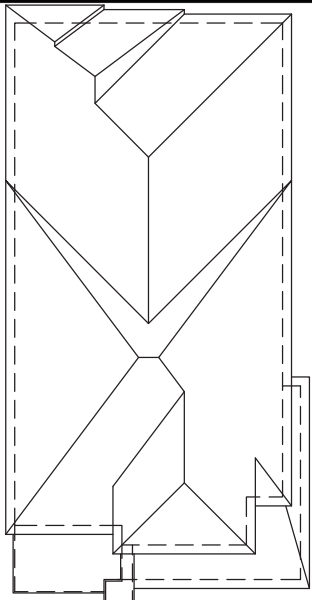


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JOHN G. WILLIAMS LTD., ARCHITECT
ARCHITECTURAL CONTROL REVIEW
AND APPROVAL

APPROVED BY: [Signature]
DATE: MAR 03, 2022

This stamp certifies compliance with the applicable Design Guidelines only and bears no further professional responsibility.



project no. 16023		drawing no. 24	
project name S38-19		file name 16023-S38-19	
municipality BRADFORD		scale 3/16" = 1'-0"	
date OCTOBER 2021		checked by JWM	
down by NS		RICHARD - H:\ARCHIVE\WORKING\2016\16023\B.W\Units\38\16023-S38-19.dwg - Tue - Mar 1 2022 - 9:33 AM	
project name BAYVIEW WELLINGTON		municipality GREEN VALLEY EAST	
project no. 25591		BCN 42658	
signature [Signature]		name Wellington Jno-Baptiste	
registration information VAS Design Inc.		name VAS Design Inc.	
Contractor must verify all dimensions on the job and report any discrepancy to the Designer before proceeding with the work. All drawings and specifications are instruments of service and the property of the Designer which must be returned at the completion of the work. Drawings are not to be scaled.		Contractor must verify all dimensions on the job and report any discrepancy to the Designer before proceeding with the work. All drawings and specifications are instruments of service and the property of the Designer which must be returned at the completion of the work. Drawings are not to be scaled.	
2. REVISED AS PER ENG'S COMMENTS		FEB 25-22 RC	
1. ISSUED FOR CLIENT REVIEW		NOV 23-21 VAS	
no. description		date by	

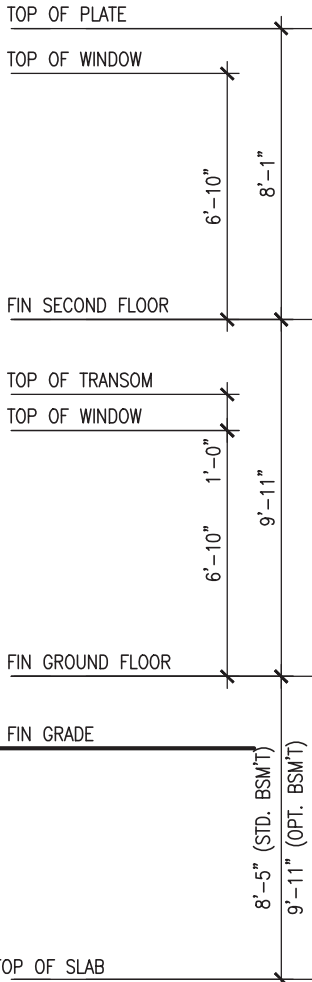REFER TO FRONT ELEVATION FOR
TYPICAL NOTES.

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JOHN G. WILLIAMS LTD., ARCHITECT
ARCHITECTURAL CONTROL REVIEW
AND APPROVAL

APPROVED BY: 
DATE: MAR 03, 2022

This stamp certifies compliance with the applicable
Design Guidelines only and bears no further
professional responsibility.

S38-19

BAYVIEW WELLINGTON

BAYVIEW

VA3
DESIGN
255 Consumers Rd Suite 120
Toronto ON M2J 1R4
t 416.630.2255 f 416.630.4782
vo3design.com

<p>the undersigned has reviewed and takes responsibility for this design and has the qualifications and meets the requirements set out in the Ontario Building Code to be a Designer.</p> <p>information information</p>		25591
<p>Wellington Jno-Baptiste</p>	<p>name registration information</p> <p><i>Jno-Baptiste</i> signature</p>	BCIN
<p>VAS Design Inc.</p>	<p>Contractor must verify all dimensions on the job and report any discrepancy to the Designer before proceeding with the work. All drawings and specifications are instruments of service and the property of the Designer which must be returned at the completion of the work. Drawings are not to be scaled.</p>	42658

9	.	.	.
8	.	.	.
7	.	.	.
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4	.	.	.
3	.	.	.
2	REVISED AS PER ENG'S COMMENTS	FEB 25-22	REV
1	ISSUED FOR CLIENT REVIEW	NOV 23-21	VA
no.	description	date	by

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REVIEWED



MAR 1, 2022

UPGRADED REAR ELEVATION 'A' – WOD COND.


— 6"X6" P.T. WOOD POST C/W GALV.
METAL CAP AND METAL SHOE SET INTO
12" DIA. SONO TUBES TO EXTEND 6"
ABOVE GRADE AND 5'-0" BELOW GRADE.

REVIEWED

REFER TO FRONT ELEVATION FOR
TYPICAL NOTES.



MAR 1, 2022

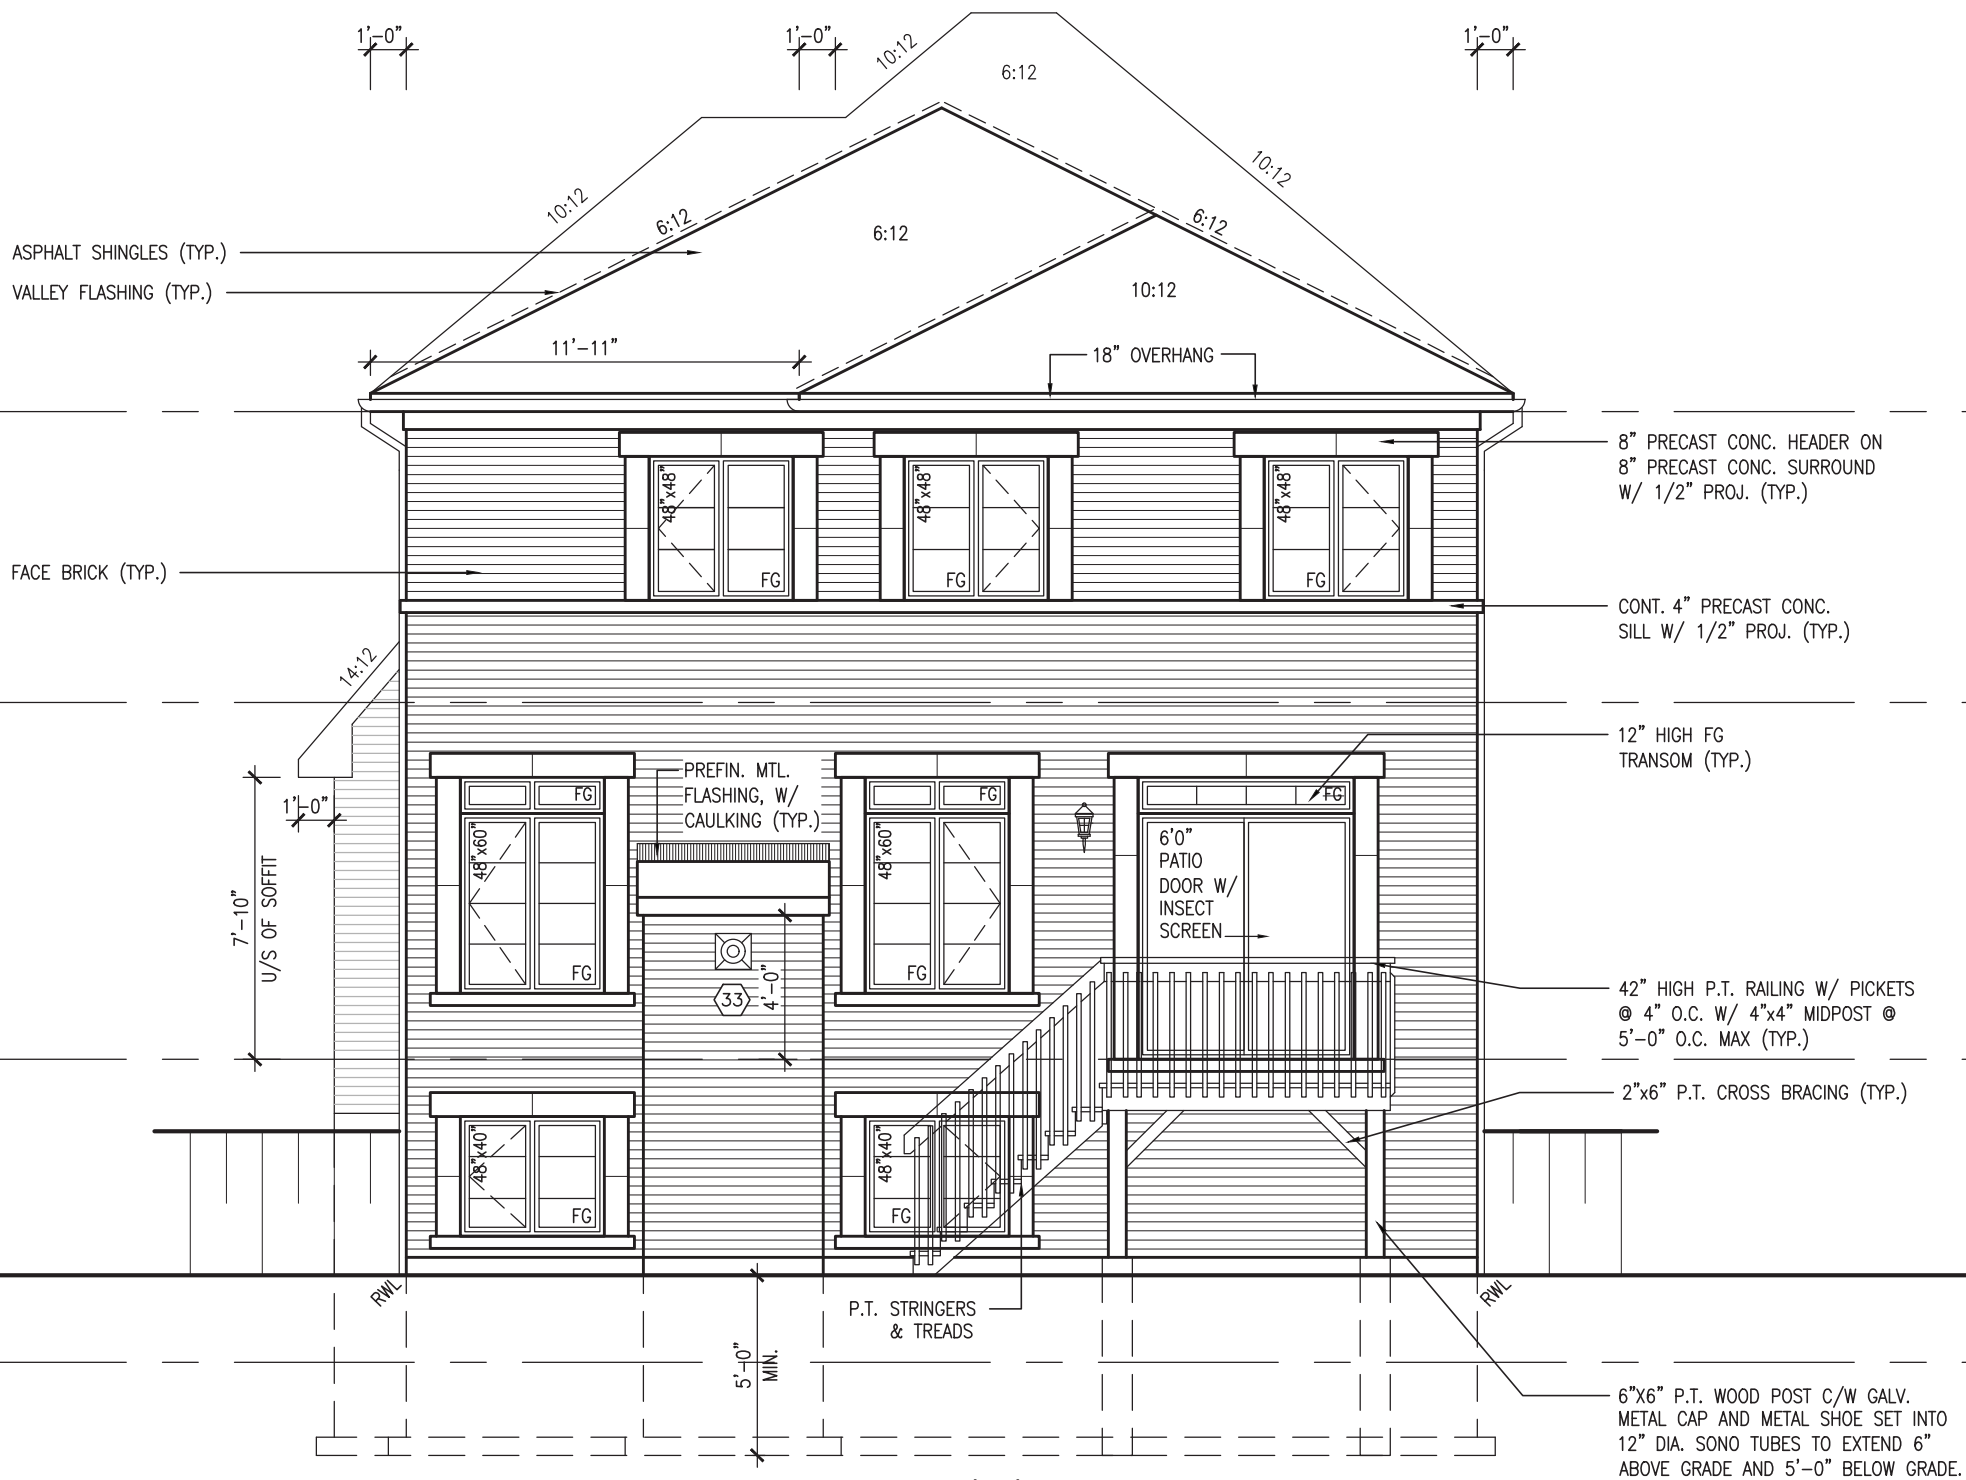

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JOHN G. WILLIAMS LTD., ARCHITECT
ARCHITECTURAL CONTROL REVIEW
AND APPROVAL

APPROVED BY:

DATE: MAR 03, 2022

This stamp certifies compliance with the applicable Design Guidelines only and bears no further professional responsibility.

TOP OF PLATE

TOP OF WINDOW

6'-10"

8'-1"

FIN SECOND FLOOR

TOP OF TRANSOM

TOP OF WINDOW

1'-0"

6'-10"

9'-11"

FIN GROUND FLOOR

TOP OF WINDOW

6'-10"

8'-5" (STD. BSM'T)

9'-11" (OPT. BSM'T)

FIN GRADE


TOP OF SLAB

S38-19		BAYVIEW WELLINGTON		GREEN VALLEY EAST		BRADFORD		16023	
project no.		drawing no.		file name		scale		checked by	
16023		26		16023-S38-19		3/16" = 1'-0"		JWM	
date		date		date		date		date	
OCTOBER 2021		OCTOBER 2021		OCTOBER 2021		OCTOBER 2021		OCTOBER 2021	
down by		down by		down by		down by		down by	
NS		NS		NS		NS		NS	
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The undersigned has reviewed and takes responsibility for this design and has the qualifications and meets the requirements set out in the Ontario Building Code to be a Designer.		The undersigned has reviewed and takes responsibility for this design and has the qualifications and meets the requirements set out in the Ontario Building Code to be a Designer.		The undersigned has reviewed and takes responsibility for this design and has the qualifications and meets the requirements set out in the Ontario Building Code to be a Designer.		The undersigned has reviewed and takes responsibility for this design and has the qualifications and meets the requirements set out in the Ontario Building Code to be a Designer.		The undersigned has reviewed and takes responsibility for this design and has the qualifications and meets the requirements set out in the Ontario Building Code to be a Designer.	
Wellington Jno-Baptiste		Wellington Jno-Baptiste		Wellington Jno-Baptiste		Wellington Jno-Baptiste		Wellington Jno-Baptiste	
25591		25591		25591		25591		25591	
BCIN		BCIN		BCIN		BCIN		BCIN	
42658		42658		42658		42658		42658	
name		name		name		name		name	
Wellington Jno-Baptiste		Wellington Jno-Baptiste		Wellington Jno-Baptiste		Wellington Jno-Baptiste		Wellington Jno-Baptiste	
signature		signature		signature		signature		signature	
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FEB 25-22 RC		FEB 25-22 RC		FEB 25-22 RC		FEB 25-22 RC		FEB 25-22 RC	
NOV 23-21 VAS		NOV 23-21 VAS		NOV 23-21 VAS		NOV 23-21 VAS		NOV 23-21 VAS	
REVISED AS PER ENG'S COMMENTS		REVISED AS PER ENG'S COMMENTS		REVISED AS PER ENG'S COMMENTS		REVISED AS PER ENG'S COMMENTS		REVISED AS PER ENG'S COMMENTS	
ISSUED FOR CLIENT REVIEW		ISSUED FOR CLIENT REVIEW		ISSUED FOR CLIENT REVIEW		ISSUED FOR CLIENT REVIEW		ISSUED FOR CLIENT REVIEW	
no.		no.		no.		no.		no.	
description		description		description		description		description	

REFER TO FRONT ELEVATION FOR
TYPICAL NOTES.

This is to certify that these plans comply with the applicable Architectural Design Guidelines approved by the Town of BRADFORD / WEST GWILLIMBURY.

JOHN G. WILLIAMS LTD., ARCHITECT
ARCHITECTURAL CONTROL REVIEW
AND APPROVAL

APPROVED BY: 

DATE: MAR 03, 2022

This stamp certifies compliance with the applicable Design Guidelines only and bears no further professional responsibility.

BAYVIEW WELLINGTON	S38-19
project name GREEN VALLEY EAST	municipality BRADFORD
date OCTOBER 2021	project no. 16023
drawn by NS	drawing no. 29
checked by JWM	scale 3/16" = 1'-0"
file name 16023-S38-19	
RICHARD - H:\ARCHIVE\WORKING\2016\16023.BW Units\38\16023-S38-19.dwg -- Tue - Mar 1, 2022 - 9:33 AM	

VA3
DESIGN
255 Consumers Rd Suite 120
Toronto ON M2J 1R4
t 416.630.2255 f 416.630.4782
vo3design.com

[illegible]

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REVIEWED



MAR 1, 2022

UPGRADED REAR ELEVATION 'B' - WOB COND.

ASPHALT SHINGLES (TYP.)

VALLEY FLASHING (TYP.)

FACE BRICK (TYP.)

— 8" PRECAST CONC. HEADER ON
8" PRECAST CONC. SURROUND
W/ 1/2" PROJ. (TYP.)

— CONT. 4" PRECAST CONC.
SILL W/ 1/2" PROJ. (TYP.)

— 12" HIGH FG
TRANSOM (TYP.)

— 42" HIGH P.T. RAILING W/ PICKETS
@ 4" O.C. W/ 4"x4" MIDPOST @
5'-0" O.C. MAX (TYP.)

— 2"x6" P.T. CROSS BRACING (TYP.)

— 6"X6" P.T. WOOD POST C/W GALV.
METAL CAP AND METAL SHOE SET INTO
12" DIA. SONO TUBES TO EXTEND 6"
ABOVE GRADE AND 5'-0" BELOW GRADE.

TOP OF PLATE

TOP OF WINDOW

FIN SECOND FLOOR

TOP OF TRANSOM

TOP OF WINDOW

FIN GROUND FLOOR


TOP OF WINDOW/DOOR

TOP OF SLAB

2	REVISED AS
1	ISSUED FOR
no.	description

UNINSULATED OPENINGS (PER OBC. SB-12,3.1.1(7))				
9'-0" GROUND FLOOR	S38-19 ELEVATION C REAR UPG WOB	ENERGY EFFICIENCY – OBC SB12		
	ELEVATION	WALL AREA S.F.	OPENING S.F.	PERCENTAGE
	FRONT	613 S.F.	170.11 S.F.	27.75 %
	LEFT SIDE	1136 S.F.	81.33 S.F.	7.16 %
	RIGHT SIDE	1144 S.F.	117.56 S.F.	10.28 %
	REAR	801 S.F.	252.57 S.F.	31.53 %
	* OPENINGS OMITTED AS PER SB-12 3.1.1.9(4) MAX 19.9 S.F. REFER TO ELEVATION FOR LOCATION		0.00 S.F.	
	TOTAL SQ. FT.	3694.00 S.F.	621.57 S.F.	16.83 %
TOTAL SQ. M.	343.18 S.M.	57.75 S.M.	16.83 %	

UNINSULATED OPENINGS (PER OBC. SB-12,3.1.1(7))					
SB-12-19 ELEVATION C REAR UPG WOB	ENERGY EFFICIENCY – OBC SB12				
	ELEVATION	WALL	AREA S.F.	OPENING S.F.	PERCENTAGE
	FRONT		613 S.F.	170.11 S.F.	27.75 %
	LEFT SIDE		1136 S.F.	81.33 S.F.	7.16 %
	RIGHT SIDE		1144 S.F.	117.56 S.F.	10.28 %
	REAR		830 S.F.	252.57 S.F.	30.43 %
	* OPENINGS OMITTED AS PER SB-12 3.1.1.9(4) MAX 19.9 S.F. REFER TO ELEVATION FOR LOCATION			0.00 S.F.	
	TOTAL SQ. FT.		3723.00 S.F.	621.57 S.F.	16.70 %
TOTAL SQ. M.		345.88 S.M.	57.75 S.M.	16.70 %	

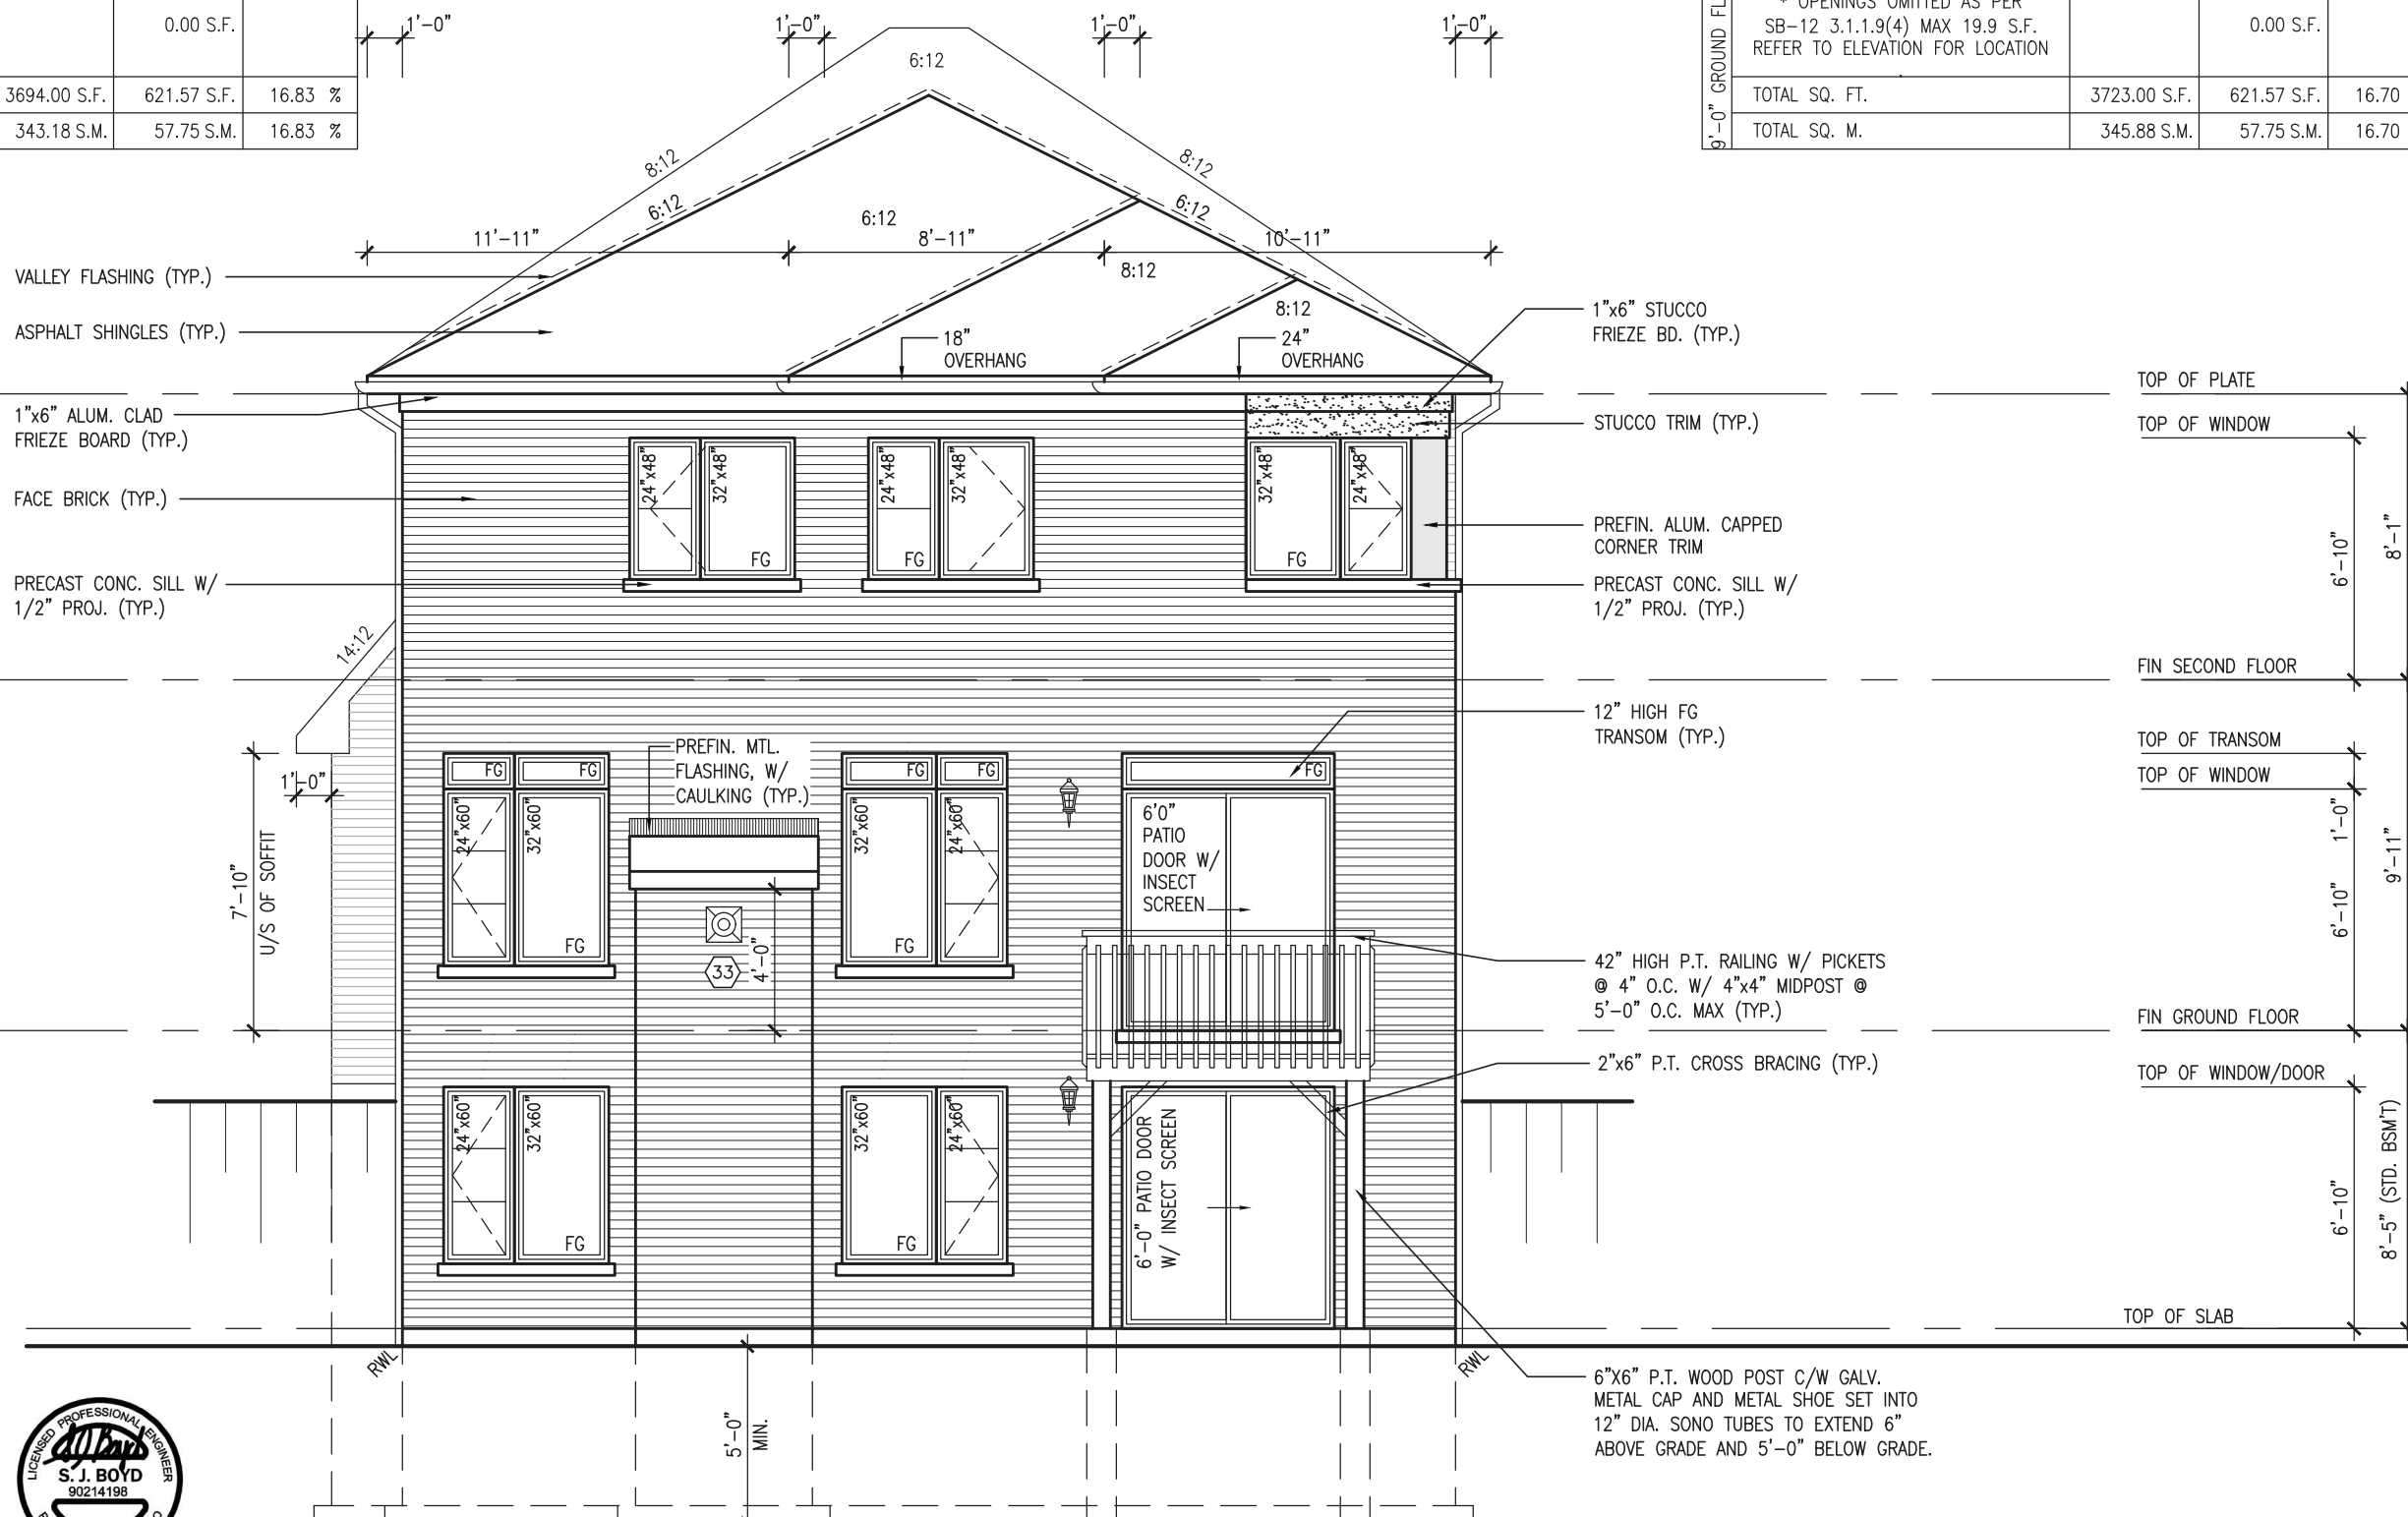

REVIEWED

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JOHN G. WILLIAMS LTD., ARCHITECT
ARCHITECTURAL CONTROL REVIEW
AND APPROVAL

APPROVED BY: _____
DATE: MAR 03, 2022

This stamp certifies compliance with the applicable
Design Guidelines only and bears no further
professional responsibility.

MAR 1, 2022

UPGRADED REAR ELEVATION 'C' - WOB COND.

6"X6" P.T. WOOD POST C/W GALV.
METAL CAP AND METAL SHOE SET INTO
12" DIA. SONO TUBES TO EXTEND 6"
ABOVE GRADE AND 5'-0" BELOW GRADE.

9	.	.	The undersigned has reviewed and takes responsibility for this design and has the qualifications and meets the requirements set out in the Ontario Building Code to be a Designer.	25591	 signature	BCIN	 VA3 DESIGN 255 Consumers Rd Suite 120 Toronto ON M2J 1R4 t 416.630.2235 f 416.630.4782 va3design.com	BAYVIEW WELLINGTON GREEN VALLEY EAST project name municipality BRADFORD	S38-19
8	.	.	qualification information	name		registration information			
7	.	.	Wellington Jho-Baptiste	VA3 Design Inc.		42658			
6	.	.							
5	.	.							
4	.	.							
3	.	.							
2	REVISED AS PER ENG'S COMMENTS	FEB 25-22	RC	Contractor must verify all dimensions on the job and report any discrepancy to the Designer before proceeding with the work. All drawings and specifications are instruments of service and the property of the Designer which must be returned at the completion of the work. Drawings are not to be scaled.					
1	ISSUED FOR CLIENT REVIEW	NOV 23-21	VA3						
no.	description	date	by						

REVIEWED

10' GROUND

ROOF PLAN 'A'

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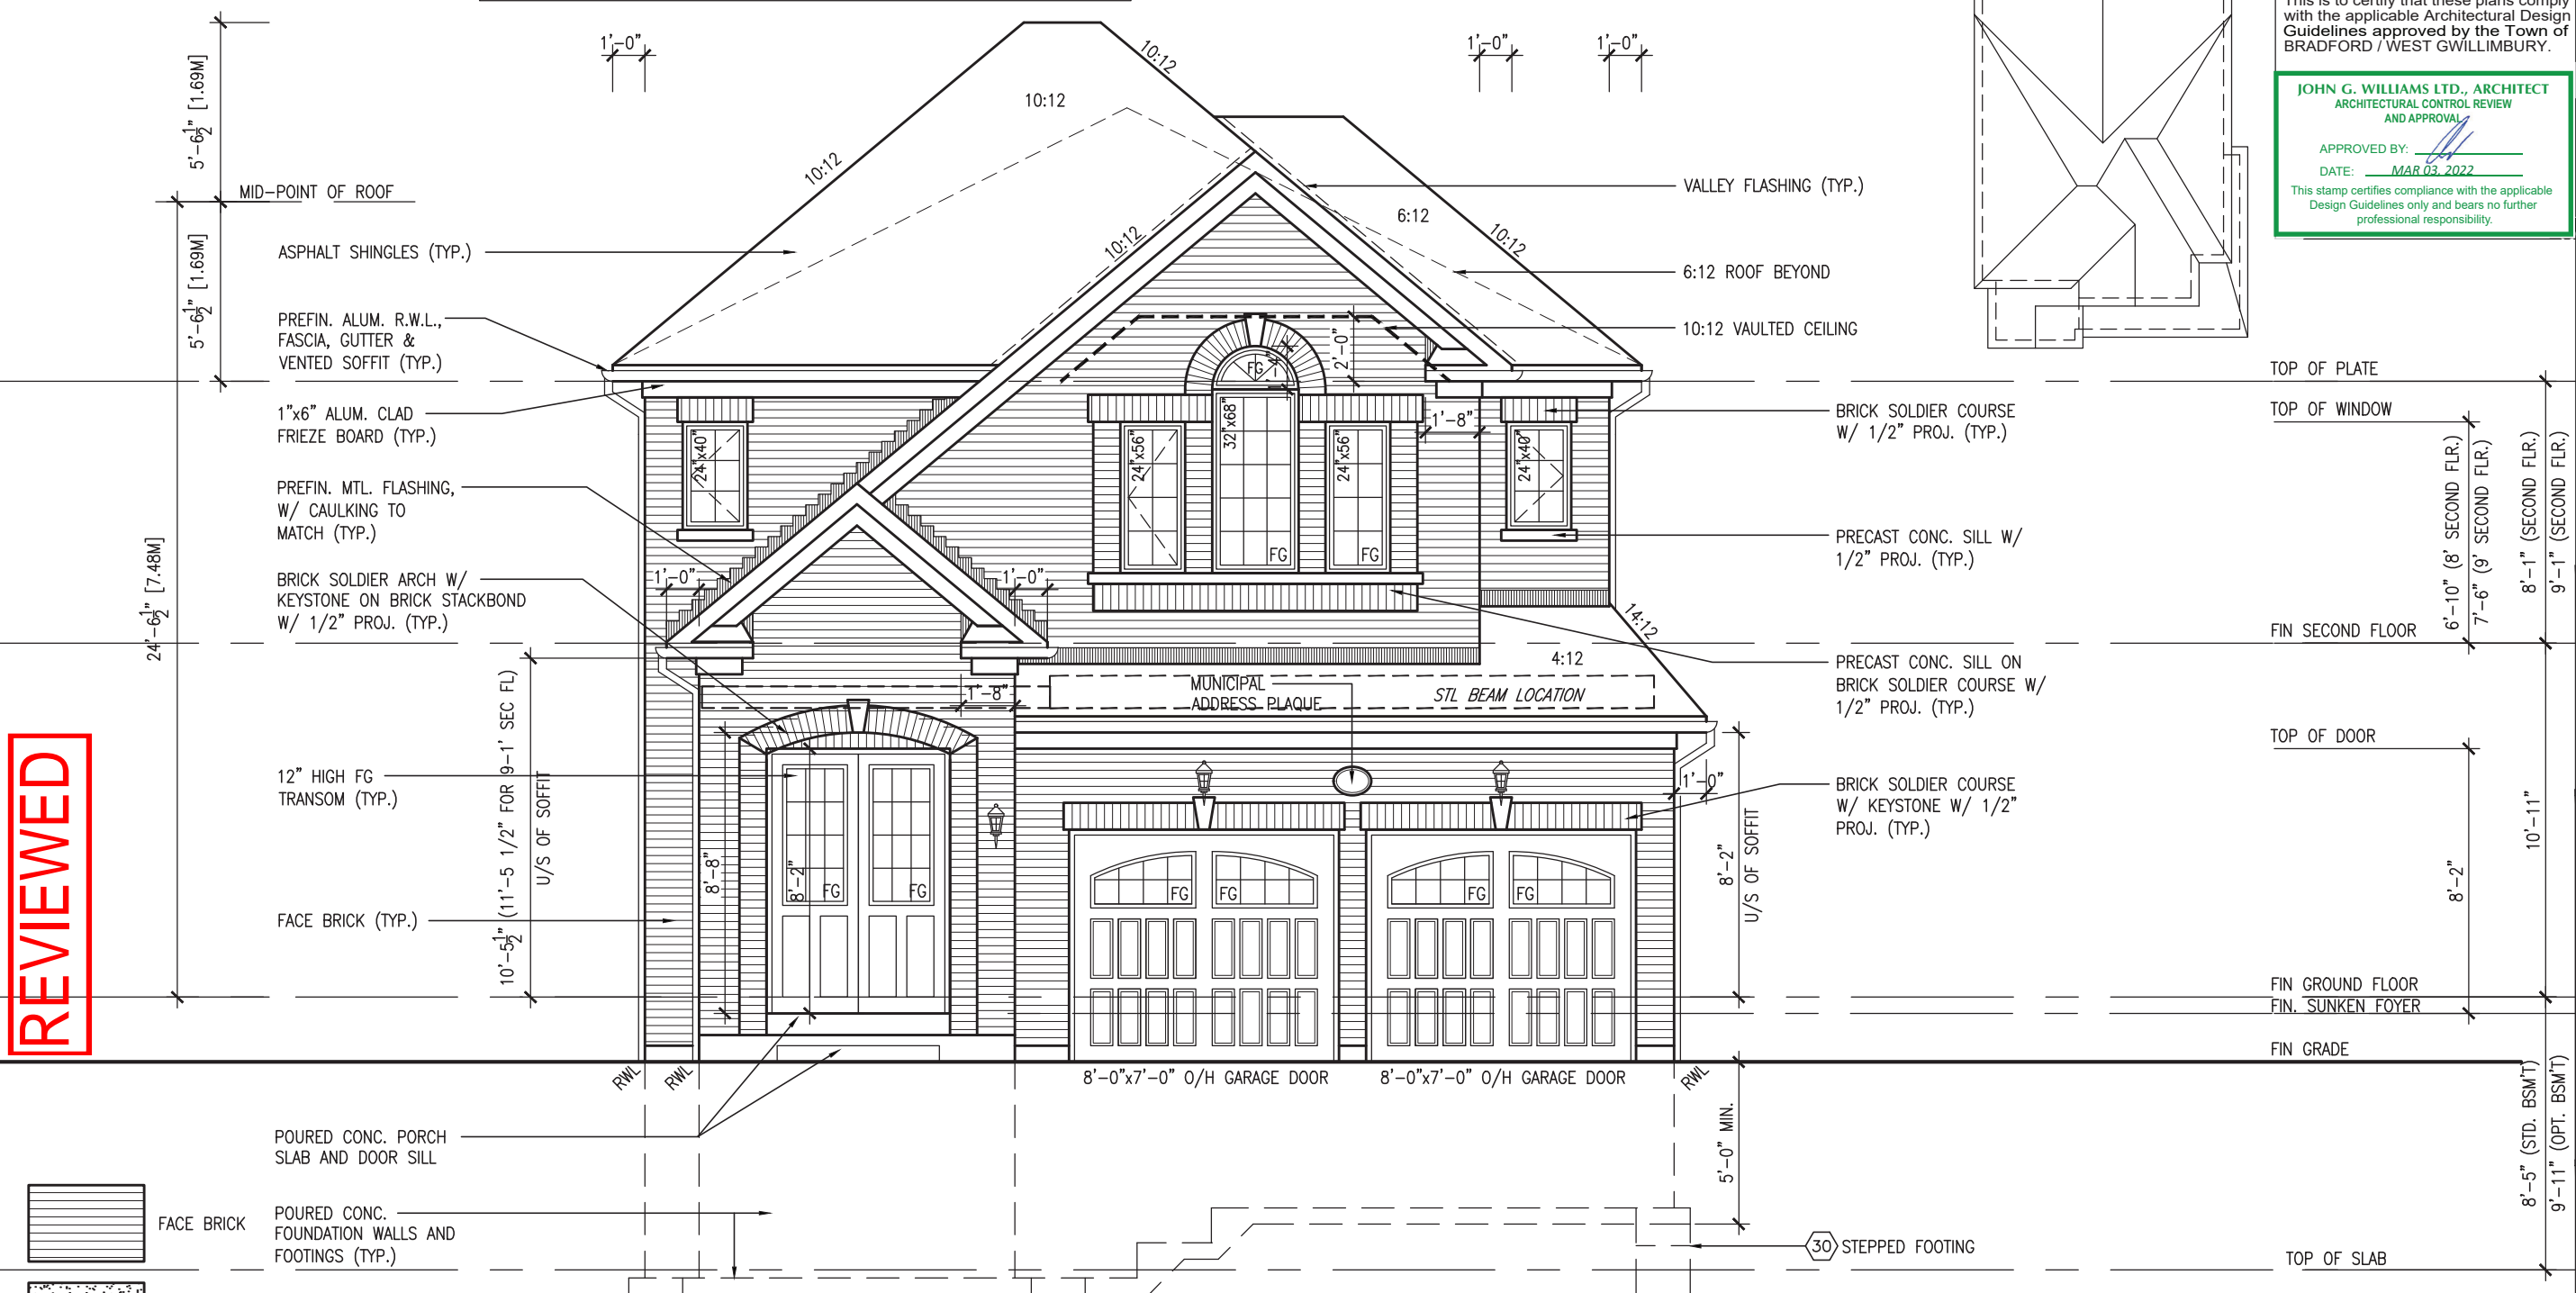
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JOHN G. WILLIAMS LTD., ARCHITECT
ARCHITECTURAL CONTROL REVIEW
AND APPROVAL

APPROVED BY: 
DATE: MAR 03, 2022

This stamp certifies compliance with the applicable Design Guidelines only and bears no further professional responsibility.

S38-19		BAYVIEW WELLINGTON		BRADFORD	
project no.	16023	project name	GREEN VALLEY EAST	municipality	BRADFORD
drawing no.	31	date	OCTOBER 2021	checked by	JWM
file name	16023-S38-19	scale	3/16" = 1'-0"	drawn by	NS
FRONT ELEVATION 'A'					
9					
8					
7					
6					
5					
4					
3					
2	REVISED AS PER ENG'S COMMENTS	FEB 25-22	RC		
1	ISSUED FOR CLIENT REVIEW	NOV 26-21	VA3		
no.	description	date	by		



- FACE BRICK
- STUCCO FINISH
- RENAISSANCE STONE
- ALUMINUM PANEL



MAR 1, 2022

VA3 DESIGN

255 Consumers Rd. Suite 120
Toronto, ON M2J 1P4
t 416.630.2255 f 416.630.4782
va3design.com


The undersigned has reviewed and takes responsibility for this design and has the qualifications and meets the requirements set out in the Ontario Building Code to be a Designer.

Wellington Jno-Baptiste 25591 BCN
signature
VA3 Design Inc. 42658
name
registration information

Contractor must verify all dimensions on the job and report any discrepancy to the Designer before proceeding with the work. All drawings and specifications are instruments of service and the property of the Designer which must be returned at the completion of the work. Drawings are not to be scaled.

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10⁹ GROUND

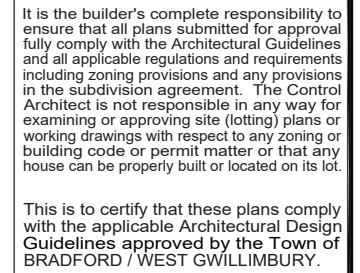

JOHN G. WILLIAMS LTD., ARCHITECT
ARCHITECTURAL CONTROL REVIEW
AND APPROVAL

APPROVED BY: 

DATE: MAR 03, 2022

This stamp certifies compliance with the applicable Design Guidelines only and bears no further professional responsibility.

S38-19

BAYVIEW WELLINGTON

project name
GREEN

signature	25591	BCIN	40659
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name
registration information

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[illegible]

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REVIEWED

REFER TO FRONT ELEVATION FOR
TYPICAL NOTES.

BRICK VENEER CONSTRUCTION

(FOR WALLS LESS THAN 1.2M (3'-11") FROM THE LOT LINE)

45 MINUTE FIRE RATED WALL

PROVIDE A CONTINUOUS LAYER OF 12.7mm (1/2") TYPE 'X' GYPSUM BOARD (INTERIOR SIDE) INSTALLED SO THAT ALL EDGES ARE SUPPORTED, TAPED AND FILLED. SPACE BETWEEN WOOD STUDS TO BE FILLED WITH INSULATION CONFORMING TO CAN/ULC-S702, "MINERAL FIBRE THERMAL INSULATION FOR BUILDINGS" WITH A MASS OF NOT LESS THAN 1.22 Kg/SQ.M. AND MUST FILL AT LEAST 90% OF THE CAVITY THICKNESS. THE TYPE 'X' & INSULATION MUST BE RUN CONTINUOUSLY BEHIND ALL INTERSECTING PARTITIONS, MECHANICAL CHASES, BATHTUBS, SHOWERS, ETC. ENSURE INSULATION & TYPE 'X' IS INSTALLED IN GARAGE EXTERIOR WALLS.

(REFER TO SECTION SB-2 OF OBC 2012-SUPPLEMENTARY STANDARDS)

PROVIDE A CONTINUOUS LAYER OF 12.7mm (1/2") TYPE 'X' GYPSUM BOARD (INTERIOR SIDE)
INSTALLED SO THAT ALL EDGES ARE SUPPORTED, TAPED AND FILLED. SPACE BETWEEN WOOD STUDS TO
BE FILLED WITH INSULATION CONFORMING TO CAN/ULC-S702, "MINERAL FIBRE THERMAL INSULATION
FOR BUILDINGS" WITH A MASS OF NOT LESS THAN 1.22 Kg/SQ.M. AND MUST FILL AT LEAST 90% OF
THE CAVITY THICKNESS. THE TYPE 'X' & INSULATION MUST BE RUN CONTINUOUSLY BEHIND ALL
INTERSECTING PARTITIONS, MECHANICAL CHASES, BATHTUBS, SHOWERS, ETC. ENSURE INSULATION &
TYPE 'X' IS INSTALLED IN GARAGE EXTERIOR WALLS.
(REFER TO SECTION SB-2 OF OBC 2012-SUPPLEMENTARY STANDARDS)

10⁹ GROUND

It is the builder's complete responsibility to ensure that all plans submitted for approval fully comply with the Architectural Guidelines and all applicable regulations and requirements including zoning provisions and any provisions in the subdivision agreement. The Control Architect is not responsible in any way for examining or approving site (lotting) plans or working drawings with respect to any zoning or building code or permit matter or that any house can be properly built or located on its lot.

This is to certify that these plans comply with the applicable Architectural Design Guidelines approved by the Town of BRADFORD / WEST GWILLIMBURY.

JOHN G. WILLIAMS LTD., ARCHITECT
ARCHITECTURAL CONTROL REVIEW
AND APPROVAL

APPROVED BY: 

DATE: MAR 03, 2022

This stamp certifies compliance with the applicable
Design Guidelines only and bears no further
professional responsibility.

TOP OF PLATE

TOP OF WINDOW

S38-19

BAYVIEW WELLINGTON

•

project no. 16023

ELEVATION 'A'	file name	77
	drawing no.	

16023-S38-19
Mar 1 2022 - 9:33 AM
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prohibited without VAO Design's written permission.

A3

DESIGN
255 Consumers Rd Suite 120
Toronto, ON M2J 1R4

416.630.2255 f 416.630.4782

vadesign.com

is specifications, related documents and design

The undersigned has reviewed and takes responsibility for this design and has the qualifications and meets the requirements set out in the

and has the qualifications and resources and requirements set out in the Ontario Building Code to be a Designer.

Wellington Jno-Baptiste *W. Baptiste* 25591

name	registration information	signature	BCIN
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VA3 Design Inc. 42658

Contractor must verify all dimensions on the job and report any discrepancy to the Designer before proceeding with the work. All

drawings and specifications are instruments of service and the property of the Designer which must be returned at the completion of the work.

Drawings are not to be scaled.

will grow:

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REVISED AS PER ENG'S COMMENTS	FEB 25-22	RC
2		

ISSUED FOR CLIENT REVIEW	NOV 26-21	VA3
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no.	description	date	by
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REVIEWED

RIGHT SIDE ELEVATION 'A'

HEADER/RIM JOIST LEVEL
(FOR WALLS LESS THAN 1.2M (3'-11") FROM THE LOT LINE) 45 MINUTE FIRE RATING @ HEADER
PROVIDE 15.9mm (5/8") TYPE 'X' GYPSUM BOARD BETWEEN FLOOR JOIST AT THE HEADER OR CONTINUOUSLY ALONG THE RIM JOIST WHEN FLOOR JOISTS ARE PARALLEL TO RIM JOIST TO MAINTAIN 45 MINUTE FIRE RATING.

WALL AREA	1205.31 SQ. FT.
WALL AREA	1267.14 SQ. FT. (9' SEC. FL)
LIMITING DISTANCE	1.2 M (7%)
OPENING ALLOWED	84.37 SQ. FT.
OPENING ALLOWED	88.69 SQ. FT. (9' SEC. FLR.)
OPENING PROVIDED	71.07 SQ. FT. (GLASS AREA ONLY)



MAR 1, 2022

TOP OF PLATE

TOP OF WINDOW

4'-0" FRIEZE BD.
RETURN FOR
UPGRADE ONLY

FIN SECOND FLOOR

TOP OF TRANSOM

TOP OF WINDOW

FIN GROUND FLOOR

FIN GRADE

6'-10" (8' SECOND FLR.)
7'-6" (9' SECOND FLR.)

8'-1" (SECOND FLR.)
9'-1" (SECOND FLR.)

1'-6"

7'-4"

10'-11"

JOHN G. WILLIAMS LTD., ARCHITECT
ARCHITECTURAL CONTROL REVIEW
AND APPROVAL

APPROVED BY: 

DATE: MAR 03, 2022

This stamp certifies compliance with the applicable
Design Guidelines only and bears no further
professional responsibility.

[illegible]

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10

ALUMINUM PANEL

0-POINT OF ROOF

8'-0"x7'-0" O/H GARAGE DOOR

TOP OF SLAB

MAR 1, 2022

REVIEWED

This figure contains architectural drawings for a building's right side elevation, labeled "RIGHT SIDE ELEVATION 'B'". It includes detailed dimensions for roof pitches (e.g., 10:12, 6:12), window sizes (e.g., 48"x48", 24"x48"), and floor levels relative to ground and grade. A large red stamp reading "REVIEWED" is positioned vertically along the left edge.

The drawing also features several informational tables:

BRICK VENEER CONSTRUCTION (FOR WALLS LESS THAN 1.2M (3'-11") FROM THE LOT LINE)	
45 MINUTE FIRE RATED WALL	
PROVIDE A CONTINUOUS LAYER OF 12.7mm (1/2") TYPE 'X' GYPSUM BOARD (INTERIOR SIDE) INSTALLED SO THAT ALL EDGES ARE SUPPORTED, TAPED AND FILLED. SPACE BETWEEN WOOD STUDS TO BE FILLED WITH INSULATION CONFORMING TO CAN/ULC-S702, "MINERAL FIBRE THERMAL INSULATION FOR BUILDINGS" WITH A MASS OF NOT LESS THAN 1.22 Kg/SQ.M. AND MUST FILL AT LEAST 90% OF THE CAVITY THICKNESS. THE TYPE 'X' & INSULATION MUST BE RUN CONTINUOUSLY BEHIND ALL INTERSECTING PARTITIONS, MECHANICAL CHASES, BATHTUBS, SHOWERS, ETC. ENSURE INSULATION & TYPE 'X' IS INSTALLED IN GARAGE EXTERIOR WALLS. (REFER TO SECTION SB-2 OF OBC 2012-SUPPLEMENTARY STANDARDS)	

HEADER/RIM JOIST LEVEL (FOR WALLS LESS THAN 1.2M (3'-11") FROM THE LOT LINE) 45 MINUTE FIRE RATING @ HEADER	
PROVIDE 15.9mm (5/8") TYPE 'X' GYPSUM BOARD BETWEEN FLOOR JOIST AT THE HEADER OR CONTINUOUSLY ALONG THE RIM JOIST WHEN FLOOR JOISTS ARE PARALLEL TO RIM JOIST TO MAINTAIN 45 MINUTE FIRE RATING.	

WALL AREA	
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WALL AREA	1267.14 SQ. FT. (9' SEC. FL.)
LIMITING DISTANCE	1.2 M (7%)
OPENING ALLOWED	84.37 SQ. FT.
OPENING ALLOWED	88.69 SQ. FT. (9' SEC. FLR.)
OPENING PROVIDED	71.07 SQ. FT. (GLASS AREA ONLY)

A professional engineer's seal is visible at the bottom center, identifying S.J. BOYD as a Licensed Professional Engineer in Ontario, dated MAR 1, 2022.

REVIEWED

RIGHT SIDE ELEVATION 'B'

BRICK VENEER CONSTRUCTION
(FOR WALLS LESS THAN 1.2M (3'-11") FROM THE LOT LINE)
45 MINUTE FIRE RATED WALL
PROVIDE A CONTINUOUS LAYER OF 12.7mm (1/2") TYPE 'X' GYPSUM BOARD (INTERIOR SIDE) INSTALLED SO THAT ALL EDGES ARE SUPPORTED, TAPED AND FILLED. SPACE BETWEEN WOOD STUDS TO BE FILLED WITH INSULATION CONFORMING TO CAN/ULC-S702, "MINERAL FIBRE THERMAL INSULATION FOR BUILDINGS" WITH A MASS OF NOT LESS THAN 1.22 Kg/SQ.M. AND MUST FILL AT LEAST 90% OF THE CAVITY THICKNESS. THE TYPE 'X' & INSULATION MUST BE RUN CONTINUOUSLY BEHIND ALL INTERSECTING PARTITIONS, MECHANICAL CHASES, BATHTUBS, SHOWERS, ETC. ENSURE INSULATION & TYPE 'X' IS INSTALLED IN GARAGE EXTERIOR WALLS.
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OPENING PROVIDED	71.07 SQ. FT. (GLASS AREA ONLY)

TABLE:

no.	description	date	by
1	ISSUED FOR CLIENT REVIEW	NOW 26-21	VA3
2	REVISED AS PER ENG'S COMMENTS	FEB 25-22	RC

QUALIFICATION INFORMATION:

name	registration information	signature
Wellington Jno-Baptiste	25591 B.C.N.	[Signature]
VAS Design Inc.	42658	[Signature]

DESIGNER: VAS DESIGN
255 Consumers Rd, Suite 120
Toronto, ON M2J 1R4
t 416.630.2255 f 416.630.4782
vasdesign.com

PROJECT NO.: 16023
MUNICIPALITY: BRADFORD
DRAWN BY: JMW
CHECKED BY: NS
DATE: OCTOBER 2021
SCALE: 3/16" = 1'-0"

THIS IS TO CERTIFY THAT THESE PLANS COMPLY WITH THE APPLICABLE ARCHITECTURAL DESIGN GUIDELINES APPROVED BY THE TOWN OF BRADFORD / WEST GWILLIMBURY.

JOHN G. WILLIAMS LTD., ARCHITECT
ARCHITECTURAL CONTROL REVIEW AND APPROVAL
APPROVED BY: [Signature]
DATE: MAR 03, 2022
This stamp certifies compliance with the applicable Design Guidelines only and bears no further professional responsibility.

S38-19
BAYVIEW WELLINGTON
GREEN VALLEY EAST
RIGHT SIDE ELEVATION 'B'

REVIEWED

The drawing shows the right side elevation of a two-story building. The roof has multiple pitches: 10:12, 6:12, and 10:12. Key features include asphalt shingles, valley flashing, prefinished metal flashing, and a stepped footing. Windows are shown on both floors with various sizes and configurations. Construction details like brick veneer, soldier courses, and precast concrete sills are noted. A table at the bottom provides area calculations for walls and openings.

WALL AREA	1205.31 SQ. FT.
WALL AREA	1267.14 SQ. FT. (9' SEC. FL.)
LIMITING DISTANCE	1.2 M (7%)
OPENING ALLOWED	84.37 SQ. FT.
OPENING ALLOWED	88.69 SQ. FT. (9' SEC. FLR.)
OPENING PROVIDED	71.07 SQ. FT. (GLASS AREA ONLY)

REFER TO FRONT ELEVATION FOR
TYPICAL NOTES.

BRICK VENEER CONSTRUCTION
(FOR WALLS LESS THAN 1.2M (3'-11") FROM THE LOT LINE)
45 MINUTE FIRE RATED WALL
PROVIDE A CONTINUOUS LAYER OF 12.7mm (1/2") TYPE 'X' GYPSUM BOARD (INTERIOR SIDE) INSTALLED SO THAT ALL EDGES ARE SUPPORTED, TAPED AND FILLED. SPACE BETWEEN WOOD STUDS TO BE FILLED WITH INSULATION CONFORMING TO CAN/ULC-S702, "MINERAL FIBRE THERMAL INSULATION FOR BUILDINGS" WITH A MASS OF NOT LESS THAN 1.22 Kg/SQ.M. AND MUST FILL AT LEAST 90% OF THE CAVITY THICKNESS. THE TYPE 'X' & INSULATION MUST BE RUN CONTINUOUSLY BEHIND ALL INTERSECTING PARTITIONS, MECHANICAL CHASES, BATHTUBS, SHOWERS, ETC. ENSURE INSULATION & TYPE 'X' IS INSTALLED IN GARAGE EXTERIOR WALLS.
(REFER TO SECTION SB-2 OF OBC 2012-SUPPLEMENTARY STANDARDS)

10' GROUND

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JOHN G. WILLIAMS LTD., ARCHITECT
ARCHITECTURAL CONTROL REVIEW
AND APPROVAL
APPROVED BY: [Signature]
DATE: MAR 03, 2022
This stamp certifies compliance with the applicable Design Guidelines only and bears no further professional responsibility.

project no.		16023
municipality		BRADFORD
project name		BAYVIEW WELLINGTON
date		OCTOBER 2021
drawn by		JWM
checked by		JWM
scale		3/16" = 1'-0"
file name		16023-S38-19
drawing no.		37

VAS DESIGN
255 Consumers Rd Suite 120
Toronto ON M2J 1R4
t 416.630.2255 f 416.630.4782
vasdesign.com

The undersigned has reviewed and takes responsibility for this design and has the qualifications and meets the requirements set out in the Ontario Building Code to be a Designer.
qualification information
Wellington Jno-Baptiste
name
VAS Design Inc.
registration number
25591
BCN
42658
Contractor must verify all dimensions on the job and report any discrepancy to the Designer before proceeding with the work. All drawings and specifications are instruments of service and the property of the Designer which must be returned at the completion of the work. Drawings are not to be scaled.

no.	description	date	by
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2	REVISED AS PER ENG'S COMMENTS	FEB 25-22 RC	
1	ISSUED FOR CLIENT REVIEW	NOV 26-21 VAS	

MAR 1, 2022

[illegible][illegible][illegible]

REVIEWED

The drawing shows the right side elevation of a two-story building. The roof has a main pitch of 6:12 and a dormer section with a 10:12 pitch. The main roofline is 24'-0" wide. The building features several windows: four double-hung windows on the second floor (each 48"x48") and three larger windows on the ground floor (two 48"x60" and one 24"x48"). A brick soldier course runs horizontally across the middle of the elevation. The foundation includes a precast concrete sill and a stepped footing. Various construction details are noted, such as asphalt shingles, valley flashing, and insulation requirements for walls less than 1.2M from the lot line.

BRICK VENEER CONSTRUCTION
(FOR WALLS LESS THAN 1.2M (3'-11") FROM THE LOT LINE)
45 MINUTE FIRE RATED WALL
PROVIDE A CONTINUOUS LAYER OF 12.7mm (1/2") TYPE 'X' GYPSUM BOARD (INTERIOR SIDE) INSTALLED SO THAT ALL EDGES ARE SUPPORTED, TAPED AND FILLED. SPACE BETWEEN WOOD STUDS TO BE FILLED WITH INSULATION CONFORMING TO CAN/ULC-S702, "MINERAL FIBRE THERMAL INSULATION FOR BUILDINGS" WITH A MASS OF NOT LESS THAN 1.22 Kg/SQ.M. AND MUST FILL AT LEAST 90% OF THE CAVITY THICKNESS. THE TYPE 'X' & INSULATION MUST BE RUN CONTINUOUSLY BEHIND ALL INTERSECTING PARTITIONS, MECHANICAL CHASES, BATHTUBS, SHOWERS, ETC. ENSURE INSULATION & TYPE 'X' IS INSTALLED IN GARAGE EXTERIOR WALLS.
(REFER TO SECTION SB-2 OF OBC 2012-SUPPLEMENTARY STANDARDS)

HEADER/RIM JOIST LEVEL
(FOR WALLS LESS THAN 1.2M (3'-11") FROM THE LOT LINE) 45 MINUTE FIRE RATING @ HEADER
PROVIDE 15.9mm (5/8") TYPE 'X' GYPSUM BOARD BETWEEN FLOOR JOIST AT THE HEADER OR CONTINUOUSLY ALONG THE RIM JOIST WHEN FLOOR JOISTS ARE PARALLEL TO RIM JOIST TO MAINTAIN 45 MINUTE FIRE RATING.

RIGHT SIDE ELEVATION 'B'

WALL AREA
WALL AREA 1205.31 SQ. FT.
LIMITING DISTANCE 1.2 M (7%)
OPENING ALLOWED 84.37 SQ. FT.
OPENING ALLOWED 88.69 SQ. FT. (9' SEC. FLR.)
OPENING PROVIDED 71.07 SQ. FT. (GLASS AREA ONLY)

FINISHED GRADE
FIN SECOND FLOOR
TOP OF WINDOW
TOP OF TRANSOM
FIN GROUND FLOOR
FIN GRADE
TOP OF SLAB

CONSTRUCTION DETAILS:
ASPHALT SHINGLES (TYP.)
VALLEY FLASHING (TYP.)
TOP OF PLATE & U/S OF SOFFIT
PREFIN. MTL. FLASHING, W/ CAULKING TO MATCH (TYP.)
STL BEAM LOCATION
RWL
FACE BRICK (TYP.)
BRICK SOLDIER COURSE W/ 1/2" PROJ. (TYP.)
PRECAST CONC. SILL W/ 1/2" PROJ. (TYP.)

ROOF LINE FOR UPGRADE ONLY

10' GROUND

JOHN G. WILLIAMS LTD., ARCHITECT
ARCHITECTURAL CONTROL REVIEW AND APPROVAL
APPROVED BY: [Signature]
DATE: MAR 03, 2022
This stamp certifies compliance with the applicable Design Guidelines only and bears no further professional responsibility.

BAYVIEW WELLINGTON
GREEN VALLEY EAST
OCTOBER 2021
JMW
NS

VAS DESIGN
255 Consumers Rd Suite 120
Toronto ON M2J 1R4
t 416.630.2255 f 416.630.4782
vasdesign.com

S.J. BOYD
90214198
MAR 1, 2022

REVISIONS:
no. description date by
1 ISSUED FOR CLIENT REVIEW NOV 26-21 VAS
2 REVISED AS PER ENG'S COMMENTS FEB 25-22 RC

PROJECT INFORMATION:
project no. 16023
municipality BRADFORD
file name 16023-S38-19
drawing no. 37
scale 3/16" = 1'-0"
checked by JMW
drawn by NS
date OCTOBER 2021
project name BAYVIEW WELLINGTON
location GREEN VALLEY EAST
sheet title RIGHT SIDE ELEVATION 'B'
sheet number 37
project manager JOHN G. WILLIAMS LTD., ARCHITECT
architectural control review AND APPROVAL
approved by [Signature]
date MAR 03, 2022
this stamp certifies compliance with the applicable design guidelines only and bears no further professional responsibility.

REVIEWED

REFER TO FRONT ELEVATION FOR
TYPICAL NOTES.

BRICK VENEER CONSTRUCTION
(FOR WALLS LESS THAN 1.2M (3'-11") FROM THE LOT LINE)
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JOHN G. WILLIAMS LTD., ARCHITECT
ARCHITECTURAL CONTROL REVIEW
AND APPROVAL

APPROVED BY: [Signature]
DATE: MAR 03, 2022

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project name		BAYVIEW WELLINGTON	municipality	BRADFORD	project no.	S38-19
GREEN VALLEY EAST		RIGHT SIDE ELEVATION 'B'	scale		file name	16023-S38-19
date		OCTOBER 2021	checked by		drawn by	JMW
NS		RICHARD - H:\ARCHIVE WORKING\2016\16023.BW\Units\38\16023-S38-19.dwg	drawing no.		Tue - Mar 1 2022 - 9:33 AM	37

The undersigned has reviewed and takes responsibility for this design and has the qualifications and meets the requirements set out in the Ontario Building Code to be a Designer.		signature	25591 BCN	42658
Wellington Jno-Baptiste		VAS Design Inc.	Contractor must verify all dimensions on the job and report any discrepancy to the Designer before proceeding with the work. All drawings and specifications are instruments of service and the property of the Designer which must be returned at the completion of the work. Drawings are not to be scaled.	
FEB 25-22 RC		NOV 26-21 VA3	description	
REVISED AS PER ENG'S COMMENTS				
ISSUED FOR CLIENT REVIEW				

REVIEWED

RIGHT SIDE ELEVATION 'B'

HEADER/RIM JOIST LEVEL

(FOR WALLS LESS THAN 1.2M (3'-11") FROM THE LOT LINE) 45 MINUTE FIRE RATING @ HEADER
PROVIDE 15.9mm (5/8") TYPE 'X' GYPSUM BOARD BETWEEN FLOOR JOIST AT THE HEADER OR CONTINUOUSLY ALONG THE RIM JOIST WHEN FLOOR JOISTS ARE PARALLEL TO RIM JOIST TO MAINTAIN 45 MINUTE FIRE RATING.

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WALL AREA	1267.14 SQ. FT. (9' SEC. FL.)
LIMITING DISTANCE	1.2 M (7%)
OPENING ALLOWED	84.37 SQ. FT.
OPENING ALLOWED	88.69 SQ. FT. (9' SEC. FLR.)
OPENING PROVIDED	71.07 SQ. FT. (GLASS AREA ONLY)

BRICK VENEER CONSTRUCTION

(FOR WALLS LESS THAN 1.2M (3'-11") FROM THE LOT LINE)

45 MINUTE FIRE RATED WALL

PROVIDE A CONTINUOUS LAYER OF 12.7mm (1/2") TYPE 'X' GYPSUM BOARD (INTERIOR SIDE) INSTALLED SO THAT ALL EDGES ARE SUPPORTED, TAPED AND FILLED. SPACE BETWEEN WOOD STUDS TO BE FILLED WITH INSULATION CONFORMING TO CAN/ULC-S702, "MINERAL FIBRE THERMAL INSULATION FOR BUILDINGS" WITH A MASS OF NOT LESS THAN 1.22 Kg/SQ.M. AND MUST FILL AT LEAST 90% OF THE CAVITY THICKNESS. THE TYPE 'X' & INSULATION MUST BE RUN CONTINUOUSLY BEHIND ALL INTERSECTING PARTITIONS, MECHANICAL CHASES, BATHTUBS, SHOWERS, ETC. ENSURE INSULATION & TYPE 'X' IS INSTALLED IN GARAGE EXTERIOR WALLS.
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JOHN G. WILLIAMS LTD., ARCHITECT
ARCHITECTURAL CONTROL REVIEW
AND APPROVAL

APPROVED BY:

DATE: MAR 03, 2022

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project name		municipality		project no.	
GREEN VALLEY EAST		BRADFORD		16023	
date		checked by		file name	
OCTOBER 2021		JMW		16023-S38-19	
drawn by		scale		drawing no.	
NS		3/16" = 1'-0"		37	
title		description			
RIGHT SIDE ELEVATION 'B'					
no.		description			
1		ISSUED FOR CLIENT REVIEW			
2		REVISED AS PER ENG'S COMMENTS			
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qualification information

name	Wellington Jno-Baptiste	signature	25591
registration number	VAS Design Inc.	BCN	42658

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DESIGN

255 Consumers Rd Suite 120
Toronto ON M2J 1R4
t 416.630.2255 f 416.630.4782
vo3design.com

VA3

LICENCED PROFESSIONAL ENGINEER
S.J. BOYD
90214198
PROVINCE OF ONTARIO

MAR 1, 2022

REVIEWED

REFER TO FRONT ELEVATION FOR
TYPICAL NOTES.

BRICK VENEER CONSTRUCTION

(FOR WALLS LESS THAN 1.2M (3'-11") FROM THE LOT LINE)

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PROVIDE A CONTINUOUS LAYER OF 12.7mm (1/2") TYPE 'X' GYPSUM BOARD (INTERIOR SIDE) INSTALLED SO THAT ALL EDGES ARE SUPPORTED, TAPED AND FILLED. SPACE BETWEEN WOOD STUDS TO BE FILLED WITH INSULATION CONFORMING TO CAN/ULC-S702, "MINERAL FIBRE THERMAL INSULATION FOR BUILDINGS" WITH A MASS OF NOT LESS THAN 1.22 Kg/SQ.M. AND MUST FILL AT LEAST 90% OF THE CAVITY THICKNESS. THE TYPE 'X' & INSULATION MUST BE RUN CONTINUOUSLY BEHIND ALL INTERSECTING PARTITIONS, MECHANICAL CHASES, BATHTUBS, SHOWERS, ETC. ENSURE INSULATION & TYPE 'X' IS INSTALLED IN GARAGE EXTERIOR WALLS.
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AND APPROVAL

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BAYVIEW WELLINGTON

S38-19

project no.	16023
municipality	BRADFORD
project name	GREEN VALLEY EAST
date	OCTOBER 2021
drawn by	JWM
checked by	JWM
scale	3/16" = 1'-0"
file name	16023-S38-19
drawing no.	37

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qualification information	Wellington Jno-Baptiste	42658	
name	VAS Design Inc.		
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2	REVISED AS PER ENG'S COMMENTS	FEB 25-22 RC	
1	ISSUED FOR CLIENT REVIEW	NOV 26-21 VA3	

MAR 1, 2022

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RIGHT SIDE ELEVATION 'B'

HEADER/RIM JOIST LEVEL

(FOR WALLS LESS THAN 1.2M (3'-11") FROM THE LOT LINE) 45 MINUTE FIRE RATING @ HEADER

PROVIDE 15.9mm (5/8") TYPE 'X' GYPSUM BOARD BETWEEN FLOOR JOIST AT THE HEADER OR CONTINUOUSLY ALONG THE RIM JOIST WHEN FLOOR JOISTS ARE PARALLEL TO RIM JOIST TO MAINTAIN 45 MINUTE FIRE RATING.

REVIEWED

BRICK VENEER CONSTRUCTION
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RIGHT SIDE ELEVATION 'B'

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S.J. BOYD
LICENSED PROFESSIONAL ENGINEER
90214198
PROVINCE OF ONTARIO
MAR 1, 2022

JOHN G. WILLIAMS LTD., ARCHITECT
ARCHITECTURAL CONTROL REVIEW AND APPROVAL
APPROVED BY: [Signature]
DATE: MAR 03, 2022
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BAYVIEW WELLINGTON
GREEN VALLEY EAST
OCTOBER 2021
NS

S38-19
RIGHT SIDE ELEVATION 'B'
scale 3/16" = 1'-0"
checked by JMW
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project no. 16023
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[illegible][illegible][illegible]

REVIEWED

RIGHT SIDE ELEVATION 'B'

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project no.		16023	municipality		BRADFORD	project name		S38-19
drawing no.		37	file name		16023-S38-19	checked by		JMW
scale		3/16" = 1'-0"	date		OCTOBER 2021	drawn by		NS
right side elevation 'B'			checked by		JMW	date		MAR 03, 2022
no.		description	revision		date	by		
1	ISSUED FOR CLIENT REVIEW	NOW 26-21 VA3						
2	REVISED AS PER ENG'S COMMENTS	FEB 25-22 RC						
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qualification information

Wellington Jno-Baptiste

name

registration number

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BCN

42658

signature

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no. description | date | by || 1 | ISSUED FOR CLIENT REVIEW | NOW 26-21 VA3 | | |
2	REVISED AS PER ENG'S COMMENTS	FEB 25-22 RC		
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MAR 1, 2022

REVIEWED

RIGHT SIDE ELEVATION 'B'

HEADER/RIM JOIST LEVEL

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BRICK VENEER CONSTRUCTION

(FOR WALLS LESS THAN 1.2M (3'-11") FROM THE LOT LINE)

45 MINUTE FIRE RATED WALL

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qualification information	Wellington Jno-Baptiste			
name	VAS Design Inc.			
registration information				
Contractor must verify all dimensions on the job and report any discrepancy to the Designer before proceeding with the work. All drawings and specifications are instruments of service and the property of the Designer which must be returned at the completion of the work. Drawings are not to be scaled.				

no.	description	date	by
9			
8			
7			
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2	REVISED AS PER ENG'S COMMENTS	FEB 25-22 RC	
1	ISSUED FOR CLIENT REVIEW	NOV 26-21 VA3	

MAR 1, 2022

[illegible]

REVIEWED

RIGHT SIDE ELEVATION 'B'

HEADER/RIM JOIST LEVEL

(FOR WALLS LESS THAN 1.2M (3'-11") FROM THE LOT LINE) 45 MINUTE FIRE RATING @ HEADER
PROVIDE 15.9mm (5/8") TYPE 'X' GYPSUM BOARD BETWEEN FLOOR JOIST AT THE HEADER OR CONTINUOUSLY ALONG THE RIM JOIST WHEN FLOOR JOISTS ARE PARALLEL TO RIM JOIST TO MAINTAIN 45 MINUTE FIRE RATING.

WALL AREA	1205.31 SQ. FT.
WALL AREA	1267.14 SQ. FT. (9' SEC. FL.)
LIMITING DISTANCE	1.2 M (7%)
OPENING ALLOWED	84.37 SQ. FT.
OPENING ALLOWED	88.69 SQ. FT. (9' SEC. FLR.)
OPENING PROVIDED	71.07 SQ. FT. (GLASS AREA ONLY)

BRICK VENEER CONSTRUCTION

(FOR WALLS LESS THAN 1.2M (3'-11") FROM THE LOT LINE)

45 MINUTE FIRE RATED WALL

PROVIDE A CONTINUOUS LAYER OF 12.7mm (1/2") TYPE 'X' GYPSUM BOARD (INTERIOR SIDE) INSTALLED SO THAT ALL EDGES ARE SUPPORTED, TAPED AND FILLED. SPACE BETWEEN WOOD STUDS TO BE FILLED WITH INSULATION CONFORMING TO CAN/ULC-S702, "MINERAL FIBRE THERMAL INSULATION FOR BUILDINGS" WITH A MASS OF NOT LESS THAN 1.22 Kg/SQ.M. AND MUST FILL AT LEAST 90% OF THE CAVITY THICKNESS. THE TYPE 'X' & INSULATION MUST BE RUN CONTINUOUSLY BEHIND ALL INTERSECTING PARTITIONS, MECHANICAL CHASES, BATHTUBS, SHOWERS, ETC. ENSURE INSULATION & TYPE 'X' IS INSTALLED IN GARAGE EXTERIOR WALLS.
(REFER TO SECTION SB-2 OF OBC 2012-SUPPLEMENTARY STANDARDS)

10' GROUND

It is the builder's complete responsibility to ensure that all plans submitted for approval fully comply with the Architectural Guidelines and all applicable regulations and requirements including zoning provisions and any provisions in the subdivision agreement. The Control Architect is not responsible in any way for examining or approving site (lotting) plans or working drawings with respect to any zoning or building code or permit matter or that any house can be properly built or located on its lot.

This is to certify that these plans comply with the applicable Architectural Design Guidelines approved by the Town of BRADFORD / WEST GWILLIMBURY.

JOHN G. WILLIAMS LTD., ARCHITECT
ARCHITECTURAL CONTROL REVIEW
AND APPROVAL

APPROVED BY:

DATE: MAR 03, 2022

This stamp certifies compliance with the applicable Design Guidelines only and bears no further professional responsibility.

project name		municipality		project no.
GREEN VALLEY EAST		BRADFORD		16023
date		checked by		drawing no.
OCTOBER 2021	JWM	RIGHT SIDE ELEVATION 'B'		37
drawn by		scale		file name
NS	3/16" = 1'-0"			16023-S38-19
RICHARD - H:\ARCHIVE WORKING\2016\16023.BW\Units\38\16023-S38-19.dwg Tue Mar 1 2022 9:33 AM				

signature		name	registration information	qualification information
		S.J. BOYD	BCIN 42658	Wellington Jno-Baptiste
The undersigned has reviewed and takes responsibility for this design and has the qualifications and meets the requirements set out in the Ontario Building Code to be a Designer.		Contractor must verify all dimensions on the job and report any discrepancy to the Designer before proceeding with the work. All drawings and specifications are instruments of service and the property of the Designer which must be returned at the completion of the work. Drawings are not to be scaled.		
no.	description	date	by	
2	REVISED AS PER ENG'S COMMENTS	FEB 25-22 RC		
1	ISSUED FOR CLIENT REVIEW	NOV 26-21 VA3		

[illegible]

10' GROUND

REFER TO FRONT ELEVATION FOR TYPICAL NOTES.

BRICK VENEER CONSTRUCTION
(FOR WALLS LESS THAN 1.2M (3'-11") FROM THE LOT LINE)
45 MINUTE FIRE RATED WALL
PROVIDE A CONTINUOUS LAYER OF 12.7mm (1/2") TYPE 'X' GYPSUM BOARD (INTERIOR SIDE) INSTALLED SO THAT ALL EDGES ARE SUPPORTED, TAPED AND FILLED. SPACE BETWEEN WOOD STUDS TO BE FILLED WITH INSULATION CONFORMING TO CAN/ULC-S702, "MINERAL FIBRE THERMAL INSULATION FOR BUILDINGS" WITH A MASS OF NOT LESS THAN 1.22 Kg/SQ.M. AND MUST FILL AT LEAST 90% OF THE CAVITY THICKNESS. THE TYPE 'X' & INSULATION MUST BE RUN CONTINUOUSLY BEHIND ALL INTERSECTING PARTITIONS, MECHANICAL CHASES, BATHTUBS, SHOWERS, ETC. ENSURE INSULATION & TYPE 'X' IS INSTALLED IN GARAGE EXTERIOR WALLS.
(REFER TO SECTION SB-2 OF OBC 2012-SUPPLEMENTARY STANDARDS)

ASPHALT SHINGLES (TYP.)
VALLEY FLASHING (TYP.)
TOP OF PLATE & U/S OF SOFFIT
1'-0" 1'-0" 1'-0"
10:12 6:12 6:12 10:12
24'-0"
ROOF LINE FOR UPGRADE ONLY
1'-0"

PREFIN. MTL. FLASHING, W/ CAULKING TO MATCH (TYP.)
1'-8" 1'-0" 8'-8" 10'-10" 7'-8" 4'-0" TYP. 8'-2" U/S OF SOFFIT
STL BEAM LOCATION
RWL 14:12 4:12
FACE BRICK (TYP.)
48"x48" FG 48"x48" FG 48"x48" FG 48"x48" FG
4'-0" TYP. 4'-0" TYP.
8'-1" (SECOND FLR.) 9'-1" (SECOND FLR.) 9'-1" (SECOND FLR.)
6'-10" (8' SECOND FLR.) 7'-6" (9' SECOND FLR.)
FIN SECOND FLOOR
TOP OF TRANSOM 1'-6"
TOP OF WINDOW 7'-4" 10'-11"
FIN GROUND FLOOR
FIN GRADE
8'-5" (STD. BSM/T) 9'-11" (OPT. BSM/T)
TOP OF SLAB

PRECAST CONC. SILL W/ 1/2" PROJ. (TYP.)
BRICK SOLDIER COURSE W/ 1/2" PROJ. (TYP.)
48"x60" FG 48"x60" FG 48"x60" FG
1'-0" 1'-0" 1'-0"

WALL AREA 1205.31 SQ. FT.
WALL AREA 1267.14 SQ. FT. (9' SEC. FL.)
LIMITING DISTANCE 1.2 M (7%)
OPENING ALLOWED 84.37 SQ. FT.
OPENING ALLOWED 88.69 SQ. FT. (9' SEC. FLR.)
OPENING PROVIDED 71.07 SQ. FT. (GLASS AREA ONLY)

30 STEPPED FOOTING

RIGHT SIDE ELEVATION 'B'

HEADER/RIM JOIST LEVEL
(FOR WALLS LESS THAN 1.2M (3'-11") FROM THE LOT LINE) 45 MINUTE FIRE RATING @ HEADER
PROVIDE 15.9mm (5/8") TYPE 'X' GYPSUM BOARD BETWEEN FLOOR JOIST AT THE HEADER OR CONTINUOUSLY ALONG THE RIM JOIST WHEN FLOOR JOISTS ARE PARALLEL TO RIM JOIST TO MAINTAIN 45 MINUTE FIRE RATING.

JOHN G. WILLIAMS LTD., ARCHITECT
ARCHITECTURAL CONTROL REVIEW AND APPROVAL
APPROVED BY: [Signature]
DATE: MAR 03, 2022
This stamp certifies compliance with the applicable Design Guidelines only and bears no further professional responsibility.

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BAYVIEW WELLINGTON
GREEN VALLEY EAST
BRADFORD
RIGHT SIDE ELEVATION 'B'

project no. 16023
municipality
date OCTOBER 2021
checked by JMW
drawn by JMW
scale 3/16" = 1'-0"
file name 16023-S38-19
drawing no. 37

VA3 DESIGN
255 Consumers Rd, Suite 120
Toronto, ON M2J 1R4
t 416.630.2255 f 416.630.4782
vo3design.com

The undersigned has reviewed and takes responsibility for this design and has the qualifications and meets the requirements set out in the Ontario Building Code to be a Designer.
qualification information
Wellington Jno-Baptiste
name
registration information
VA3 Design Inc.
signature
25591 BCN
42658
Contractor must verify all dimensions on the job and report any discrepancy to the Designer before proceeding with the work. All drawings and specifications are instruments of service and the property of the Designer which must be returned at the completion of the work. Drawings are not to be scaled.

2 REVISED AS PER ENG'S COMMENTS
1 ISSUED FOR CLIENT REVIEW
no. description date by

9 .
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1 .

REVIEWED

MAR 1, 2022

REVIEWED

10' GROUND

ROOF PLAN 'C'

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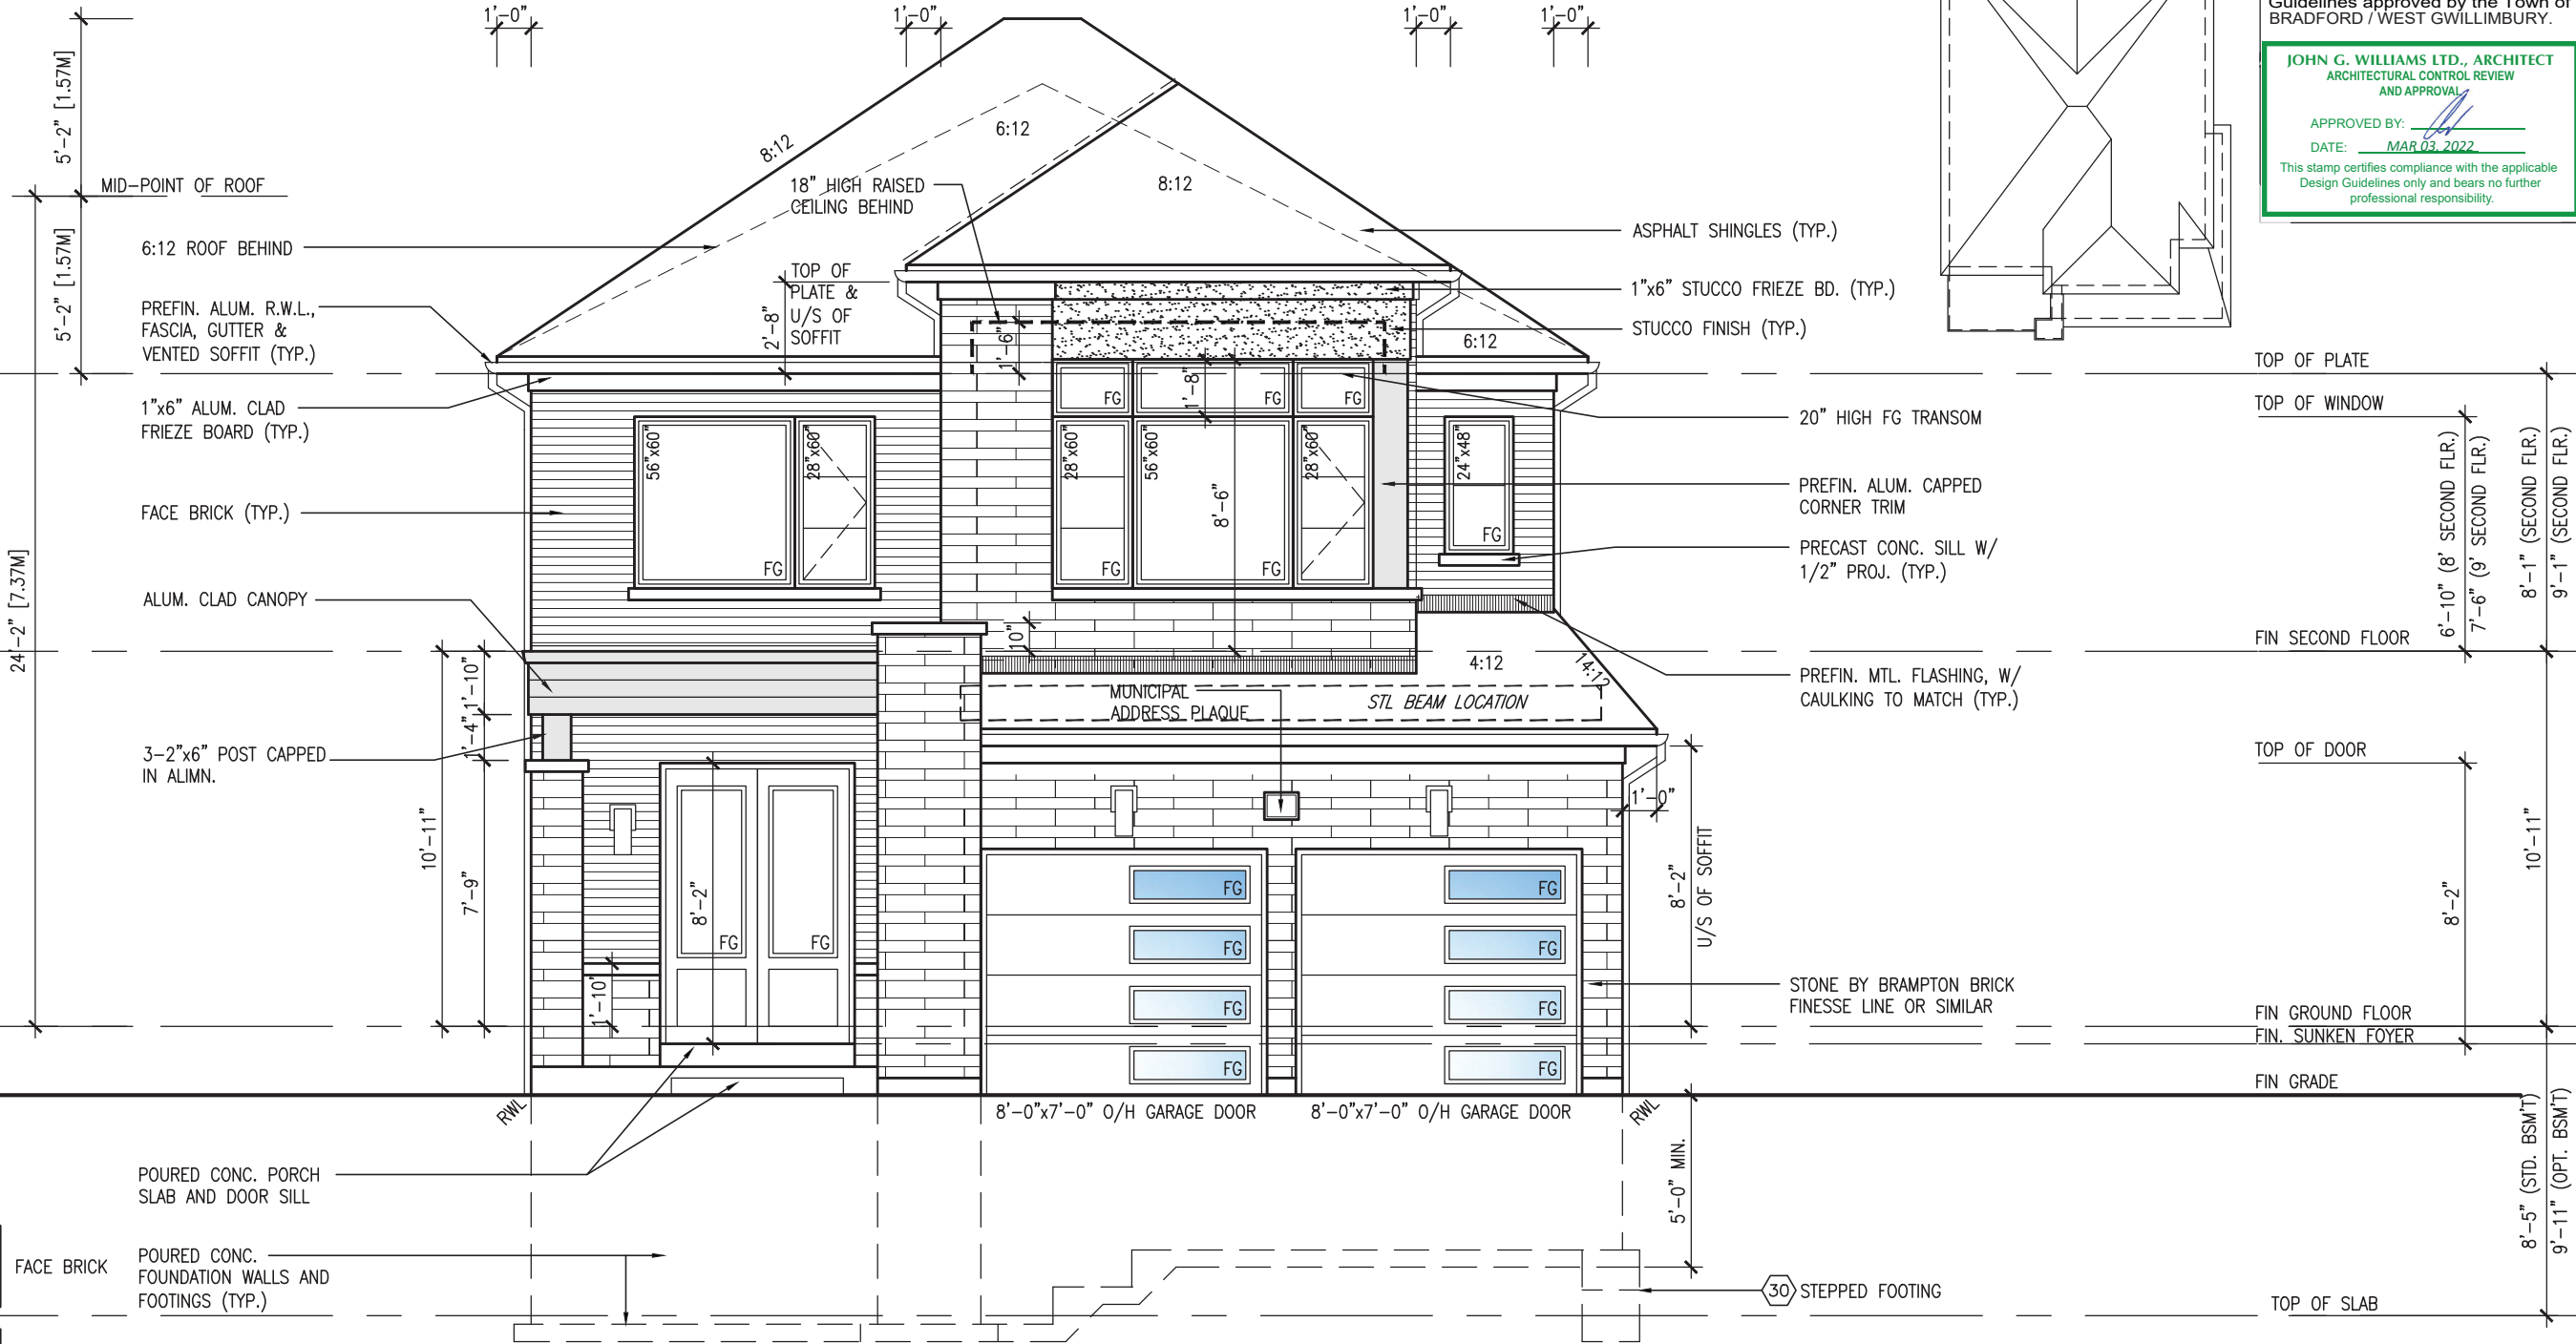
This is to certify that these plans comply with the applicable Architectural Design Guidelines approved by the Town of BRADFORD / WEST GWILLIMBURY.

JOHN G. WILLIAMS LTD., ARCHITECT
ARCHITECTURAL CONTROL REVIEW
AND APPROVAL

APPROVED BY:

DATE: MAR 03, 2022

This stamp certifies compliance with the applicable Design Guidelines only and bears no further professional responsibility.



FRONT ELEVATION 'C'



MAR 1, 2022

VA3 DESIGN

255 Consumers Rd. Suite 120
Toronto, ON M2J 1R4
t 416.630.2255 f 416.630.4782
va3design.com

The undersigned has reviewed and takes responsibility for this design and has the qualifications and meets the requirements set out in the Ontario Building Code to be a Designer.

Wellington Jno-Baptiste
name
BCIN
25591
42658

RC
FEB 25-22
NOV 26-21

2 REVISED AS PER ENG'S COMMENTS
1 ISSUED FOR CLIENT REVIEW

no. description

project no. 16023
drawing no. 38
project name GREEN VALLEY EAST
municipality BRADFORD
date OCTOBER 2021
checked by JMW
down by NS
scale 3/16" = 1'-0"

project name GREEN VALLEY EAST
municipality BRADFORD
date OCTOBER 2021
checked by JMW
down by NS
scale 3/16" = 1'-0"

project name GREEN VALLEY EAST
municipality BRADFORD
date OCTOBER 2021
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project name GREEN VALLEY EAST
municipality BRADFORD
date OCTOBER 2021
checked by JMW
down by NS
scale 3/16" = 1'-0"

project name GREEN VALLEY EAST
municipality BRADFORD
date OCTOBER 2021
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down by NS
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project name GREEN VALLEY EAST
municipality BRADFORD
date OCTOBER 2021
checked by JMW
down by NS
scale 3/16" = 1'-0"


project name GREEN VALLEY EAST
municipality BRADFORD
date OCTOBER 2021
checked by JMW
down by NS
scale 3/16" = 1'-0"

project name GREEN VALLEY EAST
municipality BRADFORD
date OCTOBER 2021
checked by JMW
down by NS
scale 3/16" = 1'-0"

REVIEWED

REFER TO FRONT ELEVATION FOR
TYPICAL NOTES.

10⁹ GROUND

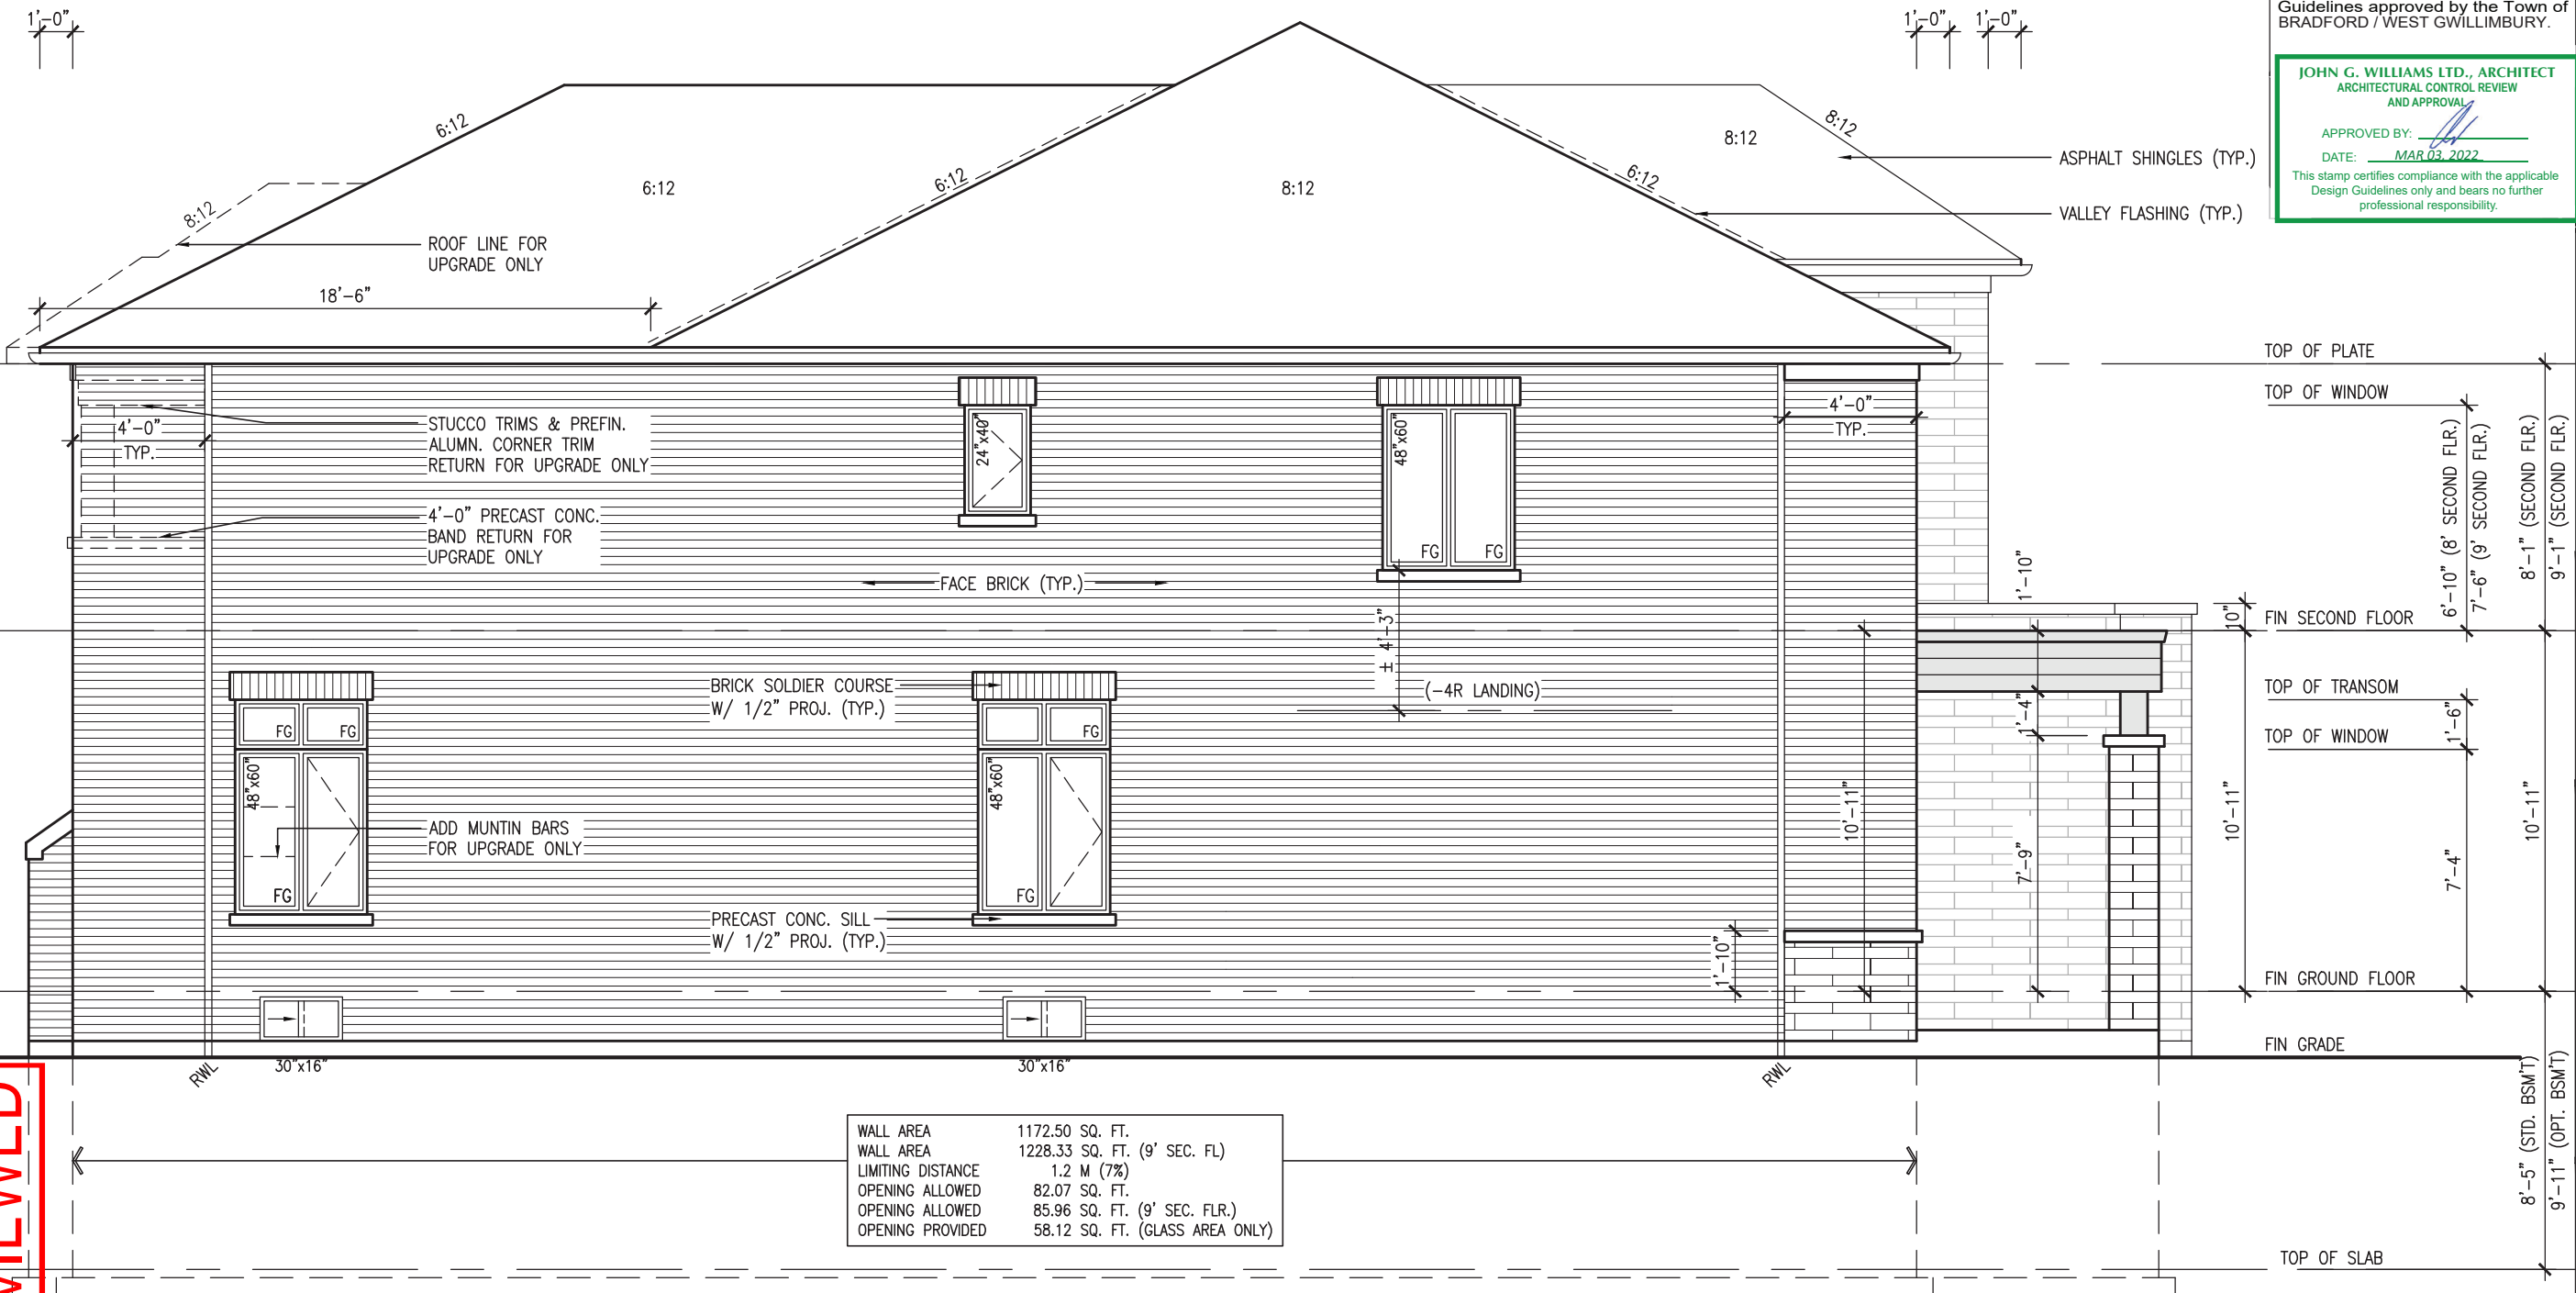

WALL AREA	1172.50 SQ. FT.
WALL AREA	1228.33 SQ. FT. (9' SEC. FL)
LIMITING DISTANCE	1.2 M (7%)
OPENING ALLOWED	82.07 SQ. FT.
OPENING ALLOWED	85.96 SQ. FT. (9' SEC. FLR.)
OPENING PROVIDED	58.12 SQ. FT. (GLASS AREA ONLY)

LEFT SIDE ELEVATION 'C'



MAR 1, 2022

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JOHN G. WILLIAMS LTD., ARCHITECT
ARCHITECTURAL CONTROL REVIEW
AND APPROVAL
APPROVED BY: [Signature]
DATE: MAR 03, 2022
This stamp certifies compliance with the applicable Design Guidelines only and bears no further professional responsibility.

		VA3 DESIGN		255 Consumers Rd, Suite 120 Toronto, ON M2J 1Y4 t 416.630.2253 f 416.630.4782 vco3design.com	
9	.	The undersigned has reviewed and takes responsibility for this design and has the qualifications and meets the requirements set out in the Ontario Building Code to be a Designer.		25591	BCIN
8	.	Wellington Jno-Baptiste			
7	.	signature			
6	.	name			
5	.	registration information			
4	.	VA3 Design Inc.			
3	.	signature		42658	
2	REVISED AS PER ENG'S COMMENTS	FEB 25--22 RC			
1	ISSUED FOR CLIENT REVIEW	NOV 26--21 VA3			
description		date			

project no.		16023		drawing no.		39	
project name		GREEN VALLEY EAST		checked by		JWM	
municipality		BRADFORD		scale		3/16" = 1'-0"	
date		OCTOBER 2021		down by		NS	
project name		BAYVIEW WELLINGTON		file name		16023-S38-19	
municipality		BRADFORD		LEFT SIDE		ELEVATION 'C'	
project no.		16023		drawing no.		39	
project name		GREEN VALLEY EAST		checked by		JWM	
municipality		BRADFORD		scale		3/16" = 1'-0"	
date		OCTOBER 2021		down by		NS	
project name		BAYVIEW WELLINGTON		file name		16023-S38-19	
municipality		BRADFORD		LEFT SIDE		ELEVATION 'C'	
project no.		16023		drawing no.		39	
project name		GREEN VALLEY EAST		checked by		JWM	
municipality		BRADFORD		scale		3/16" = 1'-0"	
date		OCTOBER 2021		down by		NS	
project name		BAYVIEW WELLINGTON		file name		16023-S38-19	
municipality		BRADFORD		LEFT SIDE		ELEVATION 'C'	
project no.		16023		drawing no.		39	
project name		GREEN VALLEY EAST		checked by		JWM	
municipality		BRADFORD		scale		3/16" = 1'-0"	
date		OCTOBER 2021		down by		NS	
project name		BAYVIEW WELLINGTON		file name		16023-S38-19	
municipality		BRADFORD		LEFT SIDE		ELEVATION 'C'	
project no.		16023		drawing no.		39	
project name		GREEN VALLEY EAST		checked by		JWM	
municipality		BRADFORD		scale		3/16" = 1'-0"	
date		OCTOBER 2021		down by		NS	
project name		BAYVIEW WELLINGTON		file name		16023-S38-19	
municipality		BRADFORD		LEFT SIDE		ELEVATION 'C'	
project no.		16023		drawing no.		39	
project name		GREEN VALLEY EAST		checked by		JWM	
municipality		BRADFORD		scale		3/16" = 1'-0"	
date		OCTOBER 2021		down by		NS	
project name		BAYVIEW WELLINGTON		file name		16023-S38-19	
municipality		BRADFORD		LEFT SIDE		ELEVATION 'C'	
project no.		16023		drawing no.		39	
project name		GREEN VALLEY EAST		checked by		JWM	
municipality		BRADFORD		scale		3/16" = 1'-0"	
date		OCTOBER 2021		down by		NS	
project name		BAYVIEW WELLINGTON		file name		16023-S38-19	
municipality		BRADFORD		LEFT SIDE		ELEVATION 'C'	
project no.		16023		drawing no.		39	
project name		GREEN VALLEY EAST		checked by		JWM	
municipality		BRADFORD		scale		3/16" = 1'-0"	
date		OCTOBER 2021		down by		NS	
project name		BAYVIEW WELLINGTON		file name		16023-S38-19	
municipality		BRADFORD		LEFT SIDE		ELEVATION 'C'	
project no.		16023		drawing no.		39	
project name		GREEN VALLEY EAST		checked by		JWM	
municipality		BRADFORD		scale		3/16" = 1'-0"	
date		OCTOBER 2021		down by		NS	
project name		BAYVIEW WELLINGTON		file name		16023-S38-19	
municipality		BRADFORD		LEFT SIDE		ELEVATION 'C'	
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municipality		BRADFORD		LEFT SIDE		ELEVATION 'C'	
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municipality		BRADFORD		scale		3/16" = 1'-0"	
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project name		BAYVIEW WELLINGTON		file name		16023-S38-19	
municipality		BRADFORD		LEFT SIDE		ELEVATION 'C'	
project no.		16023		drawing no.		39	
project name		GREEN VALLEY EAST		checked by		JWM	
municipality		BRADFORD		scale		3/16" = 1'-0"	
date		OCTOBER 2021		down by		NS	
project name		BAYVIEW WELLINGTON		file name		16023-S38-19	
municipality		BRADFORD		LEFT SIDE		ELEVATION 'C'	
project no.		16023		drawing no.		39	
project name		GREEN VALLEY EAST		checked by		JWM	
municipality		BRADFORD		scale		3/16" = 1'-0"	
date		OCTOBER 2021		down by		NS	
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municipality		BRADFORD		LEFT SIDE		ELEVATION 'C'	
project no.		16023		drawing no.		39	
project name		GREEN VALLEY EAST		checked by		JWM	
municipality		BRADFORD		scale		3/16" = 1'-0"	
date		OCTOBER 2021		down by		NS	
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municipality		BRADFORD		LEFT SIDE		ELEVATION 'C'	
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municipality		BRADFORD		scale		3/16" = 1'-0"	
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project no.		16023		drawing no.		39	
project name		GREEN VALLEY EAST		checked by		JWM	
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municipality		BRADFORD		scale		3/16" = 1'-0"	
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municipality		BRADFORD		scale		3/16" = 1'-0"	
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municipality		BRADFORD		scale		3/16" = 1'-0"	
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municipality		BRADFORD		scale		3/16" = 1'-0"	
date		OCTOBER 2021		down by		NS	
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project name		GREEN VALLEY EAST		checked by		JWM	
municipality		BRADFORD		scale		3/16" = 1'-0"	
date		OCTOBER 2021		down by		NS	
project name		BAYVIEW WELLINGTON		file name		16023-S38-19	
municipality		BRADFORD		LEFT SIDE		ELEVATION 'C'	
project no.		16023		drawing no.		39	
project name		GREEN VALLEY EAST		checked by		JWM	
municipality		BRADFORD		scale		3/16" = 1'-0"	
date		OCTOBER 2021		down by		NS	
project name		BAYVIEW WELLINGTON		file name		16023-S38-19	
municipality		BRADFORD		LEFT SIDE		ELEVATION 'C'	
project no.		16023		drawing no.		39	
project name		GREEN VALLEY EAST		checked by		JWM	
municipality		BRADFORD		scale		3/16" = 1'-0"	
date		OCTOBER 2021		down by		NS	
project name		BAYVIEW WELLINGTON		file name		16023-S38-19	
municipality		BRADFORD		LEFT SIDE		ELEVATION 'C'	
project no.		16023		drawing no.		39	
project name		GREEN VALLEY EAST		checked by		JWM	
municipality		BRADFORD		scale		3/16" = 1'-0"	
date		OCTOBER 2021		down by		NS	
project name		BAYVIEW WELLINGTON		file name		16023-S38-19	
municipality		BRADFORD		LEFT SIDE		ELEVATION 'C'	
project no.		16023		drawing no.		39	
project name		GREEN VALLEY EAST		checked by		JWM	
municipality		BRADFORD		scale		3/16" = 1'-0"	
date		OCTOBER 2021		down by		NS	
project name		BAYVIEW WELLINGTON		file name		16023-S38-19	
municipality		BRADFORD		LEFT SIDE		ELEVATION 'C'	
project no.		16023		drawing no.		39	
project name		GREEN VALLEY EAST		checked by		JWM	
municipality		BRADFORD		scale		3/16" = 1'-0"	
date		OCTOBER 2021		down by		NS	
project name		BAYVIEW WELLINGTON		file name		16023-S38-19	
municipality		BRADFORD		LEFT SIDE		ELEVATION 'C'	
project no.		16023		drawing no.		39	
project name		GREEN VALLEY EAST		checked by		JWM	
municipality		BRADFORD		scale		3/16" = 1'-0"	
date		OCTOBER 2021		down by		NS	
project name		BAYVIEW WELLINGTON		file name		16023-S38-19	
municipality		BRADFORD		LEFT SIDE		ELEVATION 'C'	
project no.		16023		drawing no.		39	
project name		GREEN VALLEY EAST		checked by		JWM	
municipality		BRADFORD		scale		3/16" = 1'-0"	
date		OCTOBER 2021		down by		NS	
project name		BAYVIEW WELLINGTON		file name		16023-S38-19	
municipality		BRADFORD		LEFT SIDE		ELEVATION 'C'	
project no.		16023		drawing no.		39	
project name		GREEN VALLEY EAST		checked by		JWM	
municipality		BRADFORD		scale		3/16" = 1'-0"	
date		OCTOBER 2021		down by		NS	
project name		BAYVIEW WELLINGTON		file name		16023-S38-19	
municipality		BRADFORD		LEFT SIDE		ELEVATION 'C'	
project no.		16023		drawing no.		39	
project name		GREEN VALLEY EAST		checked by		JWM	
municipality		BRADFORD		scale		3/16" = 1'-0"	
date		OCTOBER 2021		down by		NS	
project name		BAYVIEW WELLINGTON		file name		16023-S38-19	
municipality		BRADFORD		LEFT SIDE		ELEVATION 'C'	
project no.		16023		drawing no.		39	
project name		GREEN VALLEY EAST		checked by		JWM	
municipality		BRADFORD		scale		3/16" = 1'-0"	
date		OCTOBER 2021		down by		NS	
project name		BAYVIEW WELLINGTON		file name		16023-S38-19	
municipality		BRADFORD		LEFT SIDE		ELEVATION 'C'	
project no.		16023		drawing no.		39	
project name		GREEN VALLEY EAST		checked by		JWM	
municipality		BRADFORD		scale		3/16" = 1'-0"	
date		OCTOBER 2021		down by		NS	

REVIEWED

UPGRADED REAR ELEVATION 'A'

JOHN G. WILLIAMS LTD., ARCHITECT
ARCHITECTURAL CONTROL REVIEW
AND APPROVAL

APPROVED BY: 

DATE: MAR 03, 2022

This stamp certifies compliance with the applicable Design Guidelines only and bears no further professional responsibility.



name
registration information
VA3 Design Inc.

signature

BCIN 42658

no.	description	date	by	<p>Contractor must verify all dimensions on the job and report any discrepancy to the Designer before proceeding with the work. All drawings and specifications are instruments of service and the property of the Designer which must be returned at the completion of the work.</p> <p>Drawings are not to be scaled.</p>	
2	REVISED AS PER ENG'S COMMENTS	FEB 25--22	RC		
1	ISSUED FOR CLIENT REVIEW	NOV 26-21	WAS		
<p>255 Consumers Rd Suite 120 Toronto ON M2J 1P4 t 416.630.2255 f 416.630.4782 vo3design.com</p>					
		drawn by	checked by	scale	file name
		NS	JWM	3/16" = 1'-0"	16023-S38-19
		<p>OCTOBER 2021</p> <p>UPGRADED REAR ELEVATION A</p>			
		<p>RICHARD - H:\ARCHIVE\WORKING\2016\16023.BW\Units\38\16023-S38-19.dwg - Tue - Mar 1, 2022 - 9:33 AM</p>			

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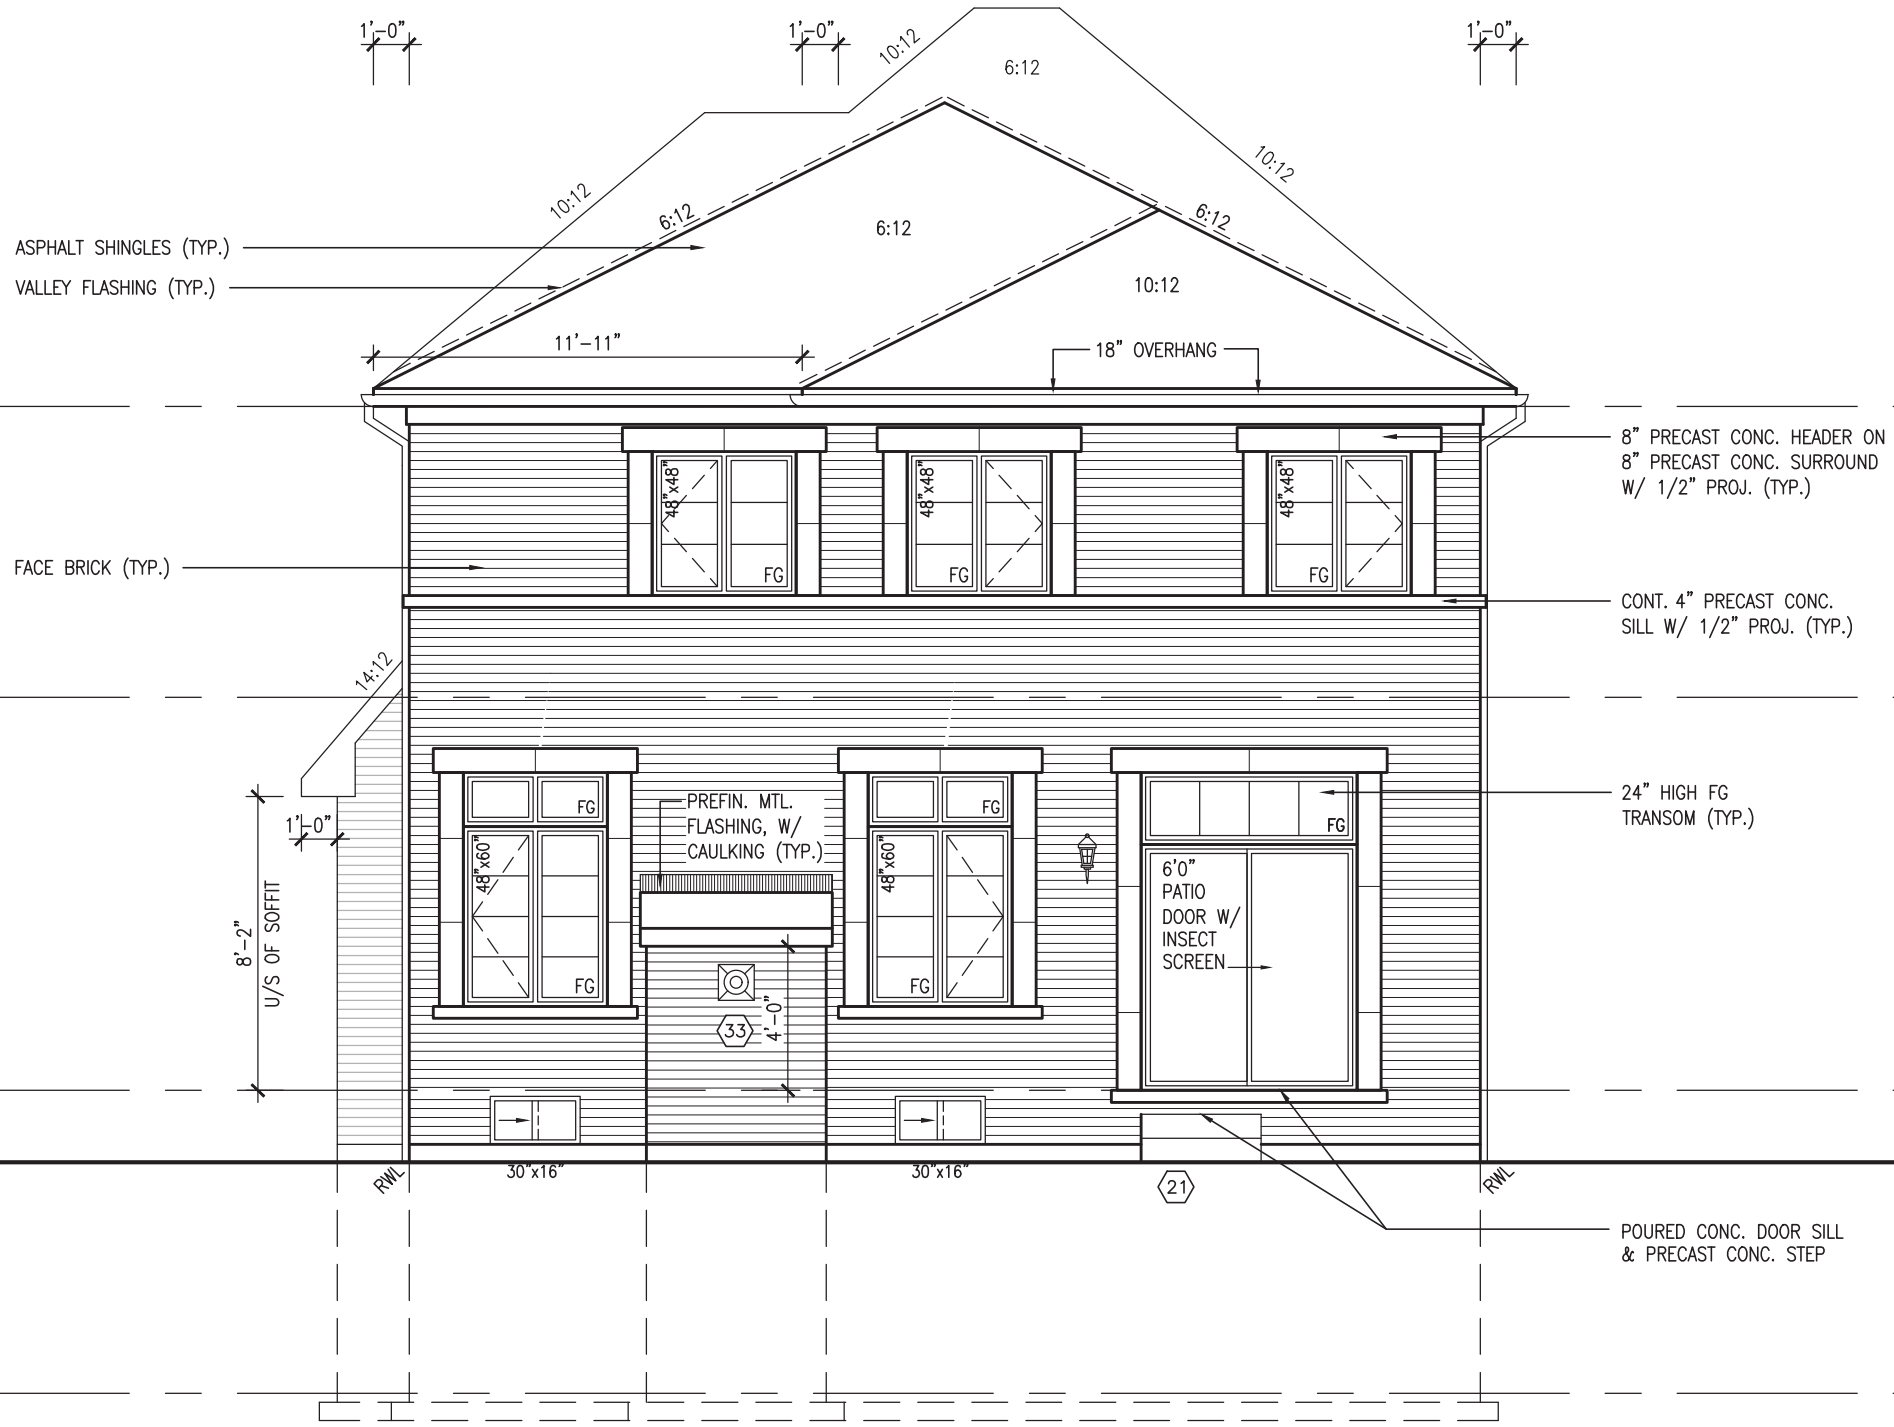
MAR 1, 2022

REVIEWED



REFER TO FRONT ELEVATION FOR
TYPICAL NOTES.

10' GROUND



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This is to certify that these plans comply with the applicable Architectural Design Guidelines approved by the Town of BRADFORD / WEST GWILLIMBURY.

JOHN G. WILLIAMS LTD., ARCHITECT
ARCHITECTURAL CONTROL REVIEW
AND APPROVAL

APPROVED BY:

DATE: MAR 03, 2022

This stamp certifies compliance with the applicable Design Guidelines only and bears no further professional responsibility.

TOP OF PLATE	
TOP OF WINDOW	
FIN SECOND FLOOR	6'-10" (8' SECOND FLR.)
TOP OF TRANSOM	7'-6" (9' SECOND FLR.)
TOP OF WINDOW	8'-1" (SECOND FLR.)
FIN GROUND FLOOR	9'-1" (SECOND FLR.)
FIN GRADE	
TOP OF SLAB	8'-5" (STD. BSM'T)

project no.		16023	
drawing no.		44	
project name		UPGRADED REAR ELEVATION 'B'	
municipality		BRADFORD	
project name		GREEN VALLEY EAST	
date		OCTOBER 2021	
checked by		JWM	
scale		3/16" = 1'-0"	
down by		NS	
file name		16023-S38-19	
date		Mar 1 2022 - 9:33 AM	
no.		description	
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2	REVISED AS PER ENG'S COMMENTS	FEB 25-22 RC	
1	ISSUED FOR CLIENT REVIEW	NOV 26-21 VAS	

The undersigned has reviewed and takes responsibility for this design and has the qualifications and meets the requirements set out in the Ontario Building Code to be a Designer.

qualification information

Wellington Jno-Baptiste 25591 BCN

name

VA3 Design Inc.

registration information

42658

Contractor must verify all dimensions on the job and report any discrepancy to the Designer before proceeding with the work. All drawings and specifications are instruments of service and the property of the Designer which must be returned at the completion of the work. Drawings are not to be scaled.

10'-0" GROUND FLOOR

10'-0" GROUND FLOOR	S38-19 ELEVATION C REAR UPG	ENERGY EFFICIENCY – OBC SB12		
	ELEVATION	WALL AREA S.F.	OPENING S.F.	PERCENTAGE
	FRONT	643 S.F.	178.72 S.F.	27.79 %
	LEFT SIDE	1192 S.F.	85.33 S.F.	7.16 %
	RIGHT SIDE	1200 S.F.	123.89 S.F.	10.32 %
	REAR	625 S.F.	176.29 S.F.	28.21 %
	* OPENINGS OMITTED AS PER SB-12 3.1.1.9(4) MAX 19.9 S.F. REFER TO ELEVATION FOR LOCATION		0.00 S.F.	
	TOTAL SQ. FT.	3660.00 S.F.	564.23 S.F.	15.42 %
	TOTAL SQ. M.	340.02 S.M.	52.42 S.M.	15.42 %

REFER TO FRONT ELEVATION FOR
TYPICAL NOTES.

10⁹ GROUND

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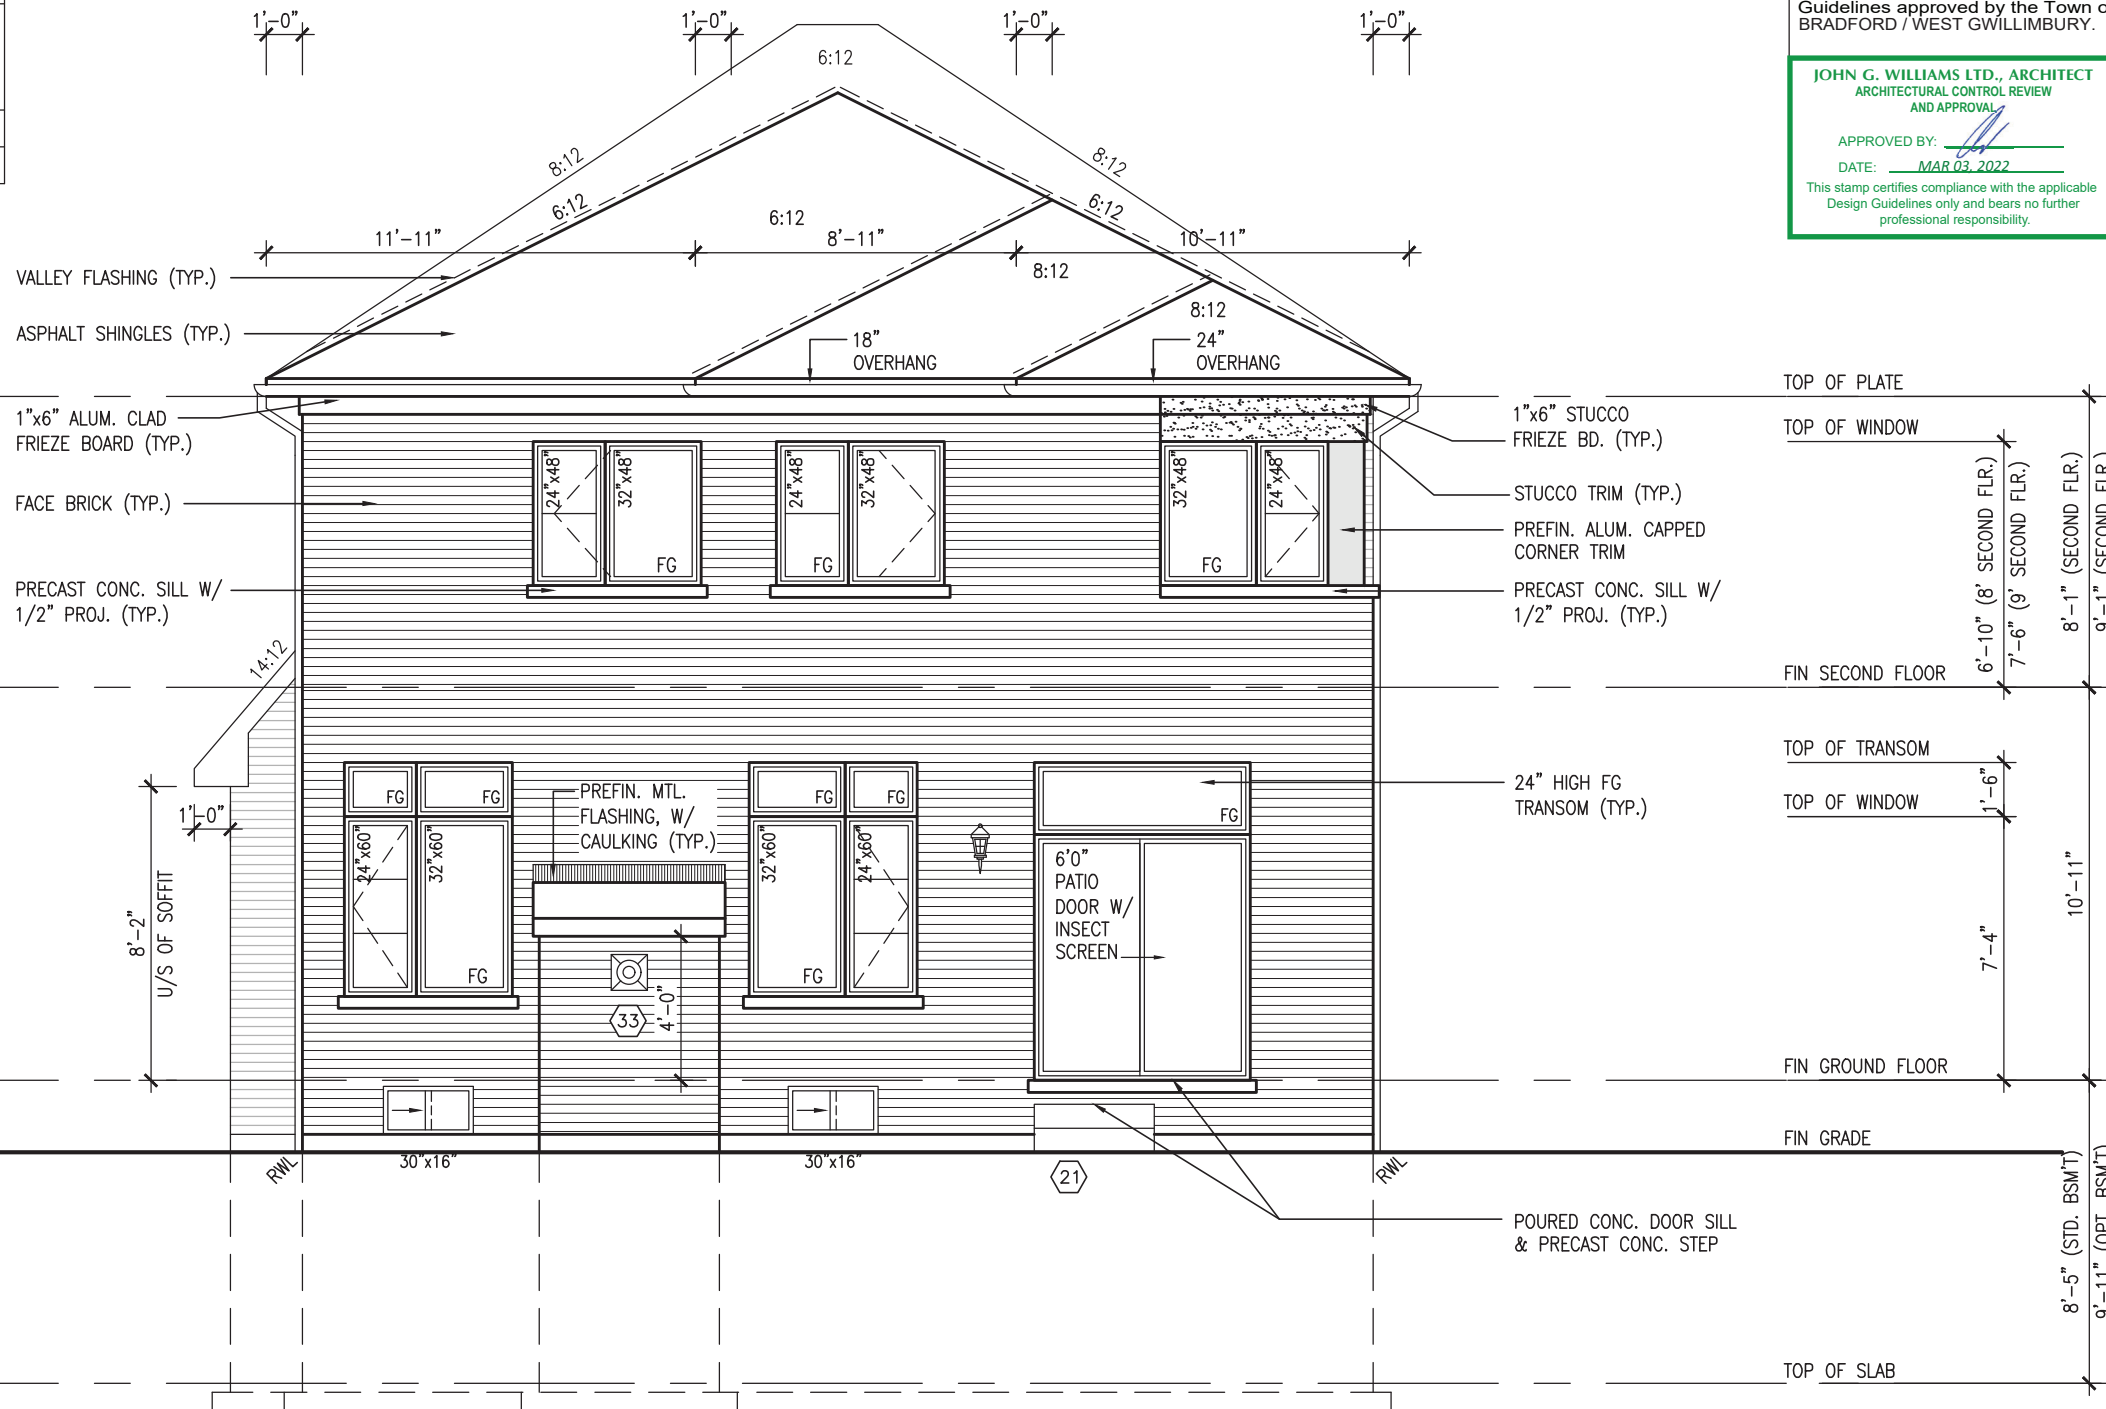
This is to certify that these plans comply with the applicable Architectural Design Guidelines approved by the Town of BRADFORD / WEST GWILLIMBURY.

JOHN G. WILLIAMS LTD., ARCHITECT
ARCHITECTURAL CONTROL REVIEW
AND APPROVAL

APPROVED BY: 

DATE: MAR 03, 2022

This stamp certifies compliance with the applicable Design Guidelines only and bears no further professional responsibility.



UPGRADED REAR ELEVATION 'C'

REVIEWED



MAR 1, 2022

S38-19

BAYVIEW WELLINGTON

project name	project no.
GREEN VALLEY EAST	16023
municipality	
BRADFORD	

date	LIBRARY REAR ELEVATION '09	drawing no.
------	----------------------------	-------------

file name	scale	checked by	drawn by
UPGRADED REAR ELEVATION C			

NS	JWM	$3/16'' = 1'-0''$	16023-S38-19
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RICHARD - H:\ARCHIVE\WORKING\2016\16023.BW\Units_38\16023-S38-19.dwg - Tue - Mar 1 2022 - 9:33 AM

A3

DESIGN

255 Consumers Rd Suite 120
Toronto ON M2J 1R4

416.630.2255 f 416.630.4782

www.vadesign.com

the undersigned has reviewed and takes responsibility for this design and has the qualifications and meets the requirements set out in the Ontario Building Code to be a Designer.

Wellington Jno-Baptiste *W. Baptiste* signature BCIN 25591

✓	/A3 Design Inc.	42658
---	-----------------	-------

Contractor must verify all dimensions on the job and report any discrepancy to the Designer before proceeding with the work. All

Drawings and specifications are instruments of service and the property of the Designer. They must be returned at the completion of the work.

Drawings are not to be scaled.

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2	REVISED AS PER ENG'S COMMENTS	FEB 25-22	R
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1	ISSUED FOR CLIENT REVIEW	NOV 26-21	VA
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no.	description	date	b
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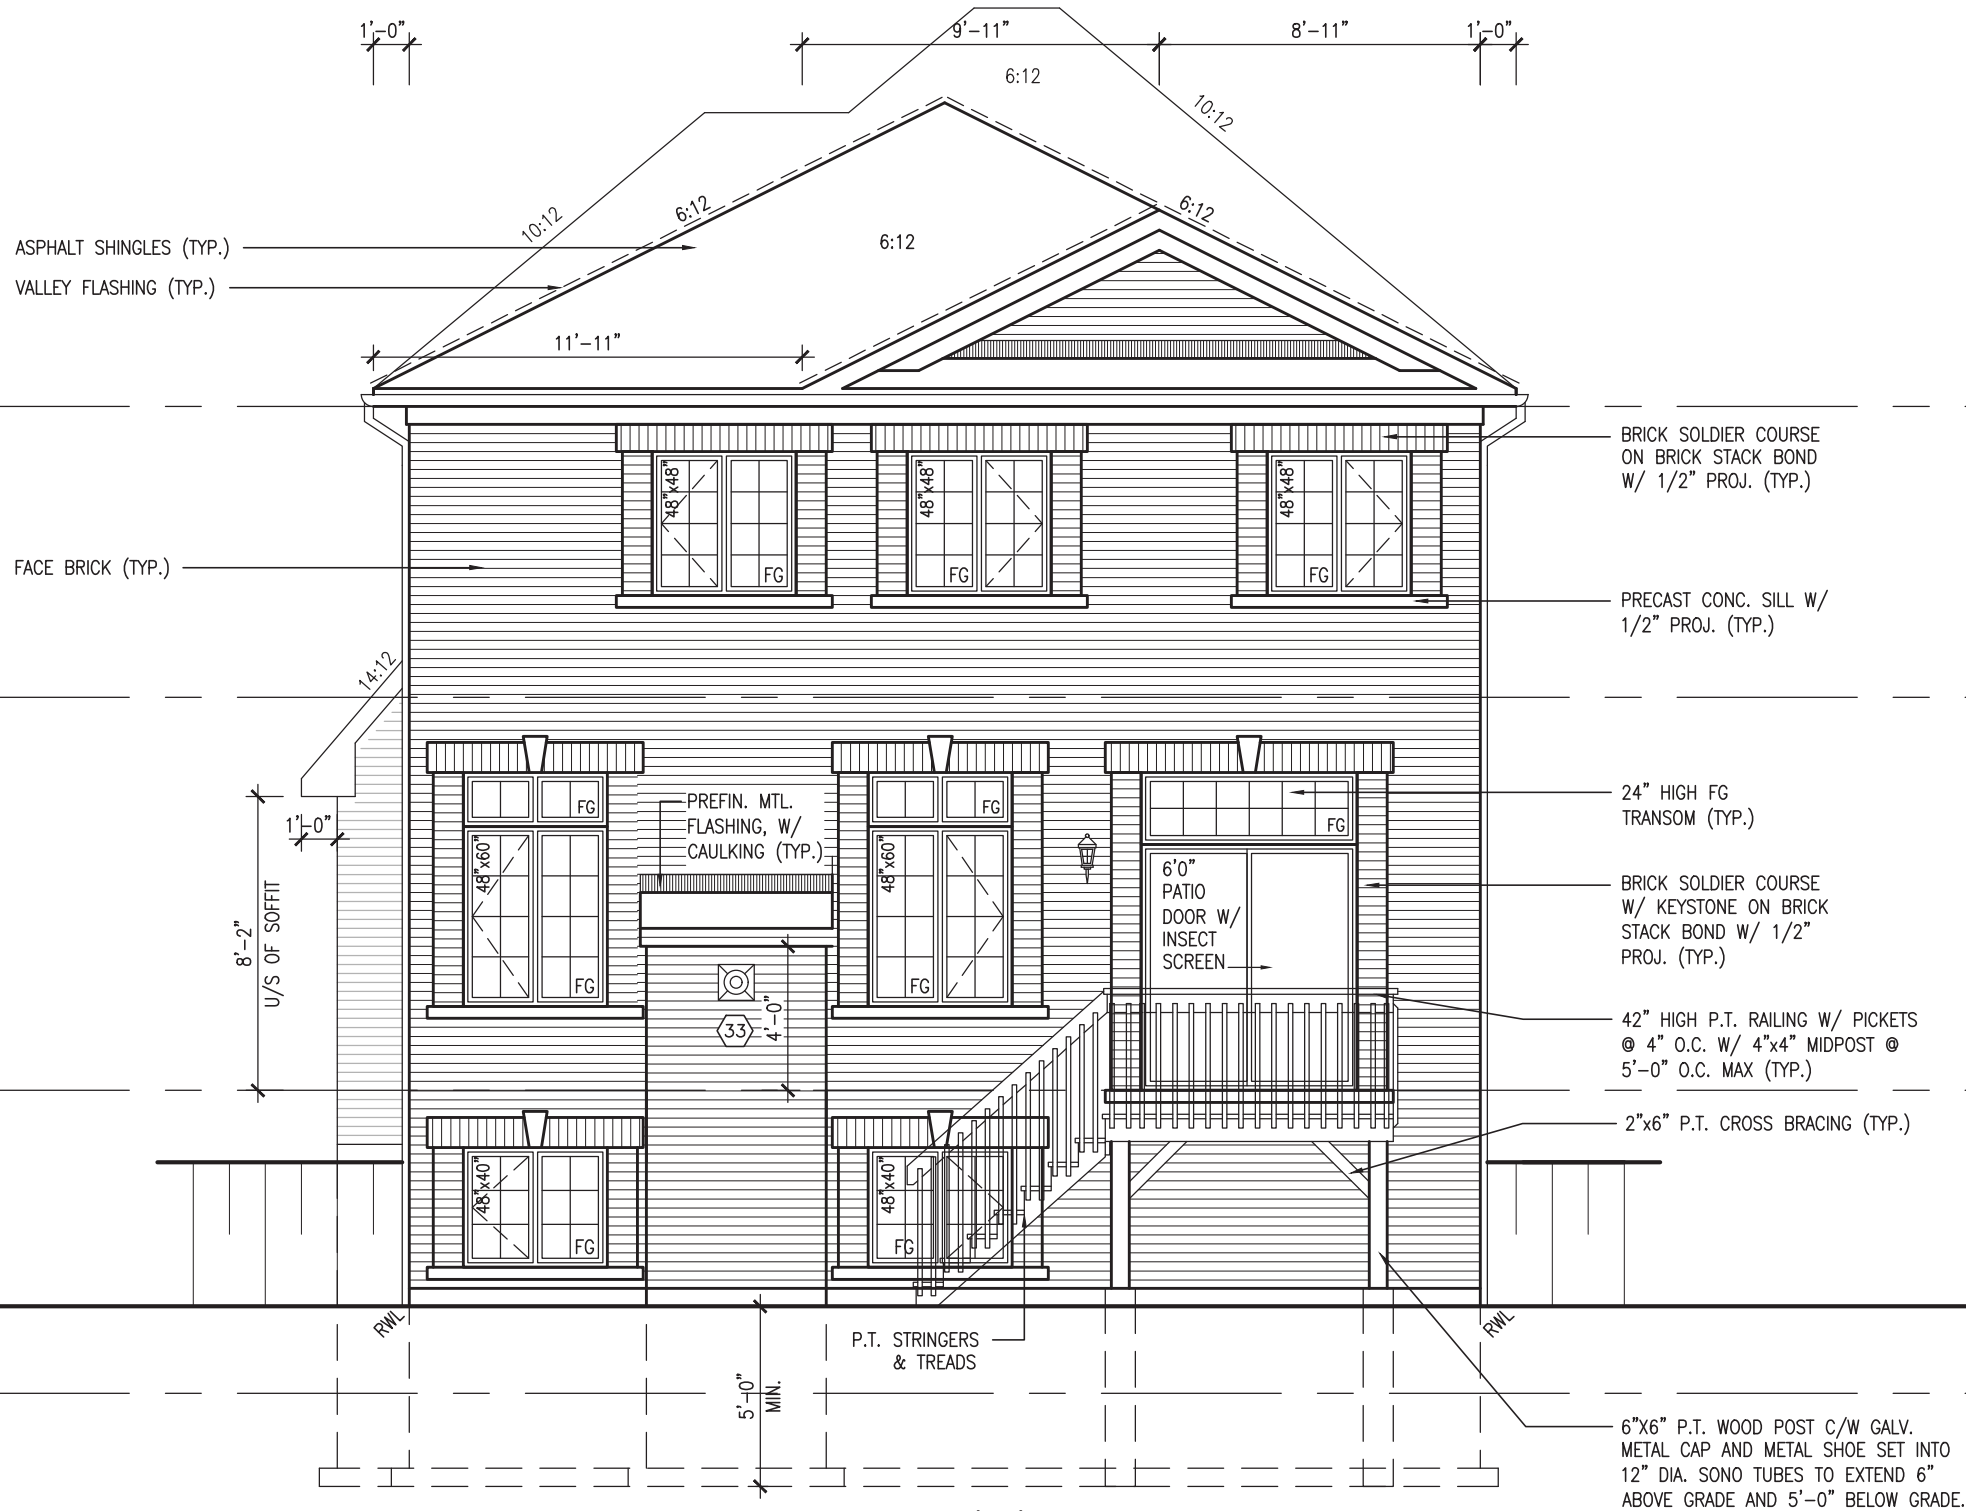
REVIEWED



MAR 1, 2022

REFER TO FRONT ELEVATION FOR
TYPICAL NOTES.

10' GROUND



UPGRADED REAR ELEVATION 'A' - WOD COND.

It is the builder's complete responsibility to ensure that all plans submitted for approval fully comply with the Architectural Guidelines and all applicable regulations and requirements including zoning provisions and any provisions in the subdivision agreement. The Control Architect is not responsible in any way for examining or approving site (lotting) plans or working drawings with respect to any zoning or building code or permit matter or that any house can be properly built or located on its lot.

This is to certify that these plans comply with the applicable Architectural Design Guidelines approved by the Town of BRADFORD / WEST GWILLIMBURY.

JOHN G. WILLIAMS LTD., ARCHITECT
ARCHITECTURAL CONTROL REVIEW
AND APPROVAL

APPROVED BY:

DATE: MAR 03, 2022

This stamp certifies compliance with the applicable Design Guidelines only and bears no further professional responsibility.

TOP OF PLATE	
TOP OF WINDOW	
FIN SECOND FLOOR	6'-10" (8' SECOND FLR.) 7'-6" (9' SECOND FLR.) 8'-1" (SECOND FLR.) 9'-1" (SECOND FLR.)
TOP OF TRANSOM	
TOP OF WINDOW	1'-6"
FIN GROUND FLOOR	7'-4" 10'-11"
TOP OF WINDOW	
FIN GRADE	6'-10" 8'-5" (STD. BSM'T) 9'-11" (OPT. BSM'T)
TOP OF SLAB	

project no. 16023

drawing no. 46

project name GREEN VALLEY EAST

municipality BRADFORD

date OCTOBER 2021

checked by JWM

down by NS

scale 3/16" = 1'-0"

file name 16023-S38-19

date 16023-S38-19

time 9:33 AM

project name UPGRADED REAR ELEVATION 'A' - WOD COND.

date 16023-S38-19

checked by JWM

down by NS

scale 3/16" = 1'-0"

file name 16023-S38-19

time 9:33 AM

project no. 25591

drawing no. 42658

project name WELLINGTON JRO-BAPTISTE

municipality BCIN

date FEB 25-22

checked by RC

down by RC

scale

file name

time

project no. 25591

drawing no. 42658

project name WELLINGTON JRO-BAPTISTE

municipality BCIN

date FEB 25-22

checked by RC

down by RC

scale

file name

time

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2 . REVISED AS PER ENG'S COMMENTS

1 . ISSUED FOR CLIENT REVIEW

no. description

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no. description

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10⁹ GROUND

This is to certify that these plans comply with the applicable Architectural Design Guidelines approved by the Town of BRADFORD / WEST GWILLIMBURY.

JOHN G. WILLIAMS LTD., ARCHITECT
ARCHITECTURAL CONTROL REVIEW
AND APPROVAL

APPROVED BY: 
 DATE: MAR 03, 2022

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S38-19

BAYVIEW WELLINGTON

BAYVIEW

project name
GREEN VALLEY EAST



The undersigned has reviewed and takes responsibility for this design and has the qualifications and meets the requirements set out in the Ontario Building Code to be a Designer.

qualification information
Wellington Jno-Baptiste
name
registration information
signature
BCIN 25591

9	.	.
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drawing no.

UPGRADED REAR ELEVATION 'B' - WOOD COND.

date OCTOBER 2021

DESIGN

VA3 Design Inc. 42658

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copy	scale	file name
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drawn by	checked by

235 Consumers Rd Suite 120
Toronto ON M2J 1R4


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2	REVISED AS PER ENG'S COMMENTS	FEB 25-22	RC
4	ISSUED FOR CLIENT REVIEW	NOV 06 24	VAZ

[illegible]

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UNINSULATED OPENINGS (PER OBC. SB-12,3.1.1(7))				
10'-0" GROUND FLOOR	S38-19 ELEVATION C REAR UPG WOD	ENERGY EFFICIENCY – OBC SB12		
	ELEVATION	WALL AREA S.F.	OPENING S.F.	PERCENTAGE
	FRONT	643 S.F.	178.72 S.F.	27.79 %
	LEFT SIDE	1192 S.F.	85.33 S.F.	7.16 %
	RIGHT SIDE	1200 S.F.	123.89 S.F.	10.32 %
	REAR	744 S.F.	194.73 S.F.	26.17 %
	* OPENINGS OMITTED AS PER SB-12 3.1.1.9(4) MAX 19.9 S.F. REFER TO ELEVATION FOR LOCATION		0.00 S.F.	
	TOTAL SQ. FT.	3779.00 S.F.	582.67 S.F.	15.42 %
TOTAL SQ. M.	351.08 S.M.	54.13 S.M.	15.42 %	



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JOHN G. WILLIAMS LTD., ARCHITECT
ARCHITECTURAL CONTROL REVIEW
AND APPROVAL

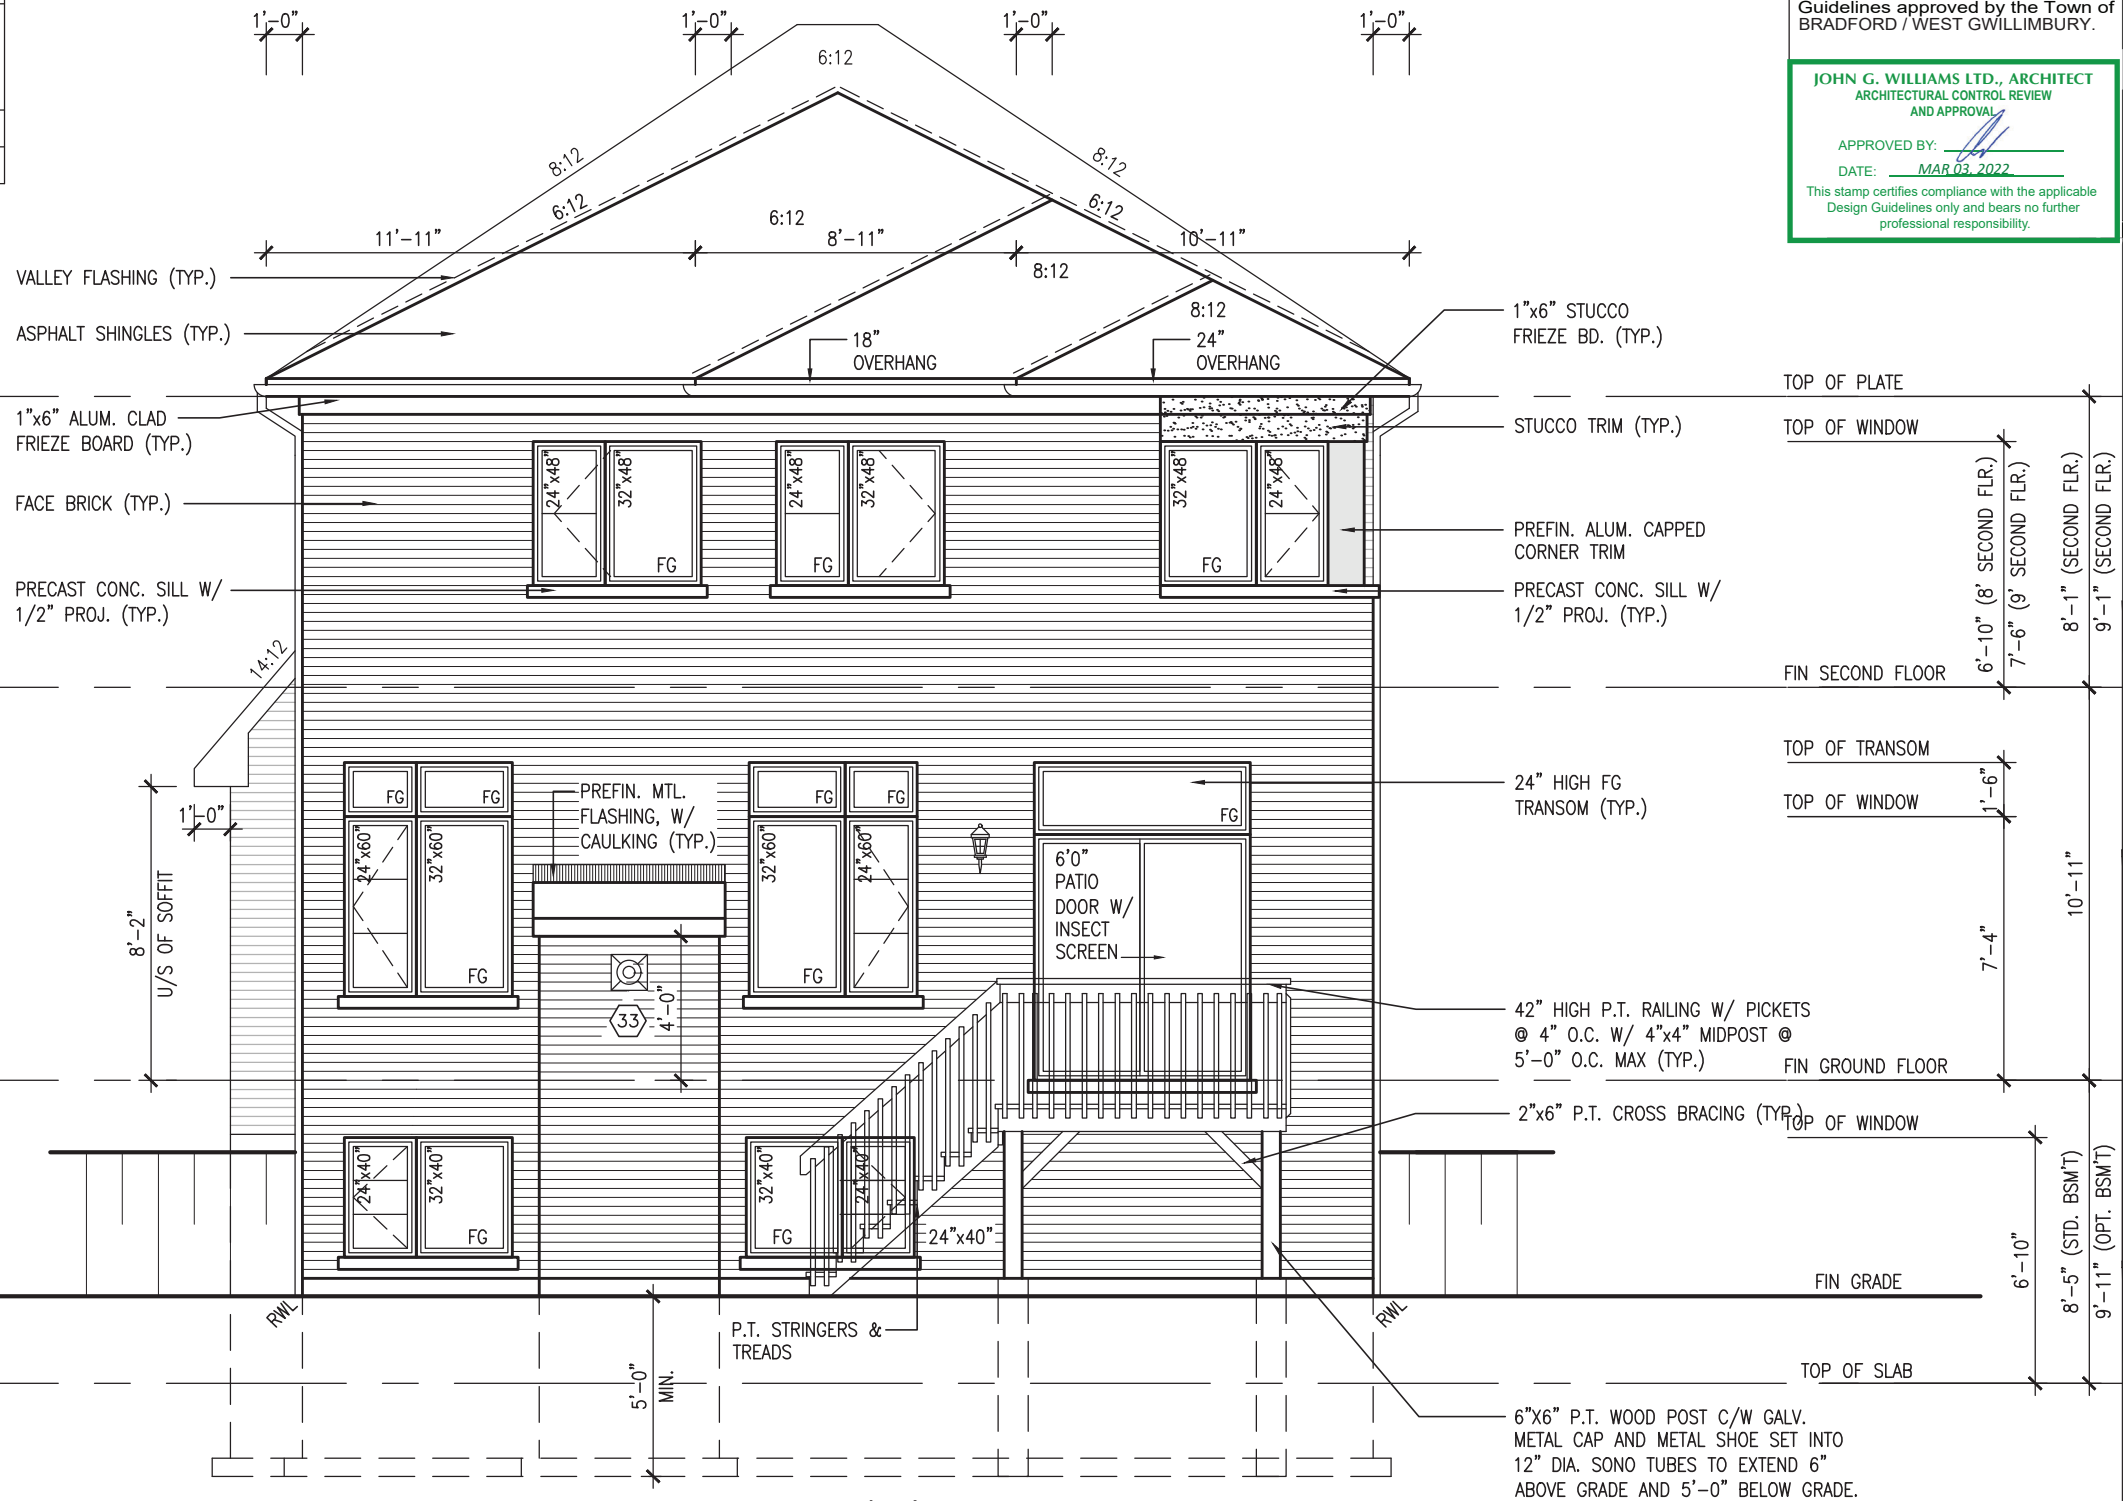APPROVED BY: 

DATE: MAR 03, 2022

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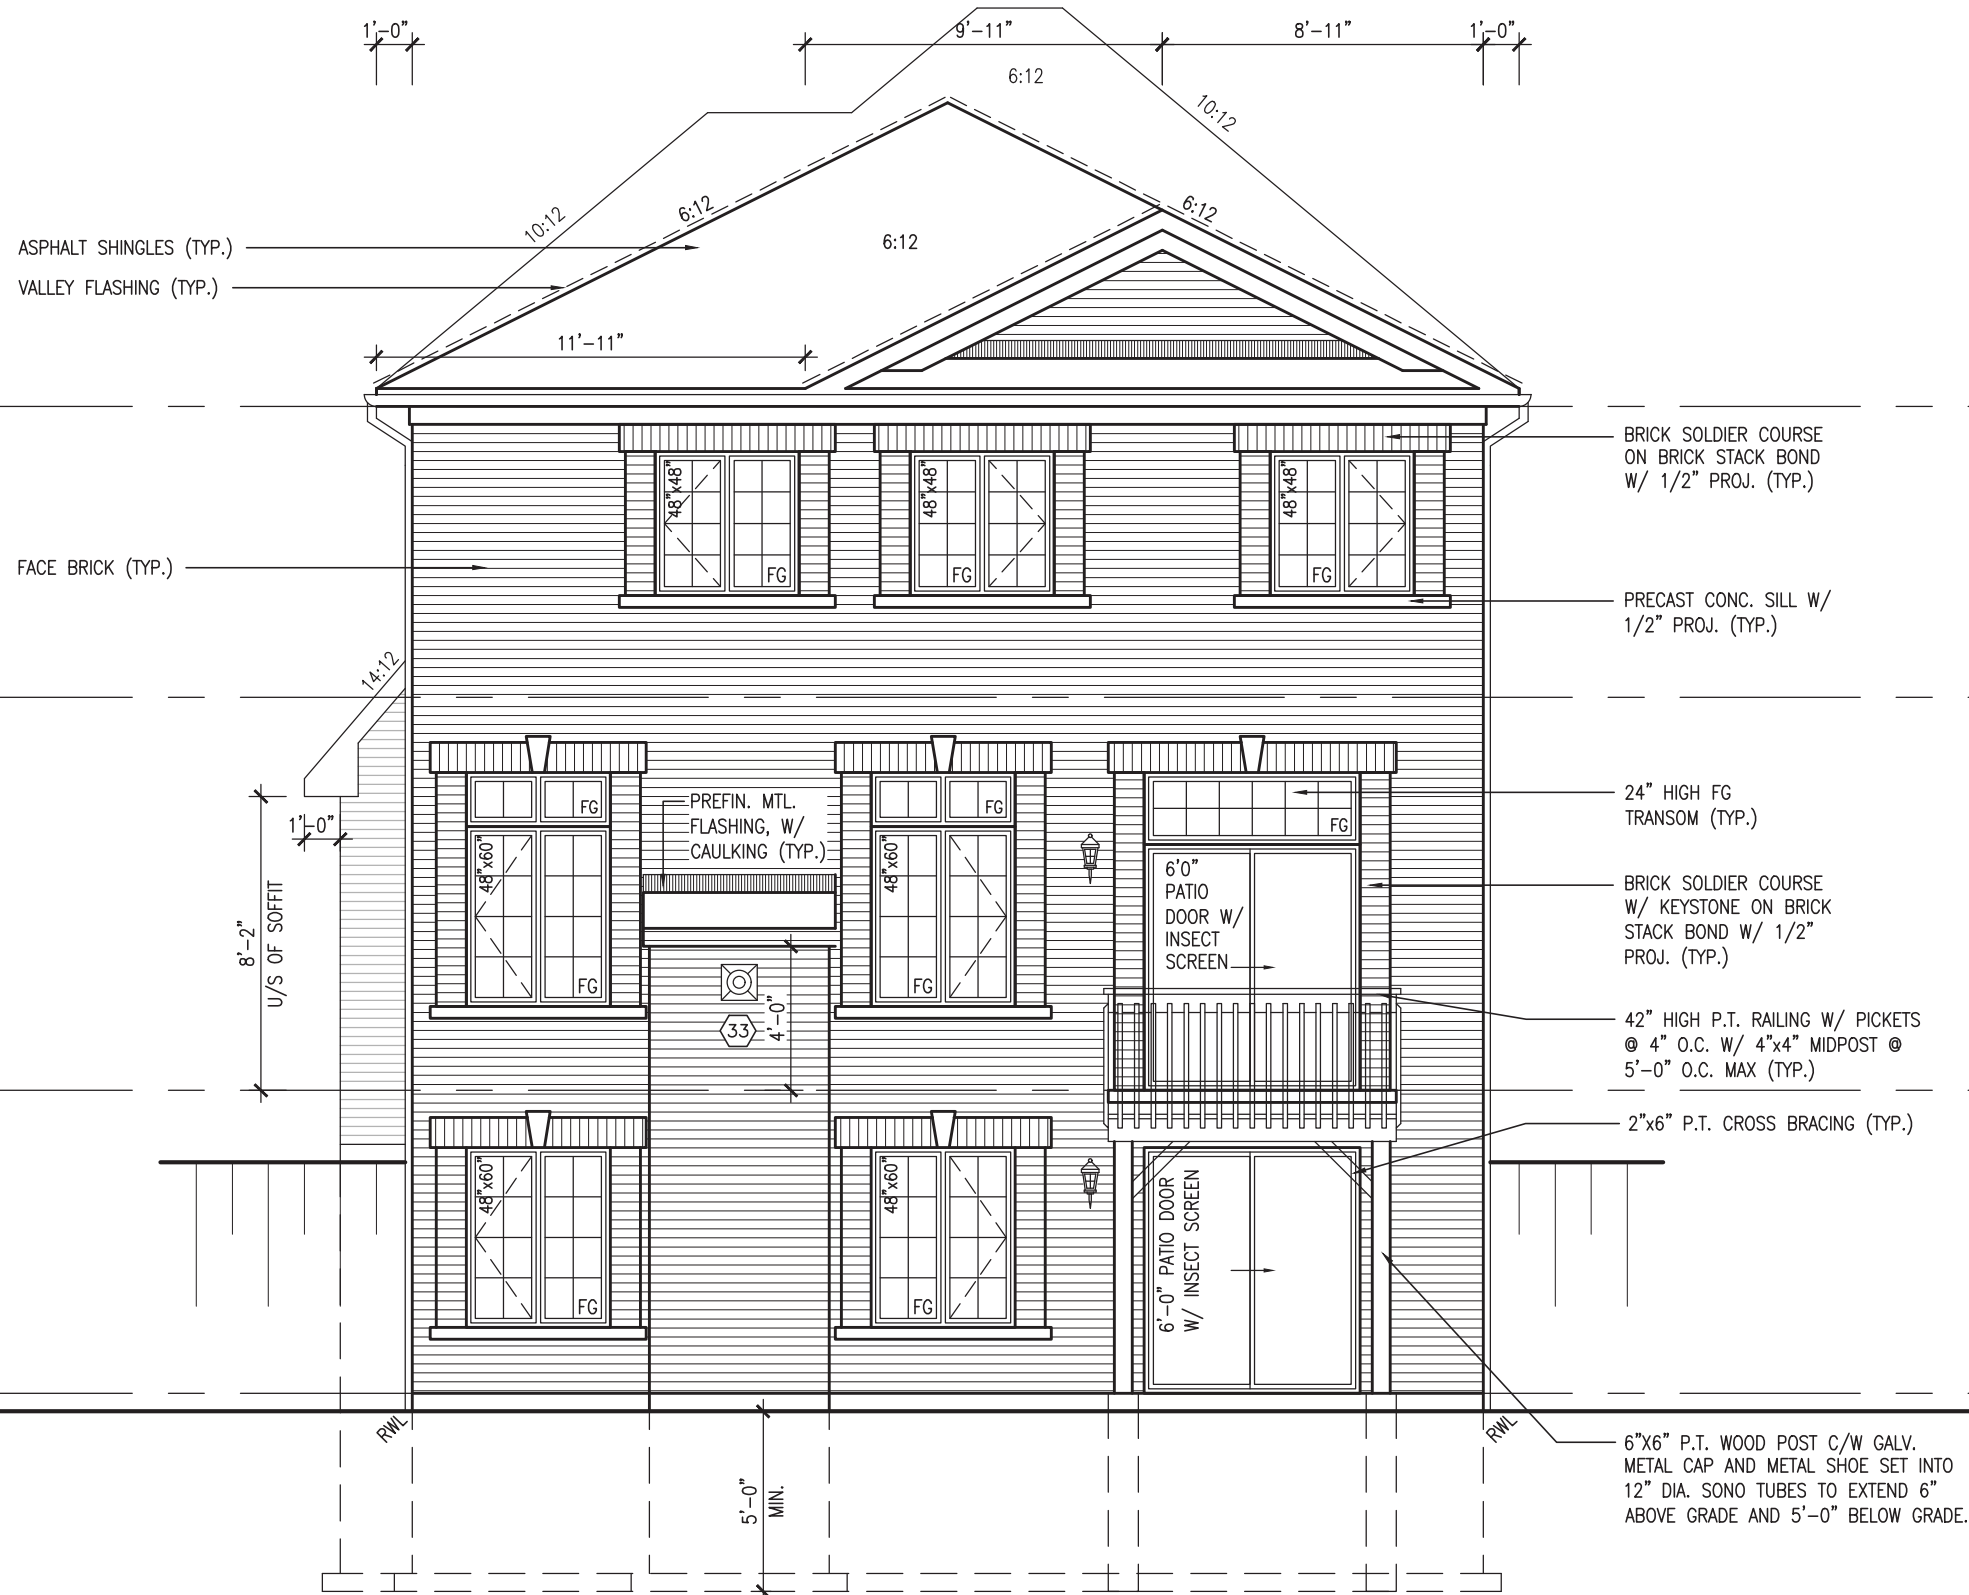
REVIEWED



MAR 1, 2022

REFER TO FRONT ELEVATION FOR
TYPICAL NOTES.

10' GROUND




UPGRADED REAR ELEVATION 'A' - WOB COND.

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JOHN G. WILLIAMS LTD., ARCHITECT
ARCHITECTURAL CONTROL REVIEW
AND APPROVAL
APPROVED BY: [Signature]
DATE: MAR 03, 2022
This stamp certifies compliance with the applicable Design Guidelines only and bears no further professional responsibility.




		project no.		16023	
		drawing no.		49	
		project name		BAYVIEW WELLINGTON	
		municipality		BRADFORD	
		date		OCTOBER 2021	
		checked by		JWM	
		drawn by		NS	
		scale		3/16" = 1'-0"	
		file name		16023-S38-19	
		date		Tue - Mar 1 2022 - 9:33 AM	
		project name		BAYVIEW WELLINGTON	
		municipality		GREEN VALLEY EAST	
		date		OCTOBER 2021	
		checked by		JWM	
		drawn by		NS	
		scale		3/16" = 1'-0"	
		file name		16023-S38-19	
		date		Tue - Mar 1 2022 - 9:33 AM	
		project name		BAYVIEW WELLINGTON	
		municipality		GREEN VALLEY EAST	
		date		OCTOBER 2021	
		checked by		JWM	
		drawn by		NS	
		scale		3/16" = 1'-0"	
		file name		16023-S38-19	
		date		Tue - Mar 1 2022 - 9:33 AM	
		project name		BAYVIEW WELLINGTON	
		municipality		GREEN VALLEY EAST	
		date		OCTOBER 2021	
		checked by		JWM	
		drawn by		NS	
		scale		3/16" = 1'-0"	
		file name		16023-S38-19	
		date		Tue - Mar 1 2022 - 9:33 AM	
		project name		BAYVIEW WELLINGTON	
		municipality		GREEN VALLEY EAST	
		date		OCTOBER 2021	
		checked by		JWM	
		drawn by		NS	
		scale		3/16" = 1'-0"	
		file name		16023-S38-19	
		date		Tue - Mar 1 2022 - 9:33 AM	
		project name		BAYVIEW WELLINGTON	
		municipality		GREEN VALLEY EAST	
		date		OCTOBER 2021	
		checked by		JWM	
		drawn by		NS	
		scale		3/16" = 1'-0"	
		file name		16023-S38-19	
		date		Tue - Mar 1 2022 - 9:33 AM	
		project name		BAYVIEW WELLINGTON	
		municipality		GREEN VALLEY EAST	
		date		OCTOBER 2021	
		checked by		JWM	
		drawn by		NS	
		scale		3/16" = 1'-0"	
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		checked by		JWM	

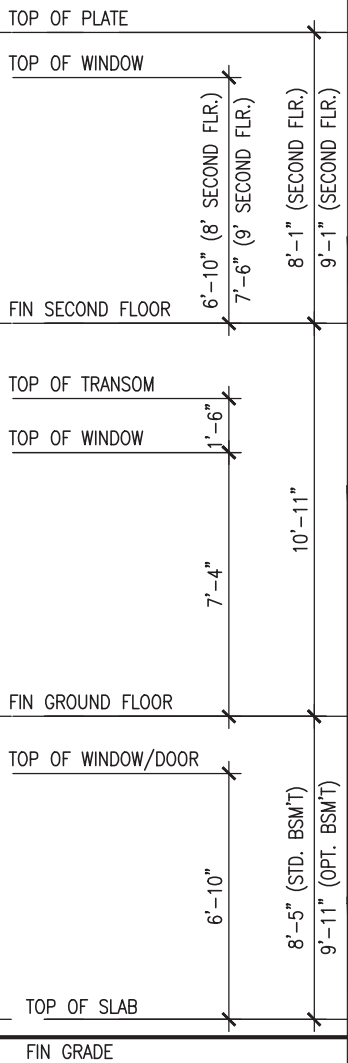10⁹ GROUND

REVIEWED



UPGRADED REAR ELEVATION 'B' - WOB COND.

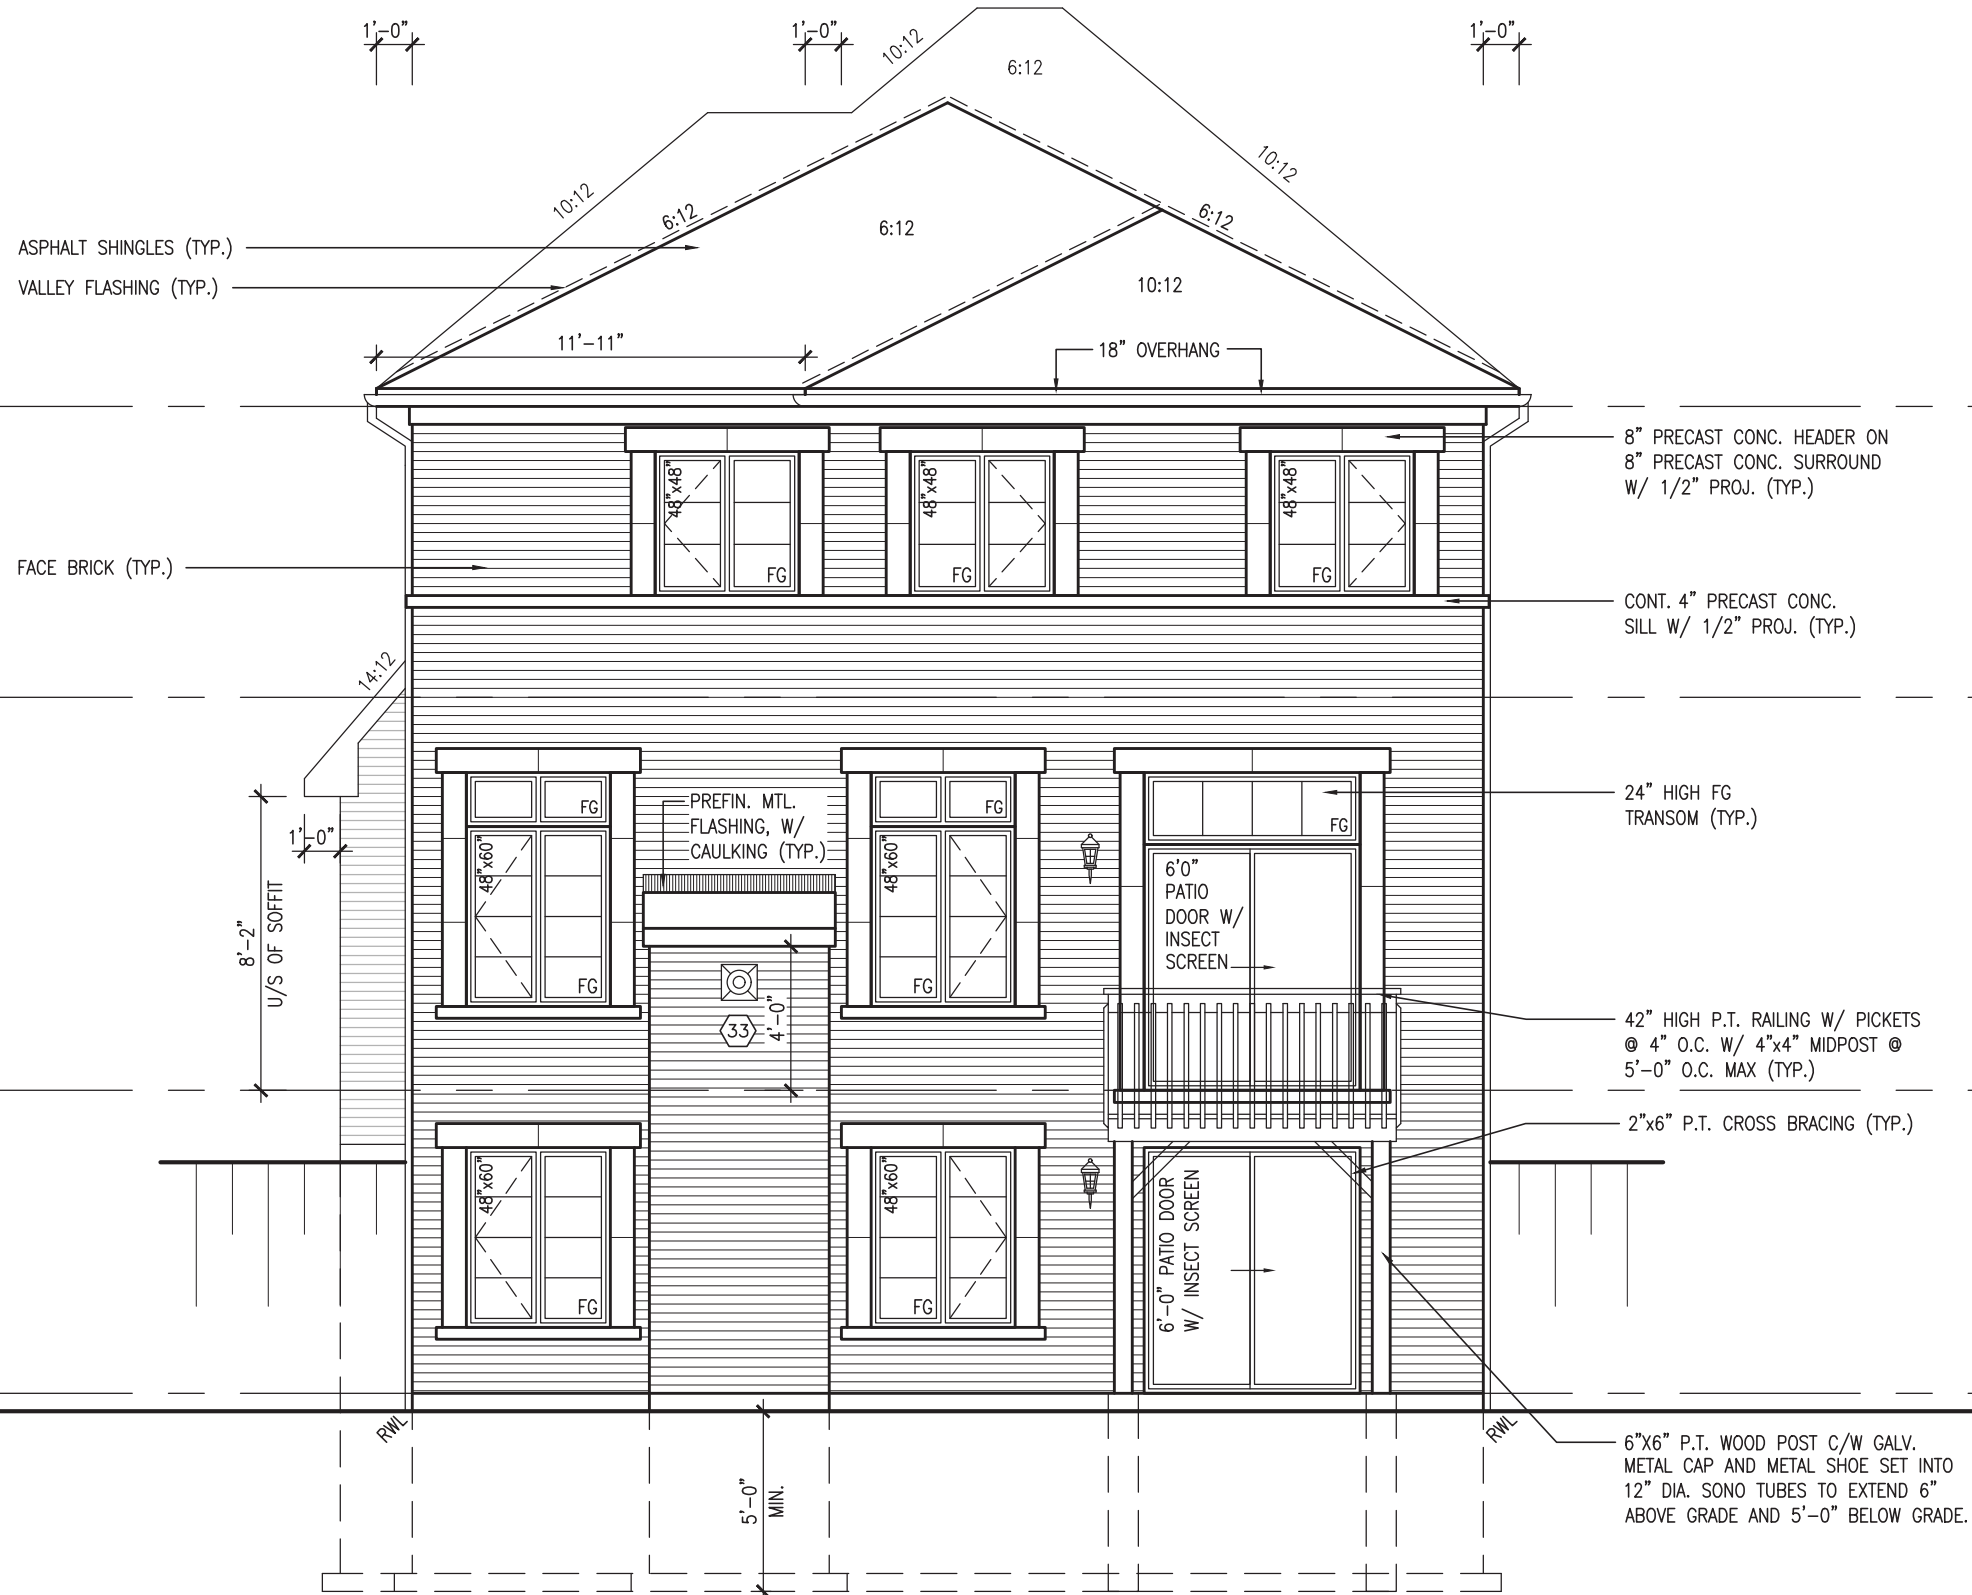

	FIN SECOND FLOOR	FIN GROUND FLOOR	FIN GRADE
TOP OF PLATE			
TOP OF WINDOW	6'-10" (8' SECOND FLR.) 7'-6" (9' SECOND FLR.)	10'-11"	8'-5" (STD. BSM'T) 9'-11" (OPT. BSM'T)
FIN SECOND FLOOR			
TOP OF TRANSOM			
TOP OF WINDOW	1'-6"	7'-4"	
FIN GROUND FLOOR			
TOP OF WINDOW/DOOR			
TOP OF SLAB	6'-10"		
FIN GRADE			

JOHN G. WILLIAMS LTD., ARCHITECT
ARCHITECTURAL CONTROL REVIEW
AND APPROVAL

APPROVED BY: _____

DATE: MAR 03, 2022

This stamp certifies compliance with the applicable Design Guidelines only and bears no further professional responsibility.

[illegible]

10'-0" GROUND FLOOR


REVIEWED



MAR 1, 2022

UNINSULATED OPENINGS (PER OBC. SB-12,3.1.1(7))

S38-19 ELEVATION C REAR UPG WOB		ENERGY EFFICIENCY - OBC SB12		
ELEVATION	WALL AREA S.F.	OPENING S.F.	PERCENTAGE	
FRONT	643 S.F.	178.72 S.F.	27.79 %	
LEFT SIDE	1192 S.F.	85.33 S.F.	7.16 %	
RIGHT SIDE	1200 S.F.	123.89 S.F.	10.32 %	
REAR	831 S.F.	257.24 S.F.	30.96 %	
* OPENINGS OMITTED AS PER SB-12 3.1.1.9(4) MAX 19.9 S.F. REFER TO ELEVATION FOR LOCATION		0.00 S.F.		
TOTAL SQ. FT.	3866.00 S.F.	645.18 S.F.	16.69 %	
TOTAL SQ. M.	359.16 S.M.	59.94 S.M.	16.69 %	

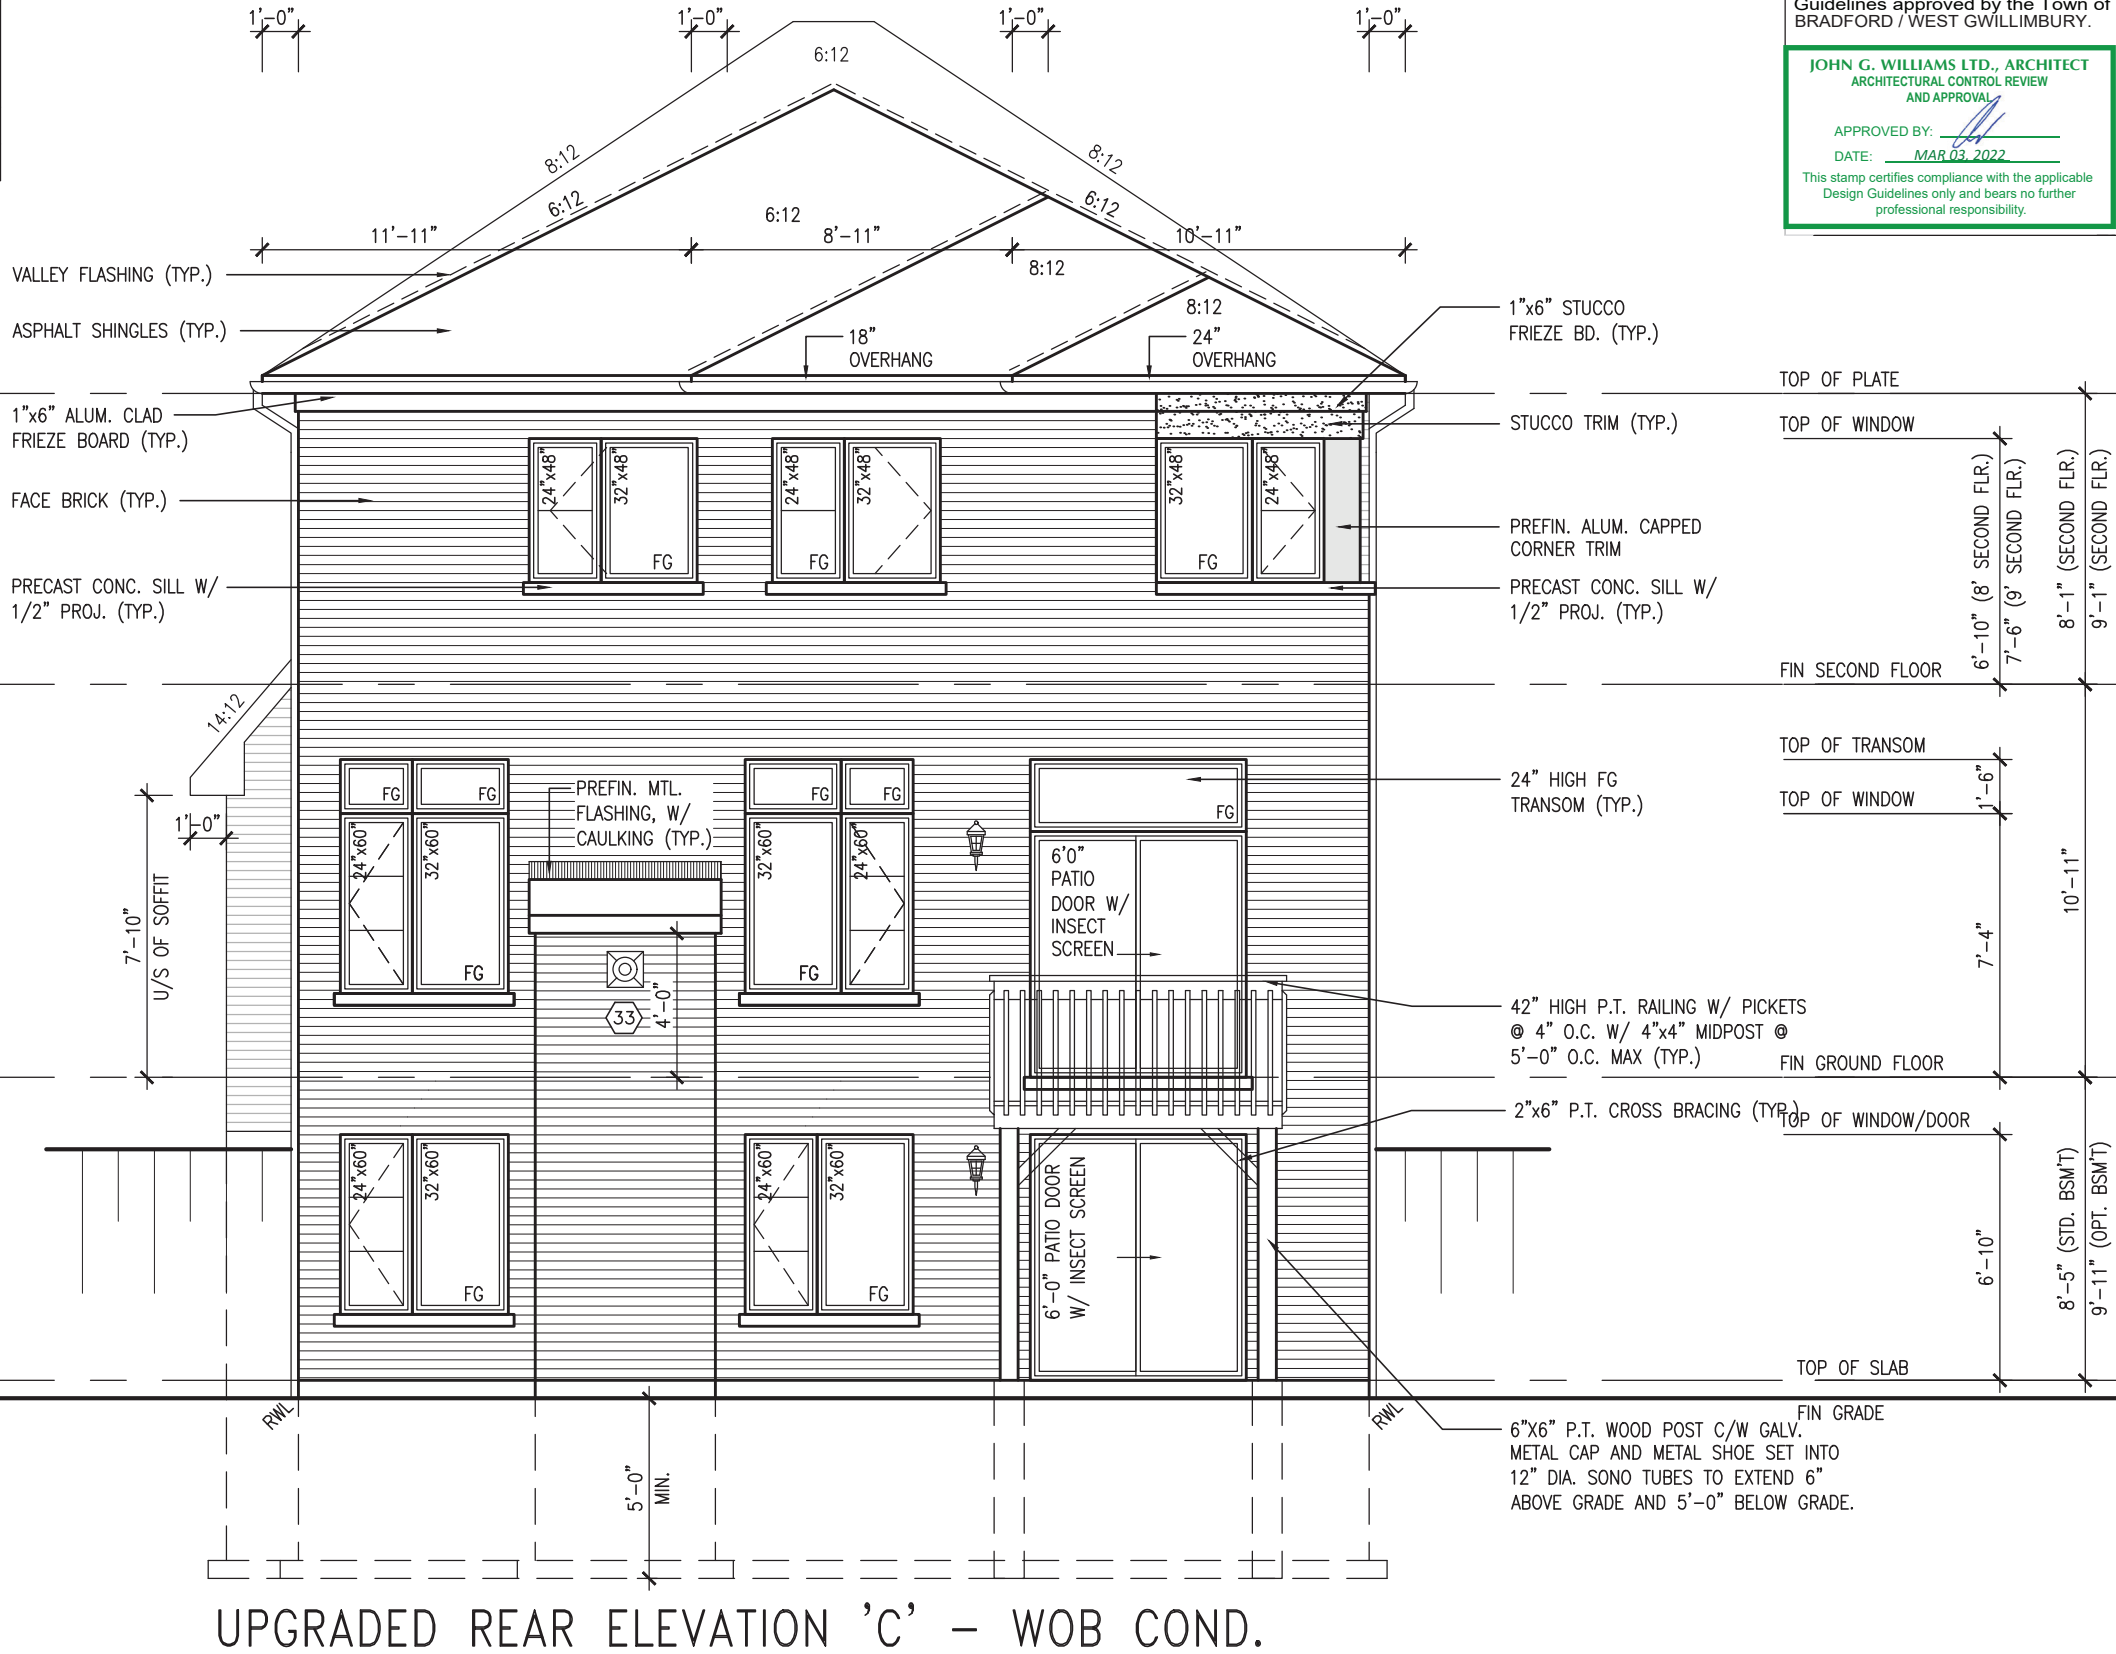

It is the builder's complete responsibility to ensure that all plans submitted for approval fully comply with the Architectural Guidelines and all applicable regulations and requirements including zoning provisions and any provisions in the subdivision agreement. The Control Architect is not responsible in any way for examining or approving site (lotting) plans or working drawings with respect to any zoning or building code or permit matter or that any house can be properly built or located on its lot.

This is to certify that these plans comply with the applicable Architectural Design Guidelines approved by the Town of BRADFORD / WEST GWILLIMBURY.

JOHN G. WILLIAMS LTD., ARCHITECT
ARCHITECTURAL CONTROL REVIEW
AND APPROVAL

APPROVED BY: [Signature]
DATE: MAR 03, 2022

This stamp certifies compliance with the applicable Design Guidelines only and bears no further professional responsibility.

S38-19

BAYVIEW WELLINGTON

GREEN VALLEY EAST

BRADFORD

project no. 16023

drawing no. 51

UPGRADED REAR ELEVATION 'C' - WOB COND.

checked by JMW

down by NS

scale 3/16" = 1'-0"

date OCTOBER 2021

file name 16023-S38-19

date MAR 1, 2022

time 9:33 AM



120 Consumers Rd. Suite 120
Toronto, ON M2J 1R4
t 416.630.2255 f 416.630.4782
va3design.com

The undersigned has reviewed and takes responsibility for this design and has the qualifications and meets the requirements set out in the Ontario Building Code to be a Designer.

qualification information

Wellington Jno-Baptiste 25591 BCN

name registration information VA3 Design Inc. 42658

Contractor must verify all dimensions on the job and report any discrepancy to the Designer before proceeding with the work. All drawings and specifications are instruments of service and the property of the Designer which must be returned at the completion of the work. Drawings are not to be scaled.

no. description

1 ISSUED FOR CLIENT REVIEW

2 REVISED AS PER ENG'S COMMENTS

3 FEB 25-22 RC

4 NOV 26-21 VA3

5 date

6 by

7

8

9

REVIEWED

<u>UNINSULATED OPENINGS</u> (PER OBC. SB-12,3.1.1(7))				
10'-0" GROUND FLOOR & 9'-0" SECOND FL.	S38-19 ELEVATION A/A REAR UPG	ENERGY EFFICIENCY – OBC SB12		
	ELEVATION	WALL AREA S.F.	OPENING S.F.	PERCENTAGE
	FRONT	673 S.F.	121.52 S.F.	18.06 %
	LEFT SIDE	1192 S.F.	92.00 S.F.	7.72 %
	RIGHT SIDE	1190 S.F.	103.33 S.F.	8.68 %
	REAR	654 S.F.	159.67 S.F.	24.41 %
	* OPENINGS OMITTED AS PER SB-12 3.1.1.9(4) MAX 19.9 S.F. REFER TO ELEVATION FOR LOCATION		0.00 S.F.	
	TOTAL SQ. FT.	3709.00 S.F.	476.52 S.F.	12.85 %
	TOTAL SQ. M.	344.57 S.M.	44.27 S.M.	12.85 %
<u>UNINSULATED OPENINGS</u> (PER OBC. SB-12,3.1.1(7))				
10'-0" GROUND FLOOR & 9'-0" SECOND FL.	S38-19 ELEVATION B/B REAR UPG	ENERGY EFFICIENCY – OBC SB12		
	ELEVATION	WALL AREA S.F.	OPENING S.F.	PERCENTAGE
	FRONT	662 S.F.	145.50 S.F.	21.98 %
	LEFT SIDE	1259 S.F.	85.33 S.F.	6.78 %
	RIGHT SIDE	1257 S.F.	108.33 S.F.	8.62 %
	REAR	654 S.F.	159.67 S.F.	24.41 %
	* OPENINGS OMITTED AS PER SB-12 3.1.1.9(4) MAX 19.9 S.F. REFER TO ELEVATION FOR LOCATION		0.00 S.F.	
	TOTAL SQ. FT.	3832.00 S.F.	498.83 S.F.	13.02 %
	TOTAL SQ. M.	356.00 S.M.	46.34 S.M.	13.02 %
<u>UNINSULATED OPENINGS</u> (PER OBC. SB-12,3.1.1(7))				
10'-0" GROUND FLOOR & 9'-0" SECOND FL.	S38-19 ELEVATION C	ENERGY EFFICIENCY – OBC SB12		
	ELEVATION	WALL AREA S.F.	OPENING S.F.	PERCENTAGE
	FRONT	672 S.F.	178.72 S.F.	26.60 %
	LEFT SIDE	1249 S.F.	85.33 S.F.	6.83 %
	RIGHT SIDE	1257 S.F.	123.89 S.F.	9.86 %
	REAR	654 S.F.	159.67 S.F.	24.41 %
	* OPENINGS OMITTED AS PER SB-12 3.1.1.9(4) MAX 19.9 S.F. REFER TO ELEVATION FOR LOCATION		0.00 S.F.	
	TOTAL SQ. FT.	3832.00 S.F.	547.61 S.F.	14.29 %
	TOTAL SQ. M.	356.00 S.M.	50.87 S.M.	14.29 %
<u>UNINSULATED OPENINGS</u> (PER OBC. SB-12,3.1.1(7))				
10'-0" GROUND FLOOR & 9'-0" SECOND FL.	S38-19 ELEVATION C REAR UPG	ENERGY EFFICIENCY – OBC SB12		
	ELEVATION	WALL AREA S.F.	OPENING S.F.	PERCENTAGE
	FRONT	672 S.F.	178.72 S.F.	26.60 %
	LEFT SIDE	1249 S.F.	85.33 S.F.	6.83 %
	RIGHT SIDE	1257 S.F.	123.89 S.F.	9.86 %
	REAR	654 S.F.	176.29 S.F.	26.96 %
	* OPENINGS OMITTED AS PER SB-12 3.1.1.9(4) MAX 19.9 S.F. REFER TO ELEVATION FOR LOCATION		0.00 S.F.	
	TOTAL SQ. FT.	3832.00 S.F.	564.23 S.F.	14.72 %
	TOTAL SQ. M.	356.00 S.M.	52.42 S.M.	14.72 %

<u>UNINSULATED OPENINGS</u> (PER OBC. SB-12,3.1.1(7))				
10'-0" GROUND FLOOR & 9'-0" SECOND FL.	S38-19 ELEVATION A/A REAR UPG WOD	ENERGY EFFICIENCY – OBC SB12		
	ELEVATION	WALL AREA S.F.	OPENING S.F.	PERCENTAGE
	FRONT	673 S.F.	121.52 S.F.	18.06 %
	LEFT SIDE	1192 S.F.	92.00 S.F.	7.72 %
	RIGHT SIDE	1190 S.F.	103.33 S.F.	8.68 %
	REAR	773 S.F.	179.67 S.F.	23.24 %
	* OPENINGS OMITTED AS PER SB-12 3.1.1.9(4) MAX 19.9 S.F. REFER TO ELEVATION FOR LOCATION		0.00 S.F.	
	TOTAL SQ. FT.	3828.00 S.F.	496.52 S.F.	12.97 %
	TOTAL SQ. M.	355.63 S.M.	46.13 S.M.	12.97 %
<u>UNINSULATED OPENINGS</u> (PER OBC. SB-12,3.1.1(7))				
10'-0" GROUND FLOOR & 9'-0" SECOND FL.	S38-19 ELEVATION B/B REAR UPG WOD	ENERGY EFFICIENCY – OBC SB12		
	ELEVATION	WALL AREA S.F.	OPENING S.F.	PERCENTAGE
	FRONT	662 S.F.	145.50 S.F.	21.98 %
	LEFT SIDE	1259 S.F.	85.33 S.F.	6.78 %
	RIGHT SIDE	1257 S.F.	108.33 S.F.	8.62 %
	REAR	773 S.F.	179.67 S.F.	23.24 %
	* OPENINGS OMITTED AS PER SB-12 3.1.1.9(4) MAX 19.9 S.F. REFER TO ELEVATION FOR LOCATION		0.00 S.F.	
	TOTAL SQ. FT.	3951.00 S.F.	518.83 S.F.	13.13 %
	TOTAL SQ. M.	367.06 S.M.	48.20 S.M.	13.13 %
<u>UNINSULATED OPENINGS</u> (PER OBC. SB-12,3.1.1(7))				
10'-0" GROUND FLOOR & 9'-0" SECOND FL.	S38-19 ELEVATION C WOD	ENERGY EFFICIENCY – OBC SB12		
	ELEVATION	WALL AREA S.F.	OPENING S.F.	PERCENTAGE
	FRONT	672 S.F.	178.72 S.F.	26.60 %
	LEFT SIDE	1249 S.F.	85.33 S.F.	6.83 %
	RIGHT SIDE	1257 S.F.	123.89 S.F.	9.86 %
	REAR	773 S.F.	179.67 S.F.	23.24 %
	* OPENINGS OMITTED AS PER SB-12 3.1.1.9(4) MAX 19.9 S.F. REFER TO ELEVATION FOR LOCATION		0.00 S.F.	
	TOTAL SQ. FT.	3951.00 S.F.	567.61 S.F.	14.37 %
	TOTAL SQ. M.	367.06 S.M.	52.73 S.M.	14.37 %
<u>UNINSULATED OPENINGS</u> (PER OBC. SB-12,3.1.1(7))				
10'-0" GROUND FLOOR & 9'-0" SECOND FL.	S38-19 ELEVATION C REAR UPG WOD	ENERGY EFFICIENCY – OBC SB12		
	ELEVATION	WALL AREA S.F.	OPENING S.F.	PERCENTAGE
	FRONT	672 S.F.	178.72 S.F.	26.60 %
	LEFT SIDE	1249 S.F.	85.33 S.F.	6.83 %
	RIGHT SIDE	1257 S.F.	123.89 S.F.	9.86 %
	REAR	773 S.F.	194.73 S.F.	25.19 %
	* OPENINGS OMITTED AS PER SB-12 3.1.1.9(4) MAX 19.9 S.F. REFER TO ELEVATION FOR LOCATION		0.00 S.F.	
	TOTAL SQ. FT.	3951.00 S.F.	582.67 S.F.	14.75 %
	TOTAL SQ. M.	367.06 S.M.	54.13 S.M.	14.75 %

<u>UNINSULATED OPENINGS</u> (PER OBC. SB-12,3.1.1(7))				
10'-0" GROUND FLOOR & 9'-0" SECOND FL.	S38-19 ELEVATION A/A REAR UPG WOB	ENERGY EFFICIENCY – OBC SB12		
	ELEVATION	WALL AREA S.F.	OPENING S.F.	PERCENTAGE
	FRONT	673 S.F.	121.52 S.F.	18.06 %
	LEFT SIDE	1192 S.F.	92.00 S.F.	7.72 %
	RIGHT SIDE	1190 S.F.	103.33 S.F.	8.68 %
	REAR	860 S.F.	234.00 S.F.	27.21 %
	* OPENINGS OMITTED AS PER SB-12 3.1.1.9(4) MAX 19.9 S.F. REFER TO ELEVATION FOR LOCATION		0.00 S.F.	
	TOTAL SQ. FT.	3915.00 S.F.	550.85 S.F.	14.07 %
	TOTAL SQ. M.	363.71 S.M.	51.18 S.M.	14.07 %
<u>UNINSULATED OPENINGS</u> (PER OBC. SB-12,3.1.1(7))				
10'-0" GROUND FLOOR & 9'-0" SECOND FL.	S38-19 ELEVATION B/B REAR UPG WOB	ENERGY EFFICIENCY – OBC SB12		
	ELEVATION	WALL AREA S.F.	OPENING S.F.	PERCENTAGE
	FRONT	662 S.F.	145.50 S.F.	21.98 %
	LEFT SIDE	1259 S.F.	85.33 S.F.	6.78 %
	RIGHT SIDE	1257 S.F.	108.33 S.F.	8.62 %
	REAR	860 S.F.	234.00 S.F.	27.21 %
	* OPENINGS OMITTED AS PER SB-12 3.1.1.9(4) MAX 19.9 S.F. REFER TO ELEVATION FOR LOCATION		0.00 S.F.	
	TOTAL SQ. FT.	4038.00 S.F.	573.16 S.F.	14.19 %
	TOTAL SQ. M.	375.14 S.M.	53.25 S.M.	14.19 %
<u>UNINSULATED OPENINGS</u> (PER OBC. SB-12,3.1.1(7))				
10'-0" GROUND FLOOR & 9'-0" SECOND FL.	S38-19 ELEVATION C WOB	ENERGY EFFICIENCY – OBC SB12		
	ELEVATION	WALL AREA S.F.	OPENING S.F.	PERCENTAGE
	FRONT	672 S.F.	178.72 S.F.	26.60 %
	LEFT SIDE	1249 S.F.	85.33 S.F.	6.83 %
	RIGHT SIDE	1257 S.F.	123.89 S.F.	9.86 %
	REAR	860 S.F.	234.00 S.F.	27.21 %
	* OPENINGS OMITTED AS PER SB-12 3.1.1.9(4) MAX 19.9 S.F. REFER TO ELEVATION FOR LOCATION		0.00 S.F.	
	TOTAL SQ. FT.	4038.00 S.F.	621.94 S.F.	15.40 %
	TOTAL SQ. M.	375.14 S.M.	57.78 S.M.	15.40 %
<u>UNINSULATED OPENINGS</u> (PER OBC. SB-12,3.1.1(7))				
10'-0" GROUND FLOOR & 9'-0" SECOND FL.	S38-19 ELEVATION C REAR UPG WOB	ENERGY EFFICIENCY – OBC SB12		
	ELEVATION	WALL AREA S.F.	OPENING S.F.	PERCENTAGE
	FRONT	672 S.F.	178.72 S.F.	26.60 %
	LEFT SIDE	1249 S.F.	85.33 S.F.	6.83 %
	RIGHT SIDE	1257 S.F.	123.89 S.F.	9.86 %
	REAR	860 S.F.	257.24 S.F.	29.91 %
	* OPENINGS OMITTED AS PER SB-12 3.1.1.9(4) MAX 19.9 S.F. REFER TO ELEVATION FOR LOCATION		0.00 S.F.	
	TOTAL SQ. FT.	4038.00 S.F.	645.18 S.F.	15.98 %
	TOTAL SQ. M.	375.14 S.M.	59.94 S.M.	15.98 %

6. Floorboards

[illegible]


REVIEWED

UNINSULATED OPENINGS (PER OBC. SB-12,3.1.1(7))				
10'-0" GROUND FLOOR & 9'-0" BASEMENT	S38-19 ELEVATION A/A REAR UPG WOB	ENERGY EFFICIENCY – OBC SB12		
	ELEVATION	WALL AREA S.F.	OPENING S.F.	PERCENTAGE
	FRONT	644 S.F.	121.52 S.F.	18.87 %
	LEFT SIDE	1192 S.F.	92.00 S.F.	7.72 %
	RIGHT SIDE	1190 S.F.	103.33 S.F.	8.68 %
	REAR	860 S.F.	234.00 S.F.	27.21 %
	* OPENINGS OMITTED AS PER SB-12 3.1.1.9(4) MAX 19.9 S.F. REFER TO ELEVATION FOR LOCATION		0.00 S.F.	
	TOTAL SQ. FT.	3886.00 S.F.	550.85 S.F.	14.18 %
	TOTAL SQ. M.	361.02 S.M.	51.18 S.M.	14.18 %
UNINSULATED OPENINGS (PER OBC. SB-12,3.1.1(7))				
10'-0" GROUND FLOOR & 9'-0" BASEMENT	S38-19 ELEVATION B/B REAR UPG WOB	ENERGY EFFICIENCY – OBC SB12		
	ELEVATION	WALL AREA S.F.	OPENING S.F.	PERCENTAGE
	FRONT	632 S.F.	145.50 S.F.	23.02 %
	LEFT SIDE	1201 S.F.	85.33 S.F.	7.10 %
	RIGHT SIDE	1198 S.F.	108.33 S.F.	9.04 %
	REAR	860 S.F.	234.00 S.F.	27.21 %
	* OPENINGS OMITTED AS PER SB-12 3.1.1.9(4) MAX 19.9 S.F. REFER TO ELEVATION FOR LOCATION		0.00 S.F.	
	TOTAL SQ. FT.	3891.00 S.F.	573.16 S.F.	14.73 %
	TOTAL SQ. M.	361.48 S.M.	53.25 S.M.	14.73 %
UNINSULATED OPENINGS (PER OBC. SB-12,3.1.1(7))				
10'-0" GROUND FLOOR & 9'-0" BASEMENT	S38-19 ELEVATION C WOB	ENERGY EFFICIENCY – OBC SB12		
	ELEVATION	WALL AREA S.F.	OPENING S.F.	PERCENTAGE
	FRONT	643 S.F.	178.72 S.F.	27.79 %
	LEFT SIDE	1192 S.F.	85.33 S.F.	7.16 %
	RIGHT SIDE	1200 S.F.	123.89 S.F.	10.32 %
	REAR	860 S.F.	234.00 S.F.	27.21 %
	* OPENINGS OMITTED AS PER SB-12 3.1.1.9(4) MAX 19.9 S.F. REFER TO ELEVATION FOR LOCATION		0.00 S.F.	
	TOTAL SQ. FT.	3895.00 S.F.	621.94 S.F.	15.97 %
	TOTAL SQ. M.	361.85 S.M.	57.78 S.M.	15.97 %
UNINSULATED OPENINGS (PER OBC. SB-12,3.1.1(7))				
10'-0" GROUND FLOOR & 9'-0" BASEMENT	S38-19 ELEVATION C REAR UPG WOB	ENERGY EFFICIENCY – OBC SB12		
	ELEVATION	WALL AREA S.F.	OPENING S.F.	PERCENTAGE
	FRONT	643 S.F.	178.72 S.F.	27.79 %
	LEFT SIDE	1192 S.F.	85.33 S.F.	7.16 %
	RIGHT SIDE	1200 S.F.	123.89 S.F.	10.32 %
	REAR	860 S.F.	257.24 S.F.	29.91 %
	* OPENINGS OMITTED AS PER SB-12 3.1.1.9(4) MAX 19.9 S.F. REFER TO ELEVATION FOR LOCATION		0.00 S.F.	
	TOTAL SQ. FT.	3895.00 S.F.	645.18 S.F.	16.56 %
	TOTAL SQ. M.	361.85 S.M.	59.94 S.M.	16.56 %

UNINSULATED OPENINGS (PER OBC. SB-12,3.1.1(7))					
10'-0" GRD FL., 9'-0" SEC. FL. & 9'-0" BASEMENT FL.	S38-19 ELEVATION A/A REAR UPG WOB		ENERGY EFFICIENCY – OBC SB12		
	ELEVATION	WALL AREA S.F.	OPENING S.F.	PERCENTAGE	
	FRONT	673 S.F.	121.52 S.F.	18.06 %	
	LEFT SIDE	1192 S.F.	92.00 S.F.	7.72 %	
	RIGHT SIDE	1190 S.F.	103.33 S.F.	8.68 %	
	REAR	890 S.F.	234.00 S.F.	26.29 %	
	* OPENINGS OMITTED AS PER SB-12 3.1.1.9(4) MAX 19.9 S.F. REFER TO ELEVATION FOR LOCATION		0.00 S.F.		
	TOTAL SQ. FT.	3945.00 S.F.	550.85 S.F.	13.96 %	
	TOTAL SQ. M.	366.50 S.M.	51.18 S.M.	13.96 %	
UNINSULATED OPENINGS (PER OBC. SB-12,3.1.1(7))					
10'-0" GRD FL., 9'-0" SEC. FL. & 9'-0" BASEMENT FL.	S38-19 ELEVATION B/B REAR UPG WOB		ENERGY EFFICIENCY – OBC SB12		
	ELEVATION	WALL AREA S.F.	OPENING S.F.	PERCENTAGE	
	FRONT	662 S.F.	145.50 S.F.	21.98 %	
	LEFT SIDE	1259 S.F.	85.33 S.F.	6.78 %	
	RIGHT SIDE	1257 S.F.	108.33 S.F.	8.62 %	
	REAR	890 S.F.	234.00 S.F.	26.29 %	
	* OPENINGS OMITTED AS PER SB-12 3.1.1.9(4) MAX 19.9 S.F. REFER TO ELEVATION FOR LOCATION		0.00 S.F.		
	TOTAL SQ. FT.	4068.00 S.F.	573.16 S.F.	14.09 %	
	TOTAL SQ. M.	377.93 S.M.	53.25 S.M.	14.09 %	
UNINSULATED OPENINGS (PER OBC. SB-12,3.1.1(7))					
10'-0" GRD FL., 9'-0" SEC. FL. & 9'-0" BASEMENT FL.	S38-19 ELEVATION C WOB		ENERGY EFFICIENCY – OBC SB12		
	ELEVATION	WALL AREA S.F.	OPENING S.F.	PERCENTAGE	
	FRONT	672 S.F.	178.72 S.F.	26.60 %	
	LEFT SIDE	1249 S.F.	85.33 S.F.	6.83 %	
	RIGHT SIDE	1257 S.F.	123.89 S.F.	9.86 %	
	REAR	890 S.F.	234.00 S.F.	26.29 %	
	* OPENINGS OMITTED AS PER SB-12 3.1.1.9(4) MAX 19.9 S.F. REFER TO ELEVATION FOR LOCATION		0.00 S.F.		
	TOTAL SQ. FT.	4068.00 S.F.	621.94 S.F.	15.29 %	
	TOTAL SQ. M.	377.93 S.M.	57.78 S.M.	15.29 %	
UNINSULATED OPENINGS (PER OBC. SB-12,3.1.1(7))					
10'-0" GRD FL., 9'-0" SEC. FL. & 9'-0" BASEMENT FL.	S38-19 ELEVATION C REAR UPG WOB		ENERGY EFFICIENCY – OBC SB12		
	ELEVATION	WALL AREA S.F.	OPENING S.F.	PERCENTAGE	
	FRONT	672 S.F.	178.72 S.F.	26.60 %	
	LEFT SIDE	1249 S.F.	85.33 S.F.	6.83 %	
	RIGHT SIDE	1257 S.F.	123.89 S.F.	9.86 %	
	REAR	890 S.F.	257.24 S.F.	28.90 %	
	* OPENINGS OMITTED AS PER SB-12 3.1.1.9(4) MAX 19.9 S.F. REFER TO ELEVATION FOR LOCATION		0.00 S.F.		
	TOTAL SQ. FT.	4068.00 S.F.	645.18 S.F.	15.86 %	
	TOTAL SQ. M.	377.93 S.M.	59.94 S.M.	15.86 %	

9	.	.	.	The undersigned has reviewed and takes responsibility for this design and has the qualifications and meets the requirements set out in the Ontario Building Code to be a Designer.
8	.	.	.	qualification information
7	.	.	.	
6	.	.	.	Wellington Jno-Baptiste 25591
5	.	.	.	name
4	.	.	.	registration information
3	.	.	.	VA3 Design Inc. 42558
2	REVISED AS PER ENG'S COMMENTS	FEB 25-22	RC	Contractor must verify all dimensions on the job and report any discrepancy to the Designer before proceeding with the work. All drawings and specifications are instruments of service and the property of the Designer. Drawings must be returned at the completion of the work. Drawings are not to be scaled.
1	ISSUED FOR CLIENT REVIEW	NOV 26-21	VA3	
no.	description	date	by	

FOR 9 1/2" JOIST DEPTH

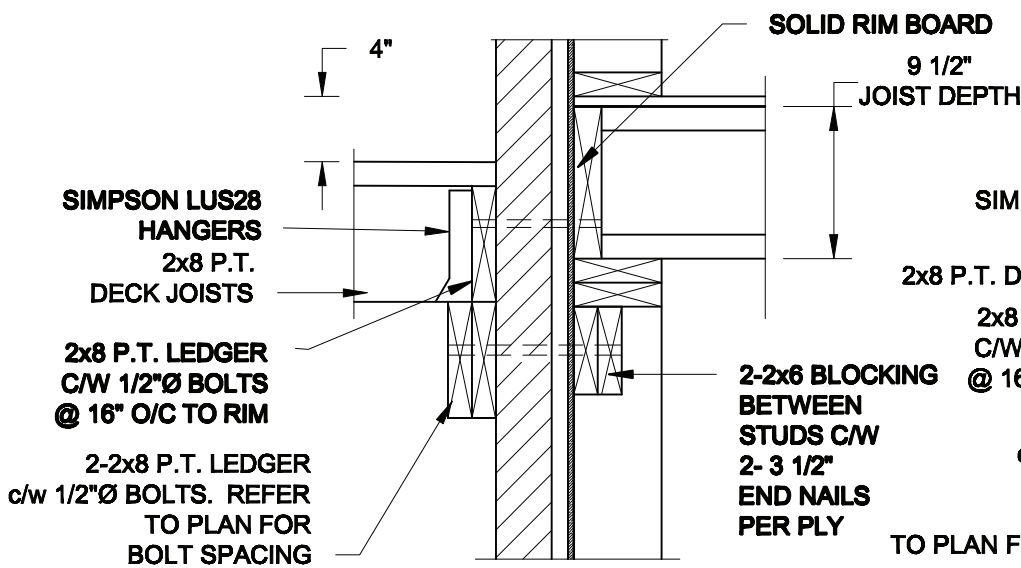

1A
S2

DECK FASTENING DETAIL


SCALE: 1" = 1'-0"

1B
S2

DECK FASTENING DETAIL

SCALE: 1" = 1'-0"


FOR 11 7/8" JOIST DEPTH

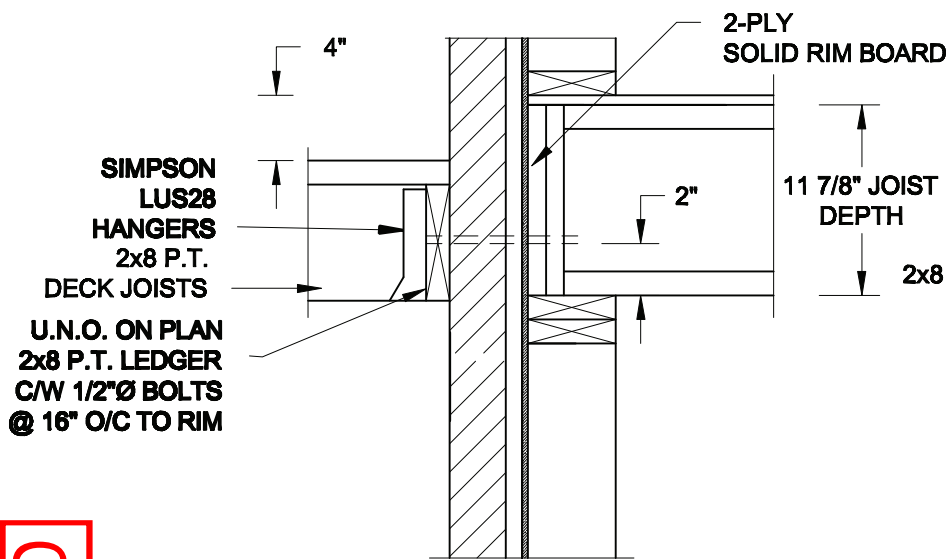

1C
S2

DECK FASTENING DETAIL

SCALE: 1" = 1'-0"

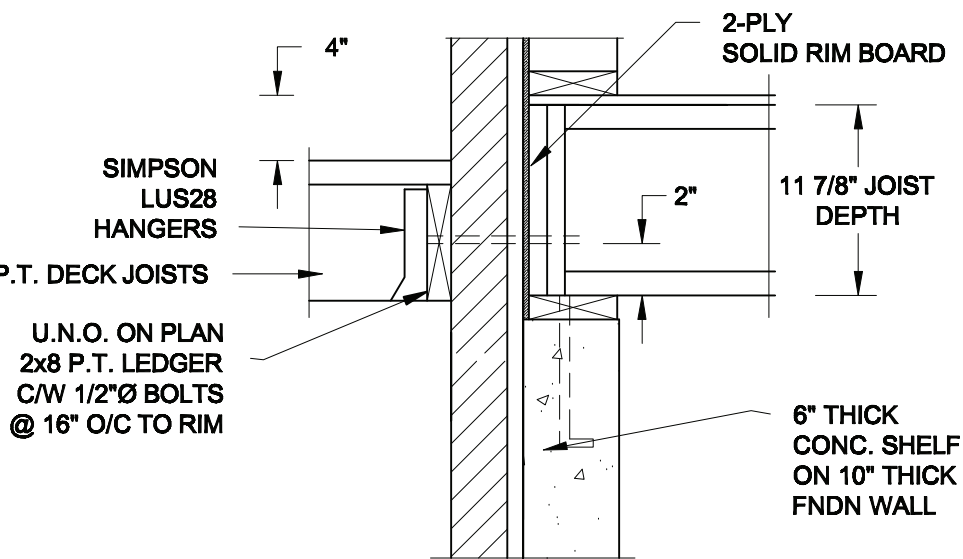


1D
S2

DECK FASTENING DETAIL

SCALE: 1" = 1'-0"

- NOTE: 1. WHERE BACKFILL HEIGHT < 4'-7", PROVIDE 2x6 @ 16" o/c KNEEWALL ON 10" THICK CONC FNDN WALL
2. WHERE BACKFILL HEIGHT > 4'-7", PROVIDE 6" CONC SHELF FOR BRICK VENEER ON 10" THICK CONC FNDN WALL
3. FOOTING TO BE 22"x6" THICK UNLESS NOTED OTHERWISE ON PLAN.

FOR 9 1/2" JOIST DEPTH

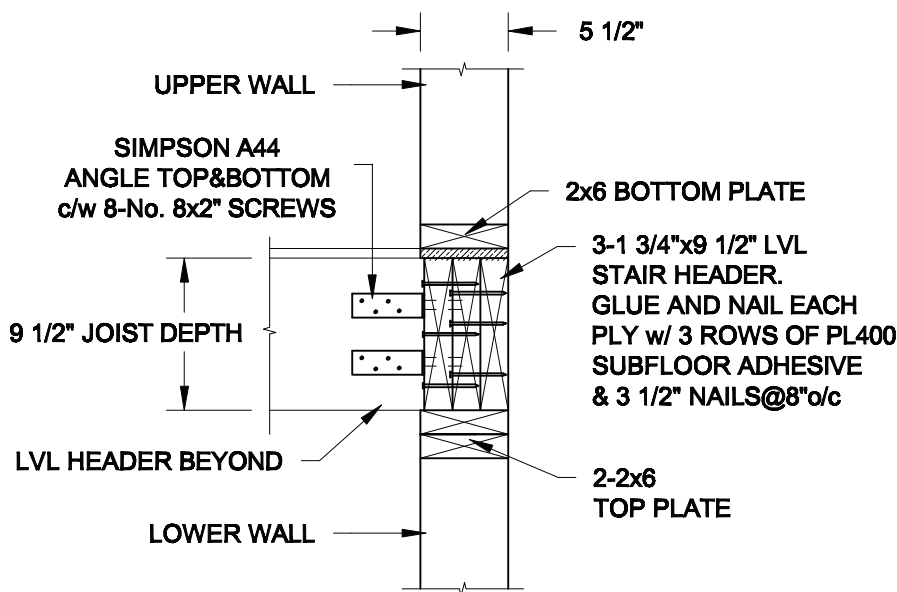


2A
S2

STAIR HEADER

SCALE: 1" = 1'-0"

FOR 11 7/8" JOIST DEPTH

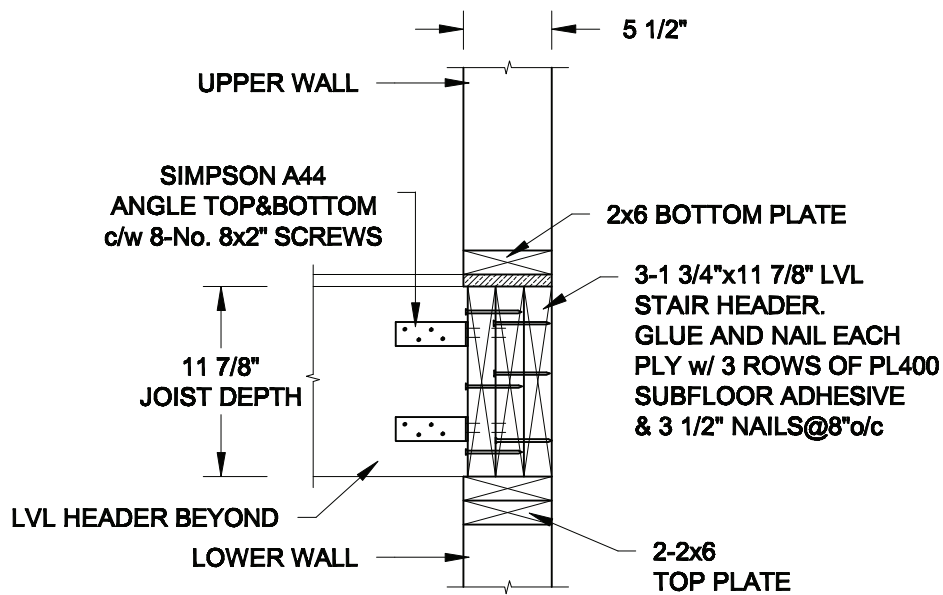

2B
S2

STAIR HEADER

SCALE: 1" = 1'-0"

Scale:
AS NOTED

Date:
MAR-15-2021

Drawn:
SC

Checked:
SJB

QUAILE ENGINEERING LTD.



38 Parkside Drive, UNIT 7
Newmarket, ON
L3Y 8J9
T: 905-853-8547
E: quaille.eng@rogers.com

Engineer's Seal



MAR 30, 2021

Project:

BAYVIEW WELLINGTON HOMES - GREEN VALLEY ESTATES - SINGLES
BRADFORD, ONTARIO


TYPICAL STRUCTURAL DETAILS

Project No.:


21-038

Drawing No.:

S2

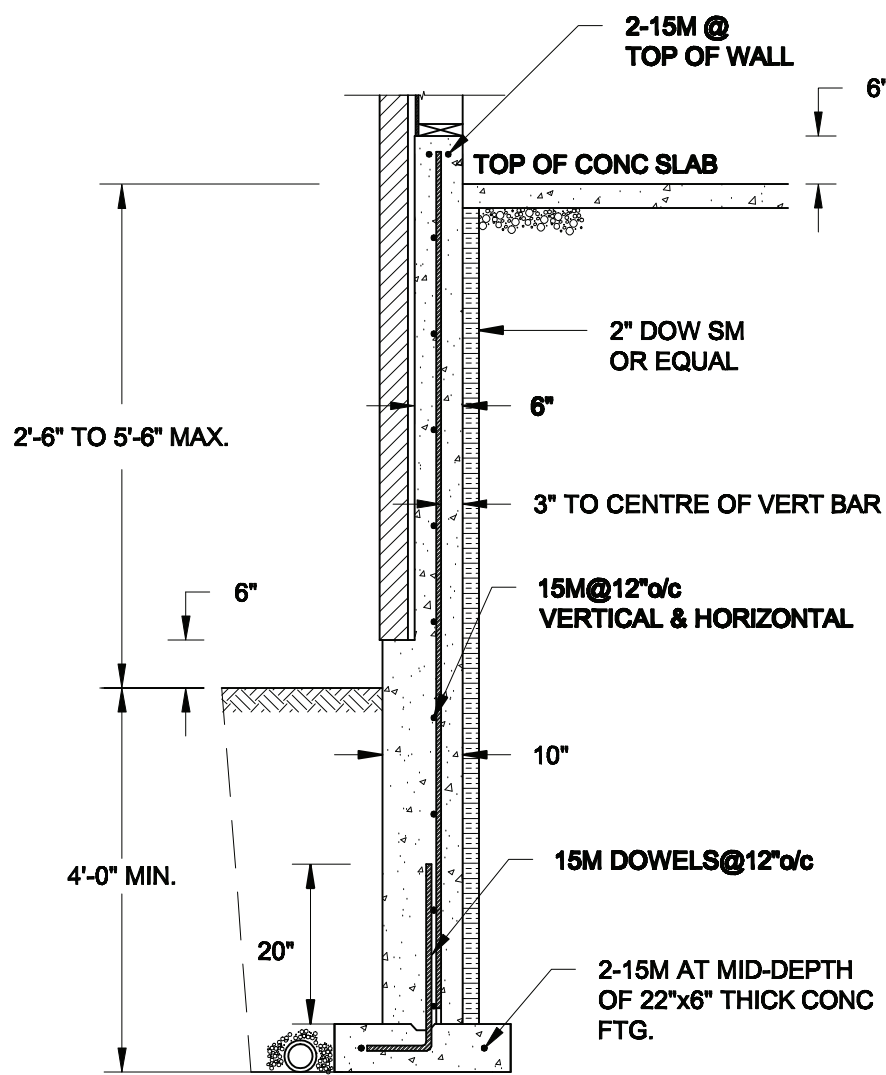


1A **REINFORCED BRICKSHELF**
S3 SCALE: 1/2" = 1' - 0"

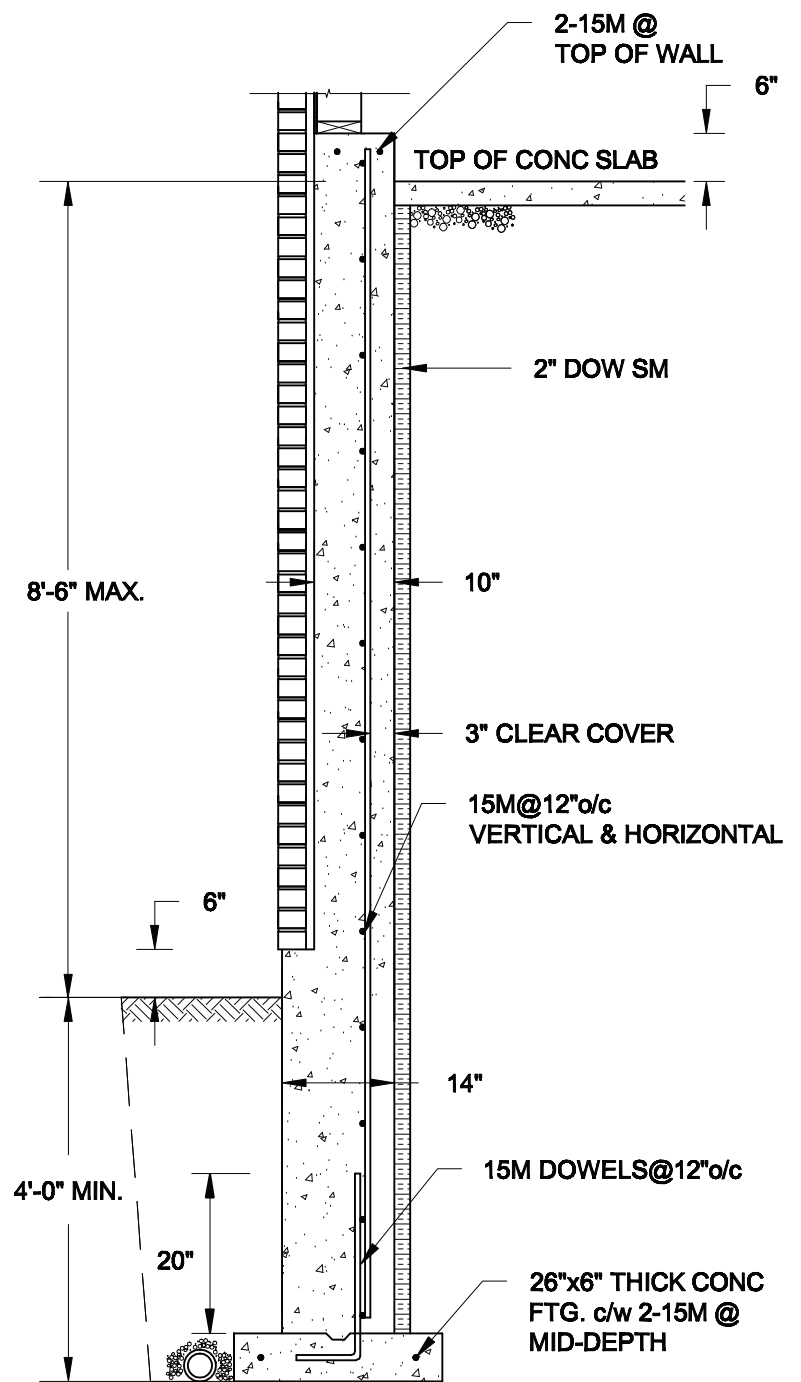

1B REINFORCED BRICKSHELF


S3 SCALE: 1/2" = 1' - 0"

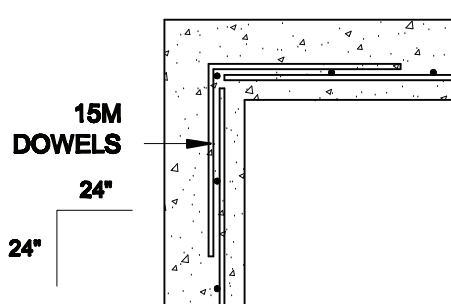

1C
S3 **PLAN VIEW AT CORNER**
SCALE: 1/2" = 1' - 0"

NOTES:

- 1. CONFORM TO THE ONTARIO BUILDING CODE, 2012.**
- 2. CONCRETE TO HAVE A 28-DAY COMPRESSIVE STRENGTH OF 20 MPa.**
- 3. REINFORCING STEEL TO BE GRADE 400.**
- 4. LAP REINFORCING STEEL 24" AT SPLICES. PROVIDE 24"x24" L-SHAPE BARS AT ALL CORNERS - SEE DETAIL 1C/S3.**
- 5. PROVIDE 3" COVER TO SOIL MINIMUM.**
- 6. BACKFILL ASSUMED TO BE FREE-DRAINING MATERIAL AS PER PART 9 OF THE OBC.**

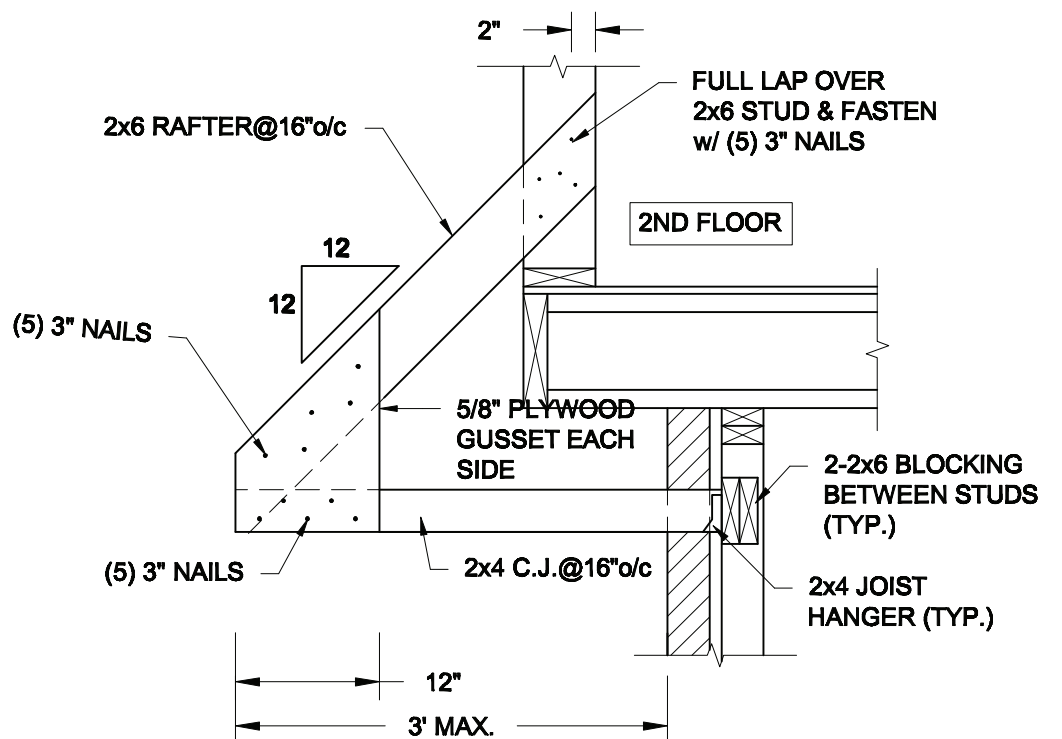

2
S3 **CANOPY ROOF OVER GARAGE**
SCALE: 3/4" = 1'-0"

Scale:
AS NOTED

Date:
FEB-24-2022

Drawn: SC	Checked: SJB
----------------------------	-------------------------------

QUAILE ENGINEERING LTD.



Engineer's Seat:



FEB 24, 2022

Project:

BAYVIEW WELLINGTON HOMES - GREEN VALLEY ESTATES - SINGLES
BRADFORD, ONTARIO

TYPICAL STRUCTURAL DETAILS


Project No.:

21-038


Drawing No.:

S3


REVIEWED

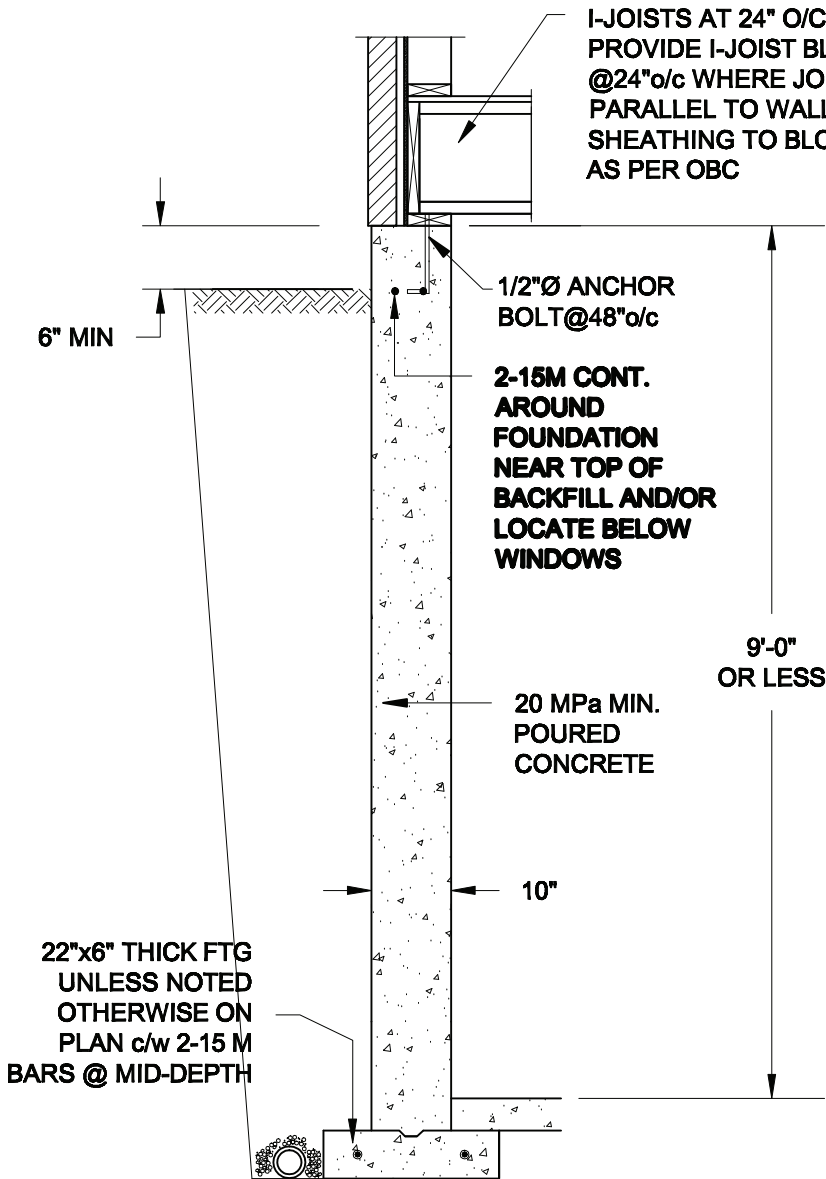

1A FOUNDATION WALL
S4 SCALE: 1/2" = 1'-0"

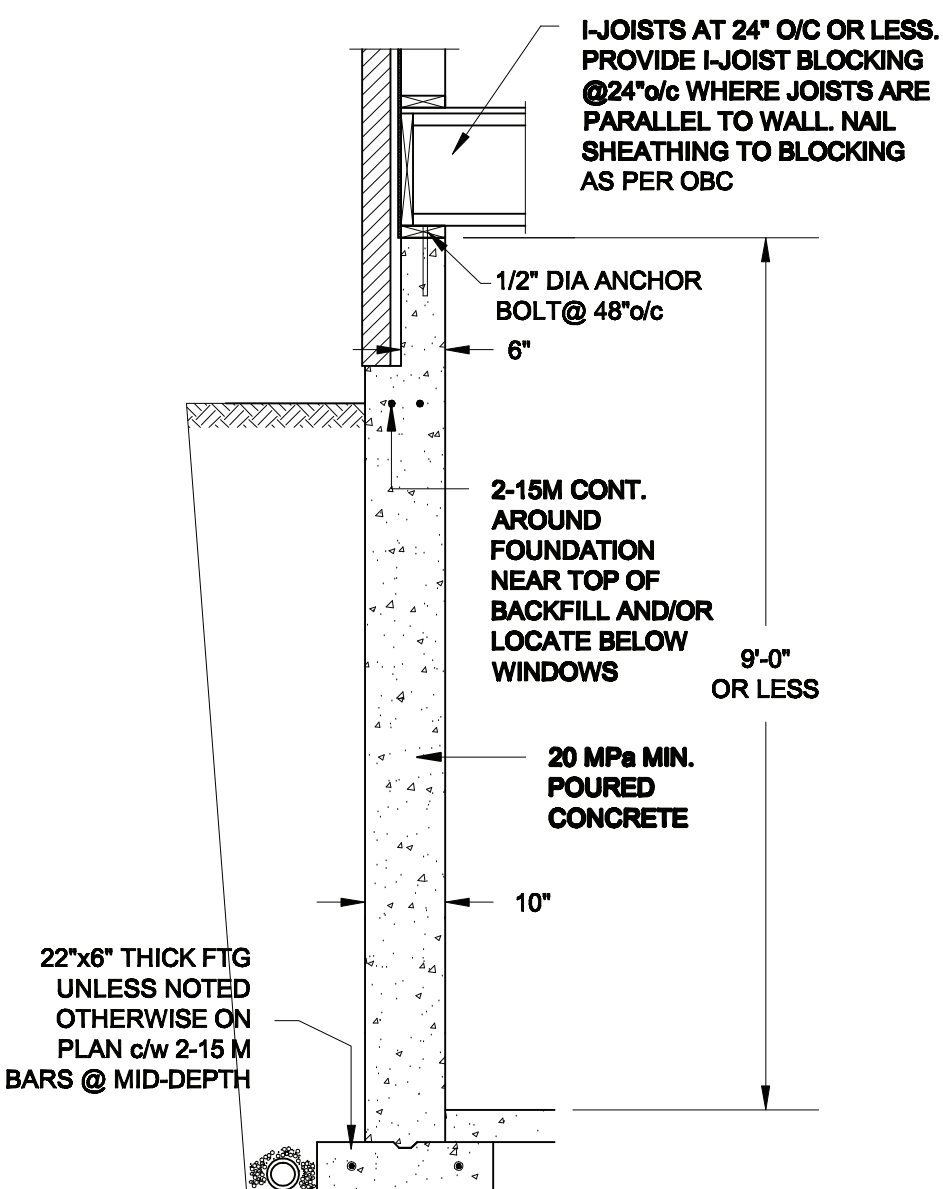

1B DROPPED VENEER
S4 SCALE: 1/2" = 1'-0"

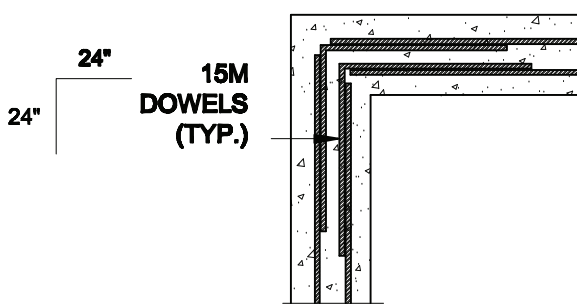



1C TYP. PLAN VIEW AT CORNER
S4 SCALE: 1/2" = 1'-0"

NOTE:
AT ALL WINDOW OPENINGS,
PROVIDE 2-15M VERTICALLY
AT EACH SIDE + 2-15M
HORIZONTALLY 2" BELOW &
EXTEND 24" BEYOND OPENING

NOTES:

1. CONFORM TO THE ONTARIO BUILDING CODE, 2012.
2. CONCRETE TO HAVE A 28 DAY COMPRESSIVE STRENGTH OF 20 MPa.
3. REINFORCING STEEL TO BE GRADE 400.
4. LAP REINFORCING STEEL 24" AT SPLICES. PROVIDE 24"x24" L-SHAPE BARS AT ALL CORNERS - SEE DETAIL 1C/S4.
5. BACKFILL ASSUMED TO BE FREE-DRAINING MATERIAL AS PER PART 9 OF THE OBC.
6. FOUNDATION IS FOR A PART 9 RESIDENTIAL BUILDING.
7. DETAIL IS APPLICABLE TO SITE CLASSES A TO D ONLY AS GIVEN IN TABLE 4.1.8.4.A OF THE OBC (TO BE CONFIRMED BY GEOTECHNICAL ENGINEER).

Scale: AS NOTED	<div>QUAILE ENGINEERING LTD.</div> <div></div> <div>38 Parkside Drive, UNIT 7 Newmarket, ON L3Y 8J9 T: 905-853-8547 E: quaile.eng@rogers.com</div>	Engineer's Seal  MAR 30, 2021	Project: BAYVIEW WELLINGTON HOMES - GREEN VALLEY ESTATES - SINGLES BRADFORD, ONTARIO
Date: MAR-15-2021			TYPICAL STRUCTURAL DETAILS
Drawn: SC		Project No.: 21-038	Drawing No.: S4

CONSTRUCTION NOTES (Unless otherwise noted)

ALL CONSTRUCTION TO ADHERE TO THESE PLANS AND SPEC'S AND TO CONFORM TO THE ONTARIO BUILDING CODE AND ALL OTHER APPLICABLE CODES AND AUTHORITIES HAVING JURISDICTION. THESE REQUIREMENTS ARE TO BE TAKEN AS MINIMUM SPECIFICATIONS. ONT. REG. 332/12-2012 OBC

1. **ROOF CONSTRUCTION**
NO.210 (10.25kg/m2) ASPHALT SHINGLES, 10mm (3/8") PLYWOOD SHEATHING WITH "H" CLIPS. APPROVED WOOD TRUSSES @ 600mm (24") O.C. MAX. APPROVED EAVES PROTECTION TO EXTEND 900mm (3'0") FROM EDGE OF ROOF AND MIN. 300mm (12") BEYOND INNER FACE OF EXTERIOR WALL. [EAVES PROTECTION NOT REQ'D FOR ROOF SLOPES 8:12 OR GREATER] 38x89 (2"x4") TRUSS BRACING @ 1830mm (6'-0") O.C. AT BOTTOM CHORD. PREFIN. ALUM. EAVESTROUGH, FASCIA, RVL & VENTED SOFFIT. PROVIDE ICE & WATER SHIELD TO ALL ROOF/WALL SURFACES SUSCEPTIBLE TO ICE DAMMING. ROOF SHEATHING TO BE FASTENED 150 (6") c/c ALONG EDGES & INTERMEDIATE SUPPORTS WHEN TRUSSES SPACED GREATER THAN 406 (16"). ATTIC VENTILATION 1:300 OF INSULATED CEILING AREA WITH MIN. 25% AT EAVES & MIN. 25% AT RIDGE [OBC 9.19.1.2.]. ENSURE ALL OVERLAPPING ROOF SPACES ARE OPEN TO MAIN ROOF ATTIC SPACE FOR VENTING PURPOSES.

2. **FRAME WALL CONSTRUCTION (2"x6") (SB-12-TABLE 3.1.1.2.A)**
SIDING AS PER ELEV., 19x38 (1"x2") VERTICAL WOOD FURRING, CONTIN. SHEATHING MEMBRANE, 9.5mm (3/8") EXT. TYPE SHEATHING, 38x140 (2"x6") STUDS @ 400mm (16") O.C. RSI 3.87 (R22) INSULATION AND APPR. VAPOUR BARRIER AND APPR. CONTIN. AIR BARRIER, 13mm (1/2") INT. DRYWALL FINISH. SIDING TO BE MIN. 200mm (8") ABOVE FINISH GRADE. REFER TO OBC SB-12, CHAPTER 3 FOR ADDITIONAL THERMAL INSULATION REQUIREMENTS.

2A. RESERVED

2B. **FRAME WALL CONSTRUCTION (2"x4")- GARAGE WALLS**
SIDING AS PER ELEV., 19x38 (1"x2") VERTICAL WOOD FURRING, CONTIN. SHEATHING MEMBRANE, 9.5mm (3/8") EXT. TYPE SHEATHING, 38x89 (2"x4") STUDS @ 400mm (16") O.C. (MAX. HEIGHT 3000mm (9'-10"), WITH APPR. DIAGONAL WALL BRACING. SIDING TO BE MIN. 200mm (8") ABOVE FINISH GRADE.

2C. RESERVED

2D. **STUCCO WALL CONSTRUCTION (2"x4")-GARAGE WALLS**
STUCCO CLADDING SYSTEM CONFORMING TO O.B.C. 9.27.1.1.(2) & 9.28 THAT EMPLOY A MINIMUM 10mm AIR SPACE BEHIND THE CLADDING WITH POSITIVE DRAINAGE TO THE EXTERIOR AND APPLIED PER MANUFACTURERS SPECIFICATIONS OVER 25mm (1") MIN. EXPANDED OR EXTRUDED RIGID POLYSTYRENE ON APPROVED AIR/MOISTURE BARRIER ON 13mm (1/2") EXT. TYPE SHEATHING ON 38x89 (2"x4") STUDS @ 400 (16") O.C.. STUCCO TO BE MIN. 200 (8") ABOVE FINISH GRADE.

2E. **WALLS ADJACENT TO ATTIC SPACE - NO CLADDING**
9.5mm (3/8") EXT. TYPE SHEATHING, 38x140 (2"x6") STUDS @ 400mm (16") O.C. RSI 3.87 (R22) INSULATION AND APPR. VAPOUR BARRIER AND APPR. CONTIN. AIR BARRIER, 13mm (1/2") INTERIOR DRYWALL FINISH. MID-HEIGHT BLOCKING REQ'D. IF NO SHEATHING APPLIED. REFER TO OBC SB-12, CHAPTER 3 FOR ADDITIONAL THERMAL INSULATION REQUIREMENTS.

3. **MASONRY VENEER CONSTRUCTION (2"x6") (SB-12-TABLE 3.1.1.2.A)**
90mm (4") MASONRY, 25mm (1") AIR SPACE, 22x180x0.76mm (7/8"x7"x0.03") GALV. METAL TIES @ 400mm (16") O.C. HORIZONTAL 600mm (24") O.C. VERTICAL. APPROVED SHEATHING PAPER, 9.5mm (3/8") EXT. TYPE SHEATHING, 38x140 (2"x6") STUDS @ 400mm (16") O.C. RSI 3.87 (R22) INSULATION & APPR. VAPOUR BARRIER WITH APPR. CONTIN. AIR BARRIER, 13mm (1/2") INTERIOR DRYWALL FINISH. PROVIDE WEEP HOLES @ 800mm (32") O.C. BOTTOM COURSE AND OVER OPENINGS. PROVIDE BASE FLASHING UP MIN. 150mm (6") BEHIND BUILDING PAPER. REFER TO OBC SB-12, CHAPTER 3 FOR ADDITIONAL THERMAL INSULATION REQUIREMENTS. MASONRY TO BE MIN. 150mm (6") ABOVE FINISH GRADE.

3A. RESERVED

3B. **MASONRY VENEER CONSTRUCTION (2"x4")- GARAGE WALLS**
90mm (4") MASONRY, 25mm (1") AIR SPACE, 22x180x0.76mm (7/8"x7"x0.03") GALV. METAL TIES @ 400mm (16") O.C. HORIZONTAL 600mm (24") O.C. VERTICAL. APPR. SHEATHING PAPER, 9.5mm (3/8") EXT. TYPE SHEATHING, 38x89 (2"x4") STUDS @ 400mm (16") O.C. (MAX. HEIGHT 3000mm 9'-10") WITH APPR. DIAGONAL WALL BRACING. PROVIDE WEEP HOLES @ 800mm (32") O.C. BOTTOM COURSE AND OVER OPENINGS. PROVIDE BASE FLASHING UP MIN. 150mm (6") BEHIND BUILDING PAPER.

3C. MASONRY TO BE MIN. 150mm (6") ABOVE FINISH GRADE.

4. **INTERIOR STUD PARTITIONS**
FOR BEARING PARTITIONS 38x89 (2"x4") @ 400mm (16") O.C. FOR 2 STOREYS AND 300mm (12") O.C. FOR 3 STOREYS, NON-BEARING PARTITIONS 38x89 (2"x4") @ 600mm (24") O.C. PROVIDE 38x89 (2"x4") BOTTOM PLATE AND 2/38x89 (2/2"x4") TOP PLATE, 13mm (1/2") INT. DRYWALL BOTH SIDES OF STUDS, PROVIDE 38x140 (2"x6") STUDS/PLATES WHERE NOTED.

5. **FOUNDATION WALL/FOOTINGS:**
250mm (10") POURED CONC. FDTN. WALL 20MPa (2900psi) WITH BITUMENOUS DAMPPROOFING AND DRAINAGE LAYER. DRAINAGE LAYER REQ'D. WHEN BASEMENT INSUL. EXTENDS 900 (2'-11") BELOW FIN. GRADE. DRAINAGE LAYER IS NOT REQ'D. WHEN FDTN. WALL IS WATERPROOFED. MAXIMUM POUR HEIGHT 2820 (9'-3") ON 56x155 (22"x6") CONTINUOUS KEYED CONC. FTG. BRACE FDTN. WALL PRIOR TO BACKFILLING. ALL FOOTINGS SHALL REST ON NATURAL UNDISTURBED SOIL OR COMPACTED ENGINEERED FILL, WITH MIN. BEARING CAPACITY OF 150kPa OR GREATER. IF SOIL BEARING DOES NOT MEET MINIMUM CAPACITY, ENGINEERED FOOTINGS ARE REQUIRED.

STOREYS SUPPORTED	W/ MASONRY VENEER	W/ SIDING ONLY
1	18" WIDE x 6" DEEP	18" WIDE x 6" DEEP
2	22" WIDE x 6" DEEP	22" WIDE x 6" DEEP
3	28" WIDE x 9" DEEP	22" WIDE x 6" DEEP

-SEE OBC 9.15.3.
-MAXIMUM FLOOR LIVE LOAD OF 2.4kPa. (50psf.) PER FLOOR, AND MAX. LENGTH OF SUPPORTED FLOOR JOISTS IS 4.9m (16'-1").
-REFER TO SOILS REPORT FOR SOIL CONDITIONS AND BEARING CAPACITY.

STRIP FOOTING SUPPORTING EXTERIOR WALLS (FOR W.O.B.)
-ASSUMING MASONRY VENEER CONSTRUCTION, MAX. FLOOR LIVE LOAD OF 2.4kPa. (50psf.) PER FLOOR, AND MAX. LENGTH OF SUPPORTED FLOOR JOISTS IS 4.9m (16'-1"). THE STRIP FOOTING SIZE IS AS FOLLOWS:
2 STOREY WITH WALK-OUT BASEMENT 545x175 (22"x7")

6. **FOUNDATION DRAINAGE OBC. 9.14.2. & 9.14.3.**
100mm (4") DIA. FOUNDATION DRAINAGE TILE 150mm (6") CRUSHED STONE OVER AND AROUND DRAINAGE TILES.

7. **BASEMENT SLAB OBC. 9.3.1.6 (1)(b). 9.16.4.5 (1). 9.25.3.3 (15)**
80mm (3") MIN. 25MPa (3600psi) CONC. SLAB ON 100mm (4") COARSE GRANULAR FILL, OR 20MPa. (3000psi) CONC. WITH DAMPPROOFING BELOW SLAB. UNDER SLAB INSULATION PER SB-12. ALL SLAB JOINTS & PENETRATIONS TO BE CAULKED.

8. **EXPOSED FLOOR TO EXTERIOR (SB-12-TABLE 3.1.1.2.A)**
PROVIDE RSI 5.46 (R31) INSULATION, APPROVED VAPOUR BARRIER AND CONTINUOUS AIR BARRIER, FINISHED SOFFIT.

9. **ATTIC INSULATION (SB-12-TABLE 3.1.1.2.A) (SB-12-3.1.1.8)**
RSI 10.56 (R60) BLOWN IN ROOF INSULATION AND APPROVED VAPOUR BARRIER, 16mm (5/8") INT. DRYWALL FINISH OR APPROVED EQUAL. RSI 3.52 (R20) MIN. ABOVE INNER SURFACE OF EXTERIOR WALL

10. **ALL STAIRS/EXTERIOR STAIRS -OBC. 9.8.- (PRIVATE STAIRS)**
UNIFORM RISE 5mm (1/4") MAX BETWEEN ADJACENT TREADS OR LANDINGS
-10mm (3/8") MAX BETWEEN TALLEST & SHORTEST RISE IN FLIGHT

MAX. RISE	= 200 (7'-7/8")
MIN. RUN	= 255 (10') (NOSING TO NOSING)
MAX. TREAD	= RUN + 25 (1")
MAX. NOSING	= 25 (1")
MIN. HEADROOM	= 1950 (6'-5")
RAIL @ LANDING	= 900 (2'-11")
RAIL @ STAIR	= 865 (2'-10") TO 1070 (3'-6")
MIN. STAIR WIDTH	= 860 (2'-10")
FOR CURVED STAIRS (TAPERED TREADS)	
MIN. RUN AT INNER RADIUS	= 150 (6")
MIN. RUN AT 300 (12")	= 255 (10')

11. **HANDRAILS -OBC. 9.8.7.-**
FINISHED RAILING ON PICKETS SPACED MAXIMUM 100mm (4") BETWEEN PICKETS. CLEARANCE BETWEEN HANDRAIL AND SURFACE BEHIND IT TO BE 50 (2") MIN. HANDRAILS TO BE CONTINUOUS EXCEPT FOR NEWEL POST AT CHANGES OF DIRECTION .

12. **INTERIOR GUARDS -OBC. 9.8.8.-**
INTERIOR GUARDS: 900mm (2'-11") MIN. HIGH
EXTERIOR GUARDS - OBC. 9.8.8.
900mm (36") HIGH GUARD WHERE DISTANCE FROM PORCH TO FIN. GRADE IS LESS THAN 1800mm (71"). 1070mm (42") HIGH GUARD IS REQUIRED WHERE DISTANCE EXCEEDS 1800mm (71").

13. **SILL PLATE - OBC. 9.23.7.**
38x89 (2"x4") SILL PLATE WITH 13mm (1/2") DIA. ANCHOR BOLTS 200mm (8") LONG, EMBEDDED MIN. 100mm (4") INTO CONC. @ 2400mm (7'-10") O.C., CAULKING OR 25 (1") MIN. MINERAL WOOL BETWEEN PLATE AND TOP OF FDTN. WALL.
USE NON-SHRINK GROUT TO LEVEL SILL PLATE WHEN REQUIRED.

14. **BASEMENT INSULATION (SB-12-3.1.1.7). 9.25.2.3. 9.13.2.6)**
FOUNDATION WALLS ENCLOSING HEATED SPACE SHALL BE INSULATED FROM THE UNDERSIDE OF THE SUBFLOOR TO NOT MORE THAN 200mm (8") ABOVE THE FINISHED FLOOR & NO CLOSER THAN 50mm (2") OF THE BASEMENT SLAB. RSI3.52ci (R20ci) BLANKET INSULATION TO HAVE APPROVED VAPOUR BARRIER. RECOMMEND DAMPPROOF WITH BUILDING PAPER BETWEEN THE FOUNDATION WALL AND INSULATION UP TO GRADE LEVEL. NOTE: FULL HEIGHT INSULATION AT COLD CELLAR WALLS, AIR BARRIER TO BE SEALED TO FOUNDATION WALL WITH CAULKING. CONTINUOUS INSULATION (ci) IS NOT TO BE INTERRUPTED BY FRAMING.

15. **BEARING STUD PARTITION**
38x89 (2"x4") STUDS @ 400mm (16") O.C. 38x89 (2"x4") SILL PLATE ON DAMPPROOFING MATERIAL, 13mm (1/2") DIA. ANCHOR BOLTS 200mm (8") LONG, EMBEDDED MIN. 100mm (4") INTO CONC. @ 2400mm (7'-10") O.C. 100mm (4") HIGH CONC. CURB ON 350x155 (14"x6") CONC. FOOTING. ADD HORIZ. BLOCKING AT MID-HEIGHT IF WALL IS UNFINISHED.

16. **STEEL BASEMENT COLUMN (SEE O.B.C. 9.15.3.3)**
89mm (3-1/2") DIA x 3.0mm (0.118) SINGLE WALL TUBE TYPE 2 ADJUSTABLE STL. COL. W/ MIN. CAPACITY OF 71.2kN (16,000lbs.) AT A MAX. EXTENSION OF 2318mm (7'-7 1/2") CONFORMING TO CAN/CGSB-7.2-94, AND WITH 150x150x9.5 (6"x6"x3/8") STL. PLATE TOP & BOTTOM. 870x870x410 (34"x34"x16") CONC. FOOTING ON UNDISTURBED SOIL OR ENGINEERED FILL CAPABLE OF SUSTAINING A PRESSURE OF 150 Kpa. MINIMUM AND AS PER SOILS REPORT.

17. **STEEL BASEMENT COLUMN (SEE O.B.C. 9.15.3.3)**
89mm (3-1/2") DIA x 4.78mm (1.88) FIXED STL. COL. WITH 150x150x9.5 (6"x6"x3/8") STL. TOP & BOTTOM PLATE ON 1070x1070x460 (42"x42"x18"). CONC. FOOTING ON UNDISTURBED SOIL OR ENGINEERED FILL CAPABLE OF SUSTAINING A PRESSURE OF 150 Kpa. MIN. AND AS PER SOILS REPORT.

18. **STEEL COLUMN**
90mm (3-1/2") DIA x 4.78mm (1.88) NON-ADJUSTABLE STL. COL. TO BE ON 150x150x9.5 (6"x6"x3/8") STL. TOP PLATE, & BOTTOM PLATE. BASE PLATE 120x250x12.5 (4 1/2"x10"x1/2") WITH 2-12mm DIA. x 300mm LONG x50mm HOOK ANCHORS (2-1/2"x12"x2") FIELD WELD COL. TO BASE PLATE.

19. BEAM POCKET OR 300x150 (12"x6") POURED CONC. NIB WALLS. MIN. BEARING 90mm (3-1/2")

20. 19x64 (1"x3") CONTINUOUS WOOD STRAPPING BOTH SIDES OF STEEL BEAM.

21. **GARAGE SLAB**
100mm (4") 32MPa (4640psi) CONC. SLAB WITH 5-8% AIR ENTRAINMENT ON OPT. 100 (4") COARSE GRANULAR FILL WITH COMPACTED SUB-BASE OR COMPACTED NATIVE FILL.
SLOPE TO FRONT.

22. **GARAGE CEILINGS/INTERIOR WALLS**
13mm (1/2") GYPSUM BOARD ON WALL AND CEILING BETWEEN HOUSE AND GARAGE. TAPE AND SEAL ALL JOINTS AIRTIGHT PER O.B.C. 9.10.9.16. WALLS (R22), CEILINGS (R31). REFER TO SB-12, TABLE 3.1.1.2.A. FOR REQUIRED THERMAL INSULATION.

23. DOOR AND FRAME GASPROOFED. DOOR EQUIPPED WITH SELF CLOSING DEVICE AND WEATHERSTRIPPING PER OBC 9.10.13.15.

24. **EXTERIOR STEP**
PRECAST CONCRETE STEP OR WOOD STEP WHERE NOT EXPOSED TO WEATHER. MAX. RISE 200mm (7-7/8") MIN. TREAD 250mm (9'-1/2"). SEE OBC. 9.8.9.2. 9.8.9.3. & 9.8.10.

25. **DRYER EXHAUST (OBC-6.2.3.8(7) & 6.2.4.11.)**
CAPPED DRYER EXHAUST VENTED TO EXTERIOR. (USE 100mm (4") DIA. SMOOTH WALL VENT PIPE)

26. **INSULATED ATTIC ACCESS (OBC-9.19.2.1. & SB12-3.1.1.8)**
ATTIC ACCESS HAUCH WITH MIN. DIMENSION OF 545x610mm (21 1/2"x24") & A MIN. AREA OF 0.32 SQ.M. (3.44 SQ.FT.) WITH WEATHERSTRIPPING. RSI 3.52 (R20) RIGID INSUL. BACKING.

27. **FIREPLACE CHIMNEYS OBC. 9.21.**
TOP OF FIREPLACE CHIMNEY SHALL BE 915mm (3'-0") ABOVE THE HIGHEST POINT AT WHICH IT COMES IN CONTACT WITH THE ROOF AND 610mm (2'-0") ABOVE THE ROOF SURFACE WITHIN A HORIZ. DISTANCE OF 3050mm (10'-0") FROM THE CHIMNEY.

28. LINEN CLOSET, 4 SHELVES MIN. 350mm (14") DEEP.

29. MECHANICAL EXHAUST FAN, VENTED TO EXTERIOR AS REQUIRED BY OBC. 9.32.3.5. & 9.32.3.10.

30. **STEEL BEARING PLATE FOR MASONRY WALLS**
280x280x16 (11"x11"x5/8") STL. PLATE FOR STL BEAMS AND 280x280x12 (11"x11"x1/2") STL. PLATE FOR WOOD BEAMS BEARING ON CONC. BLOCK PARTYWALL, ANCHORED WITH 2-19mm (3/4") x 200mm (8") LONG GALV. ANCHORS WITHIN SOLID BLOCK COURSE. LEVEL WITH NON-SHRINK GROUT.

31. **SOLID WOOD BEARING FOR WOOD STUD WALLS**
SOLID BEARING TO BE AT LEAST AS WIDE AS THE SUPPORTED MEMBER. SOLID WOOD BEARING COMPRISED OF BUILT-UP WOOD STUDS TO BE CONSTRUCTED IN ACCORDANCE WITH OBC 9.17.4.2(2).

32. **BEARING WOOD POST (BASEMENT) (OBC 9.17.4.)**
3-38x140 (3-2"x6") BUILT-UP-POST ON METAL BASE SHOE ANCHORED TO CONC. WITH 12.7 DIA. BOLT, 610x610x300 (24"x24"x12") CONC. FOOTING.

33. **STEPPED FOOTINGS OBC 9.15.3.9.**
MIN. HORIZ. STEP = 600mm (24").
MAX. VERT. STEP = 600mm (24")

34. **SLAB ON GRADE**
MIN. 100mm (4") CONCRETE SLAB ON GRADE ON 100mm (4") COARSE GRANULAR FILL. REINFORCED WITH 6x6-w2x9w2.9 MESH PLACED NEAR MID-DEPTH OF SLAB. CONC. STRENGTH 32 MPa (4640 psi) WITH 5-8% AIR ENTRAINMENT ON COMPACTED SUB-GRADE. WHERE REQUIRED, REFER TO OBC SB-12, TABLE 3.1.1.2.A. FOR REQUIRED MINIMUM INSULATION UNDER SLAB.

35. **DIRECT VENTING GAS FURNACE/ H.W.T VENT**
DIRECT VENT FURNACE TERMINAL MIN. 900mm (36") FROM A NATURAL GAS REGULATOR, MIN. 300mm (12") ABOVE FIN. GRADE. FROM ALL OPENINGS, EXHAUST AND INTAKE VENTS. HRV INTAKE TO BE A MIN. OF 1830mm (6'-0") FROM ALL EXHAUST TERMINALS. REFER TO GAS UTILIZATION CODE. ALL AIR INTAKES SHALL BE LOCATED SO THAT THEY ARE SEPARATED FROM KITCHEN EXHAUST BY 3.0M IN COMPLIANCE WITH O.B.C. DIV.-8 TABLE 6.2.3.12..

36. **DIRECT VENTING GAS FIREPLACE VENT**
DIRECT VENT GAS FIREPLACE. VENT TO BE A MINIMUM 300mm (12") FROM ANY OPENING AND ABOVE FIN. GRADE. REFER TO GAS UTILIZATION CODE.

37. **SUBFLOOR, JOIST STRAPPING AND BRIDGING**
16mm (5/8") T & G SUBFLOOR ON WOOD FLOOR JOISTS. FOR CERAMIC TILE APPLICATION (* SEE OBC 9.30.6. *) 6mm (1/4") PANEL TYPE UNDERLAY UNDER RESILIENT & PARQUET FLOORING. (* SEE OBC 9.30.2.-). FLOOR JOISTS WITH SPANS OVER 2100mm (6'-11") TO BE BRIDGED WITH 38x38 (2"x2") CROSS BRACING OR SOLID BLOCKING @ 2100mm (6'-11") O.C. MAX. AND WHERE SPECIFIED BY JOIST TABLES A-1 OR A-2 STRAPPING SHALL BE 19x64 (1"x3") @ 2100mm (6'-11") O.C. UNLESS A PANEL TYPE CEILING FINISH IS APPLIED. (* SEE OBC 9.23.9.4. *)

38. **EXPOSED BUILDING FACE OBC. 9.10.15. & SB-2-2.3.5(2)**
EXTERIOR WALLS TO HAVE A FIRE RESISTANCE RATING OF NOT LESS THAN 45 min. WHERE LIMITING DISTANCE (LD) IS LESS THAN 1.2M (3'-11"). WHERE THE LD IS LESS THAN 600mm (1'-11") THE EXPOSING FACE SHALL BE CLAD IN NON-COMBUSTIBLE MATERIAL. SEE ELEVATIONS FOR ADDITIONAL NOTES. OFFENDING GARAGE WALLS INCLUDED.

39. **COLD CELLAR PORCH SLAB (OBC 9.39.)**
FOR MAX. 2500mm (8'-2") PORCH DEPTH (SHORTEST DIM.), 125mm (5") 32MPa (4640psi) CONC. SLAB WITH 5-8% AIR ENTRAINMENT. REINF. WITH 10M BARS @ 200mm (7 7/8") O.C. EACH WAY IN BOTTOM THIRD OF SLAB. MIN. 30mm (1 1/4") COVER. 600x600 (23 5/8"x23 5/8") 10M DOWELS @ 600mm (23 5/8") O.C.. ANCHORED IN PERIMETER FDTN. WALLS. SLOPE SLAB MIN. 1.0% FROM HOUSE WALL. SLAB TO HAVE MIN. 75mm (3") BEARING ON FDTN. WALLS. PROVIDE (L7) LINTEL OVER CELLAR DOOR WITH 100mm (4") END BEARING.

40. THE FDTN. WALL SHALL NOT BE REDUCED TO LESS THAN 90mm (3-1/2") THICK TO A MAX. DEPTH OF 600mm (24") AND SHALL BE TIED TO THE FACING MATERIAL WITH METAL TIES SPACED 200mm (8") O.C. VERTICALLY AND 900mm (36") O.C. HORIZONTALLY. FILL SPACE BETWEEN WALL AND FACING SILL WITH MORTAR.

41. **CONVENTIONAL ROOF FRAMING (2.0Kpg. SNOW LOAD)**
38x140 (2"x6") RAFTERS @ 400mm (16"O.C.) FOR MAX 11-7" SPAN, 38x184 (2"x8") RIDGE BOARD, 38x89 (2"x4") COLLAR TIES AT MIDSPANS. CEILING JOISTS TO BE 38x89 (2"x4") @ 400mm (16") O.C. FOR MAX. 2830mm (9'-3") SPAN & 38x140 (2"x6") @ 400 (16") O.C. FOR MAX. 4450mm (14'-7") SPAN.
RAFTERS FOR BUILT-UP ROOF TO BE 38x89 (2"x4") @ 600mm (24") O.C. WITH A 38x89 (2"x4") CENTRE POST TO THE TRUSS BELOW, LATERALLY BRACED @ 1800mm (6'-0") O.C. VERTICALLY.

GENERAL NOTES

- WINDOWS:** 1) **MINIMUM BEDROOM WINDOW -OBC. 9.9.10.1.-**
AT LEAST ONE BEDROOM WINDOW ON A GIVEN FLOOR IS TO HAVE MIN. 0.35m2 UNOBSTRUCTED GLAZED OR OPENABLE AREA WITH MIN. CLEAR WIDTH OF 380 mm (1'-3").
2) **WINDOW GUARDS -OBC. 9.8.8.1.(6).**
A GUARD IS REQUIRED WHERE THE TOP OF THE WINDOW SILL IS LOCATED LESS THAN 480mm (1'-7") ABOVE FIN. FLOOR AND THE DISTANCE FROM THE FIN. FLOOR TO THE ADJACENT GRADE IS GREATER THAN 1800mm (5'-11")
3) **EXTERIOR WINDOWS**
SHALL COMPLY WITH OBC DIV.-8 9.7.3. & SB12-3.1.1.9
4) **GLASS-STRUCTURAL SUFFICIENCY OF GLASS**
DOOR & WINDOW MANUFACTURER/ SUPPLIER TO PROVIDE ADEQUATE INFORMATION TO DEMONSTRATE COMPLIANCE WITH OBC DIV.-8 9.6.1.3.

- GENERAL:** 1) MECHANICAL VENTILATION IS REQUIRED TO COMPLY WITH OBC-DIV. 8, 6.2.2. SEE MECHANICAL DRAWINGS.
2) ALL DOWNSPOUTS TO DRAIN AWAY FROM THE BUILDING AS PER OBC 9.26.18.2 & 5.6.2.2.(3) AND MUNICIPAL STANDARDS.
3) ALL WINDOW WELLS TO DRAIN TO FOOTING LEVEL PER OBC 9.14.6.3. CHECK WITH THE LOCAL AUTHORITY.
4) **STUD WALL REINFORCEMENT FOR FUTURE GRAB BARS IN MAIN BATHROOM**
REINFORCEMENT OF STUD WALLS SHALL BE INSTALLED ADJACENT TO WATER CLOSETS AND SHOWER OR BATHTUB IN MAIN BATHROOM. REFER TO OBC, DIV. 8- 9.5.2.3 & DETAIL PROVIDED.
5) ALL EXTERIOR DOORS TO COMPLY WITH THERMAL RESISTANCE AS STATED IN O.B.C. SB-12-3.1.1.9.
6) ALL AIR BARRIER SYSTEMS ARE REQUIRED TO COMPLY WITH O.B.C. DIV.-8 9.25.3.
7) ALL OUTDOOR AIR INTAKES SHALL BE LOCATED SO THAT THEY ARE SEPARATED FROM SOURCES OF CONTAMINATION (EXHAUST VENTS) IN COMPLIANCE WITH O.B.C. DIV.-8 6.2.3.12. AND TABLE 6.2.3.12.

- LUMBER:** 1) ALL LUMBER SHALL BE SPRUCE NO.2 GRADE, UNLESS NOTED OTHERWISE.
2) STUDS SHALL BE STUD GRADE SPRUCE, UNLESS NOTED OTHERWISE.
3) LUMBER EXPOSED TO THE EXTERIOR TO BE SPRUCE No.2 GRADE PRESSURE TREATED OR CEDAR, UNLESS NOTED OTHERWISE.
4) ALL LAMINATED VENEER LUMBER (L.V.L) BEAMS, GIRDER TRUSSES, AND METAL HANGER CONNECTIONS SUPPORTING ROOF FRAMING TO BE DESIGNED & CERTIFIED BY TRUSS MANUFACTURER.

- 5) LVL BEAMS SHALL BE 2.0E -2950Fb MIN., NAIL EACH PLY OF LVL WITH 89mm (3 1/2") LONG COMMON WIRE NAILS @ 300mm (12") O.C. STAGGERED. IN 2 ROWS FOR 184, 240 & 300mm (7 1/4" 9 1/2" 11 7/8") DEPTHS AND STAGGERED IN 3 ROWS FOR GREATER DEPTHS AND FOR 4 PLY MEMBERS ADD 13mm (1/2") DIA. GALVANIZED BOLTS BOLTED AT MID-DEPTH OF BEAM @ 915mm (3'-0") O.C.
6) PROVIDE FACE MOUNT BEAM HANGERS TYPE "SCL" MANUFACTURED BY SIMPSON STRONG-TIE OR EQUAL FOR ALL LVL BEAM TO BEAM CONNECTIONS UNLESS OTHERWISE NOTED; REFER TO ENG. FLOOR LAYOUTS.
7) JOIST HANGERS: PROVIDE METAL HANGERS FOR ALL JOISTS AND BUILT-UP WOOD MEMBERS INTERSECTING FLUSH BUILT-UP WOOD MEMBERS.
8) WOOD FRAMING NOT TREATED WITH A WOOD PRESERVATIVE, IN CONTACT WITH CONCRETE, SHALL BE SEPARATED FROM THE CONCRETE BY AT LEAST 2 mil. POLYETHYLENE FILM, No. 50 (45lbs.) ROLL ROOFING OR OTHER DAMPPROOFING MATERIAL, EXCEPT WHERE THE WOOD MEMBER IS AT LEAST 150mm (6") ABOVE THE GROUND.

STEEL: 1) STRUCTURAL STEEL SHALL CONFORM TO CAN/CSA-G40-21 GRADE 350W. HOLLOW STRUCTURAL SECTIONS SHALL CONFORM TO CSA-G40-21 GRADE 350W CLASS "H" "STRUCTURAL QUALITY STEEL". OBC. B-9-23.4.3.
2) REINFORCING STEEL SHALL CONFORM TO CSA-G30-18M GRADE 400R.

STUCCO: 1) ALL STUCCO WALLS TO HAVE A MINIMUM 10mm AIR SPACE BEHIND THE CLADDING WITH POSITIVE DRAINAGE TO THE EXTERIOR. THE EXTERIOR SHEATHING MUST NOT BE GYPSUM BASED. ALL STUCCO TO BE INSTALLED AS PER MANUFACTURERS SPECIFICATIONS.

LEGEND	
	CLASS 'B' VENT
	DUPLEX OUTLET (12" ABOVE SURFACE)
	WEATHERPROOF DUPLEX OUTLET
	POT LIGHT
	LIGHT FIXTURE (PULL CHAIN)
	SWITCH
	FLOOR DRAIN
	SINGLE JOIST
	DOUBLE JOIST
	TRIPLE JOIST
	LAMINATED VENEER LUMBER
	POINT LOAD FROM ABOVE
	FLAT ARCH
	CURVED ARCH
	MEDICINE CABINET (RECESSED)
	DOUBLE VOLUME WALL. SEE NOTE 39
	SOLID WOOD BEARING (SPRUCE No. 2). SOLID BEARING TO BE AS WIDE AS SUPPORTED MEMBER OR AS DIRECTED BY STRUCTURAL ENGINEER. SOLID BEARING TO BE MINIMUM 2 PIECES.
	SOLID WOOD BEARING TO MATCH FROM ABOVE

SOIL GAS/ RADON CONTROL (OBC 9.1.1.7. & 9.13.4.)
PROVIDE CONSTRUCTION TO PREVENT LEAKAGE OF SOIL GAS INTO THE BUILDING IF REQUIRED.

CONTRACTOR MUST VERIFY ALL DIMENSIONS ON THE JOB AND REPORT ANY DISCREPANCY TO VA3 DESIGN BEFORE PROCEEDING WITH THE WORK. ALL DRAWINGS AND SPECIFICATIONS ARE INSTRUMENTS OF SERVICE AND THE PROPERTY OF VA3 DESIGN WHICH IF REQUESTED, MUST BE RETURNED AT THE COMPLETION OF THE WORK. ALL DRAWINGS TO BE USED FOR CONSTRUCTION ONLY AFTER BUILDING PERMIT HAS BEEN ISSUED.

42. **TWO STOREY VOLUME SPACES**
-FOR A MAXIMUM 5490 mm (18'-0") HEIGHT AND MAXIMUM SUPPORTED ROOF TRUSS LENGTH OF 6.0m, PROVIDE 2-38x140 (2-2"x6") SPR.#2 CONTIN. STUDS @ 300mm (12") O.C. (TRIPLE UP AT EVERY THIRD DOUBLE STUD FOR BRICK WALLS) C/W 9.6 (3/8") THICK EXT. PLYWOOD SHEATHING. PROVIDE SOLID WOOD BLOCKING BETWEEN WOOD STUDS @ 1220 mm (4'-0") O.C. VERTICALLY. -FOR WALLS WITH HORIZ. DISTANCES NOT EXCEEDING 2900 mm (9'-6"). PROVIDE 38x140 (2"x6") STUDS @ 400 (16") O.C. WITH CONTINUOUS 2-38x140 (2-2"x6")TOP PLATES + 1-38x140 (1-2"x6") BOTTOM PLATE & MINIMUM OF 3-38x184 (3-2"x8") CONT. HEADER AT GRND. CEILING LEVEL TOE-NAILED & GLUED AT TOP. BOTTOM PLATES AND HEADERS.


43. TYPICAL 1 HOUR RATED PARTY WALL.
REFER TO DETAILS FOR TYPE AND SPECIFICATIONS.

44. **FOUNDATION WALL (W.O.D./W.O.B.)**
- WHERE GRADE TO T/O BASEMENT SLAB EXCEEDS 1200mm (3'-11") A 250mm (10") WIDE FOUNDATION WALL IS REQUIRED.

45. **EXTERIOR WALLS FOR WALK-OUT CONDITIONS**
THE EXTERIOR BASEMENT STUD WALL TO BE 38x140 (2"x6") STUDS @ 400mm (16") o.c. OR 38x89 (2"x4") STUDS @ 300mm (12")o.c..

DRAIN WATER HEAT RECOVERY UNIT (DWHR)
PER SB12-3.1.1.12., A DRAIN WATER HEAT RECOVERY (DWHR) UNIT SHALL BE INSTALLED IN EACH DWELLING UNIT TO RECEIVE DRAIN WATER FROM ALL SHOWERS OR FROM AT LEAST TWO SHOWERS WHERE THERE ARE TWO OR MORE SHOWERS IN THE DWELLING UNIT. DOES NOT APPLY IF THERE ARE NO SHOWERS OR NO STOREY BENEATH ANY OF THE SHOWERS.

UPDATED ONT. REG. 332/12-2012 OBC Amendment O. Reg. 88/19 Includes amendments effective Jan. 1, 2022

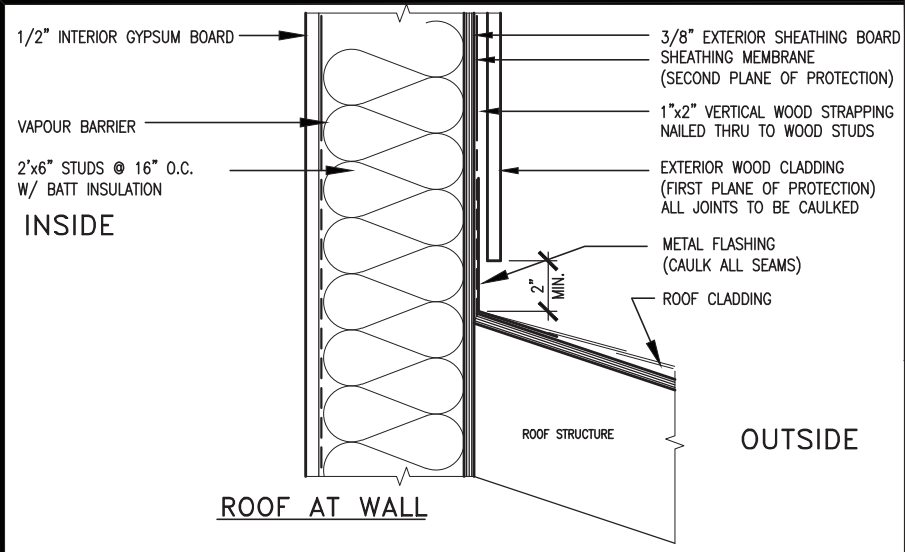

MAX. HEIGHT FOR 2"x4" GARAGE WALL IS AS FOLLOW:

2"x4" @ 16" O.C. - 9'-10"

2-2"x4" @ 12" O.C. - 10'-9"

3-2"x4" @ 16" O.C. - 11'-2"

3-2"x4" @ 12" O.C. - 12'-4"

NOTES:

- FOR ROOF DESIGN SNOW LOAD OF UP TO 2.5 KPa. SUPPORTED ROOF TRUSS LENGTH OF 6.0m AND FLOOR JOIST LENGTH OF 2.5m OF ONE FLOOR.
- PROVIDE HORIZONTAL SOLID BLOCKING @ 1200 O.C. (4'-0")
- PROVIDE A MINIMUM OF 9.5mm (3/8") PLYWOOD OR OSB EXTERIOR SHEATHING ON THE EXTERIOR FACE.
- FOR A 1/50 YEAR REFERENCE WIND PRESSURE OF 0.6 KPa.
- STUDS GREATER THAN 9'-10" HIGH TO BE No. 2 SPF.
- STUD SPECIFICATION IS SUITABLE FOR BRICK VENEER OR SIDING.

** MAX. HEIGHT FOR 2"x6" EXTERIOR WALL IS AS FOLLOW:

2"x6" @ 16" O.C. - 12'-6"

2"x6" @ 12" O.C. - 13'-10"

2-2"x6" @ 16" O.C. - 15'-0"

2-2"x6" @ 12" O.C. - 17'-4"

MAX. HEIGHT FOR 2"x8" EXTERIOR WALL IS AS FOLLOWS:

2"x8" @ 16" O.C. - 16'-0"

2"x8" @ 12" O.C. - 17'-9"




2-2"x8" @ 16" O.C. - 20'-4"

2-2"x8" @ 12" O.C. - 22'-4"

NOTES:

- FOR ROOF DESIGN SNOW LOAD OF UP TO 2.5 KPa
- SUPPORTED ROOF TRUSS LENGTH OF 6.0m ONLY.
- PROVIDE HORIZONTAL SOLID BLOCKING @ 1200 O.C. (4'-0")
- PROVIDE A MINIMUM OF 9.5mm (3/8") PLYWOOD OR OSB EXTERIOR SHEATHING ON THE EXTERIOR FACE AND 12.5mm (1/2") GYPSUM BOARD ON THE INTERIOR FACE.
- WALL FRAMING SHALL CONFORM TO OBC 9.23.10.1.(2)
- FOR A 1/50 YEAR REFERENCE WIND PRESSURE OF 0.6 KPa
- STUDS GREATER THAN 9'-10" HIGH TO BE No. 2 SPF.
- STUD SPECIFICATION IS SUITABLE FOR BRICK VENEER OR SIDING.

** STUD INFORMATION TAKEN FROM OBC TABLE A-30

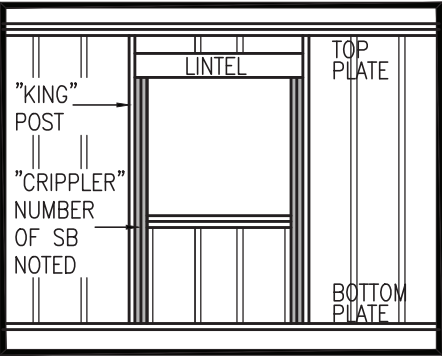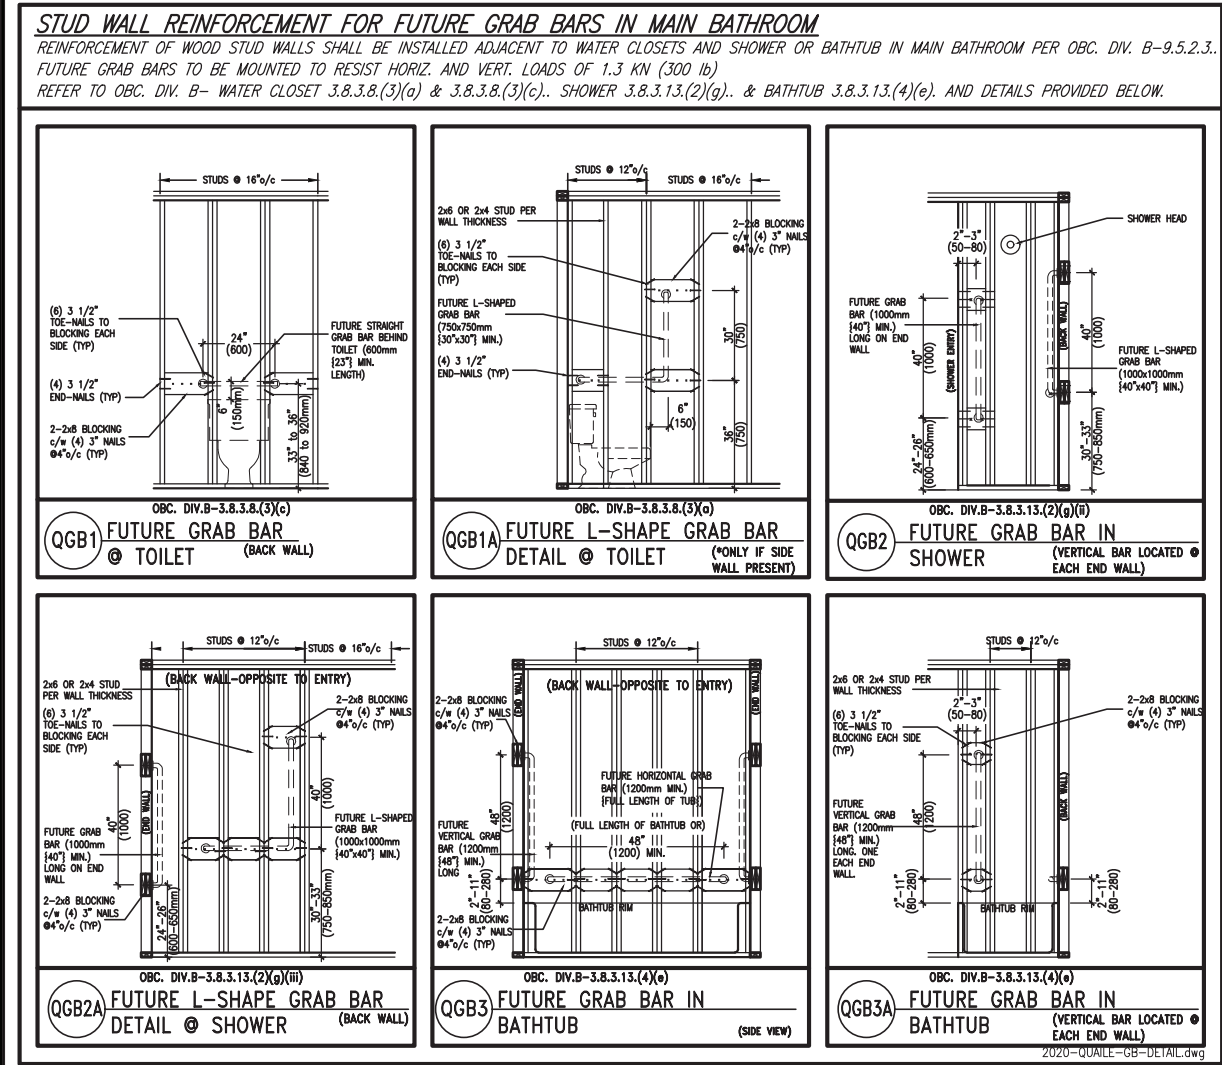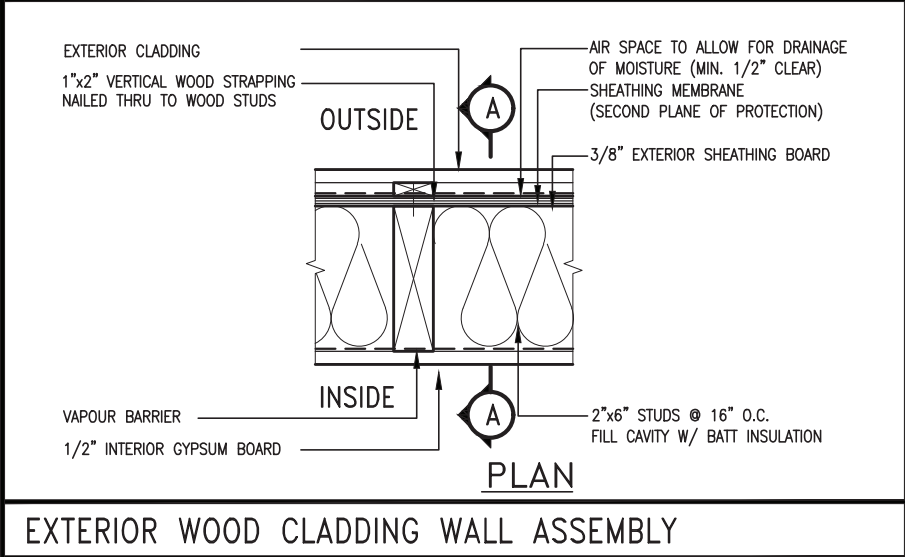

REVIEWED




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8	.	.	.	qualification information
7	.	.	.	Wellington Jno-Baptiste 25591
6	.	.	.	name
5	.	.	.	registration information
4	UPDATE TO 2022	JAN 11-22	RC	VA3 Design Inc. 42658
3	UPDATE TO 2020	FEB 24-20	RC	
2	UPDATE TO 2018	JAN 11-18	RC	Contractor must verify all dimensions on the job and report any discrepancy to the Designer before proceeding with the work. All drawings and specifications are instruments of service and the property of the Designer which must be returned at the completion of the work. Drawings are not to be scaled.
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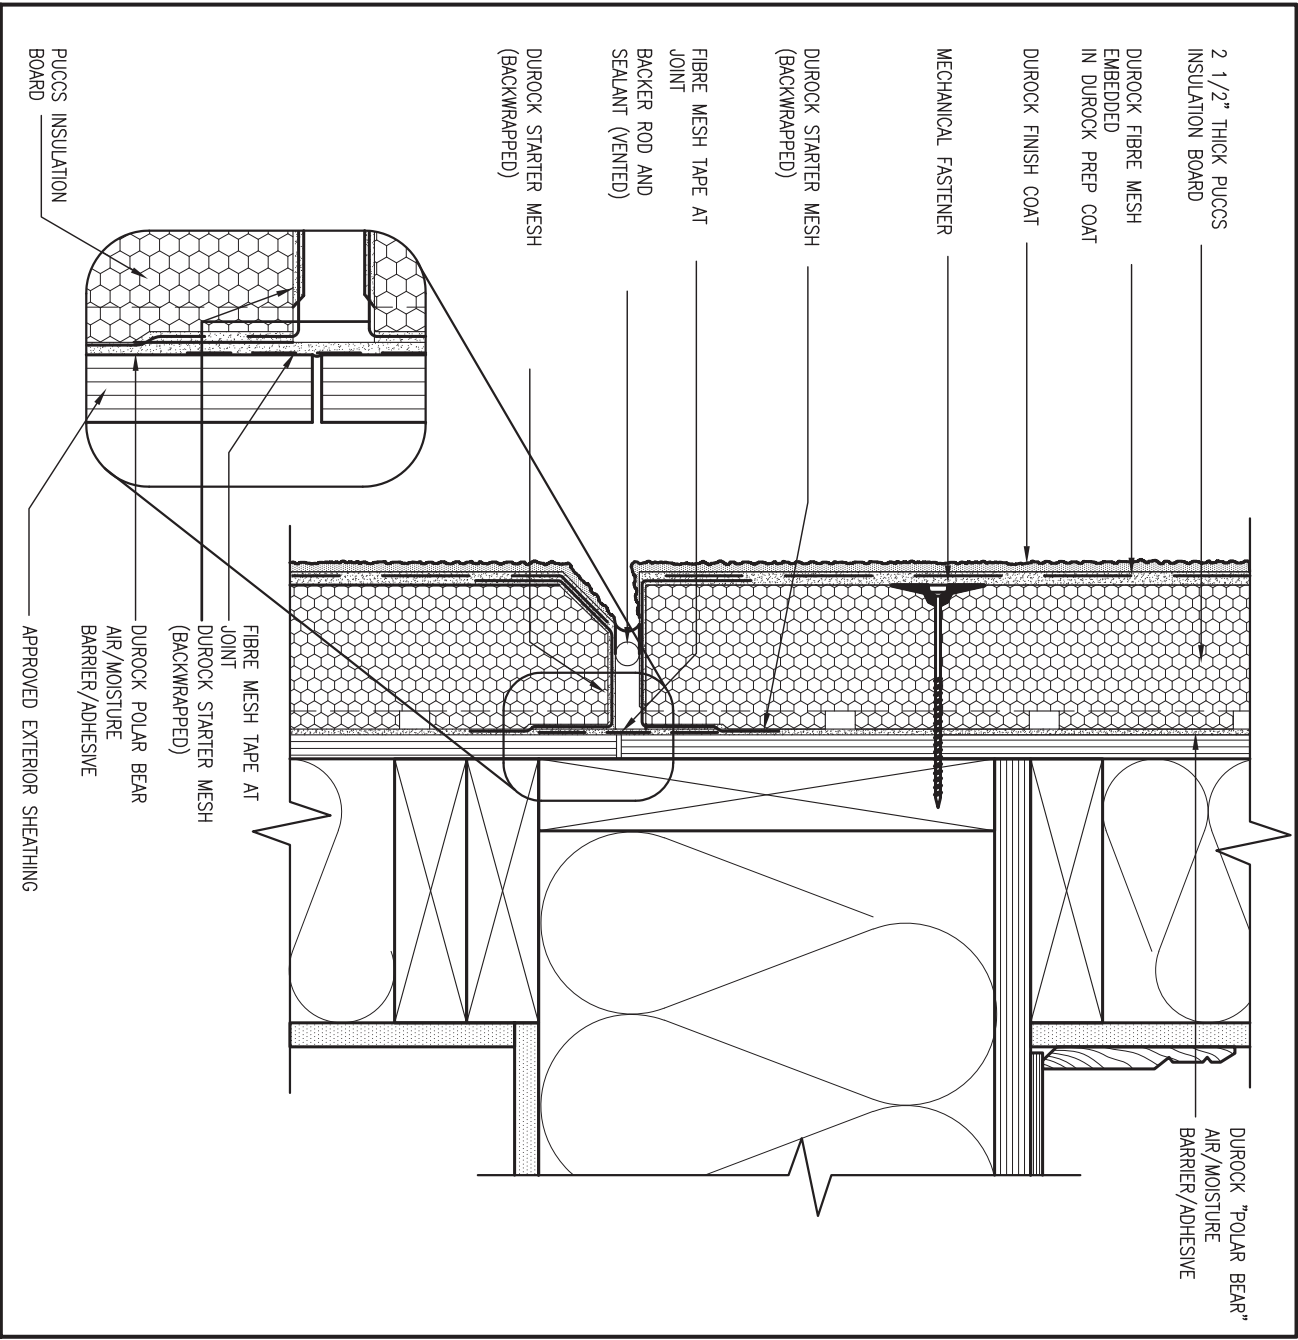
BAYVIEW WELLINGTON			CONST NOTE	
project name			municipality	
GREEN VALLEY EAST			BRADFORD	
date			project no.	
MAY 2016			16023	
CONSTRUCTION NOTES			drawing no.	
drawn by			file name	
RC			16023-CN-2022-A1	
checked by			scale	
-			3/16" = 1'-0"	
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3 STUCCO TERMINATION @ ROOF

CN4 SCALE: 3"=1'-0"

ALL STUCCO WALLS TO HAVE A MINIMUM 10mm AIR SPACE BEHIND THE CLADDING WITH POSITIVE DRAINAGE TO THE EXTERIOR. THE EXTERIOR SHEATHING MUST NOT BE GYPSUM BASED. ALL STUCCO TO BE INSTALLED AS PER MANUFACTURERS SPECIFICATIONS.
DETAILS ARE BASED ON DUROCK PUCCS SYSTEM

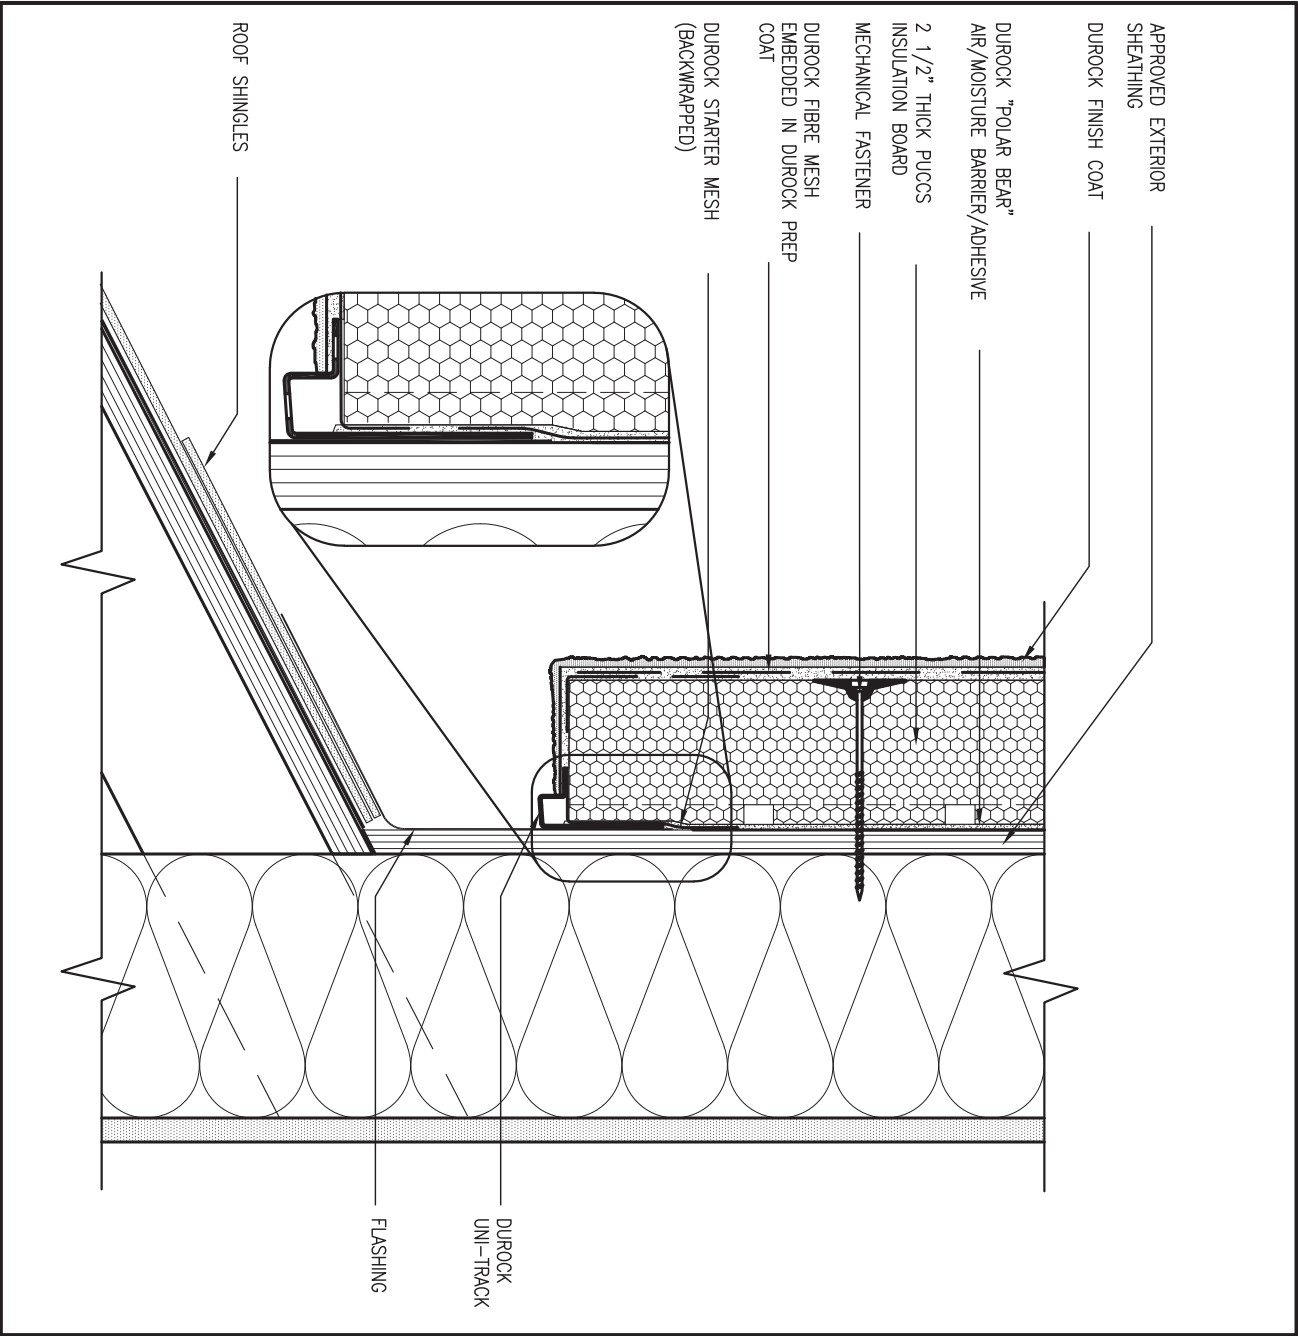


4 HORIZONTAL EXPANSION JOINT

CN4 SCALE: 3"=1'-0"

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8.	.	.	qualification information Wellington Jno-Baptiste 25591 signature VA3 Design Inc. 42658 BCIN						
7.	.	.	name registration information qualification information						
6.	.	.	Contractor must verify all dimensions on the job and report any discrepancy to the Designer before proceeding with the work. All drawings and specifications are instruments of service and the property of the Designer which must be returned at the completion of the work. Drawings are not to be scaled.						
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2.	UPDATE TO 2018	JAN 11-18	RC						
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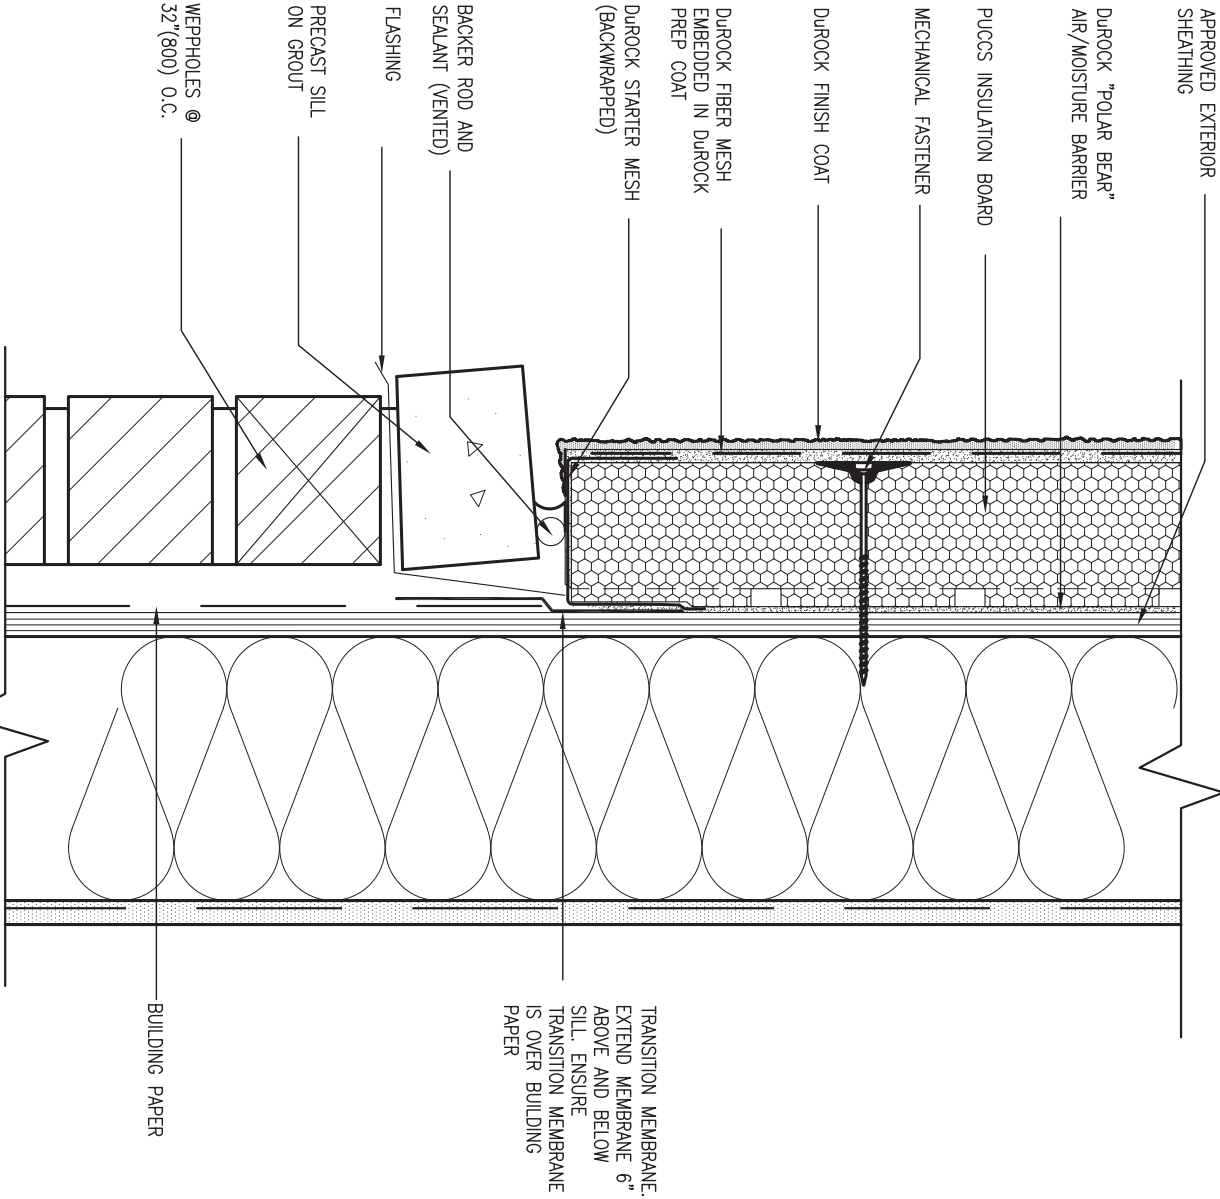


5 CORNER DETAIL

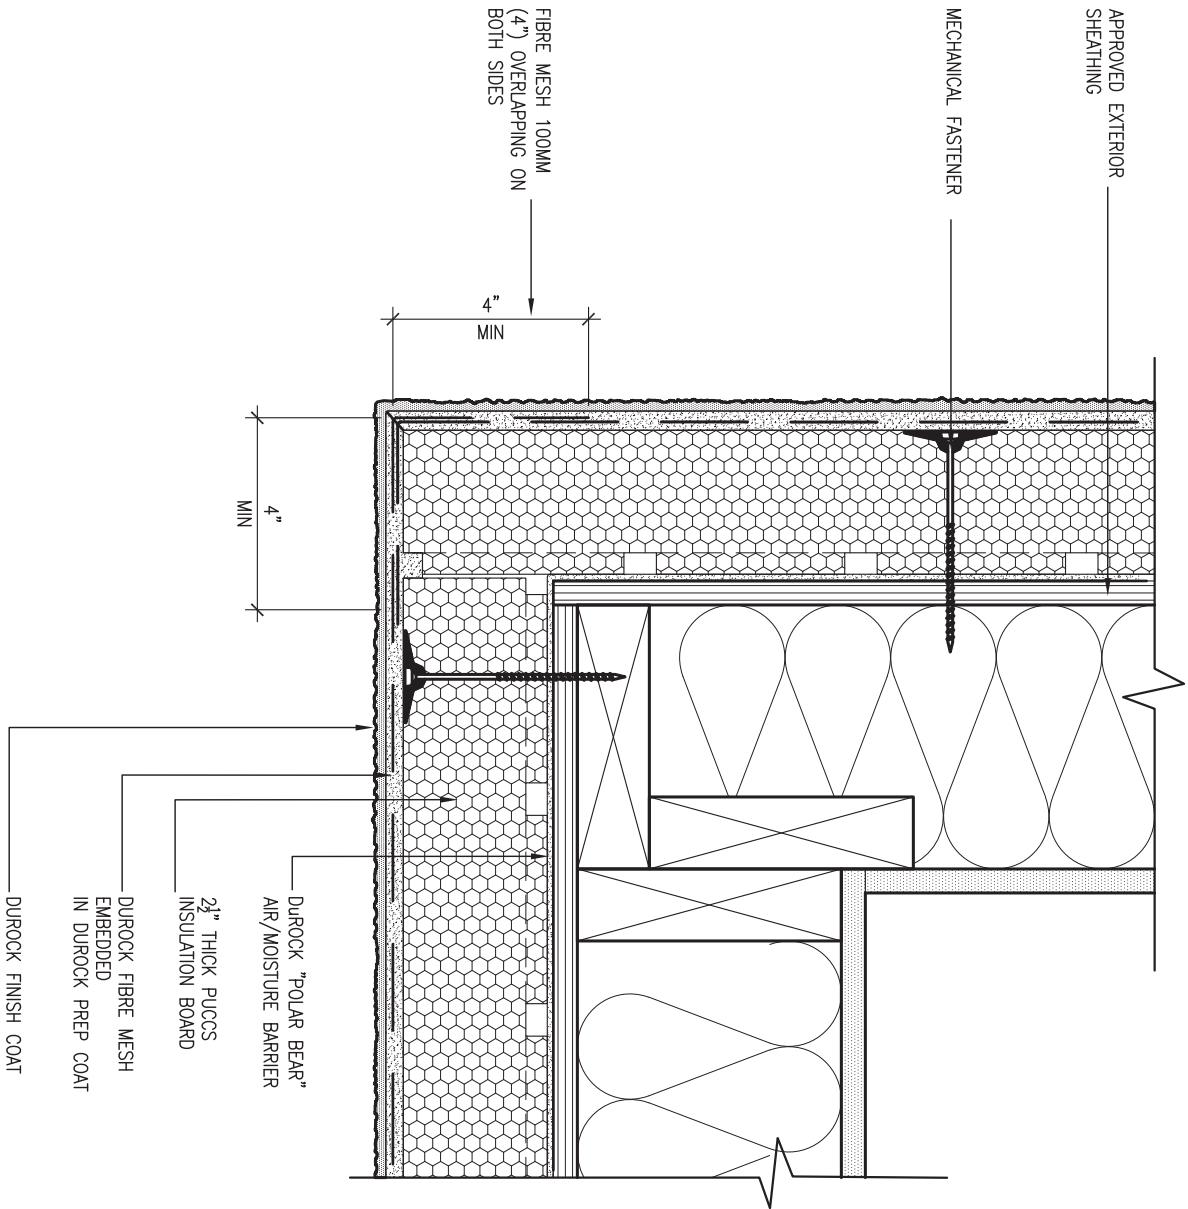CN5 SCALE: 3"=1'-0"

ALL STUCCO WALLS TO HAVE A MINIMUM 10mm AIR SPACE BEHIND THE CLADDING WITH POSITIVE DRAINAGE TO THE EXTERIOR. THE EXTERIOR SHEATHING MUST NOT BE GYPSUM BASED. ALL STUCCO TO BE INSTALLED AS PER MANUFACTURERS SPECIFICATIONS.

DETAILS ARE BASED ON DUROCK PUCCS SYSTEM



6 STUCCO / MASONRY PLINTH CONNECTION

CN5 SCALE: 3"=1'-0"


ALL STUCCO WALLS TO HAVE A MINIMUM 10mm AIR SPACE BEHIND THE CLADDING WITH POSITIVE DRAINAGE TO THE EXTERIOR. THE EXTERIOR SHEATHING MUST NOT BE GYPSUM BASED. ALL STUCCO TO BE INSTALLED AS PER MANUFACTURERS SPECIFICATIONS.

DETAILS ARE BASED ON DUROCK PUCCS SYSTEM

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8 .			7 .			project name			project no.		
7 .			6 .			GREEN VALLEY EAST			16023		
6 .			5 .			municipality			drawing no.		
5 .			4 UPDATE TO 2022			BRADFORD			16023		
4 UPDATE TO 2020			JAN 11-22			date			CONSTRUCTION NOTES		
3 UPDATE TO 2020			FEB 24-20			MAY 2016			file name		
2 UPDATE TO 2018			JAN 11-18			RC			16023-CN-2022-A1		
1 ISSUE FOR CLIENT REVIEW			AUG 04-17			checked by			3/16" = 1'-0"		
no. description			date			scale			RC		
						Richard - H:\ARCHIVE\WORKING\2016\16023.BW\Units\CN NOTES\16023-CN-2022-A1.dwg - Wed - Jan 26 2022 - 12:08 PM			CN5		

SB12-COMPLIANCE PACKAGE 'A1'

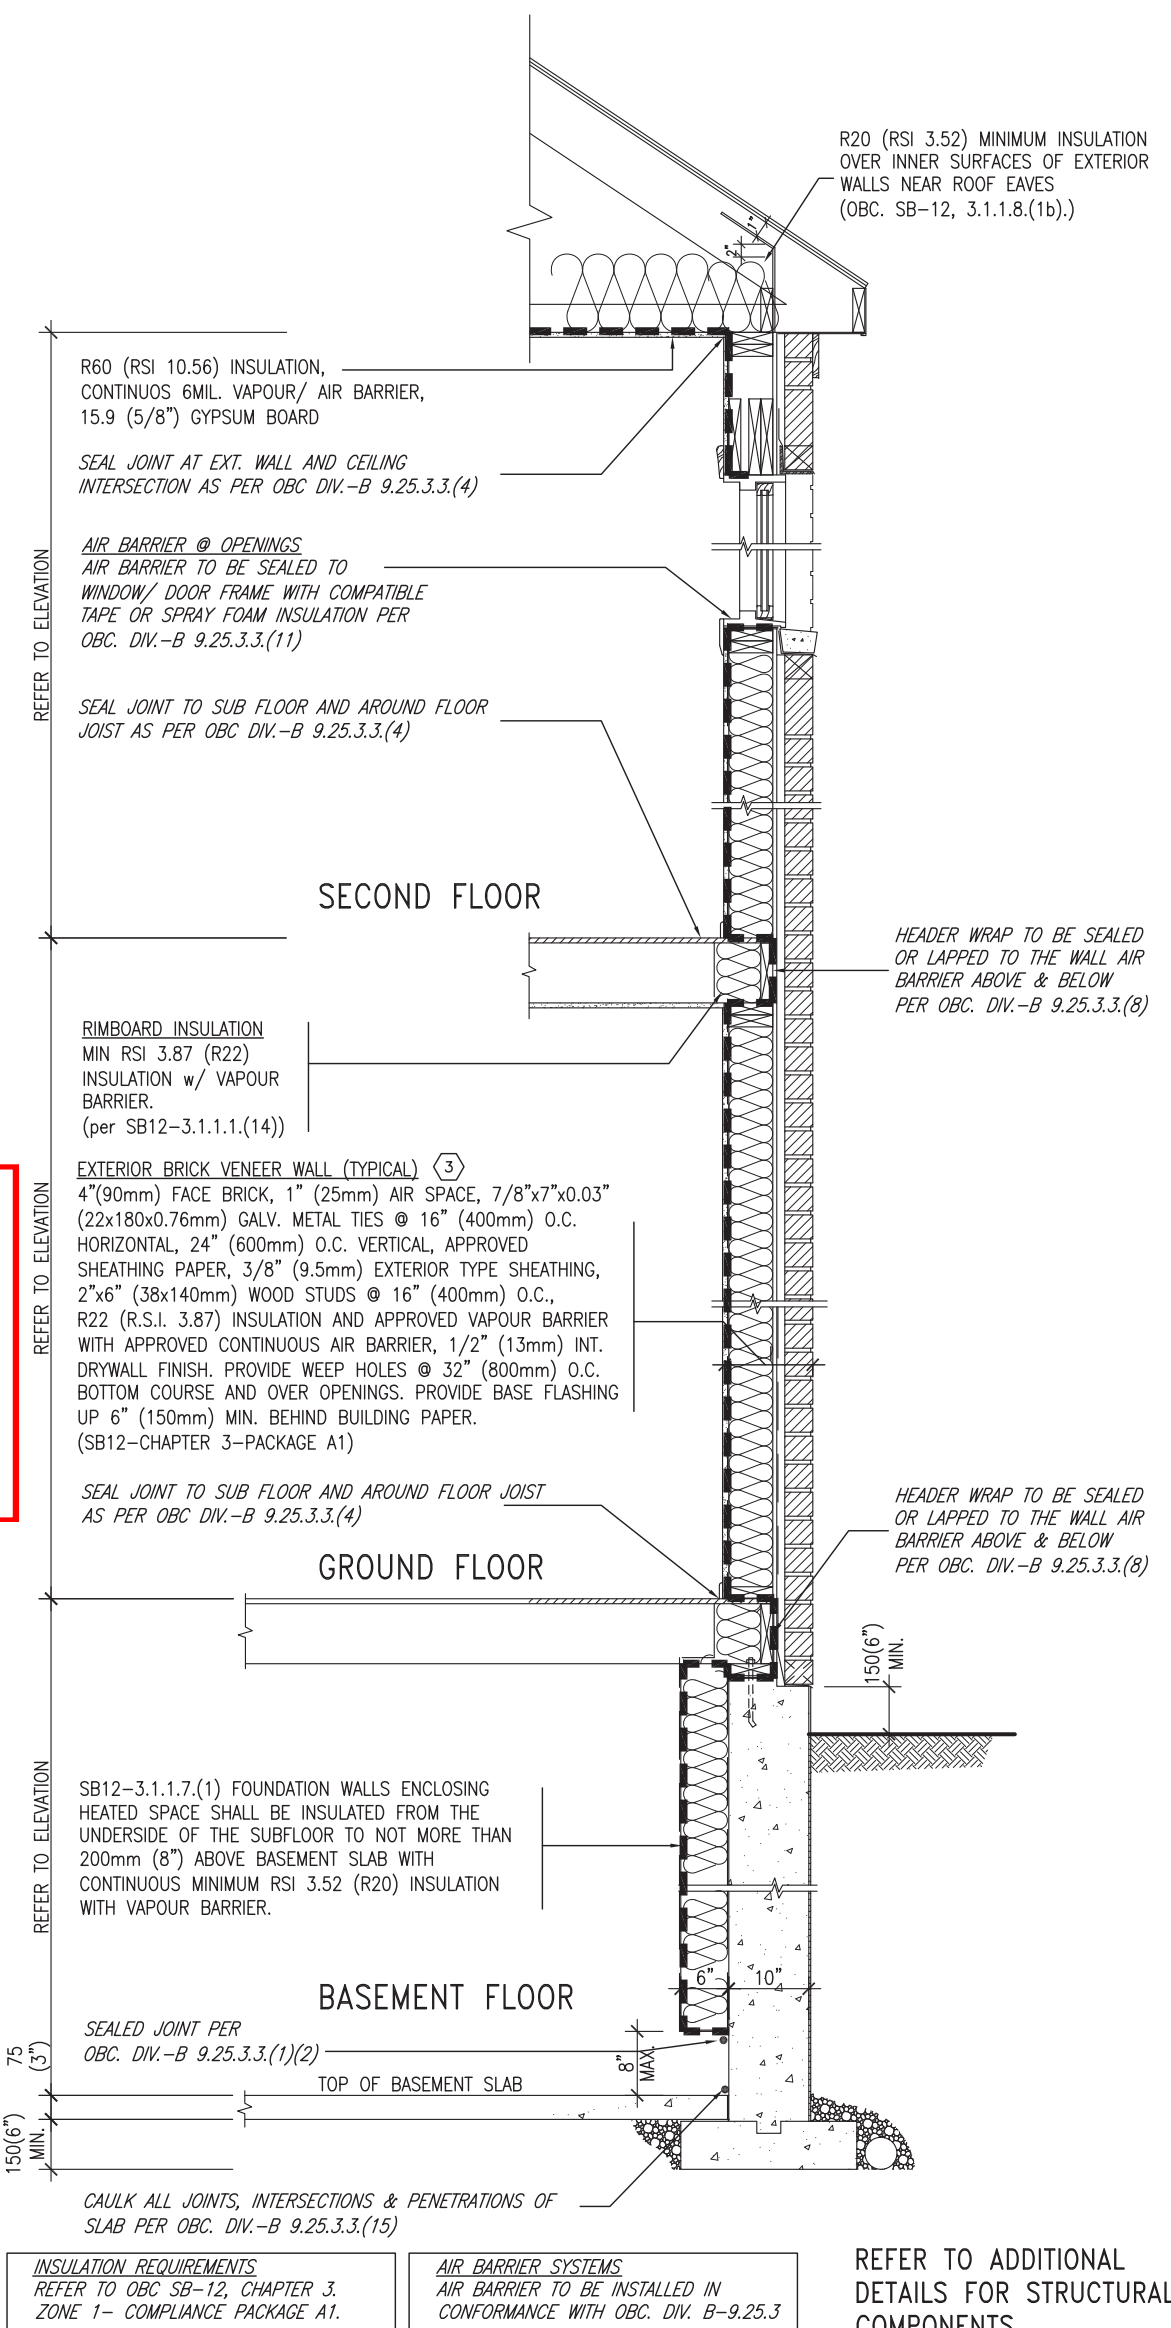

REVIEWED

EW TYPICAL EXT. WALL AIR BARRIER CONTINUITY
SECTION w/ BRICK VENEER (PACKAGE A1)
10" FOUNDATION WALL SCALE: N.T.S.

THE MINIMAL THERMAL PERFORMANCE OF BUILDING ENVELOPE AND EQUIPMENT SHALL CONFORM TO THE FOLLOWING SB-12 COMPLIANCE PACKAGE AS PER OBC SUPPLEMENTARY STANDARD SB-12, SECTION 3.1.1.1.


USE SB-12 COMPLIANCE PACKAGE (A1):

COMPONENT	A1	Notes:
Ceiling with Attic Space Minimum RSI (R) value	10.56 (R60)	R20 at inner face of exterior walls
Ceiling without Attic Space Minimum RSI (R) value	5.46 (R31)	BATT or SPRAY
Exposed Floor Minimum RSI (R) value	5.46 (R31)	BATT or SPRAY
Walls Above Grade Minimum RSI (R) value	3.87 (R22)	6" R22 BATT
Basement Walls Minimum RSI (R) value	3.52ci (R20ci)	OPTION TO USE R12+R10ci.
Edge of Below Grade Slab ≤600mm below grade Minimum RSI (R) value	1.76 (R10)	RIGID INSUL
Windows & Sliding glass Doors Maximum U-value	1.6	
Skylights Maximum U-value	2.8U	
Space Heating Equipment Minimum AFUE	96% Min.	NATURAL GAS
Hot Water Heater Minimum EF	0.8	NATURAL GAS
HRV Minimum Efficiency	75%	—
Drain Water Heat Recovery Unit (DWHR)	Minimum 1 OR Maximum 2 Required. Dependent on number of showers installed. Refer to SB12-3.1.1.12 for information	

ci- Denotes Continuous Insulation without framing interruption.



JAN 26, 2022

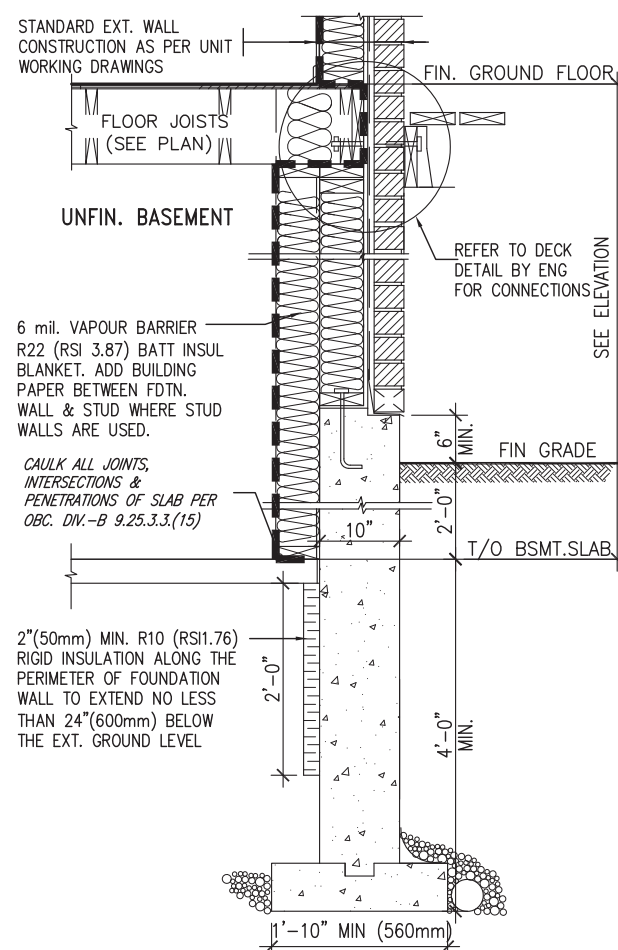

* REVISED-FEB 2017

SECTION AT W.O.D/W.O.B.

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5	.	.	.	signature BCIN
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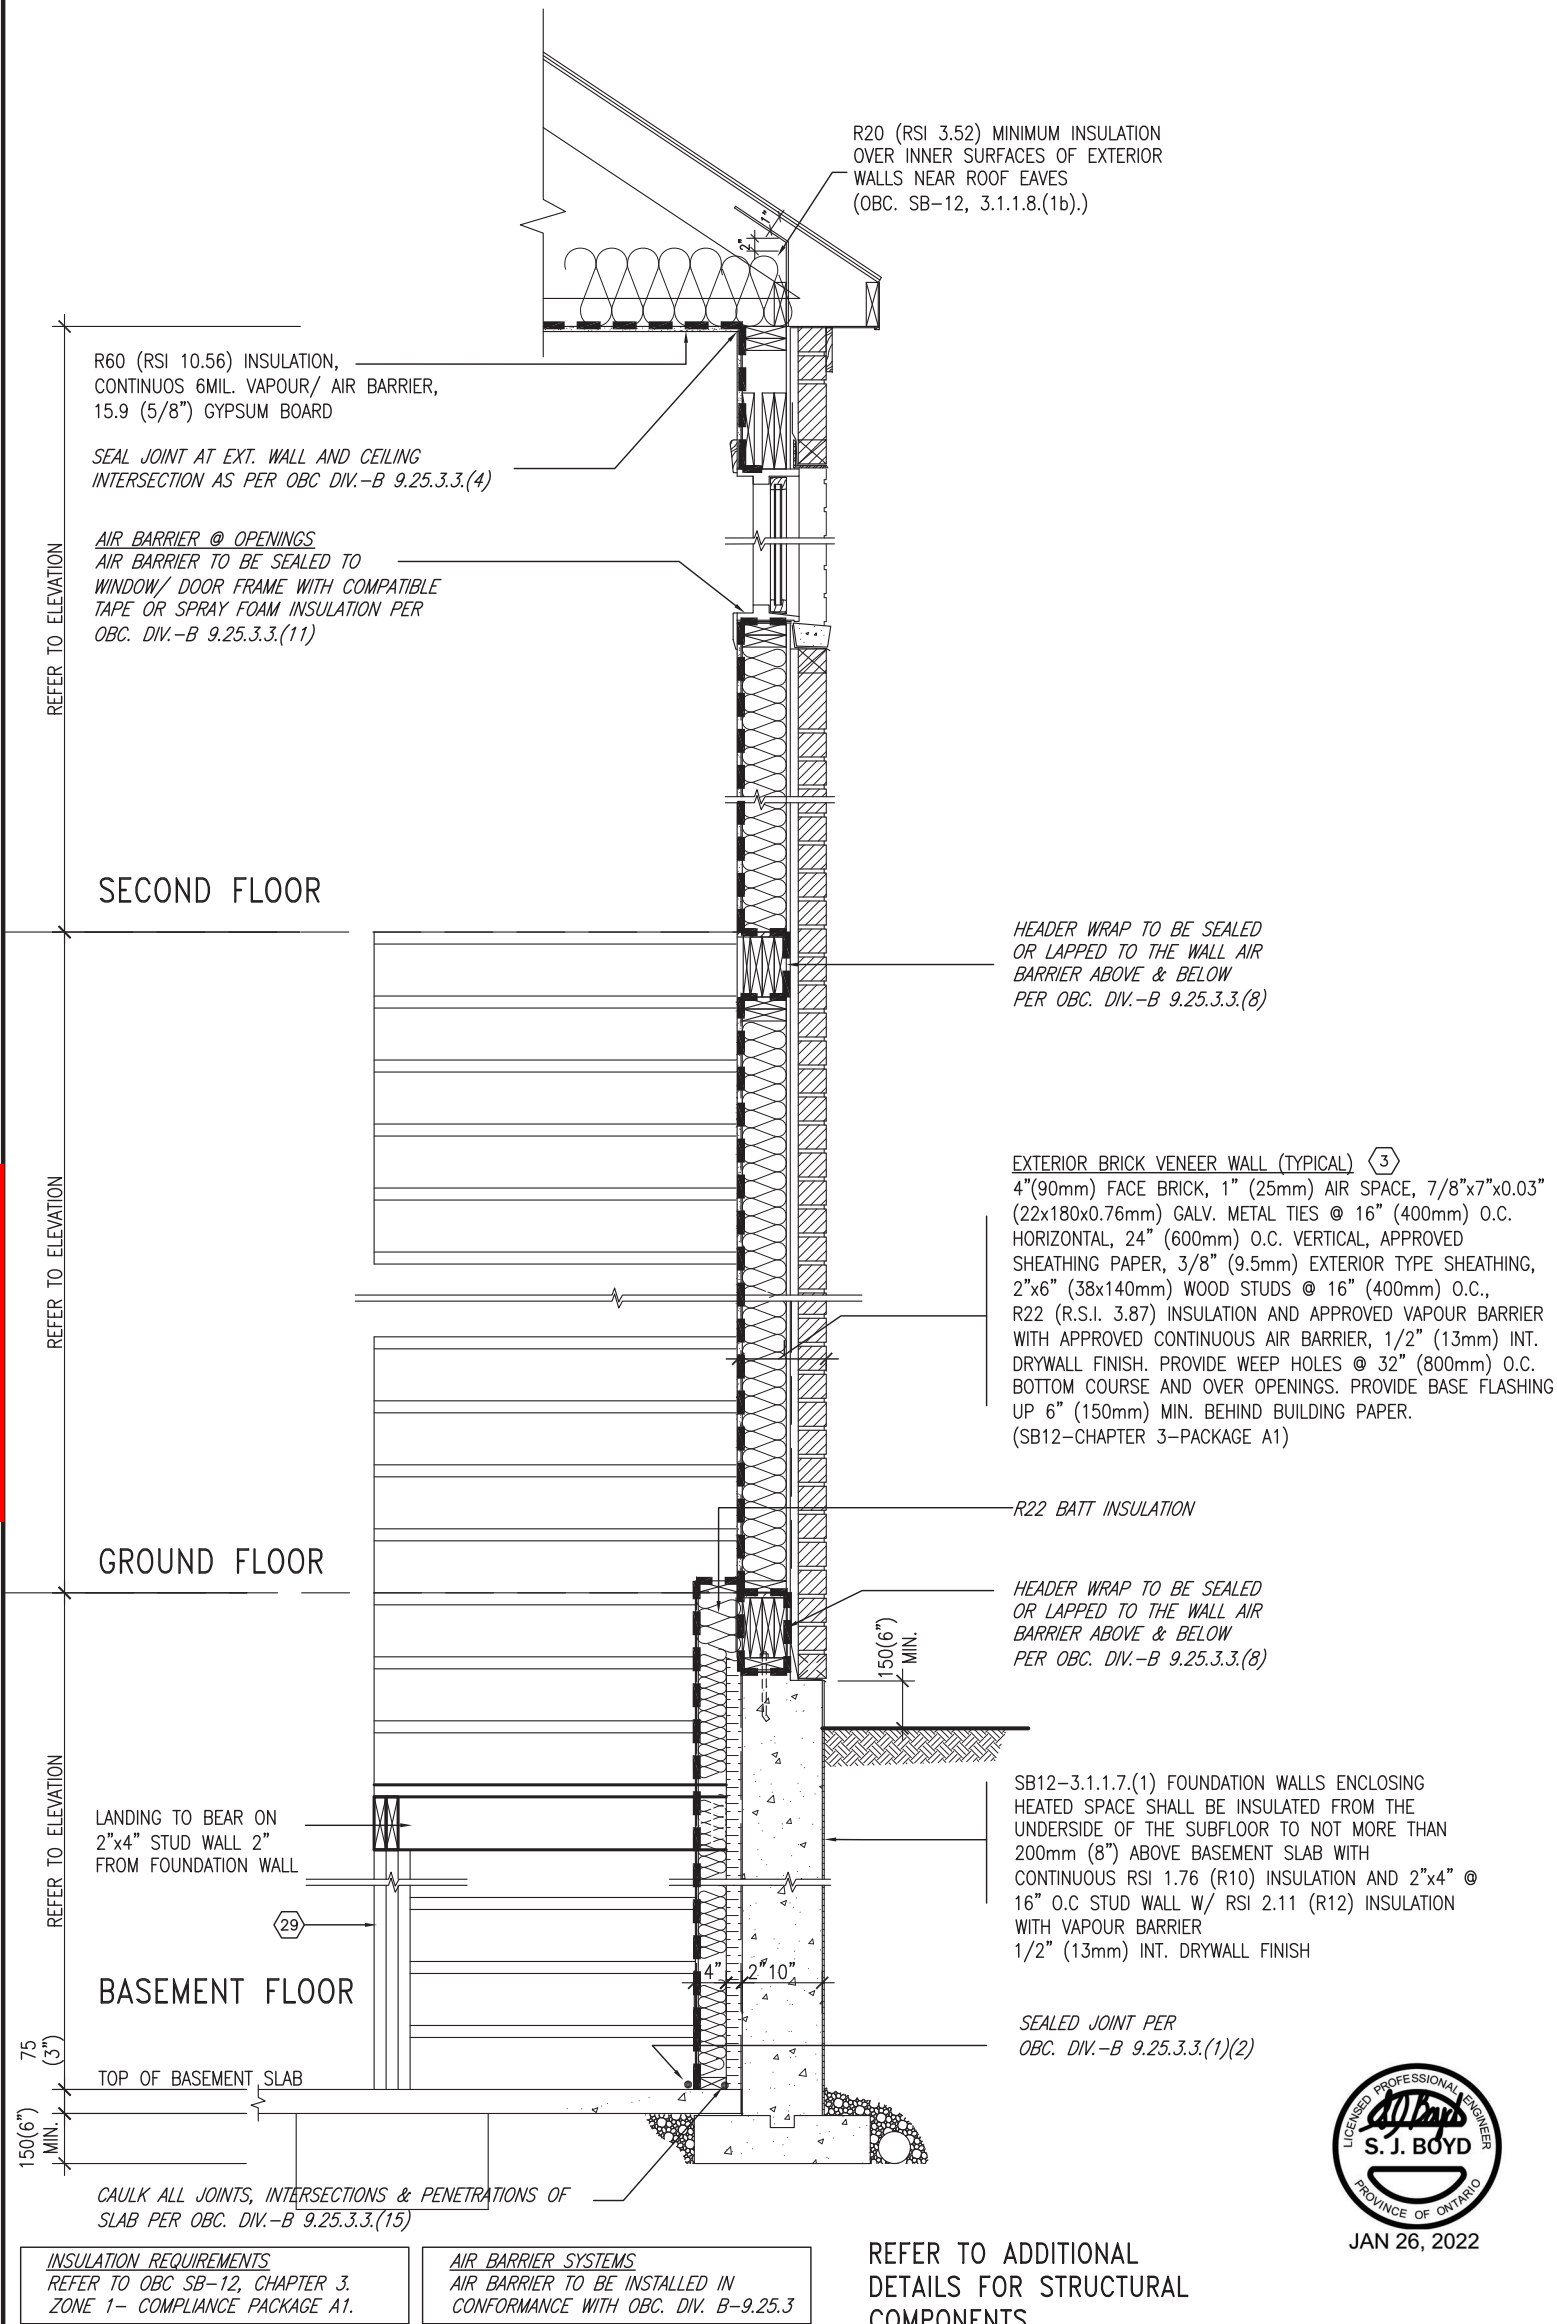
CONST NOTE

project name GREEN VALLEY EAST	municipality BRADFORD	project no. 16023
date MAY 2016		CONSTRUCTION NOTES drawing no. <div style="font-size: 2em; font-weight: bold; float: right;">CN6</div>
drawn by RC	checked by -	
scale 3/16" = 1'-0"		
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SB12-COMPLIANCE PACKAGE 'A1'

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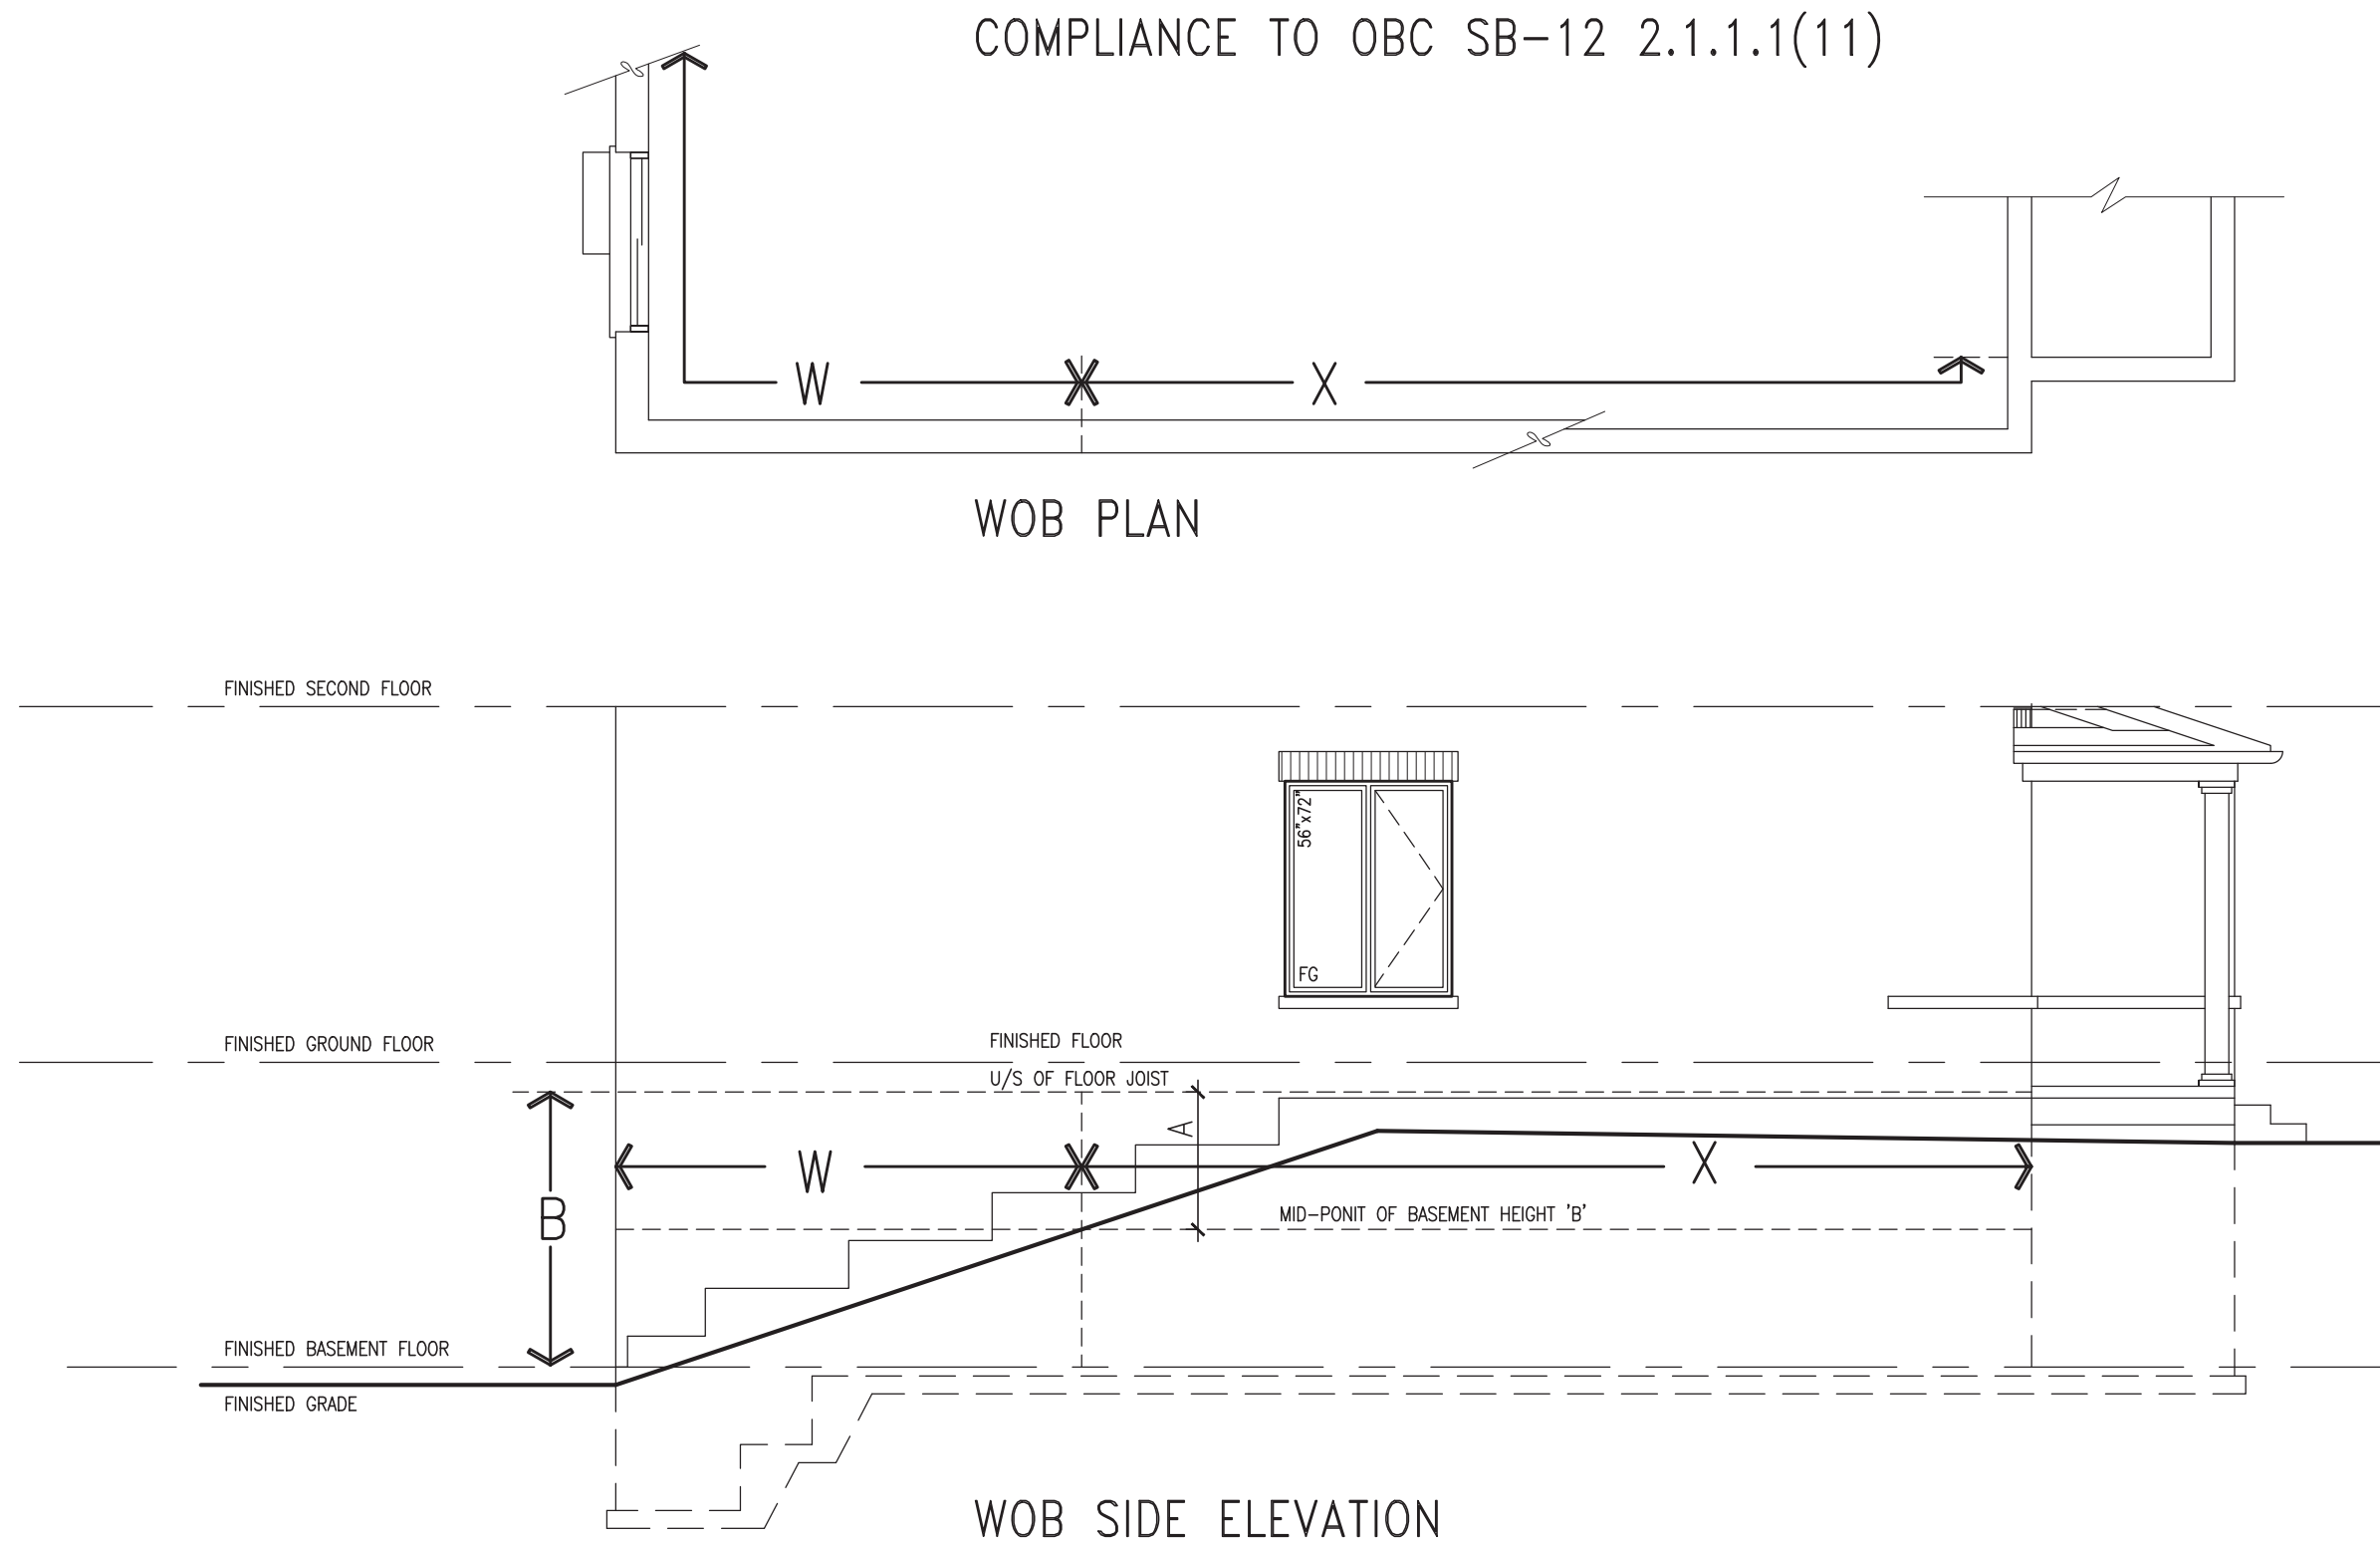
JAN 26, 2022



TYPICAL EXT. WALL AIR BARRIER CONTINUITY SECTION w/
BRICK VENEER AT STAIR AND SUNKEN COND (PACKAGE A1)
10" FOUNDATION WALL
SCALE: N.T.S.

9 .			The undersigned has reviewed and takes responsibility for this design and has the qualifications and meets the requirements set out in the Ontario Building Code to be a Designer.			BAYVIEW WELLINGTON			CONST NOTE		
8 .			7 .			project name			project no.		
6 .			5 .			GREEN VALLEY EAST			16023		
4 UPDATE TO 2022			3 UPDATE TO 2020			date			CONSTRUCTION NOTES		
2 UPDATE TO 2018			1 ISSUE FOR CLIENT REVIEW			MAY 2016			file name		
no.			description			RC			16023-CN-2022-A1		
						checked by			drawing no.		
						-			CN7		
						scale					
						3/16" = 1'-0"					
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REVIEWED



WHEN EXPOSED WALL "A" IS GREATER THAN 50%
OF BASEMENT WALL HEIGHT "B"
INSULATION VALUE FOR WALL IN SECTION "W"
IS NOT LESS THAN IS REQUIRED FOR ABOVE
GRADE WALL AS REQUIRED BY TABLE 2.1.1.2A

WHEN EXPOSED WALL "A" IS LESS THAN 50%
OF BASEMENT WALL HEIGHT "B"
INSULATION VALUE FOR WALL IN SECTION "X"
IS NOT LESS THAN BASEMENT WALL AS
REQUIRED BY TABLE 2.1.1.2A




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7	Wellington Jno-Baptiste 25591
6	name BCIN
5	signature
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no.	description	date	by						

x1

SCALE: N.T.S.

 x_2

SCALE: N.T.S.

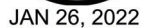

BAYVIEW WELLINGTON

project name
GREEN VALLEY EAST

date

CONSTRUCTION NOTES	file name
	16023-CN-2022-A1

$$\frac{3}{16}'' = 1'-0''$$


scale

MAY 2016
drawn by
RC

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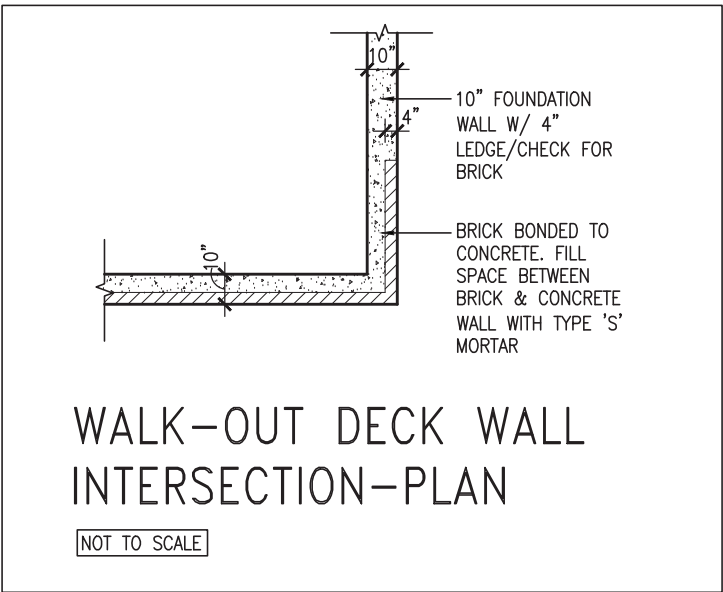
missions on the job and report any more proceeding with the work. All instruments of service and the property returned at the completion of the work.

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WALK-OUT DECK WALL INTERSECTION-ELEVATION


NOT TO SCALE

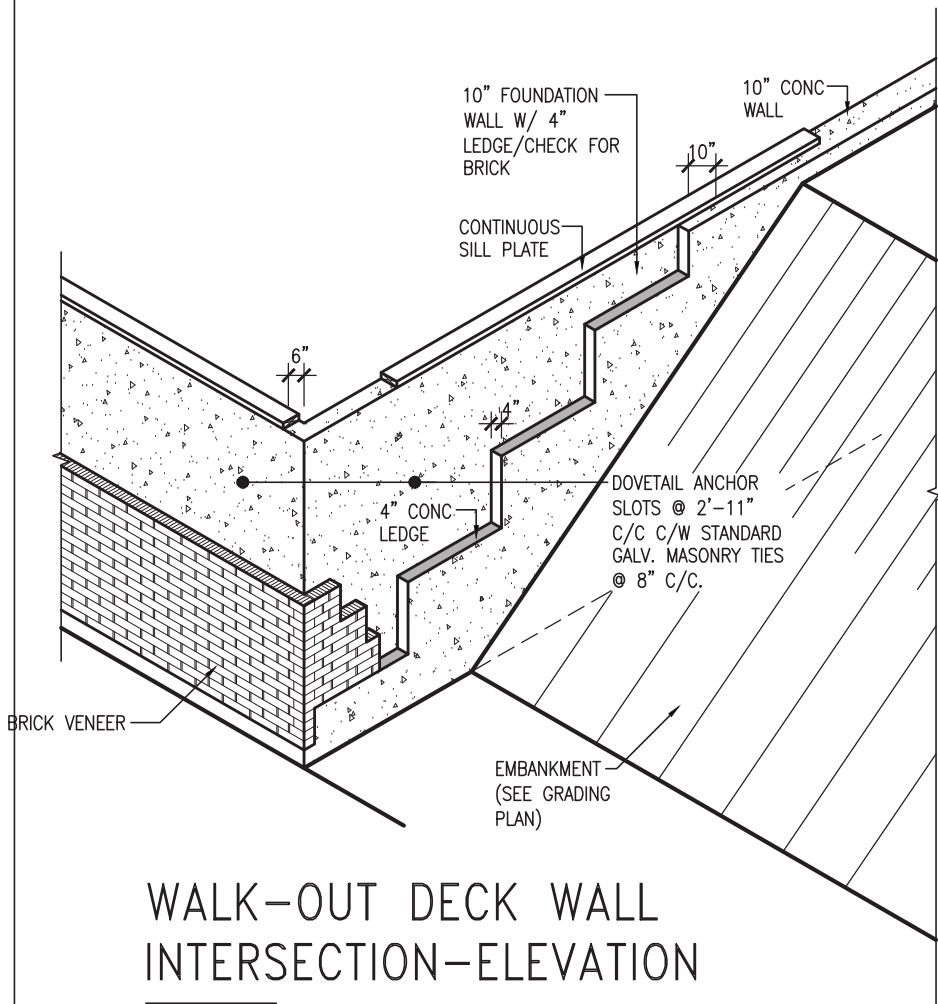

WALK-OUT DECK WALL INTERSECTION-PLAN


NOT TO SCALE

(10" FOUNDATION WALL)

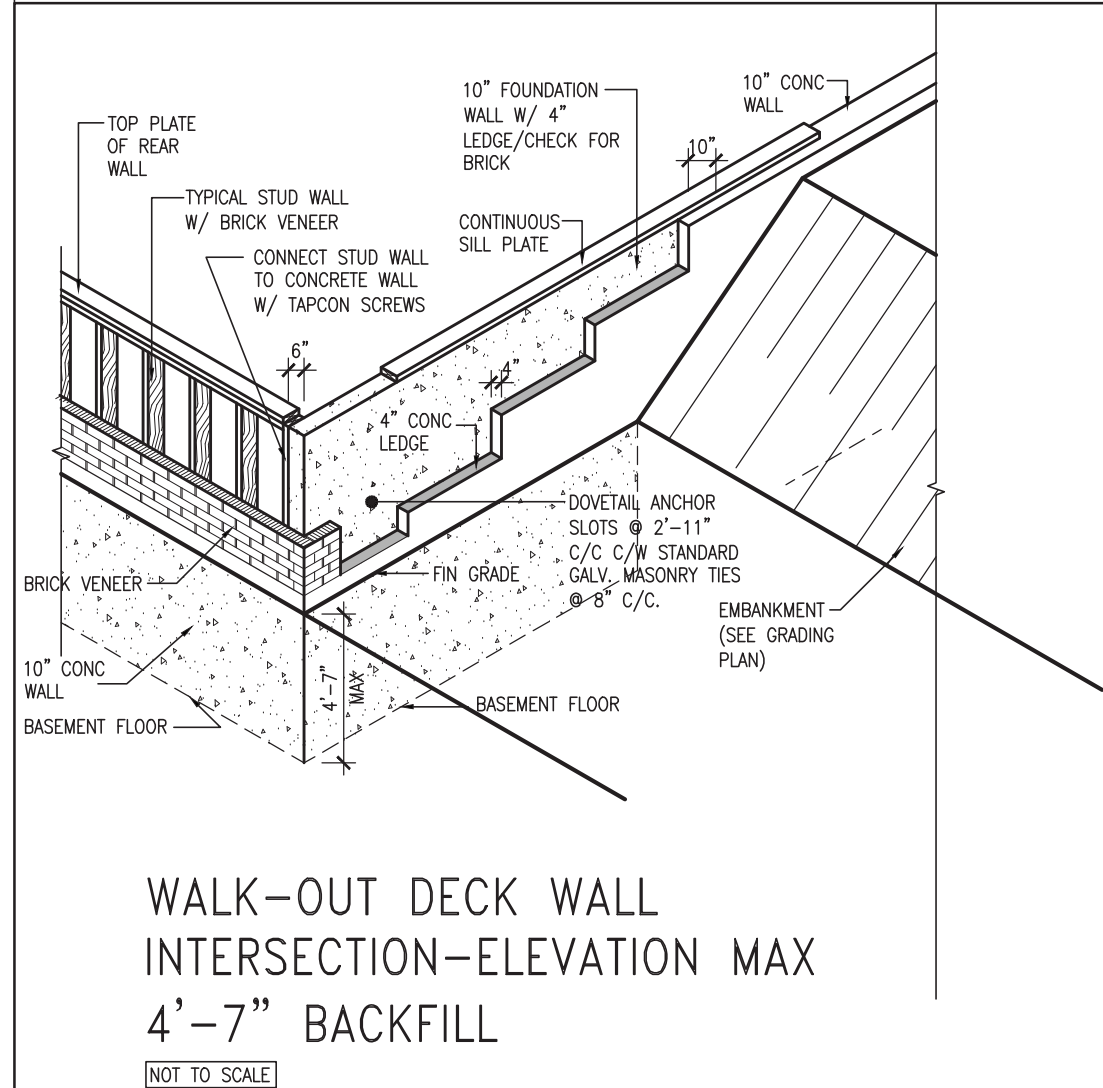

WALK-OUT DECK WALL INTERSECTION-ELEVATION MAX 4'-7" BACKFILL

NOT TO SCALE

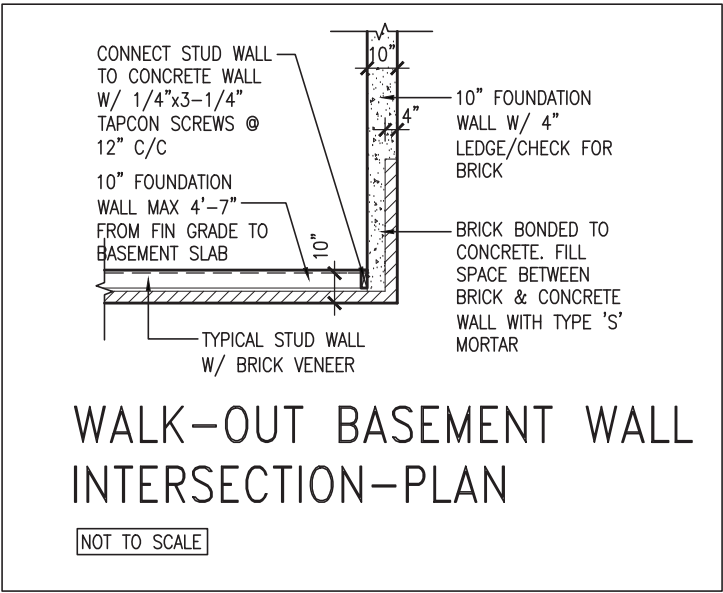

WALK-OUT BASEMENT WALL INTERSECTION-PLAN


NOT TO SCALE

(10" FOUNDATION WALL)

REVIEWED




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7	.	.	.	signature BCIN					GREEN VALLEY EAST	BRADFORD	16023
6	.	.	.	42658					date	CONSTRUCTION NOTES	
5	.	.	.						MAY 2016	drawing no.	
4	UPDATE TO 2022	JAN 11-22	RC	Contractor must verify all dimensions on the job and report any discrepancy to the Designer before proceeding with the work. All drawings and specifications are instruments of service and the property of the Designer which must be returned at the completion of the work. Drawings are not to be scaled.							
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2	UPDATE TO 2018	JAN 11-18	RC								
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no.	description	date	by								

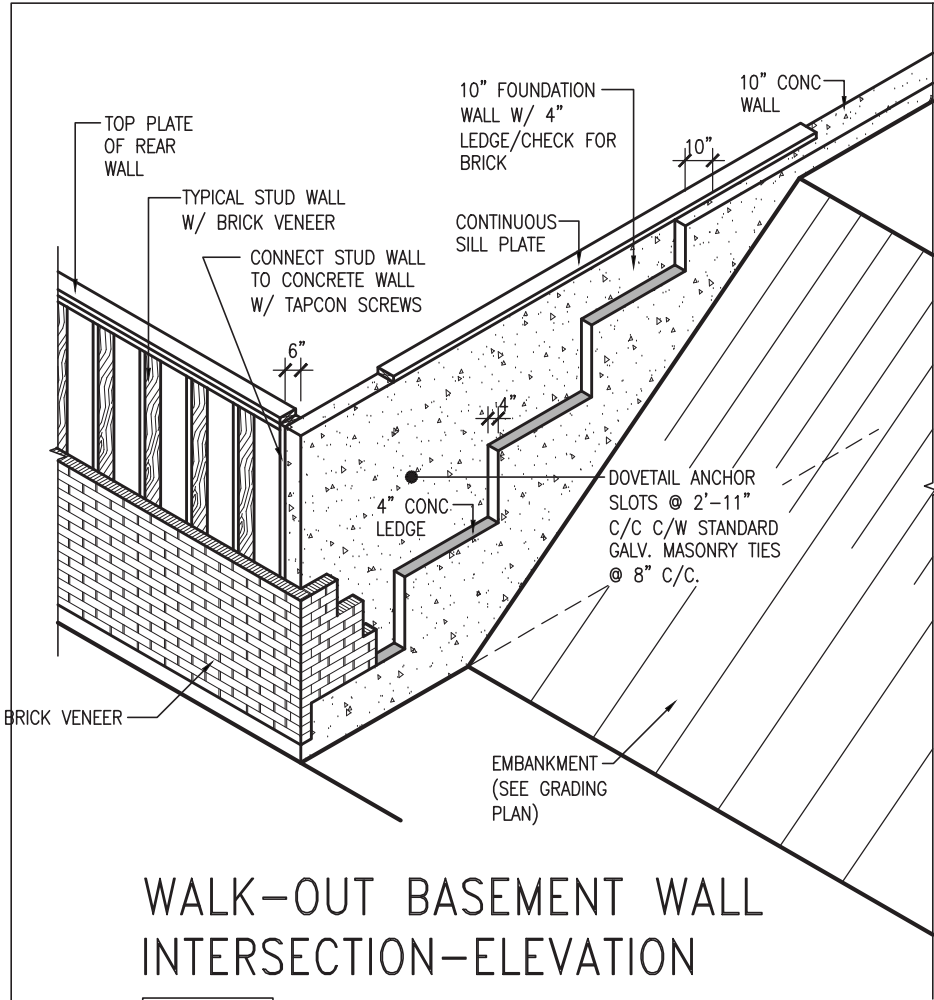

WALK-OUT BASEMENT WALL
INTERSECTION-ELEVATION


NOT TO SCALE

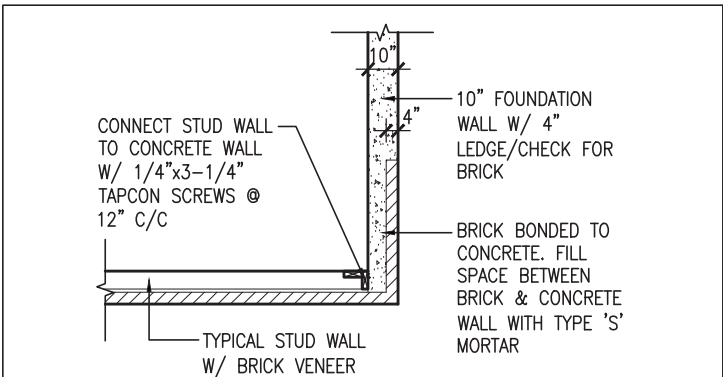

WALK-OUT BASEMENT WALL
INTERSECTION-PLAN


NOT TO SCALE

(10" FOUNDATION WALL)

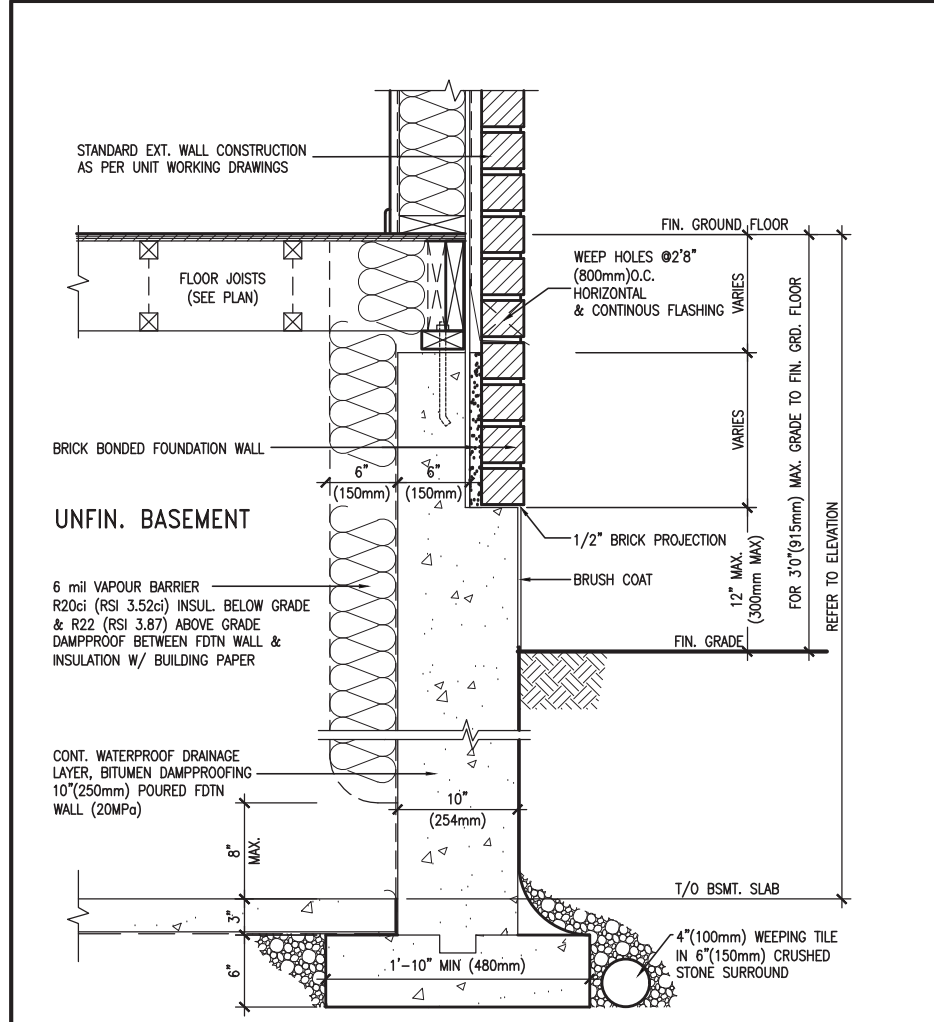

WALL SECTION FOR GRADE TO FIN.
FLOOR MORE THAN 4'7" (1400mm)
HEIGHT DIFFERENCE

SCALE: N.T.S.

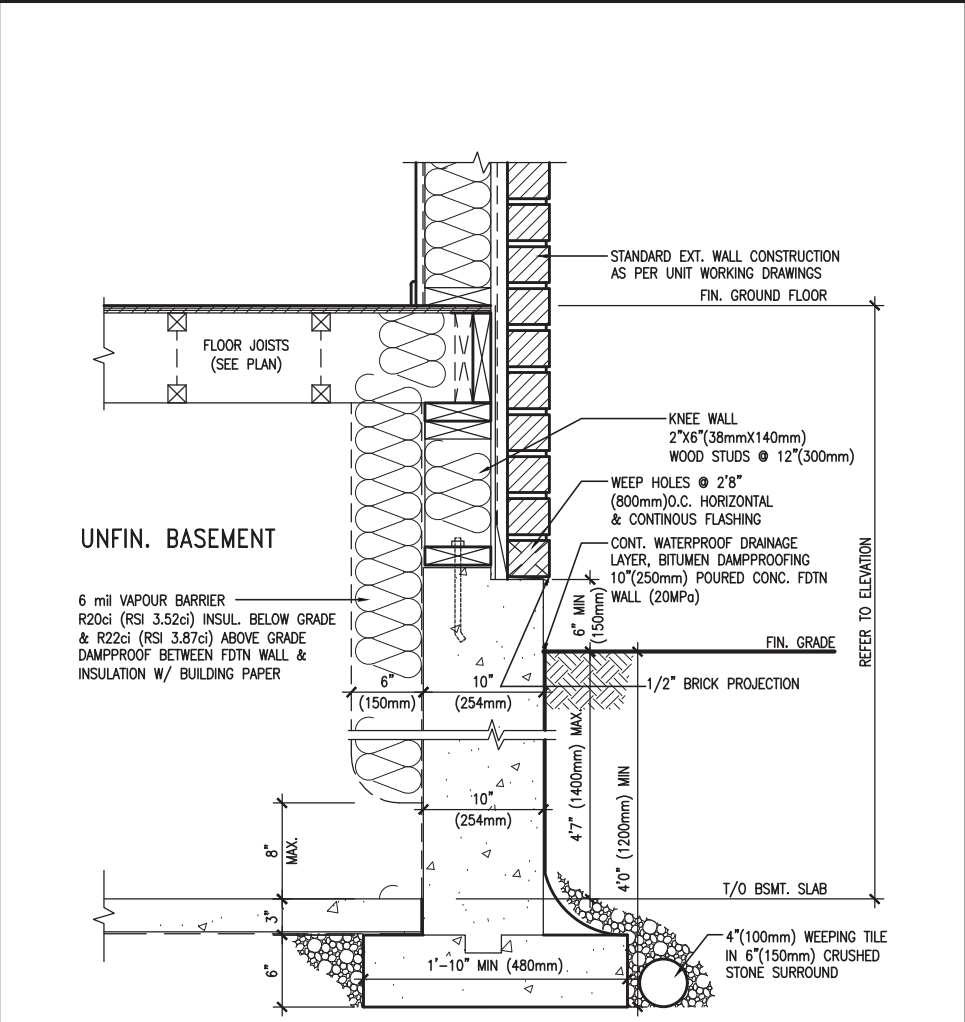

WALL SECTION FOR GRADE TO BASEMENT
SLAB 4'7" (1400mm)
MAX. HEIGHT DIFFERENCE

SCALE: N.T.S.

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CONST NOTE

project name	GREEN VALLEY EAST	municipality	BRADFORD	project no.	16023
date	MAY 2016	checked by	scale	3/16" = 1'-0"	file name
drawn by	RC			16023-CN-2022-A1	CN11
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PREFIN. METAL ROOF
CAP OVER WATERPROOF
MEMBRANE

5/8" T&G PLYWOOD
SHEATHING ON 2"x4"
SLOPED TO FRONT

2"x12" LEDGER

2"x12" @ HEADER

3"x3"x1 1/16" GALVANIZED
STANLEY CORNER BRACE
C/W (4) No. 10x1 1/2"
SCREWS AT 4'-0" O.C.

PREFIN. ALUM. FASCIA
AND SOFFIT AT U/S

DRIP EDGE

STL. LINTEL

TYPICAL BRICK VENEER
WALL CONSTRUCTION

HEATED SPACE

ENG. FLOOR JOIST

SECOND FLOOR

MIN. 6" PREFIN. METAL FLASHING W/
CAULKING TO MATCH BRICK/STONE

BUILT-UP CANOPY BOLTED THRU
LVL/WOOD BEAM (SEE UNIT PLANS) W/
1/2" Ø BOLTS STAGGERED @ 24" O.C.
W/ SOLID WD. BLK. BETWEEN STUDS

1

CN12

SECTION THROUGH CANOPY

SCALE 1/2" = 1'-0"

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7	-	-	-	Wellington Jno-Baptiste 25591					
6	-	-	-	name registration information VA3 Design Inc. 42658					
5	-	-	-	signature BCIN					
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no.	description	date	by			RICHARD - H:\ARCHIVE\WORKING\2016\16023.BW\Units\CN NOTES\16023-CN-2022-A1.dwg - Wed - Jan 26 2022 - 12:09 PM			

REVIEWED

3/16"x4"x4" PREFIN.
METAL PLATE

3/8" DIA. DECORATIVE
PREFIN. METAL ROD
WELDED TO ANCHOR
PLATE

PREFIN. METAL ROOF
CAP OVER WATERPROOF
MEMBRANE

5/8" T&G PLYWOOD
SHEATHING ON 2"x4"
SLOPED TO FRONT

2"x12" LEDGER
3/16"x4"x4" PREFIN.
METAL PLATE SCREWED
TO TOP OF CANOPY

2"x12" @ HEADER

3"x3"x1/16" GALVANIZED
STANLEY CORNER BRACE
C/W (4) No.10x1 1/2"
SCREWS AT 4'-0" O.C.

PREFIN. ALUM. FASCIA
AND SOFFIT AT U/S

DRIP EDGE

STL. LINTEL

HEATED SPACE

TYPICAL BRICK VENEER
WALL CONSTRUCTION 3

8" GALV. METAL SCREWS INTO
3-2"x6" BLOCKING

ENG. FLOOR JOIST

SECOND FLOOR

MIN. 6" PREFIN. METAL FLASHING W/
CAULKING TO MATCH BRICK/STONE

BUILT-UP CANOPY BOLTED THRU
LVL/WOOD BEAM (SEE UNIT PLANS) W/
1/2" Ø BOLTS STAGGERED @ 24" O.C.
W/ SOLID WD. BLK. BETWEEN STUDS

1

CN13

SECTION THROUGH CANOPY

W/ DECORATIVE ROD

SCALE 1/2" = 1'-0"



JAN 26, 2022

9	.	.	.	The undersigned has reviewed and takes responsibility for this design and has the qualifications and meets the requirements set out in the Ontario Building Code to be a Designer.	<div><div>VA3</div><div>DESIGN</div><div>255 Consumers Rd Suite 120 Toronto ON M2J 1R4 t 416.630.2255 f 416.630.4782 va3design.com</div></div>	<div>BAYVIEW WELLINGTON</div> <div>project name GREEN VALLEY EAST</div> <div>date MAY 2016</div> <div>drawn by RC</div> <div>checked by -</div> <div>scale 3/16" = 1'-0"</div> <div>file name 16023-CN-2022-A1</div> <div>RICHARD - H:\ARCHIVE\WORKING\2016\16023.BW\Units\CN NOTES\16023-CN-2022-A1.dwg - Wed - Jan 26 2022 - 12:09 PM</div>	<div>CONST NOTE</div> <div>-</div> <div>project no. 16023</div> <div>drawing no. CN13</div>
8	.	.	.	qualification information			
7	.	.	.	Wellington Jno-Baptiste 25591			
6	.	.	.	name registration information VA3 Design Inc. 42658			
5	.	.	.	Contractor must verify all dimensions on the job and report any discrepancy to the Designer before proceeding with the work. All drawings and specifications are instruments of service and the property of the Designer which must be returned at the completion of the work. Drawings are not to be scaled.			
4	UPDATE TO 2022	JAN 11-22	RC				
3	UPDATE TO 2020	FEB 24-20	RC				
2	UPDATE TO 2018	JAN 11-18	RC				
1	ISSUE FOR CLIENT REVIEW	AUG 04-17	RC				
no.	description			date	by	RICHARD - H:\ARCHIVE\WORKING\2016\16023.BW\Units\CN NOTES\16023-CN-2022-A1.dwg - Wed - Jan 26 2022 - 12:09 PM	

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REVIEWED

3/16"x4"x4" PREFIN.
METAL PLATE

3/8" DIA. DECORATIVE
PREFIN. METAL ROD
WELDED TO ANCHOR
PLATE

PREFIN. METAL ROOF
CAP OVER WATERPROOF
MEMBRANE

5/8" T&G PLYWOOD
SHEATHING ON 2"x4"
SLOPED TO FRONT

2"x12" LEDGER

3/16"x4"x4" PREFIN.
METAL PLATE SCREWED
TO TOP OF CANOPY

2"x12" @ HEADER

3"x3"x1 1/16" GALVANIZED
STANLEY CORNER BRACE
C/W (4) No. 10x1 1/2"
SCREWS AT 4'-0" O.C.

PREFIN. ALUM. FASCIA
AND SOFFIT AT U/S

DRIP EDGE

STL. LINTEL

8" GALV. METAL SCREWS INTO
3-2"x6" BLOCKING

PREFINISHED METAL FLASHING
OVER WATERPROOF MEMBRANE

2"x6" @ 12" O.C. NAILED TO
2"x8" JOIST BELOW

CANT STRIP

ROOF NOTE R1

SINGLE PLY ROOF MEMBRANE
W/ 5/8" EXTERIOR GRADE

SHEATHING W/ 2"x4" @ 12"
O.C. DIAGONALLY CUT CROSS
PURLINS 2"x8" @ 16" O.C. W/

MIN. 6" PREFIN. METAL FLASHING W/
CAULKING TO MATCH BRICK/STONE

BUILT-UP CANOPY BOLTED THRU
LVL/WOOD BEAM (SEE UNIT PLANS) W/
1/2" Ø BOLTS STAGGERED @ 24" O.C.
W/ SOLID WD. BLK. BETWEEN STUDS

1

CN14

SECTION THROUGH CANOPY

W/ DECORATIVE ROD

SCALE 1/2" = 1'-0"



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8	.	.	.	qualification information			
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6	.	.	.	registration information			
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3	UPDATE TO 2020	FEB 24-20	RC				
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no.	description	date	by				

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