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This is to certify that these plans comply with the applicable Architectural Design Guidelines approved by the Town of BRADFORD / WEST GWILLIMBURY.

JOHN G. WILLIAMS LTD., ARCHITECT
ARCHITECTURAL CONTROL REVIEW
AND APPROVAL

APPROVED BY:

DATE: MAR 03, 2022

This stamp certifies compliance with the applicable Design Guidelines only and bears no further professional responsibility.

22"x6" THK. CONC.
FOOTING UNDER
EXTERIOR WALL (TYP.)

2"x8" @
16" O.C. (H)

REFER TO DETAIL
1/S1 FOR
LATERAL SUPPORT
@ STAIR OPENING

3-2"x6" ON
30"x28"x12"
FOOTING

BASEMENT INSULATION @ STAIR/
SUNKEN AREA
-2"(R10) CONTINUOUS INSULATION
RIGID OR SPRAY FOAM)
-2"x4"@16"O.C W/ R12 BATT
INSULATION & 1/2" DRYWALL
FINISH
-EXTENDED EXTERIOR WALL FOOTING
TO SUPPORT 2"x4" WALL WHERE
LOAD BEARING.

CHECK FOUNDATION
WALL FOR SUNKEN
FLOOR ABOVE

FULL HEIGHT
INSUL.


4" DIA. VENT SLEEVE
W/ INSECT SCREEN

NOTE: SPACE ALL FLOOR
JOISTS @ 12" O.C. UNDER
ALL CERAMIC TILE AREAS.

NOTE: ALL LVL'S SUPPORTING
FLOOR LOADS ARE TO BE
SPECIFIED BY FLOOR TRUSS
MANUFACTURER.

NOTE: FLOOR FRAMING INFO
REFER TO SHOP DRAWINGS
FOR ALL TRUSS-JOIST
INFORMATION AND DETAILS.
UNLESS OTHERWISE NOTED.

NOTE J1: PROVIDE SOLID BLOCKING
@ 24" O.C. WHERE FLOOR JOISTS ARE
PARALLEL TO FOUNDATION WALL (TYP.)

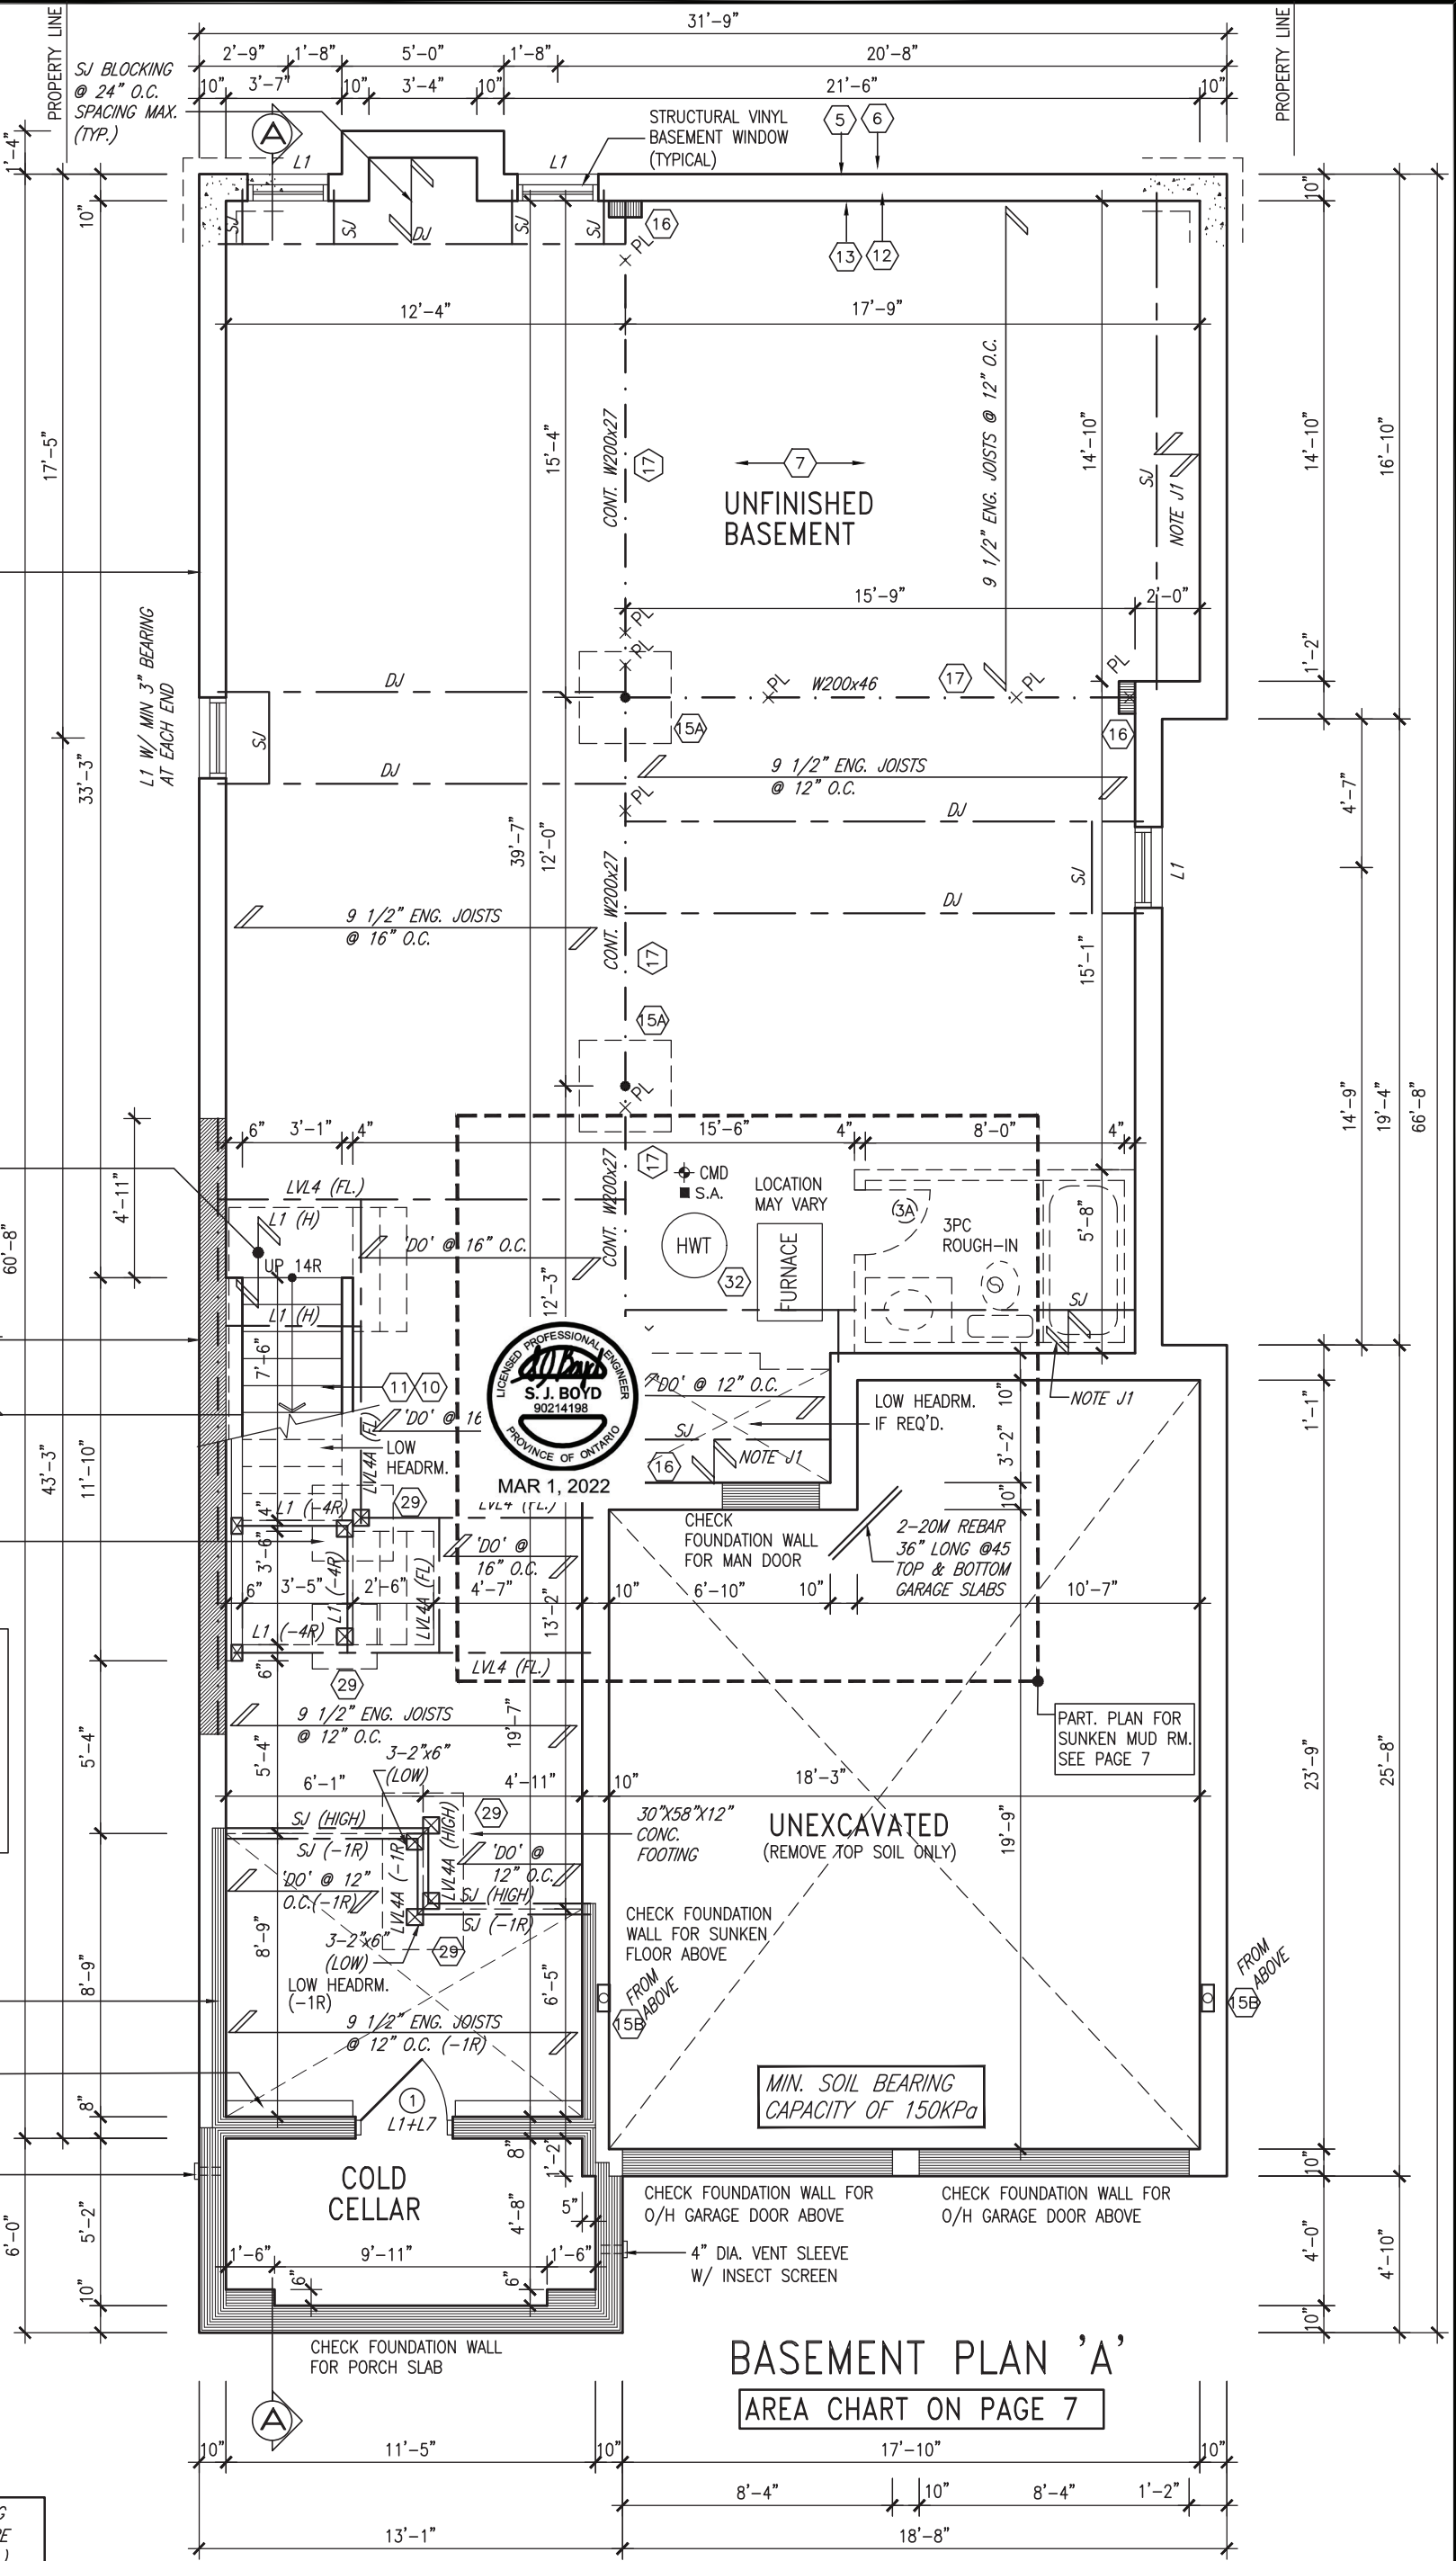

BASEMENT PLAN 'A'
AREA CHART ON PAGE 7

| | | | |
|-----|-------------------------------------|-----------|-----|
| 9. | . | . | . |
| 8. | . | . | . |
| 7. | . | . | . |
| 6. | . | . | . |
| 5. | . | . | . |
| 4. | . | . | . |
| 3. | REVISED AS PER ENG COMMENTS | MAR 01-22 | RC |
| 2. | REVISED AS PER FLOOR / ROOF LAYOUTS | FEB 24-22 | RC |
| 1. | ISSUED FOR CLIENT REVIEW | NOV 23-21 | VA3 |
| no. | description | date | by |

The undersigned has reviewed and takes responsibility for this design and has the qualifications and meets the requirements set out in the Ontario Building Code to be a Designer.

qualification information
Wellington Jno-Baptiste 25591
name
signature
registration information
VA3 Design Inc. 42658

Contractor must verify all dimensions on the job and report any discrepancy to the Designer before proceeding with the work. All drawings and specifications are instruments of service and the property of the Designer which must be returned at the completion of the work. Drawings are not to be scaled.

VA3
DESIGN
255 Consumers Rd Suite 120
Toronto ON M2J 1R4
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va3design.com

| | | | |
|--------------------|----------------------|--------------|--------------------|
| BAYVIEW WELLINGTON | | S38-20 | |
| project name | GREEN VALLEY ESTATES | municipality | BRADFORD EAST, ON. |
| date | SEPT. 2021 | project no. | 16023 |
| drawn by | NC | checked by | JWM |
| scale | 3/16" = 1'-0" | file name | 16023-S38-20 |
| BASEMENT PLAN 'A' | | drawing no. | |
| 1 | | 1 | |

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MAR 1, 2022

DOOR HEIGHTS


| CEILING HEIGHT | DOOR HEIGHT |
|------------------|-------------|
| 11'0" or greater | 8'0" (96") |
| 10'0" | 8'0" (96") |
| 9'0" | 6'8" (80") |
| 8'0" or lower | 6'8" (80") |

CONTRACTOR TO CONFIRM HEIGHTS WITH BUILDER

NOTE: SPACE ALL FLOOR JOISTS @ 12" O.C. UNDER ALL CERAMIC TILE AREAS.

NOTE: ALL LVL'S SUPPORTING FLOOR LOADS ARE TO BE SPECIFIED BY FLOOR TRUSS MANUFACTURER.

NOTE: FLOOR FRAMING INFO REFER TO SHOP DRAWINGS FOR ALL TRUSS-JOIST INFORMATION AND DETAILS. UNLESS OTHERWISE NOTED.

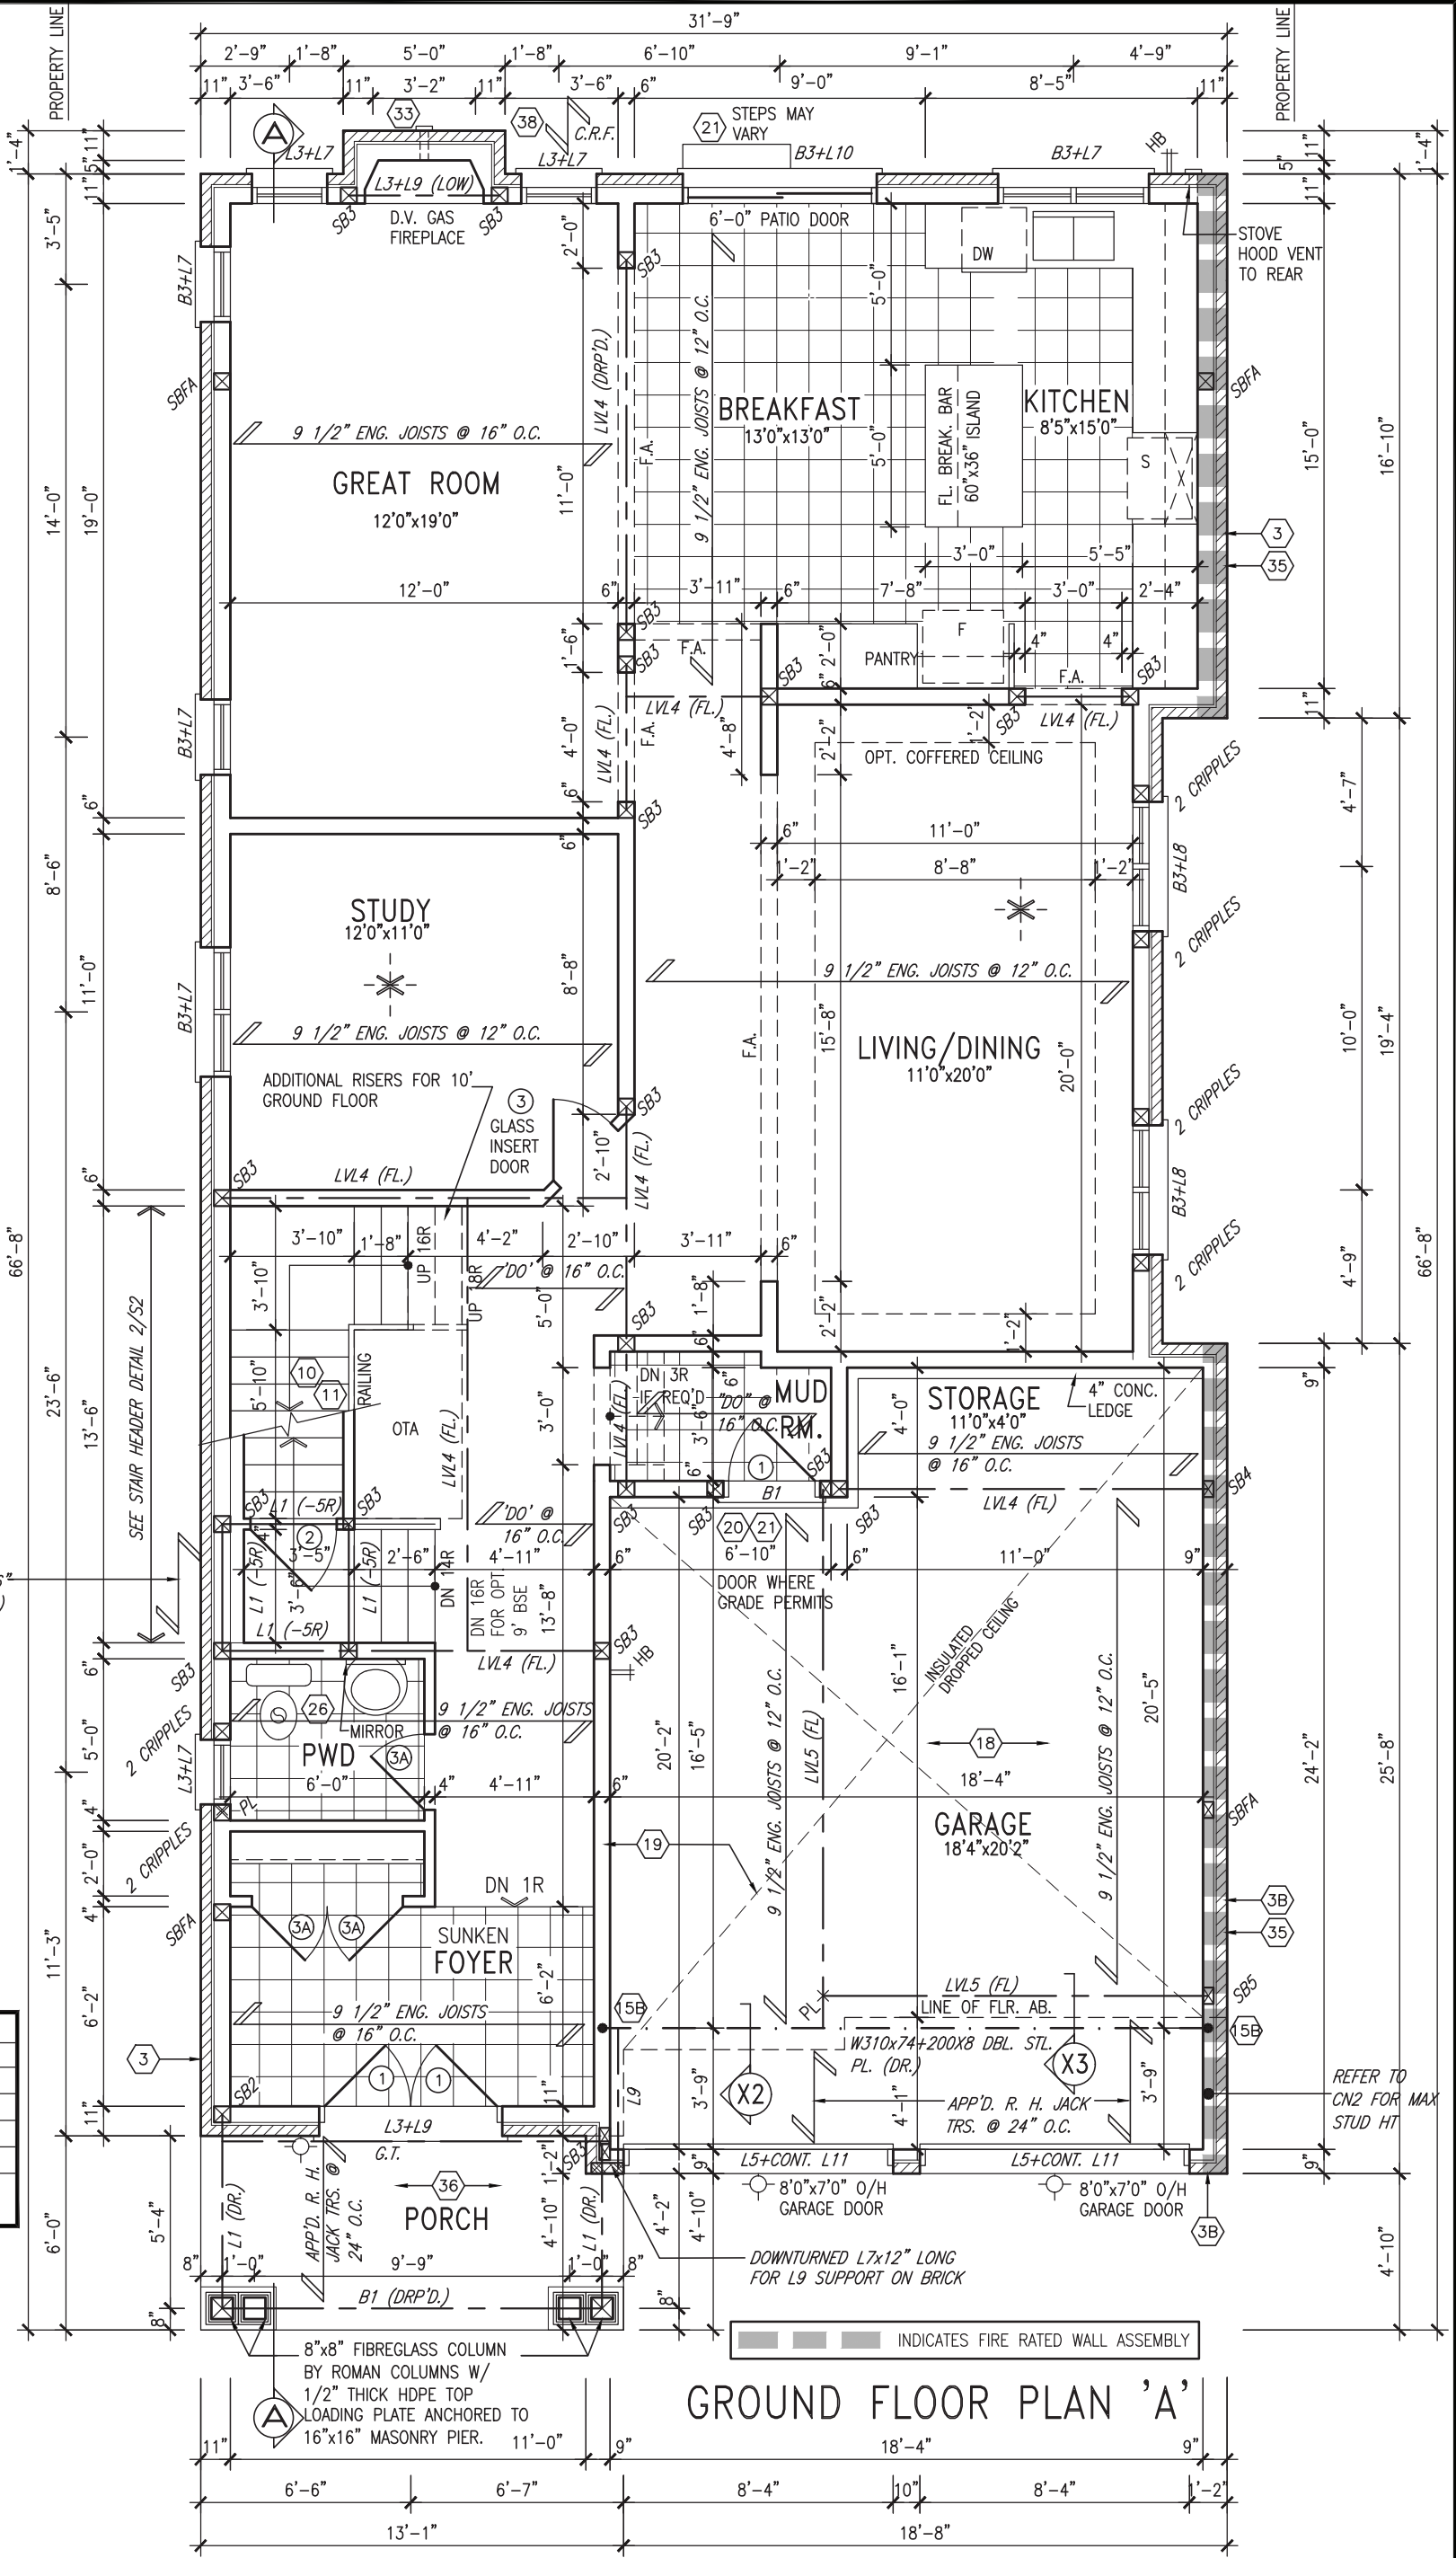

GROUND FLOOR PLAN 'A'

| | | |
|-----|-------------------------------------|---------------|
| 9. | . | . |
| 8. | . | . |
| 7. | . | . |
| 6. | . | . |
| 5. | . | . |
| 4. | . | . |
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| 2. | REVISED AS PER FLOOR / ROOF LAYOUTS | FEB 24-22 RC |
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| no. | description | date by |

| | | |
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| qualification information | | |
| Wellington Jno-Baptiste | signature | 25591 |
| name | BCIN | |
| registration information | | 42658 |
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VA3
DESIGN

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BAYVIEW WELLINGTON

S38-20

| | | | | | |
|---|----------------------|--------------|--------------------|-------------|---------------|
| project name | GREEN VALLEY ESTATES | municipality | BRADFORD EAST, ON. | project no. | 16023 |
| date | SEPT. 2021 | checked by | JWM | scale | 3/16" = 1'-0" |
| drawn by | NC | file name | 16023-S38-20 | drawing no. | 2 |
| RICHARD - H:\ARCHIVE\WORKING\2016\16023.BW\Units\38\16023-S38-20.dwg - Tue - Mar 1 2022 - 2:38 PM | | | | | |

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ARCHITECTURAL CONTROL REVIEW
AND APPROVAL

APPROVED BY:

DATE: MAR 03, 2022

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MAR 1, 2022

GRAB BAR NOTE:


STUD WALL REINFORCEMENT FOR FUTURE GRAB BARS IN MAIN BATHROOM

REINFORCEMENT OF STUD WALLS SHALL BE INSTALLED ADJACENT TO WATER CLOSETS AND SHOWER OR BATHTUB IN MAIN BATHROOM PER OBC, DIV. B-9.5.2.3. REFER TO FOLLOWING SECTIONS FOR THE FIXTURES LISTED. WATER CLOSET: 3.8.3.8.(3)(a) & 3.8.3.8.(3)(c). SHOWER 3.8.3.13.(2)(g). BATHTUB 3.8.3.13.(4)(e). FREE STANDING BATHTUB EXCLUDED. SEE DETAILS PROVIDED.

GB-NOTE-2020.dwg

NOTE: ROOF FRAMING

ROOF TRUSS INFORMATION REFER TO ROOF TRUSS SHOP DRAWINGS FOR ALL ROOF FRAMING INFORMATION UNLESS OTHERWISE NOTED.

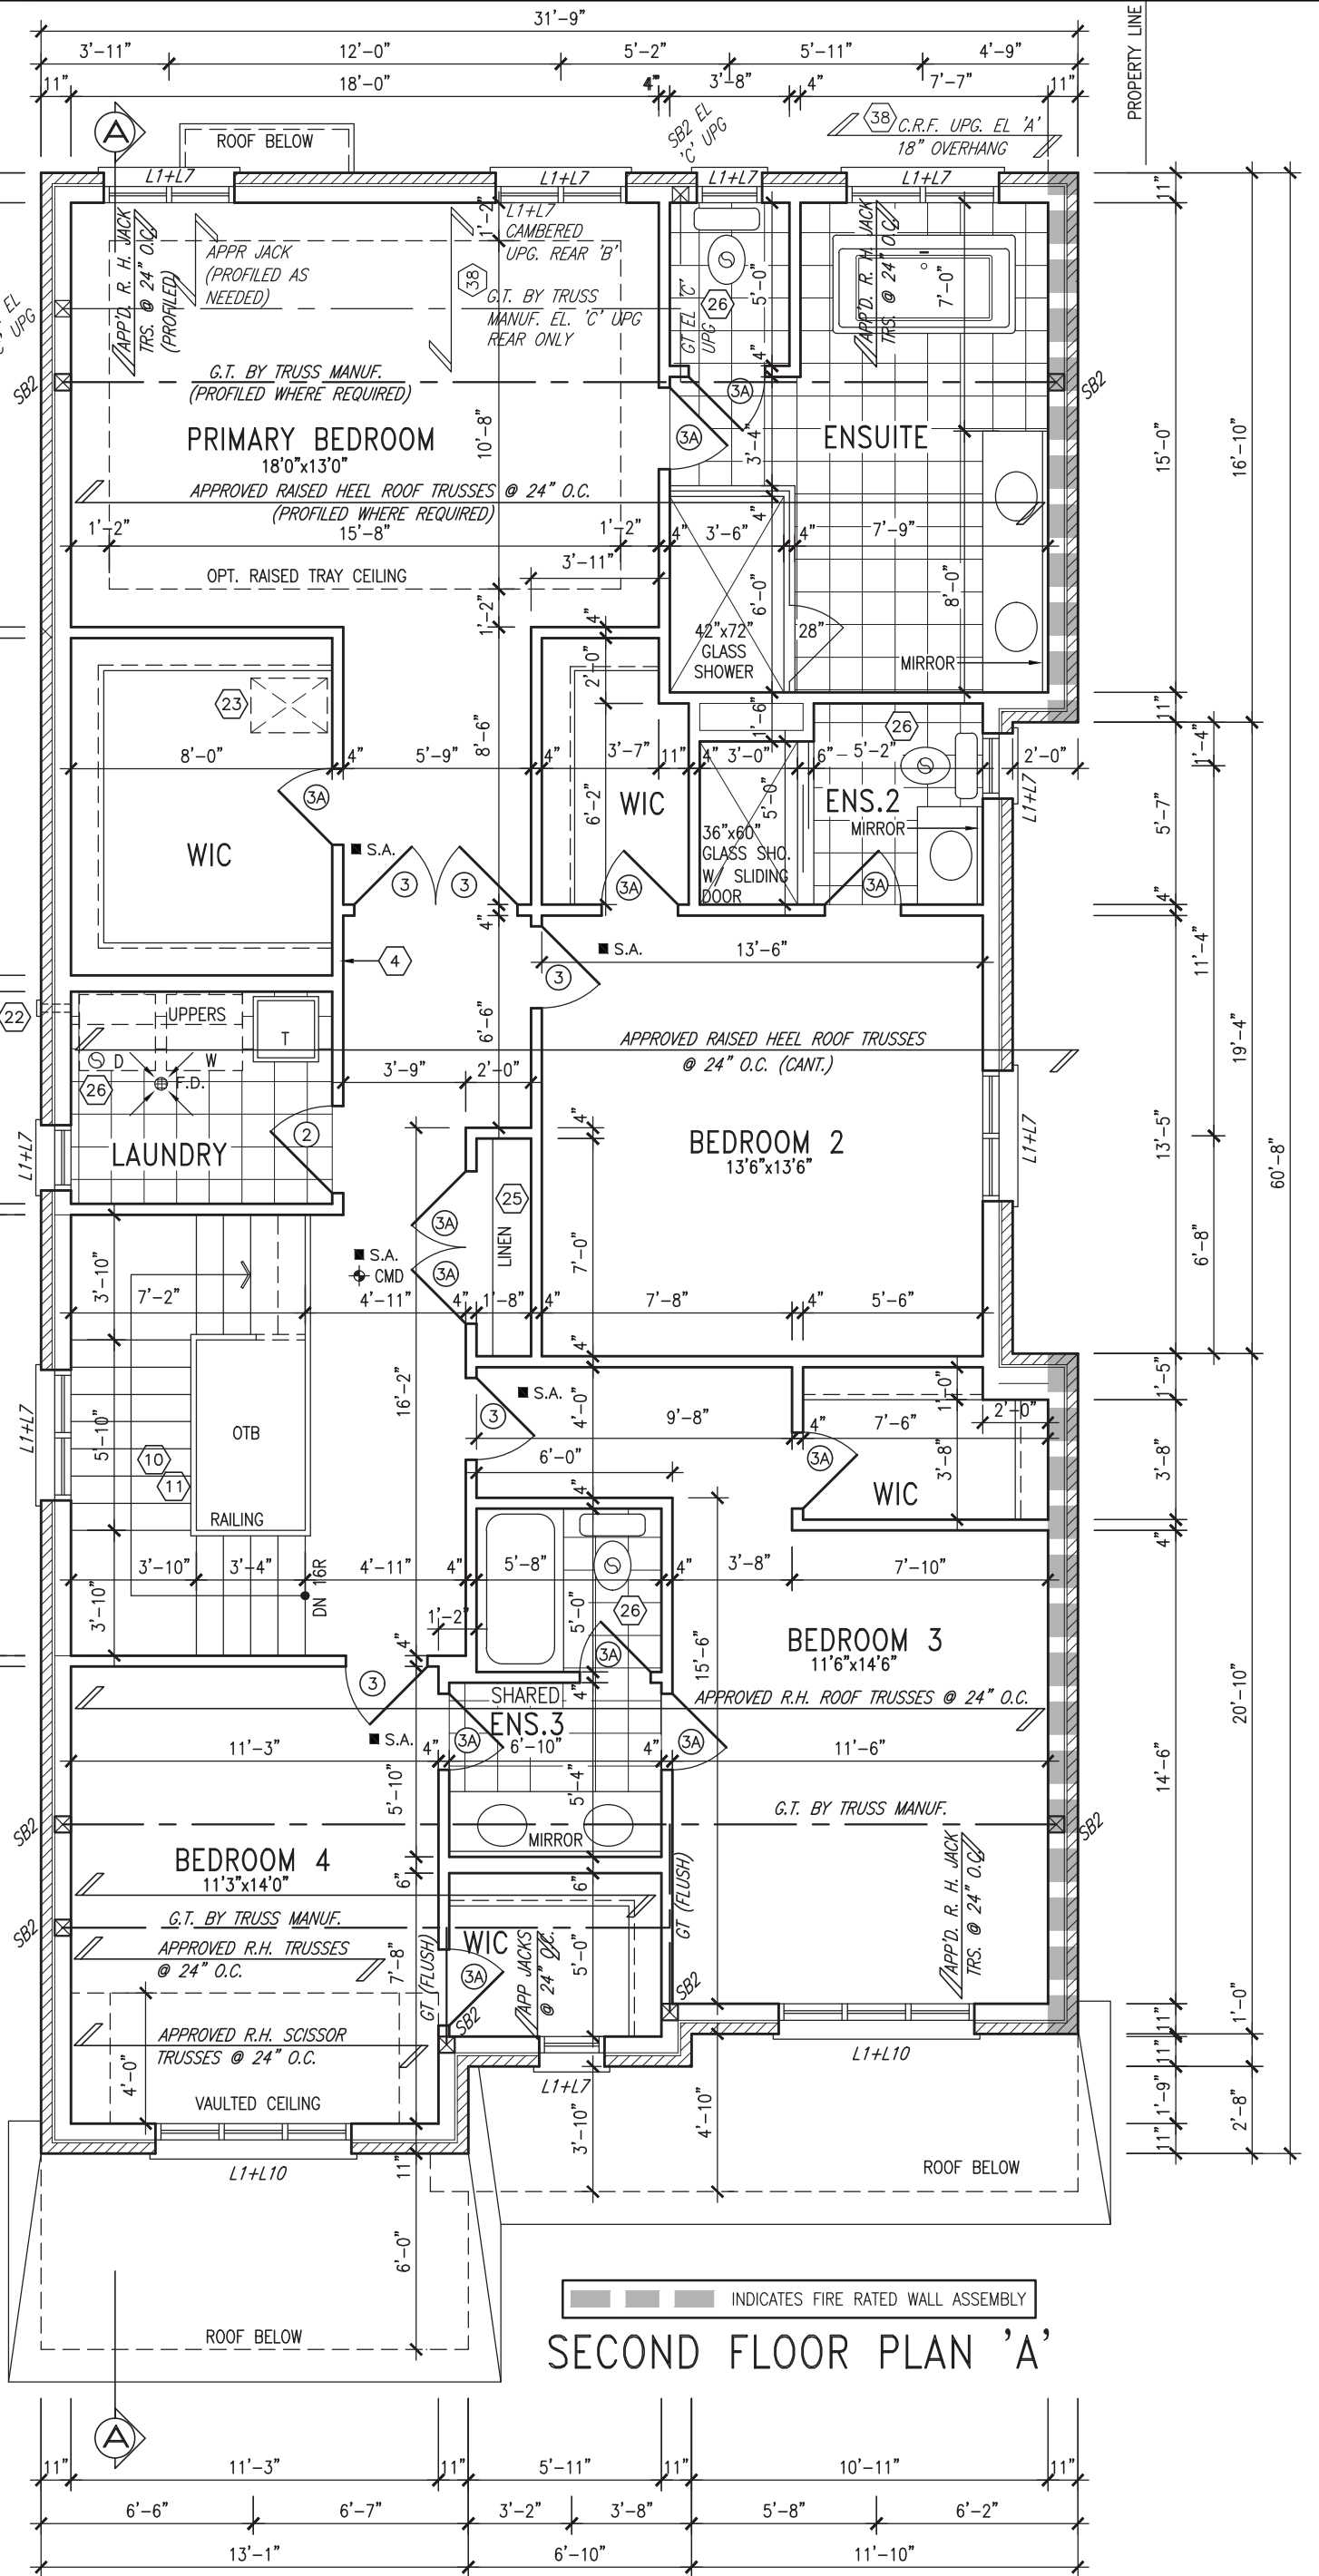

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| 9 | . | . | . |
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| 5 | . | . | . |
| 4 | . | . | . |
| 3 | REVISED AS PER ENG COMMENTS | MAR 01-22 | RC |
| 2 | REVISED AS PER FLOOR / ROOF LAYOUTS | FEB 24-22 | RC |
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| no. | description | date | by |

| | | | |
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| | | | |
|---|----------------------|---------------|--------------------|
| BAYVIEW WELLINGTON | | S38-20 | |
| project name | GREEN VALLEY ESTATES | municipality | BRADFORD EAST, ON. |
| date | SEPT. 2021 | project no. | 16023 |
| drawn by | NC | drawing no. | 16023-S38-20 |
| checked by | JWM | scale | 3/16" = 1'-0" |
| SECOND FLOOR PLAN 'A' | | | |
| RICHARD - H:\ARCHIVE\WORKING\2016\16023.BW\Units\38\16023-S38-20.dwg - Tue - Mar 1 2022 - 2:38 PM | | | |

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APPROVED BY:

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MAR 1, 2022

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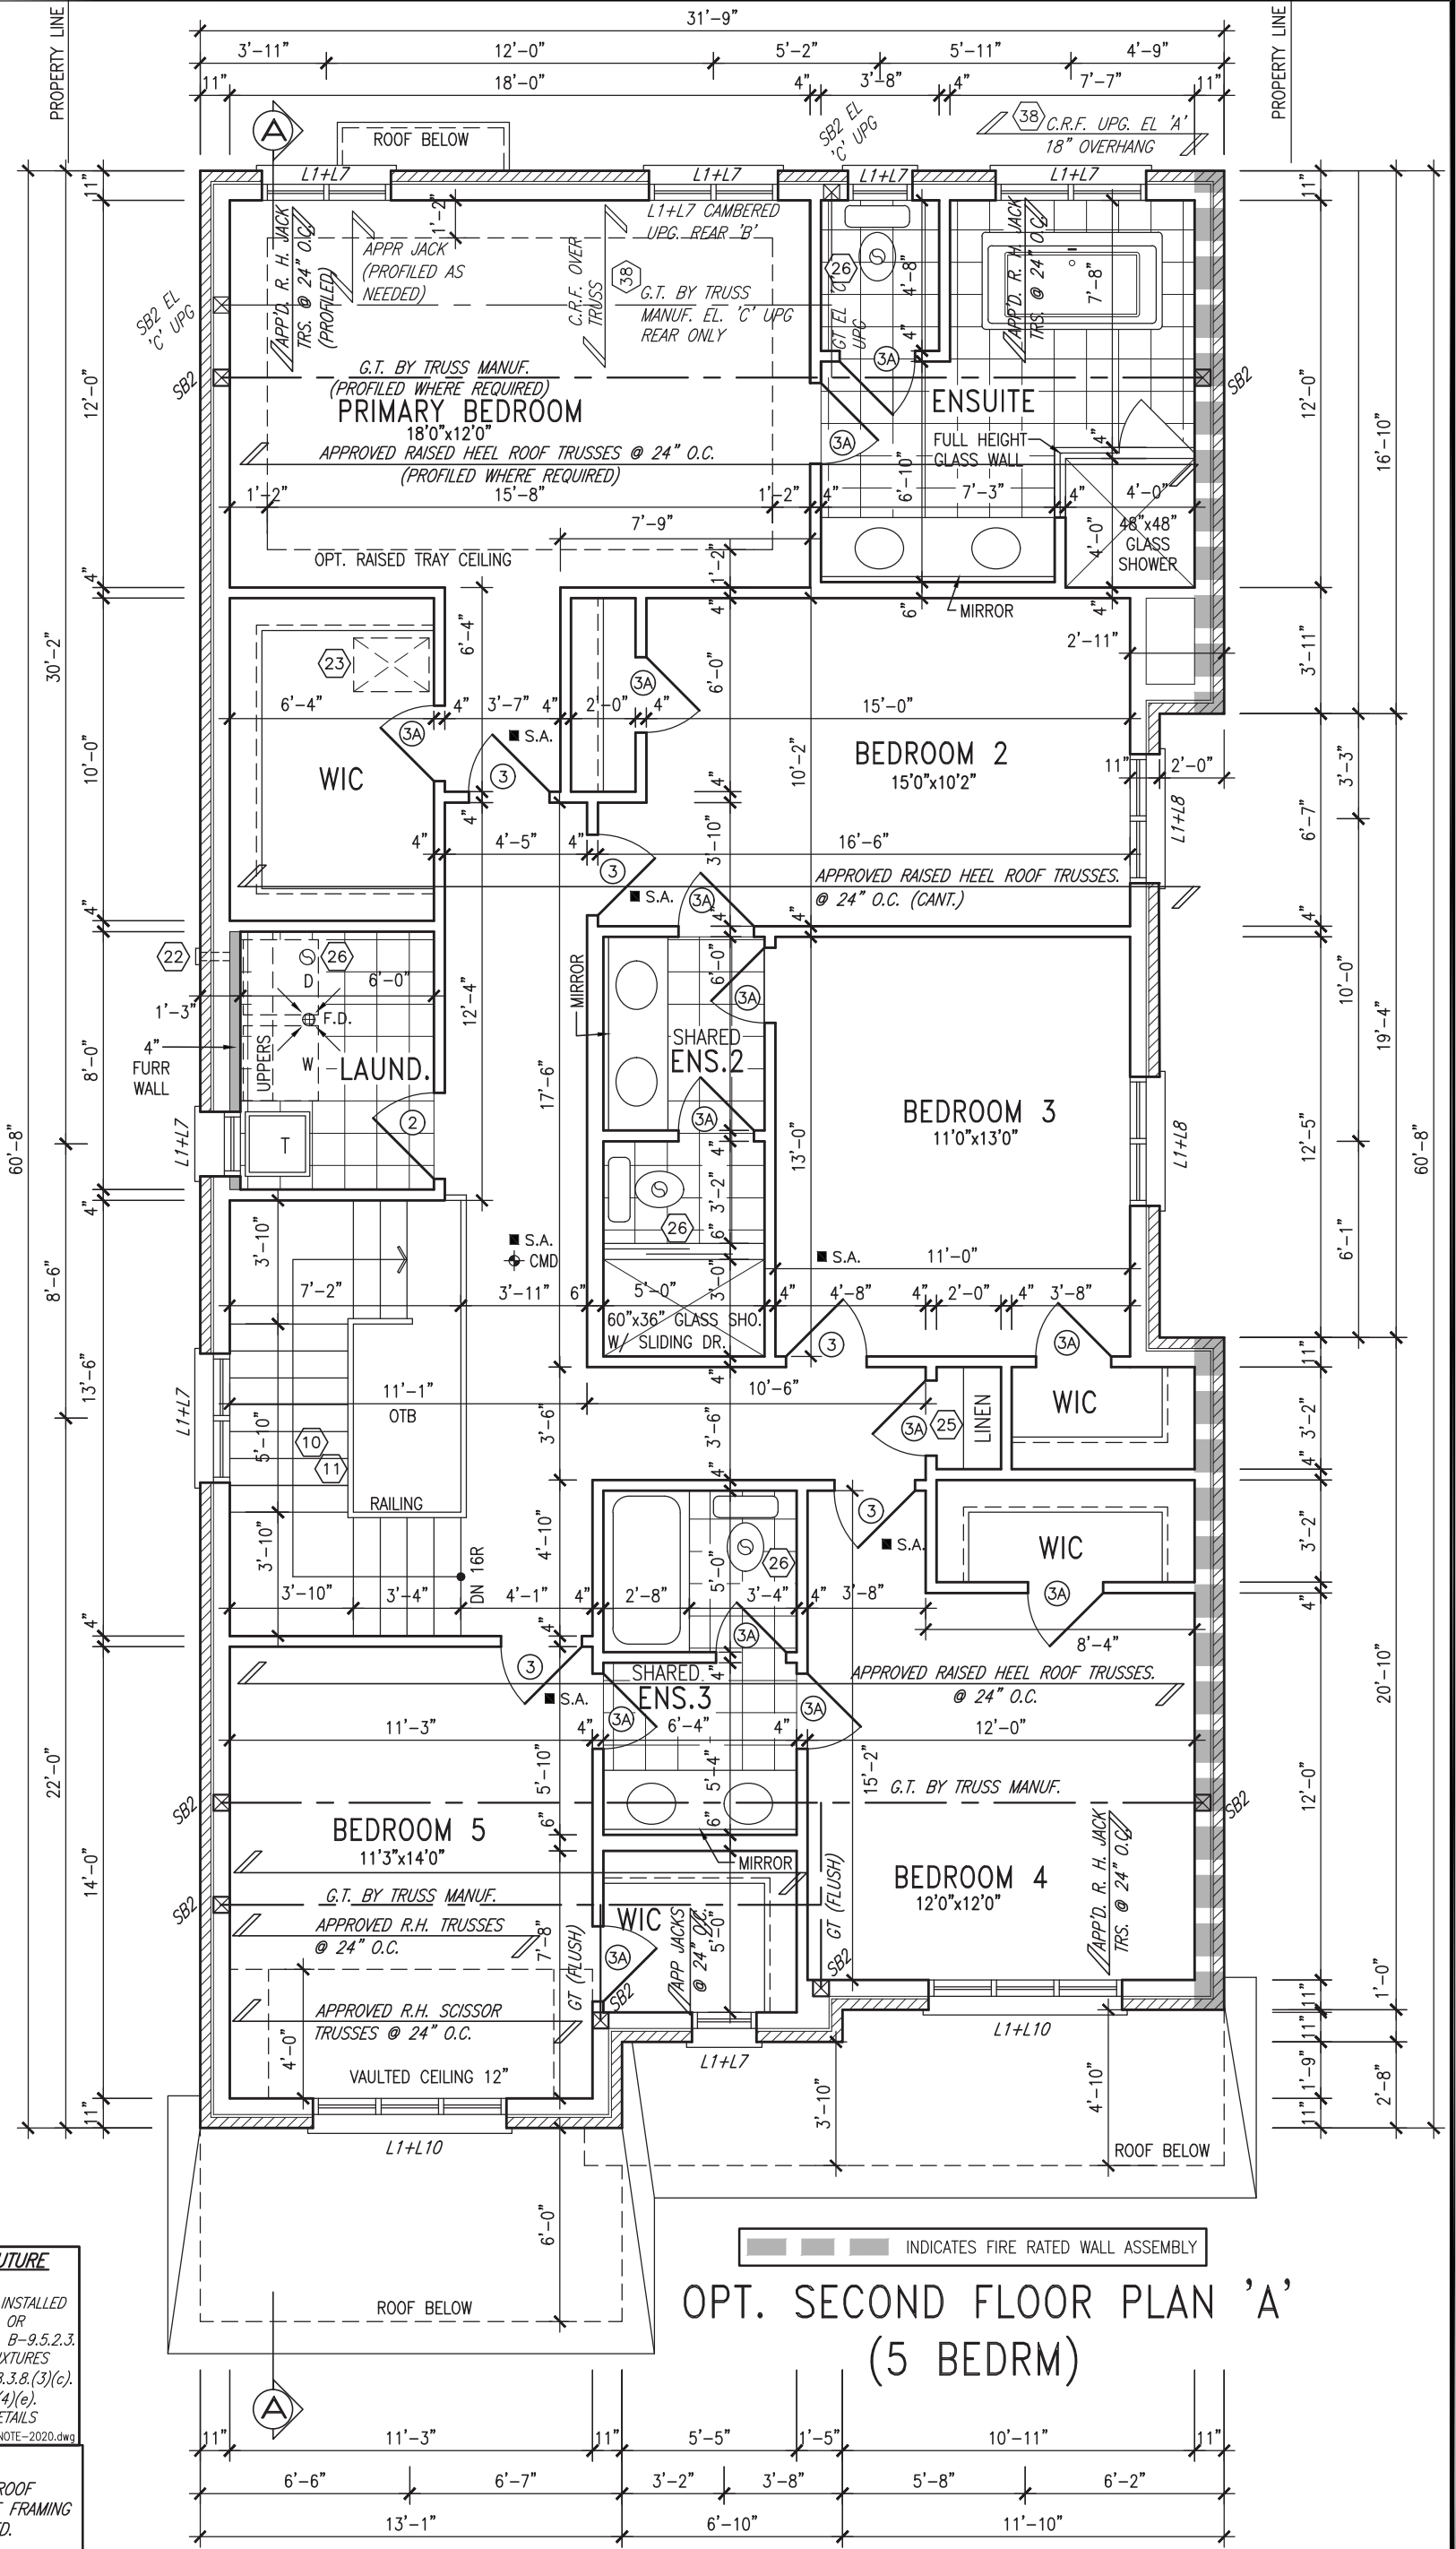
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GB-NOTE-2020.dwg

NOTE: ROOF FRAMING

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OPT. SECOND FLOOR PLAN 'A'
(5 BEDRM)

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| 9. | . | . | . |
| 8. | . | . | . |
| 7. | . | . | . |
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| 4. | . | . | . |
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| no. | description | date | by |

| | | | |
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| qualification information | | | |
| Wellington Jno-Baptiste | signature | 25591 | BCIN |
| registration information | | 42658 | |
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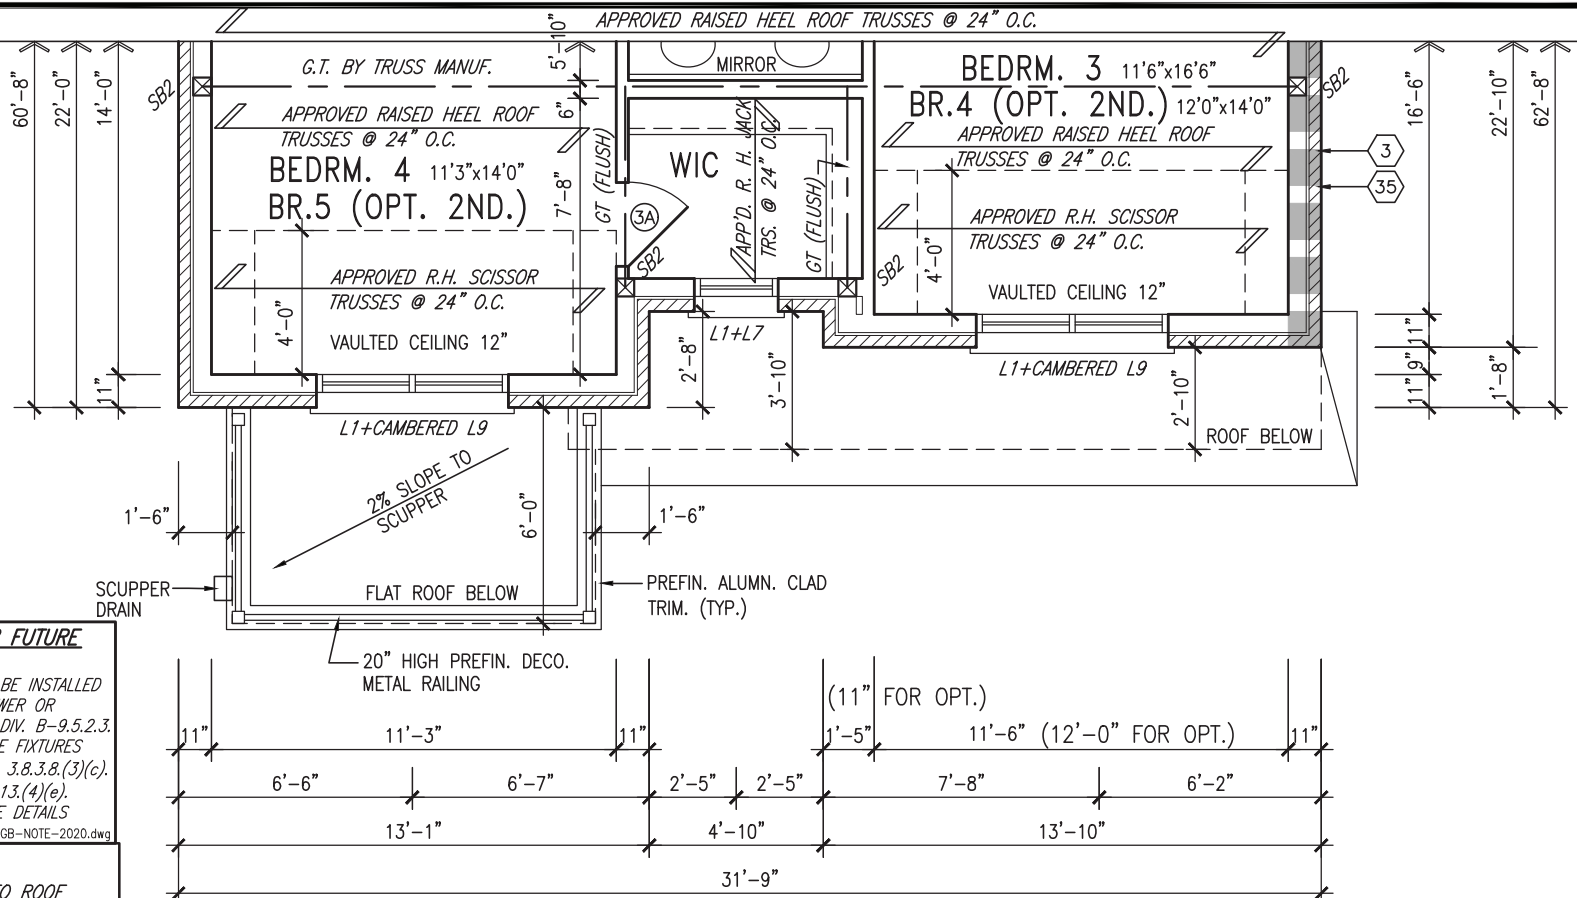
| | | | |
|---|----------------------|---------------|--------------------|
| BAYVIEW WELLINGTON | | S38-20 | |
| project name | GREEN VALLEY ESTATES | municipality | BRADFORD EAST, ON. |
| date | SEPT. 2021 | project no. | 16023 |
| drawn by | NC | file name | 16023-S38-20 |
| checked by | JWM | scale | 3/16" = 1'-0" |
| drawing no. 4 | | | |
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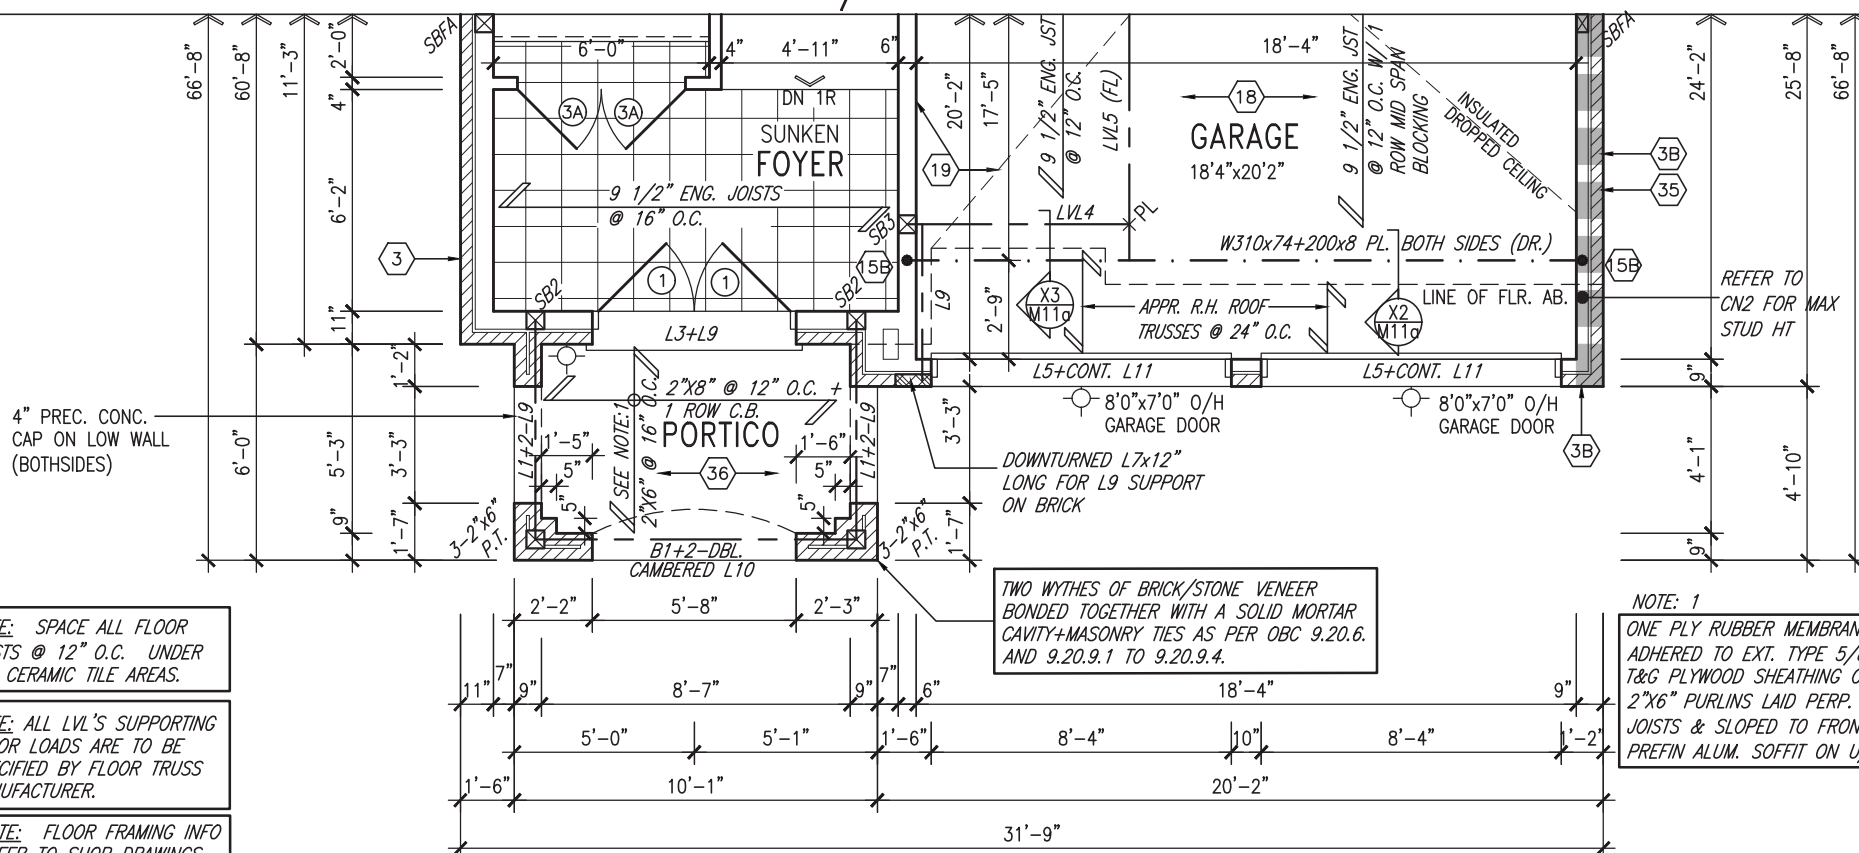
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GRAB BARS IN MAIN BATHROOM

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BATHUB IN MAIN BATHROOM PER OBC. DIV. B-9.5.2.3.
REFER TO FOLLOWING SECTIONS FOR THE FIXTURES
LISTED. WATER CLOSET: 3.8.3.8.(3)(a) & 3.8.3.8.(3)(c).
SHOWER 3.8.3.13.(2)(g). BATHTUB 3.8.3.13.(4)(e).
FREE STANDING BATHTUB EXCLUDED. SEE DETAILS
PROVIDED.

NOTE: ROOF FRAMING

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PARTIAL STD./OPT. SECOND FLOOR PLAN 'B'




NOTE: SPACE ALL FLOOR
JOISTS @ 12" O.C. UNDER
ALL CERAMIC TILE AREAS.

NOTE: ALL LVL'S SUPPORTING FLOOR LOADS ARE TO BE SPECIFIED BY FLOOR TRUSS MANUFACTURER.

NOTE: FLOOR FRAMING INFO
REFER TO SHOP DRAWINGS
FOR ALL TRUSS-JOIST
INFORMATION AND DETAILS.
UNLESS OTHERWISE NOTED.

NOTE: 1
ONE PLY RUBBER MEMBRANE
ADHERED TO EXT. TYPE 5/8"
T&G PLYWOOD SHEATHING ON
2"x6" PURLINS LAID PERP. TO
JOISTS & SLOPED TO FRONT W/
PREFIN ALUM. SOFFIT ON U/S

PARTIAL GROUND FLOOR PLAN 'B'

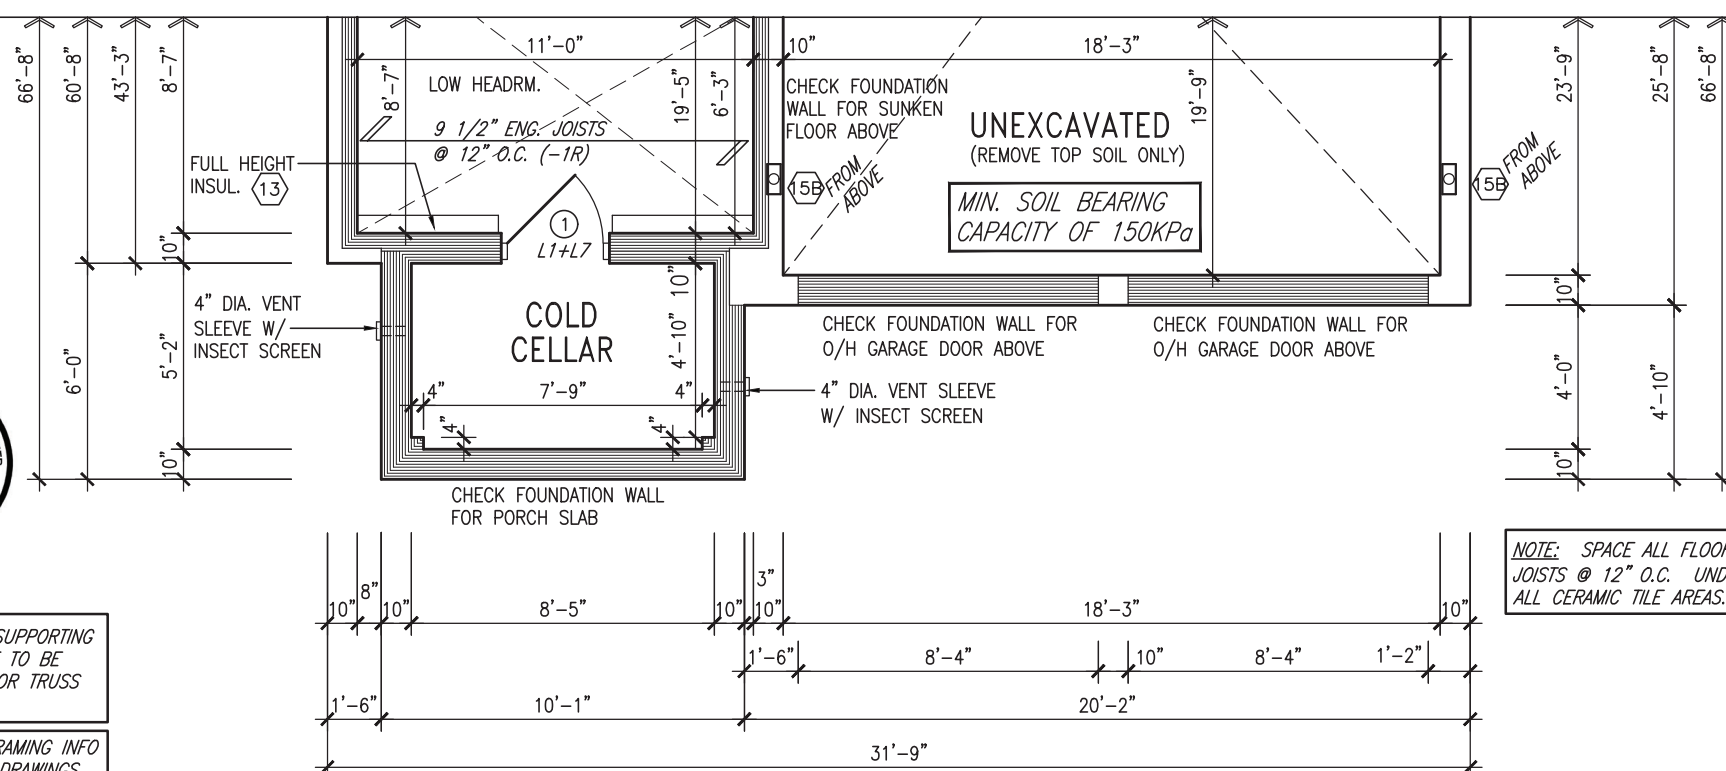

NOTE: SPACE ALL FLOOR
JOISTS @ 12" O.C. UNDER
ALL CERAMIC TILE AREAS.

PARTIAL BASEMENT PLAN 'B'

NOTE J1: PROVIDE SOLID BLOCKING @ 24" O.C. WHERE FLOOR JOISTS ARE PARALLEL TO FOUNDATION WALL (TYP.)

| | | | |
|-----|-------------------------------------|-----------|-----|
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| 5 | . | . | . |
| 4 | . | . | . |
| 3 | REVISED AS PER ENG COMMENTS | MAR 01-22 | RC |
| 2 | REVISED AS PER FLOOR / ROOF LAYOUTS | FEB 24-22 | RC |
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| no. | description | date | by |

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qualification information

| | |
|--------------------------|-----------|
| Wellington Jno-Baptiste | 25591 |
| name | signature |
| registration information | BCIN |
| YA3 Design Inc. | 42658 |

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BAYVIEW WELLINGTON

S38-20

| | | | | |
|---|--------------------------|---|----------------------------------|---|
| project name GREEN VALLEY ESTATES | | municipality BRADFORD EAST, ON. | | project no. 16023 |
| date SEPT. 2021 | | | | drawing no. <div style="font-size: 2em; text-align: center;">5</div> |
| PART. FLOOR PLAN 'B' | | | | |
| drawn by NC | checked by JWM | scale 3/16" = 1'-0" | file name 16023-S38-20 | |
| RICHARD - H:\ARCHIVE\WORKING\2016\16023.BW\Units\38\16023-S38-20.dwg - Tue - Mar 1 2022 - 2:38 PM | | | | |

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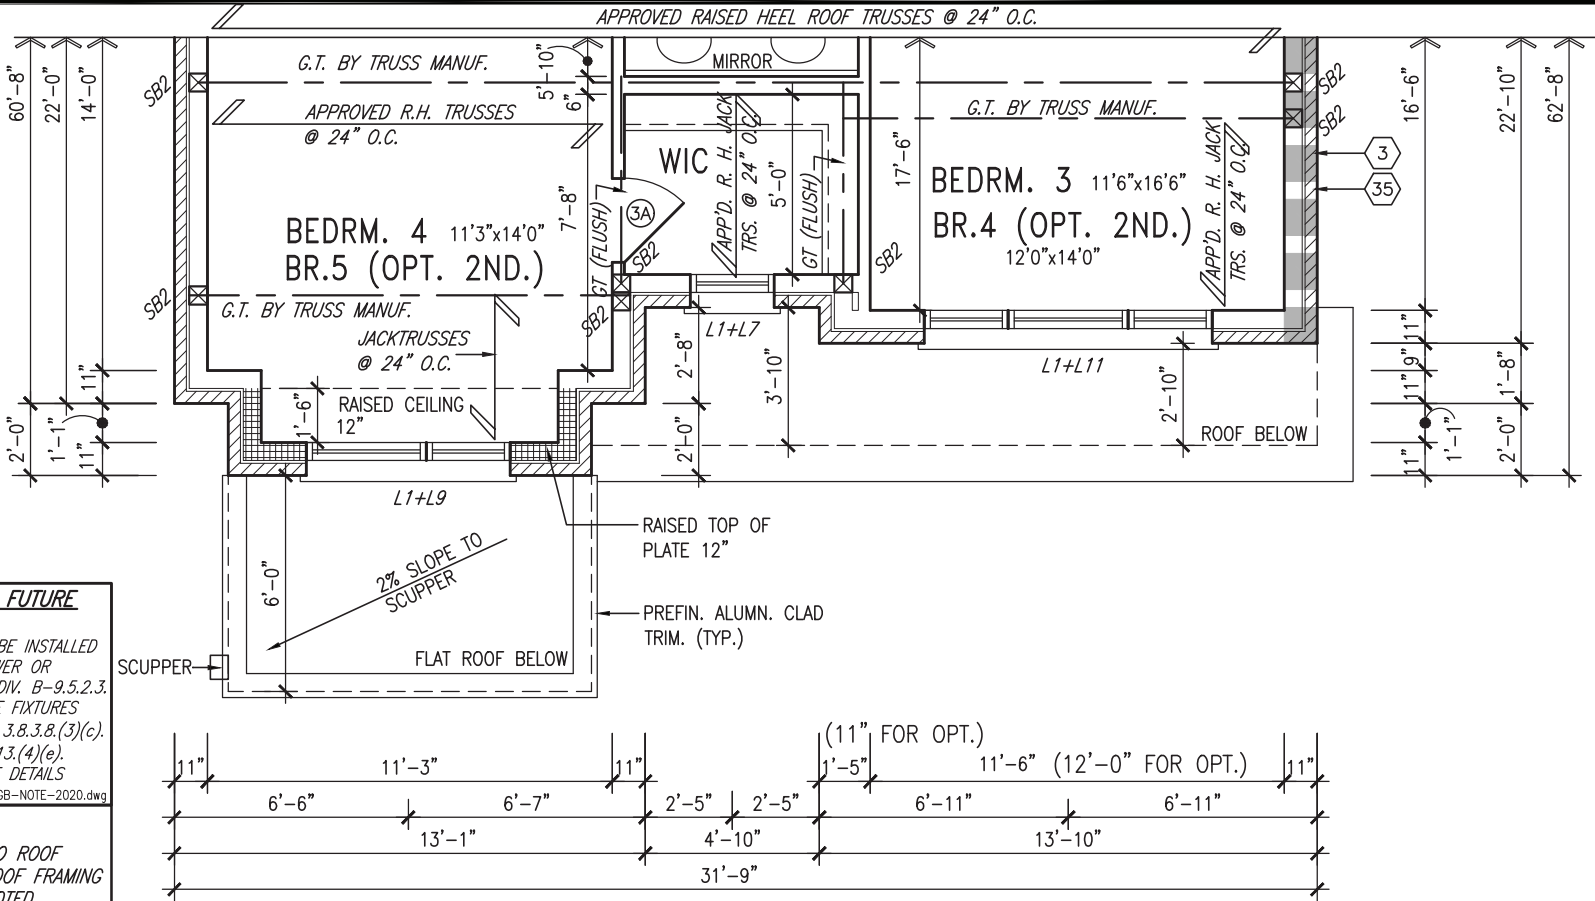
GRAB BAR NOTE:

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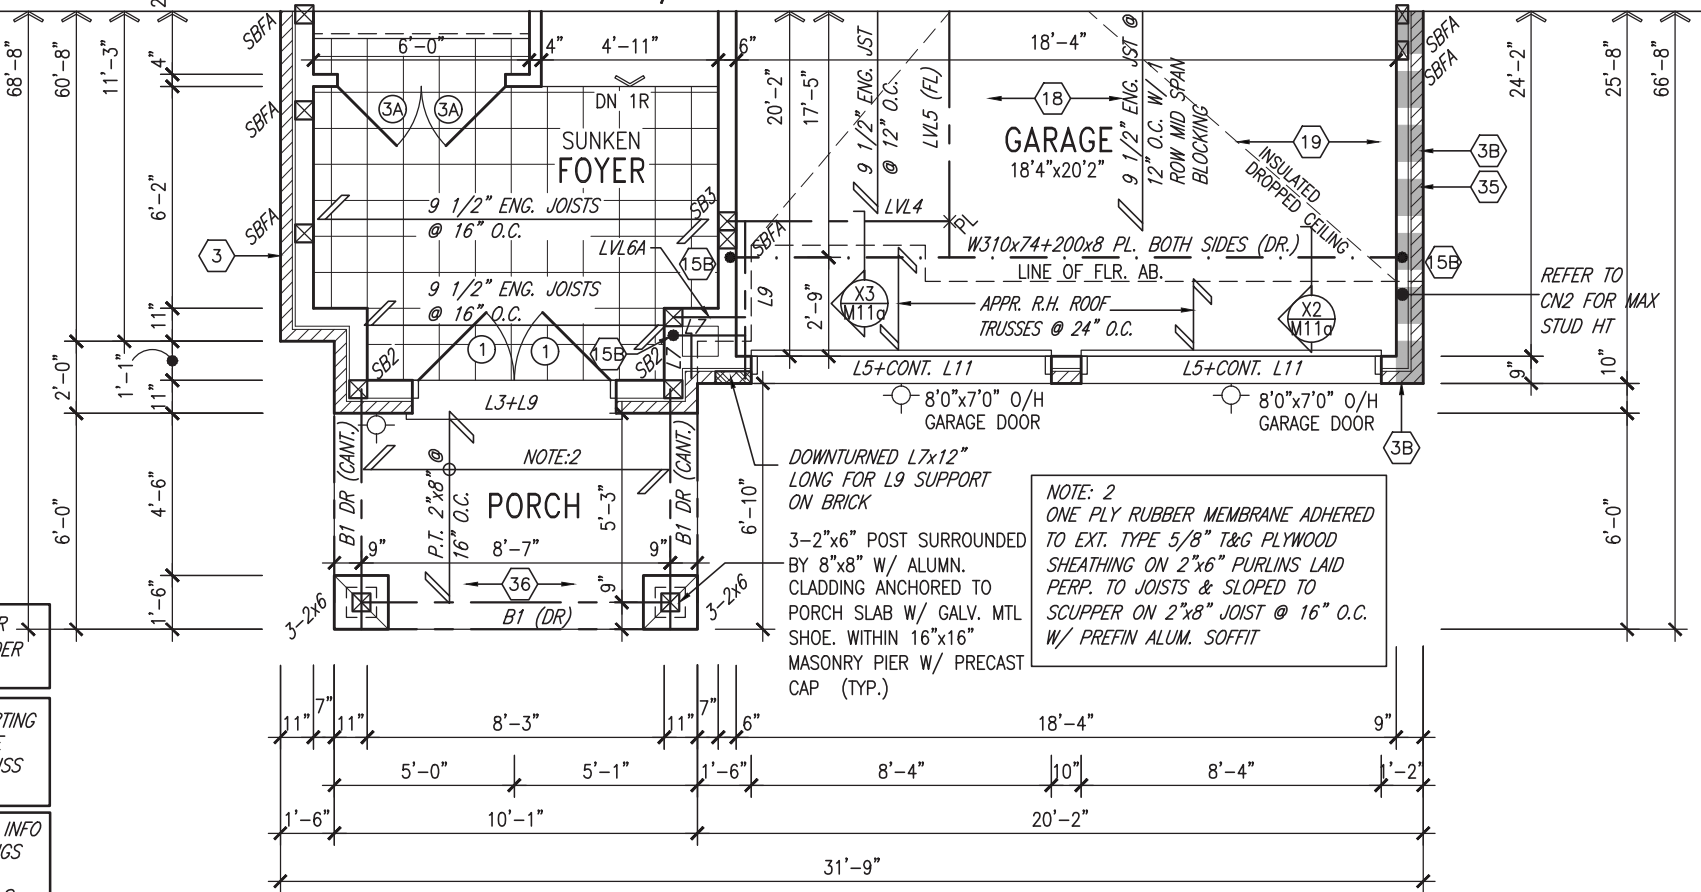
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NOTE: ROOF FRAMING


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PARTIAL STD./OPT. SECOND FLOOR PLAN 'C'



PARTIAL GROUND FLOOR PLAN 'C'



PARTIAL BASEMENT PLAN 'C'

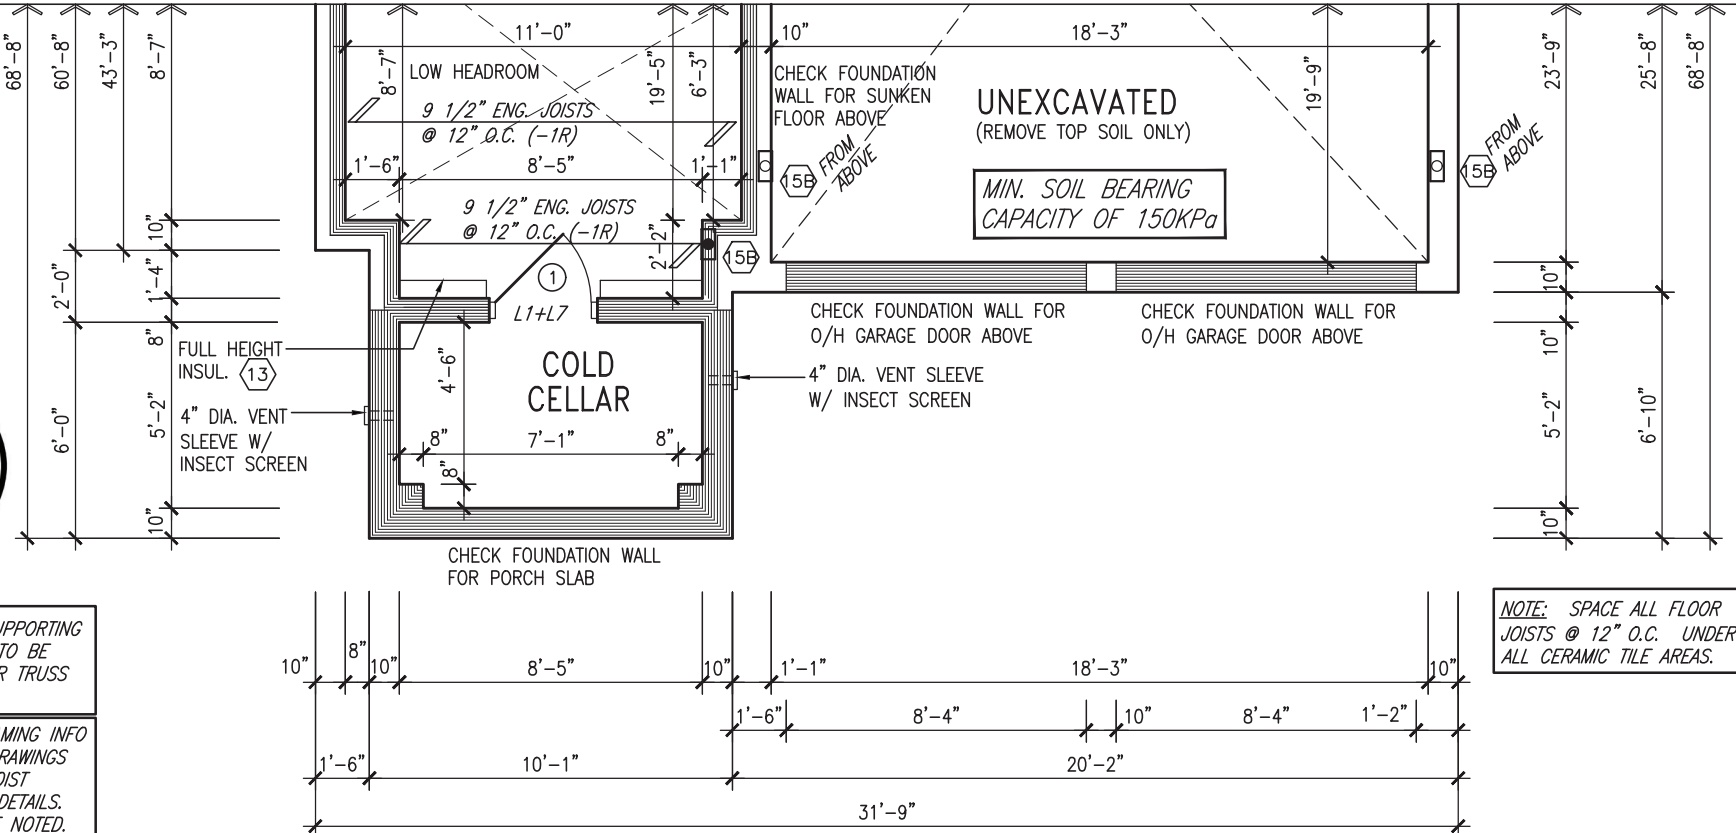

MAR 1, 2022

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BAYVIEW WELLINGTON

S38-20

project name GREEN VALLEY ESTATES municipality BRADFORD EAST, ON.

project no. 16023

date SEPT. 2021
drawn by NC
checked by JWM
scale 3/16" = 1'-0"

PART. FLOOR PLAN 'C'

file name 16023-S38-20

drawing no. 6

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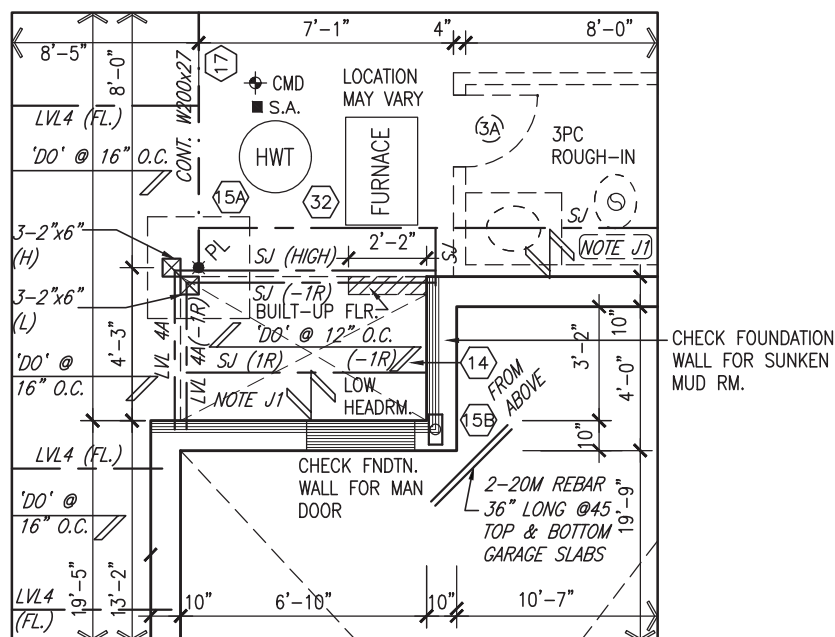
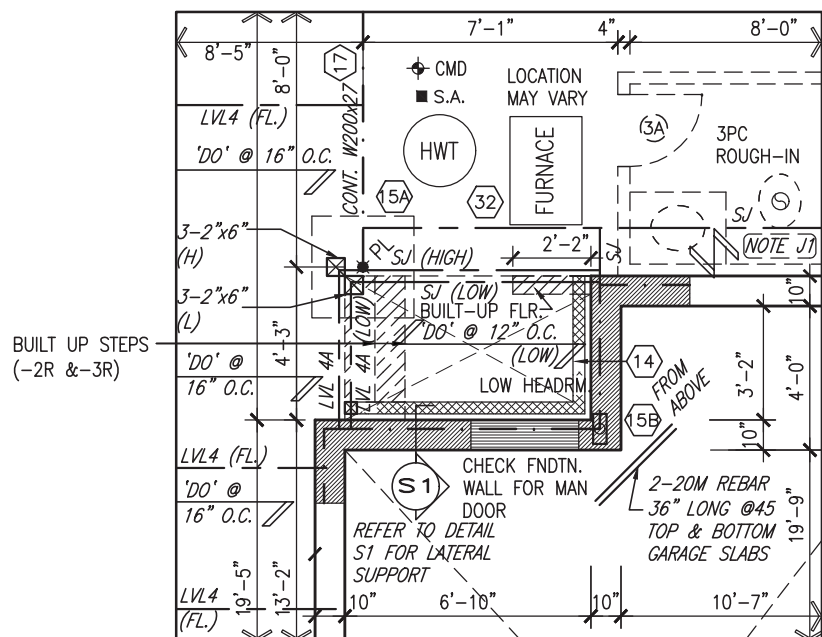
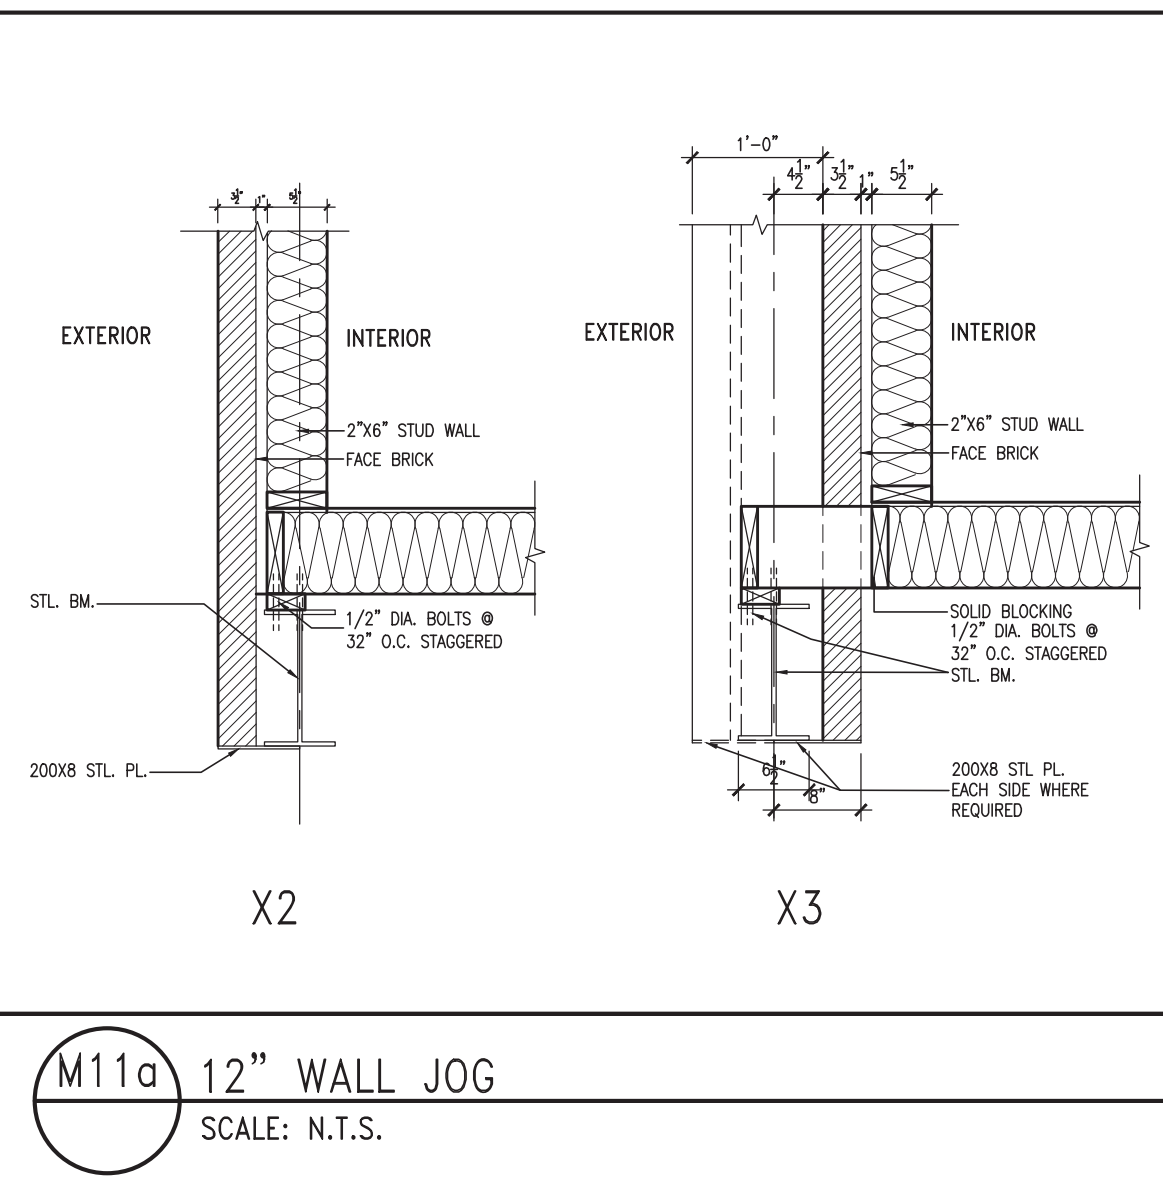
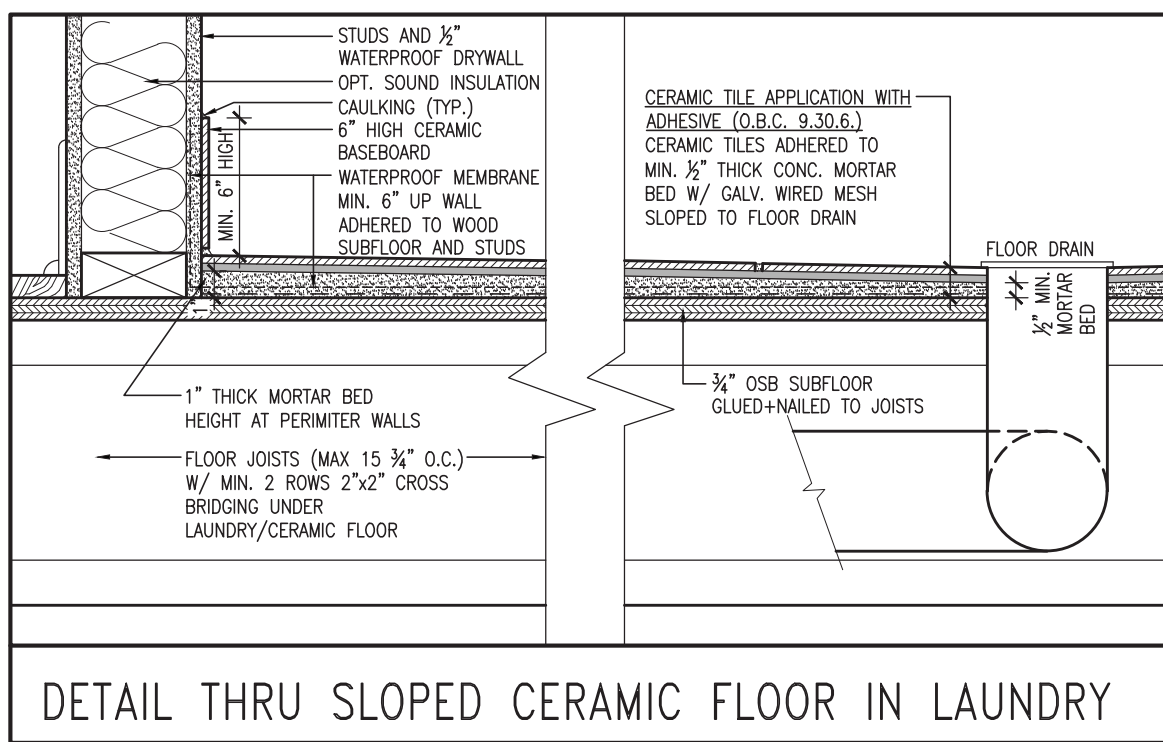
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MAR 1, 2022

| AREA CALCULATIONS | | | |
|-----------------------|----------------|----------------|----------------|
| | ELEV. A | ELEV. B | ELEV. C |
| GROUND FLOOR AREA | 1462.1 SF | 1462.1 SF | 1483.5 SF |
| SECOND FLOOR AREA | 1825.9 SF | 1851.6 SF | 1871.7 SF |
| SUBTOTAL | 3288.0 SF | 3313.7 SF | 3355.3 SF |
| DEDUCT ALL OPENINGS | 25.8 SF | 25.8 SF | 25.8 SF |
| TOTAL NET AREA | 3262 SF | 3288 SF | 3329 SF |
| | 303.1 m2 | 305.4 m2 | 309.3 m2 |
| FINISHED BSMT AREA | 0 SF | 0 SF | 0 SF |
| TOTAL NET AREA | 3262 SF | 3288 SF | 3329 SF |
| W/ FIN BSMT | 303.1 m2 | 305.4 m2 | 309.3 m2 |
| COVERAGE W/O PORCH | 1917.3 SF | 1918.6 SF | 1937.9 SF |
| | 178.1 m2 | 178.2 m2 | 180.0 m2 |
| COVERAGE W/PORCH | 1994.4 SF | 1978.2 SF | 1998.4 SF |
| | 185.3 m2 | 183.8 m2 | 185.7 m2 |



PART. SUNKEN MUD ROOM
(2-3R)

PART. SUNKEN MUD ROOM (-1R)

| | | | | | | | | |
|-----|-------------------------------------|-----------|-----|---|--|--------------------------------------|------------------------------------|----------------------|
| 9 | . | . | . | The undersigned has reviewed and takes responsibility for this design and has the qualifications and meets the requirements set out in the Ontario Building Code to be a Designer. |  255 Consumers Rd Suite 120 Toronto ON M2J 1R4 t 416.630.2255 f 416.630.4782 va3design.com | BAYVIEW WELLINGTON | | S38-20 |
| 8 | . | . | . | qualification information | | project name GREEN VALLEY ESTATES | municipality BRADFORD EAST, ON. | project no. 16023 |
| 7 | . | . | . | Wellington Jno-Baptiste | | date SEPT. 2021 | | PART. FLOOR PLAN 'C' |
| 6 | . | . | . | signature | | drawing no. 7 | file name 16023-S38-20 | |
| 5 | . | . | . | BCIN | | drawing no. 7 | | |
| 4 | . | . | . | name VA3 Design Inc. | drawing no. 7 | | | |
| 3 | REVISED AS PER ENG COMMENTS | MAR 01-22 | RC | Contractor must verify all dimensions on the job and report any discrepancy to the Designer with the work. All drawings and specifications are instruments of service and the property of the Designer which must be returned at the completion of the work. Drawings are not to be scaled. | drawing no. 7 | | | |
| 2 | REVISED AS PER FLOOR / ROOF LAYOUTS | FEB 24-22 | RC | | drawing no. 7 | | | |
| 1 | ISSUED FOR CLIENT REVIEW | NOV 23-21 | VA3 | | drawing no. 7 | | | |
| no. | description | date | by | | drawing no. 7 | | | |

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This is to certify that these plans comply with the applicable Architectural Design Guidelines approved by the Town of BRADFORD / WEST GWILLIMBURY.

JOHN G. WILLIAMS LTD., ARCHITECT
ARCHITECTURAL CONTROL REVIEW
AND APPROVAL


APPROVED BY: 

DATE: MAR 03, 2022

This stamp certifies compliance with the applicable Design Guidelines only and bears no further professional responsibility.


VA3
DESIGN
255 Consumers Rd Suite 120
Toronto ON M2J 1R4
t 416.630.2255 f 416.630.4782
vo3design.com

| no. | description | date | by |
|-----|-------------------------------------|------------|-----|
| 9 | . | . | . |
| 8 | . | . | . |
| 7 | . | . | . |
| 6 | . | . | . |
| 5 | . | . | . |
| 4 | . | . | . |
| 3 | REVISED AS PER ENG COMMENTS | MAR 01--22 | RC |
| 2 | REVISED AS PER FLOOR / ROOF LAYOUTS | FEB 24--22 | RC |
| 1 | ISSUED FOR CLIENT REVIEW | NOV 23--21 | VA3 |

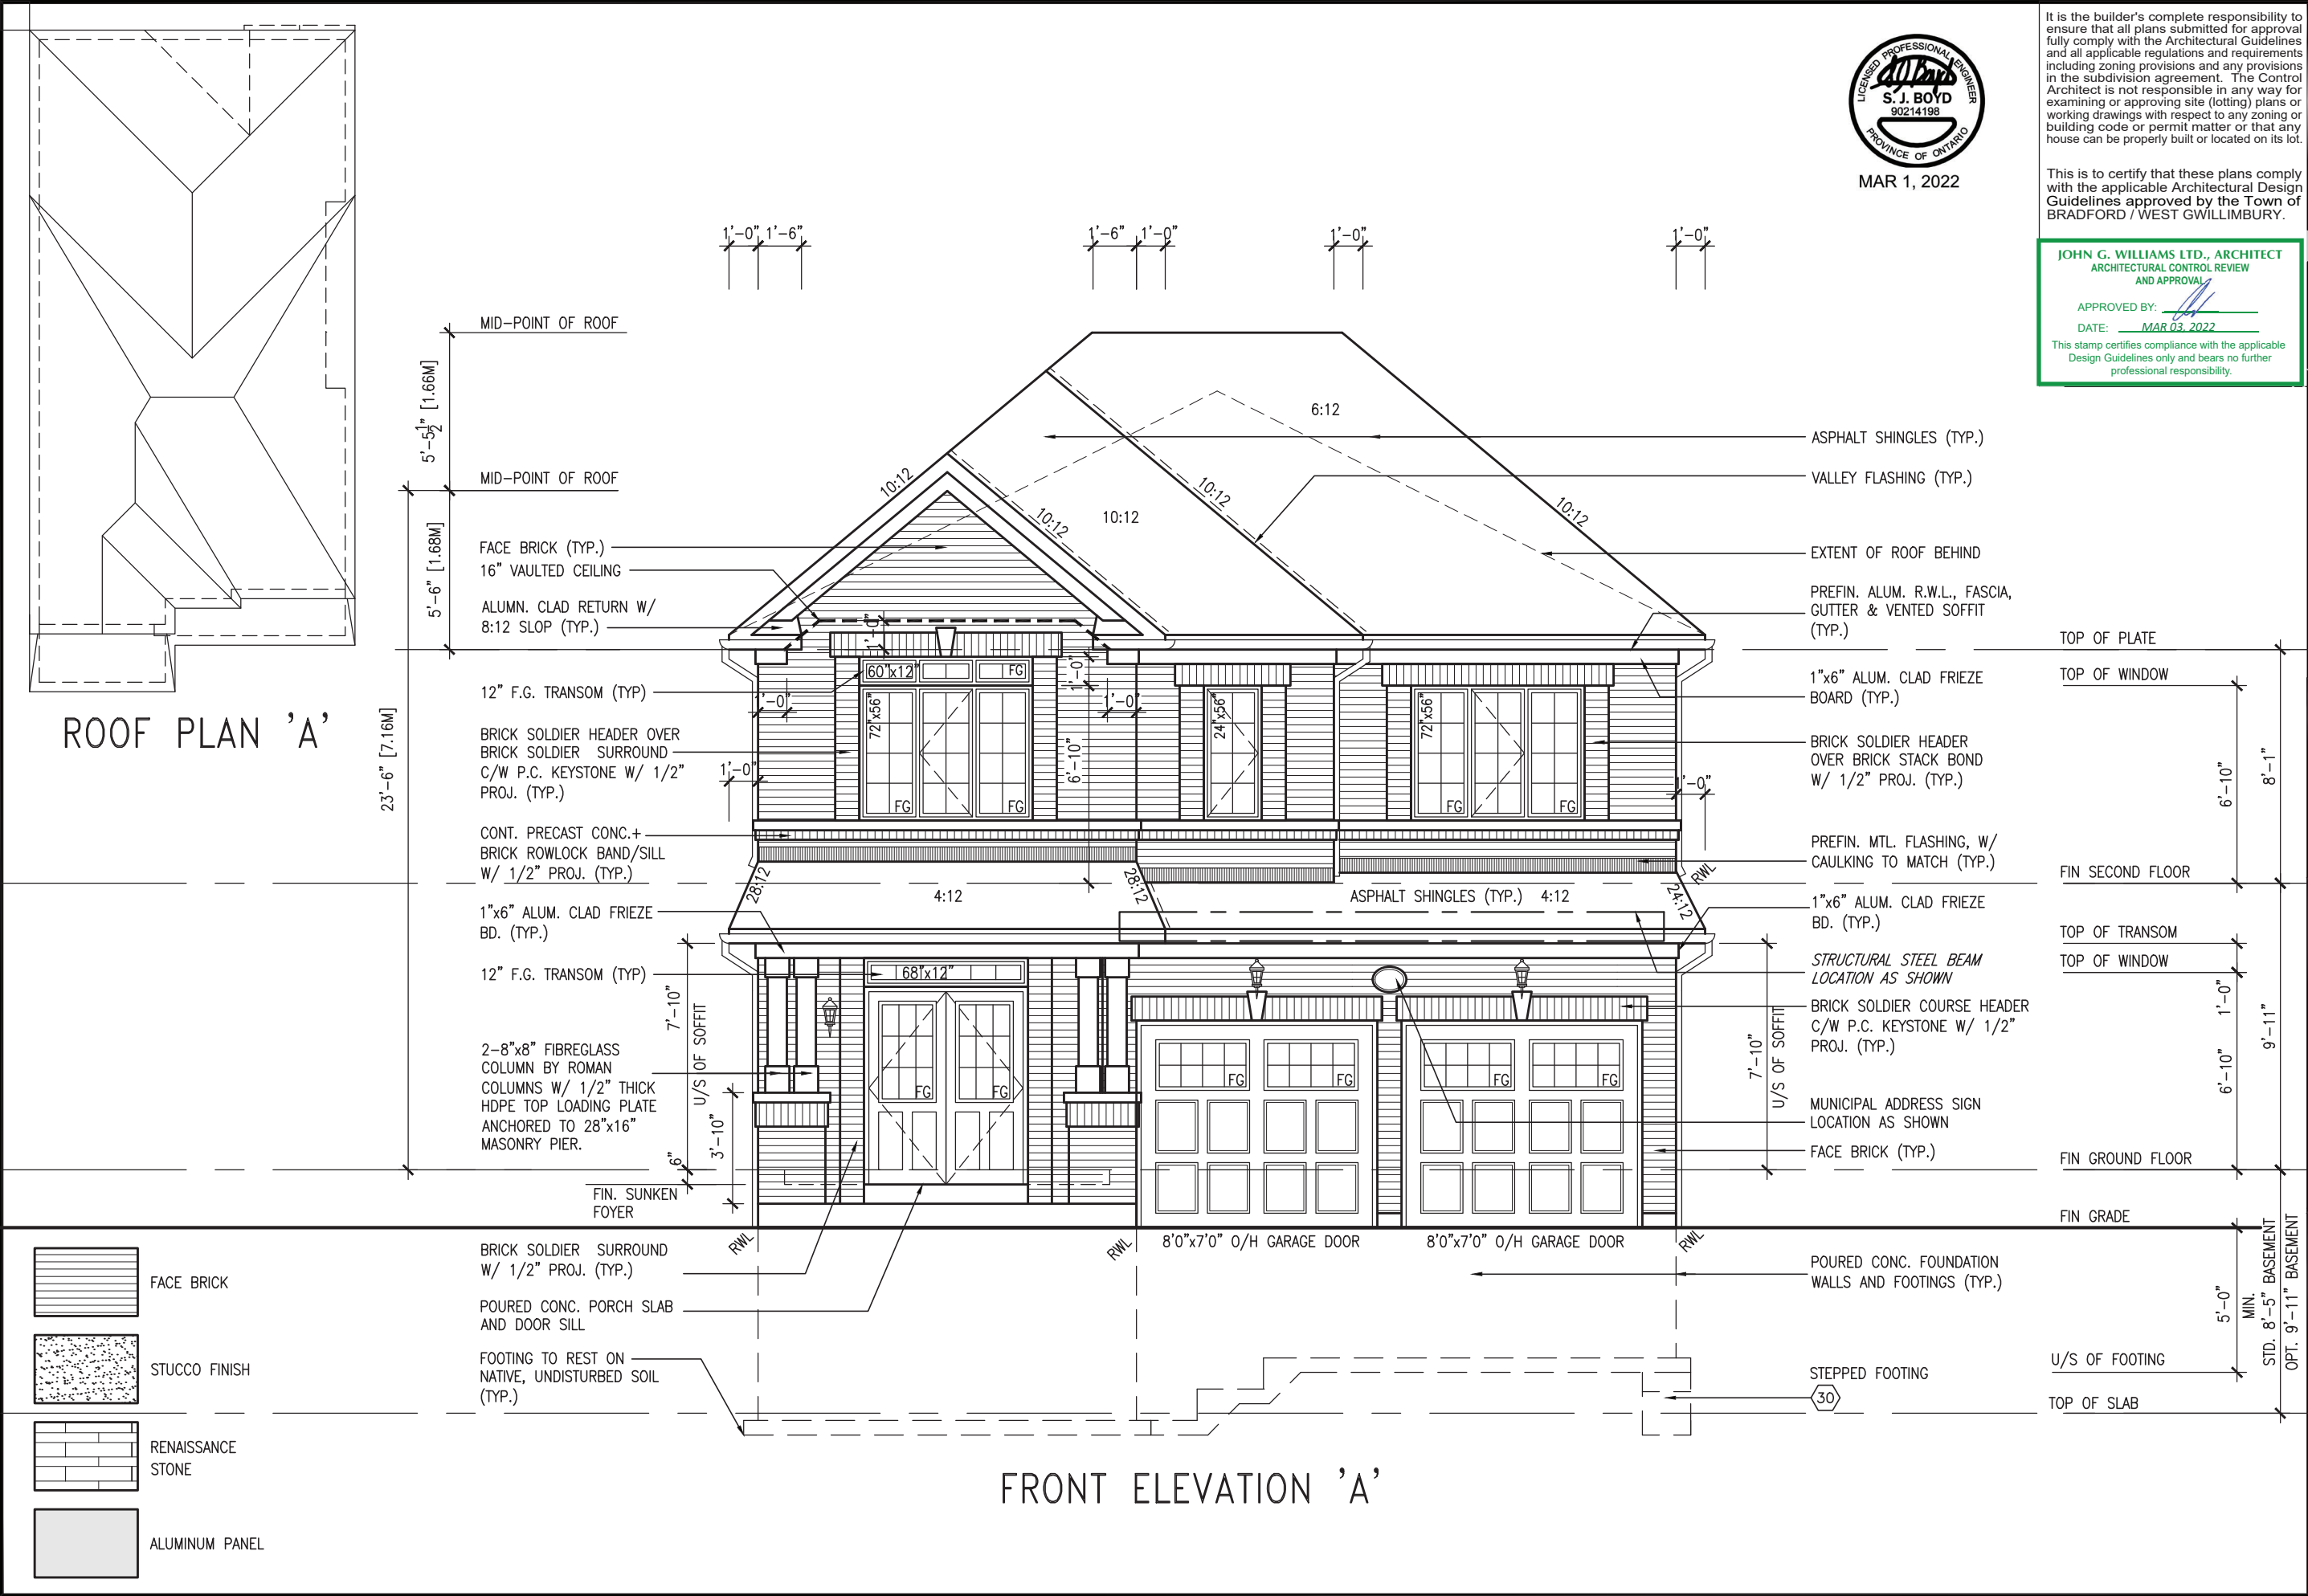

1'-0"

1'-0"

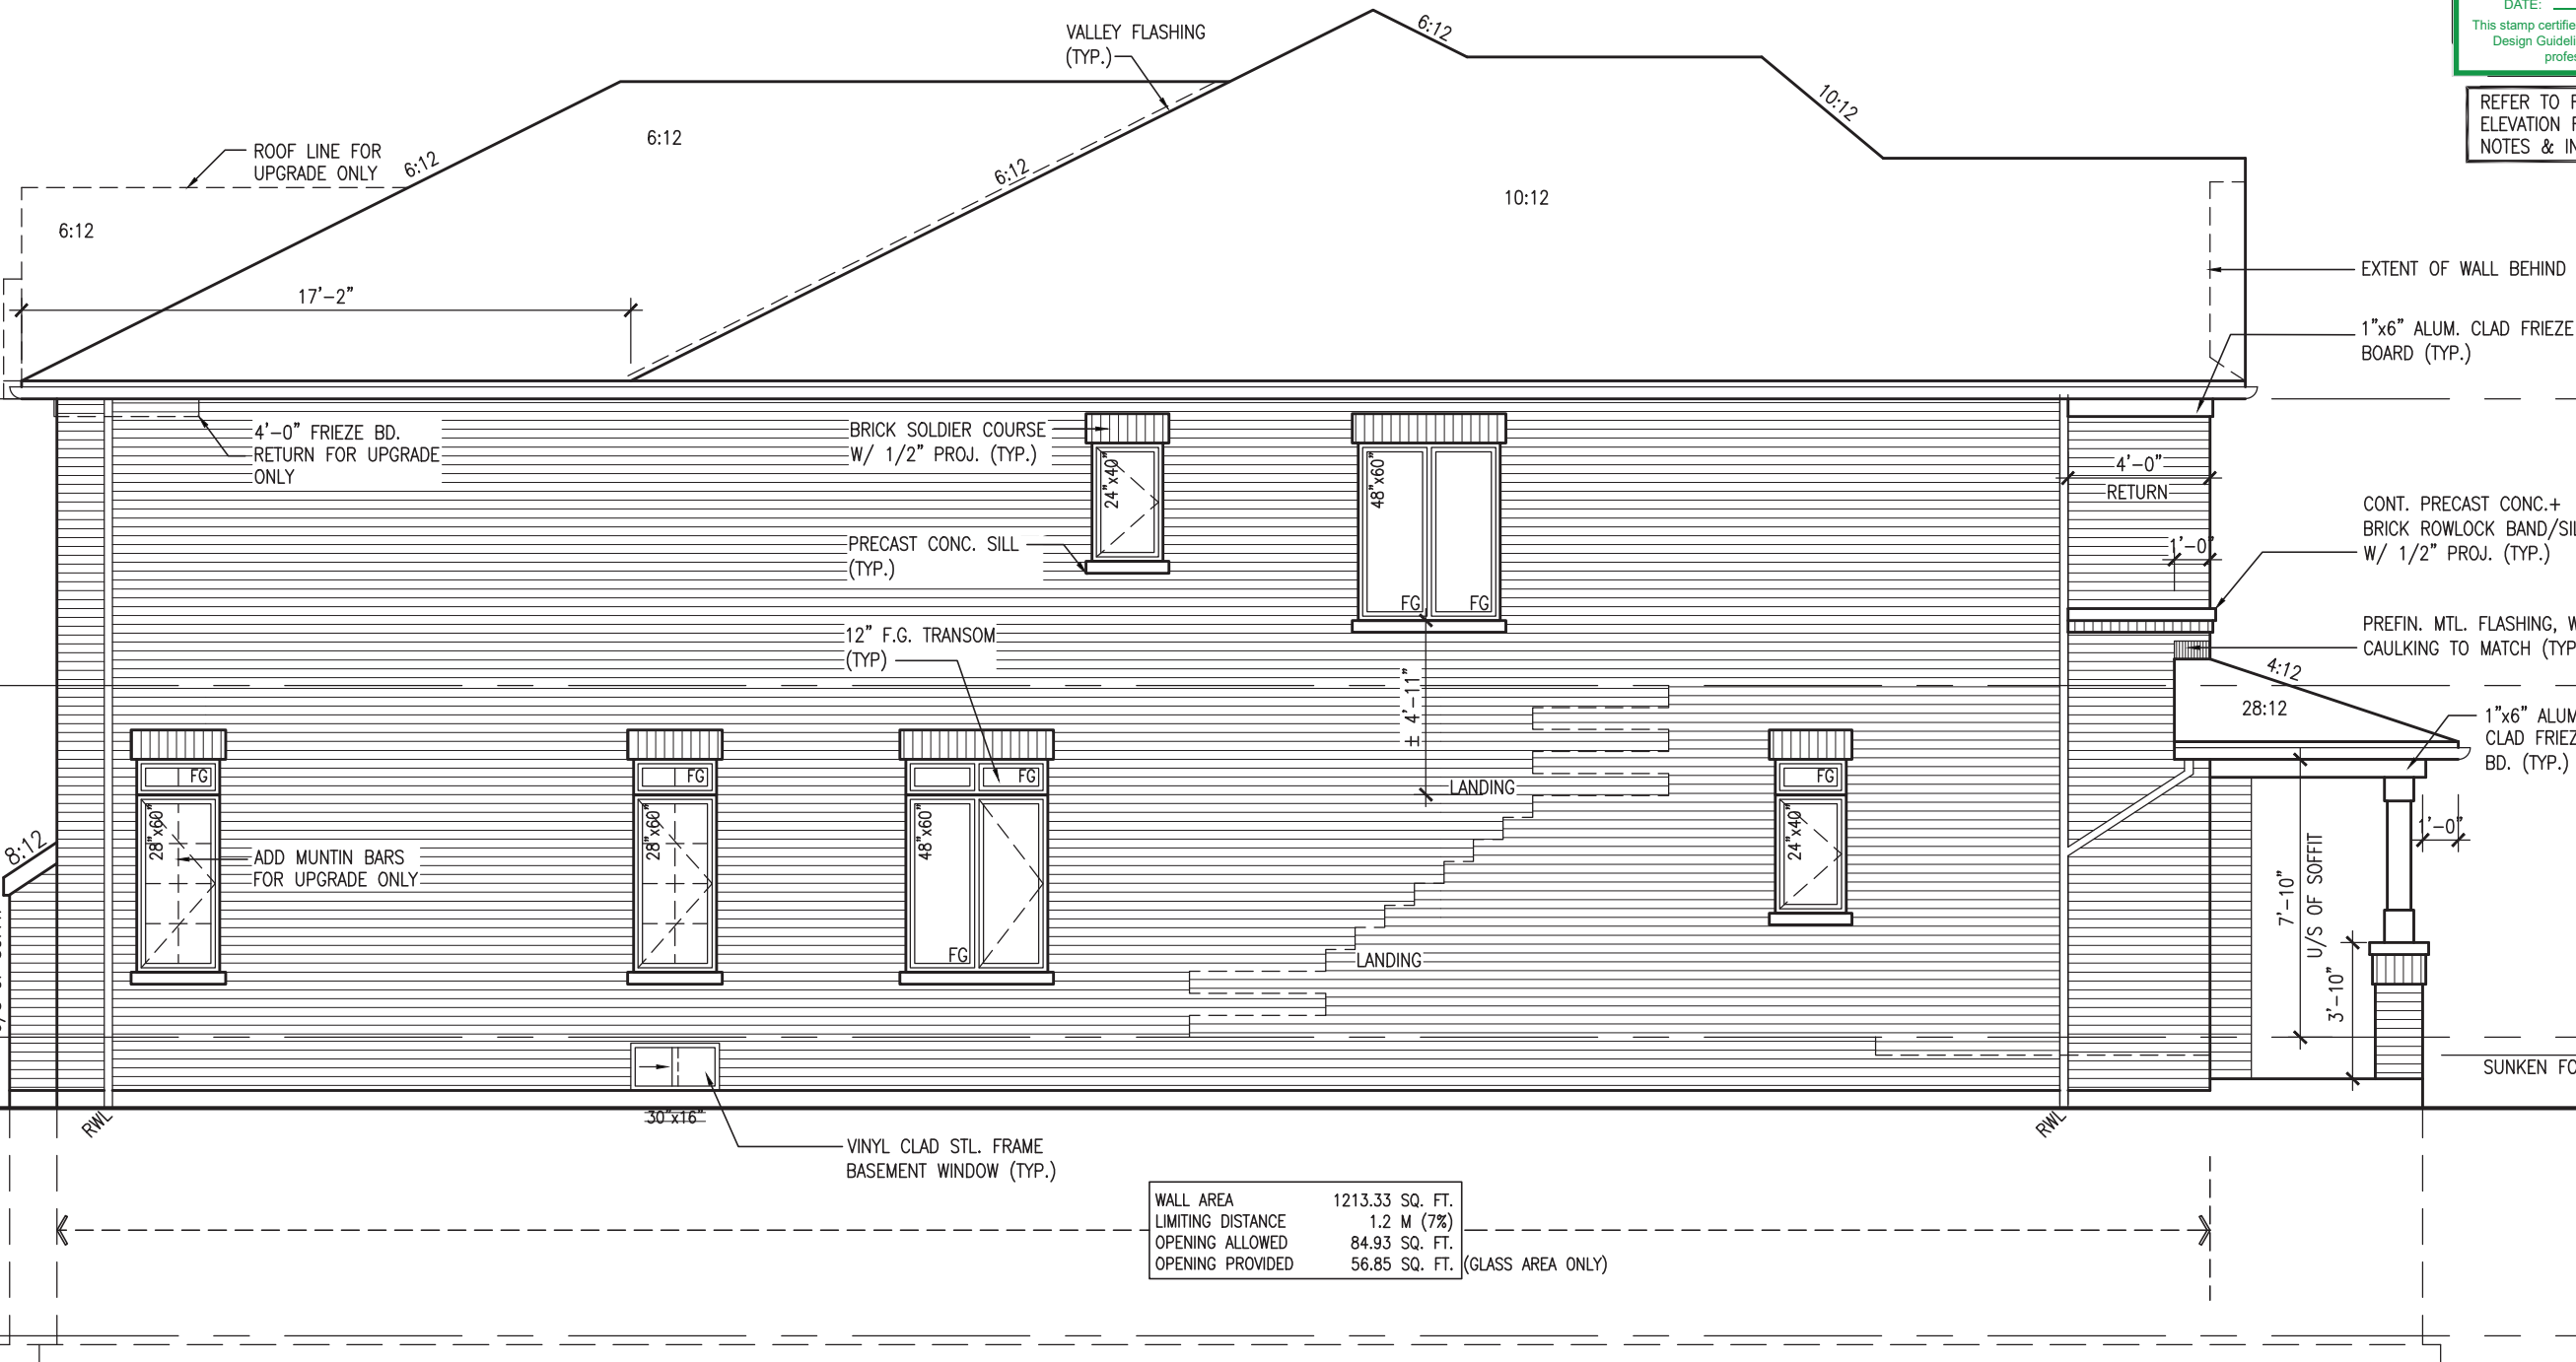

LEFT SIDE ELEVATION 'A'



MAR 1, 2022

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JOHN G. WILLIAMS LTD., ARCHITECT
ARCHITECTURAL CONTROL REVIEW
AND APPROVAL
APPROVED BY: *[Signature]*
DATE: MAR 03, 2022
This stamp certifies compliance with the applicable Design Guidelines only and bears no further professional responsibility.

REFER TO FRONT
ELEVATION FOR TYPICAL
NOTES & INFORMATION

| | | | |
|----------------------|--|-------------------------|--|
| project name | | project no. | |
| BAYVIEW WELLINGTON | | 16023 | |
| GREEN VALLEY ESTATES | | drawing no. | |
| BRADFORD EAST, ON. | | 9 | |
| municipality | | LEFT SIDE ELEVATION 'A' | |
| date | | file name | |
| SEPT. 2021 | | 16023-S38-20 | |
| drawn by | | scale | |
| JWM | | 3/16" = 1'-0" | |
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| checked by | | date | |

BRICK VENEER CONSTRUCTION

(FOR WALLS LESS THAN 1.2M (3'-11") FROM THE LOT LINE)
45 MINUTE FIRE RATED WALL

PROVIDE A CONTINUOUS LAYER OF 12.7mm (1/2") TYPE 'X' GYPSUM BOARD (INTERIOR SIDE) INSTALLED SO THAT ALL EDGES ARE SUPPORTED, TAPED AND FILLED. SPACE BETWEEN WOOD STUDS TO BE FILLED WITH INSULATION CONFORMING TO CAN/ULC-S702, "MINERAL FIBRE THERMAL INSULATION FOR BUILDINGS" WITH A MASS OF NOT LESS THAN 1.22 Kg/SQ.M. AND MUST FILL AT LEAST 90% OF THE CAVITY THICKNESS. THE TYPE 'X' & INSULATION MUST BE RUN CONTINUOUSLY BEHIND ALL INTERSECTING PARTITIONS, MECHANICAL CHASES, BATHTUBS, SHOWERS, ETC. ENSURE INSULATION & TYPE 'X' IS INSTALLED IN GARAGE EXTERIOR WALLS.
(REFER TO SECTION SB-2 OF OBC 2012-SUPPLEMENTARY STANDARDS)




MAR 1, 2022

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JOHN G. WILLIAMS LTD., ARCHITECT
ARCHITECTURAL CONTROL REVIEW
AND APPROVAL
APPROVED BY: [Signature]
DATE: MAR 03, 2022
This stamp certifies compliance with the applicable Design Guidelines only and bears no further professional responsibility.

REFER TO FRONT
ELEVATION FOR TYPICAL
NOTES & INFORMATION



RIGHT SIDE ELEVATION 'A'
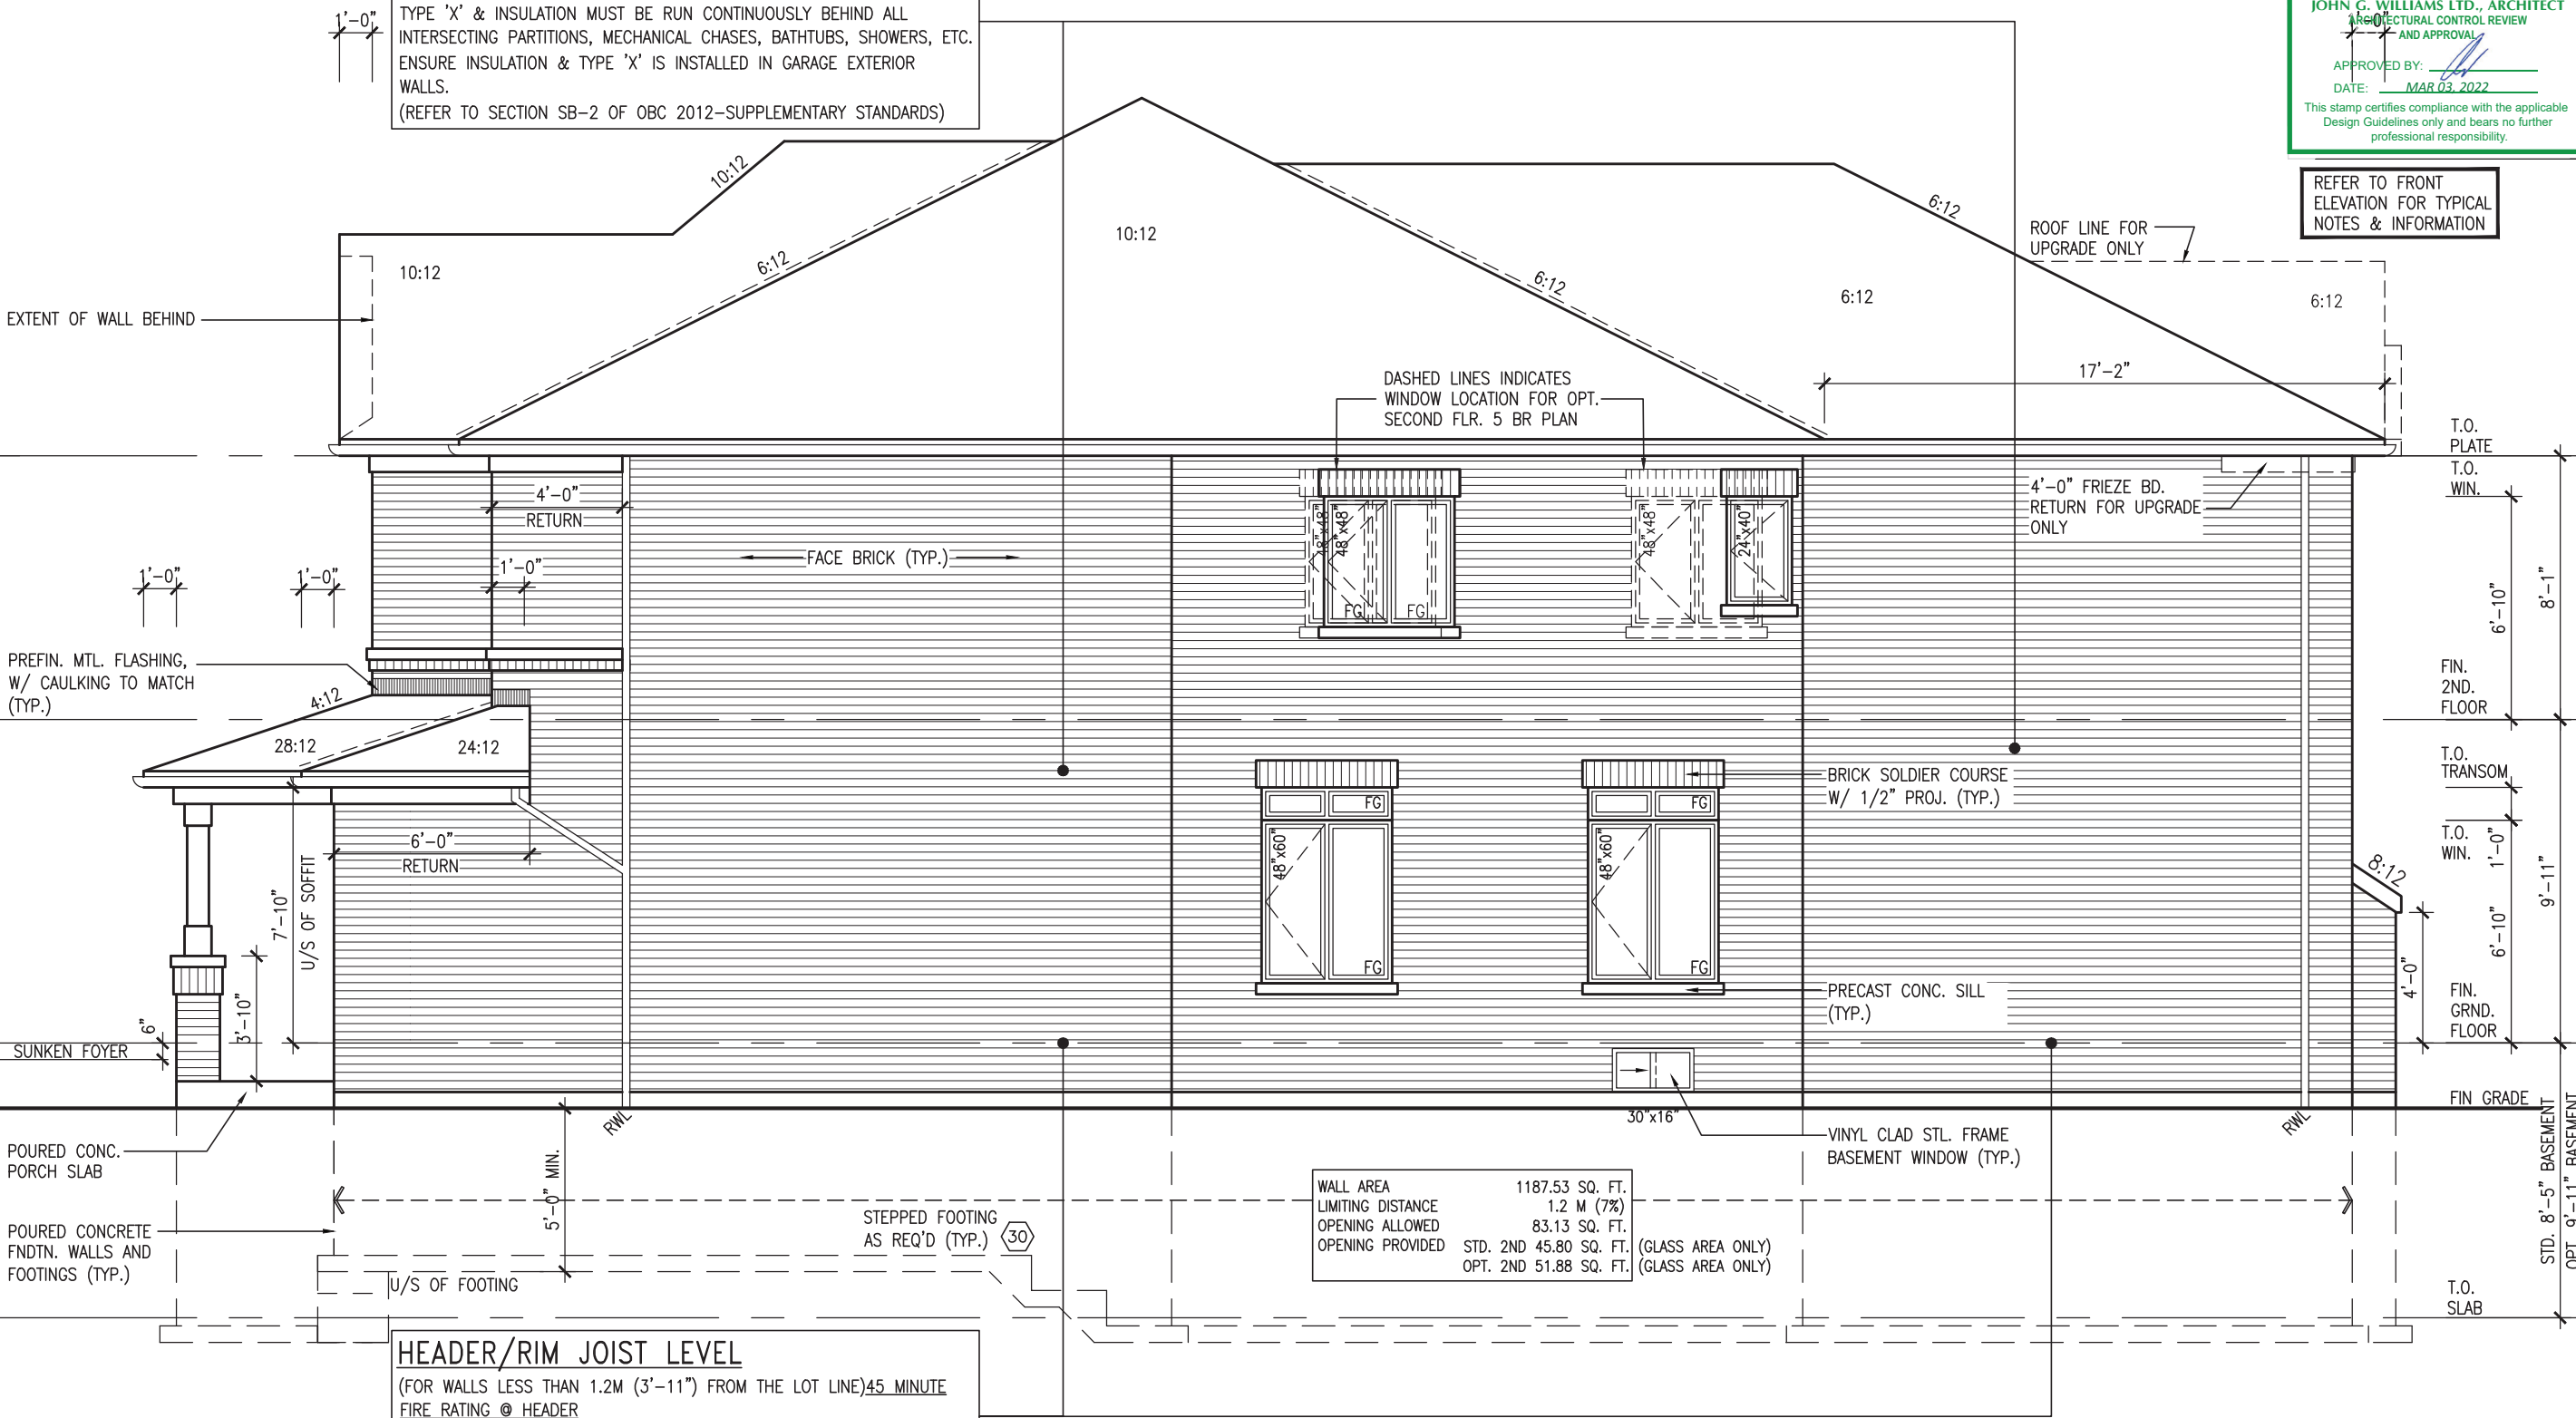
| | | | | | | | |
|---|-------------------------------------|--|--|--------------------|--|----------------------------|--|
| project no. | | 16023 | | drawing no. | | 10 | |
| project name | | GREEN VALLEY ESTATES | | BRADFORD EAST, ON. | | RIGHT SIDE ELEVATION 'A' | |
| municipality | | BAYVIEW WELLINGTON | | S38-20 | | | |
| date | | SEPT. 2021 | | checked by | | JWM | |
| drawn by | | NC | | scale | | 3/16" = 1'-0" | |
| drawn by | | RICHARD - H. ARCHIVE WORKING\2016\16023.BW\Units\38\16023-S38-20.dwg | | drawn by | | Tue - Mar 1 2022 - 2:39 PM | |
| no. | | description | | date | | by | |
| 3 | REVISED AS PER ENG COMMENTS | MAR 01-22 RC | | | | | |
| 2 | REVISED AS PER FLOOR / ROOF LAYOUTS | FEB 24-22 RC | | | | | |
| 1 | ISSUED FOR CLIENT REVIEW | NOV 23-21 VAS | | | | | |
| The undersigned has reviewed and takes responsibility for this design and has the qualifications and meets the requirements set out in the Ontario Building Code to be a Designer. | | Wellington Jno-Baptiste | | 25591 | | BCIN | |
| name | | Jno-Baptiste | | 42658 | | BCIN | |
| registration information | | VAS Design Inc. | | | | | |
| Contractor must verify all dimensions on the job and report any discrepancy to the Designer before proceeding with the work. All drawings and specifications are instruments of service and the property of the Designer which must be returned at the completion of the work. Drawings are not to be scaled. | | | | | | | |

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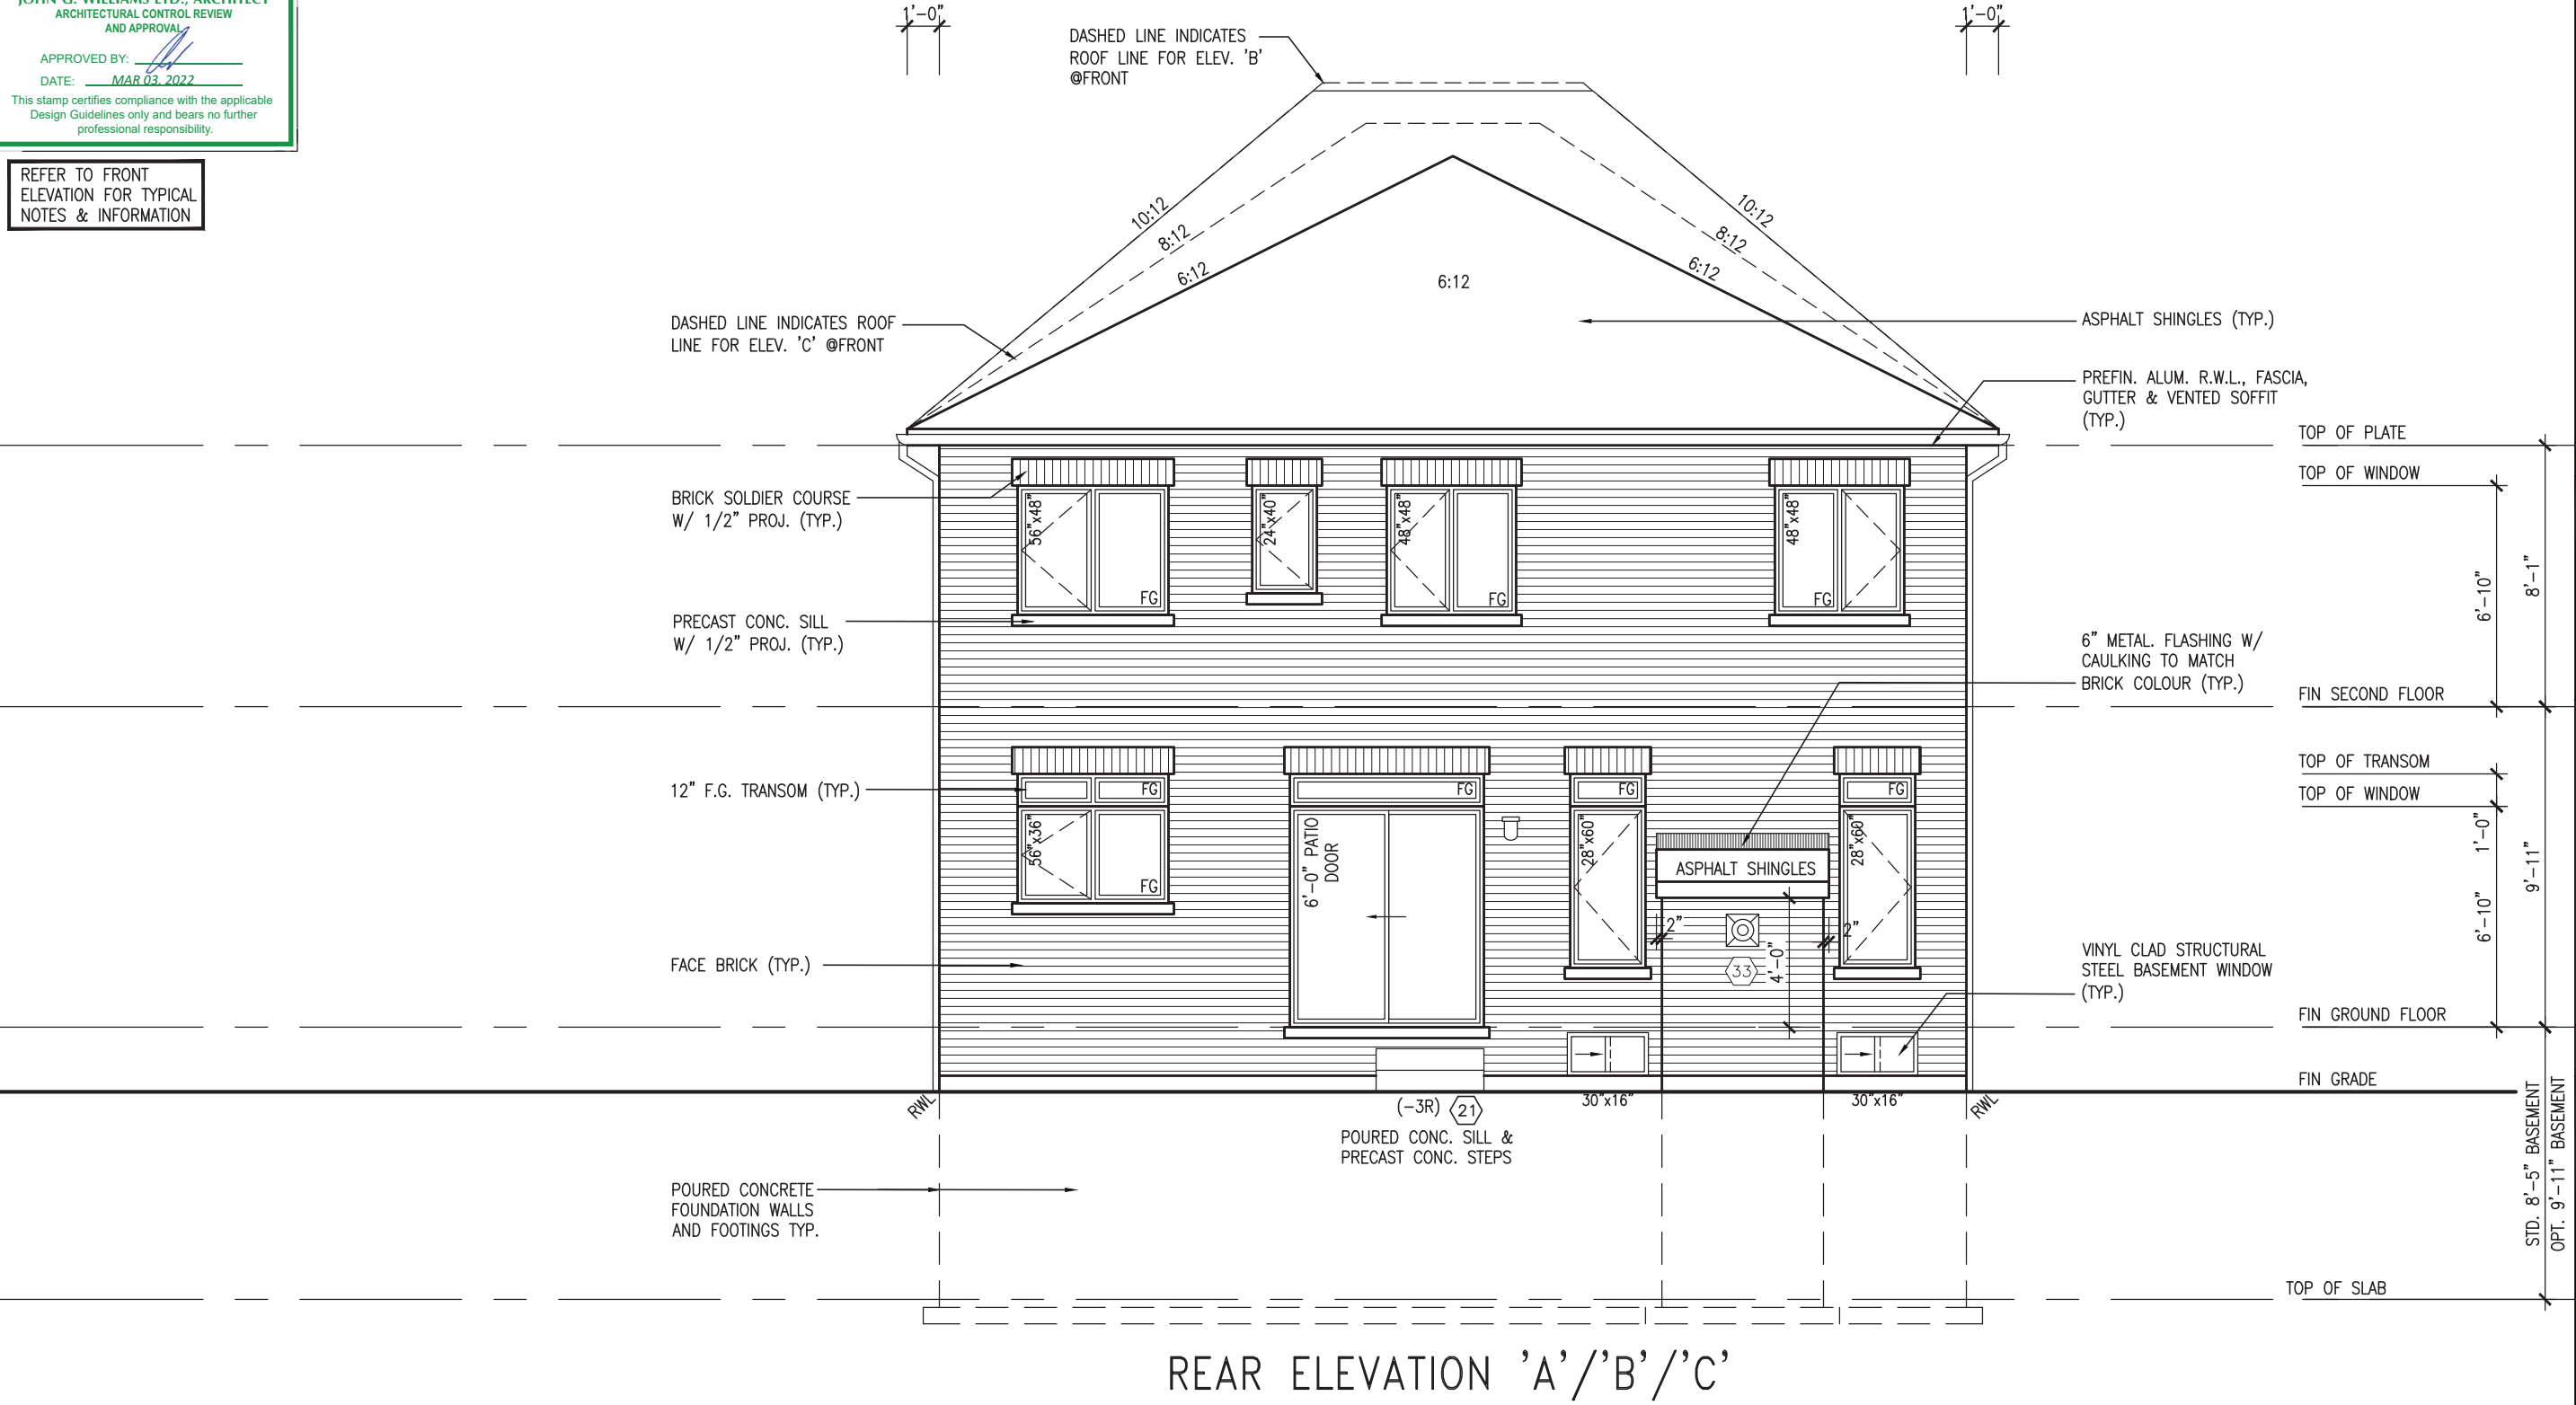
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JOHN G. WILLIAMS LTD., ARCHITECT
ARCHITECTURAL CONTROL REVIEW
AND APPROVAL


APPROVED BY: _____
DATE: MAR 03, 2022

This stamp certifies compliance with the applicable Design Guidelines only and bears no further professional responsibility.


REFER TO FRONT
ELEVATION FOR TYPICAL
NOTES & INFORMATION



| BAYVIEW WELLINGTON | | S38-20 | |
|----------------------------|--|----------------------------|--|
| GREEN VALLEY ESTATES | | BRADFORD EAST, ON. | |
| project name | | project no. | |
| 16023-S38-20 | | 16023 | |
| drawing no. | | 11 | |
| date | | date | |
| SEPT. 2021 | | SEPT. 2021 | |
| drawn by | | drawn by | |
| JWM | | JWM | |
| checked by | | checked by | |
| JWM | | JWM | |
| scale | | scale | |
| 3/16" = 1'-0" | | 3/16" = 1'-0" | |
| municipality | | municipality | |
| BRADFORD EAST, ON. | | BRADFORD EAST, ON. | |
| rear elevation 'A'/'B'/'C' | | rear elevation 'A'/'B'/'C' | |
| file name | | file name | |
| 16023-S38-20 | | 16023-S38-20 | |
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| rear elevation 'A'/'B'/'C' | | rear elevation 'A'/'B'/'C' | |
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| rear elevation 'A'/'B'/'C' | | rear elevation 'A'/'B'/'C' | |
| file name | | file name | |
| 16023-S38-20 | | 16023-S38-20 | |
| drawn by | | drawn by | |
| JWM | | JWM | |
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| rear elevation 'A'/'B'/'C' | | rear elevation 'A'/'B'/'C' | |
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| checked by | | checked by | |
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| rear elevation 'A'/'B'/'C' | | rear elevation 'A'/'B'/'C' | |
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| 3/16" = 1'-0" | | 3/16" = 1'-0" | |
| municipality | | municipality | |
| BRADFORD EAST, ON. | | BRADFORD EAST, ON. | |
| rear elevation 'A'/'B'/'C' | | rear elevation 'A'/'B'/'C' | |
| file name | | file name | |
| 16023-S38-20 | | 16023-S38-20 | |
| drawn by | | drawn by | |
| JWM | | JWM | |
| checked by | | checked by | |
| JWM | | JWM | |
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| 3/16" = 1'-0" | | 3/16" = 1'-0" | |
| municipality | | municipality | |
| BRADFORD EAST, ON. | | BRADFORD EAST, ON. | |
| rear elevation 'A'/'B'/'C' | | rear elevation 'A'/'B'/'C' | |
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| 16023-S38-20 | | 16023-S38-20 | |
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| 3/16" = 1'-0" | | 3/16" = 1'-0" | |
| municipality | | municipality | |
| BRADFORD EAST, ON. | | BRADFORD EAST, ON. | |
| rear elevation 'A'/'B'/'C' | | rear elevation 'A'/'B'/'C' | |
| file name | | file name | |
| 16023-S38-20 | | 16023-S38-20 | |
| drawn by | | drawn by | |
| JWM | | JWM | |
| checked by | | checked by | |
| JWM | | JWM | |
| scale | | scale | |
| 3/16" = 1'-0" | | 3/16" = 1'-0" | |
| municipality | | municipality | |
| BRADFORD EAST, ON. | | BRADFORD EAST, ON. | |
| rear elevation 'A'/'B'/'C' | | rear elevation 'A'/'B'/'C' | |
| file name | | file name | |
| 16023-S38-20 | | 16023-S38-20 | |
| drawn by | | drawn by | |
| JWM | | JWM | |
| checked by | | checked by | |
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| 3/16" = 1'-0" | | 3/16" = 1'-0" | |
| municipality | | municipality | |
| BRADFORD EAST, ON. | | BRADFORD EAST, ON. | |
| rear elevation 'A'/'B'/'C' | | rear elevation 'A'/'B'/'C' | |
| file name | | file name | |
| 16023-S38-20 | | 16023-S38-20 | |
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| 3/16" = 1'-0" | | 3/16" = 1'-0" | |
| municipality | | municipality | |
| BRADFORD EAST, ON. | | BRADFORD EAST, ON. | |
| rear elevation 'A'/'B'/'C' | | rear elevation 'A'/'B'/'C' | |
| file name | | file name | |
| 16023-S38-20 | | 16023-S38-20 | |
| drawn by | | drawn by | |
| JWM | | JWM | |
| checked by | | checked by | |
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| municipality | | municipality | |
| BRADFORD EAST, ON. | | BRADFORD EAST, ON. | |
| rear elevation 'A'/'B'/'C' | | rear elevation 'A'/'B'/'C' | |
| file name | | file name | |
| 16023-S38-20 | | 16023-S38-20 | |
| drawn by | | drawn by | |
| JWM | | JWM | |
| checked by | | checked by | |
| JWM | | JWM | |
| scale | | scale | |
| 3/16" = 1'-0" | | 3/16" = 1'-0" | |
| municipality | | municipality | |
| BRADFORD EAST, ON. | | BRADFORD EAST, ON. | |
| rear elevation 'A'/'B'/'C' | | rear elevation 'A'/'B'/'C' | |
| file name | | file name | |
| 16023-S38-20 | | 16023-S38-20 | |
| drawn by | | drawn by | |
| JWM | | JWM | |
| checked by | | checked by | |
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| scale | | scale | |
| 3/16" = 1'-0" | | 3/16" = 1'-0" | |
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| BRADFORD EAST, ON. | | BRADFORD EAST, ON. | |
| rear elevation 'A'/'B'/'C' | | rear elevation 'A'/'B'/'C' | |
| file name | | file name | |
| 16023-S38-20 | | 16023-S38-20 | |
| drawn by | | drawn by | |
| JWM | | JWM | |
| checked by | | checked by | |
| JWM | | JWM | |
| scale | | scale | |
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| municipality | | municipality | |
| BRADFORD EAST, ON. | | BRADFORD EAST, ON. | |
| rear elevation 'A'/'B'/'C' | | rear elevation 'A'/'B'/'C' | |
| file name | | file name | |
| 16023-S38-20 | | 16023-S38-20 | |
| drawn by | | drawn by | |
| JWM | | JWM | |
| checked by | | checked by | |
| JWM | | JWM | |
| scale | | scale | |
| 3/16" = 1'-0" | | 3/16" = 1'-0" | |
| municipality | | municipality | |
| BRADFORD EAST, ON. | | BRADFORD EAST, ON. | |
| rear elevation 'A'/'B'/'C' | | rear elevation 'A'/'B'/'C' | |
| file name | | file name | |
| 16023-S38-20 | | 16023-S38-20 | |
| drawn by | | drawn by | |
| JWM | | JWM | |
| checked by | | checked by | |
| JWM | | JWM | |
| scale | | scale | |
| 3/16" = 1'-0" | | 3/16" = 1'-0" | |
| municipality | | municipality | |
| BRADFORD EAST, ON. | | BRADFORD EAST, ON. | |
| rear elevation 'A'/'B'/' | | | |

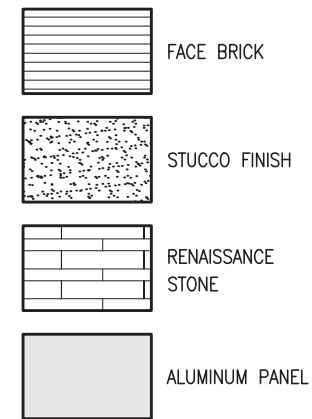

JOHN G. WILLIAMS LTD., ARCHITECT
ARCHITECTURAL CONTROL REVIEW
AND APPROVAL

APPROVED BY: 

DATE: MAR 03, 2022


This stamp certifies compliance with the applicable Design Guidelines only and bears no further professional responsibility.

VA3
DESIGN

255 Consumers Rd Suite 120
Toronto ON M2J 1R4
t 416.630.2255 f 416.630.4782
va3design.com


specifications related documents and drawings

| no. | description | date | by |
|-----|-------------------------------------|-----------|-----|
| 1 | ISSUED FOR CLIENT REVIEW | NOV 23-21 | VA3 |
| 2 | REMOVED AS PER FLOOR / ROOF LAYOUTS | FEB 24-22 | RC |
| 3 | REVISED AS PER ENG COMMENTS | MAR 01-22 | RC |
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1'-0"

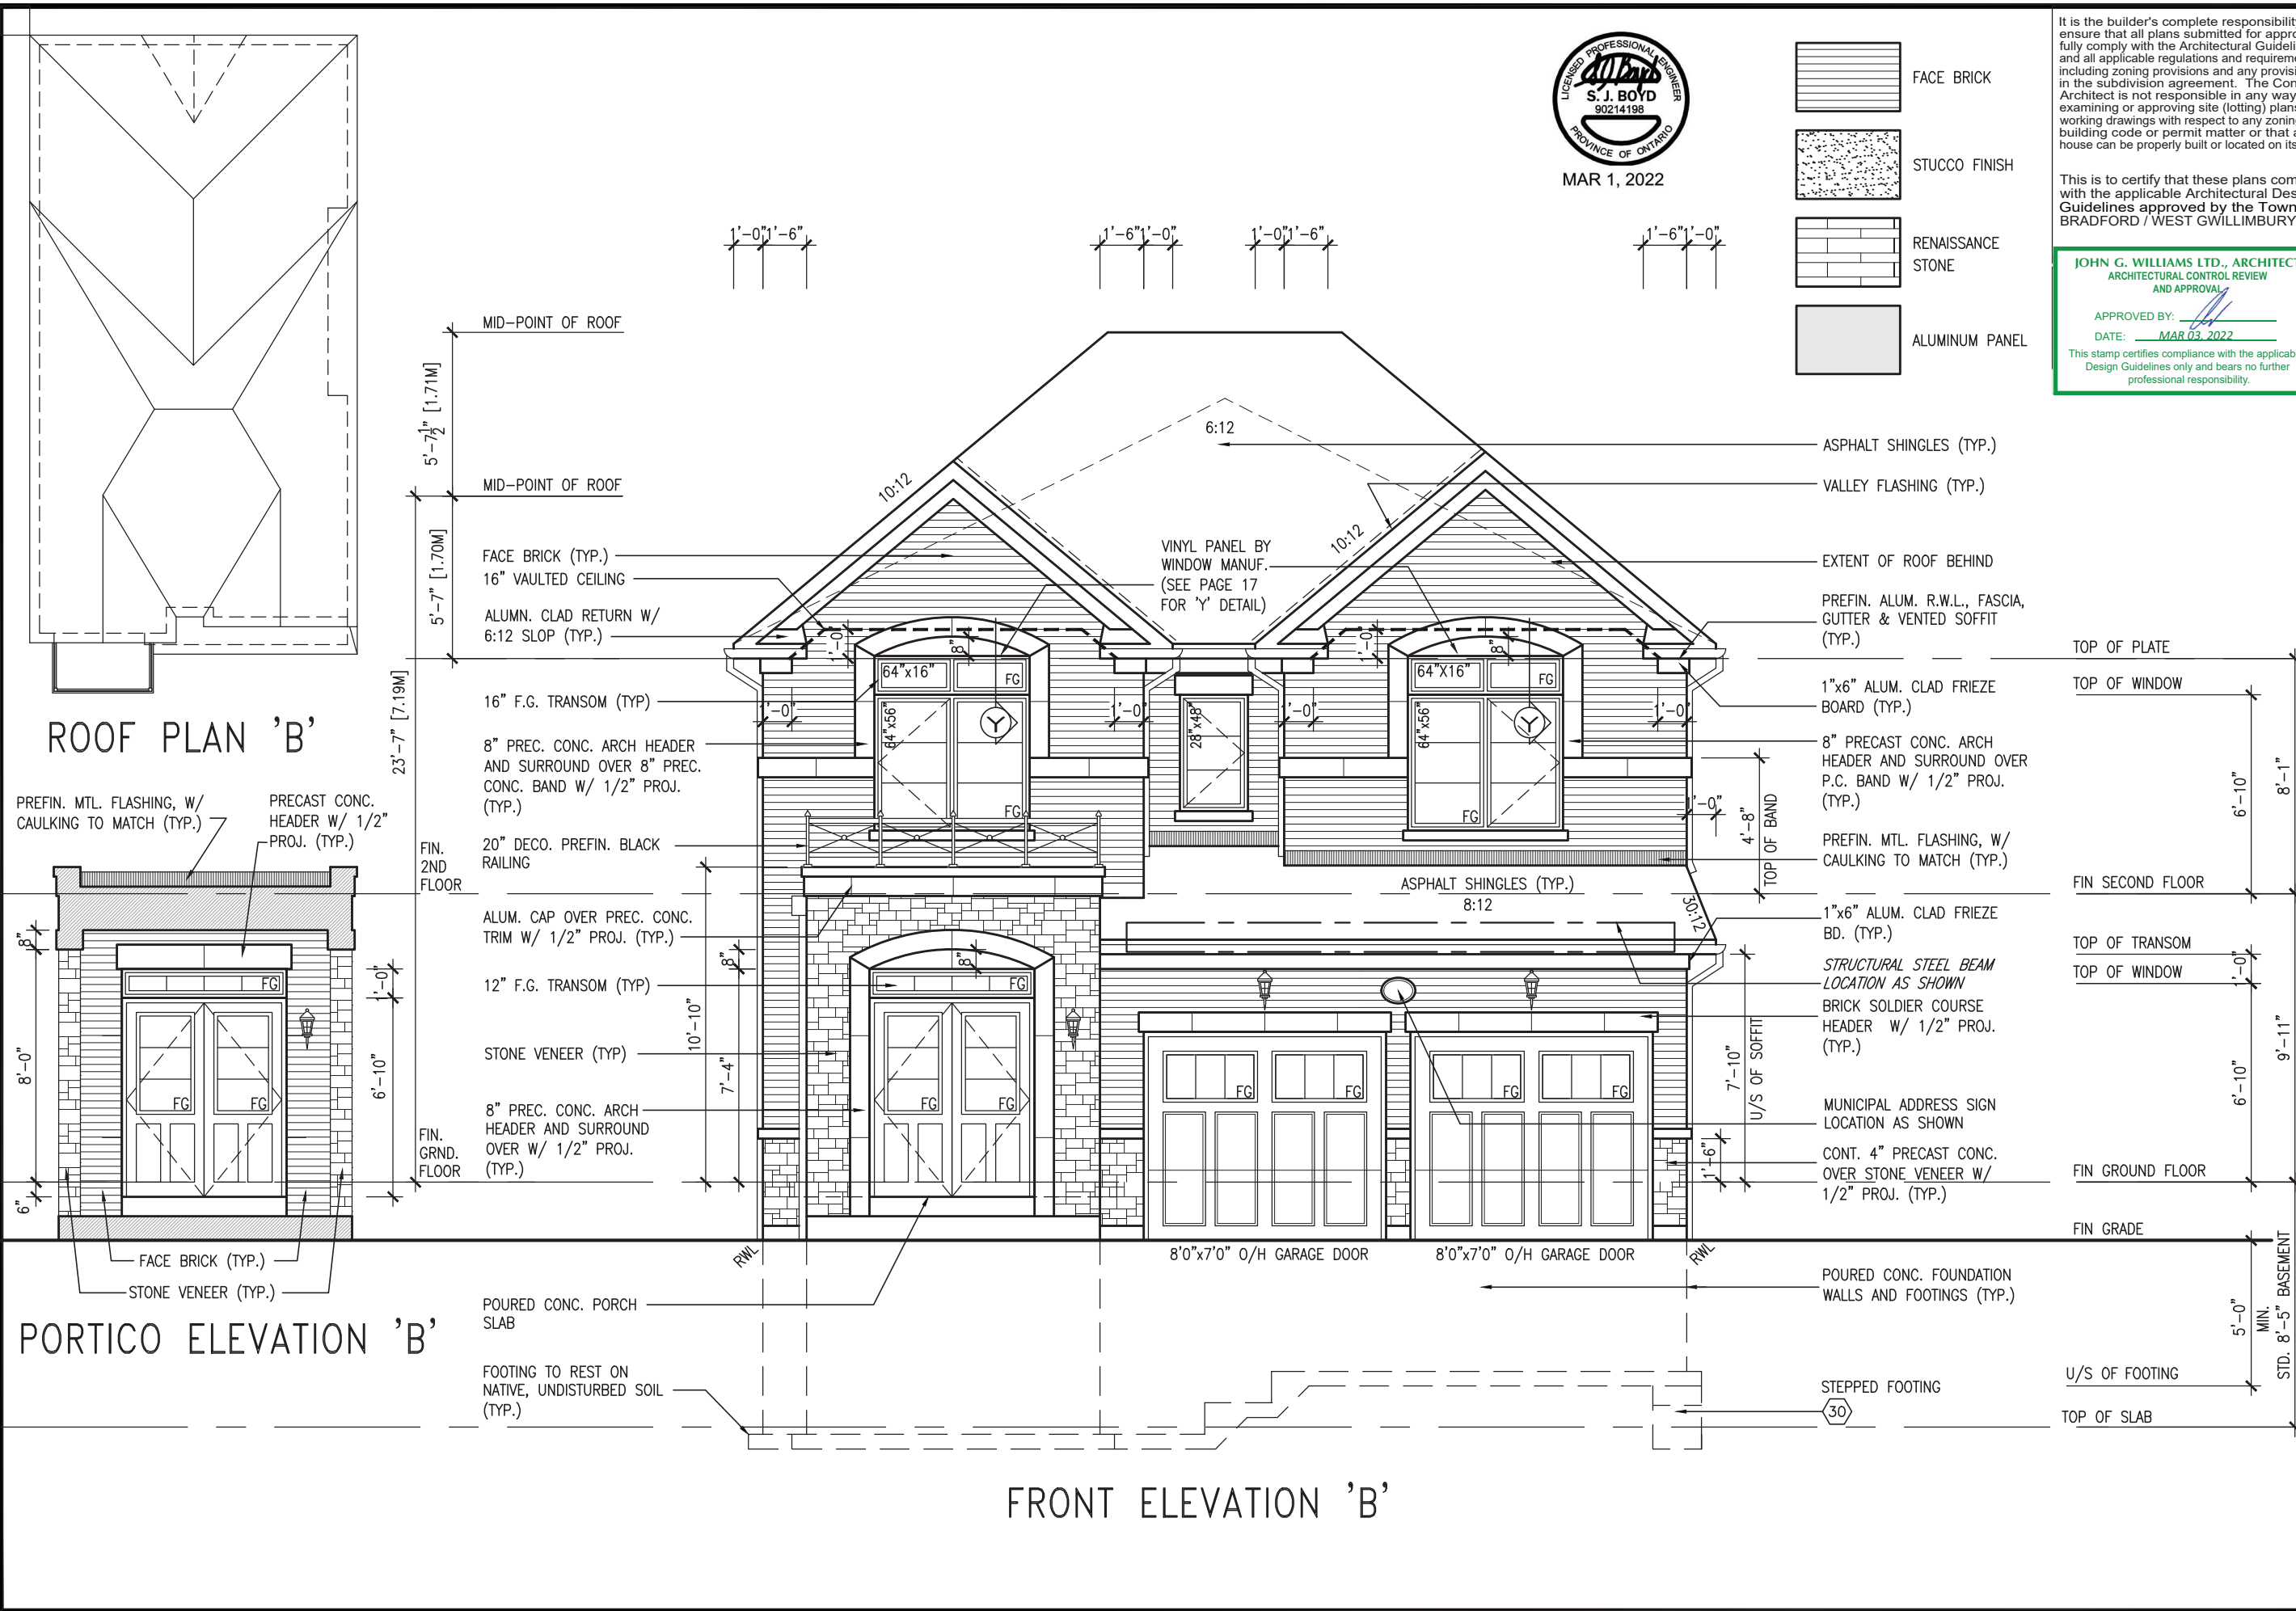1'-0"



LEFT SIDE ELEVATION 'B'

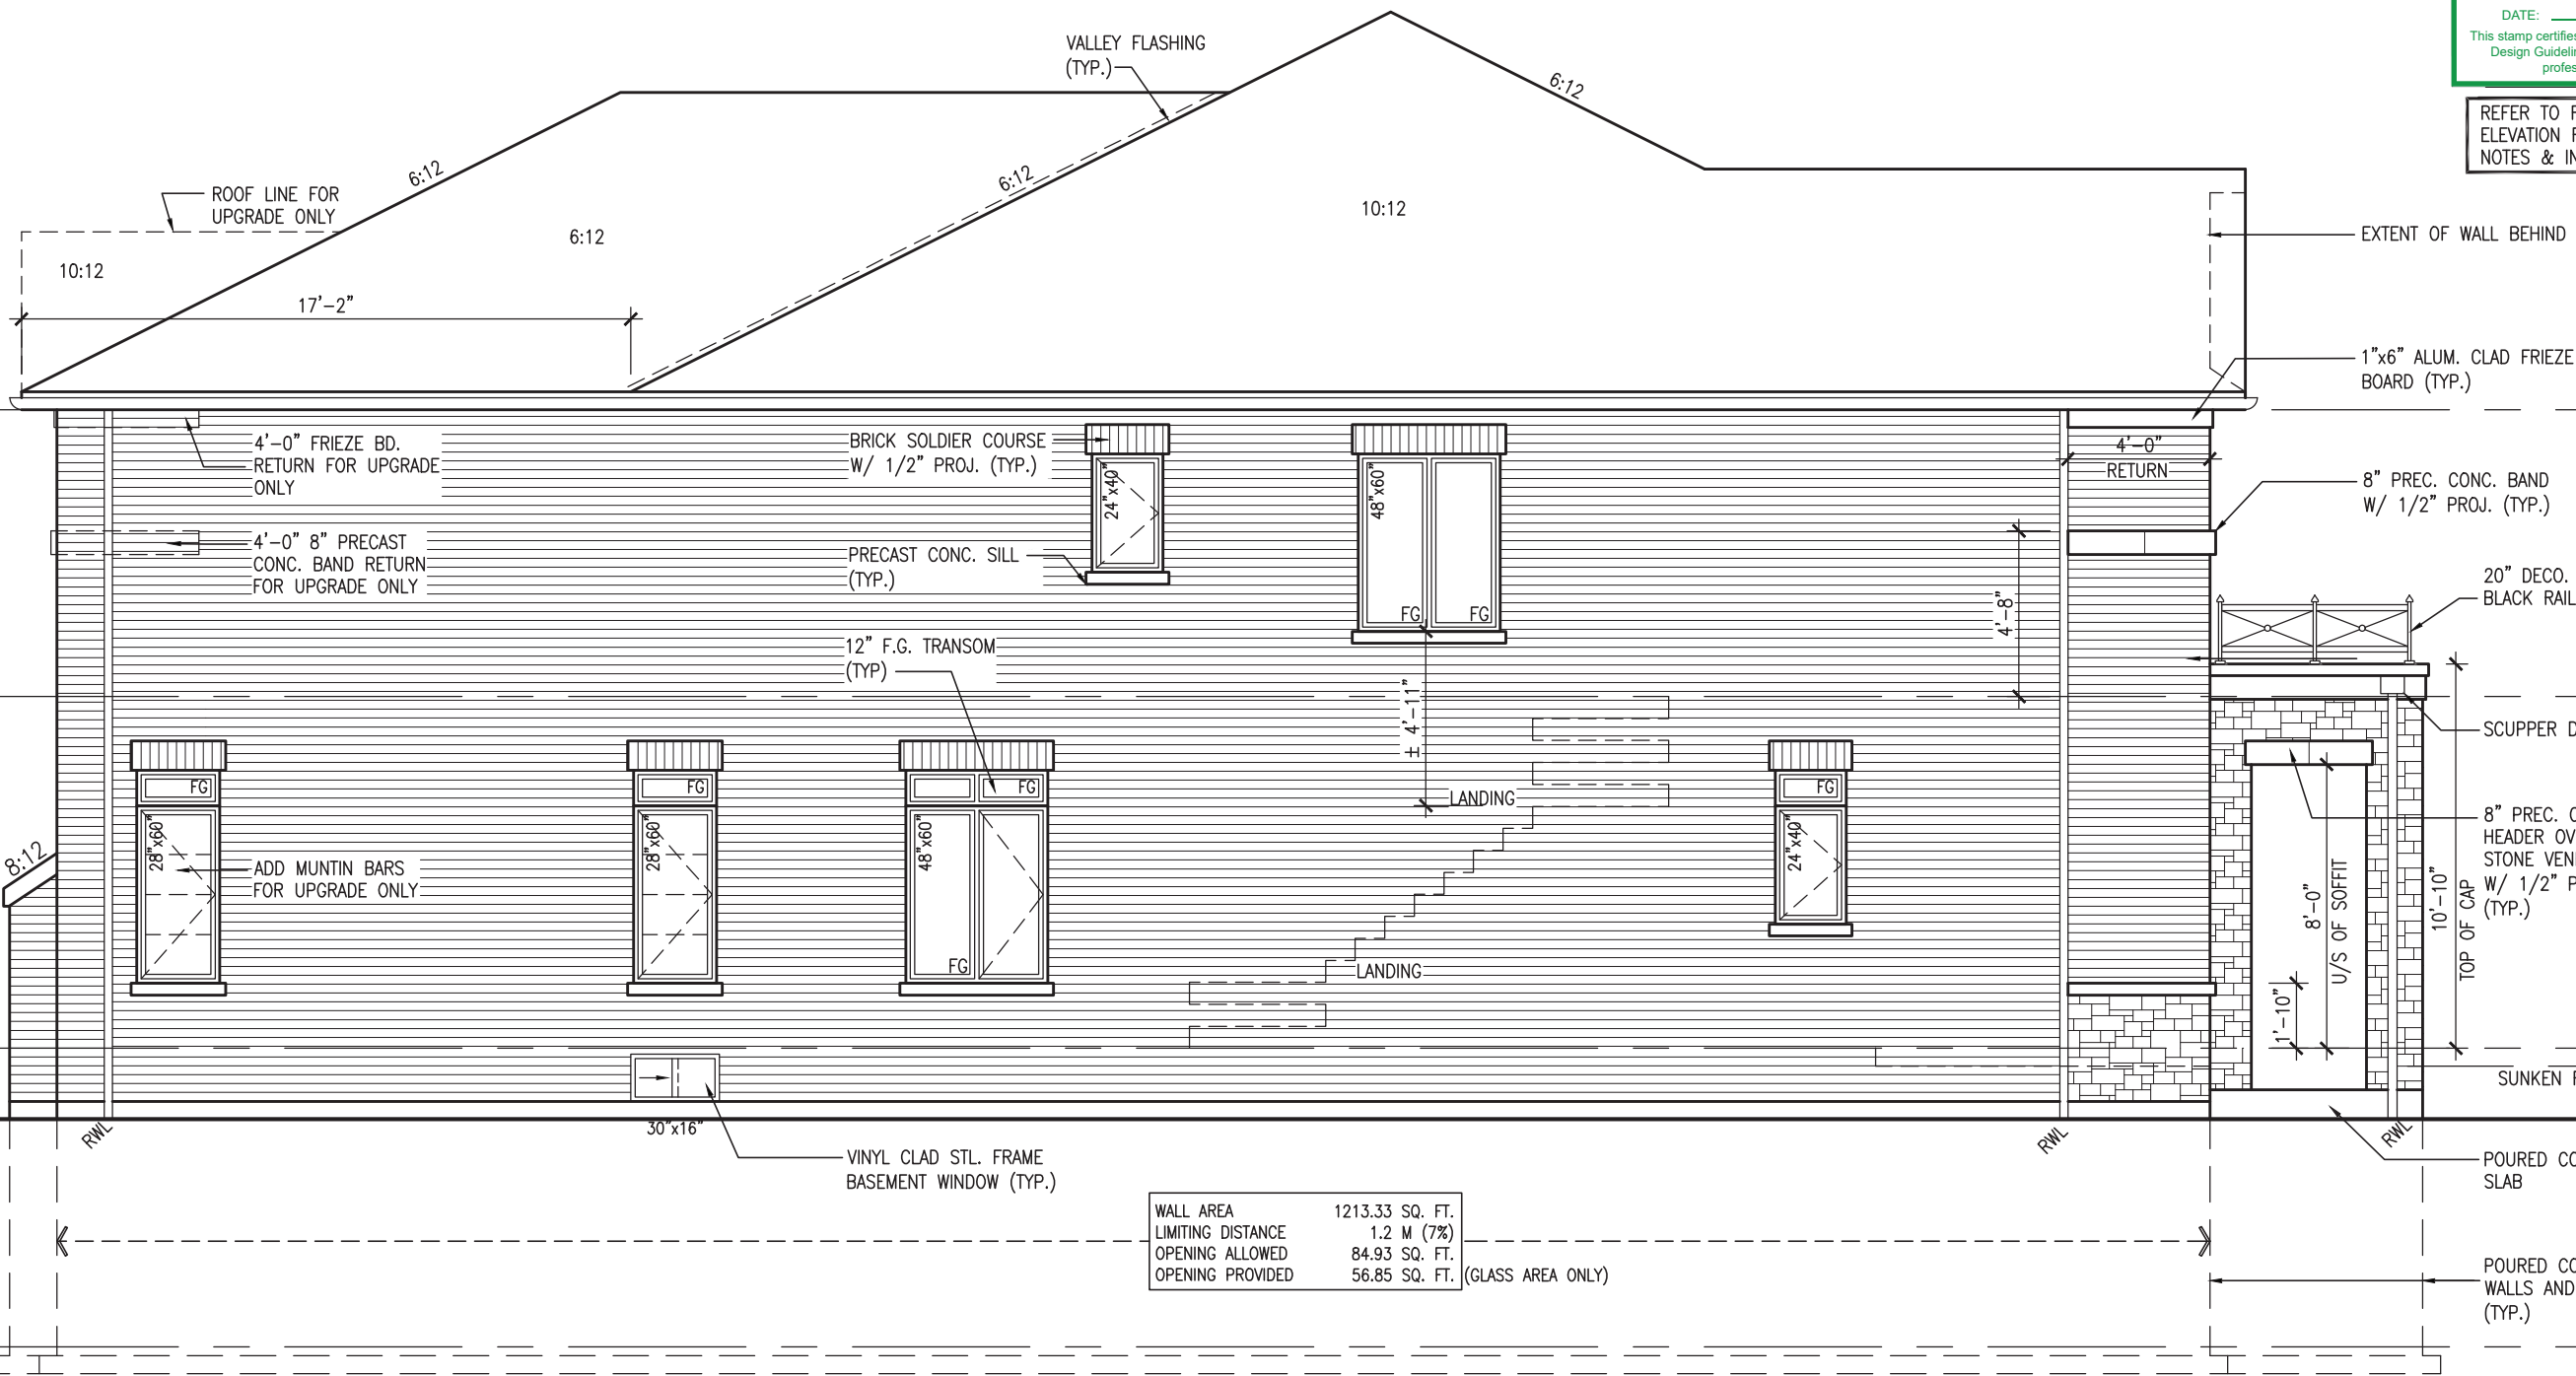

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This is to certify that these plans comply with the applicable Architectural Design Guidelines approved by the Town of BRADFORD / WEST GWILLIMBURY.

JOHN G. WILLIAMS LTD., ARCHITECT
ARCHITECTURAL CONTROL REVIEW
AND APPROVAL
APPROVED BY: *[Signature]*
DATE: MAR 03, 2022
This stamp certifies compliance with the applicable Design Guidelines only and bears no further professional responsibility.

REFER TO FRONT
ELEVATION FOR TYPICAL
NOTES & INFORMATION

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|--|--|---|--|--|--|
| | |  | | | |
| | | 255 Consumers Rd Suite 120 Toronto, ON M2J 1R4 t 416.630.2255 f 416.630.4782 va3design.com | | | |
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BRICK VENEER CONSTRUCTION

(FOR WALLS LESS THAN 1.2M (3'-11") FROM THE LOT LINE)
45 MINUTE FIRE RATED WALL

PROVIDE A CONTINUOUS LAYER OF 12.7mm (1/2") TYPE 'X' GYPSUM BOARD (INTERIOR SIDE) INSTALLED SO THAT ALL EDGES ARE SUPPORTED, TAPED AND FILLED. SPACE BETWEEN WOOD STUDS TO BE FILLED WITH INSULATION CONFORMING TO CAN/ULC-S702, "MINERAL FIBRE THERMAL INSULATION FOR BUILDINGS" WITH A MASS OF NOT LESS THAN 1.22 Kg/SQ.M. AND MUST FILL AT LEAST 90% OF THE CAVITY THICKNESS. THE TYPE 'X' & INSULATION MUST BE RUN CONTINUOUSLY BEHIND ALL INTERSECTING PARTITIONS, MECHANICAL CHASES, BATHTUBS, SHOWERS, ETC. ENSURE INSULATION & TYPE 'X' IS INSTALLED IN GARAGE EXTERIOR WALLS.

(REFER TO SECTION SB-2 OF OBC 2012-SUPPLEMENTARY STANDARDS)



MAR 1, 2022

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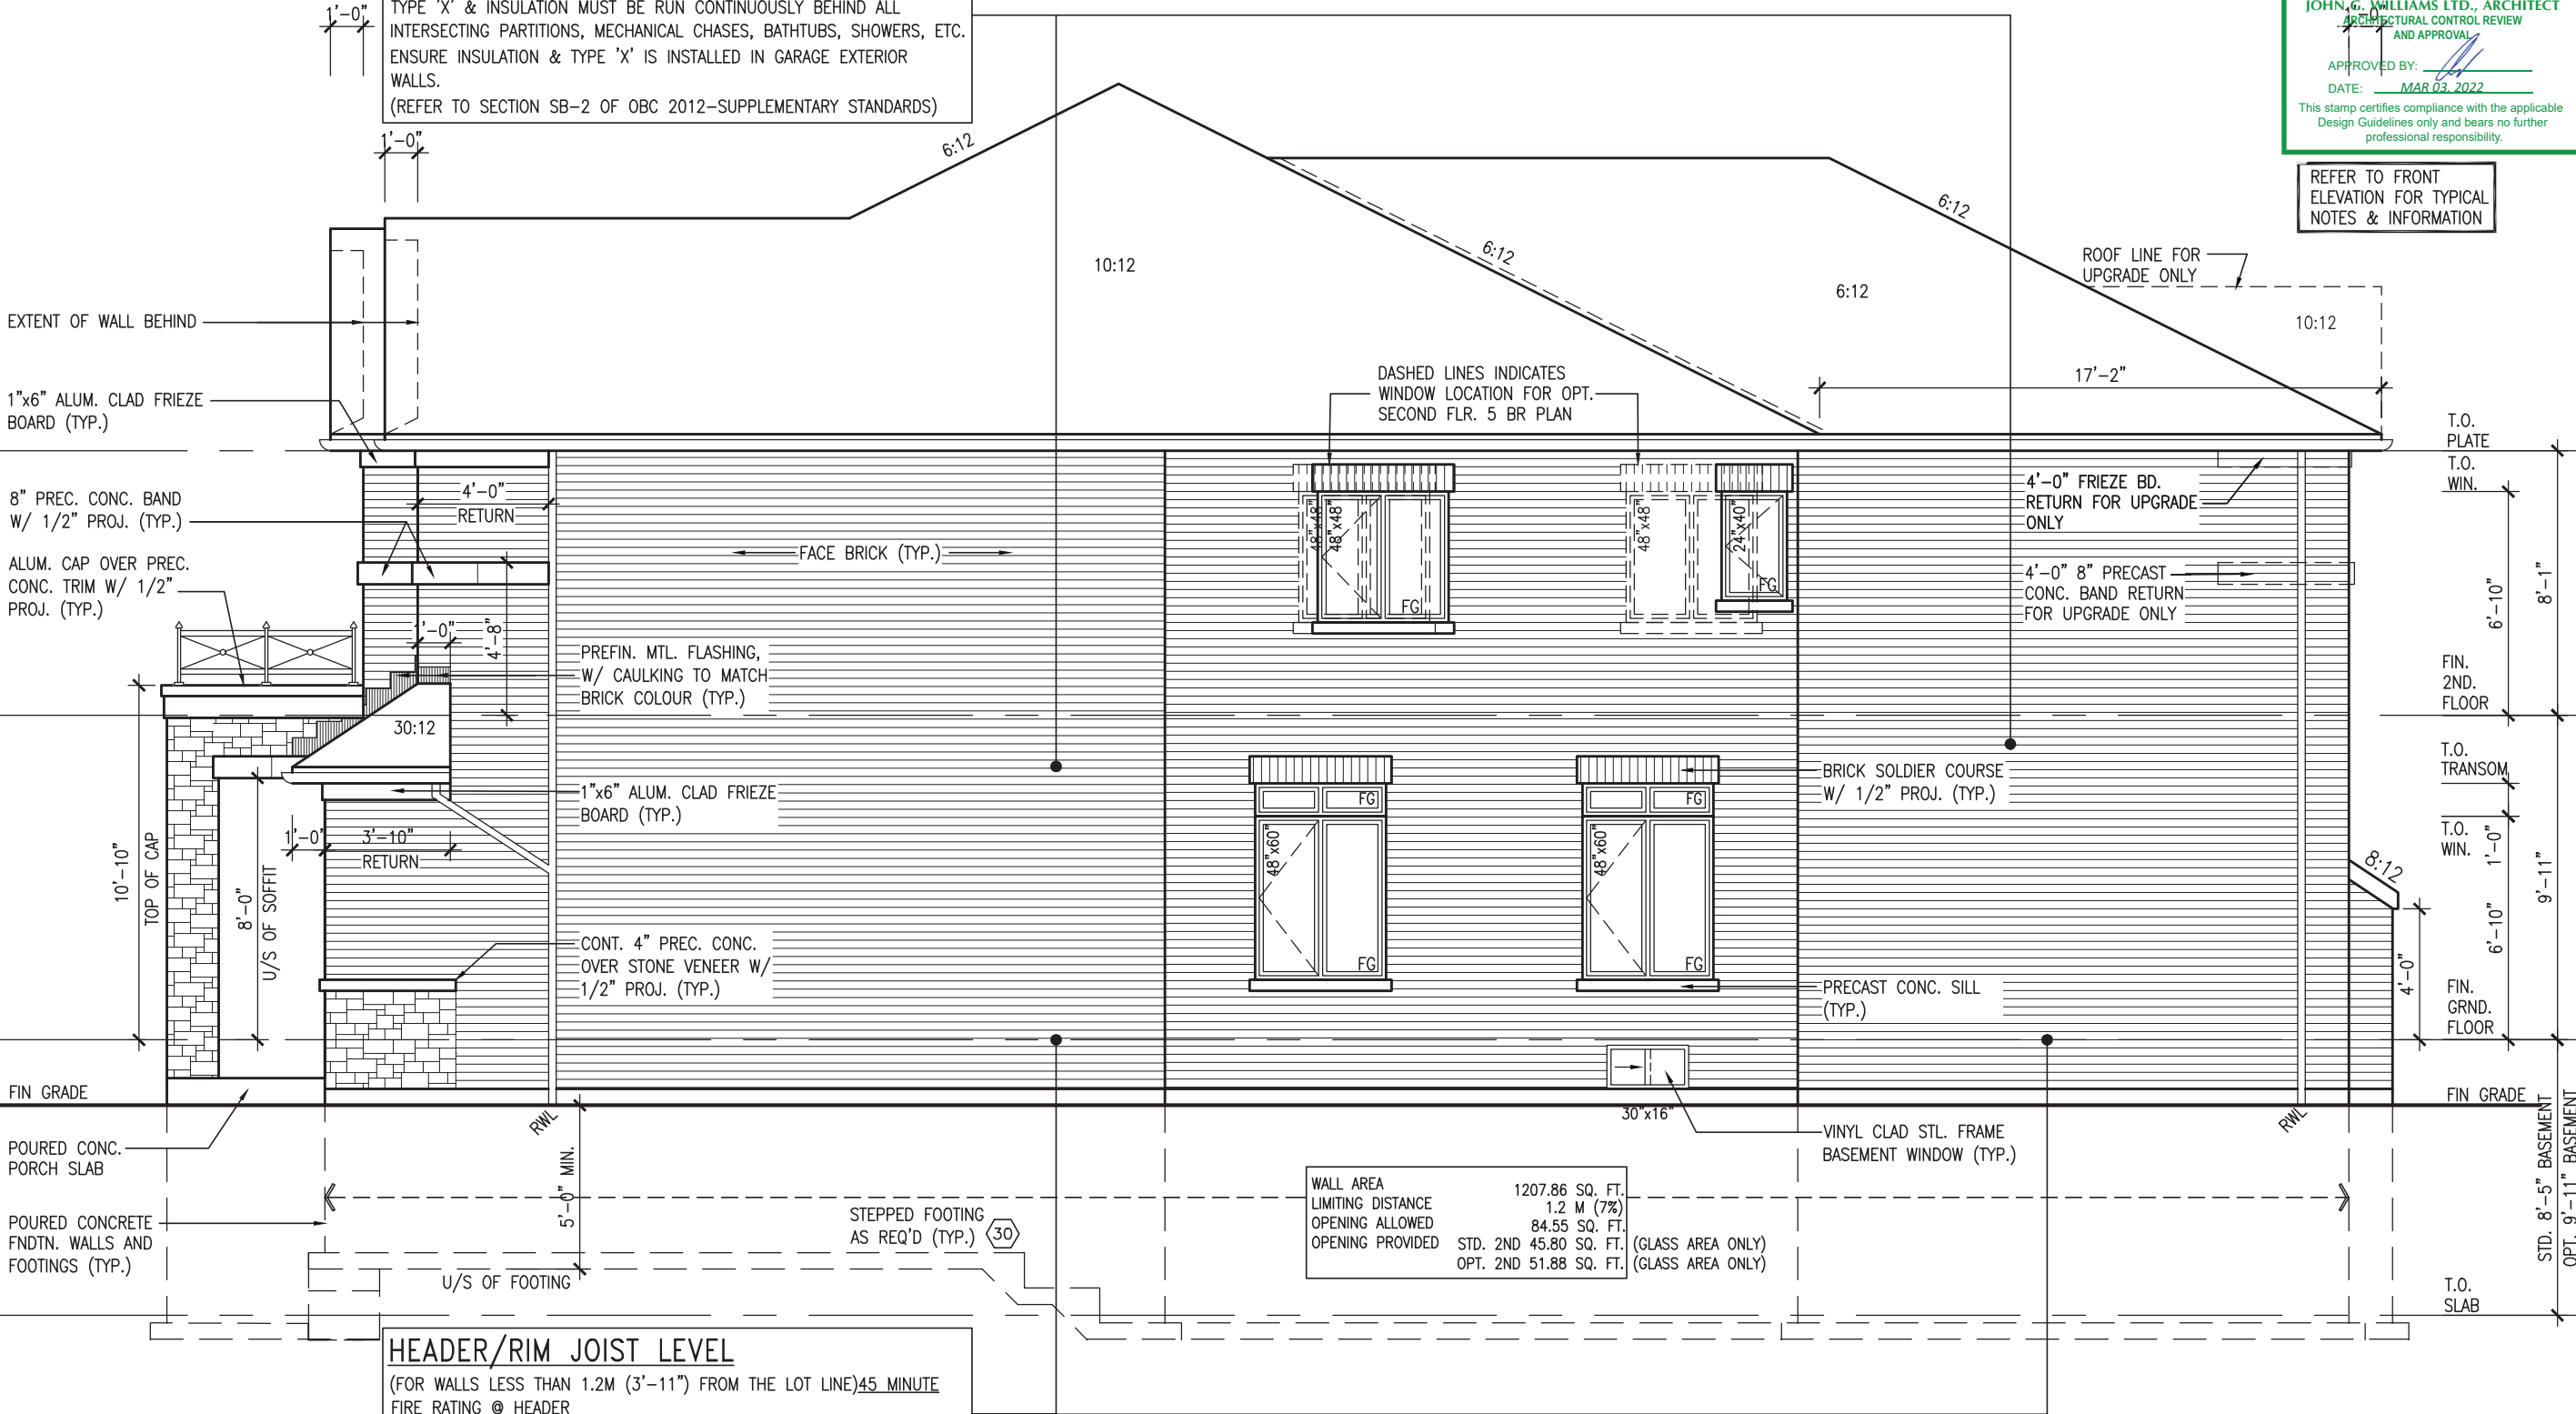
This is to certify that these plans comply with the applicable Architectural Design Guidelines approved by the Town of BRADFORD / WEST GWILLIMBURY.

JOHN G. WILLIAMS LTD., ARCHITECT
ARCHITECTURAL CONTROL REVIEW
AND APPROVAL

APPROVED BY: [Signature]
DATE: MAR 03, 2022


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REFER TO FRONT
ELEVATION FOR TYPICAL
NOTES & INFORMATION





RIGHT SIDE ELEVATION 'B'

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|--------------|--|----------------------|--|--------------------------|--|---------------|--|
| project no. | | 16023 | | drawing no. | | 14 | |
| project name | | GREEN VALLEY ESTATES | | BRADFORD EAST, ON. | | file name | |
| municipality | | BAYVIEW WELLINGTON | | RIGHT SIDE ELEVATION 'B' | | 16023-S38-20 | |
| date | | SEPT. 2021 | | checked by | | JWM | |
| drawn by | | NC | | scale | | 3/16" = 1'-0" | |
| drawn by | | JWM | | checked by | | JWM | |
| drawn by | | JWM | | checked by | | JWM | |
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ROOF PLAN 'C'

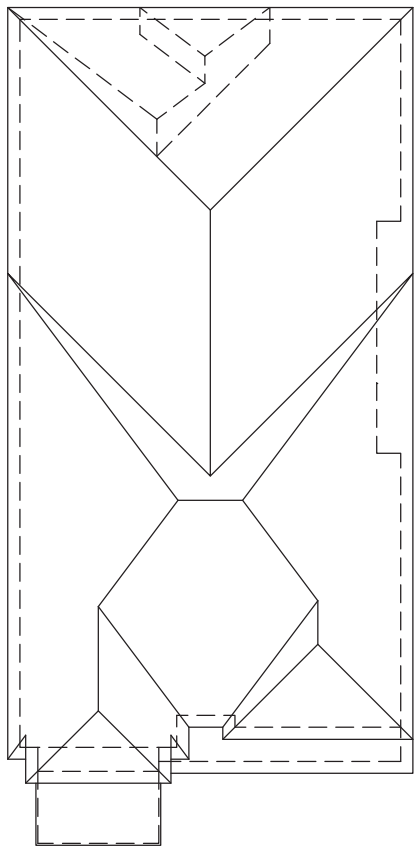

FRONT ELEVATION 'C'

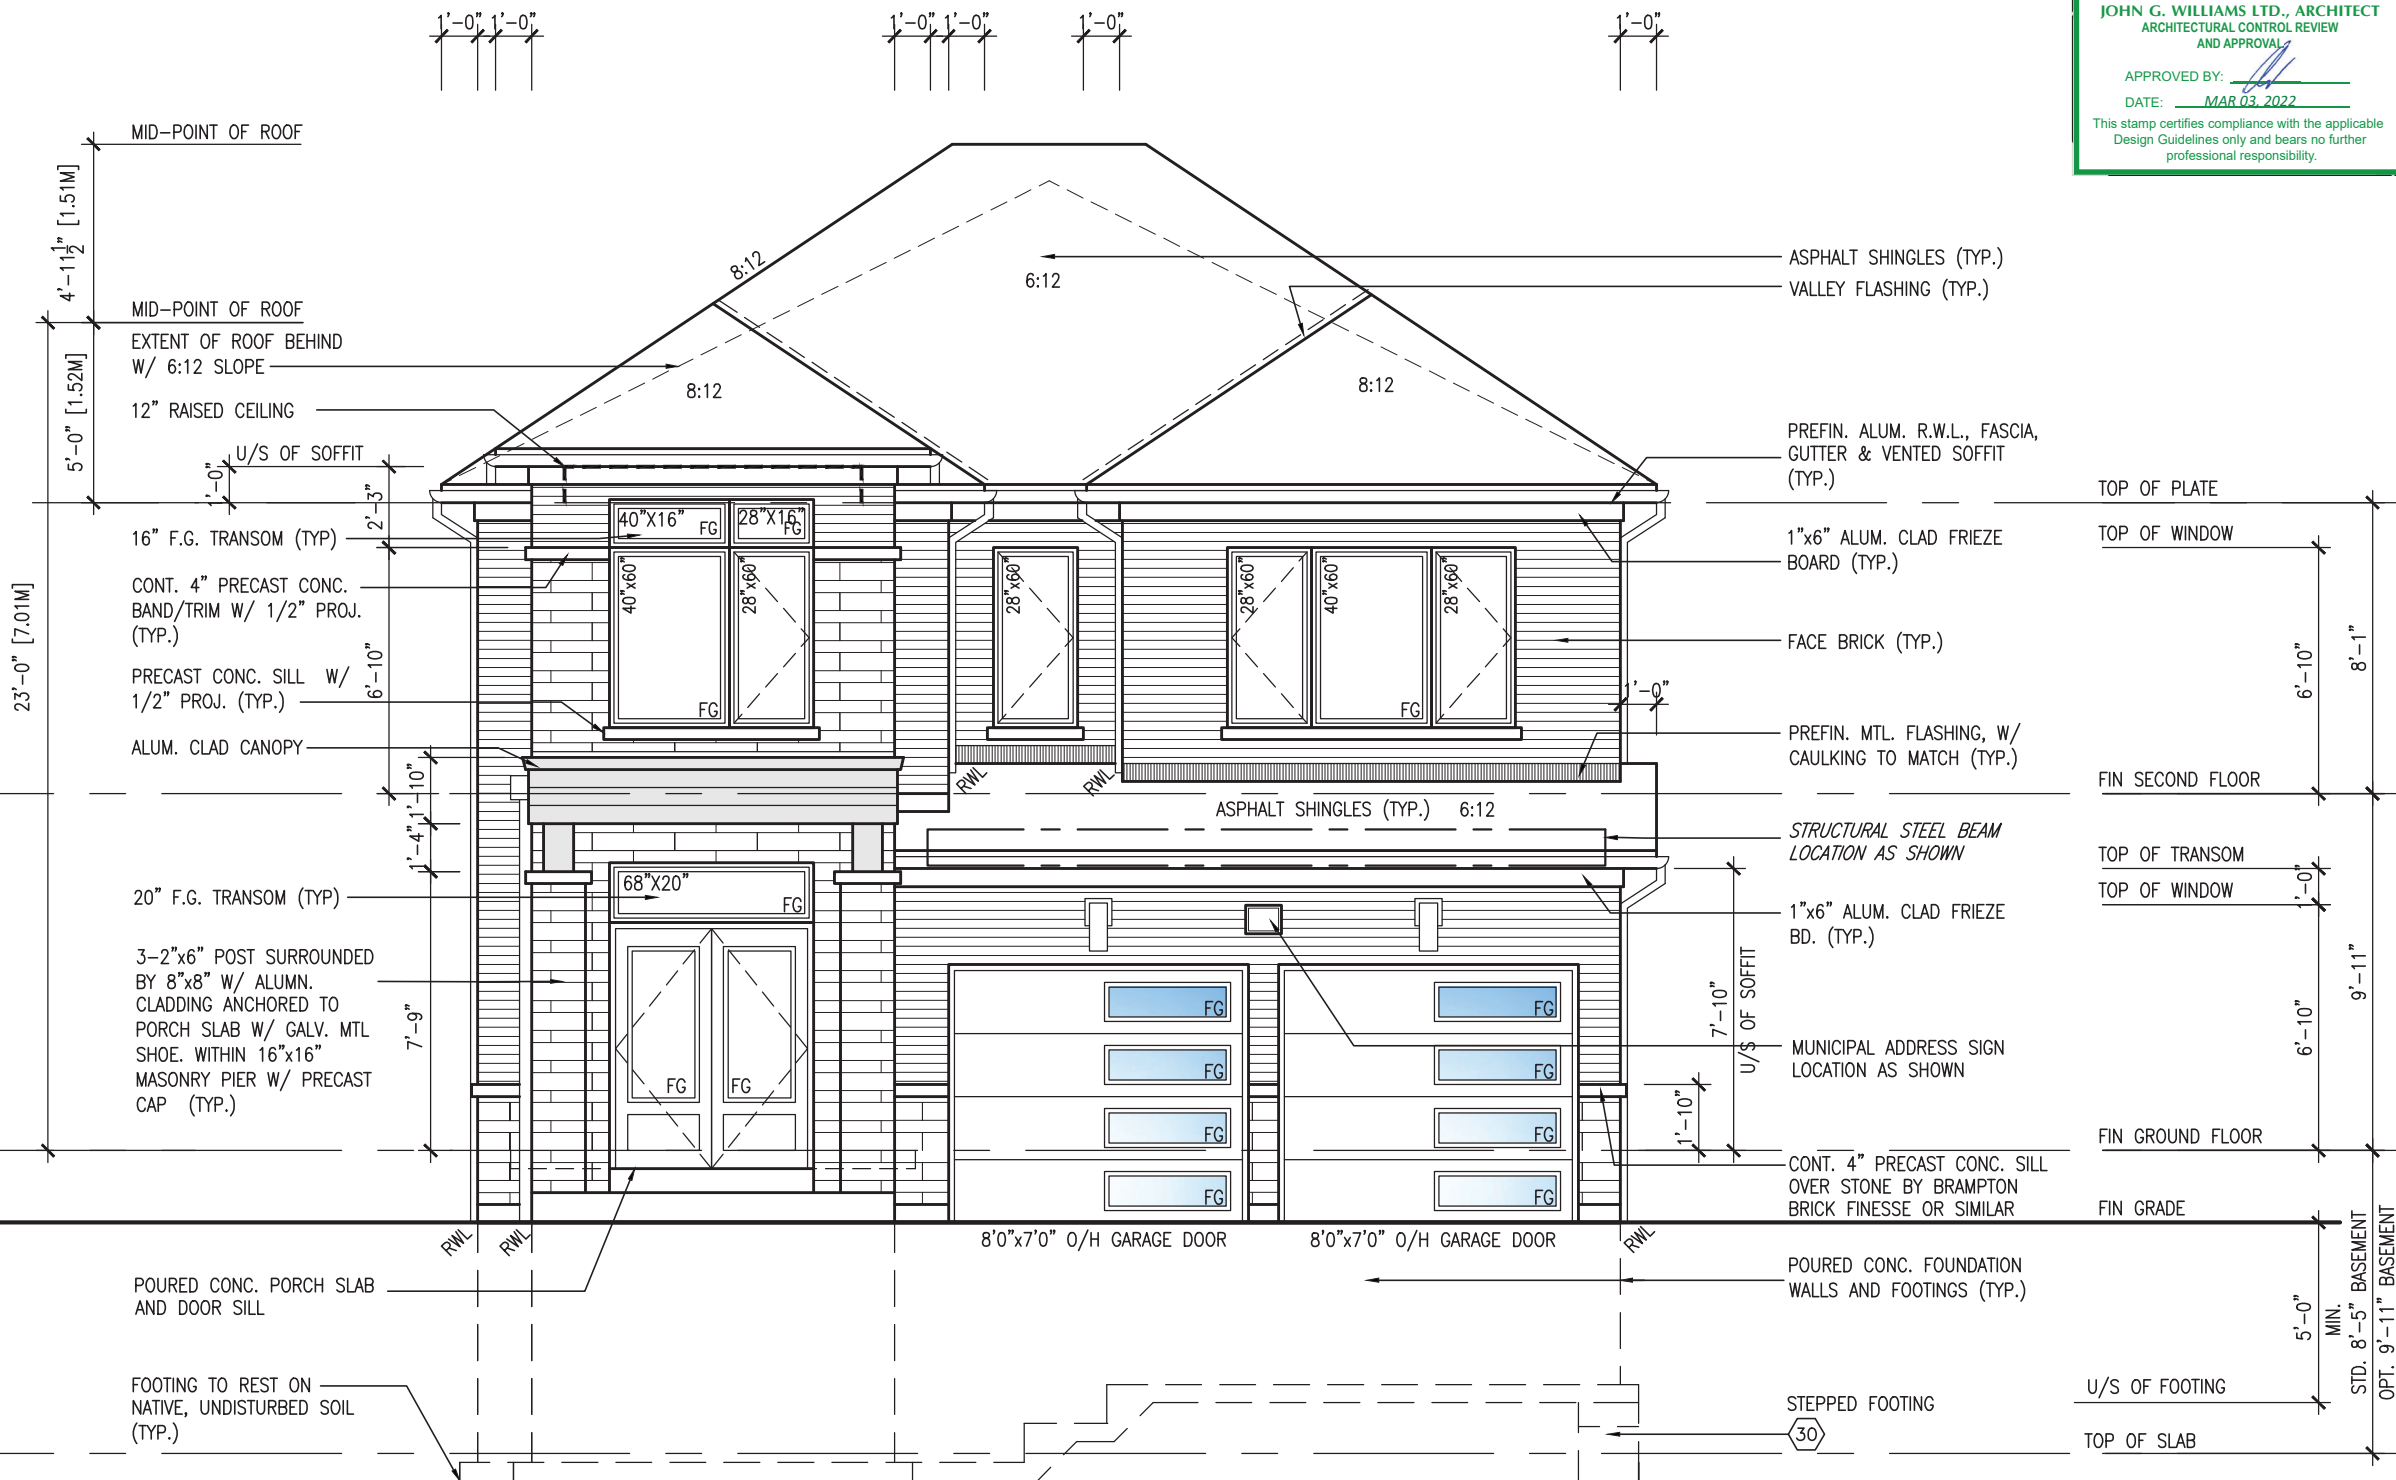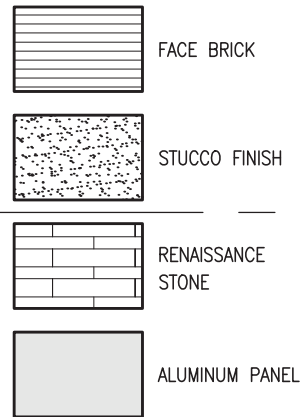

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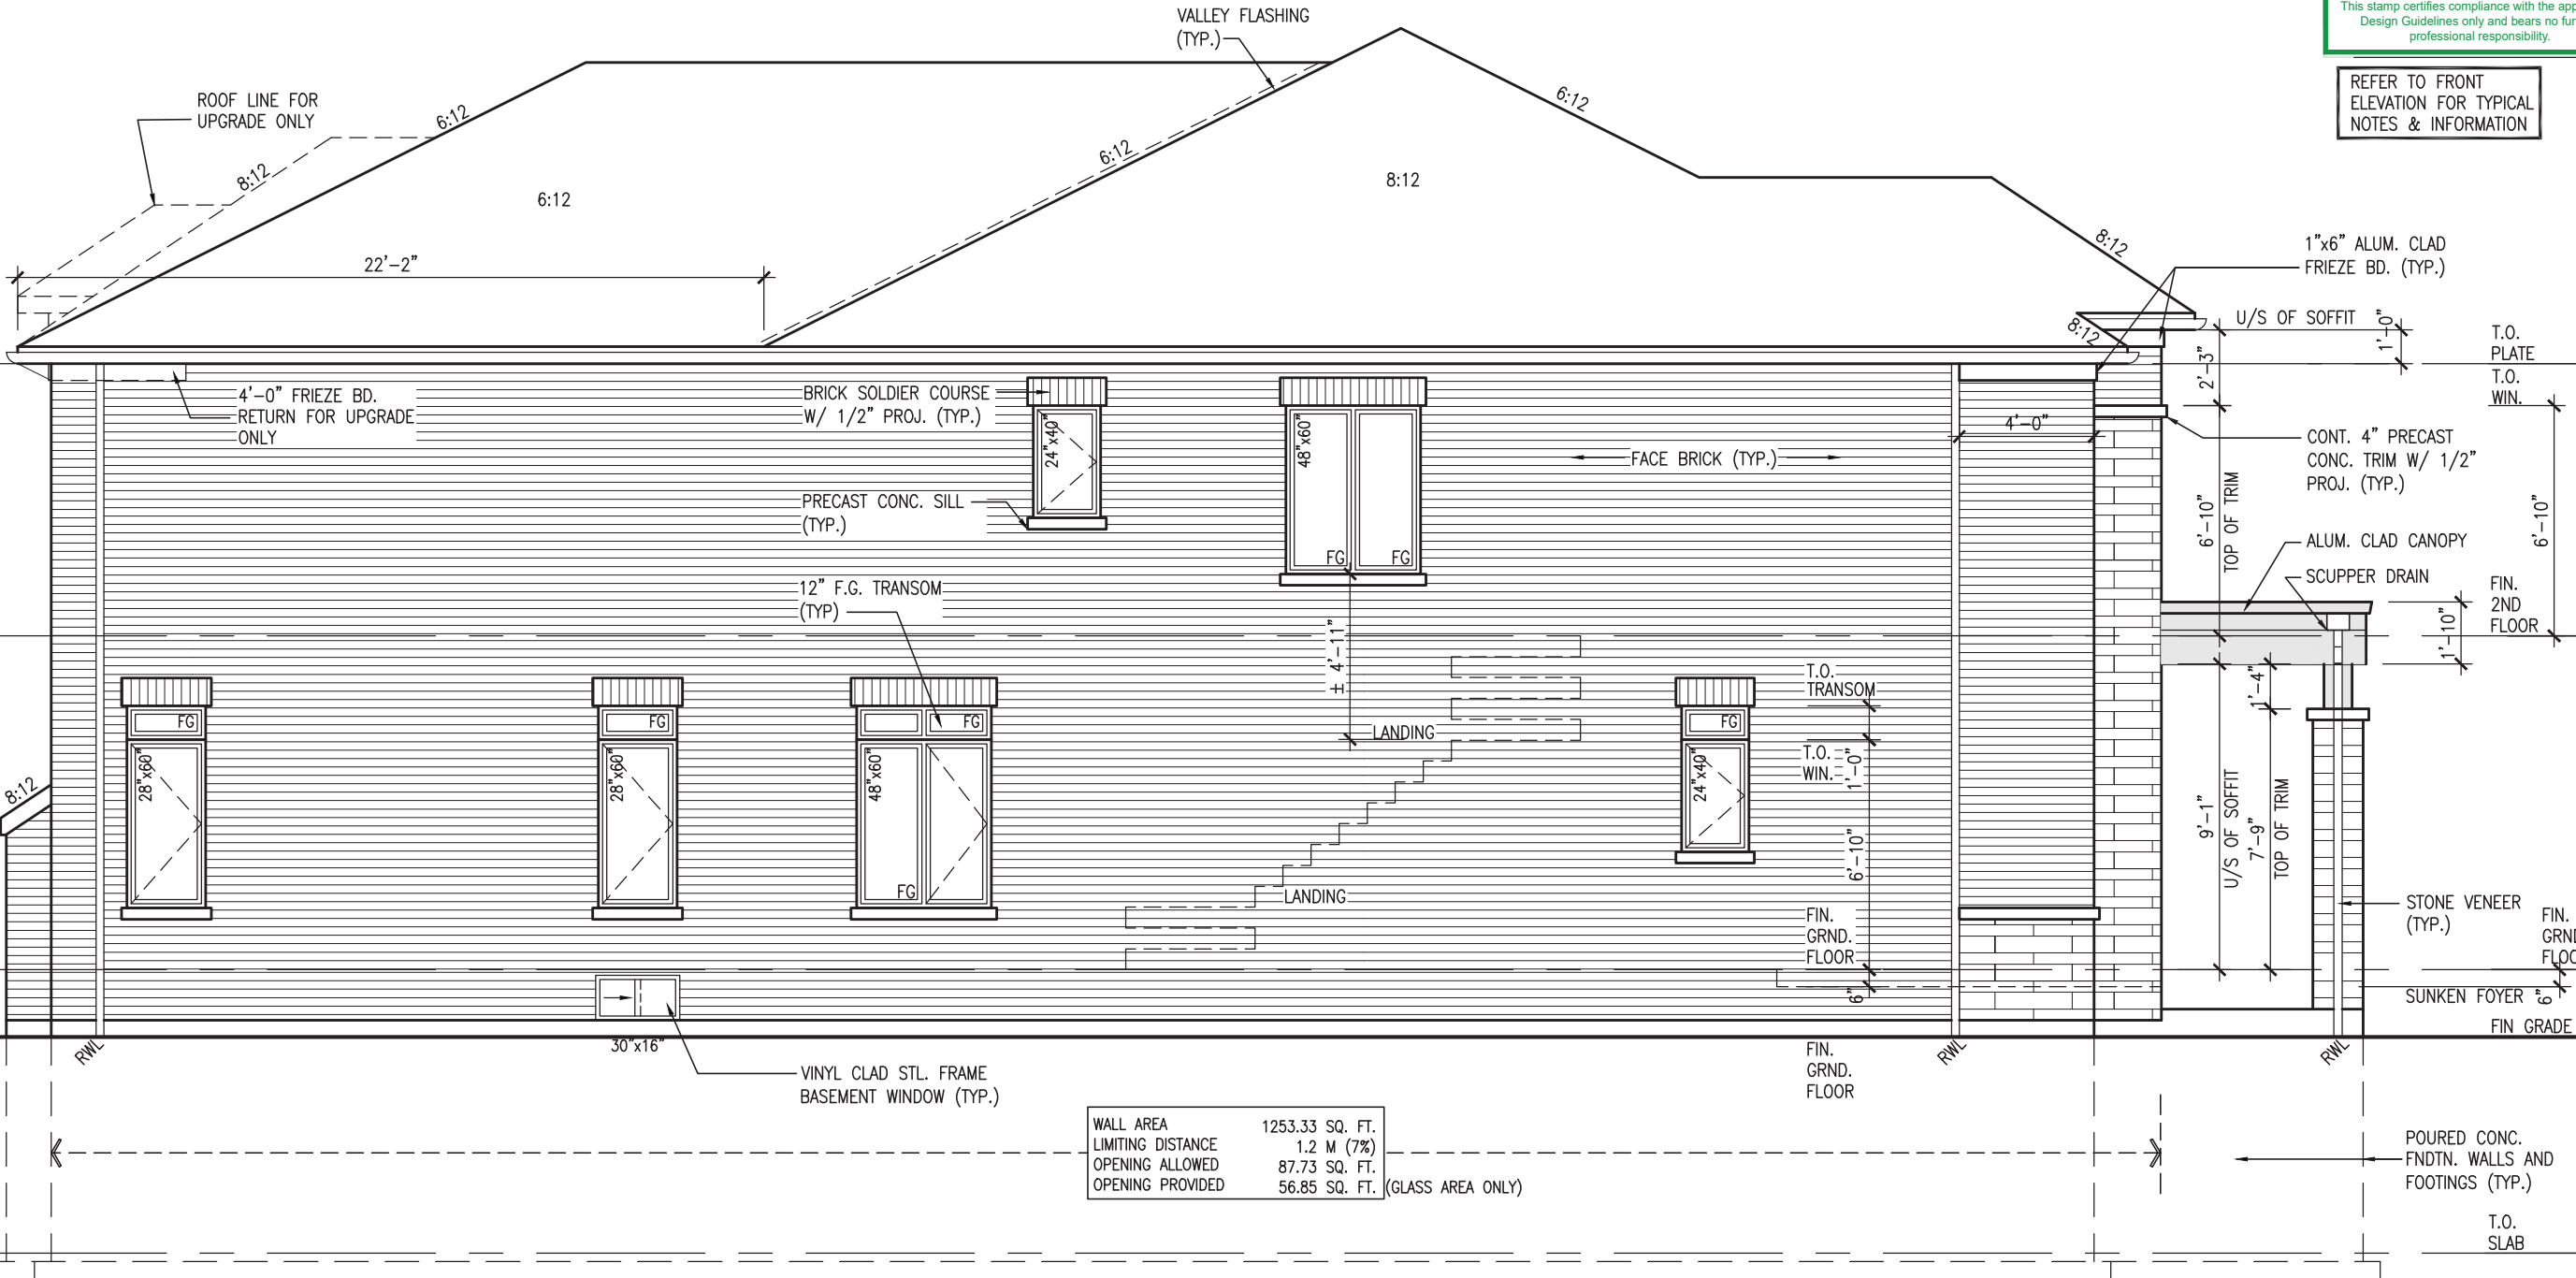
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| 9 . | | . | | . | | The undersigned has reviewed and takes responsibility for this design and has the qualifications and meets the requirements set out in the Ontario Building Code to be a Designer. | | 25591 | | VA3 DESIGN | | project no. 16023 | |
| 8 . | | . | | . | | | | | | 255 | | drawing no. 15 | |
| 7 . | | . | | . | | qualification information | | | | VA3 | | | |
| 6 . | | . | | . | | | | | | DESIGN | | | |
| 5 . | | . | | . | | Wellington, Ino-Baptiste | | signature | | 25591 | | project name GREEN VALLEY ESTATES | |
| 4 . | | . | | . | | name | | BCIN | | 42658 | | municipality BRADFORD EAST, ON. | |
| 3 | | REVISED AS PER ENG COMMENTS | | MAR 01--22 RC | | registration information | | VA3 Design Inc. | | 42658 | | date SEPT. 2021 | |
| 2 | | REVISED AS PER FLOOR / ROOF LAYOUTS | | FEB 24--22 RC | | signature | | [Signature] | | 42658 | | checked by JWM | |
| 1 | | ISSUED FOR CLIENT REVIEW | | NOV 23--21 VA3 | | Contractor must verify all dimensions on the job and report any discrepancy to the Designer before proceeding with the work. All drawings and specifications are instruments of service and the property of the Designer. Drawings are not to be scaled. | | | | | | scale 3/16" = 1'-0" | |
| no. | | description | | date | | by | | | | | | FRONT ELEVATION 'C' | |
| | | | | | | | | | | | | file name 16023-S38-20 | |
| | | | | | | | | | | | | drawn by NC | |
| | | | | | | | | | | | | checked by JWM | |
| | | | | | | | | | | | | date Mar 1, 2022 | |
| | | | | | | | | | | | | drawn by RICHARD - H:\ARCHIVE\WORKING\2016\16023.BW\Units\38\16023-S38-20.dwg | |
| | | | | | | | | | | | | date Tue - Mar 1, 2022 | |
| | | | | | | | | | | | | time 2:39 PM | |

1'-0"



MAR 1, 2022

1'-0" 1'-0"



LEFT SIDE ELEVATION 'C'

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JOHN G. WILLIAMS LTD., ARCHITECT
ARCHITECTURAL CONTROL REVIEW
AND APPROVAL
APPROVED BY: [Signature]
DATE: MAR 03, 2022
This stamp certifies compliance with the applicable Design Guidelines only and bears no further professional responsibility.

REFER TO FRONT
ELEVATION FOR TYPICAL
NOTES & INFORMATION

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| The undersigned has reviewed and takes responsibility for this design and has the qualifications and meets the requirements set out in the Ontario Building Code to be a Designer. | | qualification information | | Wellington Jno-Baptiste 25591 | | BCIN | |
| name | | registration information | | signatory | | 42658 | |
| VA3 Design Inc. | | name | | BCIN | | 42658 | |
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| VA3 Design Inc. | | name | | BCIN | | 42658 | |
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BRICK VENEER CONSTRUCTION

(FOR WALLS LESS THAN 1.2M (3'-11") FROM THE LOT LINE)
45 MINUTE FIRE RATED WALL
PROVIDE A CONTINUOUS LAYER OF 12.7mm (1/2") TYPE 'X' GYPSUM BOARD (INTERIOR SIDE) INSTALLED SO THAT ALL EDGES ARE SUPPORTED, TAPED AND FILLED. SPACE BETWEEN WOOD STUDS TO BE FILLED WITH INSULATION CONFORMING TO CAN/ULC-S702, "MINERAL FIBRE THERMAL INSULATION FOR BUILDINGS" WITH A MASS OF NOT LESS THAN 1.22 Kg/SQ.M. AND MUST FILL AT LEAST 90% OF THE CAVITY THICKNESS. THE TYPE 'X' & INSULATION MUST BE RUN CONTINUOUSLY BEHIND ALL INTERSECTING PARTITIONS, MECHANICAL CHASES, BATHTUBS, SHOWERS, ETC. ENSURE INSULATION & TYPE 'X' IS INSTALLED IN GARAGE EXTERIOR WALLS.
(REFER TO SECTION SB-2 OF OBC 2012-SUPPLEMENTARY STANDARDS)




It is the builder's complete responsibility to ensure that all plans submitted for approval fully comply with the Architectural Guidelines and all applicable regulations and requirements including zoning provisions and any provisions in the subdivision agreement. The Control Architect is not responsible in any way for examining or approving site (lotting) plans or working drawings with respect to any zoning or building code or permit matter or that any house can be properly built or located on its lot.

This is to certify that these plans comply with the applicable Architectural Design Guidelines approved by the Town of BRADFORD / WEST GWILLIMBURY.



REFER TO FRONT ELEVATION FOR TYPICAL NOTES & INFORMATION

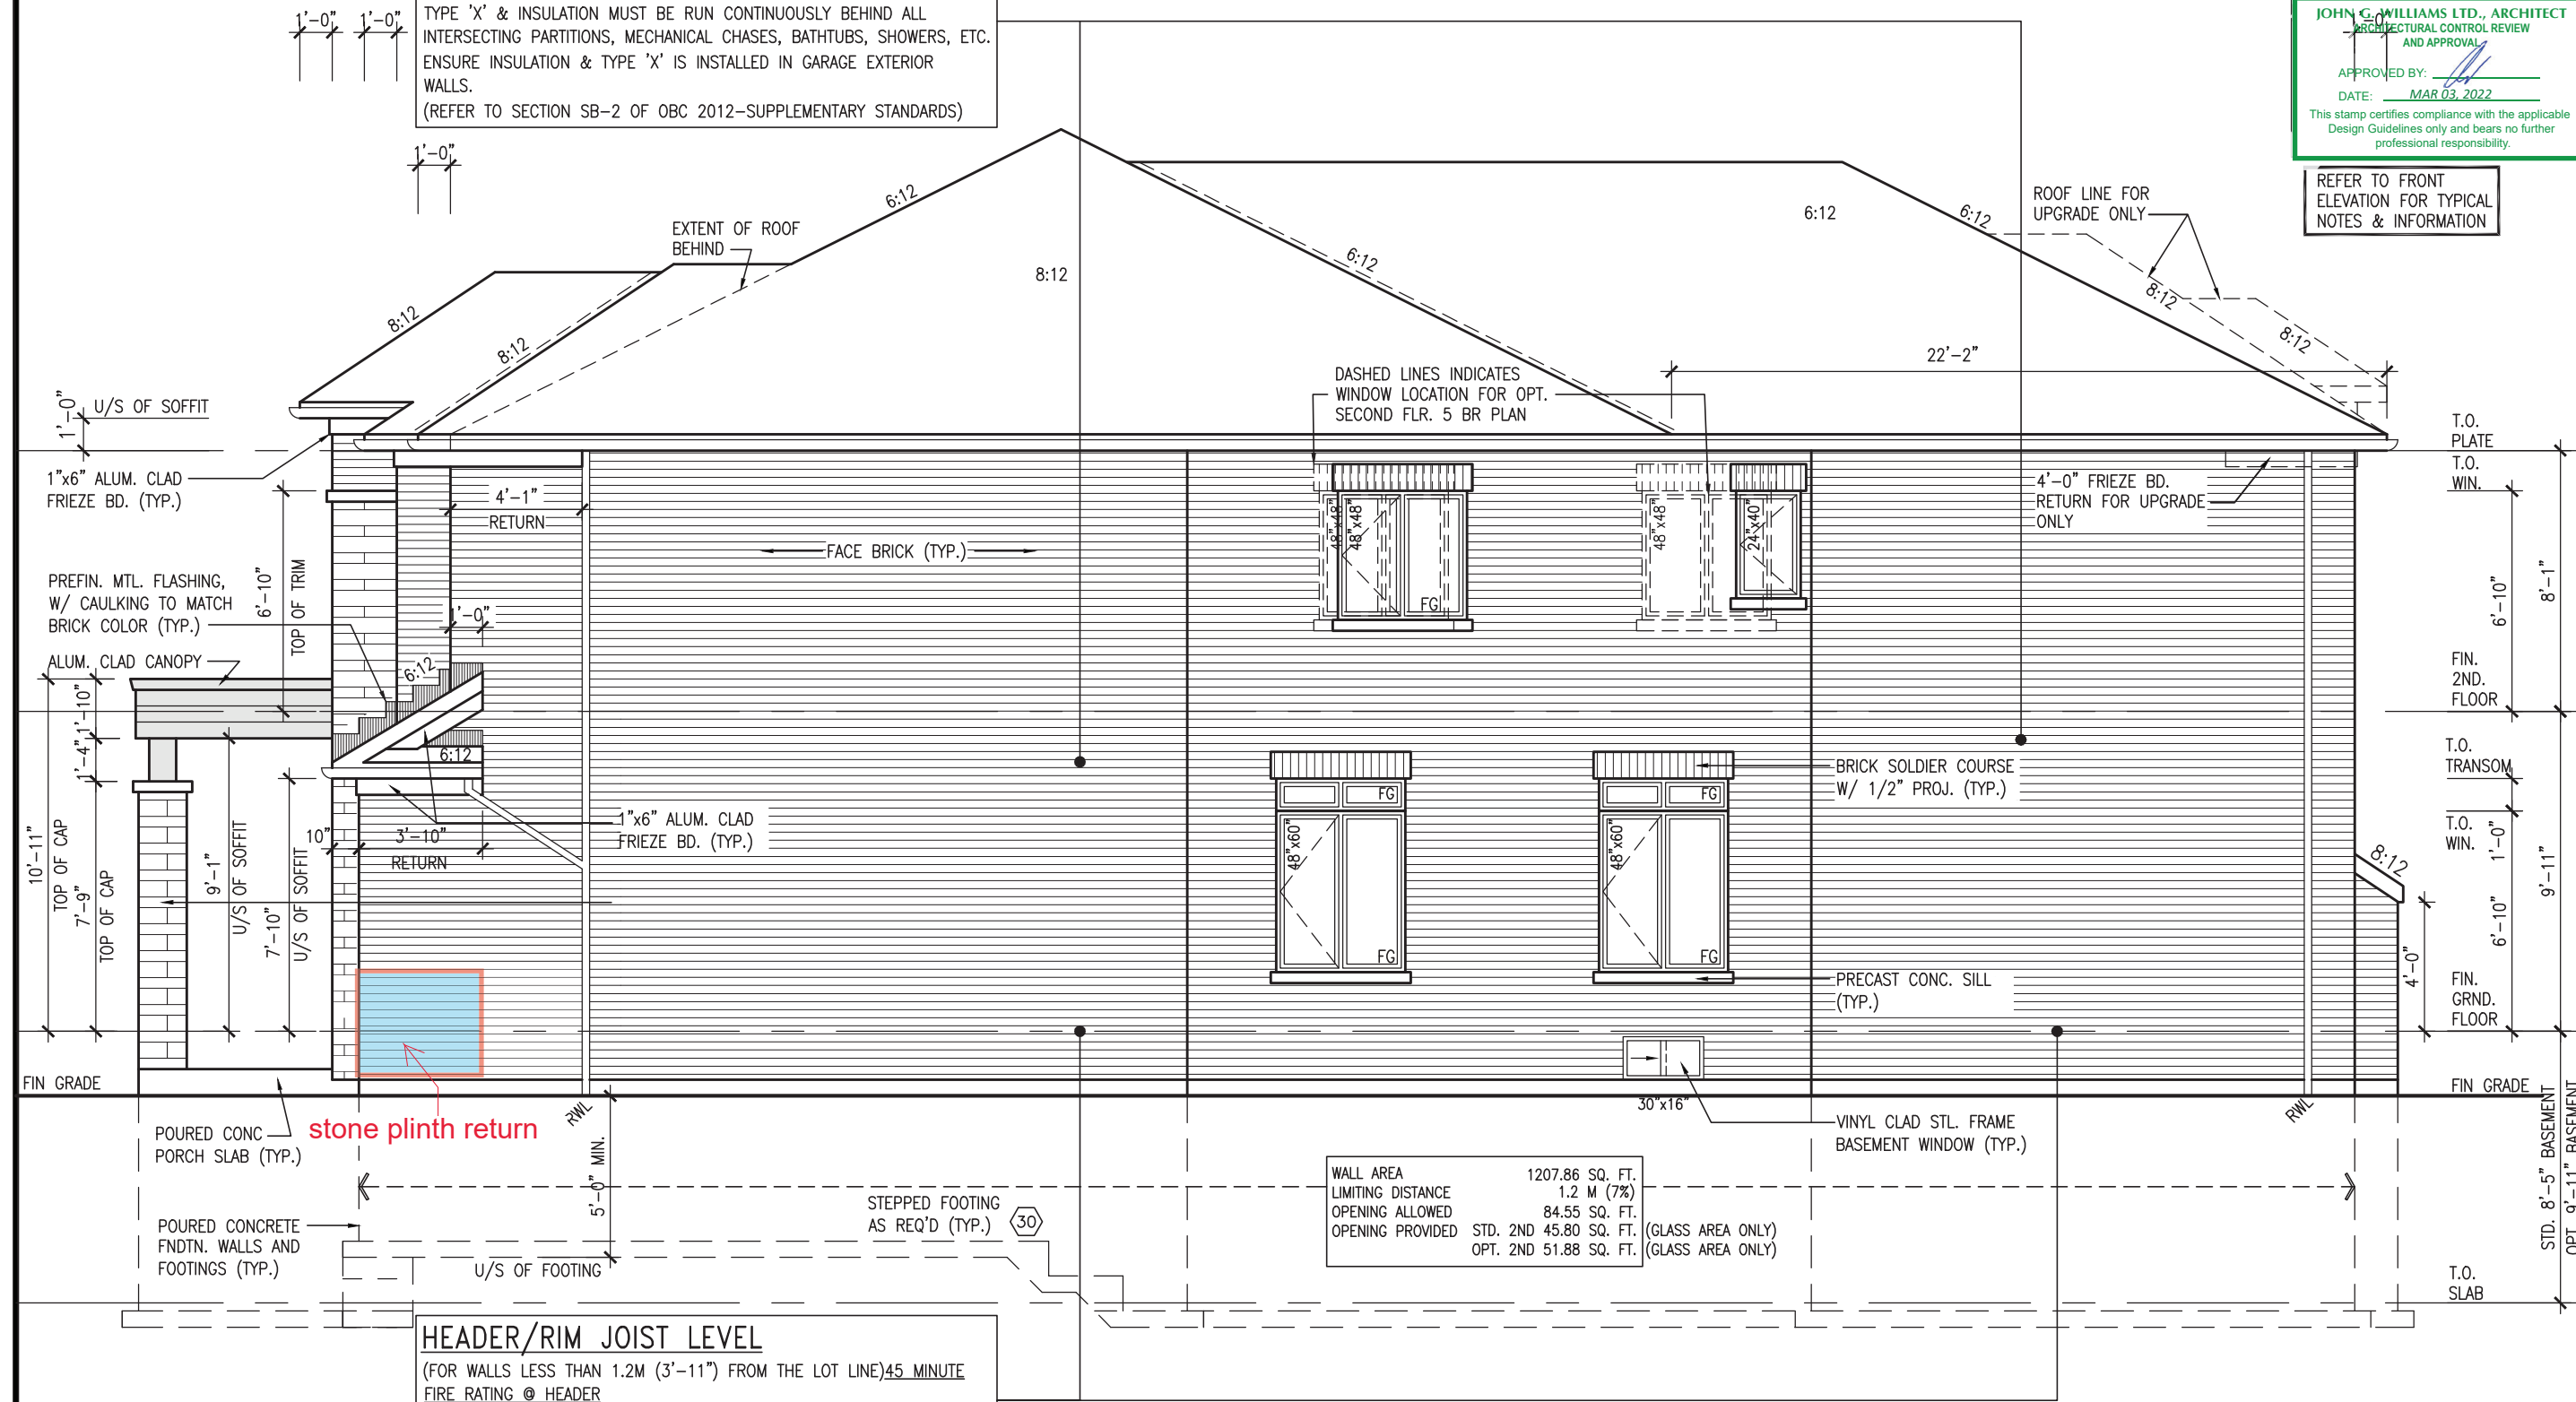

RIGHT SIDE ELEVATION 'C'


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REFER TO FRONT ELEVATION FOR TYPICAL NOTES & INFORMATION



LONGITUDINAL SECTION A-A

| | | | | | |
|--|--|-------------------------------------|--|-----------------|--|
| The undersigned has reviewed and takes responsibility for this design and has the qualifications and meets the requirements set out in the Ontario Building Code to be a Designer. | | Wellington Jno-Baptiste | | 25591 | |
| qualification information | | signature | | BCIN | |
| name | | registration information | | VA3 Design Inc. | |
| 4. | | 5. | | 42558 | |
| 3 | | REVISD AS PER ENG COMMENTS | | MAR 01-22 RC | |
| 2 | | REVISED AS PER FLOOR / ROOF LAYOUTS | | FEB 24-22 RC | |
| 1 | | ISSUED FOR CLIENT REVIEW | | NOV 23-21 VA3 | |
| no. description | | date | | by | |

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| S38-20 | | BAYVIEW WELLINGTON | | project no. | |
| GREEN VALLEY ESTATES | | BRADFORD EAST, ON. | | 16023 | |
| date | | project name | | drawing no. | |
| SEPT. 2021 | | LONGITUDINAL SECTION A-A | | 18 | |
| drawn by | | checked by | | file name | |
| NC | | JWM | | 16023-S38-20 | |
| scale | | 3/16" = 1'-0" | | RICHARD - H:\ARCHIVE\WORKING\2016\16023.BWA\Units\38\16023-S38-20.dwg - Tue - Mar 1 2022 - 2:39 PM | |

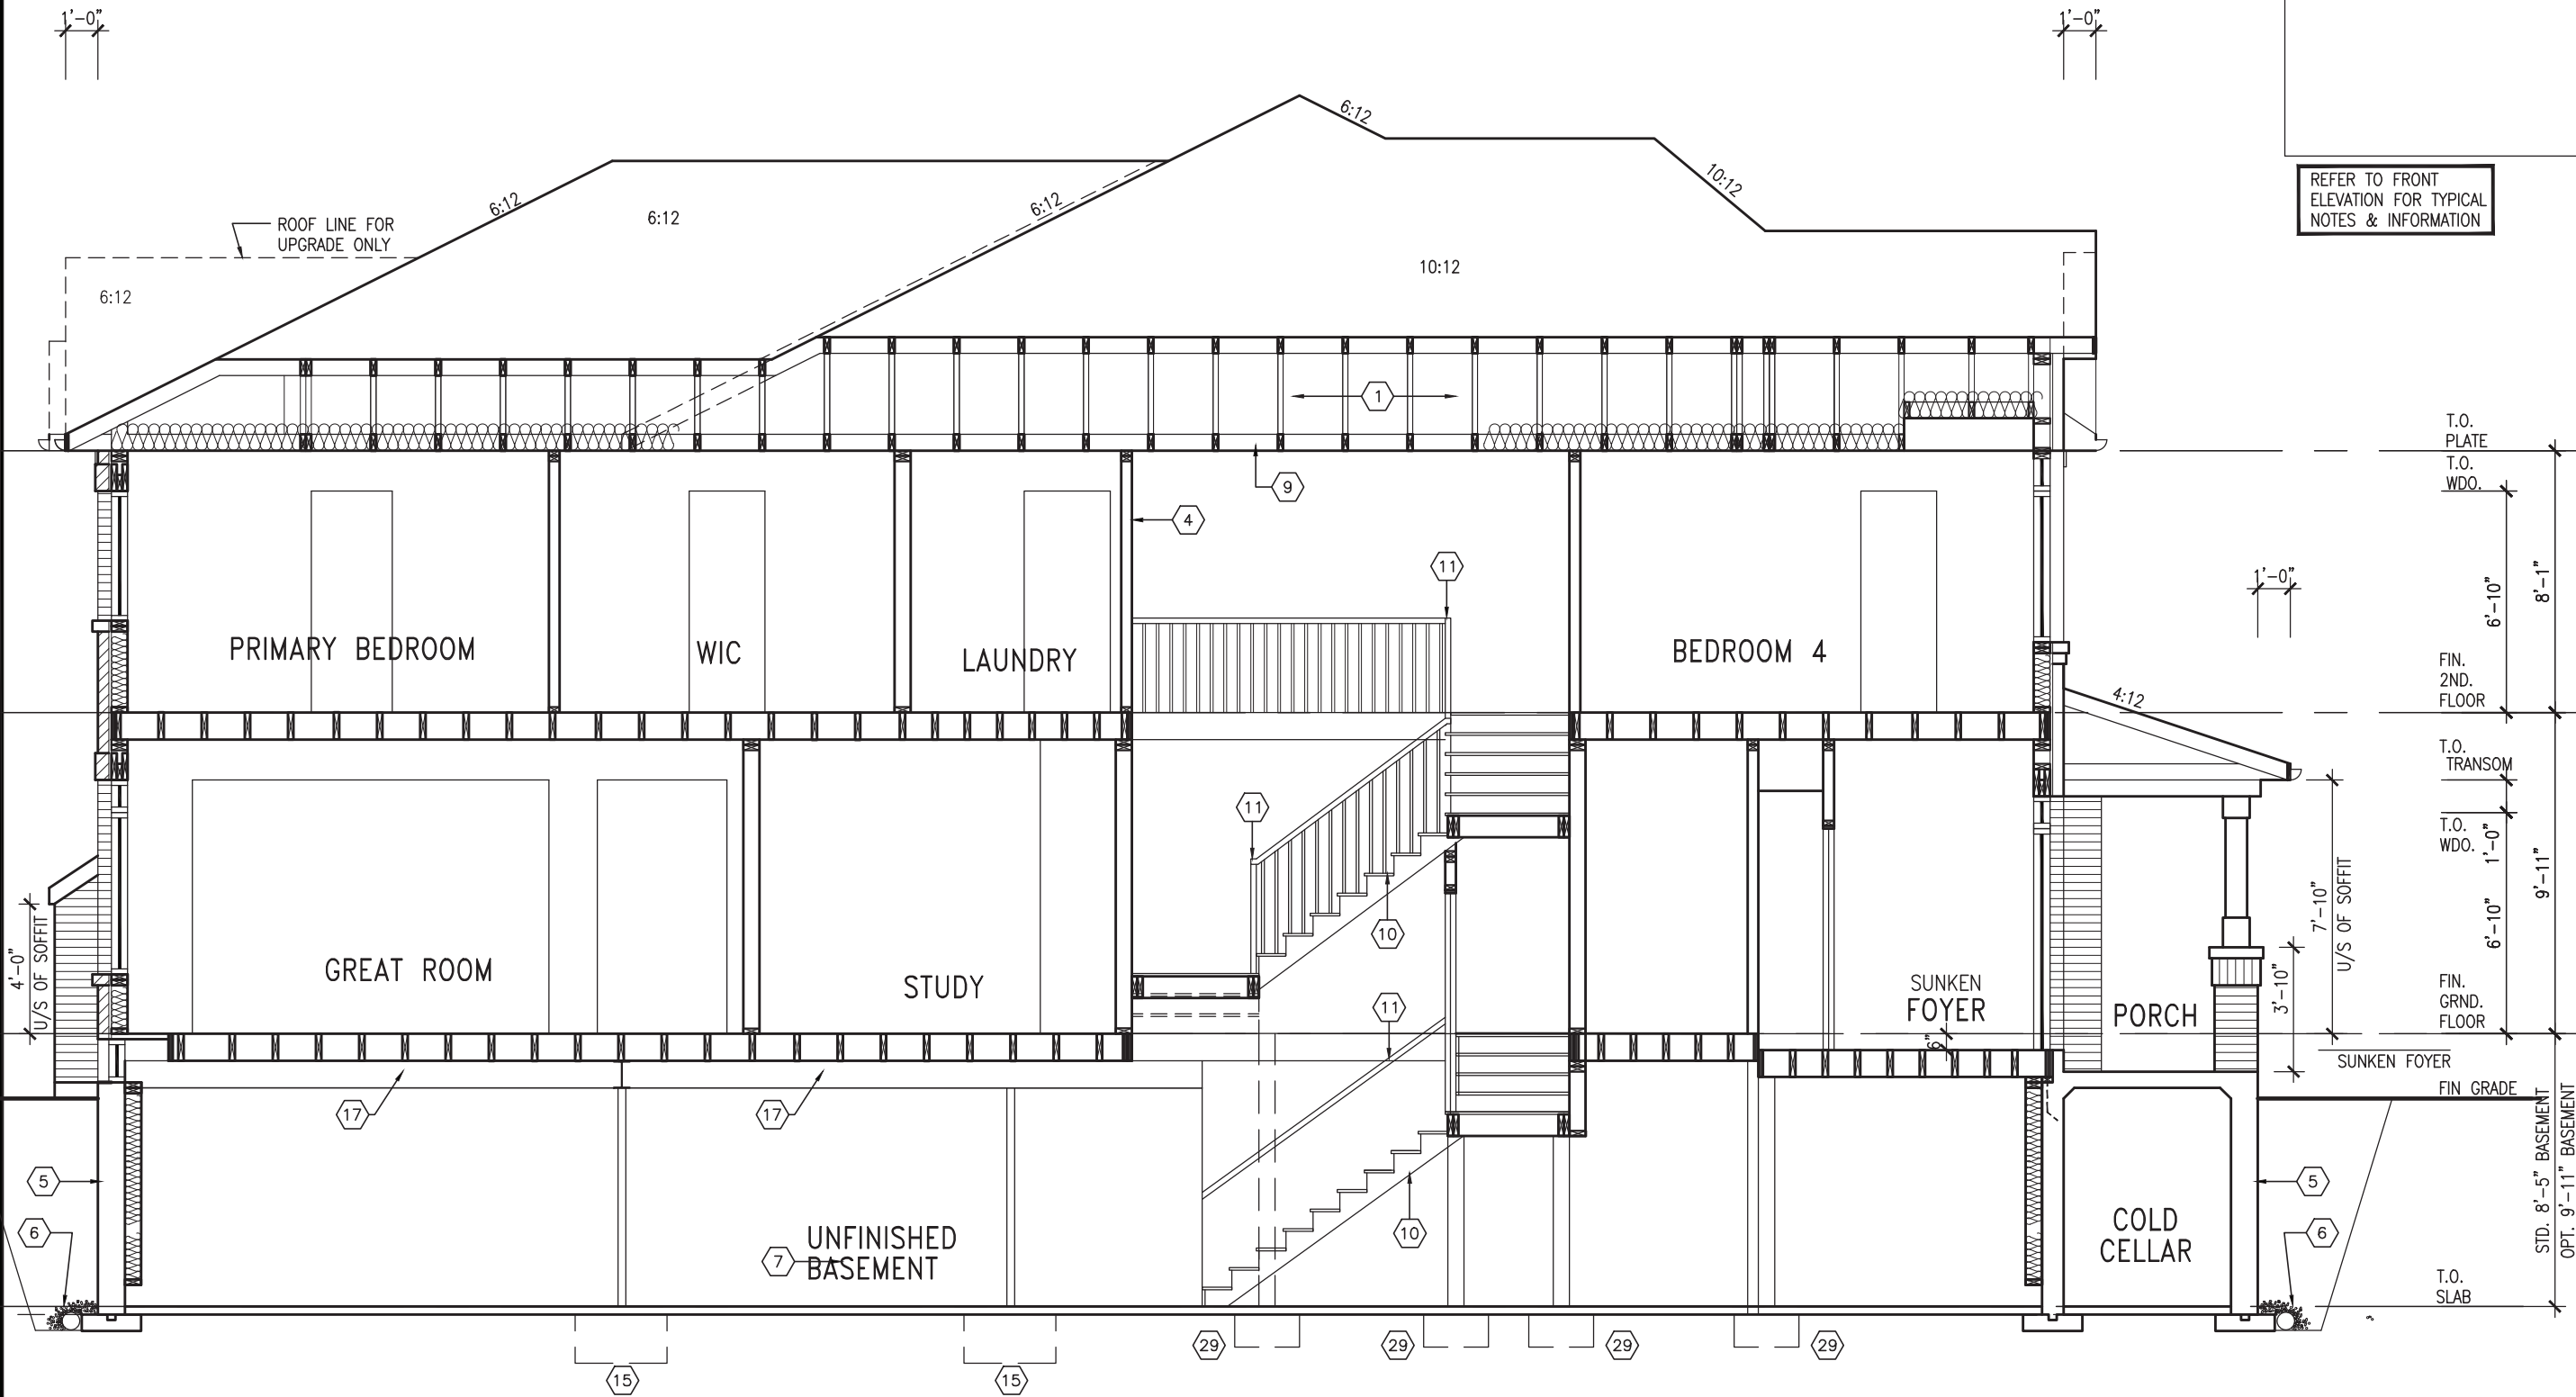VA3

DESIGN

255 Consumers Rd Suite 120
Toronto ON M2J 1R4
t 416.630.2255 f 416.630.4782
va3design.com


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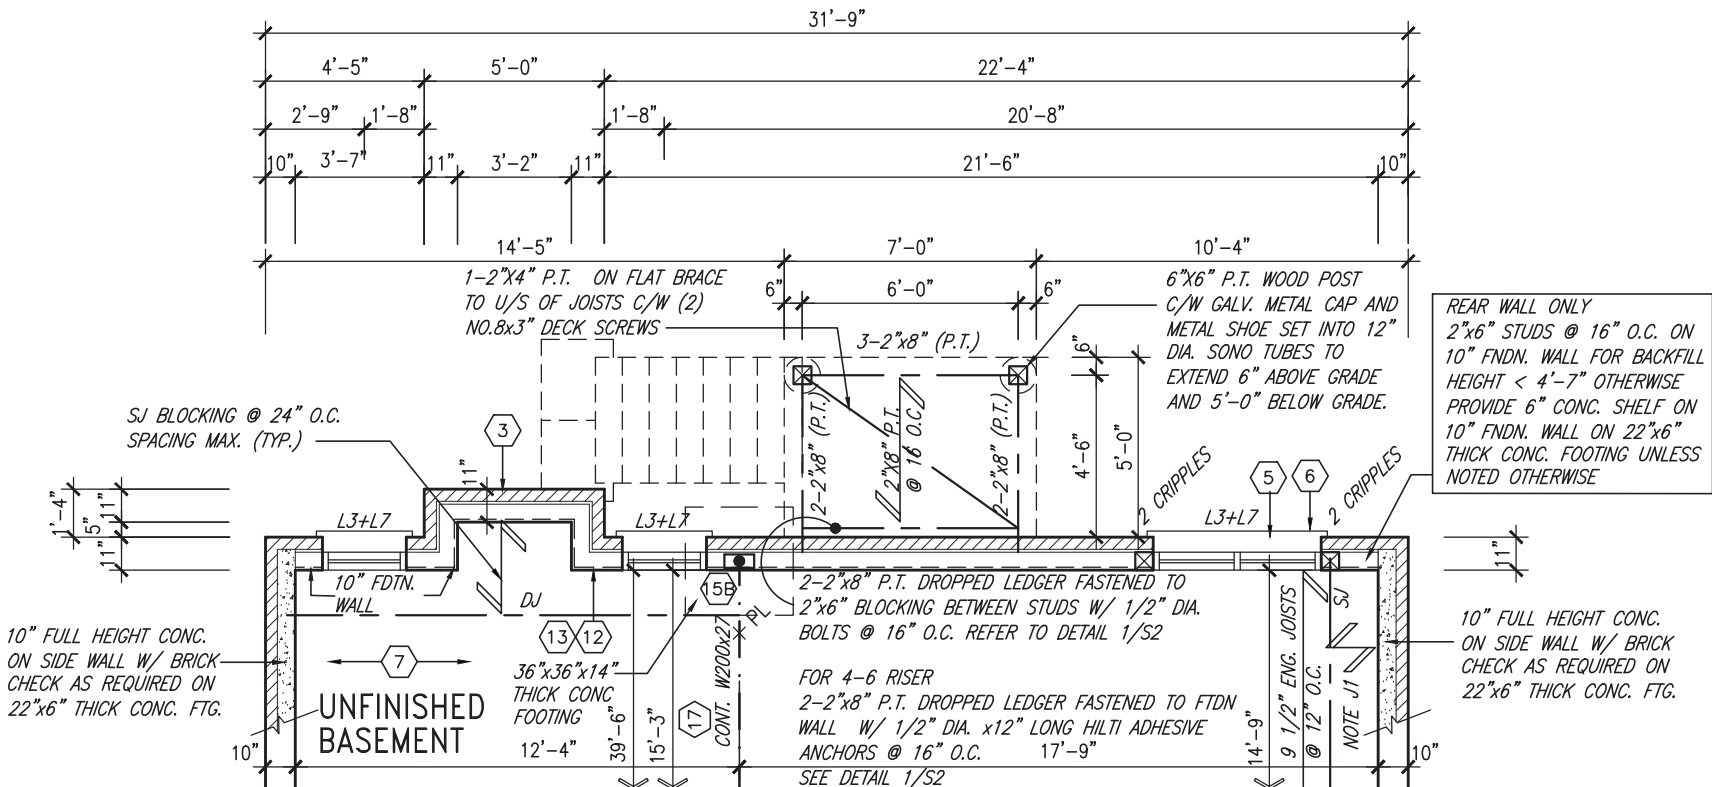
JOHN G. WILLIAMS LTD., ARCHITECT
ARCHITECTURAL CONTROL REVIEW
AND APPROVAL
APPROVED BY: 
DATE: MAR 03, 2022
This stamp certifies compliance with the applicable Design Guidelines only and bears no further professional responsibility.



MAR 1, 2022



PARTIAL BASEMENT PLAN 'A','B' & 'C'
- 9R OR MORE W.O.D. CONDITION

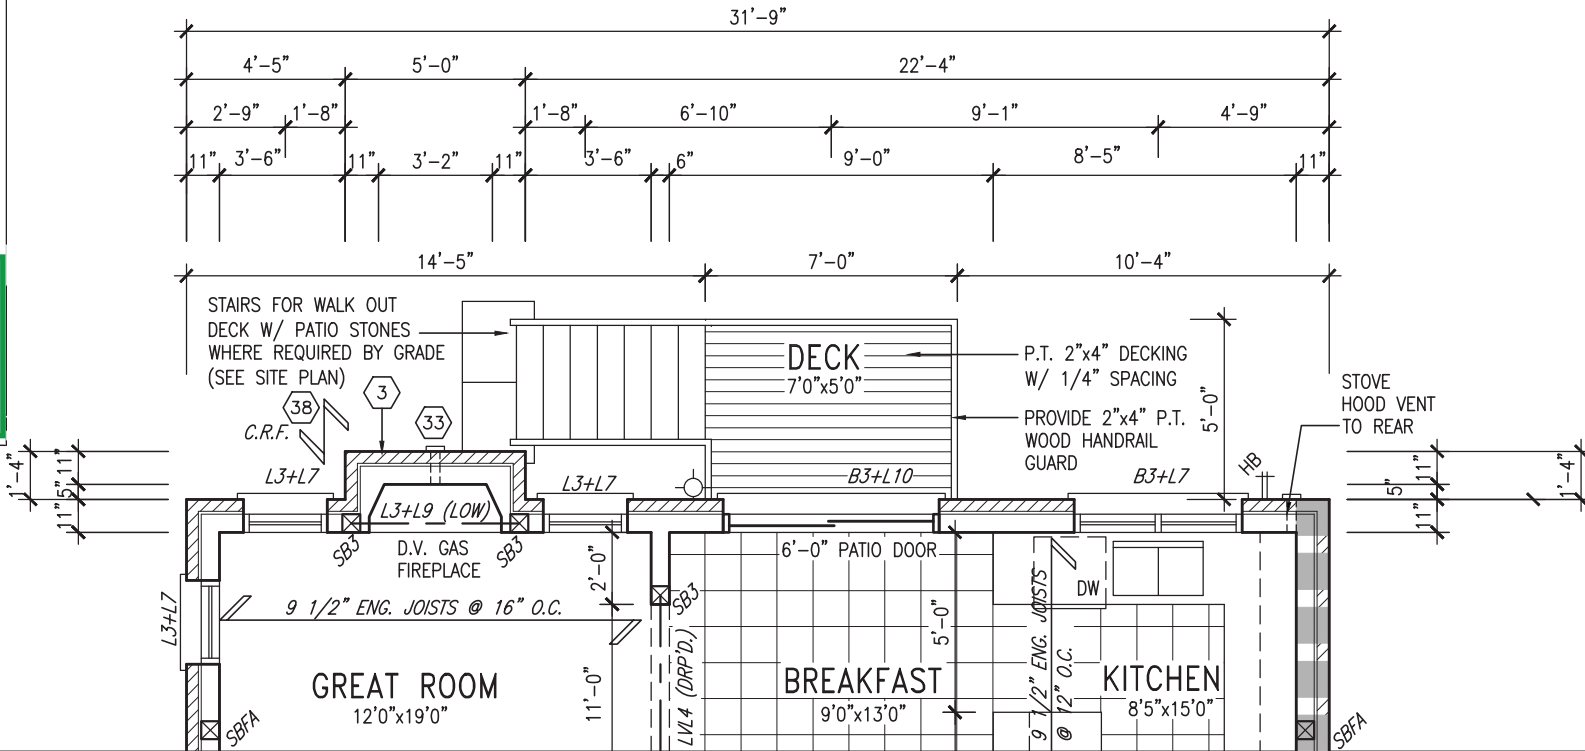

PARTIAL GROUND FLOOR PLAN 'A','B' & 'C'
- 9R OR MORE W.O.D. COND.

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| 3 | REVISED AS PER ENG COMMENTS | MAR 01-22 | RC |
| 2 | REVISED AS PER FLOOR / ROOF LAYOUTS | FEB 24-22 | RC |
| 1 | ISSUED FOR CLIENT REVIEW | NOV 23-21 | VA3 |
| no. | description | date | by |

The undersigned has reviewed and takes responsibility for this design and has the qualifications and meets the requirements set out in the Ontario Building Code to be a Designer.
qualification information
Wellington Jno-Baptiste 25591
name signature BCIN
registration information
VA3 Design Inc. 42658
Contractor must verify all dimensions on the job and report any discrepancy to the Designer before proceeding with the work. All drawings and specifications are instruments of service and the property of the Designer which must be returned at the completion of the work. Drawings are not to be scaled.



255 Consumers Rd Suite 120
Toronto ON M2J 1R4
t 416.630.2255 f 416.630.4782
va3design.com

BAYVIEW WELLINGTON

S38-20

| | | | | | |
|---|----------------------|--------------|--------------------|-------------|---------------|
| project name | GREEN VALLEY ESTATES | municipality | BRADFORD EAST, ON. | project no. | 16023 |
| date | SEPT. 2021 | checked by | JWM | scale | 3/16" = 1'-0" |
| drawn by | NC | file name | 16023-S38-20 | drawing no. | 19 |
| PART. FLOOR PLAN -W.O.D. COND. | | | | | |
| RICHARD - H:\ARCHIVE\WORKING\2016\16023.BW\Units\38\16023-S38-20.dwg - Tue - Mar 1 2022 - 2:39 PM | | | | | |

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JOHN G. WILLIAMS LTD., ARCHITECT
ARCHITECTURAL CONTROL REVIEW
AND APPROVAL


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S38-20

BAYVIEW WELLINGTON

project no. 16023
project name GREEN VALLEY ESTATES
municipality BRADFORD EAST, ON.

date SEPT. 2021
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drawing no. 20
file name 16023-S38-20
date SEPT. 2021
drawn by NC
checked by JWM
scale 3/16" = 1'-0"

REAR ELEV. 'A'/'B'/'C' -W.O.D. -COND.

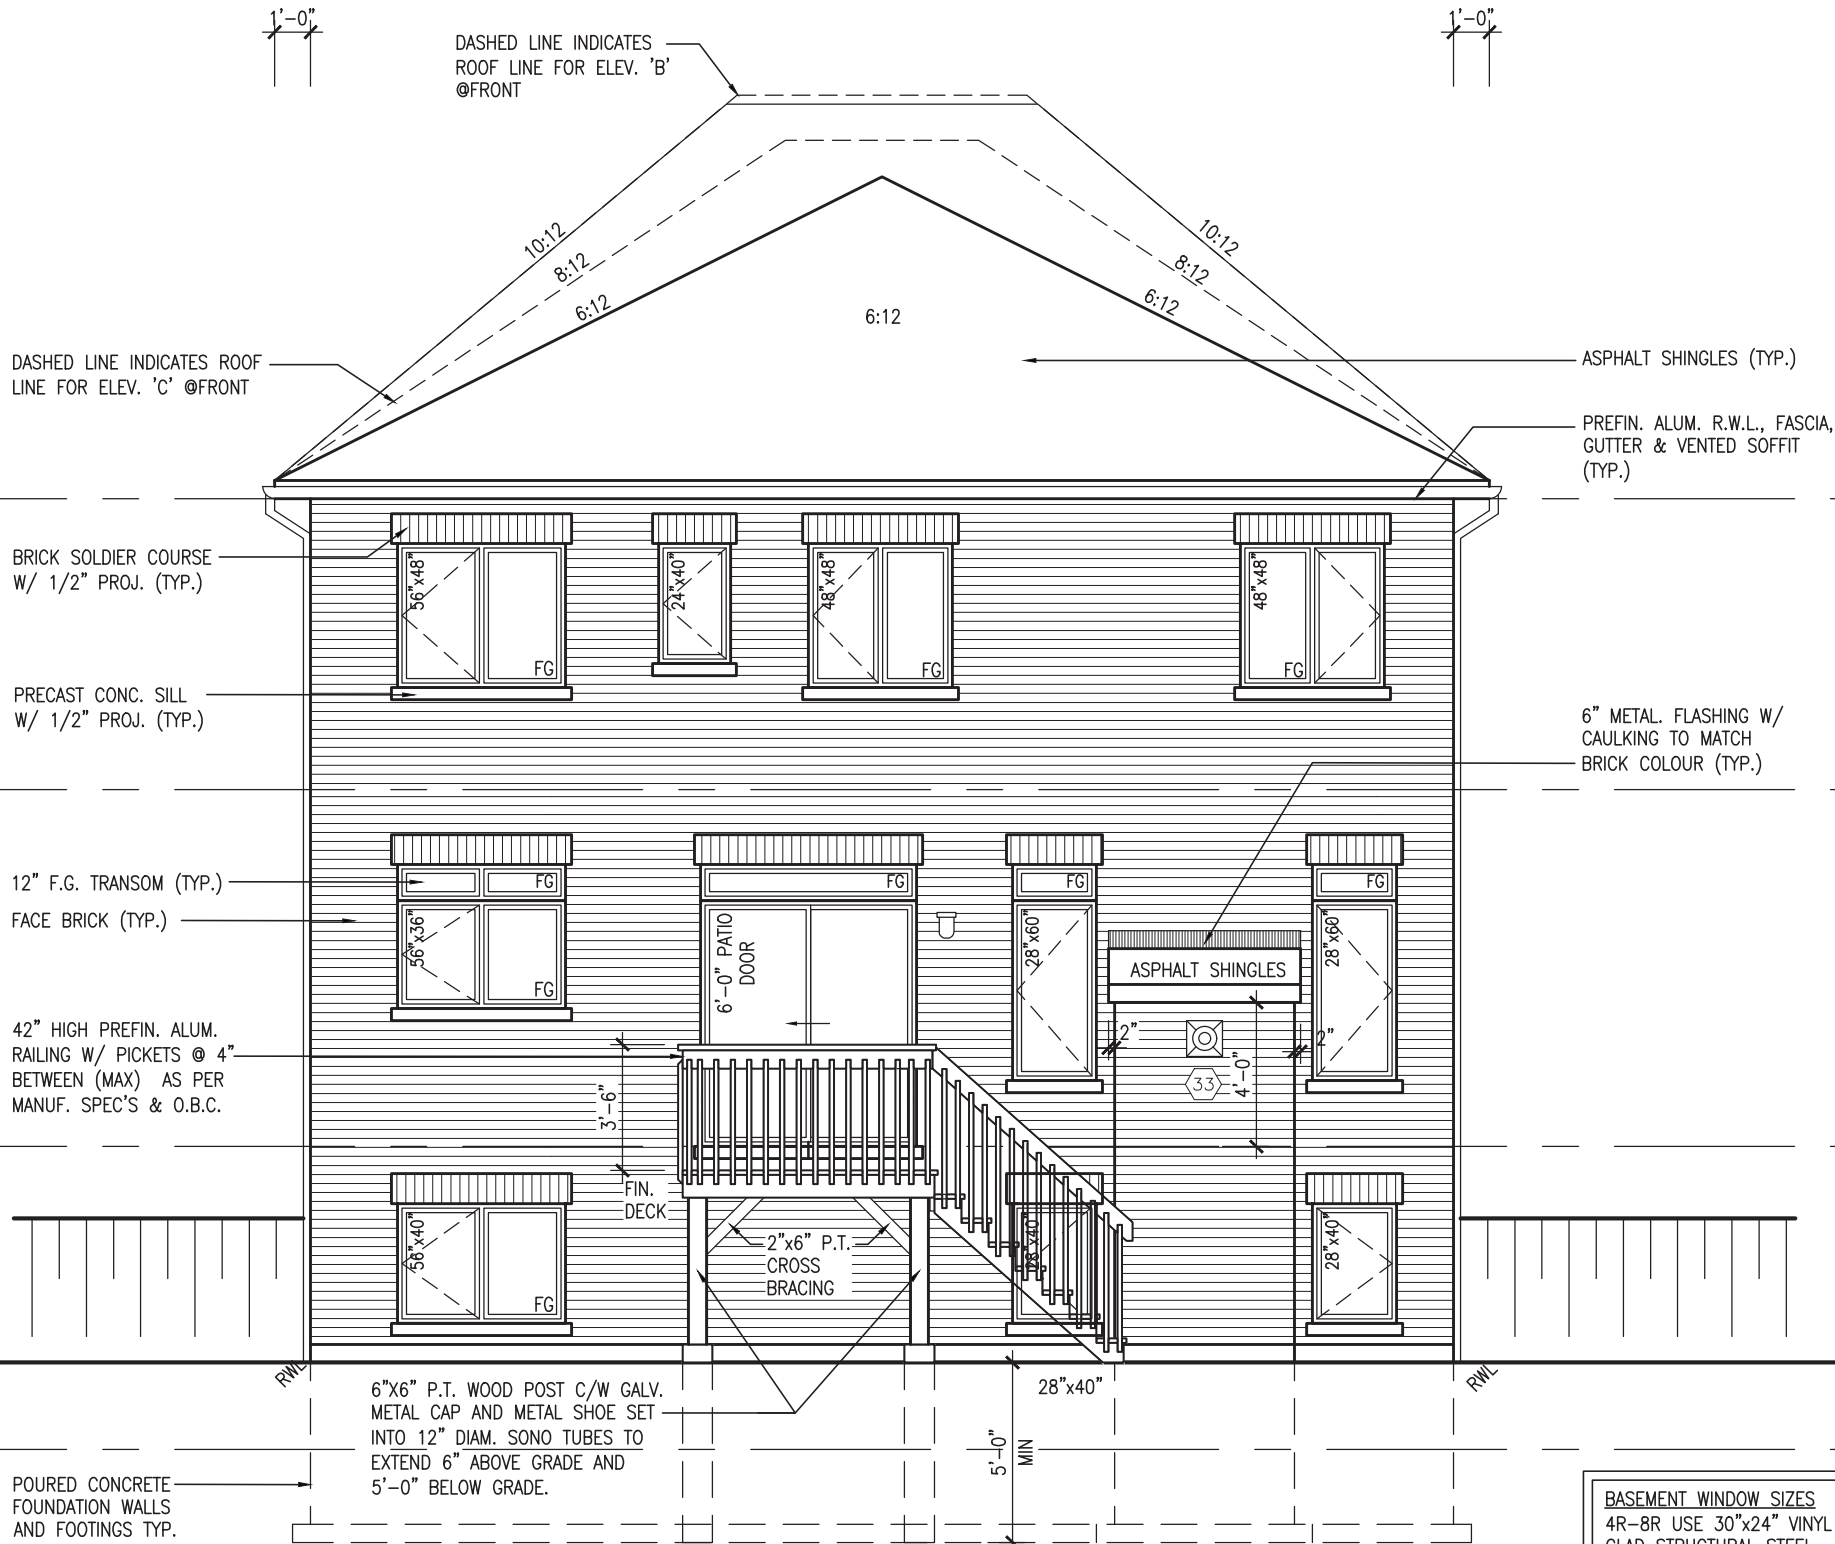
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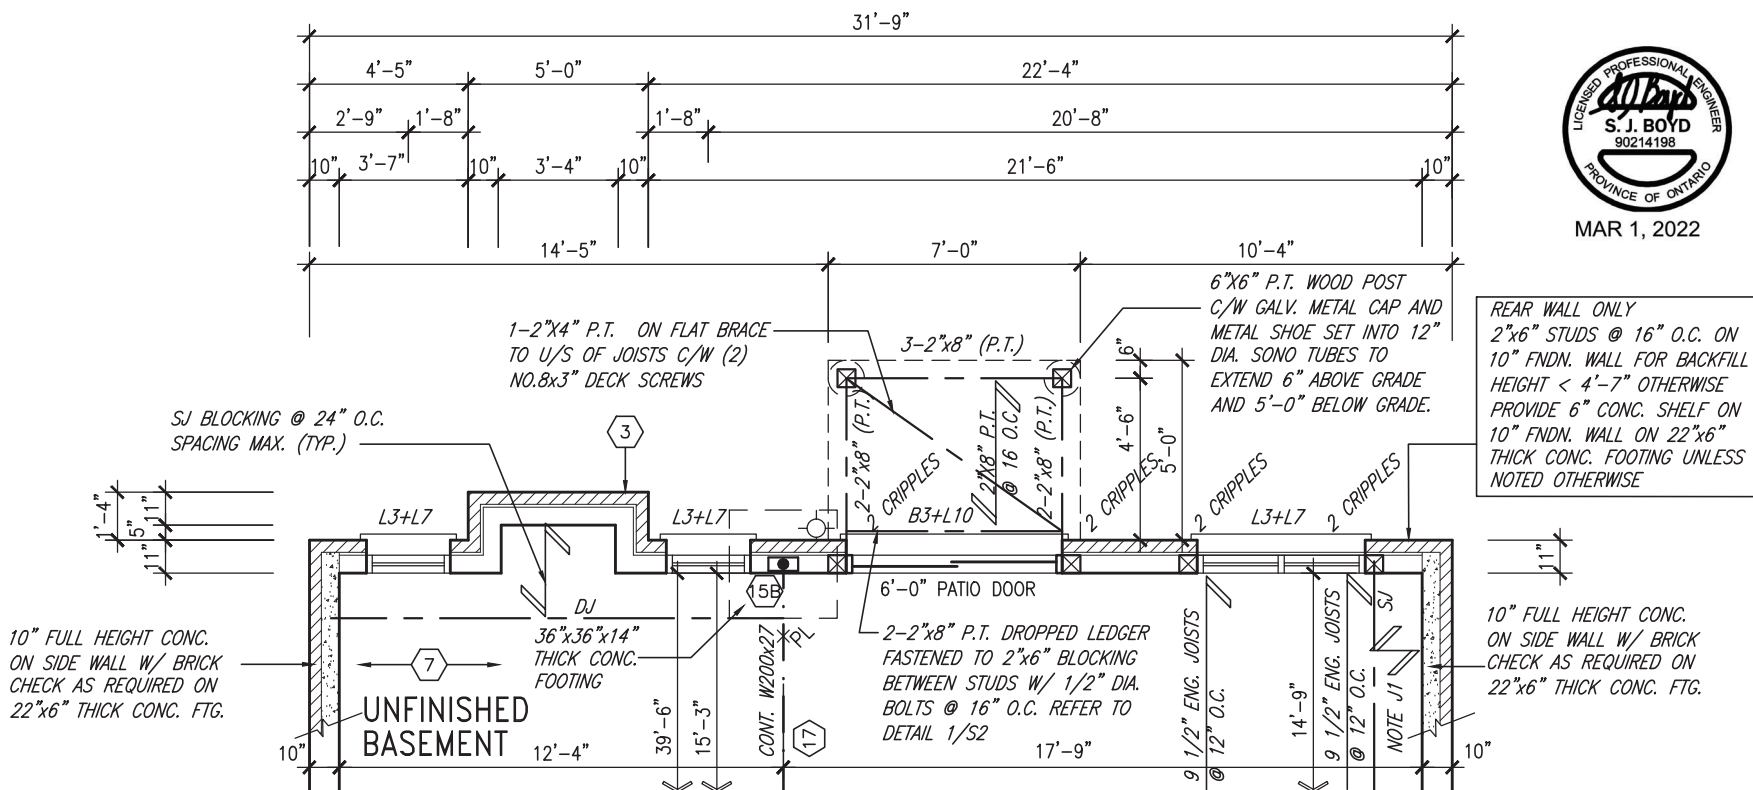
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ARCHITECTURAL CONTROL REVIEW
AND APPROVAL
APPROVED BY: 
DATE: MAR 03, 2022
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PART. GROUND FLOOR PLAN 'A','B'&'C'
-W.O.B. COND.



PART. BASEMENT PLAN 'A','B'&'C'
-W.O.B. COND.

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| 1 | ISSUED FOR CLIENT REVIEW | NOV 23-21 | VA3 |
| no. | description | date | by |

The undersigned has reviewed and takes responsibility for this design and has the qualifications and meets the requirements set out in the Ontario Building Code to be a Designer.

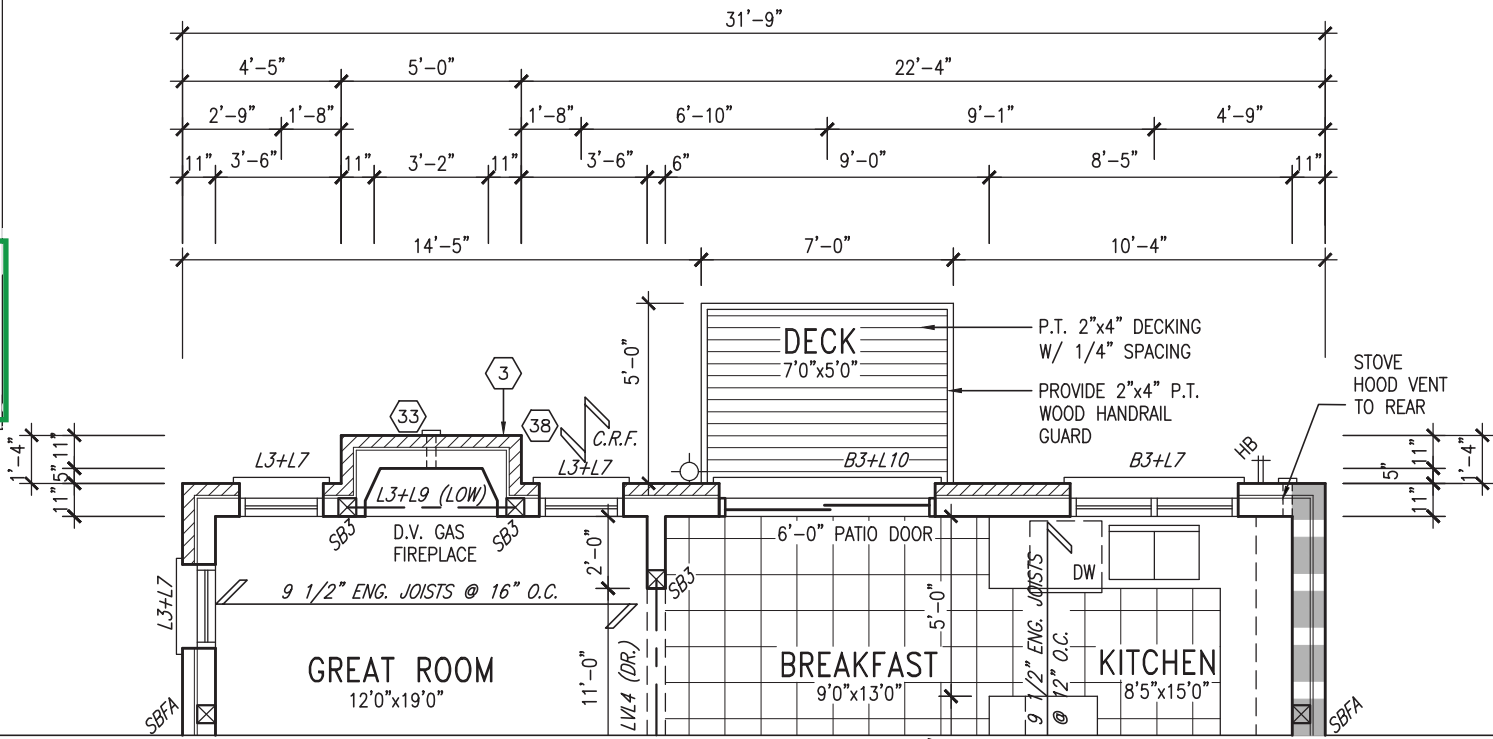qualification information

Wellington Jno-Baptiste 25591
name signature BCIN
registration information
VA3 Design Inc. 42658

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| BAYVIEW WELLINGTON | | S38-20 | |
| project name | GREEN VALLEY ESTATES | municipality | BRADFORD EAST, ON. |
| date | SEPT. 2021 | project no. | 16023 |
| drawn by | NC | file name | 16023-S38-20 |
| checked by | JWM | scale | 3/16" = 1'-0" |
| PART. FLOOR PLAN -W.O.B. COND. | | | |
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| drawing no. | | | 21 |

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REFER TO FRONT
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NOTES & INFORMATION



REAR ELEVATION 'A'/'B'/'C'
-W.O.B. CONDITION

BAYVIEW WELLINGTON

S38-20

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| project name | project no. |
| GREEN VALLEY ESTATES | 16023 |
| BRADFORD EAST, ON. | |

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| | | | REAR ELEV. A / B / C -W.U.B. COND. |

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| NC | JWM | $3/16" = 1'-0"$ | 16023-S38-20 |
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specifications, related documents and d

the undersigned has reviewed and takes responsibility for this design and has the qualifications and meets the requirements set out in the

Ontario Building Code to be a Designer.

Qualification information
Wellington Inc-Bantist
25591

| | | |
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| name | signature | BCIN |
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Registration information
A3 Design Inc.
42658

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All drawings


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APPROVED BY:


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UPGRADED ROOF PLAN 'A'




UPGRADED REAR ELEVATION 'A'


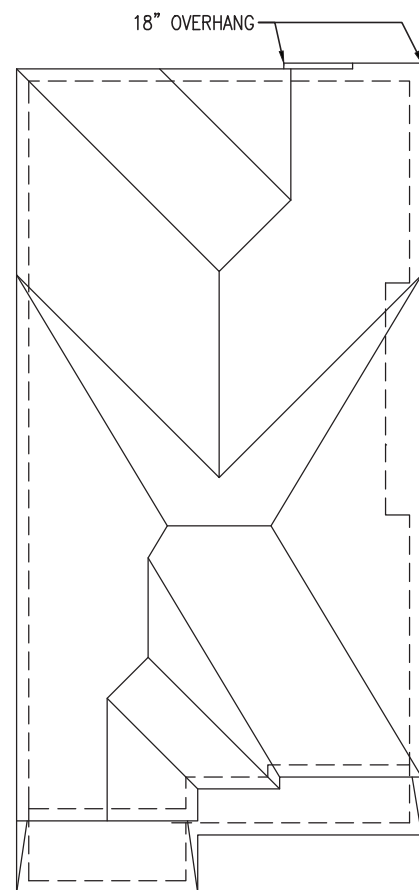


MAR 1, 2022
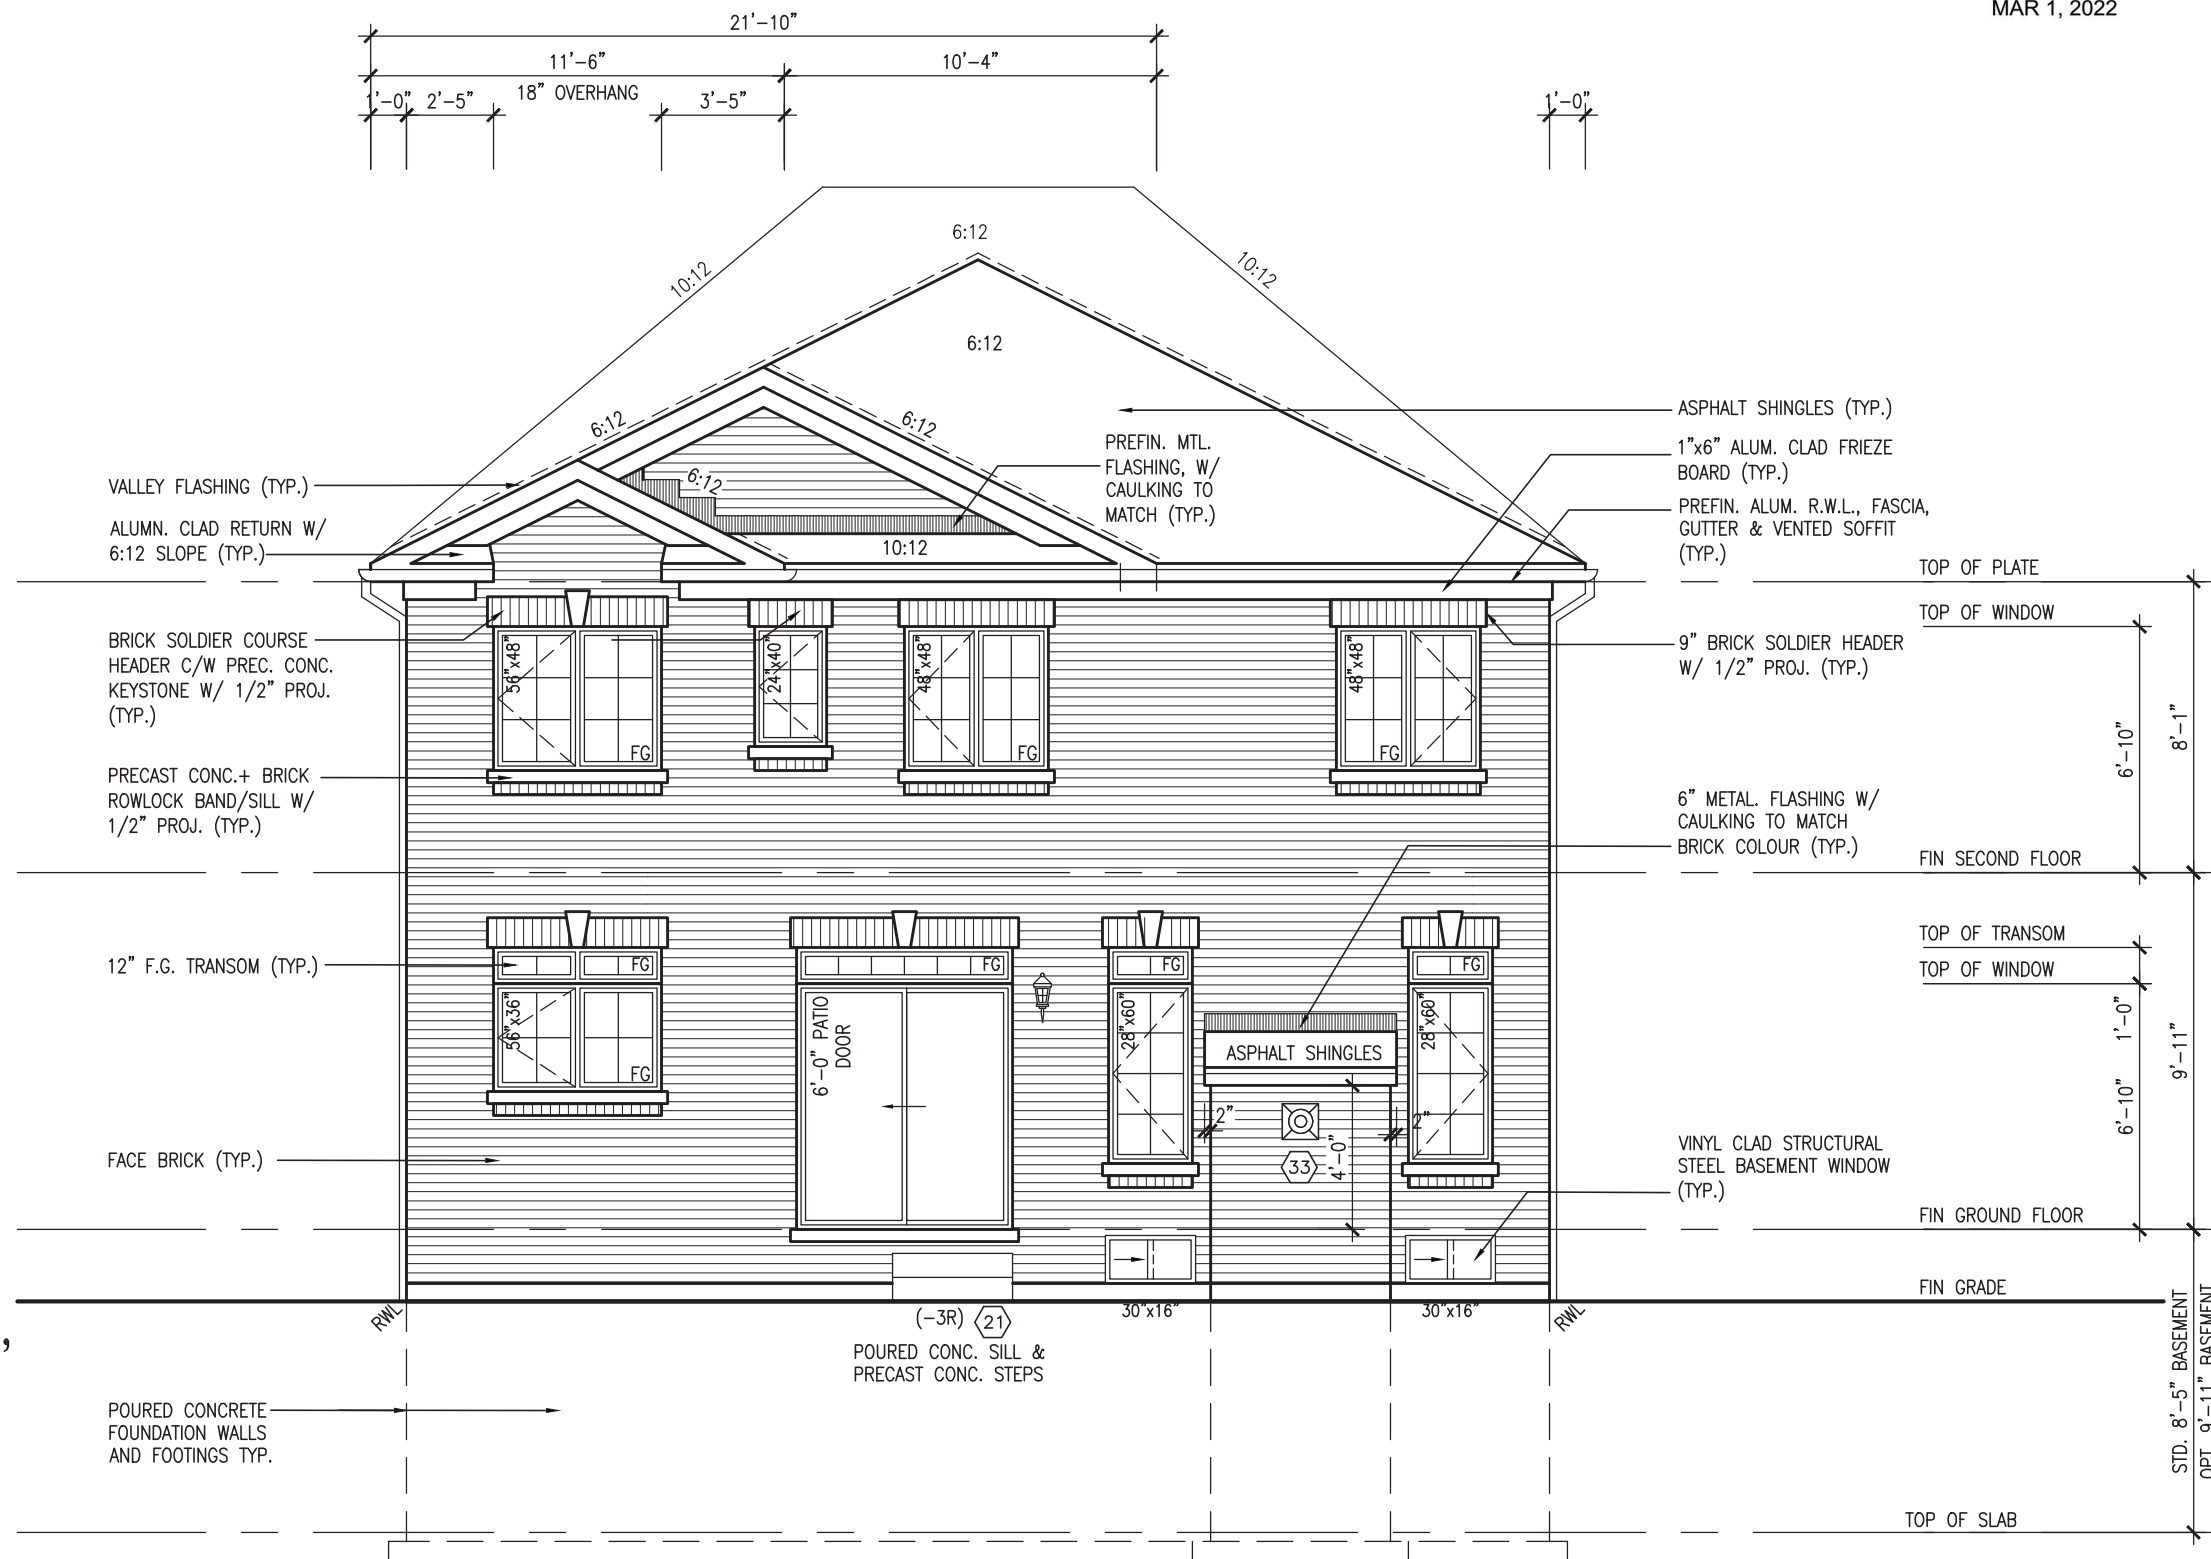
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| 9 | . | . | The undersigned has reviewed and takes responsibility for this design and has the qualifications and meets the requirements set out in the Ontario Building Code to be a Designer. | qualification information | Wellingdon Jno-Baptiste | 25591 |
| 8 | . | . | | name | BCIN | |
| 7 | . | . | | registration information | signature | |
| 6 | . | . | | VAS Design Inc. | 42658 | |
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| 3 | REVISED AS PER ENG. COMMENTS | MAR 01-22 | RC | | | |
| 2 | REVISED AS PER FLOOR / ROOF LAYOUTS | FEB 24-22 | RC | | | |
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| no. | description | date | by | Contractor must verify all dimensions on the job and report any discrepancy to the Designer before proceeding with the work. All drawings and specifications are instruments of service and the property of the Designer which must be returned at the completion of the work. Drawings are not to be scaled. | | |

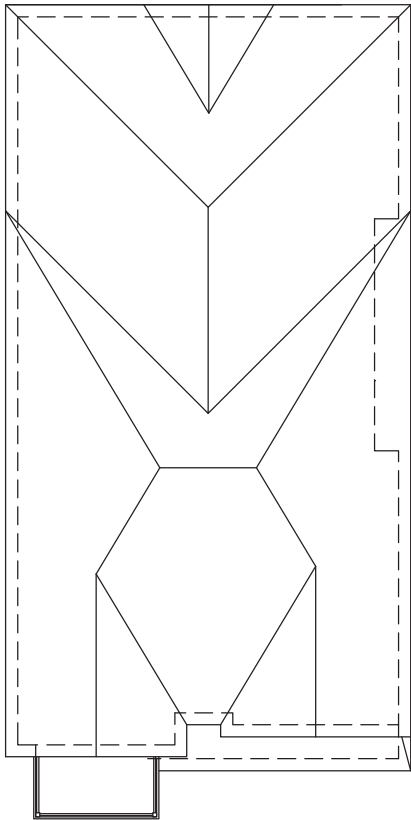

UPGRADED ROOF PLAN 'A'

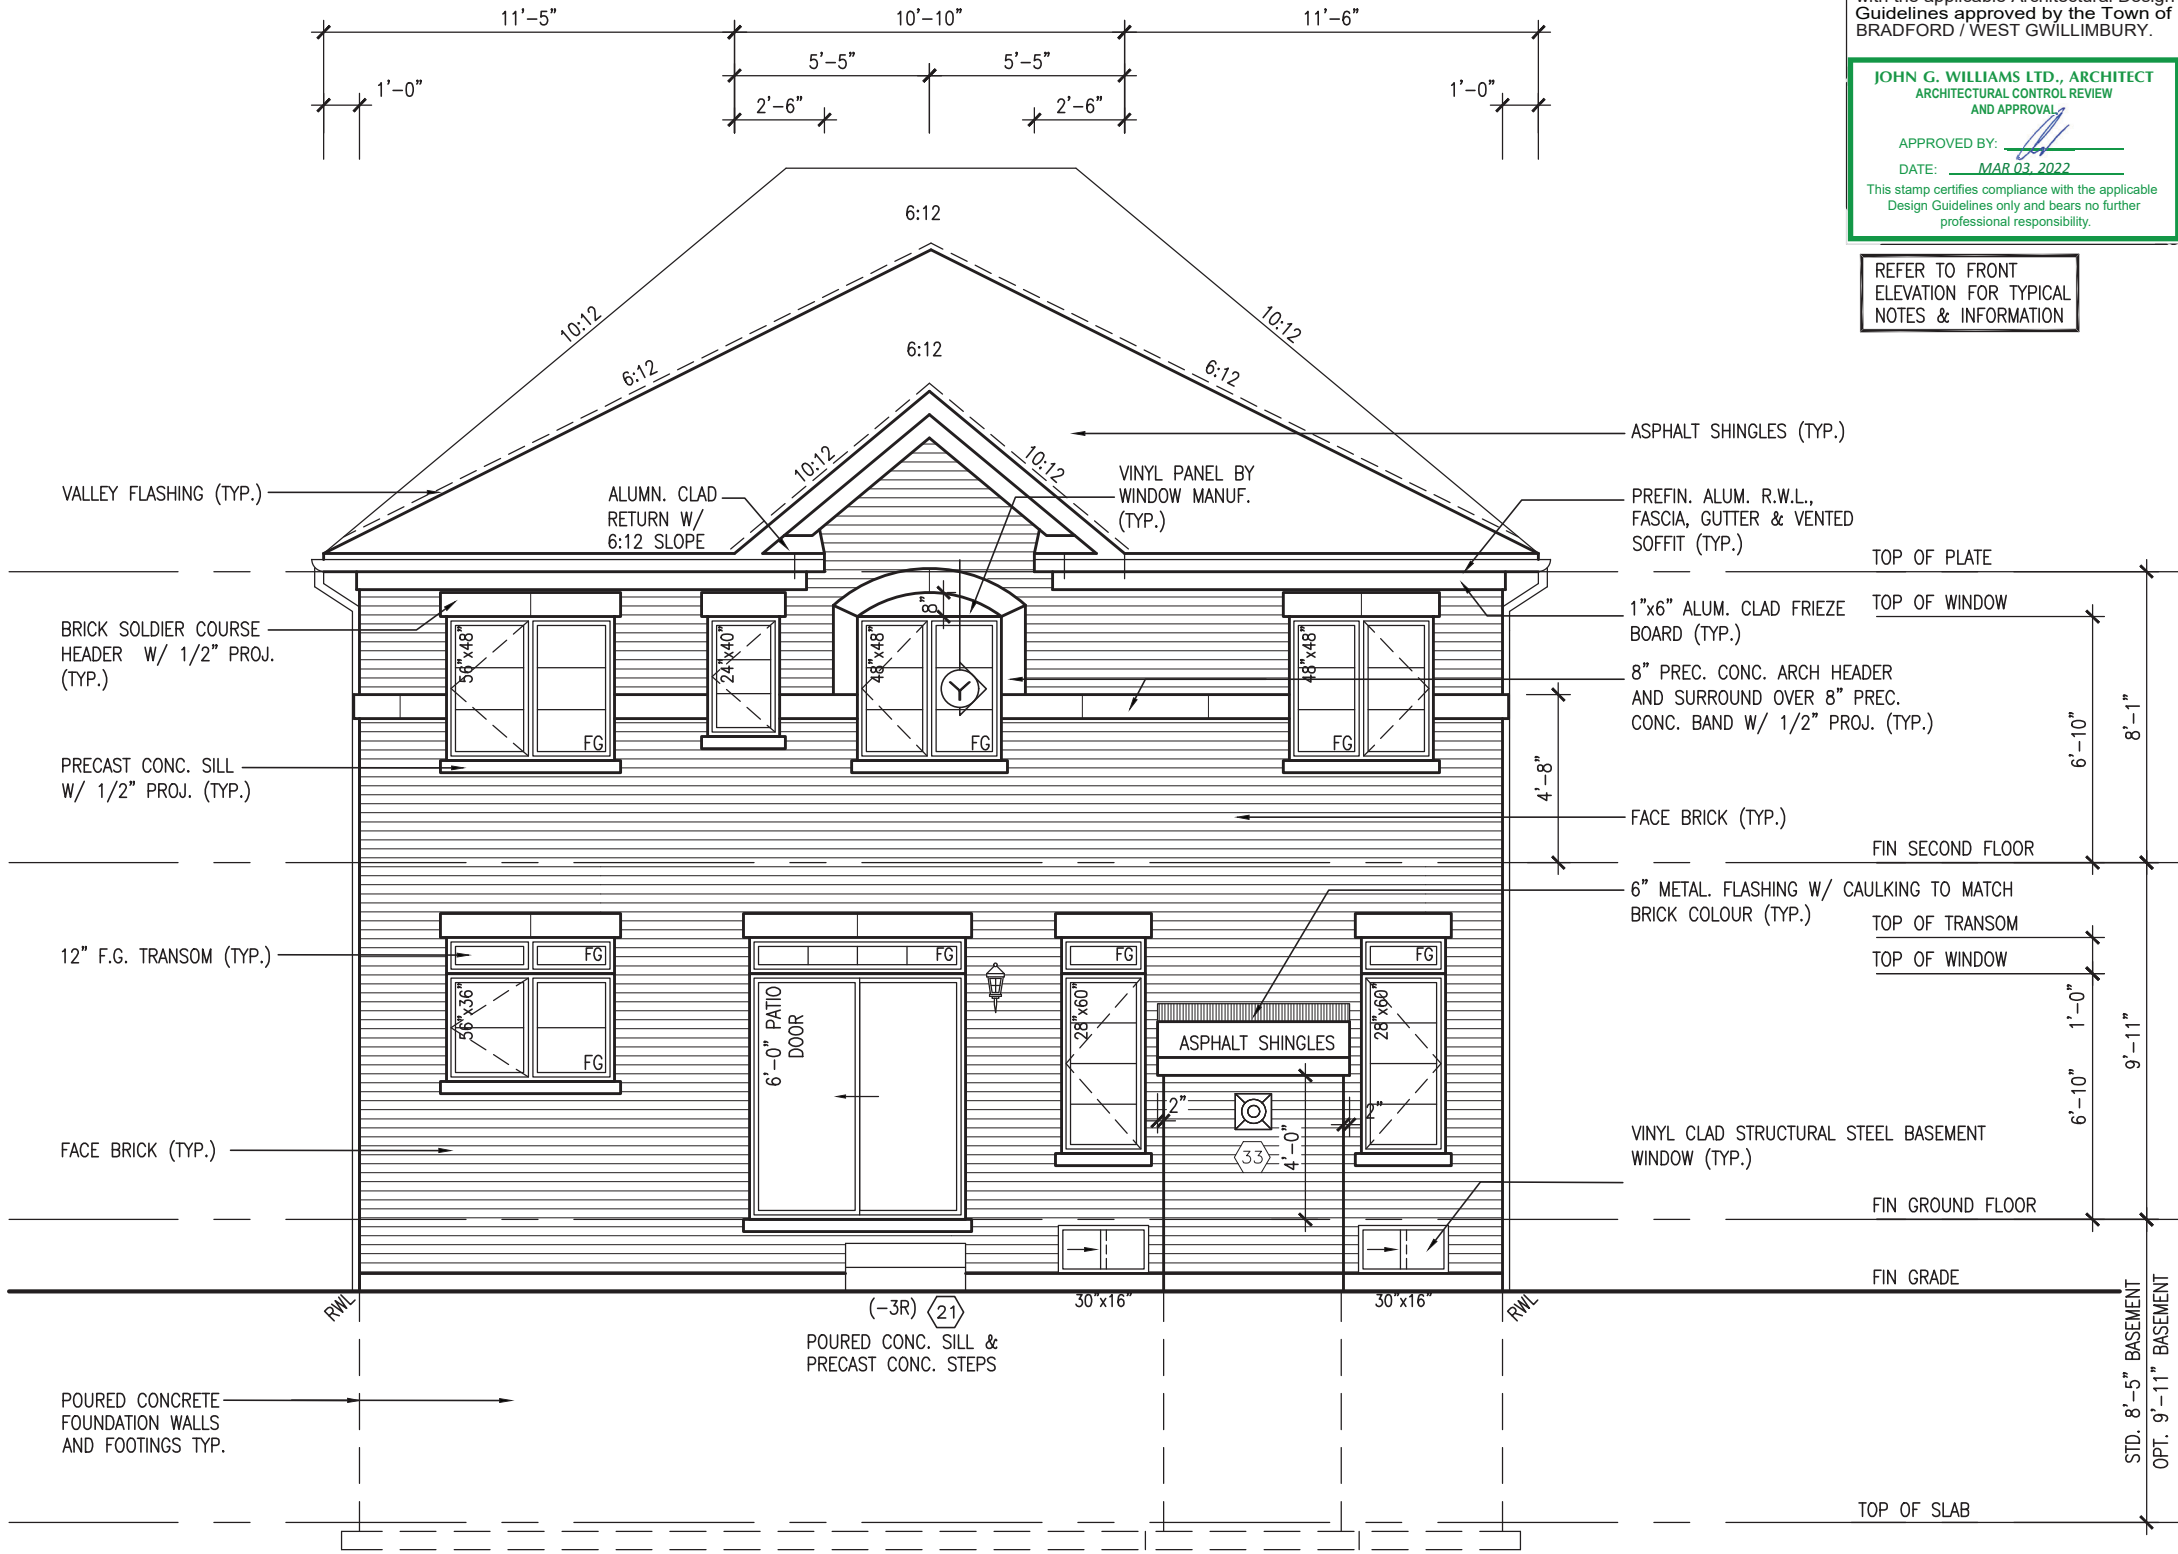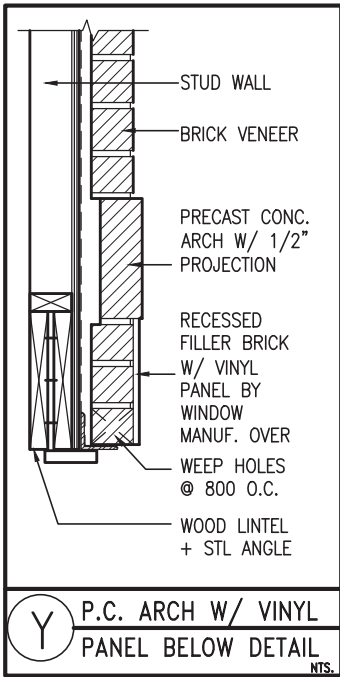

UPGRADED REAR ELEVATION 'B'



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JOHN G. WILLIAMS LTD., ARCHITECT
ARCHITECTURAL CONTROL REVIEW
AND APPROVAL

APPROVED BY:

DATE: MAR 03, 2022

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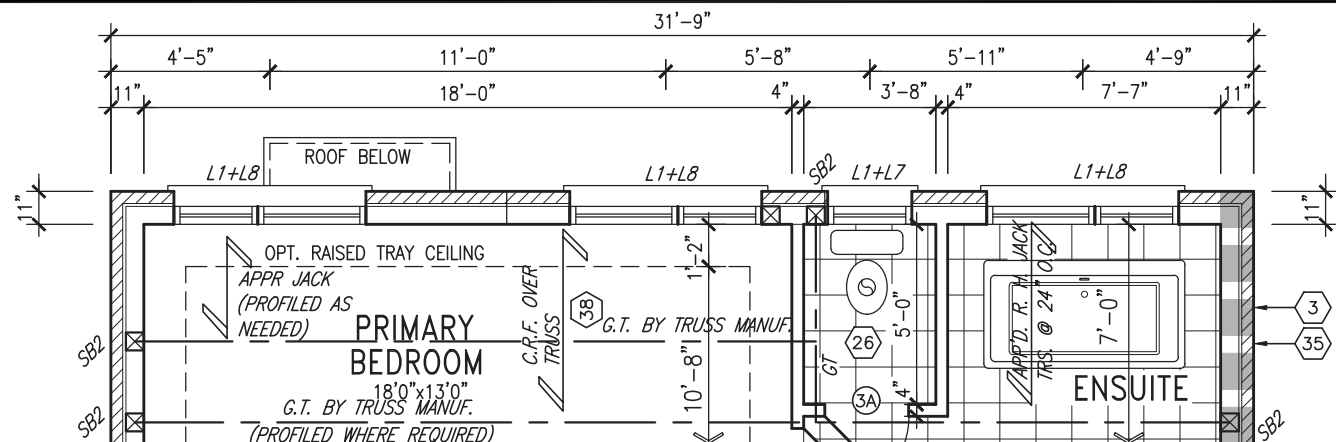
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NOTES & INFORMATION

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| name | | BCIN | | | |
| registration information | | signify/e | | | |
| VA3 Design Inc. | | 42658 | | | |
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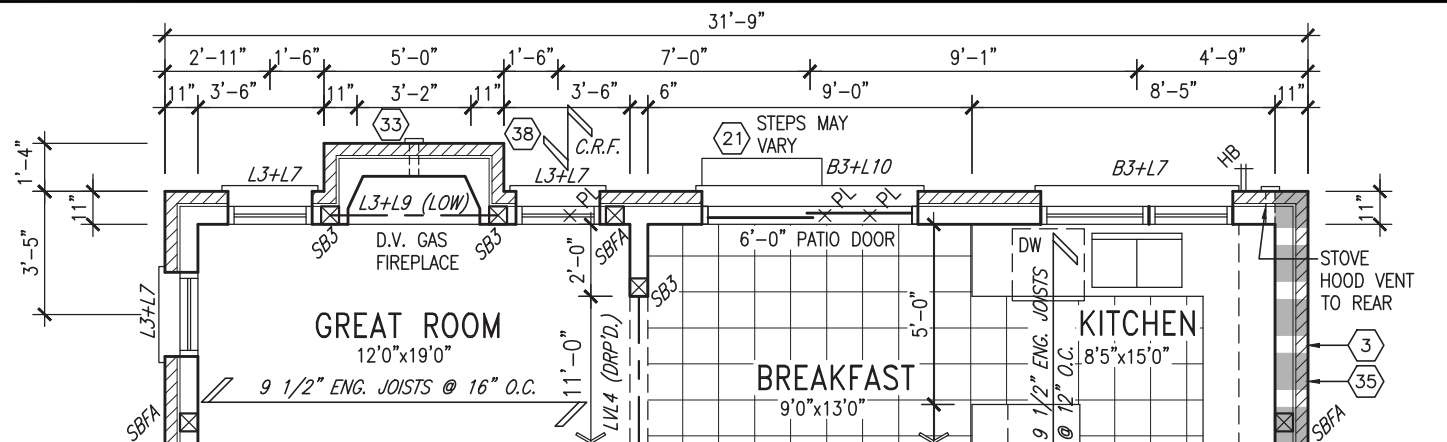
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| BAYVIEW WELLINGTON | | S38-20 | |
| project name | | project no. | |
| GREEN VALLEY ESTATES | | 16023 | |
| municipality | | drawing no. | |
| BRADFORD EAST, ON. | | 24 | |
| date | | file name | |
| SEPT. 2021 | | 16023-S38-20 | |
| drawn by | | scale | |
| NC | | 3/16" = 1'-0" | |
| checked by | | JWM | |
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PARTIAL SECOND FLOOR PLAN 'C'
W/ REAR UPGRADE



PARTIAL GROUND FLOOR PLAN 'C'
W/ REAR UPGRADE




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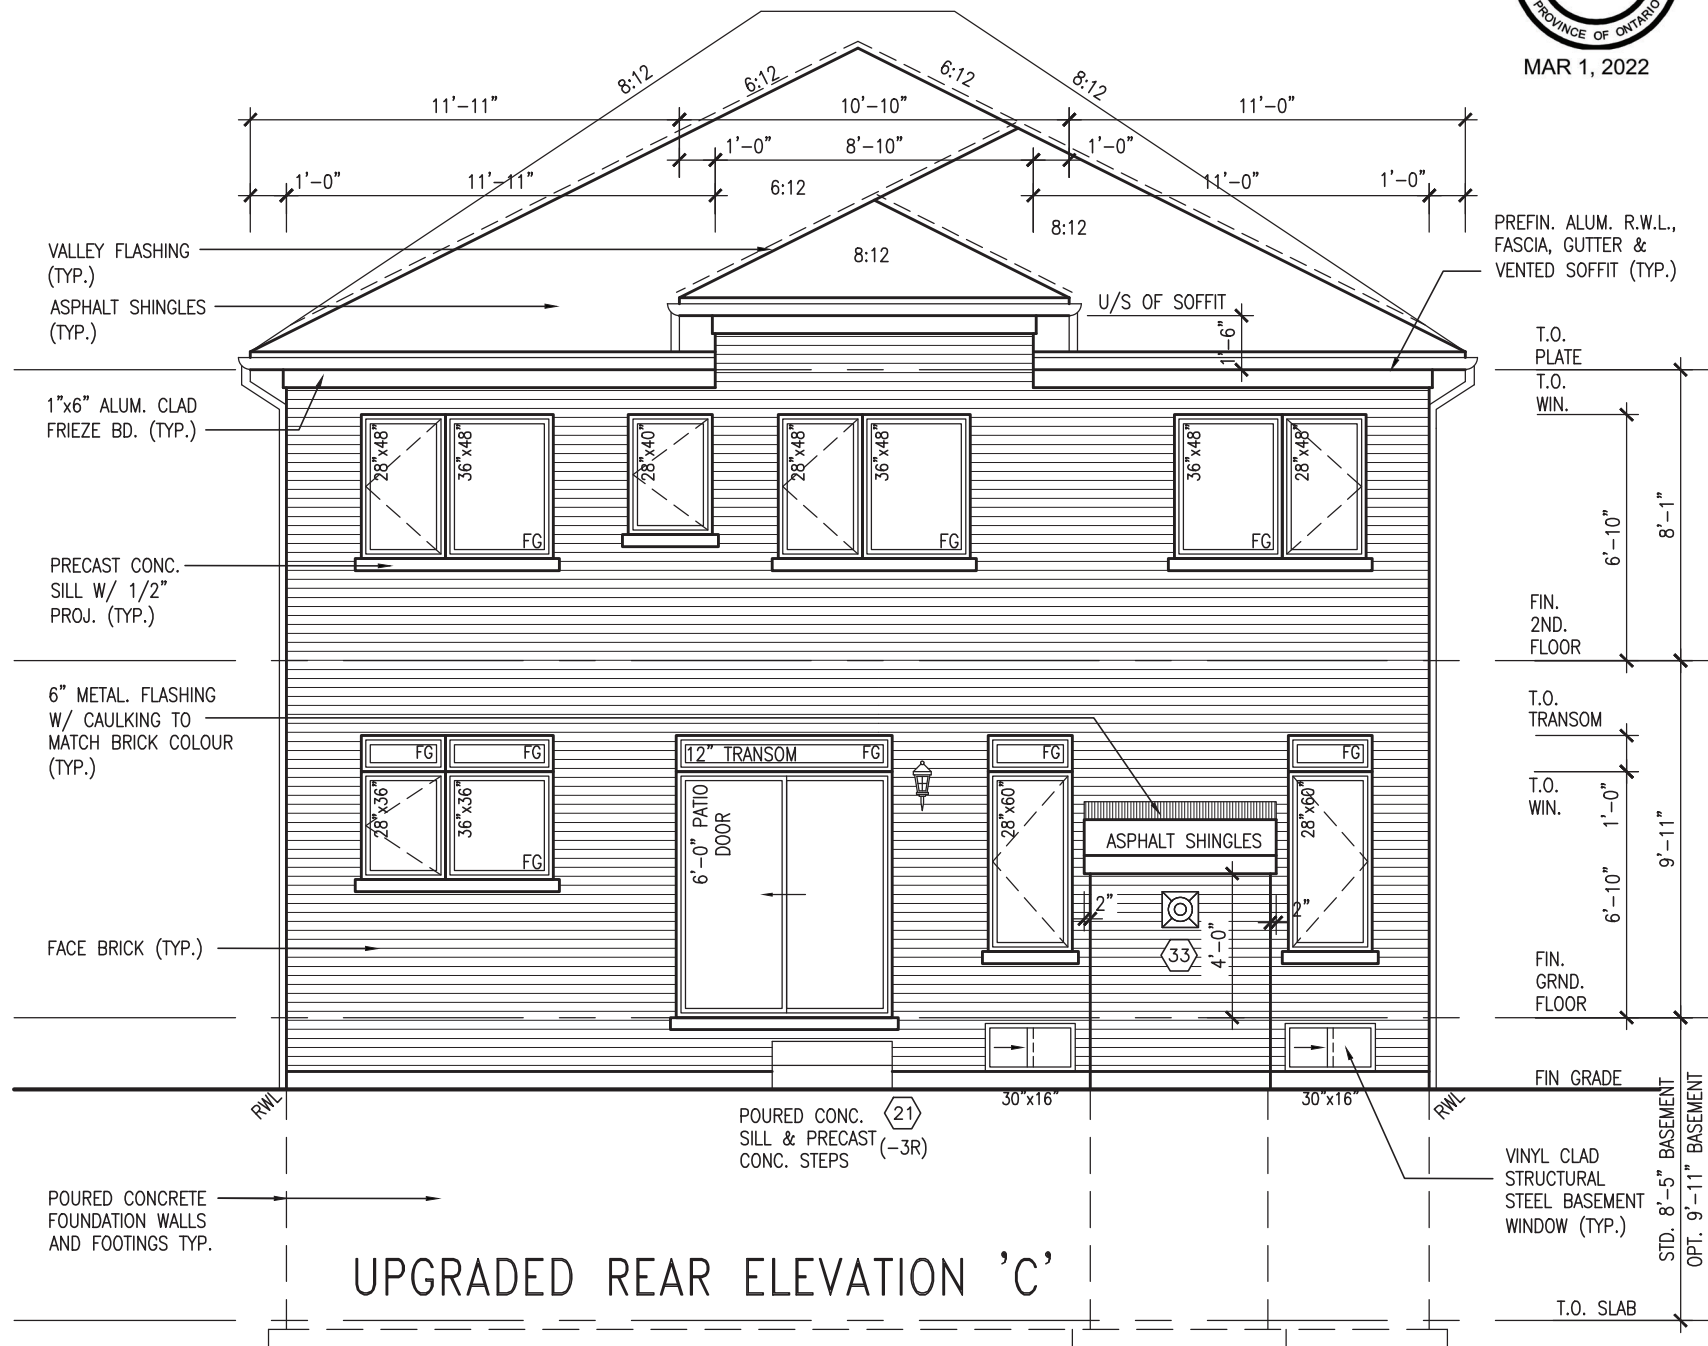
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ARCHITECTURAL CONTROL REVIEW
AND APPROVAL
APPROVED BY: [Signature]
DATE: MAR 03, 2022
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UPGRADED ROOF PLAN 'A'



UPGRADED REAR ELEVATION 'C'

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| project name | | project no. | | drawing no. | |
| BAYVIEW WELLINGTON | | S38-20 | | 16023 | |
| project name | | project no. | | drawing no. | |
| GREEN VALLEY ESTATES | | BRADFORD EAST, ON. | | 25 | |
| date | | checked by | | scale | |
| SEPT. 2021 | | JWM | | 3/16" = 1'-0" | |
| drawn by | | checked by | | file name | |
| NC | | JWM | | 16023-S38-20 | |
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| Wellington Jno-Baptiste 25591 BCIN 42658 | | | | | |
| name registration information VAS Design Inc. | | | | | |
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| 2 REVISED AS PER FLOOR / ROOF LAYOUTS FEB 24-22 RC | | | | | |
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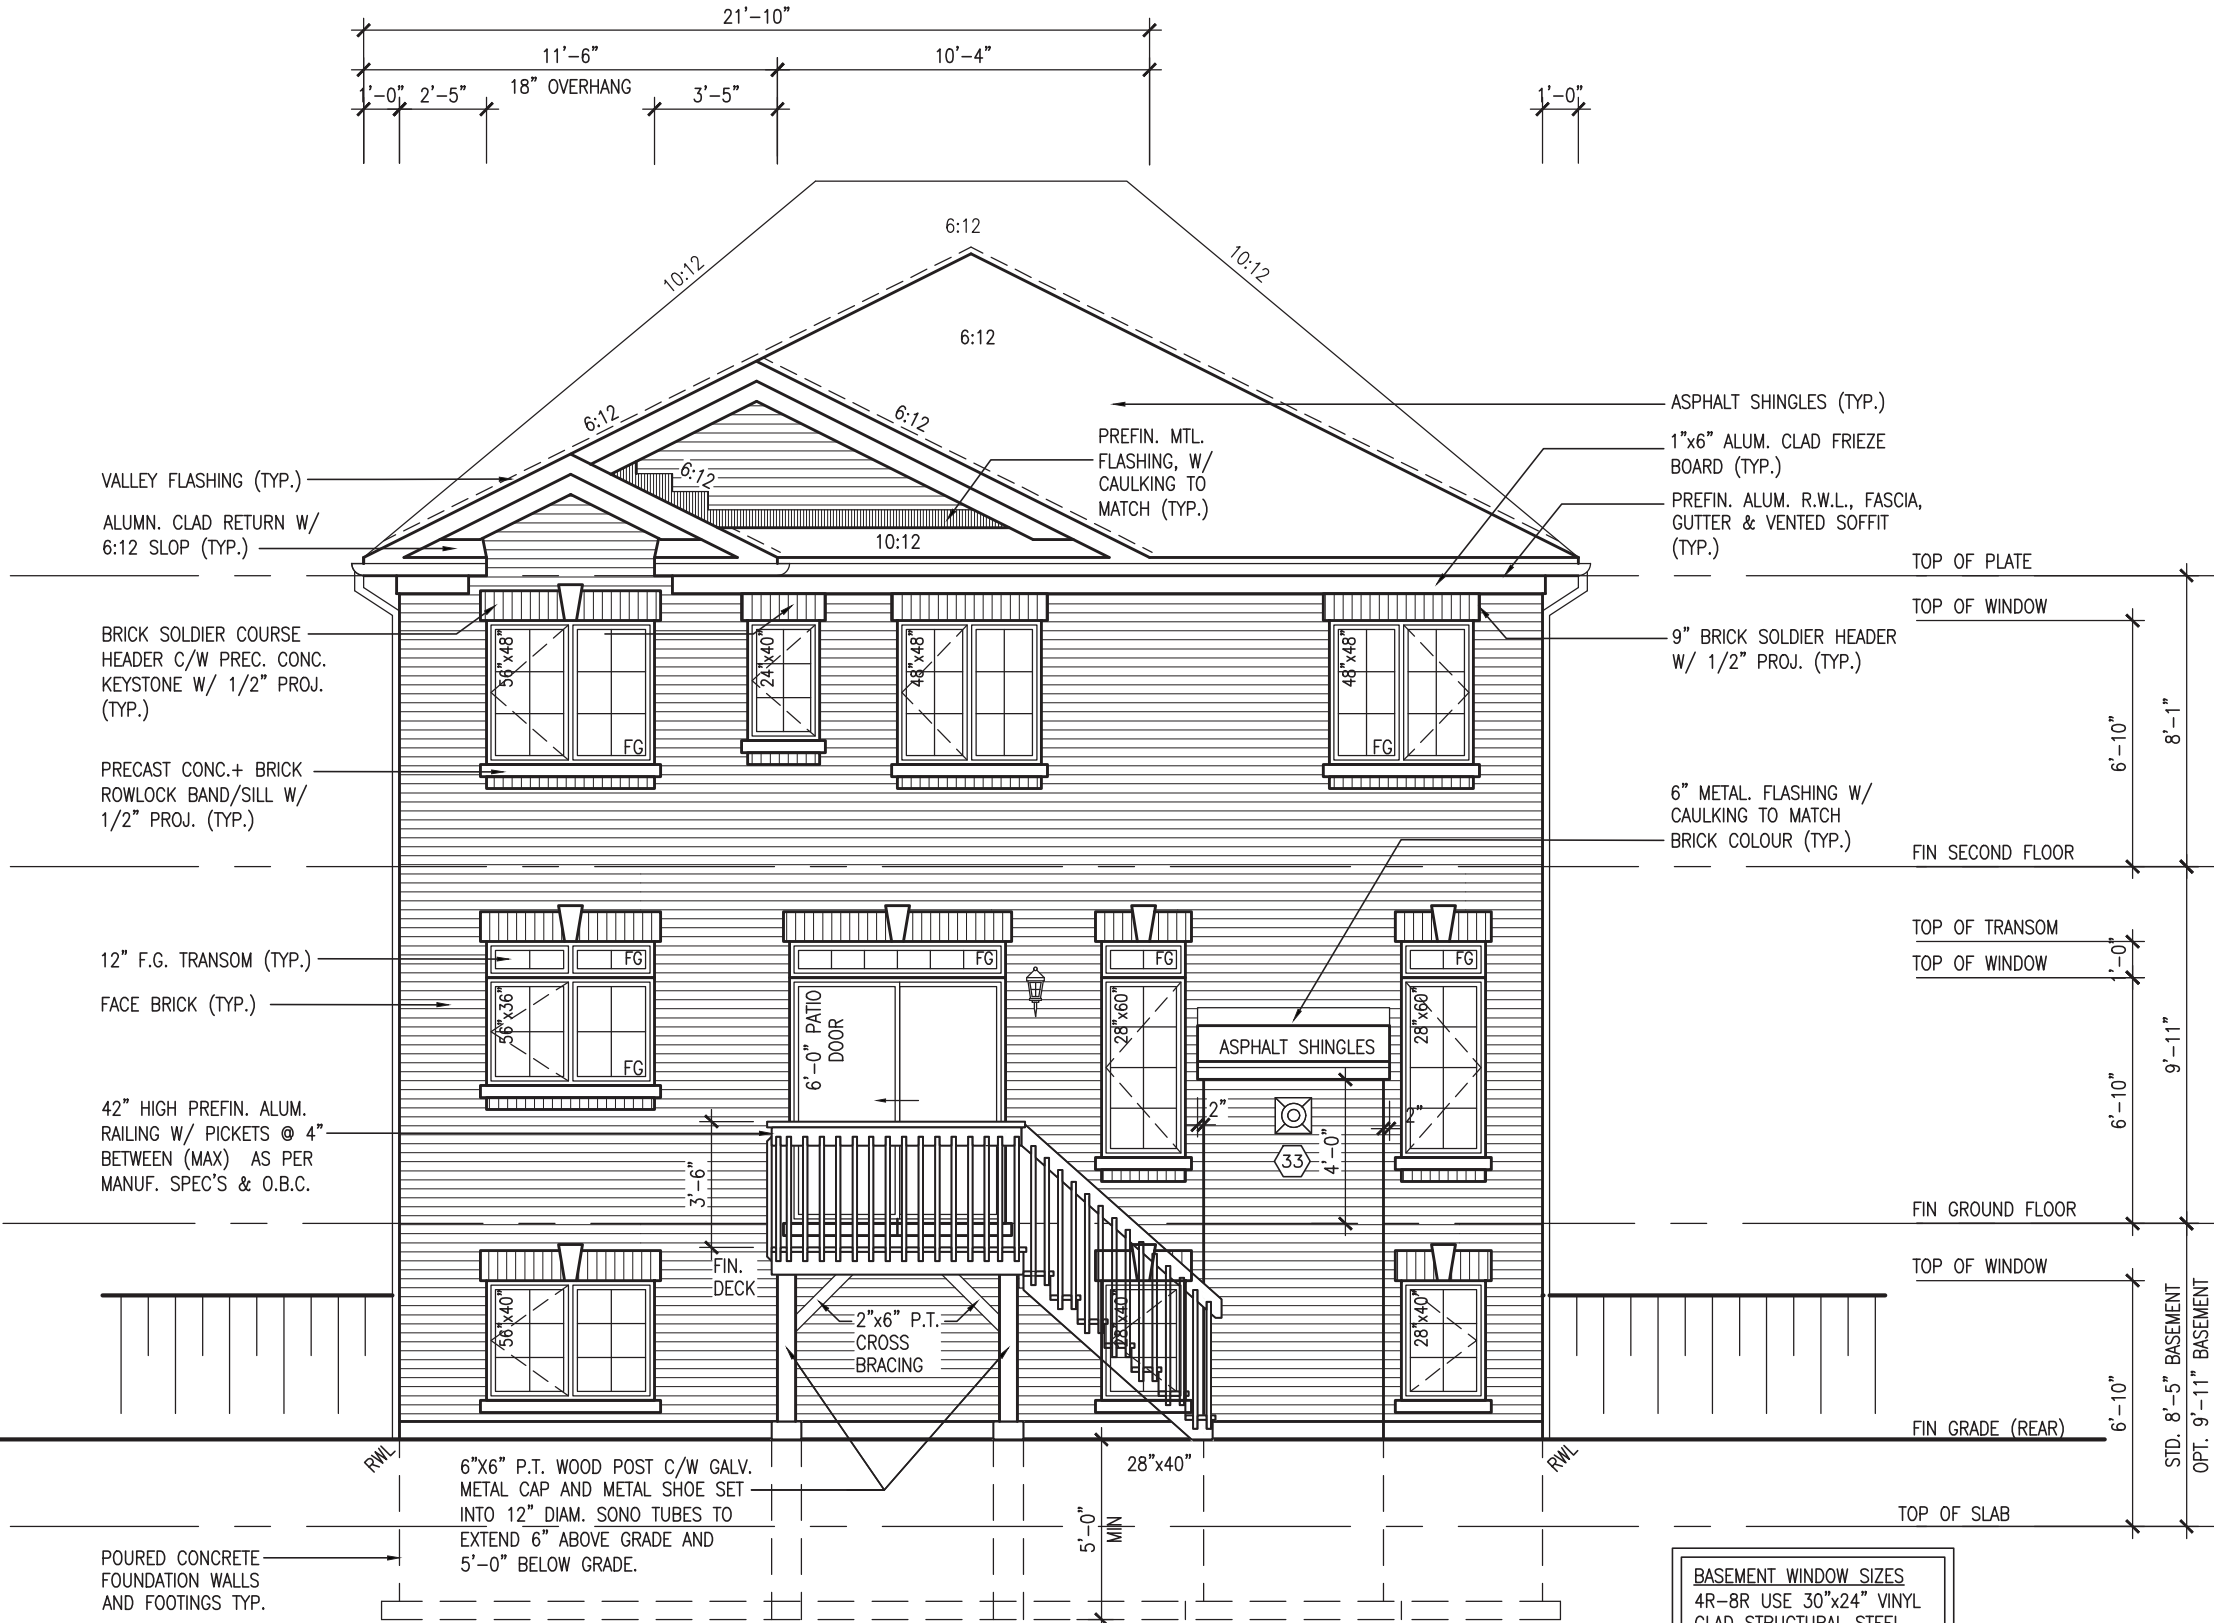
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AND APPROVAL

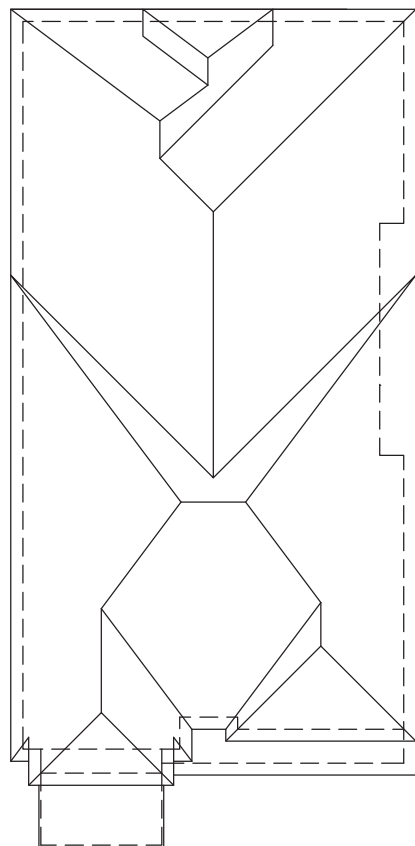APPROVED BY: 
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REFER TO FRONT
ELEVATION FOR TYPICAL
NOTES & INFORMATION



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BASEMENT WINDOW SIZES
4R-8R USE 30"x24" VINYL
CLAD STRUCTURAL STEEL
FRAME BASEMENT WINDOWS

project name
GREEN VALLEY ESTATES

project no.
16023

date
SEPT. 2021

drawn by
JWM

checked by
JWM

scale
3/16" = 1'-0"

file name
16023-S38-20

drawing no.
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municipality
BRADFORD EAST, ON.

project name
UPGRADED REAR ELEV. 'A' -W.O.D. COND.

date
SEPT. 2021

drawn by
JWM

checked by
JWM

scale
3/16" = 1'-0"

file name
16023-S38-20

drawing no.
26

name
Wellington Jno-Baptiste

registration information
V3S Design Inc.

BCIN
25591

BCIN
42658

name
Jno-Baptiste

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MAR 1, 2022

Architectural elevation drawing of a two-story house with a gabled roof. The drawing includes detailed dimensions, material specifications, and window/door details.

Roof Dimensions:

- Overall width: 11'-11"
- Overall height: 11'-0"
- Roof pitch: 8:12 (left side), 6:12 (center), 8:12 (right side)
- Valley flashing (TYP.)
- U/S OF SOFFIT
- ASPHALT SHINGLES (TYP.)

Second Floor:

- Windows: 28" x 48" (left), 36" x 48" (left), 28" x 40" (center), 28" x 48" (right), 36" x 48" (right), 28" x 48" (right)
- Materials: PRECAST CONC. SILL W/ 1/2" PROJ. (TYP.), 1"x6" ALUM. CLAD FRIEZE BOARD (TYP.), 6" METAL FLASHING W/ CAULKING TO MATCH BRICK COLOUR (TYP.)
- Height: 8'-1" (from top of window to top of plate)

First Floor:

- Windows: 28" x 36" (left), 36" x 36" (left), 28" x 60" (center), 28" x 60" (right), 28" x 40" (right)
- Door: 6'-0" PATIO DOOR
- Materials: FACE BRICK (TYP.), 12" F.G. TRANSOM (TYP.), 42" HIGH PREFIN. ALUM. RAILING W/ PICKETS @ 4" BETWEEN (MAX) AS PER MANUF. SPEC'S & O.B.C.
- Height: 9'-11" (from top of transom to top of window)

Basement:

- Windows: 28" x 40" (left), 36" x 40" (left), 28" x 40" (right)
- Materials: 2"x6" P.T. CROSS BRACING
- Height: 6'-10" (from top of window to top of slab)

Foundation:

- POURED CONCRETE FOUNDATION WALLS AND FOOTINGS TYP.
- 6"x6" P.T. WOOD POST C/W GALV. METAL CAP AND METAL SHOE SET INTO 12" DIAM. SONO TUBES TO EXTEND 6" ABOVE GRADE AND 5'-0" BELOW GRADE.
- 28"x40" MIN

Other Details:

- FIN. DECK
- ASPHALT SHINGLES
- FIN SECOND FLOOR
- FIN GROUND FLOOR
- FIN GRADE (REAR)
- TOP OF SLAB
- STD. 8'-5" BASEMENT
- OPT. 9'-11" BASEMENT

Basement Window Sizes:

4R-8R USE 30"x24" VINYL

UPGRADED REAR ELEVATION 'C'
-W.O.D. 9R OR MORE COND.

BASEMENT WINDOW SIZES
4R-8R USE 30"x24" VINYL
CLAD STRUCTURAL STEEL
FRAME BASEMENT WINDOWS

S38-20

BAYVIEW WELLINGTON

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| project name | municipality | project no. |
| GREEN VALLEY ESTATES | BRADFORD EAST, ON. | 16023 |

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specifications, related documents and d

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Qualification information

| | | |
|--------------------------|-----------|-------|
| Wellington John-Baptiste | signature | BCIN |
| | | 16337 |

Registration information
/A3 Design Inc
42658

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| 3 | REVISED AS PER ENG COMMENTS | MAR 01-22 | RC |
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| 2 | REVISED AS PER FLOOR / ROOF LAYOUTS | FEB 24-22 | RC |
| 1 | ISSUED FOR CLIENT REVIEW | NOV 22 | VAZ |

| ISSUED FOR CLIENT REVIEW | date | by |
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| 1 | 2 | 3 | 100 |
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This is to certify that these plans comply with the applicable Architectural Design Guidelines approved by the Town of BRADFORD / WEST GWILLIMBURY.

APPROVED BY:


DATE: MAR 03, 2022

This stamp certifies compliance with the applicable
Design Guidelines only and bears no further
professional responsibility.

REFER TO FRONT
ELEVATION FOR TYPICAL
NOTES & INFORMATION



MAR 1, 2022

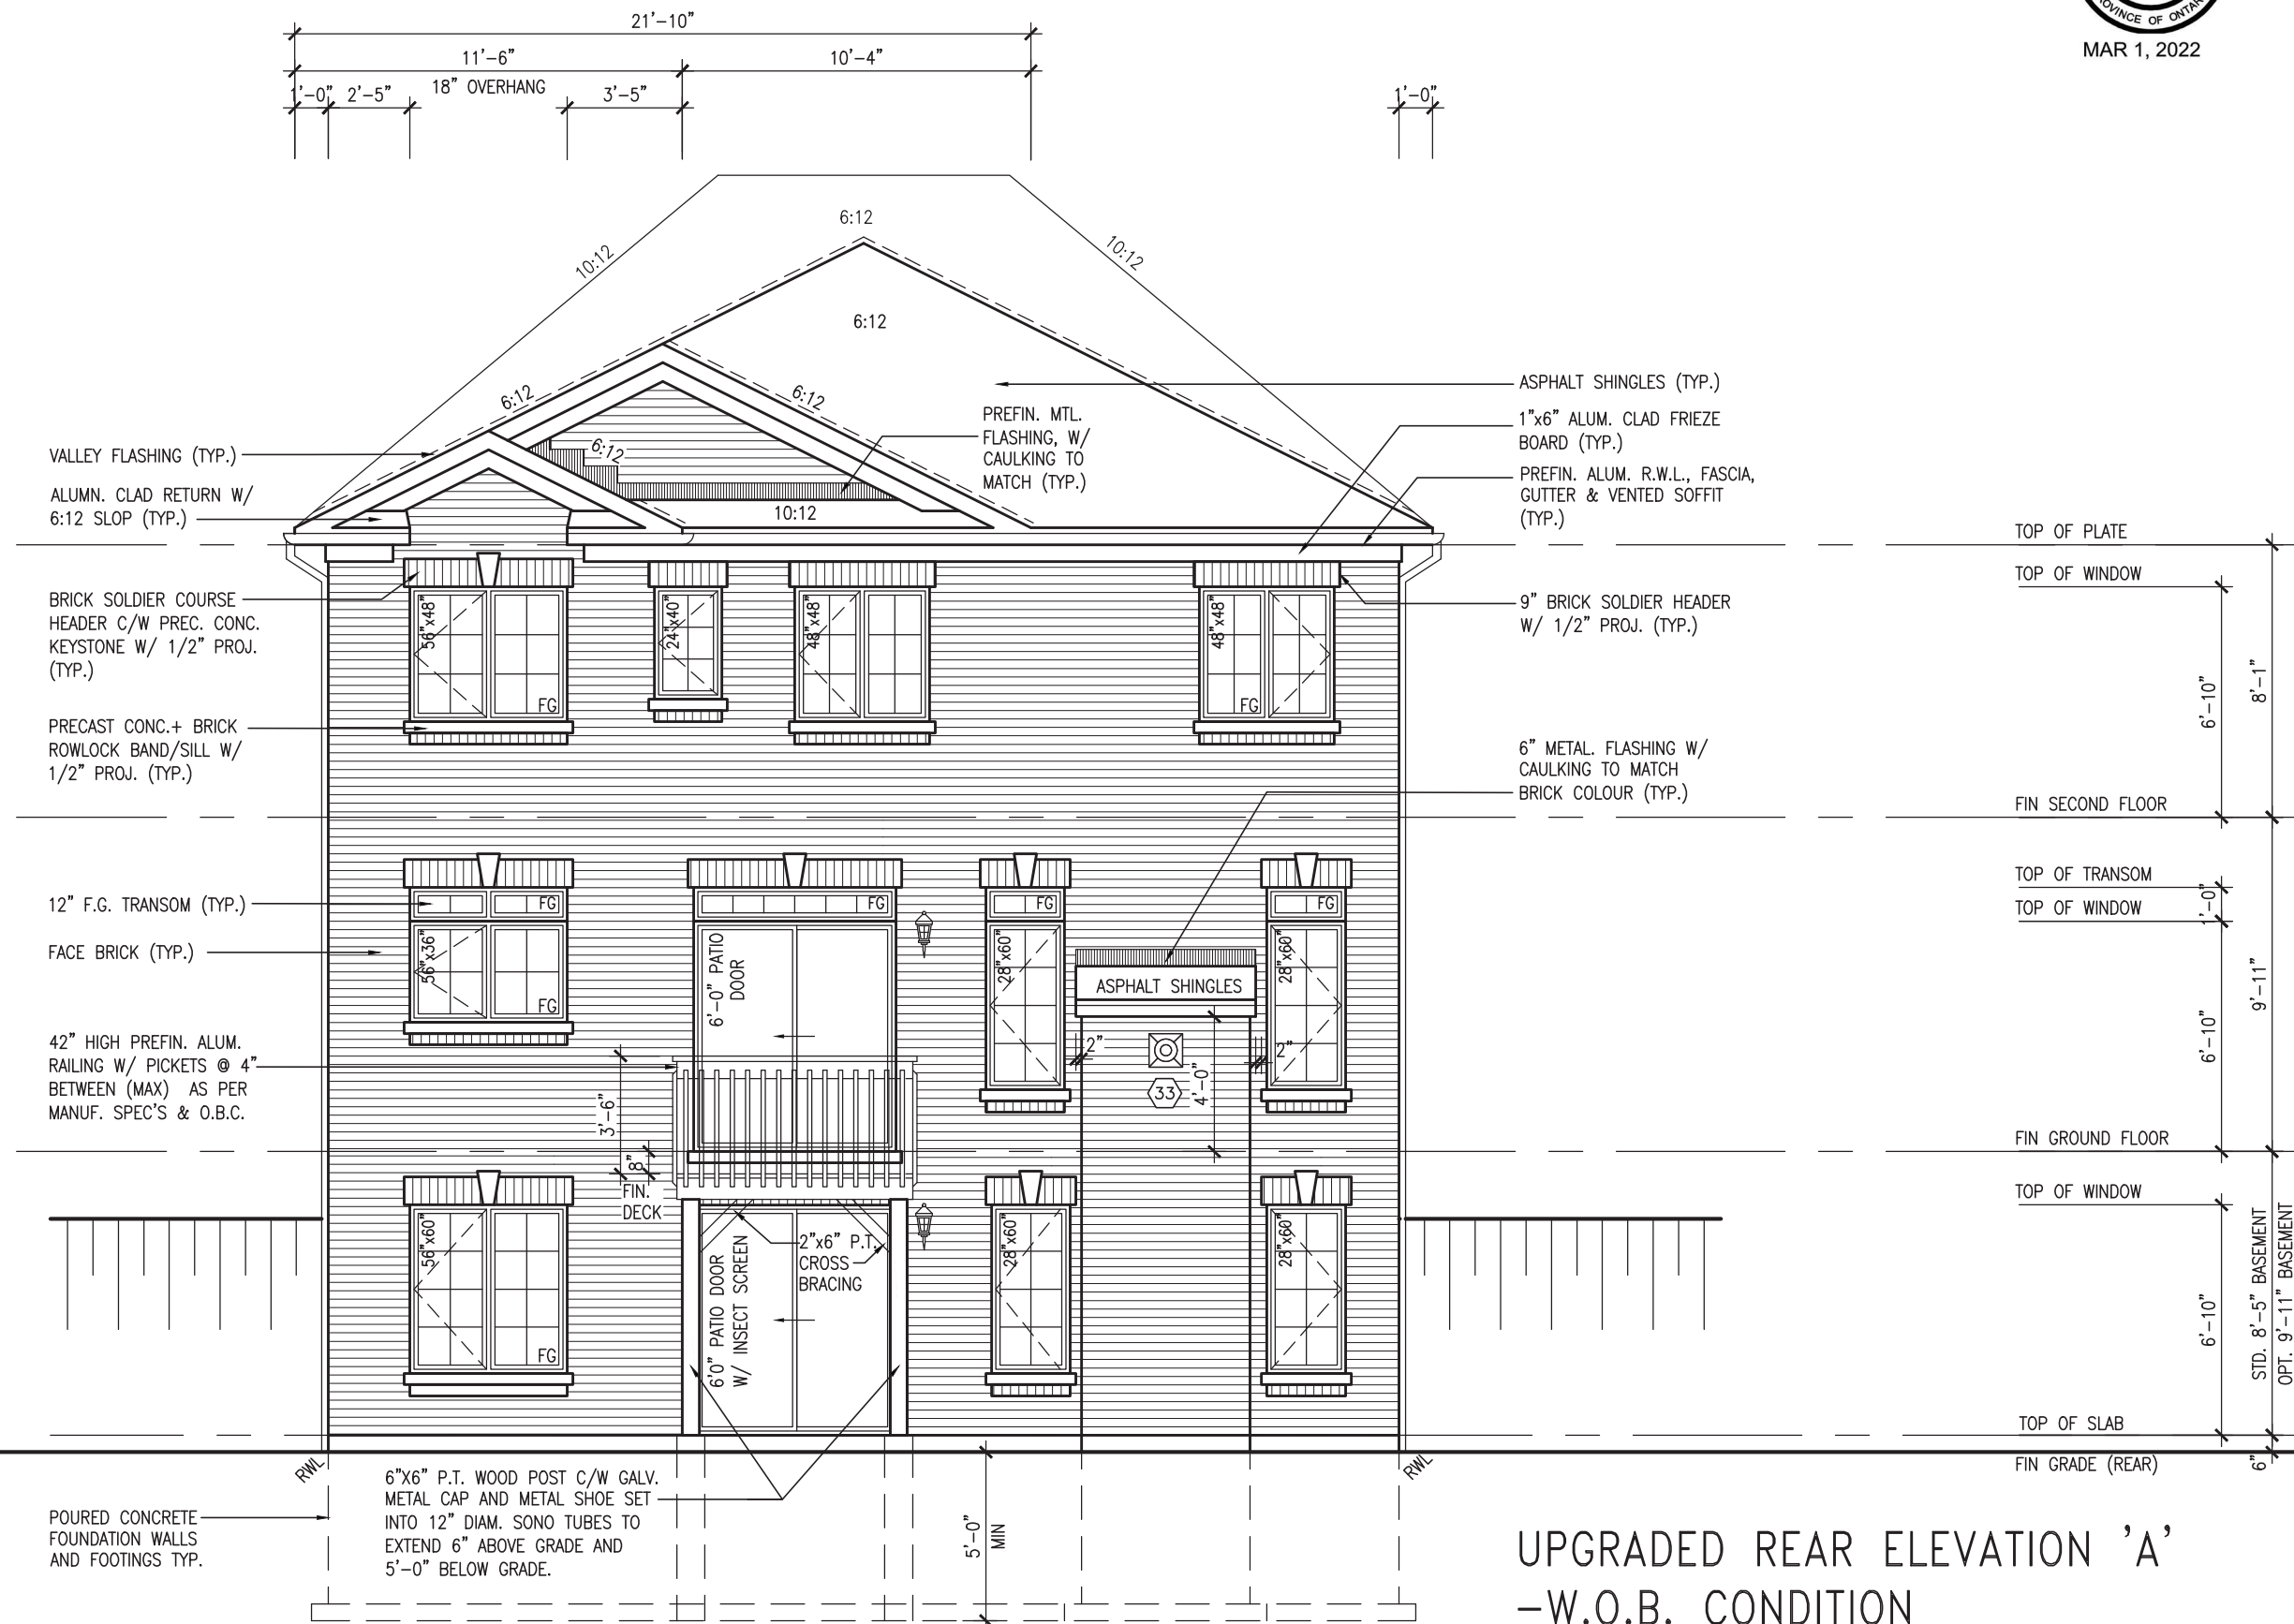

UPGRADED REAR ELEVATION 'A'
-W.O.B. CONDITION

S38-20

BAYVIEW WELLINGTON

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| project name | project no. |
| GREEN VALLEY ESTATES | 16023 |
| BRADFORD EAST, ON. | |

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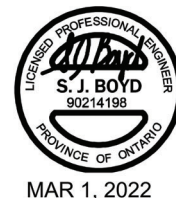
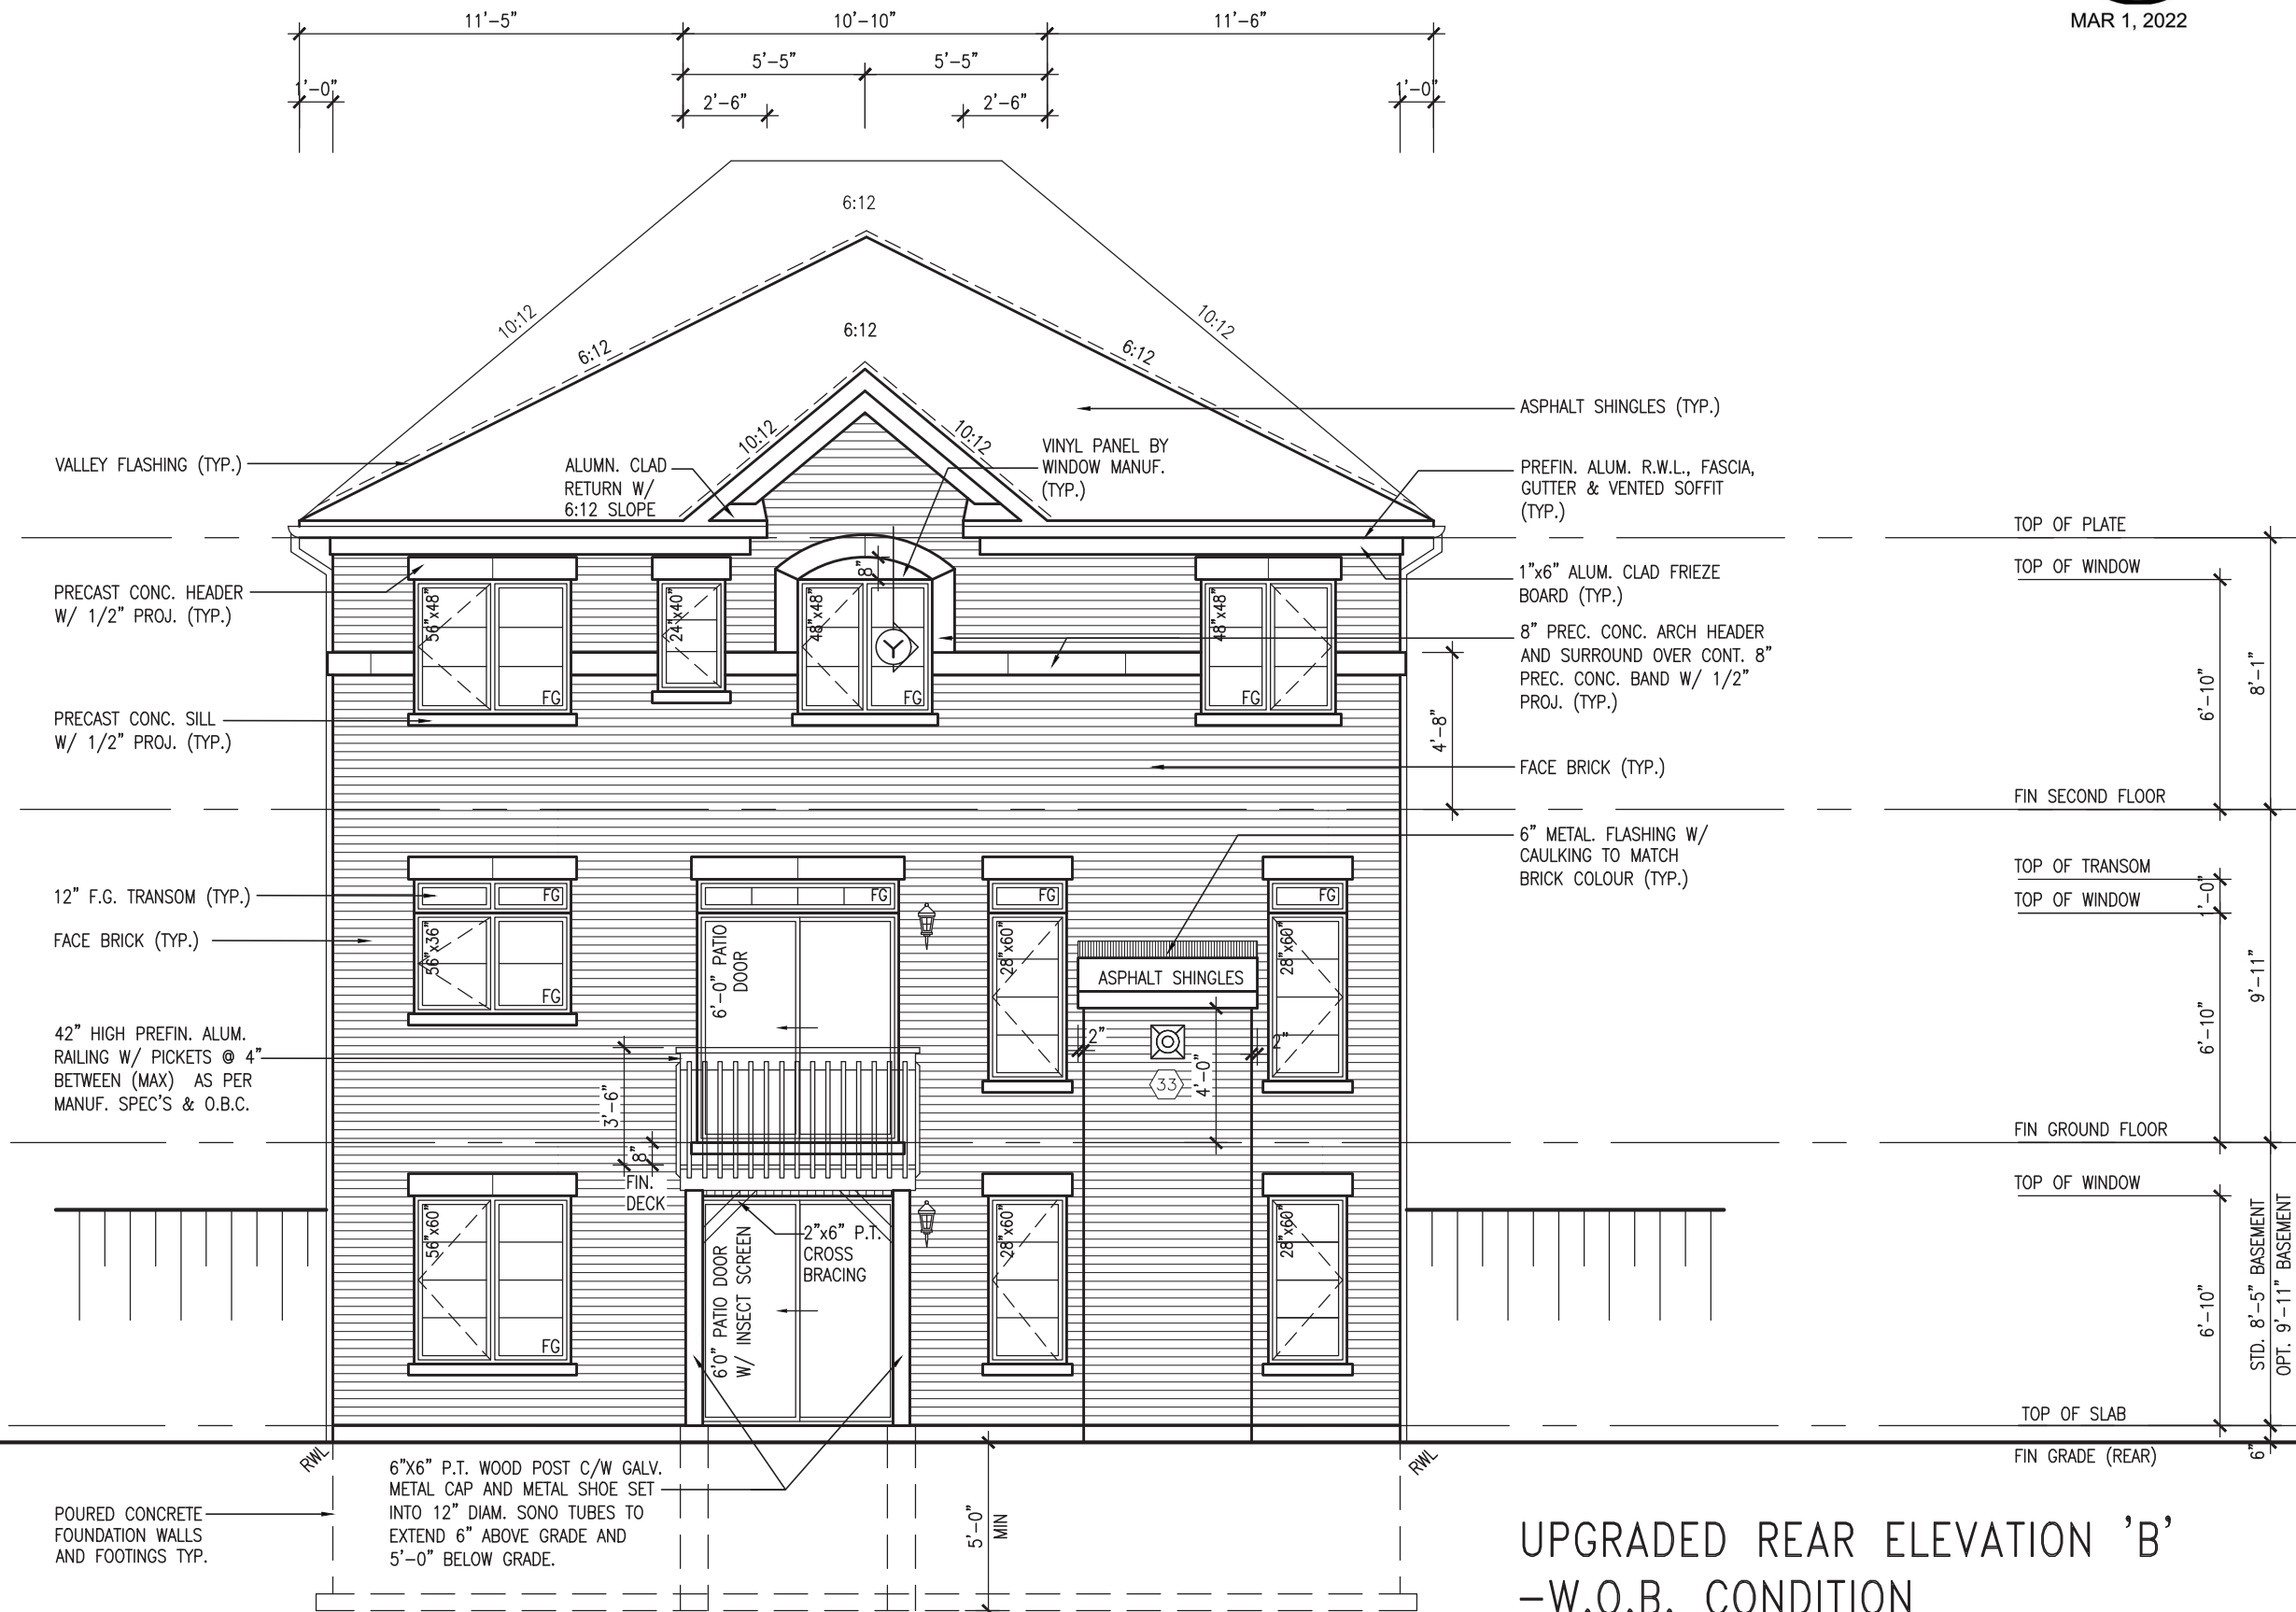
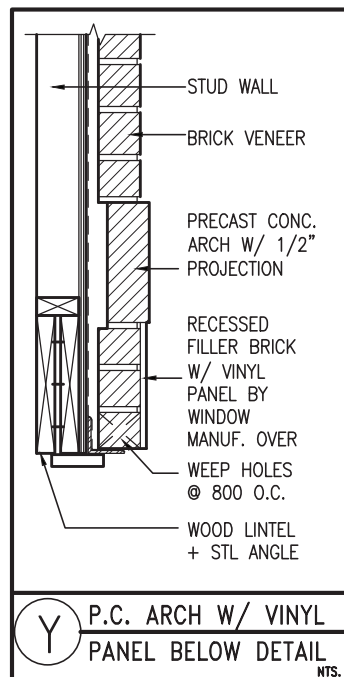
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APPROVED BY: _____
DATE: MAR 03, 2022

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Design Guidelines only and bears no further
professional responsibility.

REFER TO FRONT
ELEVATION FOR TYPICAL
NOTES & INFORMATION



S38-20

BAYVIEW WELLINGTON

| | |
|----------------------|-------------|
| project name | project no. |
| GREEN VALLEY ESTATES | 16023 |
| BRADFORD EAST, ON. | |

DATE: 2024
 TITLE: UPGRADED REAR FLEV 'B' - W O B COND
 DRAWING NO.

| drawn by | checked by | scale | file name |
|------------|------------|----------|-----------|
| SEPT, 2021 | | UNGRADED | UNGRADED |

| NC | JWM | $3/16'' = 1'-0''$ | 16023-S38-20 |
|-----------------------------------|----------------|-------------------|---|
| RICHARD = H- ARCHIVE WORKING 2016 | 16023 BW 1011e | 38" | 16023-S38-20 dwc - Tue = Mar 1 2022 = 2:30 PM |

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DESIGN
Consumers Rd Suite 1
Toronto ON M2J 1R4
416.630.2255 f 416.630.4
va3design.com

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S PER FLOOR / ROOM
R CLIENT REVIEW

ACCEPTED MANUSCRIPT

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This is to certify that these plans comply with the applicable Architectural Design Guidelines approved by the Town of BRADFORD / WEST GWILLIMBURY.

APPROVED BY: _____
DATE: MAR 03, 2022

This stamp certifies compliance with the applicable Design Guidelines only and bears no further professional responsibility.

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ELEVATION FOR TYPICAL
NOTES & INFORMATION



MAR 1, 2022



UPGRADED REAR ELEVATION 'C'
-W.O.B. CONDITION

S38-20

BAYVIEW WELLINGTON

| | | |
|----------------------|--------------------|-------------|
| project name | municipality | project no. |
| GREEN VALLEY ESTATES | BRADFORD EAST. ON. | 16023 |

| date | W A R C O N D | drawing no. |
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| | | | UPGRADED REAR ELEV. C - W.U.B. COND. |

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| NC | JWM | $3/16'' = 1'-0''$ | 16023-S38-20 |
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RICHARD - H:\ARCHIVE\WORKING\2016\16023.BW\Units\38\16023-S38-20.dwg - Tue - Mar 1 2022 - 2:39 PM



DESIGN

DESIGN
255 Consumers Rd Suite 120
Toronto ON M2J 1R4
416.630.2255 f 416.630.4782
www.vazdesign.com

va5design.com

he undersigned has reviewed and takes responsibility for this design and has the qualifications and meets the requirements set out in the Ontario Building Code to be a Designer.

Qualification information

Handwritten signature

Wellington John-Baptiste

name _____ signature _____

42658
V.A.3 Design Inc
Registration Information[illegible]

Contractor must verify all dimensions on the job and report any

drawings and specifications are instruments of service and the property of the Designer before proceeding with the work. All drawings and specifications are instruments of service and the property of the Designer before proceeding with the work. All drawings and specifications are instruments of service and the property of the Designer before proceeding with the work.

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Drawings are not to be scaled.

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| UNINSULATED OPENINGS (PER OBC. SB-12,3.1.1(7)) | | | | | UNINSULATED OPENINGS (PER OBC. SB-12,3.1.1(7)) | | | | | UNINSULATED OPENINGS (PER OBC. SB-12,3.1.1(7)) | | | | | | | |
|--|--|-------------|------------------------------|--------------|--|---------------------------------------|--|------------|------------------------------|--|------------|-------------------------------|--|---------|------------------------------|--------------|------------|
| STANDARD & REAR UPGRADE STD SEC. FL. | S38-20 ELEVATION A | | ENERGY EFFICIENCY – OBC SB12 | | | STANDARD & REAR UPGRADE STD SEC. FL. | S38-20 ELEVATION B | | ENERGY EFFICIENCY – OBC SB12 | | | STANDARD REAR & STD SEC. FL. | S38-20 ELEVATION C | | ENERGY EFFICIENCY – OBC SB12 | | |
| | ELEVATION | | WALL AREA S.F. | OPENING S.F. | PERCENTAGE | | ELEVATION | | WALL AREA S.F. | OPENING S.F. | PERCENTAGE | | ELEVATION | | WALL AREA S.F. | OPENING S.F. | PERCENTAGE |
| | FRONT | | 645 S.F. | 136.22 S.F. | 21.12 % | | FRONT | | 656 S.F. | 138.22 S.F. | 21.07 % | | FRONT | | 643 S.F. | 156.22 S.F. | 24.30 % |
| | LEFT SIDE | | 1213 S.F. | 90.67 S.F. | 7.47 % | | LEFT SIDE | | 1213 S.F. | 90.67 S.F. | 7.47 % | | LEFT SIDE | | 1252 S.F. | 90.67 S.F. | 7.24 % |
| | RIGHT SIDE | | 1200 S.F. | 74.00 S.F. | 6.17 % | | RIGHT SIDE | | 1200 S.F. | 74.00 S.F. | 6.17 % | | RIGHT SIDE | | 1218 S.F. | 74.00 S.F. | 6.08 % |
| | REAR | | 635 S.F. | 157.86 S.F. | 24.86 % | | REAR | | 635 S.F. | 157.86 S.F. | 24.86 % | | REAR | | 635 S.F. | 157.86 S.F. | 24.86 % |
| | * OPENINGS OMITTED AS PER SB-12 3.1.1.9(4) MAX 19.9 S.F. REFER TO ELEVATION FOR LOCATION | | | 0.00 S.F. | | | * OPENINGS OMITTED AS PER SB-12 3.1.1.9(4) MAX 19.9 S.F. REFER TO ELEVATION FOR LOCATION | | | 0.00 S.F. | | | * OPENINGS OMITTED AS PER SB-12 3.1.1.9(4) MAX 19.9 S.F. REFER TO ELEVATION FOR LOCATION | | | 0.00 S.F. | |
| | TOTAL SQ. FT. | | 3693.00 S.F. | 458.75 S.F. | 12.42 % | | TOTAL SQ. FT. | | 3704.00 S.F. | 460.75 S.F. | 12.44 % | | TOTAL SQ. FT. | | 3748.00 S.F. | 478.75 S.F. | 12.77 % |
| TOTAL SQ. M. | | 343.09 S.M. | 42.62 S.M. | 12.42 % | TOTAL SQ. M. | | 344.11 S.M. | 42.80 S.M. | 12.44 % | TOTAL SQ. M. | | 348.20 S.M. | 44.48 S.M. | 12.77 % | | | |
| UNINSULATED OPENINGS (PER OBC. SB-12,3.1.1(7)) | | | | | UNINSULATED OPENINGS (PER OBC. SB-12,3.1.1(7)) | | | | | UNINSULATED OPENINGS (PER OBC. SB-12,3.1.1(7)) | | | | | | | |
| STANDARD & REAR UPGRADE OPT. SEC. FL. | S38-20 ELEVATION A | | ENERGY EFFICIENCY – OBC SB12 | | | STANDARD & REAR UPGRADE OPT. SEC. FL. | S38-20 ELEVATION B | | ENERGY EFFICIENCY – OBC SB12 | | | STANDARD REAR & OPT. SEC. FL. | S38-20 ELEVATION C | | ENERGY EFFICIENCY – OBC SB12 | | |
| | ELEVATION | | WALL AREA S.F. | OPENING S.F. | PERCENTAGE | | ELEVATION | | WALL AREA S.F. | OPENING S.F. | PERCENTAGE | | ELEVATION | | WALL AREA S.F. | OPENING S.F. | PERCENTAGE |
| | FRONT | | 645 S.F. | 136.22 S.F. | 21.12 % | | FRONT | | 656 S.F. | 138.22 S.F. | 21.07 % | | FRONT | | 643 S.F. | 156.22 S.F. | 24.30 % |
| | LEFT SIDE | | 1213 S.F. | 90.67 S.F. | 7.47 % | | LEFT SIDE | | 1213 S.F. | 90.67 S.F. | 7.47 % | | LEFT SIDE | | 1253 S.F. | 90.67 S.F. | 7.24 % |
| | RIGHT SIDE | | 1200 S.F. | 83.33 S.F. | 6.94 % | | RIGHT SIDE | | 1200 S.F. | 83.33 S.F. | 6.94 % | | RIGHT SIDE | | 1218 S.F. | 83.33 S.F. | 6.84 % |
| | REAR | | 635 S.F. | 157.86 S.F. | 24.86 % | | REAR | | 635 S.F. | 157.86 S.F. | 24.86 % | | REAR | | 635 S.F. | 157.86 S.F. | 24.86 % |
| | * OPENINGS OMITTED AS PER SB-12 3.1.1.9(4) MAX 19.9 S.F. REFER TO ELEVATION FOR LOCATION | | | 0.00 S.F. | | | * OPENINGS OMITTED AS PER SB-12 3.1.1.9(4) MAX 19.9 S.F. REFER TO ELEVATION FOR LOCATION | | | 0.00 S.F. | | | * OPENINGS OMITTED AS PER SB-12 3.1.1.9(4) MAX 19.9 S.F. REFER TO ELEVATION FOR LOCATION | | | 0.00 S.F. | |
| | TOTAL SQ. FT. | | 3693.00 S.F. | 468.08 S.F. | 12.67 % | | TOTAL SQ. FT. | | 3704.00 S.F. | 470.08 S.F. | 12.69 % | | TOTAL SQ. FT. | | 3749.00 S.F. | 488.08 S.F. | 13.02 % |
| TOTAL SQ. M. | | 343.09 S.M. | 43.49 S.M. | 12.67 % | TOTAL SQ. M. | | 344.11 S.M. | 43.67 S.M. | 12.69 % | TOTAL SQ. M. | | 348.29 S.M. | 45.34 S.M. | 13.02 % | | | |

| UNINSULATED OPENINGS (PER OBC. SB-12,3.1.1(7)) | | | | | UNINSULATED OPENINGS (PER OBC. SB-12,3.1.1(7)) | | | | | UNINSULATED OPENINGS (PER OBC. SB-12,3.1.1(7)) | | | | | | | |
|--|--|-------------|------------------------------|--------------|--|---------------------------------------|--|------------|------------------------------|--|------------|-------------------------------|--|---------|------------------------------|--------------|------------|
| STANDARD & REAR UPGRADE STD SEC. FL. | S38-20 ELEVATION A WOD | | ENERGY EFFICIENCY – OBC SB12 | | | STANDARD & REAR UPGRADE STD SEC. FL. | S38-20 ELEVATION B WOD | | ENERGY EFFICIENCY – OBC SB12 | | | STANDARD REAR & STD SEC. FL. | S38-20 ELEVATION C WOD | | ENERGY EFFICIENCY – OBC SB12 | | |
| | ELEVATION | | WALL AREA S.F. | OPENING S.F. | PERCENTAGE | | ELEVATION | | WALL AREA S.F. | OPENING S.F. | PERCENTAGE | | ELEVATION | | WALL AREA S.F. | OPENING S.F. | PERCENTAGE |
| | FRONT | | 645 S.F. | 136.22 S.F. | 21.12 % | | FRONT | | 656 S.F. | 138.22 S.F. | 21.07 % | | FRONT | | 643 S.F. | 156.22 S.F. | 24.30 % |
| | LEFT SIDE | | 1213 S.F. | 90.67 S.F. | 7.47 % | | LEFT SIDE | | 1213 S.F. | 90.67 S.F. | 7.47 % | | LEFT SIDE | | 1252 S.F. | 90.67 S.F. | 7.24 % |
| | RIGHT SIDE | | 1200 S.F. | 74.00 S.F. | 6.17 % | | RIGHT SIDE | | 1200 S.F. | 74.00 S.F. | 6.17 % | | RIGHT SIDE | | 1218 S.F. | 74.00 S.F. | 6.08 % |
| | REAR | | 762 S.F. | 182.11 S.F. | 23.90 % | | REAR | | 762 S.F. | 182.11 S.F. | 23.90 % | | REAR | | 762 S.F. | 182.11 S.F. | 23.90 % |
| | * OPENINGS OMITTED AS PER SB-12 3.1.1.9(4) MAX 19.9 S.F. REFER TO ELEVATION FOR LOCATION | | | 0.00 S.F. | | | * OPENINGS OMITTED AS PER SB-12 3.1.1.9(4) MAX 19.9 S.F. REFER TO ELEVATION FOR LOCATION | | | 0.00 S.F. | | | * OPENINGS OMITTED AS PER SB-12 3.1.1.9(4) MAX 19.9 S.F. REFER TO ELEVATION FOR LOCATION | | | 0.00 S.F. | |
| | TOTAL SQ. FT. | | 3820.00 S.F. | 483.00 S.F. | 12.64 % | | TOTAL SQ. FT. | | 3831.00 S.F. | 485.00 S.F. | 12.66 % | | TOTAL SQ. FT. | | 3875.00 S.F. | 503.00 S.F. | 12.98 % |
| TOTAL SQ. M. | | 354.89 S.M. | 44.87 S.M. | 12.64 % | TOTAL SQ. M. | | 355.91 S.M. | 45.06 S.M. | 12.66 % | TOTAL SQ. M. | | 360.00 S.M. | 46.73 S.M. | 12.98 % | | | |
| UNINSULATED OPENINGS (PER OBC. SB-12,3.1.1(7)) | | | | | UNINSULATED OPENINGS (PER OBC. SB-12,3.1.1(7)) | | | | | UNINSULATED OPENINGS (PER OBC. SB-12,3.1.1(7)) | | | | | | | |
| STANDARD & REAR UPGRADE OPT. SEC. FL. | S38-20 ELEVATION A WOD | | ENERGY EFFICIENCY – OBC SB12 | | | STANDARD & REAR UPGRADE OPT. SEC. FL. | S38-20 ELEVATION B WOD | | ENERGY EFFICIENCY – OBC SB12 | | | STANDARD REAR & OPT. SEC. FL. | S38-20 ELEVATION C WOD | | ENERGY EFFICIENCY – OBC SB12 | | |
| | ELEVATION | | WALL AREA S.F. | OPENING S.F. | PERCENTAGE | | ELEVATION | | WALL AREA S.F. | OPENING S.F. | PERCENTAGE | | ELEVATION | | WALL AREA S.F. | OPENING S.F. | PERCENTAGE |
| | FRONT | | 645 S.F. | 136.22 S.F. | 21.12 % | | FRONT | | 656 S.F. | 138.22 S.F. | 21.07 % | | FRONT | | 643 S.F. | 156.22 S.F. | 24.30 % |
| | LEFT SIDE | | 1213 S.F. | 90.67 S.F. | 7.47 % | | LEFT SIDE | | 1213 S.F. | 90.67 S.F. | 7.47 % | | LEFT SIDE | | 1253 S.F. | 90.67 S.F. | 7.24 % |
| | RIGHT SIDE | | 1200 S.F. | 83.33 S.F. | 6.94 % | | RIGHT SIDE | | 1200 S.F. | 83.33 S.F. | 6.94 % | | RIGHT SIDE | | 1218 S.F. | 83.33 S.F. | 6.84 % |
| | REAR | | 762 S.F. | 182.11 S.F. | 23.90 % | | REAR | | 762 S.F. | 182.11 S.F. | 23.90 % | | REAR | | 762 S.F. | 182.11 S.F. | 23.90 % |
| | * OPENINGS OMITTED AS PER SB-12 3.1.1.9(4) MAX 19.9 S.F. REFER TO ELEVATION FOR LOCATION | | | 0.00 S.F. | | | * OPENINGS OMITTED AS PER SB-12 3.1.1.9(4) MAX 19.9 S.F. REFER TO ELEVATION FOR LOCATION | | | 0.00 S.F. | | | * OPENINGS OMITTED AS PER SB-12 3.1.1.9(4) MAX 19.9 S.F. REFER TO ELEVATION FOR LOCATION | | | 0.00 S.F. | |
| | TOTAL SQ. FT. | | 3820.00 S.F. | 492.33 S.F. | 12.89 % | | TOTAL SQ. FT. | | 3831.00 S.F. | 494.33 S.F. | 12.90 % | | TOTAL SQ. FT. | | 3876.00 S.F. | 512.33 S.F. | 13.22 % |
| TOTAL SQ. M. | | 354.89 S.M. | 45.74 S.M. | 12.89 % | TOTAL SQ. M. | | 355.91 S.M. | 45.92 S.M. | 12.90 % | TOTAL SQ. M. | | 360.09 S.M. | 47.60 S.M. | 13.22 % | | | |

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3 REVISED AS PER ENG COMMENTS

2 REVISED AS PER FLOOR / ROOF LAYOUTS

1 ISSUED FOR CLIENT REVIEW

no. description

no. description

date

by

MAR 01-22 RC

FEB 24-22 RC

NOV 23-21 VA3

The undersigned has reviewed and takes responsibility for this design and has the qualifications and meets the requirements set out in the Ontario Building Code to be a Designer.

qualification information

Wellington Jno-Baptiste

name

registration information

VA3 Design Inc.

signature

25591 BCIN

42658

Contractor must verify all dimensions on the job and report any discrepancy to the Designer before proceeding with the work. All drawings and specifications are instruments of service and the property of the Designer which must be returned at the completion of the work. Drawings are not to be scaled.

25591 BCIN

42658

VA3 DESIGN

255 Consumers Rd, Suite 120

Toronto, ON M2J 1R4

t 416.630.2255 f 416.630.4782

vo3design.com

BAYVIEW WELLINGTON

S38-20

project name

GREEN VALLEY ESTATES

municipality

BRADFORD EAST, ON.

project no.

16023

date

SEPT. 2021

drawn by

NC

checked by

JWM

scale

3/16" = 1'-0"

drawing no.

32

file name

16023-S38-20

UPGRADED REAR ELEV. 'C' – W.O.B. COND.

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| UNINSULATED OPENINGS (PER OBC. SB-12,3.1.1(7)) | | | | | UNINSULATED OPENINGS (PER OBC. SB-12,3.1.1(7)) | | | | | UNINSULATED OPENINGS (PER OBC. SB-12,3.1.1(7)) | | | | | | | |
|--|--|-------------|------------------------------|--------------|--|---------------------------------------|--|------------|------------------------------|--|------------|-------------------------------|--|---------|------------------------------|--------------|------------|
| STANDARD & REAR UPGRADE STD SEC. FL. | S38-20 ELEVATION A WOB | | ENERGY EFFICIENCY – OBC SB12 | | | STANDARD & REAR UPGRADE STD SEC. FL. | S38-20 ELEVATION B WOB | | ENERGY EFFICIENCY – OBC SB12 | | | STANDARD REAR & STD SEC. FL. | S38-20 ELEVATION C WOB | | ENERGY EFFICIENCY – OBC SB12 | | |
| | ELEVATION | | WALL AREA S.F. | OPENING S.F. | PERCENTAGE | | ELEVATION | | WALL AREA S.F. | OPENING S.F. | PERCENTAGE | | ELEVATION | | WALL AREA S.F. | OPENING S.F. | PERCENTAGE |
| | FRONT | | 645 S.F. | 136.22 S.F. | 21.12 % | | FRONT | | 656 S.F. | 138.22 S.F. | 21.07 % | | FRONT | | 643 S.F. | 156.22 S.F. | 24.30 % |
| | LEFT SIDE | | 1213 S.F. | 90.67 S.F. | 7.47 % | | LEFT SIDE | | 1213 S.F. | 90.67 S.F. | 7.47 % | | LEFT SIDE | | 1252 S.F. | 90.67 S.F. | 7.24 % |
| | RIGHT SIDE | | 1200 S.F. | 74.00 S.F. | 6.17 % | | RIGHT SIDE | | 1200 S.F. | 74.00 S.F. | 6.17 % | | RIGHT SIDE | | 1218 S.F. | 74.00 S.F. | 6.08 % |
| | REAR | | 855 S.F. | 238.67 S.F. | 27.91 % | | REAR | | 855 S.F. | 238.67 S.F. | 27.91 % | | REAR | | 855 S.F. | 238.67 S.F. | 27.91 % |
| | * OPENINGS OMITTED AS PER SB-12 3.1.1.9(4) MAX 19.9 S.F. REFER TO ELEVATION FOR LOCATION | | | 0.00 S.F. | | | * OPENINGS OMITTED AS PER SB-12 3.1.1.9(4) MAX 19.9 S.F. REFER TO ELEVATION FOR LOCATION | | | 0.00 S.F. | | | * OPENINGS OMITTED AS PER SB-12 3.1.1.9(4) MAX 19.9 S.F. REFER TO ELEVATION FOR LOCATION | | | 0.00 S.F. | |
| | TOTAL SQ. FT. | | 3913.00 S.F. | 539.56 S.F. | 13.79 % | | TOTAL SQ. FT. | | 3924.00 S.F. | 541.56 S.F. | 13.80 % | | TOTAL SQ. FT. | | 3968.00 S.F. | 559.56 S.F. | 14.10 % |
| TOTAL SQ. M. | | 363.53 S.M. | 50.13 S.M. | 13.79 % | TOTAL SQ. M. | | 364.55 S.M. | 50.31 S.M. | 13.80 % | TOTAL SQ. M. | | 368.64 S.M. | 51.98 S.M. | 14.10 % | | | |
| UNINSULATED OPENINGS (PER OBC. SB-12,3.1.1(7)) | | | | | UNINSULATED OPENINGS (PER OBC. SB-12,3.1.1(7)) | | | | | UNINSULATED OPENINGS (PER OBC. SB-12,3.1.1(7)) | | | | | | | |
| STANDARD & REAR UPGRADE OPT. SEC. FL. | S38-20 ELEVATION A WOB | | ENERGY EFFICIENCY – OBC SB12 | | | STANDARD & REAR UPGRADE OPT. SEC. FL. | S38-20 ELEVATION B WOB | | ENERGY EFFICIENCY – OBC SB12 | | | STANDARD REAR & OPT. SEC. FL. | S38-20 ELEVATION C WOB | | ENERGY EFFICIENCY – OBC SB12 | | |
| | ELEVATION | | WALL AREA S.F. | OPENING S.F. | PERCENTAGE | | ELEVATION | | WALL AREA S.F. | OPENING S.F. | PERCENTAGE | | ELEVATION | | WALL AREA S.F. | OPENING S.F. | PERCENTAGE |
| | FRONT | | 645 S.F. | 136.22 S.F. | 21.12 % | | FRONT | | 656 S.F. | 138.22 S.F. | 21.07 % | | FRONT | | 643 S.F. | 156.22 S.F. | 24.30 % |
| | LEFT SIDE | | 1213 S.F. | 90.67 S.F. | 7.47 % | | LEFT SIDE | | 1213 S.F. | 90.67 S.F. | 7.47 % | | LEFT SIDE | | 1253 S.F. | 90.67 S.F. | 7.24 % |
| | RIGHT SIDE | | 1200 S.F. | 83.33 S.F. | 6.94 % | | RIGHT SIDE | | 1200 S.F. | 83.33 S.F. | 6.94 % | | RIGHT SIDE | | 1218 S.F. | 83.33 S.F. | 6.84 % |
| | REAR | | 855 S.F. | 238.67 S.F. | 27.91 % | | REAR | | 855 S.F. | 238.67 S.F. | 27.91 % | | REAR | | 855 S.F. | 268.67 S.F. | 31.42 % |
| | * OPENINGS OMITTED AS PER SB-12 3.1.1.9(4) MAX 19.9 S.F. REFER TO ELEVATION FOR LOCATION | | | 0.00 S.F. | | | * OPENINGS OMITTED AS PER SB-12 3.1.1.9(4) MAX 19.9 S.F. REFER TO ELEVATION FOR LOCATION | | | 0.00 S.F. | | | * OPENINGS OMITTED AS PER SB-12 3.1.1.9(4) MAX 19.9 S.F. REFER TO ELEVATION FOR LOCATION | | | 0.00 S.F. | |
| | TOTAL SQ. FT. | | 3913.00 S.F. | 548.89 S.F. | 14.03 % | | TOTAL SQ. FT. | | 3924.00 S.F. | 550.89 S.F. | 14.04 % | | TOTAL SQ. FT. | | 3969.00 S.F. | 598.89 S.F. | 15.09 % |
| TOTAL SQ. M. | | 363.53 S.M. | 50.99 S.M. | 14.03 % | TOTAL SQ. M. | | 364.55 S.M. | 51.18 S.M. | 14.04 % | TOTAL SQ. M. | | 368.73 S.M. | 55.64 S.M. | 15.09 % | | | |

| UNINSULATED OPENINGS (PER OBC. SB-12,3.1.1(7)) | | | | | UNINSULATED OPENINGS (PER OBC. SB-12,3.1.1(7)) | | | | | UNINSULATED OPENINGS (PER OBC. SB-12,3.1.1(7)) | | | | | | | |
|--|--|-------------|------------------------------|--------------|--|------------------------------|--|------------|------------------------------|--|------------|------------------------------|--|---------|------------------------------|--------------|------------|
| UPGRADE REAR & STD SEC. FL. | S38-20 ELEVATION C | | ENERGY EFFICIENCY – OBC SB12 | | | UPGRADE REAR & STD SEC. FL. | S38-20 ELEVATION C WOD | | ENERGY EFFICIENCY – OBC SB12 | | | UPGRADE REAR & STD SEC. FL. | S38-20 ELEVATION C WOB | | ENERGY EFFICIENCY – OBC SB12 | | |
| | ELEVATION | | WALL AREA S.F. | OPENING S.F. | PERCENTAGE | | ELEVATION | | WALL AREA S.F. | OPENING S.F. | PERCENTAGE | | ELEVATION | | WALL AREA S.F. | OPENING S.F. | PERCENTAGE |
| | FRONT | | 643 S.F. | 156.22 S.F. | 24.30 % | | FRONT | | 643 S.F. | 156.22 S.F. | 24.30 % | | FRONT | | 643 S.F. | 156.22 S.F. | 24.30 % |
| | LEFT SIDE | | 1252 S.F. | 90.67 S.F. | 7.24 % | | LEFT SIDE | | 1252 S.F. | 90.67 S.F. | 7.24 % | | LEFT SIDE | | 1252 S.F. | 90.67 S.F. | 7.24 % |
| | RIGHT SIDE | | 1218 S.F. | 74.00 S.F. | 6.08 % | | RIGHT SIDE | | 1218 S.F. | 74.00 S.F. | 6.08 % | | RIGHT SIDE | | 1218 S.F. | 74.00 S.F. | 6.08 % |
| | REAR | | 635 S.F. | 174.78 S.F. | 27.52 % | | REAR | | 762 S.F. | 201.44 S.F. | 26.44 % | | REAR | | 855 S.F. | 259.11 S.F. | 30.31 % |
| | * OPENINGS OMITTED AS PER SB-12 3.1.1.9(4) MAX 19.9 S.F. REFER TO ELEVATION FOR LOCATION | | | 0.00 S.F. | | | * OPENINGS OMITTED AS PER SB-12 3.1.1.9(4) MAX 19.9 S.F. REFER TO ELEVATION FOR LOCATION | | | 0.00 S.F. | | | * OPENINGS OMITTED AS PER SB-12 3.1.1.9(4) MAX 19.9 S.F. REFER TO ELEVATION FOR LOCATION | | | 0.00 S.F. | |
| | TOTAL SQ. FT. | | 3748.00 S.F. | 495.67 S.F. | 13.22 % | | TOTAL SQ. FT. | | 3875.00 S.F. | 522.33 S.F. | 13.48 % | | TOTAL SQ. FT. | | 3968.00 S.F. | 580.00 S.F. | 14.62 % |
| TOTAL SQ. M. | | 348.20 S.M. | 46.05 S.M. | 13.22 % | TOTAL SQ. M. | | 360.00 S.M. | 48.53 S.M. | 13.48 % | TOTAL SQ. M. | | 368.64 S.M. | 53.88 S.M. | 14.62 % | | | |
| UNINSULATED OPENINGS (PER OBC. SB-12,3.1.1(7)) | | | | | UNINSULATED OPENINGS (PER OBC. SB-12,3.1.1(7)) | | | | | UNINSULATED OPENINGS (PER OBC. SB-12,3.1.1(7)) | | | | | | | |
| UPGRADE REAR & OPT. SEC. FL. | S38-20 ELEVATION C | | ENERGY EFFICIENCY – OBC SB12 | | | UPGRADE REAR & OPT. SEC. FL. | S38-20 ELEVATION C WOD | | ENERGY EFFICIENCY – OBC SB12 | | | UPGRADE REAR & OPT. SEC. FL. | S38-20 ELEVATION C WOB | | ENERGY EFFICIENCY – OBC SB12 | | |
| | ELEVATION | | WALL AREA S.F. | OPENING S.F. | PERCENTAGE | | ELEVATION | | WALL AREA S.F. | OPENING S.F. | PERCENTAGE | | ELEVATION | | WALL AREA S.F. | OPENING S.F. | PERCENTAGE |
| | FRONT | | 643 S.F. | 156.22 S.F. | 24.30 % | | FRONT | | 643 S.F. | 156.22 S.F. | 24.30 % | | FRONT | | 643 S.F. | 156.22 S.F. | 24.30 % |
| | LEFT SIDE | | 1253 S.F. | 90.67 S.F. | 7.24 % | | LEFT SIDE | | 1253 S.F. | 90.67 S.F. | 7.24 % | | LEFT SIDE | | 1253 S.F. | 90.67 S.F. | 7.24 % |
| | RIGHT SIDE | | 1218 S.F. | 83.33 S.F. | 6.84 % | | RIGHT SIDE | | 1218 S.F. | 83.33 S.F. | 6.84 % | | RIGHT SIDE | | 1218 S.F. | 83.33 S.F. | 6.84 % |
| | REAR | | 635 S.F. | 174.78 S.F. | 27.52 % | | REAR | | 762 S.F. | 201.44 S.F. | 26.44 % | | REAR | | 855 S.F. | 259.11 S.F. | 30.31 % |
| | * OPENINGS OMITTED AS PER SB-12 3.1.1.9(4) MAX 19.9 S.F. REFER TO ELEVATION FOR LOCATION | | | 0.00 S.F. | | | * OPENINGS OMITTED AS PER SB-12 3.1.1.9(4) MAX 19.9 S.F. REFER TO ELEVATION FOR LOCATION | | | 0.00 S.F. | | | * OPENINGS OMITTED AS PER SB-12 3.1.1.9(4) MAX 19.9 S.F. REFER TO ELEVATION FOR LOCATION | | | 0.00 S.F. | |
| | TOTAL SQ. FT. | | 3749.00 S.F. | 505.00 S.F. | 13.47 % | | TOTAL SQ. FT. | | 3876.00 S.F. | 531.66 S.F. | 13.72 % | | TOTAL SQ. FT. | | 3969.00 S.F. | 589.33 S.F. | 14.85 % |
| TOTAL SQ. M. | | 348.29 S.M. | 46.92 S.M. | 13.47 % | TOTAL SQ. M. | | 360.09 S.M. | 49.39 S.M. | 13.72 % | TOTAL SQ. M. | | 368.73 S.M. | 54.75 S.M. | 14.85 % | | | |

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date

by

REVISIONS

MAR 01-22 RC

FEB 24-22 RC

NOV 23-21 RC

3 REVISED AS PER ENG COMMENTS

2 REVISED AS PER FLOOR / ROOF LAYOUTS

1 ISSUED FOR CLIENT REVIEW

The undersigned has reviewed and takes responsibility for this design and has the qualifications and meets the requirements set out in the Ontario Building Code to be a Designer.

qualification information

Wellington Jno-Baptiste 25591

name registration information VAS Design Inc.

signature

BCIN 42658

Contractor must verify all dimensions on the job and report any discrepancy to the Designer before proceeding with the work. All drawings and specifications are instruments of service and the property of the Designer which must be returned at the completion of the work. Drawings are not to be scaled.

BAYVIEW WELLINGTON

S38-20

project name GREEN VALLEY ESTATES

project no. 16023

municipality BRADFORD EAST, ON.

drawing no. 33

date SEPT. 2021

checked by JWM

drawn by NC

scale 3/16" = 1'-0"

file name 16023-S38-20

16023-S38-20


UPGRADED REAR ELEV. 'C' – W.O.B. COND.

33

VA3 DESIGN

255 Consumers Rd Suite 120 Toronto, ON M2J 1R4 t 416.630.2255 f 416.630.4782 vo3design.com

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10⁹ GROUND

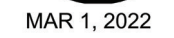
This is to certify that these plans comply with the applicable Architectural Design Guidelines approved by the Town of BRADFORD / WEST GWILLIMBURY.

REFER TO FRONT
ELEVATION FOR TYPICAL
NOTES & INFORMATION

S38-20

BAYVIEW WELLINGTON

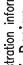

| | | |
|--|--|----------------------|
| name Jno-Baptiste registration information VAA3 Design Inc. | signature  | BCIN 25591 |
|--|--|----------------------|

The undersigned has reviewed and takes responsibility for this design and has the qualifications and meets the requirements set out in the Ontario Building Code to be a designer.

qualification information

I understand that my professional seal will expire on the 31st day of March 2011.

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ROOF LAY


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(FOR WALLS LESS THAN 1.2M (3'-11") FROM THE LOT LINE)
45 MINUTE FIRE RATED WALL
 PROVIDE A CONTINUOUS LAYER OF 12.7mm (1/2") TYPE 'X' GYPSUM BOARD (INTERIOR SIDE) INSTALLED SO THAT ALL EDGES ARE SUPPORTED, TAPED AND FILLED. SPACE BETWEEN WOOD STUDS TO BE FILLED WITH INSULATION CONFORMING TO CAN/ULC-S702, "MINERAL FIBRE THERMAL INSULATION FOR BUILDINGS" WITH A MASS OF NOT LESS THAN 1.22 Kg/SQ.M. AND MUST FILL AT LEAST 90% OF THE CAVITY THICKNESS. THE TYPE 'X' & INSULATION MUST BE RUN CONTINUOUSLY BEHIND ALL INTERSECTING PARTITIONS, MECHANICAL CHASES, BATHTUBS, SHOWERS, ETC. ENSURE INSULATION & TYPE 'X' IS INSTALLED IN GARAGE EXTERIOR WALLS.
 (REFER TO SECTION SB-2 OF OBC 2012-SUPPLEMENTARY STANDARDS)




It is the builder's complete responsibility to ensure that all plans submitted for approval fully comply with the Architectural Guidelines and all applicable regulations and requirements including zoning provisions and any provisions in the subdivision agreement. The Control Architect is not responsible in any way for examining or approving site (lotting) plans or working drawings with respect to any zoning or building code or permit matter or that any house can be properly built or located on its lot.

This is to certify that these plans comply with the applicable Architectural Design Guidelines approved by the Town of BRADFORD / WEST GWILLIMBURY.

JOHN G. WILLIAMS LTD., ARCHITECT
ARCHITECTURAL CONTROL REVIEW
AND APPROVAL
 APPROVED BY: 
 DATE: MAR 03, 2022

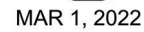This stamp certifies compliance with the applicable Design Guidelines only and bears no further professional responsibility.

REFER TO FRONT
ELEVATION FOR TYPICAL
NOTES & INFORMATION

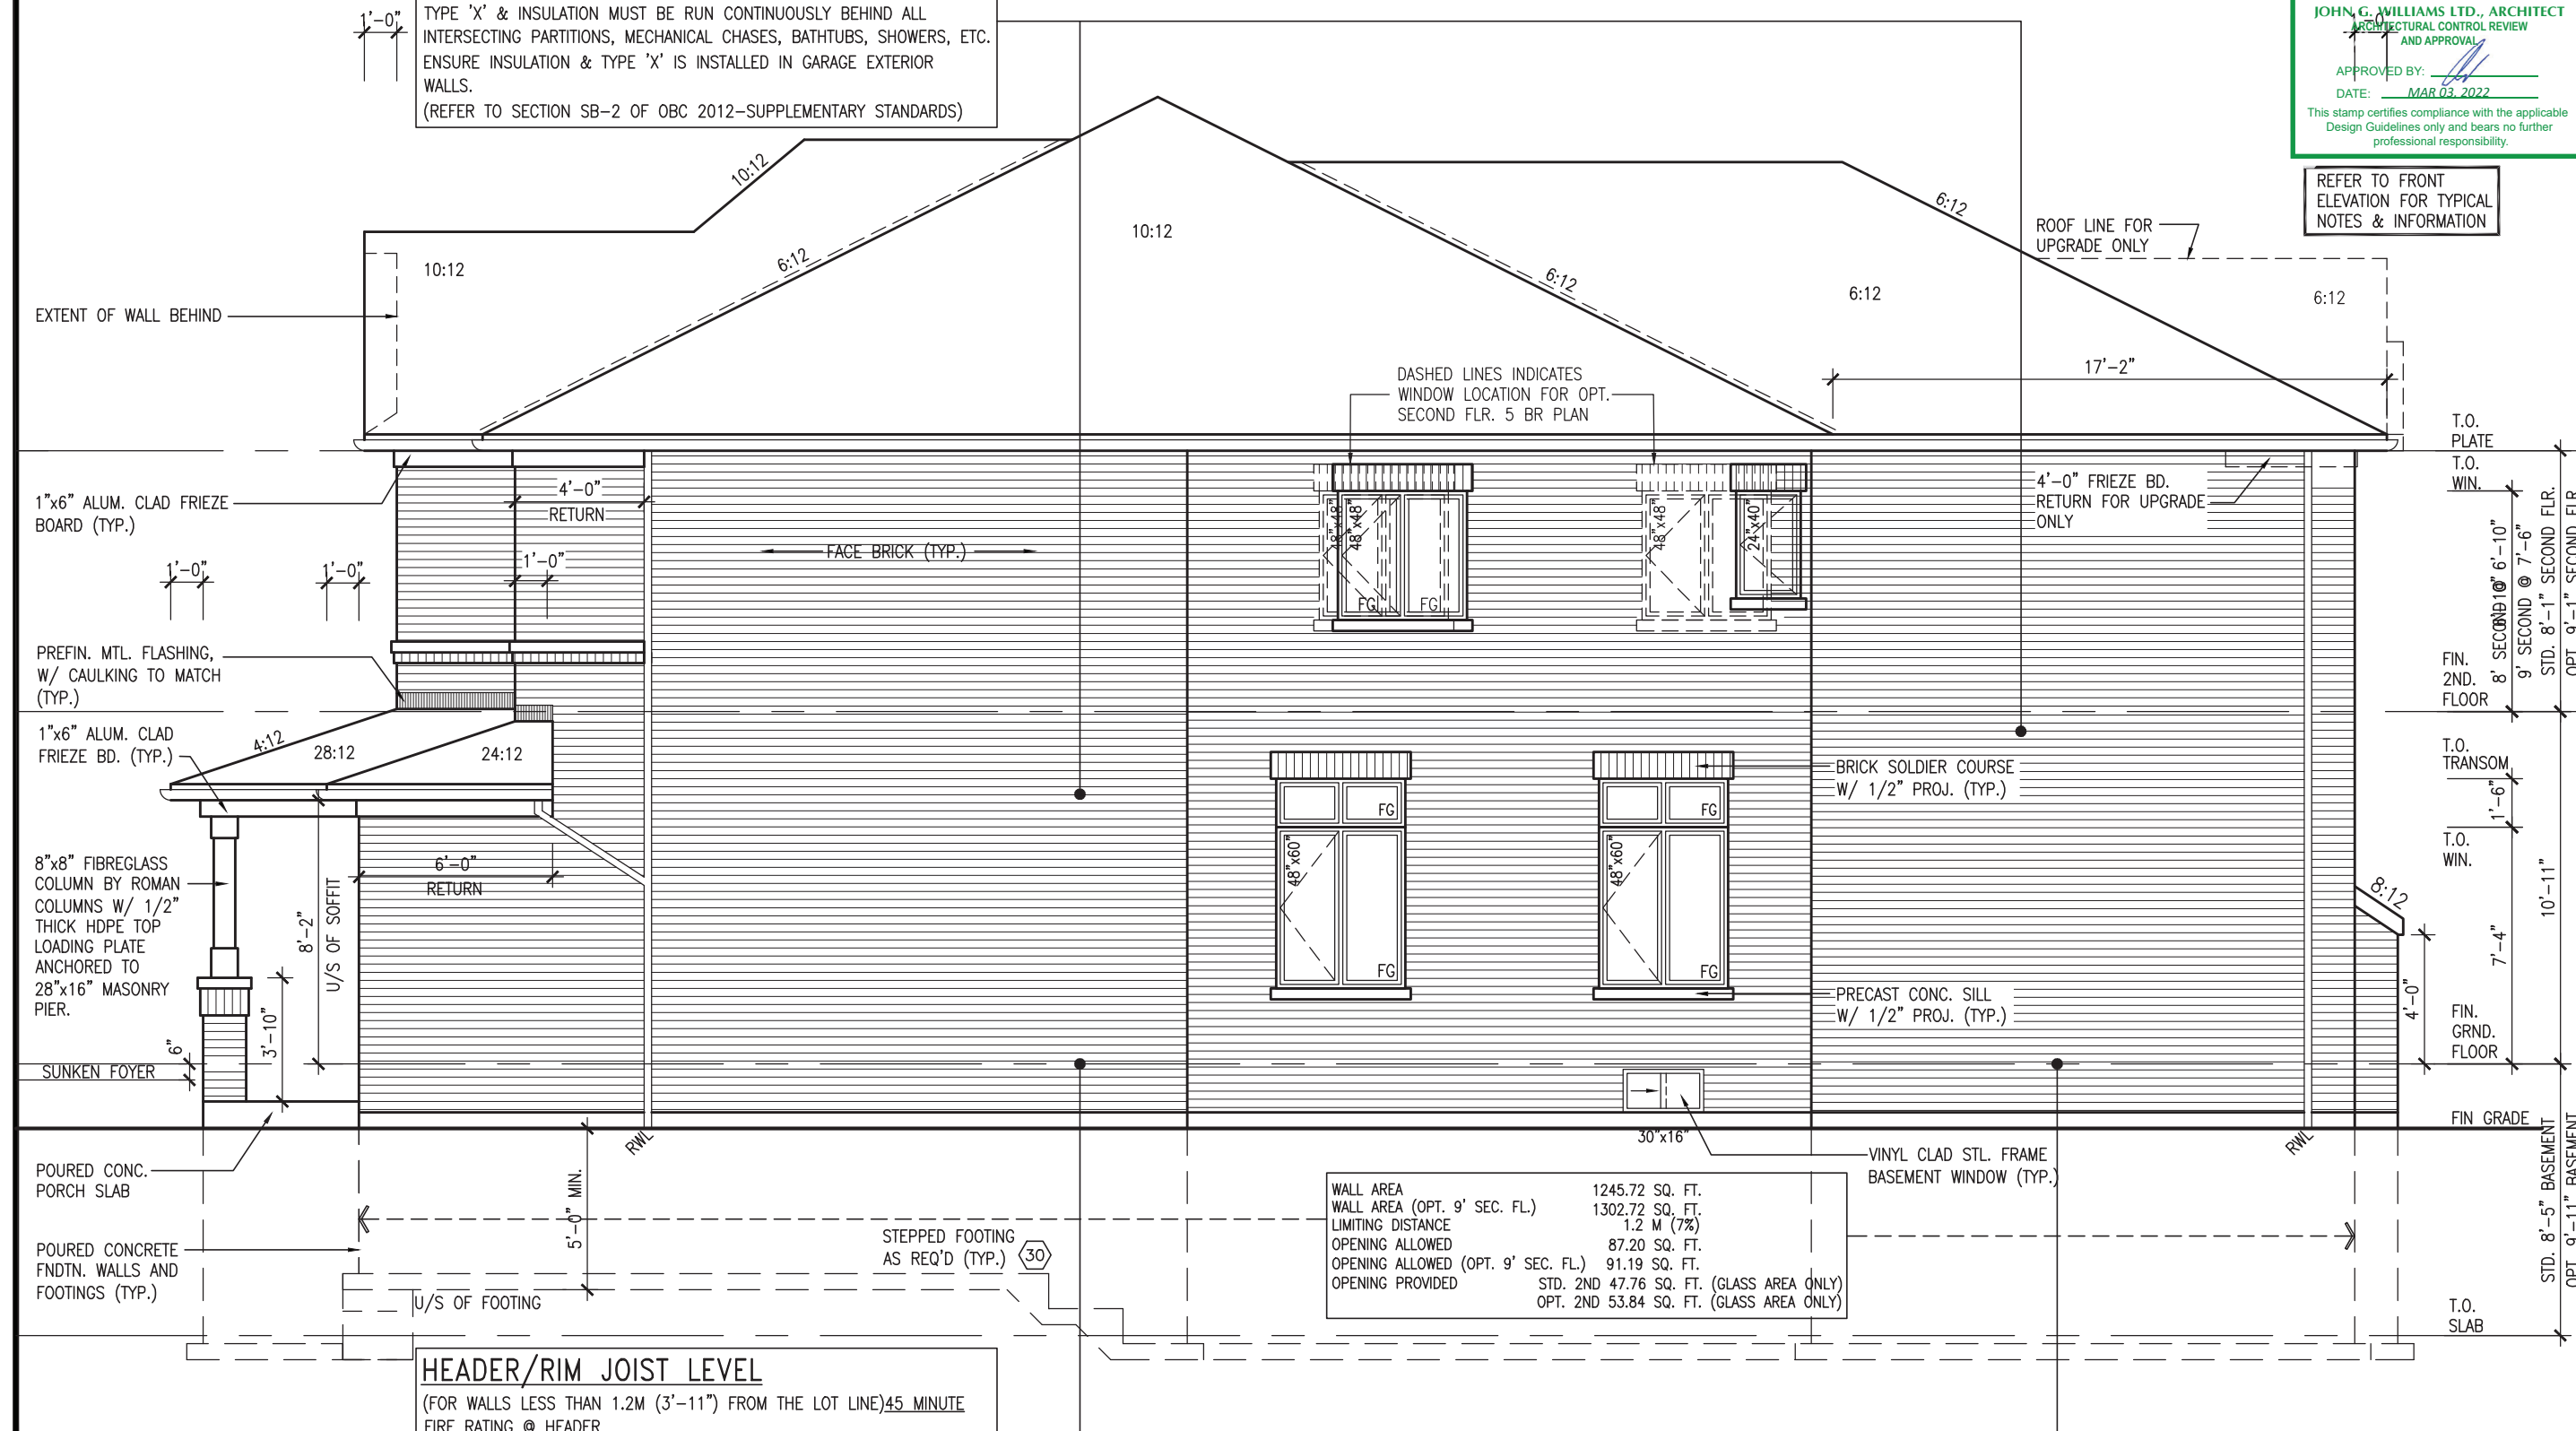

| | | | | | |
|------------------------------------|----------|---------|---------|-------------------|--|
| WALL AREA | 1245.72 | SQ. FT. | | | |
| WALL AREA (OPT. 9' SEC. FL.) | 1302.72 | SQ. FT. | | | |
| LIMITING DISTANCE | 1.2 | M (%) | | | |
| OPENING ALLOWED | 87.20 | SQ. FT. | | | |
| OPENING ALLOWED (OPT. 9' SEC. FL.) | 91.19 | SQ. FT. | | | |
| OPENING PROVIDED | STD. 2ND | 47.76 | SQ. FT. | (GLASS AREA ONLY) | |
| | OPT. 2ND | 53.84 | SQ. FT. | (GLASS AREA ONLY) | |

(FOR WALLS LESS THAN 1.2M (3'-11") FROM THE LOT LINE) 45 MINUTE FIRE RATING @ HEADER

PROVIDE 15.9mm (5/8") TYPE 'X' GYPSUM BOARD BETWEEN FLOOR JOIST AT THE HEADER OR CONTINUOUSLY ALONG THE RIM JOIST WHEN FLOOR JOISTS ARE PARALLEL TO RIM JOIST TO MAINTAIN 45 MINUTE FIRE RATING

RIGHT SIDE ELEVATION 'A'

VA3
DESIGN
15 Consumers Rd Suite
Toronto ON M2J 1R4
16.630.2255 f 416.630.2255
www.va3design.com

I, the undersigned, have reviewed and takes responsibility for this design.
 I understand and has the qualifications and meets the requirements set out in the
 Ontario Building Code to be a Designer.
 qualification information
 Wellington Jno-Baptiste
 signature
 BCIN 25591
 come
 registration information
 VAA3 Design Inc. 42658

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| 3 | REVISED AS PER ENG COMMENTS | MAR 01-22 | RO | |
| 2 | REVISED AS PER FLOOR / ROOF LAYOUTS | FEB 24-22 | RO | |
| 1 | ISSUED FOR CLIENT REVIEW | NOV 26-21 | VA | |

RICHARD = H:\ARCHIVE\WORKING\2016\16023.BW\Units\38\16025-S38-20.dwg - Tue - Mar 1 2022 - 2:39 PM
vovodesign11.com



MAR 1, 2022

10' GROUND

It is the builder's complete responsibility to ensure that all plans submitted for approval fully comply with the Architectural Guidelines and all applicable regulations and requirements including zoning provisions and any provisions in the subdivision agreement. The Control Architect is not responsible in any way for examining or approving site (lotting) plans or working drawings with respect to any zoning or building code or permit matter or that any house can be properly built or located on its lot.

This is to certify that these plans comply with the applicable Architectural Design Guidelines approved by the Town of BRADFORD / WEST GWILLIMBURY.


JOHN G. WILLIAMS LTD., ARCHITECT
ARCHITECTURAL CONTROL REVIEW
AND APPROVAL

APPROVED BY: [Signature]

DATE: MAR 03, 2022

This stamp certifies compliance with the applicable Design Guidelines only and bears no further professional responsibility.

REFER TO FRONT
ELEVATION FOR TYPICAL
NOTES & INFORMATION

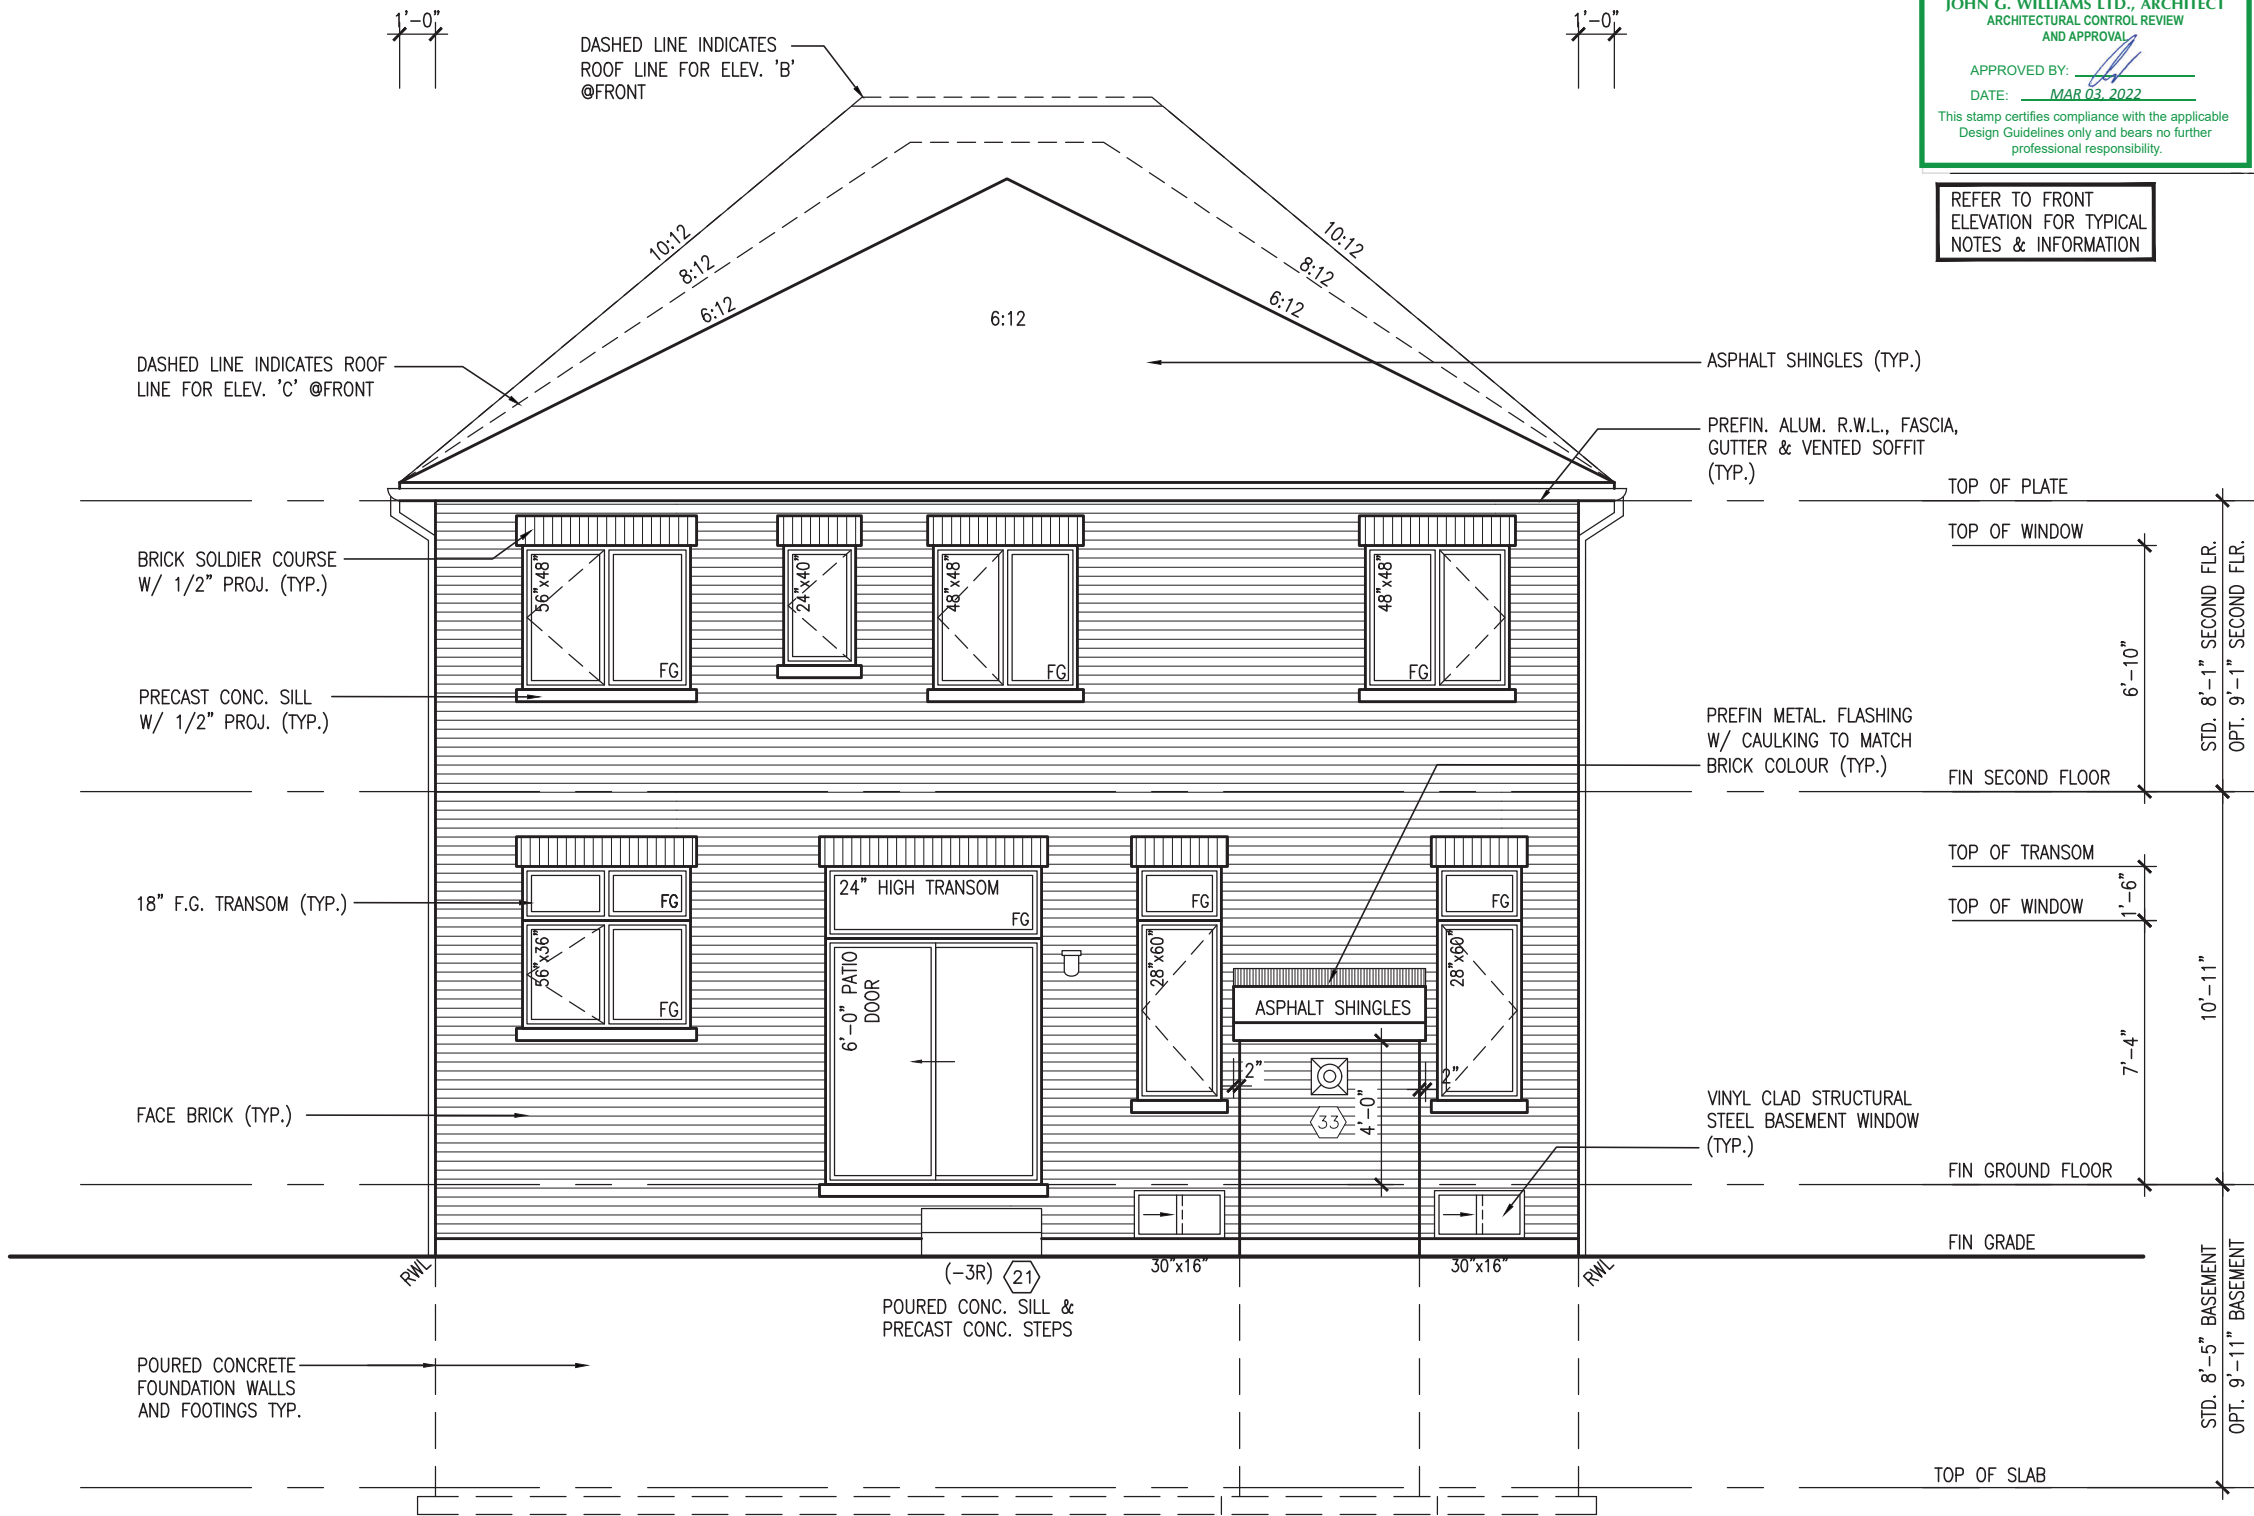

S38-20

BAYVIEW WELLINGTON

VA3 DESIGN

The undersigned has reviewed and takes responsibility for this design and has the qualifications and meets the requirements set out in the Ontario Building Code to be a Designer.

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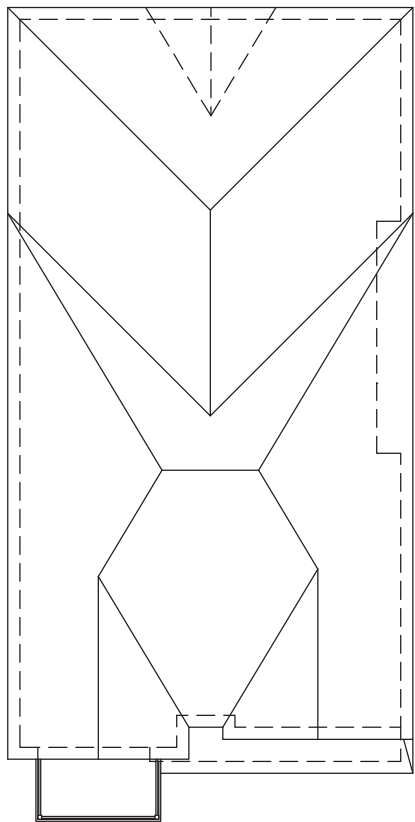
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date by
NOV 26-21 VA3
FEB 24-22 RC
MAR 01-22 RC
REVISED AS PER ENG COMMENTS
CONTRACTOR MUST VERIFY ALL DIMENSIONS ON THE JOB AND REPORT ANY DISCREPANCY TO THE DESIGNER BEFORE PROCEEDING WITH THE WORK. ALL DRAWINGS AND SPECIFICATIONS ARE INSTRUMENTS OF SERVICE AND THE PROPERTY OF THE DESIGNER WHICH MUST BE RETURNED AT THE COMPLETION OF THE WORK. DRAWINGS ARE NOT TO BE SCALED.

255 Consumers Rd, Suite 120
Toronto, ON M2J 1P4
t 416.630.2255 f 416.630.4782
vo3design.com


project name GREEN VALLEY ESTATES
municipality BRADFORD EAST, ON.
date SEPT. 2021
drawn by NC
checked by JWM
scale 3/16" = 1'-0"

project no. 16023
drawing no. 38

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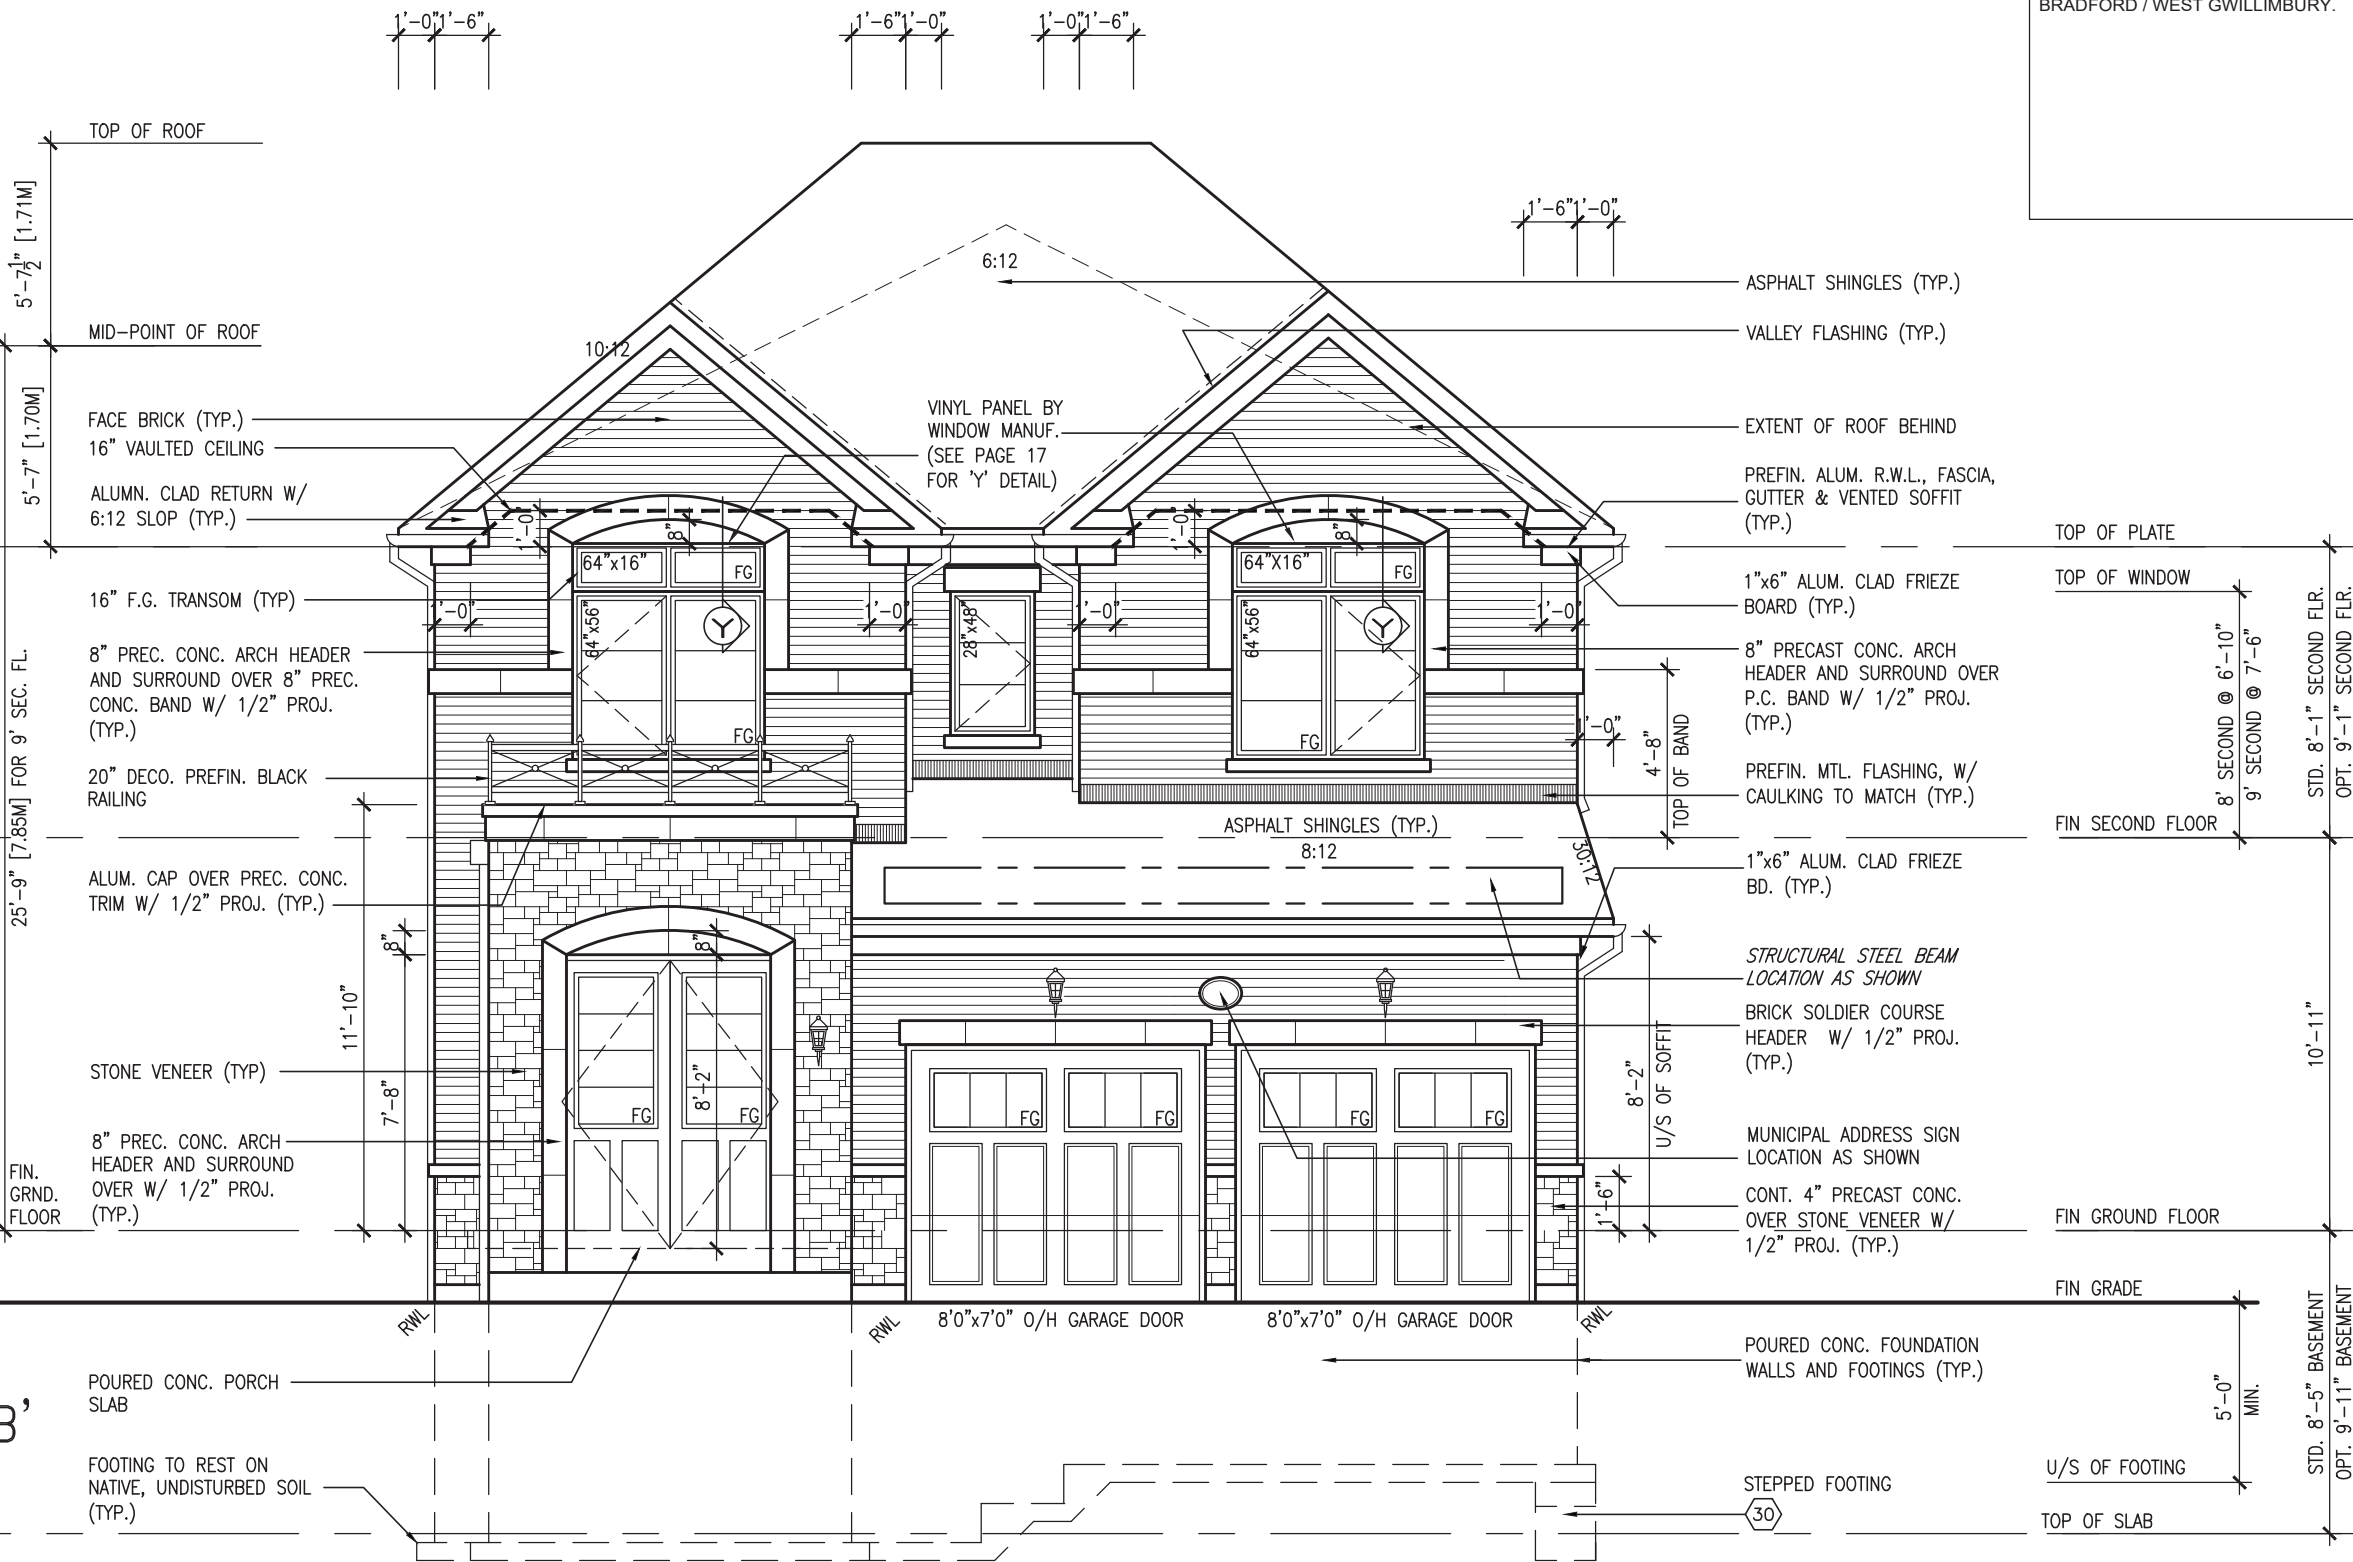


ROOF PLAN 'B'

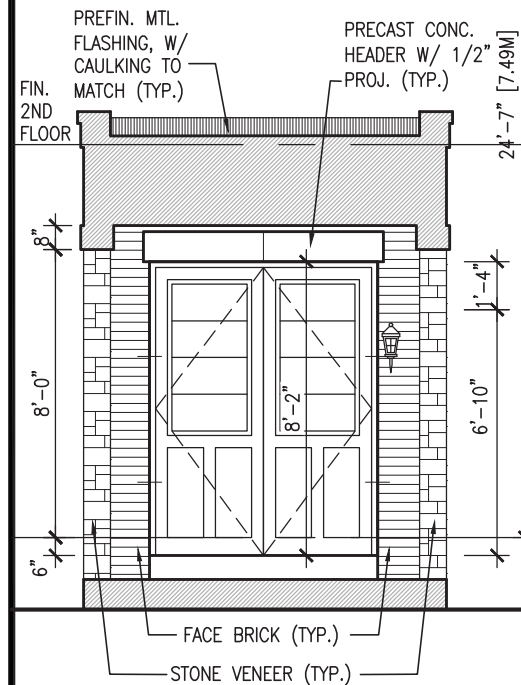

PORTICO ELEVATION 'B'

10' GROUND



FRONT ELEVATION 'B'




MAR 1, 2022

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This is to certify that these plans comply with the applicable Architectural Design Guidelines approved by the Town of BRADFORD / WEST GWILLIMBURY.

| | | | | | |
|--|--|---------------------------|--|-------|--|
| The undersigned has reviewed and takes responsibility for this design and has the qualifications and meets the requirements set out in the Ontario Building Code to be a Designer. | | qualification information | | 25591 | |
| Wellington Jno-Baptiste | | signature | | BCIN | |
| name | | registration information | | 42658 | |
| VA3 Design Inc. | | VA3 | | RC | |
| 3 REVISED AS PER ENG. COMMENTS | | MAR 01-22 | | RC | |
| 2 REVISED AS PER FLOOR / ROOF LAYOUTS | | FEB 24-22 | | RC | |
| 1 ISSUED FOR CLIENT REVIEW | | NOV 26-21 | | VA3 | |
| no. description | | date | | by | |

| | | | |
|----------------------|--|---|--|
| VA3 DESIGN | | 255 Consumers Rd. Suite 120 Toronto ON M2J 1R4 t 416.630.2255 f 416.630.4782 va3design.com | |
| project name | | project no. | |
| GREEN VALLEY ESTATES | | 16023 | |
| municipality | | drawing no. | |
| BRADFORD EAST, ON. | | 39 | |
| date | | FRONT ELEVATION 'B' | |
| SEPT. 2021 | | file name | |
| drawn by | | 16023-S38-20 | |
| NC | | scale | |
| checked by | | 3/16" = 1'-0" | |
| JWM | | date | |
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10' GROUND

This is to certify that these plans comply with the applicable Architectural Design Guidelines approved by the Town of BRADFORD / WEST GWILLIMBURY.

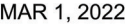REFER TO FRONT
ELEVATION FOR TYPICAL
NOTES & INFORMATION

S38-20

BAYVIEW WELLINGTON

| | | |
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| GREEN VALLEY ESTATES | BRADFORD EAST, ON. | 16023 |
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date **SEPT. 2021** **LEFT SIDE ELEVATION 'B'** drawing no. _____

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| drawn by | checked by | scale | file name |
| NC | JWM | 3/16" = 1'-0" | 16023-S38-20 |

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A

DESIGN

5 Consumers Rd Suite 120
Toronto ON M2J 1R4

16.630.2255 f 416.630.4782
va3design.com

specifications, related documents and c

and has the qualifications and meets the requirements set out in the Ontario Building Code to be a Designer.

qualification information
Wellington, Inc.-Baptiste
25591

| | | |
|--------------------------|-----------|------|
| name | signature | BCIN |
| registration information | | |

VA3 Design Inc. 42658

Contractor must verify all dimensions on the job and report any discrepancy to the Designer before proceeding with the work. All

Drawings are not to be scaled.

All drawings

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| 2 | REVISED AS PER FLOOR / ROOF LAYOUTS | FEB 24-22 | RO |
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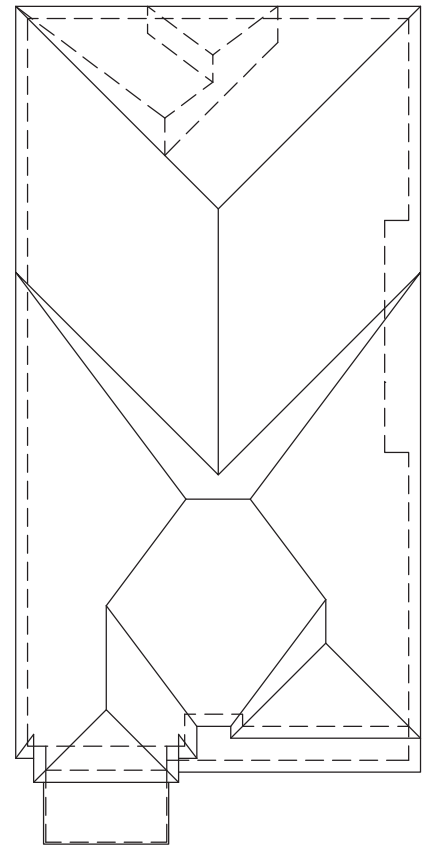
It is the builder's complete responsibility to ensure that all plans submitted for approval fully comply with the Architectural Guidelines and all applicable regulations and requirements including zoning provisions and any provisions in the subdivision agreement. The Control Architect is not responsible in any way for examining or approving site (lotting) plans or working drawings with respect to any zoning or building code or permit matter or that any house can be properly built or located on its lot.

This is to certify that these plans comply with the applicable Architectural Design Guidelines approved by the Town of BRADFORD / WEST GWILLIMBURY.


JOHN G. WILLIAMS LTD., ARCHITECT
ARCHITECTURAL CONTROL REVIEW
AND APPROVAL

APPROVED BY: 
DATE: MAR 03, 2022

This stamp certifies compliance with the applicable
Design Guidelines only and bears no further
professional responsibility.



ROOF PLAN 'C'

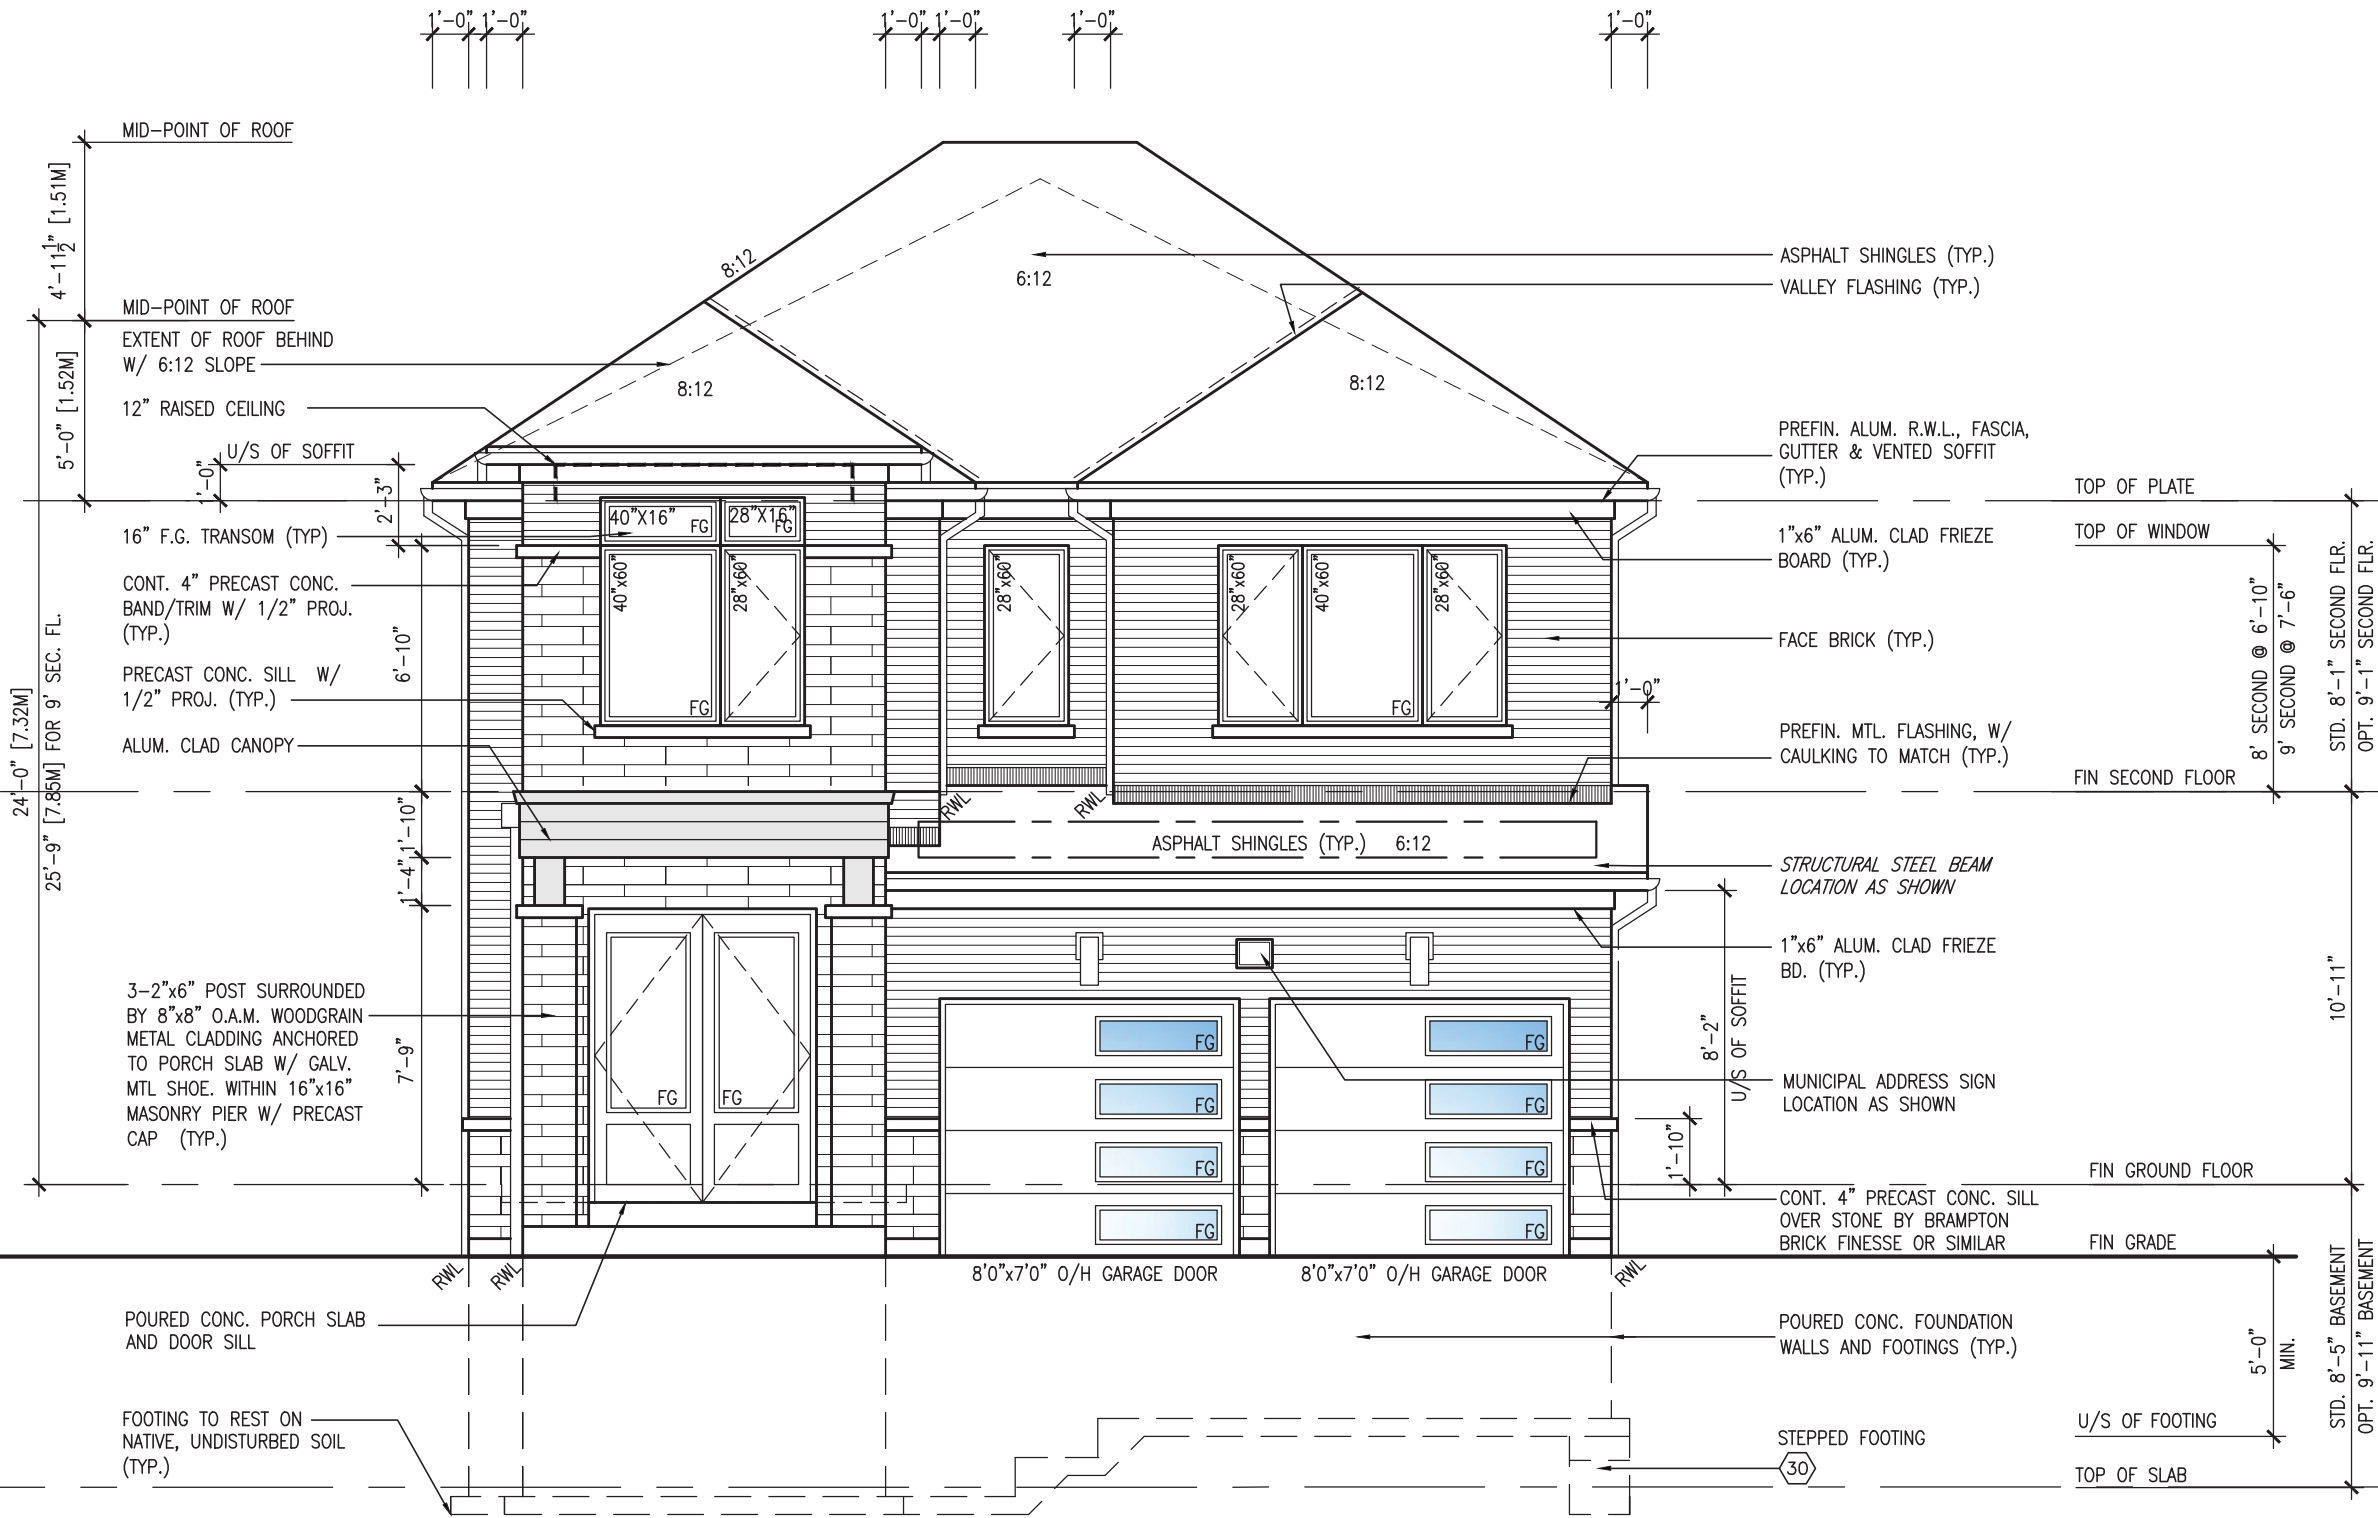

FRONT ELEVATION 'C'



MAR 1, 2022

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description

date

by

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ISSUED FOR CLIENT REVIEW

NOV 26-21

VA3

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REVISED AS PER FLOOR / ROOF LAYOUTS

FEB 24-22

RC

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REVISED AS PER ENG COMMENTS

MAR 01-22

RC

Wellington Jno-Baptiste

signature

25591

BCIN

VA3 Design Inc.

42658

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project name

GREEN VALLEY ESTATES

project no.

16023

date

SEPT. 2021

checked by

JWM

drawn by

NC

scale

3/16" = 1'-0"

file name

16023-S38-20

drawing no.

42

BAYVIEW WELLINGTON

S38-20

BRADFORD EAST, ON.

FRONT ELEVATION 'C'

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BRICK VENEER CONSTRUCTION

(FOR WALLS LESS THAN 1.2M (3'-11") FROM THE LOT LINE)

45 MINUTE FIRE RATED WALL

PROVIDE A CONTINUOUS LAYER OF 12.7mm (1/2") TYPE 'X' GYPSUM BOARD (INTERIOR SIDE) INSTALLED SO THAT ALL EDGES ARE SUPPORTED, TAPED AND FILLED. SPACE BETWEEN WOOD STUDS TO BE FILLED WITH INSULATION CONFORMING TO CAN/ULC-S702, "MINERAL FIBRE THERMAL INSULATION FOR BUILDINGS" WITH A MASS OF NOT LESS THAN 1.22 Kg/SQ.M. AND MUST FILL AT LEAST 90% OF THE CAVITY THICKNESS. THE TYPE 'X' & INSULATION MUST BE RUN CONTINUOUSLY BEHIND ALL INTERSECTING PARTITIONS, MECHANICAL CHASES, BATHTUBS, SHOWERS, ETC. ENSURE INSULATION & TYPE 'X' IS INSTALLED IN GARAGE EXTERIOR WALLS.

(REFER TO SECTION SB-2 OF OBC 2012-SUPPLEMENTARY STANDARDS)



MAR 1, 2022

10' GROUND

It is the builder's complete responsibility to ensure that all plans submitted for approval fully comply with the Architectural Guidelines and all applicable regulations and requirements including zoning provisions and any provisions in the subdivision agreement. The Control Architect is not responsible in any way for examining or approving site (lotting) plans or working drawings with respect to any zoning or building code or permit matter or that any house can be properly built or located on its lot.

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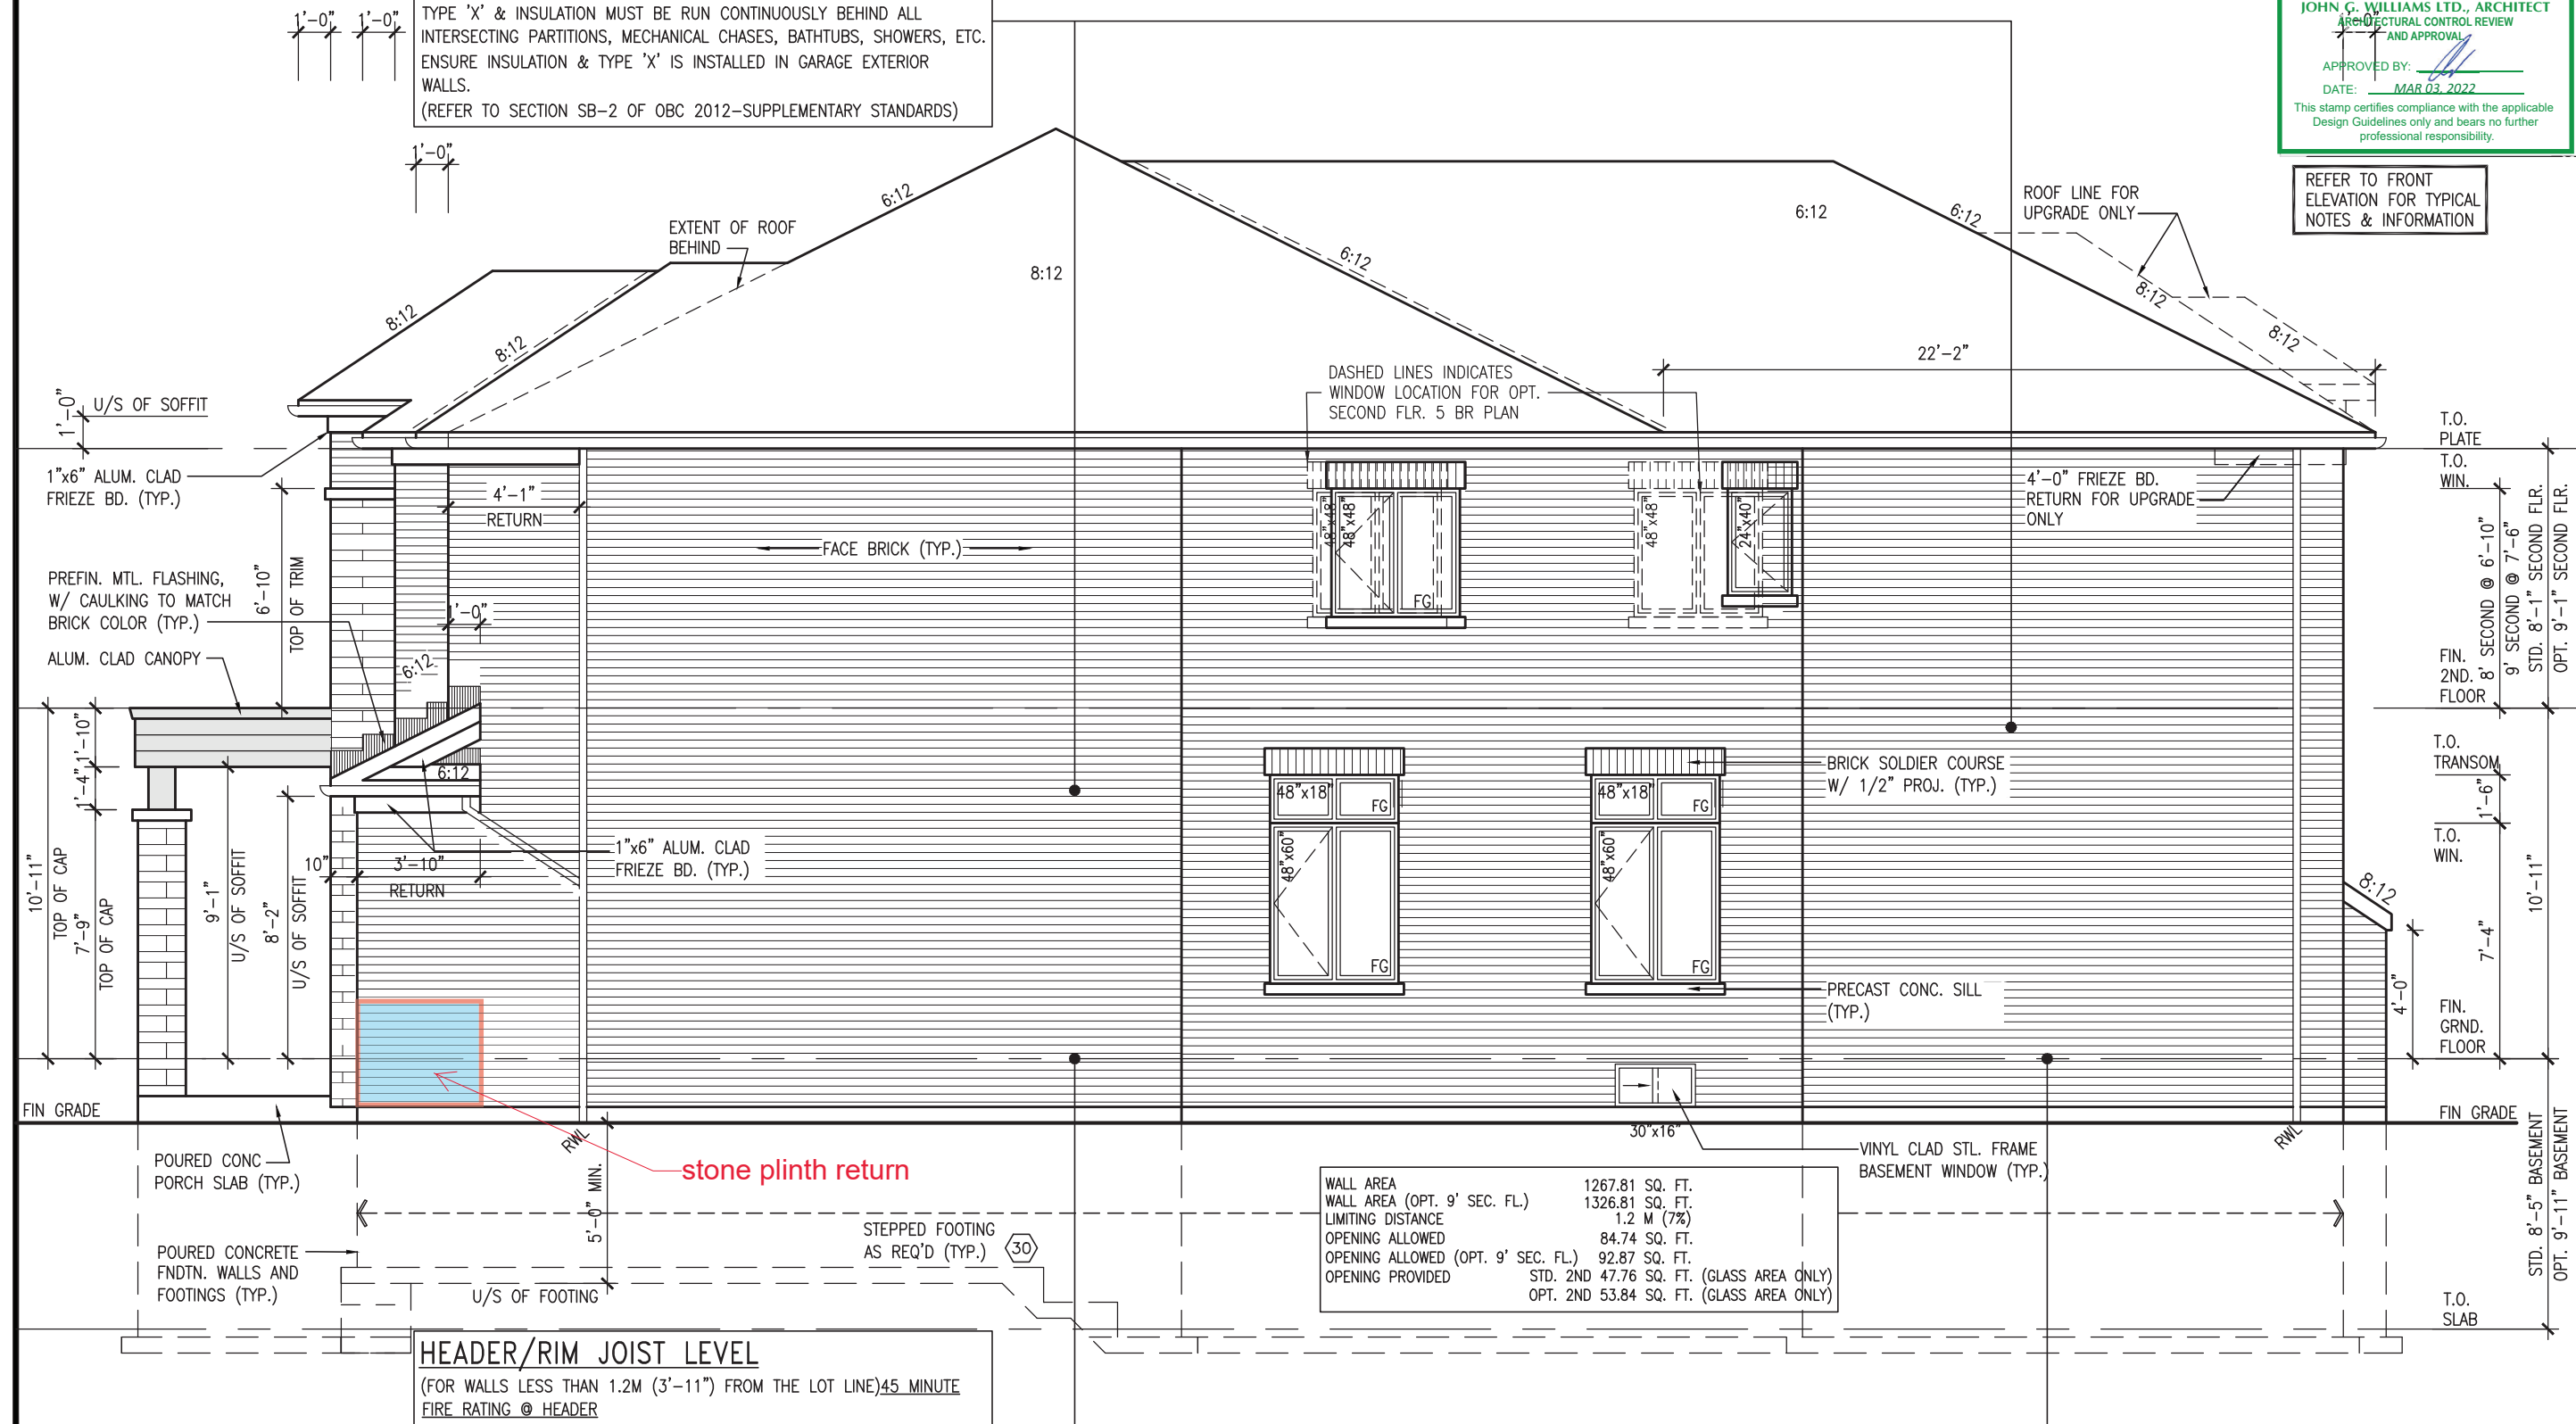
JOHN G. WILLIAMS LTD., ARCHITECT
ARCHITECTURAL CONTROL REVIEW
AND APPROVAL

APPROVED BY:

DATE: MAR 03, 2022

This stamp certifies compliance with the applicable Design Guidelines only and bears no further professional responsibility.

REFER TO FRONT
ELEVATION FOR TYPICAL
NOTES & INFORMATION



| | |
|------------------------------------|--|
| WALL AREA | 1267.81 SQ. FT. |
| WALL AREA (OPT. 9' SEC. FL.) | 1326.81 SQ. FT. |
| LIMITING DISTANCE | 1.2 M (7%) |
| OPENING ALLOWED | 84.74 SQ. FT. |
| OPENING ALLOWED (OPT. 9' SEC. FL.) | 92.87 SQ. FT. |
| OPENING PROVIDED | STD. 2ND 47.76 SQ. FT. (GLASS AREA ONLY) |
| | OPT. 2ND 53.84 SQ. FT. (GLASS AREA ONLY) |

HEADER/RIM JOIST LEVEL

(FOR WALLS LESS THAN 1.2M (3'-11") FROM THE LOT LINE)

45 MINUTE FIRE RATING @ HEADER

PROVIDE 15.9mm (5/8") TYPE 'X' GYPSUM BOARD BETWEEN FLOOR JOIST AT THE HEADER OR CONTINUOUSLY ALONG THE RIM JOIST WHEN FLOOR JOISTS ARE PARALLEL TO RIM JOIST TO MAINTAIN 45 MINUTE FIRE RATING.

RIGHT SIDE ELEVATION 'C'

S38-20

BAYVIEW WELLINGTON

VA3 DESIGN

Wellington Jno-Baptiste
Signature
BCIN 25591
42658

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|---|-------------------------------------|-----------|-----|------|----|
| 1 | ISSUED FOR CLIENT REVIEW | NOV 26-21 | VA3 | date | by |
| 2 | REVISED AS PER FLOOR / ROOF LAYOUTS | FEB 24-22 | RC | | |
| 3 | REVISED AS PER ENG COMMENTS | MAR 01-22 | RC | | |

project no. 16023
drawing no. 44
municipality BRADFORD EAST, ON.
GREEN VALLEY ESTATES

date SEPT. 2021
drawn by NC
checked by JWM
scale 3/16" = 1'-0"

file name 16023-S38-20
drawn by JWM
checked by JWM
scale 3/16" = 1'-0"

drawn by JWM
checked by JWM
scale 3/16" = 1'-0"

drawn by JWM
checked by JWM
scale 3/16" = 1'-0"

The undersigned has reviewed and takes responsibility for this design and has the qualifications and meets the requirements set out in the Ontario Building Code to be a Designer.

Wellington Jno-Baptiste
Signature
BCIN 25591
42658

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2. REVISED AS PER FLOOR / ROOF LAYOUTS

3. REVISED AS PER ENG COMMENTS

4. ISSUED FOR CLIENT REVIEW

5. ISSUED FOR CLIENT REVIEW

6. ISSUED FOR CLIENT REVIEW

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ARCHITECTURAL CONTROL REVIEW
AND APPROVAL

APPROVED BY: _____
DATE: MAR 03, 2022

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REFER TO FRONT
ELEVATION FOR TYPICAL
NOTES & INFORMATION

10' GROUND



REAR ELEVATION 'A'/'B'/'C'
-W.O.B. CONDITION



MAR 1, 2022

BAYVIEW WELLINGTON

S38-20

VAS3
DESIGN

The undersigned has reviewed and takes responsibility for this design and has the qualifications and meets the requirements set out in the Ontario Building Code to be a Designer.

qualification information
Wellington Jno-Baptiste 25591 BCIN
name
registration information
VAS Design Inc. 42658

Contractor must verify all dimensions on the job and report any discrepancy to the Designer before proceeding with the work. All drawings and specifications are instruments of service and the property of the Designer which must be returned at the completion of the work. Drawings are not to be scaled.

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| 3 | REVISED AS PER ENG COMMENTS | MAR 01-22 | RC |
| 2 | REVISED AS PER FLOOR / ROOF LAYOUTS | FEB 24-22 | RC |
| 1 | ISSUED FOR CLIENT REVIEW | NOV 26-21 | VAS |

project name
GREEN VALLEY ESTATES

project no.
16023

drawing no.
46

date
SEPT. 2021

drawn by
JWM

checked by
JWM

scale
3/16" = 1'-0"

file name
16023-S38-20

project name
GREEN VALLEY ESTATES


municipality
BRADFORD EAST, ON.

rear elev. 'A'/'B'/'C' -W.O.B. COND.

16023-S38-20.dwg - Tue - Mar 1 2022 - 2:39 PM

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10⁹ GROUND

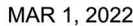

This is to certify that these plans comply with the applicable Architectural Design Guidelines approved by the Town of BRADFORD / WEST GWILLIMBURY.

APPROVED BY:

DATE: MAR 03, 2022

This stamp certifies compliance with the applicable Design Guidelines only and bears no further professional responsibility.

REFER TO FRONT
ELEVATION FOR TYPICAL
NOTES & INFORMATION

| | |
|-----------------------------|--|
| STD. 8'-5" BASEMENT | |
| <u>OPT. 9'-11" BASEMENT</u> | |

and has the qualifications and meets the requirements set out in the Ontario Building Code to be a Designer.

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All draw

DESIGN
Consumers Rd. Suite

DESIGN
255 Consumers Rd Suite 120
Toronto ON M2J 1R4
t 416.630.2255 f 416.630.4782
va3design.com

s specifications, related documents and de

| project name | municipality |
|----------------------|--------------------|
| GREEN VALLEY ESTATES | BRADFORD EAST, ON. |

project no.
16023

47

| | |
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| file name | 16023-S38-20 |
| | Apr 1 2022 - 2:39 PM |

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10' GROUND

It is the builder's complete responsibility to ensure that all plans submitted for approval fully comply with the Architectural Guidelines and all applicable regulations and requirements including zoning provisions and any provisions in the subdivision agreement. The Control Architect is not responsible in any way for examining or approving site (lotting) plans or working drawings with respect to any zoning or building code or permit matter or that any house can be properly built or located on its lot.

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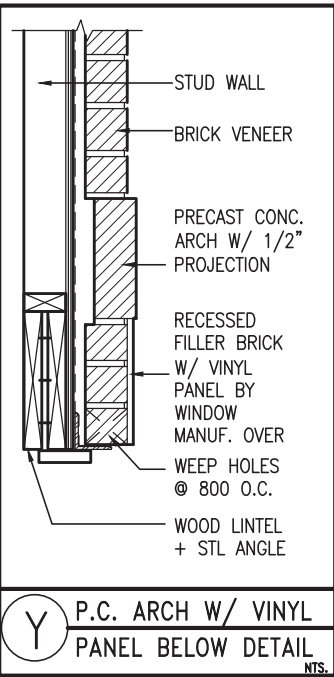
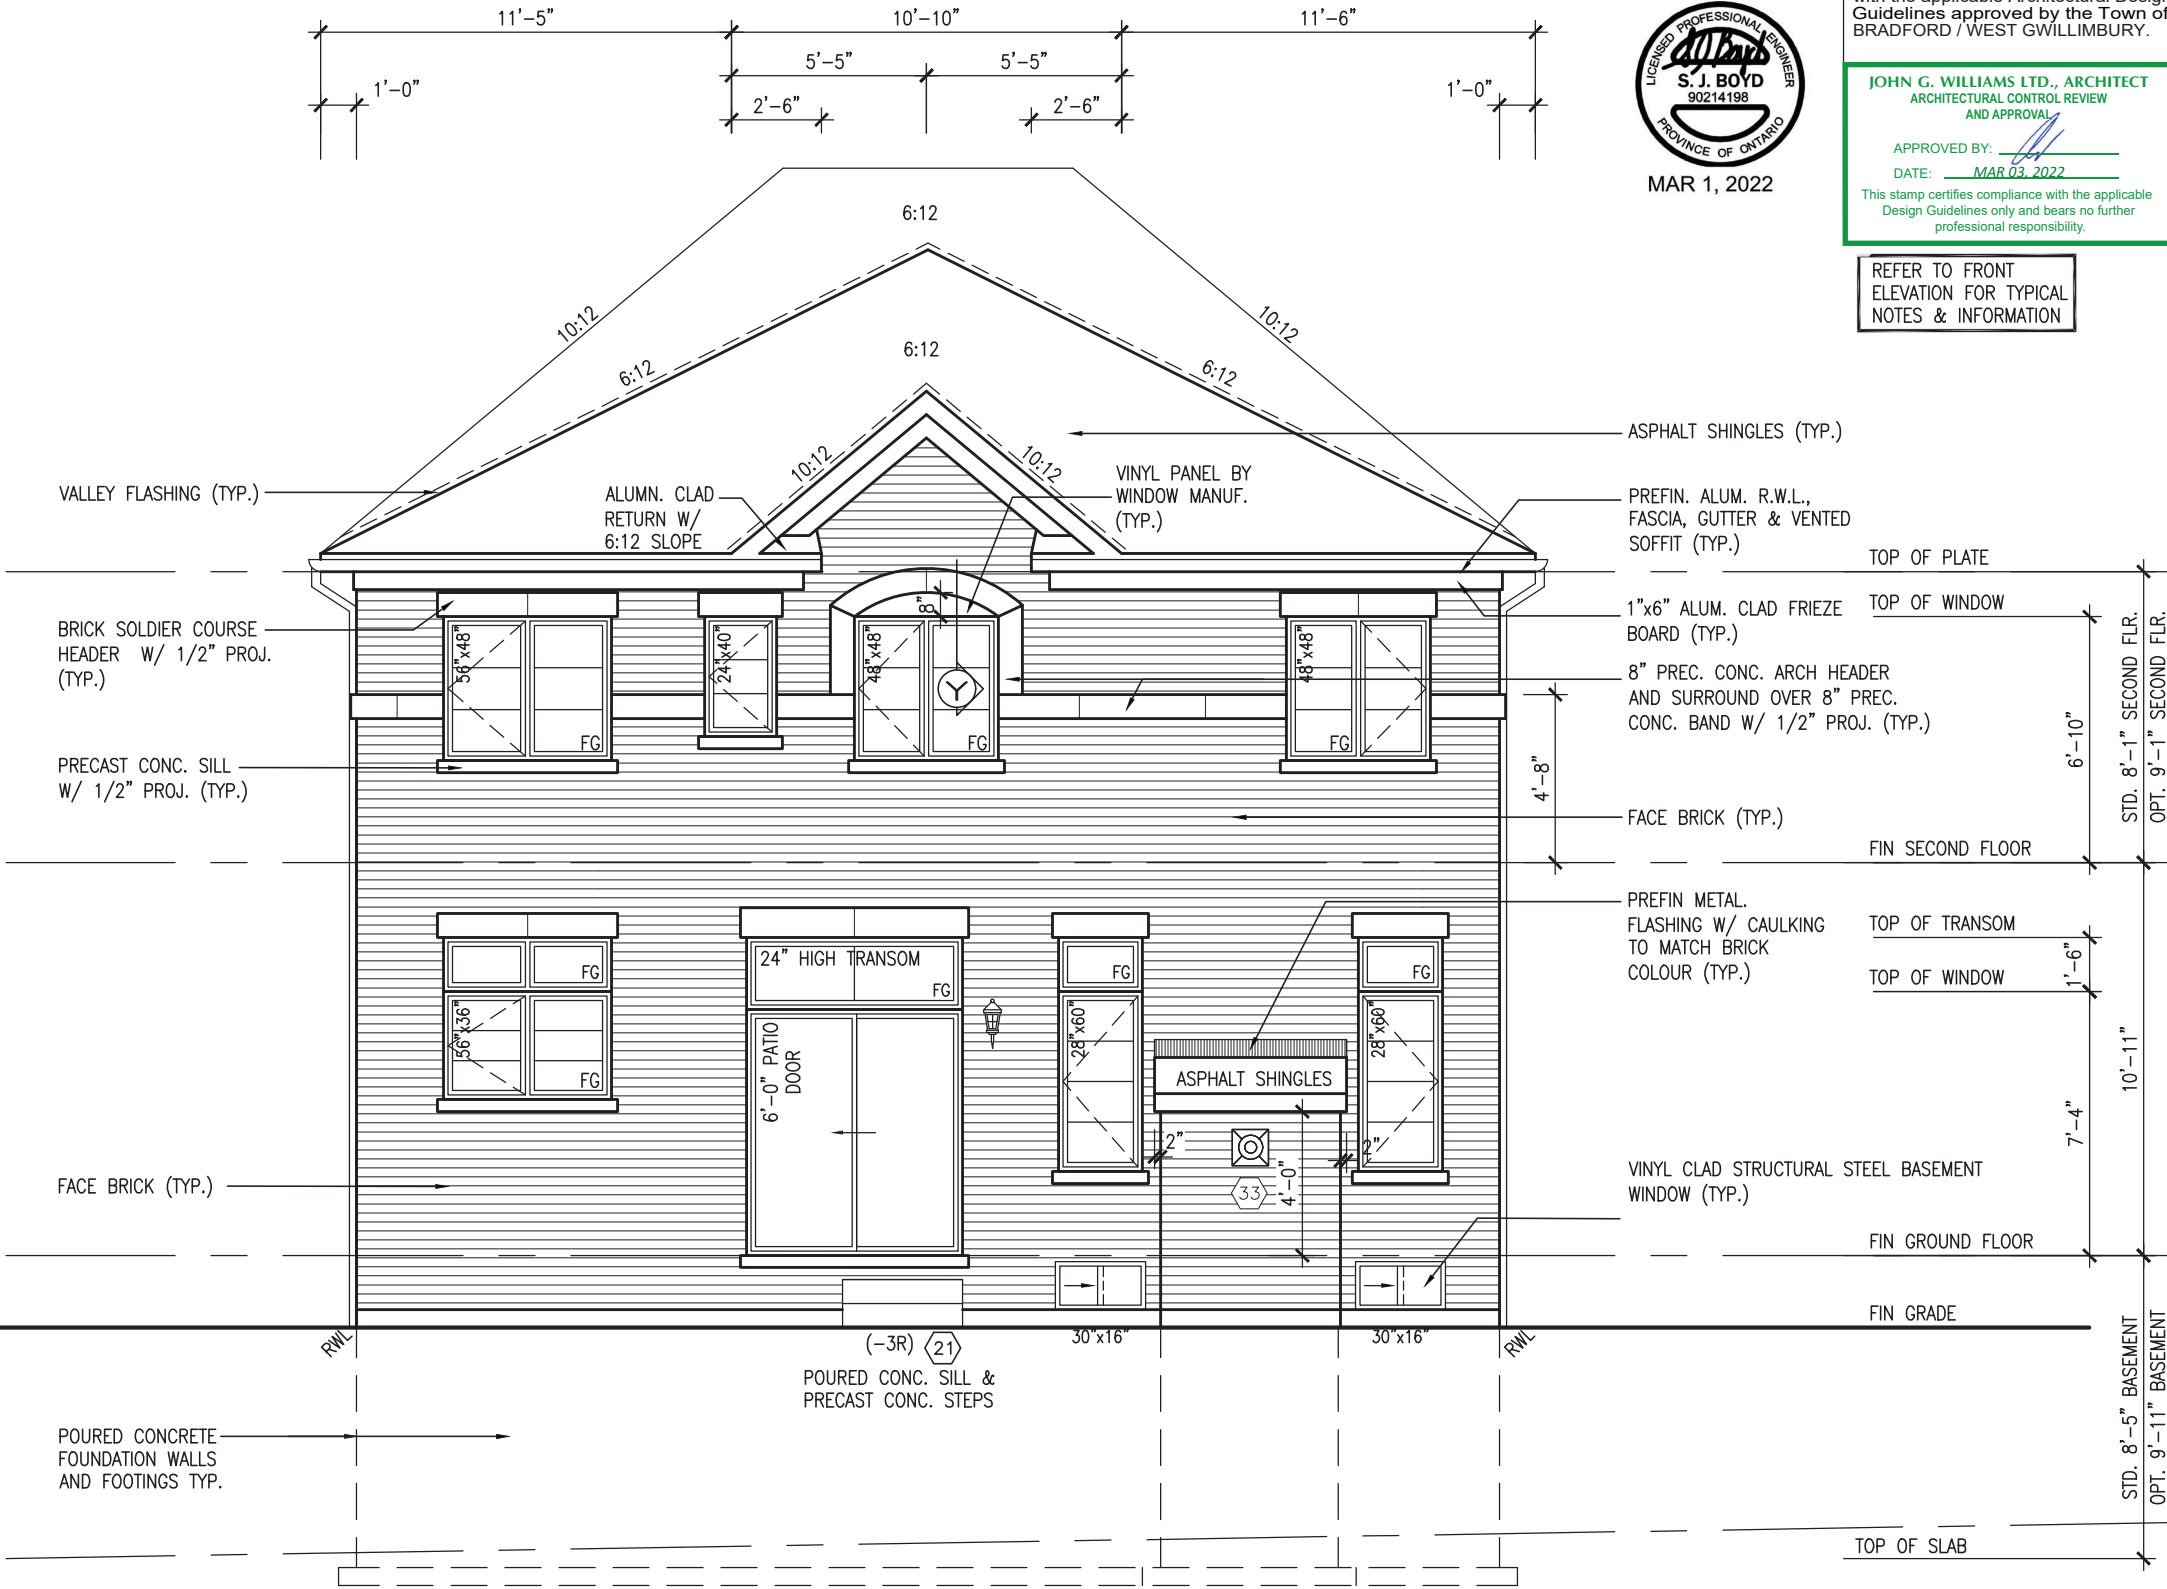
MAR 1, 2022

JOHN G. WILLIAMS LTD., ARCHITECT
ARCHITECTURAL CONTROL REVIEW
AND APPROVAL

APPROVED BY:
DATE: MAR 03, 2022

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REFER TO FRONT
ELEVATION FOR TYPICAL
NOTES & INFORMATION



UPGRADED REAR ELEVATION 'B'

| | | | | | |
|--|--|---------------------------------------|--|-------------------------------|--|
| The undersigned has reviewed and takes responsibility for this design and has the qualifications and meets the requirements set out in the Ontario Building Code to be a Designer. | | qualification information | | 25591 | |
| Wellington Jno-Baptiste | | signature | | BCIN | |
| name | | registration information | | 42658 | |
| VA3 Design Inc. | | MAR 01-22 RC | | 3 REVISED AS PER ENG COMMENTS | |
| FEB 24-22 RC | | 2 REVISED AS PER FLOOR / ROOF LAYOUTS | | 1 ISSUED FOR CLIENT REVIEW | |
| NOV 26-21 VA3 | | date | | by | |
| description | | date | | by | |

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| BAYVIEW WELLINGTON | | 16023 | |
| GREEN VALLEY ESTATES | | drawing no. | |
| BRADFORD EAST, ON. | | 48 | |
| date | | file name | |
| SEPT. 2021 | | 16023-S38-20 | |
| checked by | | scale | |
| JWM | | 3/16" = 1'-0" | |
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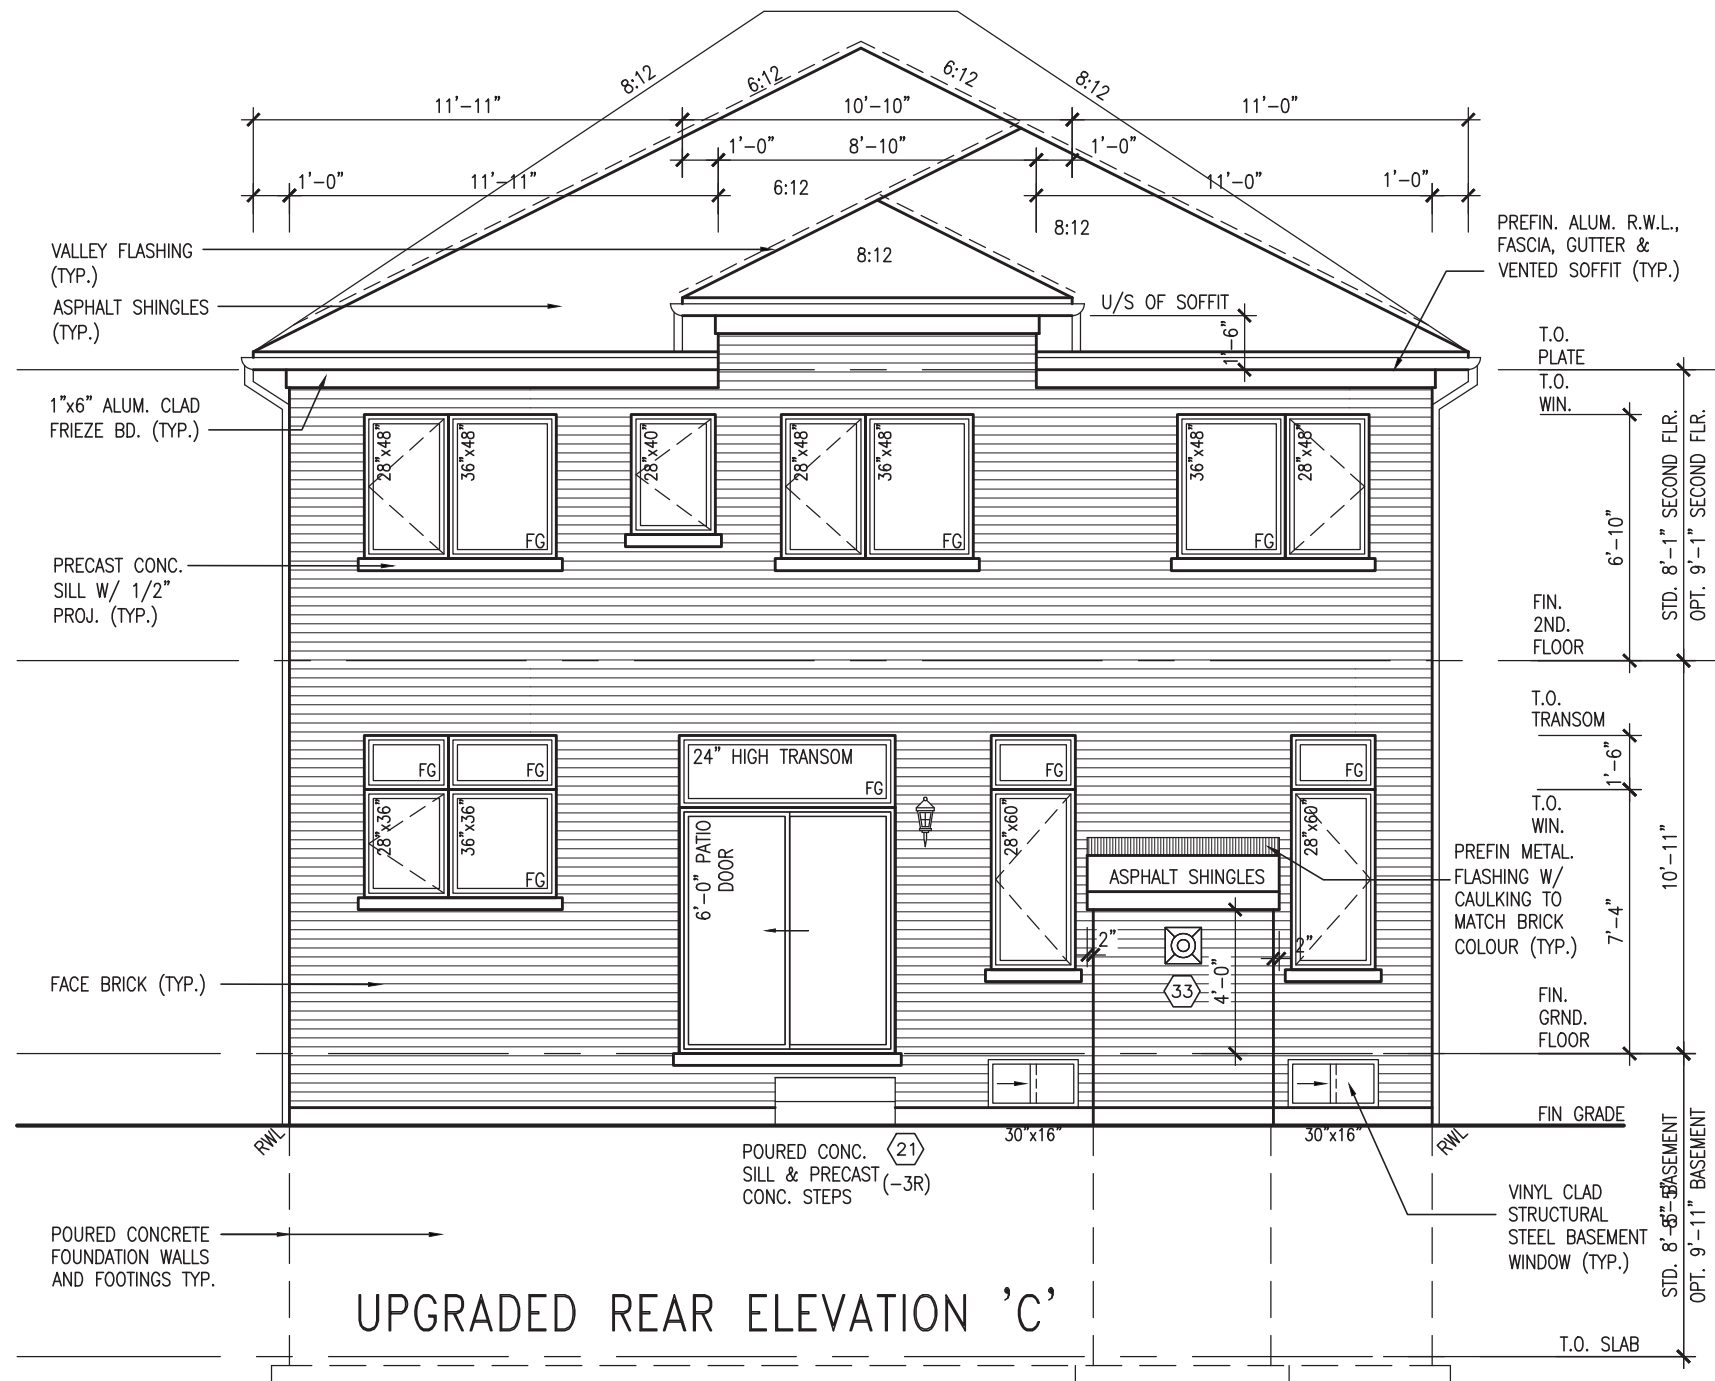
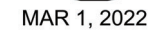
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10⁹ GROUND



V3
DESIGN
5 Consumers Rd Suite
Toronto ON M2J 1R4
16.630.2255 f 416.630.
va3design.com

The undersigned has reviewed and takes responsibility for this design and has the qualifications and meets the requirements set out in the Ontario Building Code to be a Designer.

Qualification Information

Wellington Jno-Baptiste *Jno-Baptiste* 25591
name signature BCIN

Registration information
MA3 Design Inc. 42658

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| 1 | ISSUED FOR CLIENT REVIEW | NOV 28--21 VA3 | d |

[illegible]

S38-20

BAYVIEW WELLINGTON

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| project name | project no. |
| GREEN VALLEY ESTATES | 16023 |
| BRADFORD EAST, ON. | |

| date | DESCRIPTION OF WORK | drawing no. |
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| | IMPROVED REAR ELEVATION 'A' | |

| drawn by | checked by | scale | file name |
|---------------------------|------------|-------|-----------|
| UPGRADED REAR ELEVATION C | | | |

| NC | JWM | 3/16" = 1'-0" | 16023-S38-20 |
|---|-----|---------------|--------------|
| <p>RICHARD = 16023-S38-20.dwg 38" 16023-S38-20.dwg = Tue 1 2022 = 2:32 PM</p> | | | |

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REFER TO FRONT
ELEVATION FOR TYPICAL
NOTES & INFORMATION

10 GROUND



MAR 1, 2022

Architectural elevation drawing of a two-story house with a gabled roof. The drawing includes detailed dimensions for roof pitches, window sizes, and floor heights. It also features material callouts such as "ASPHALT SHINGLES (TYP.)", "FACE BRICK (TYP.)", and "PRECAST CONC.+ BRICK ROWLOCK BAND/SILL W/ 1/2\"

UPGRADED REAR ELEVATION 'A'
-W.O.D. 9R OR MORE COND.

BASEMENT WINDOW SIZES
4R-8R USE 30"x24" VINYL
CLAD STRUCTURAL STEEL
FRAME BASEMENT WINDOWS

S38-20

BAYVIEW WELLINGTON

| project name | municipality | project no. |
|----------------------|--------------------|-------------|
| GREEN VALLEY ESTATES | BRADFORD EAST, ON. | 16073 |

| DATE | DESCRIPTION | W | A | D | COND | DRAWING NO. |
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| | UPGRADED REAR FLEV 'A' | | | | | |

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| SEPT. 2021 | UPGRADED REAR ELEV. A -W.U.D. COND. | file name |
| drawn by NC | checked by JWM | scale 3/16" = 1'-0" |
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DESIGN

DESIGN
255 Consumers Rd Suite 120
Toronto ON M2J 1R4
416.630.2255 f 416.630.4782
va3design.com

Conclusion

The undersigned has reviewed and takes responsibility for this design and has the qualifications and meets the requirements set out in the Ontario Building Code to be a Designer.

qualification information

Wellington Jno-Baptiste 2559

name registration information

4265 WA3 Design Inc.

Contractor must verify all dimensions on the job and report any discrepancy to the Designer before proceeding with the work. All drawings and specifications are instruments of service and the property of the Designer which must be returned at the completion of the work.

Drawings are not to be scaled.

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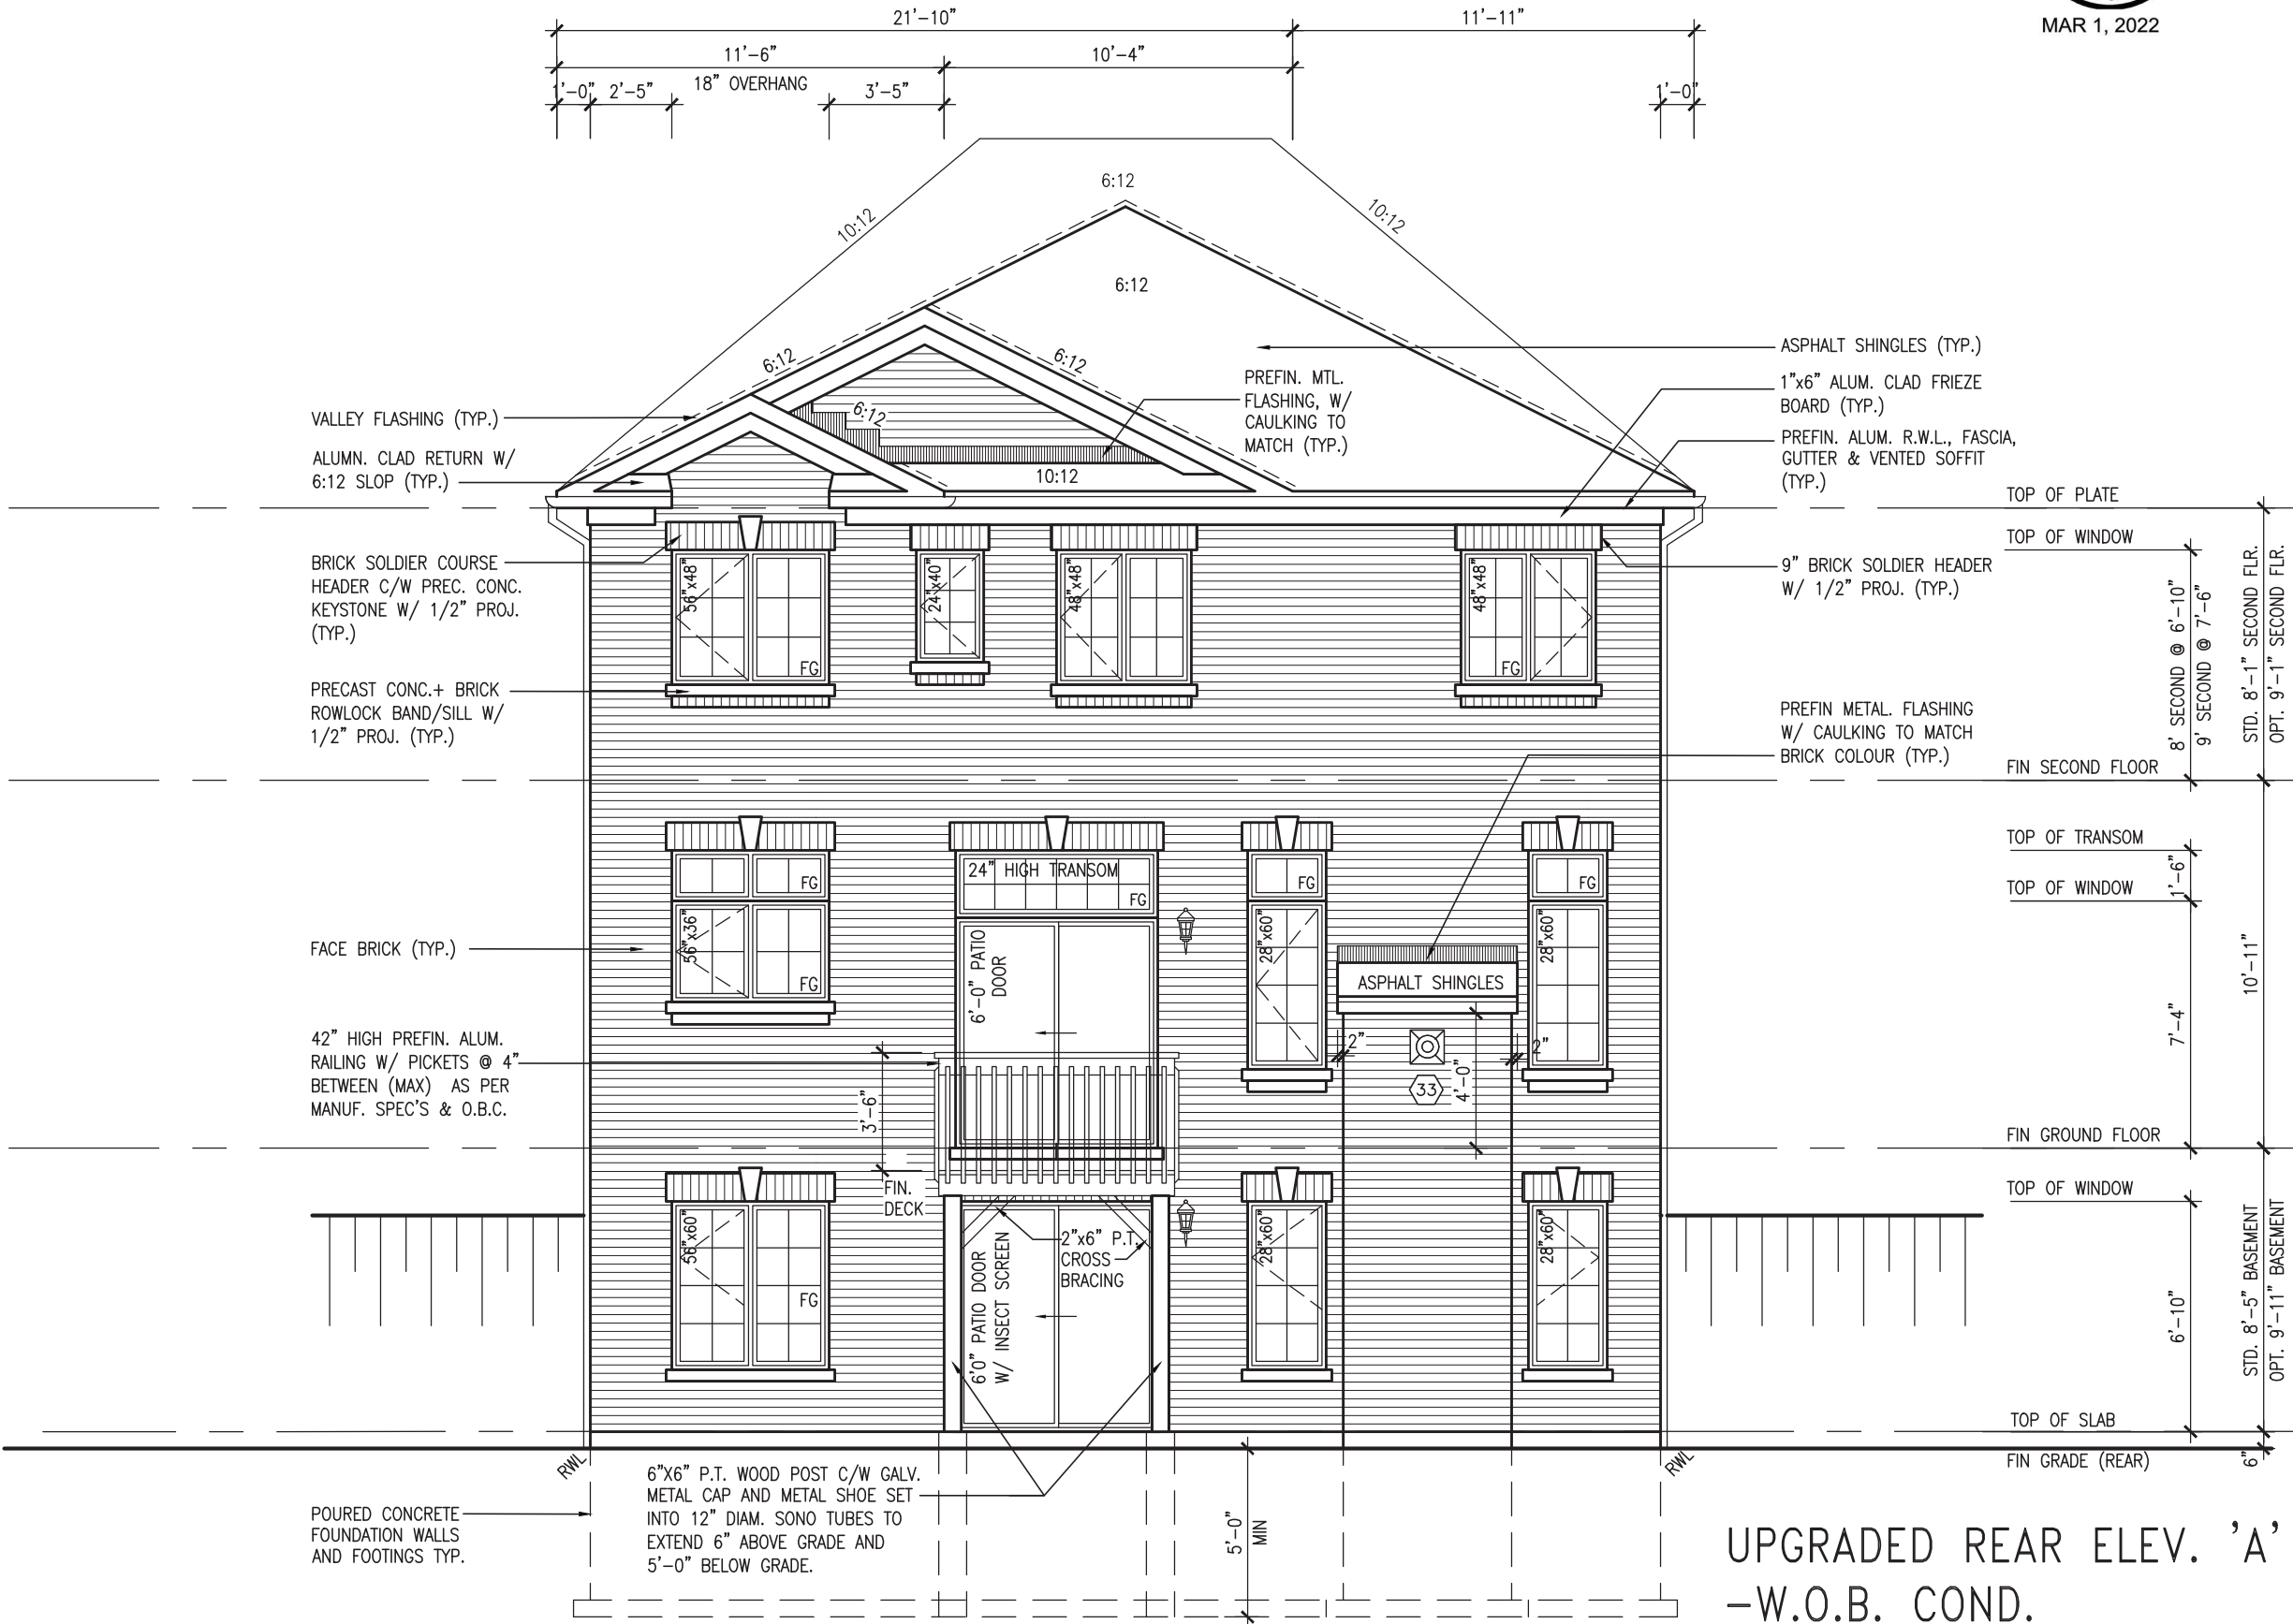
JOHN G. WILLIAMS LTD., ARCHITECT
ARCHITECTURAL CONTROL REVIEW
AND APPROVAL

APPROVED BY: 
DATE: MAR 03, 2022

This stamp certifies compliance with the applicable Design Guidelines only and bears no further professional responsibility.

REFER TO FRONT
ELEVATION FOR TYPICAL
NOTES & INFORMATION

10' GROUND



UPGRADED REAR ELEV. 'A'
-W.O.B. COND.

| BAYVIEW WELLINGTON | | S38-20 | |
|--------------------|---------------------------------------|--------------|--------------------|
| project name | GREEN VALLEY ESTATES | municipality | BRADFORD EAST, ON. |
| project no. | 16023 | date | SEPT. 2021 |
| drawing no. | 53 | checked by | JWM |
| file name | 16023-S38-20 | drawn by | NC |
| scale | 3/16" = 1'-0" | drawn by | NC |
| description | UPGRADED REAR ELEV. 'A' -W.O.B. COND. | | |
| no. | description | date | by |
| 9 | REVISED AS PER ENG COMMENTS | MAR 01-22 | RC |
| 8 | REVISED AS PER FLOOR / ROOF LAYOUTS | FEB 24-22 | RC |
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VA3 DESIGN
255 Consumers Rd Suite 120
Toronto, ON M2J 1P4
t 416.630.2255 f 416.630.4782
vo3design.com

The undersigned has reviewed and takes responsibility for this design and has the qualifications and meets the requirements set out in the Ontario Building Code to be a Designer.

Wellington Jno-Baptiste 25591 BCIN
VA3 Design Inc. 42658

name registration information
signature

Contractor must verify all dimensions on the job and report any discrepancy to the Designer before proceeding with the work. All drawings and specifications are instruments of service and the property of the Designer which must be returned at the completion of the work. Drawings are not to be scaled.


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APPROVED BY: _____
DATE: MAR 03, 2022


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ELEVATION FOR TYPICAL
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UPGRADED REAR ELEV. 'B'
-W.O.B. COND.

S38-20

BAYVIEW WELLINGTON

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DESIGN

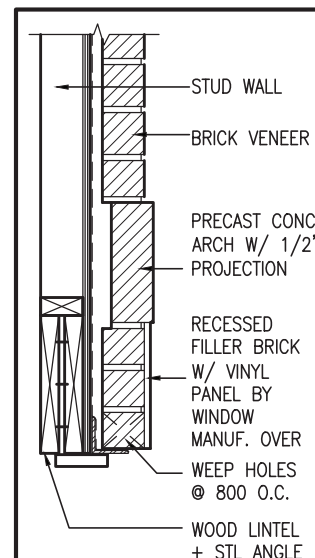255 Consumers Rd Suite 120

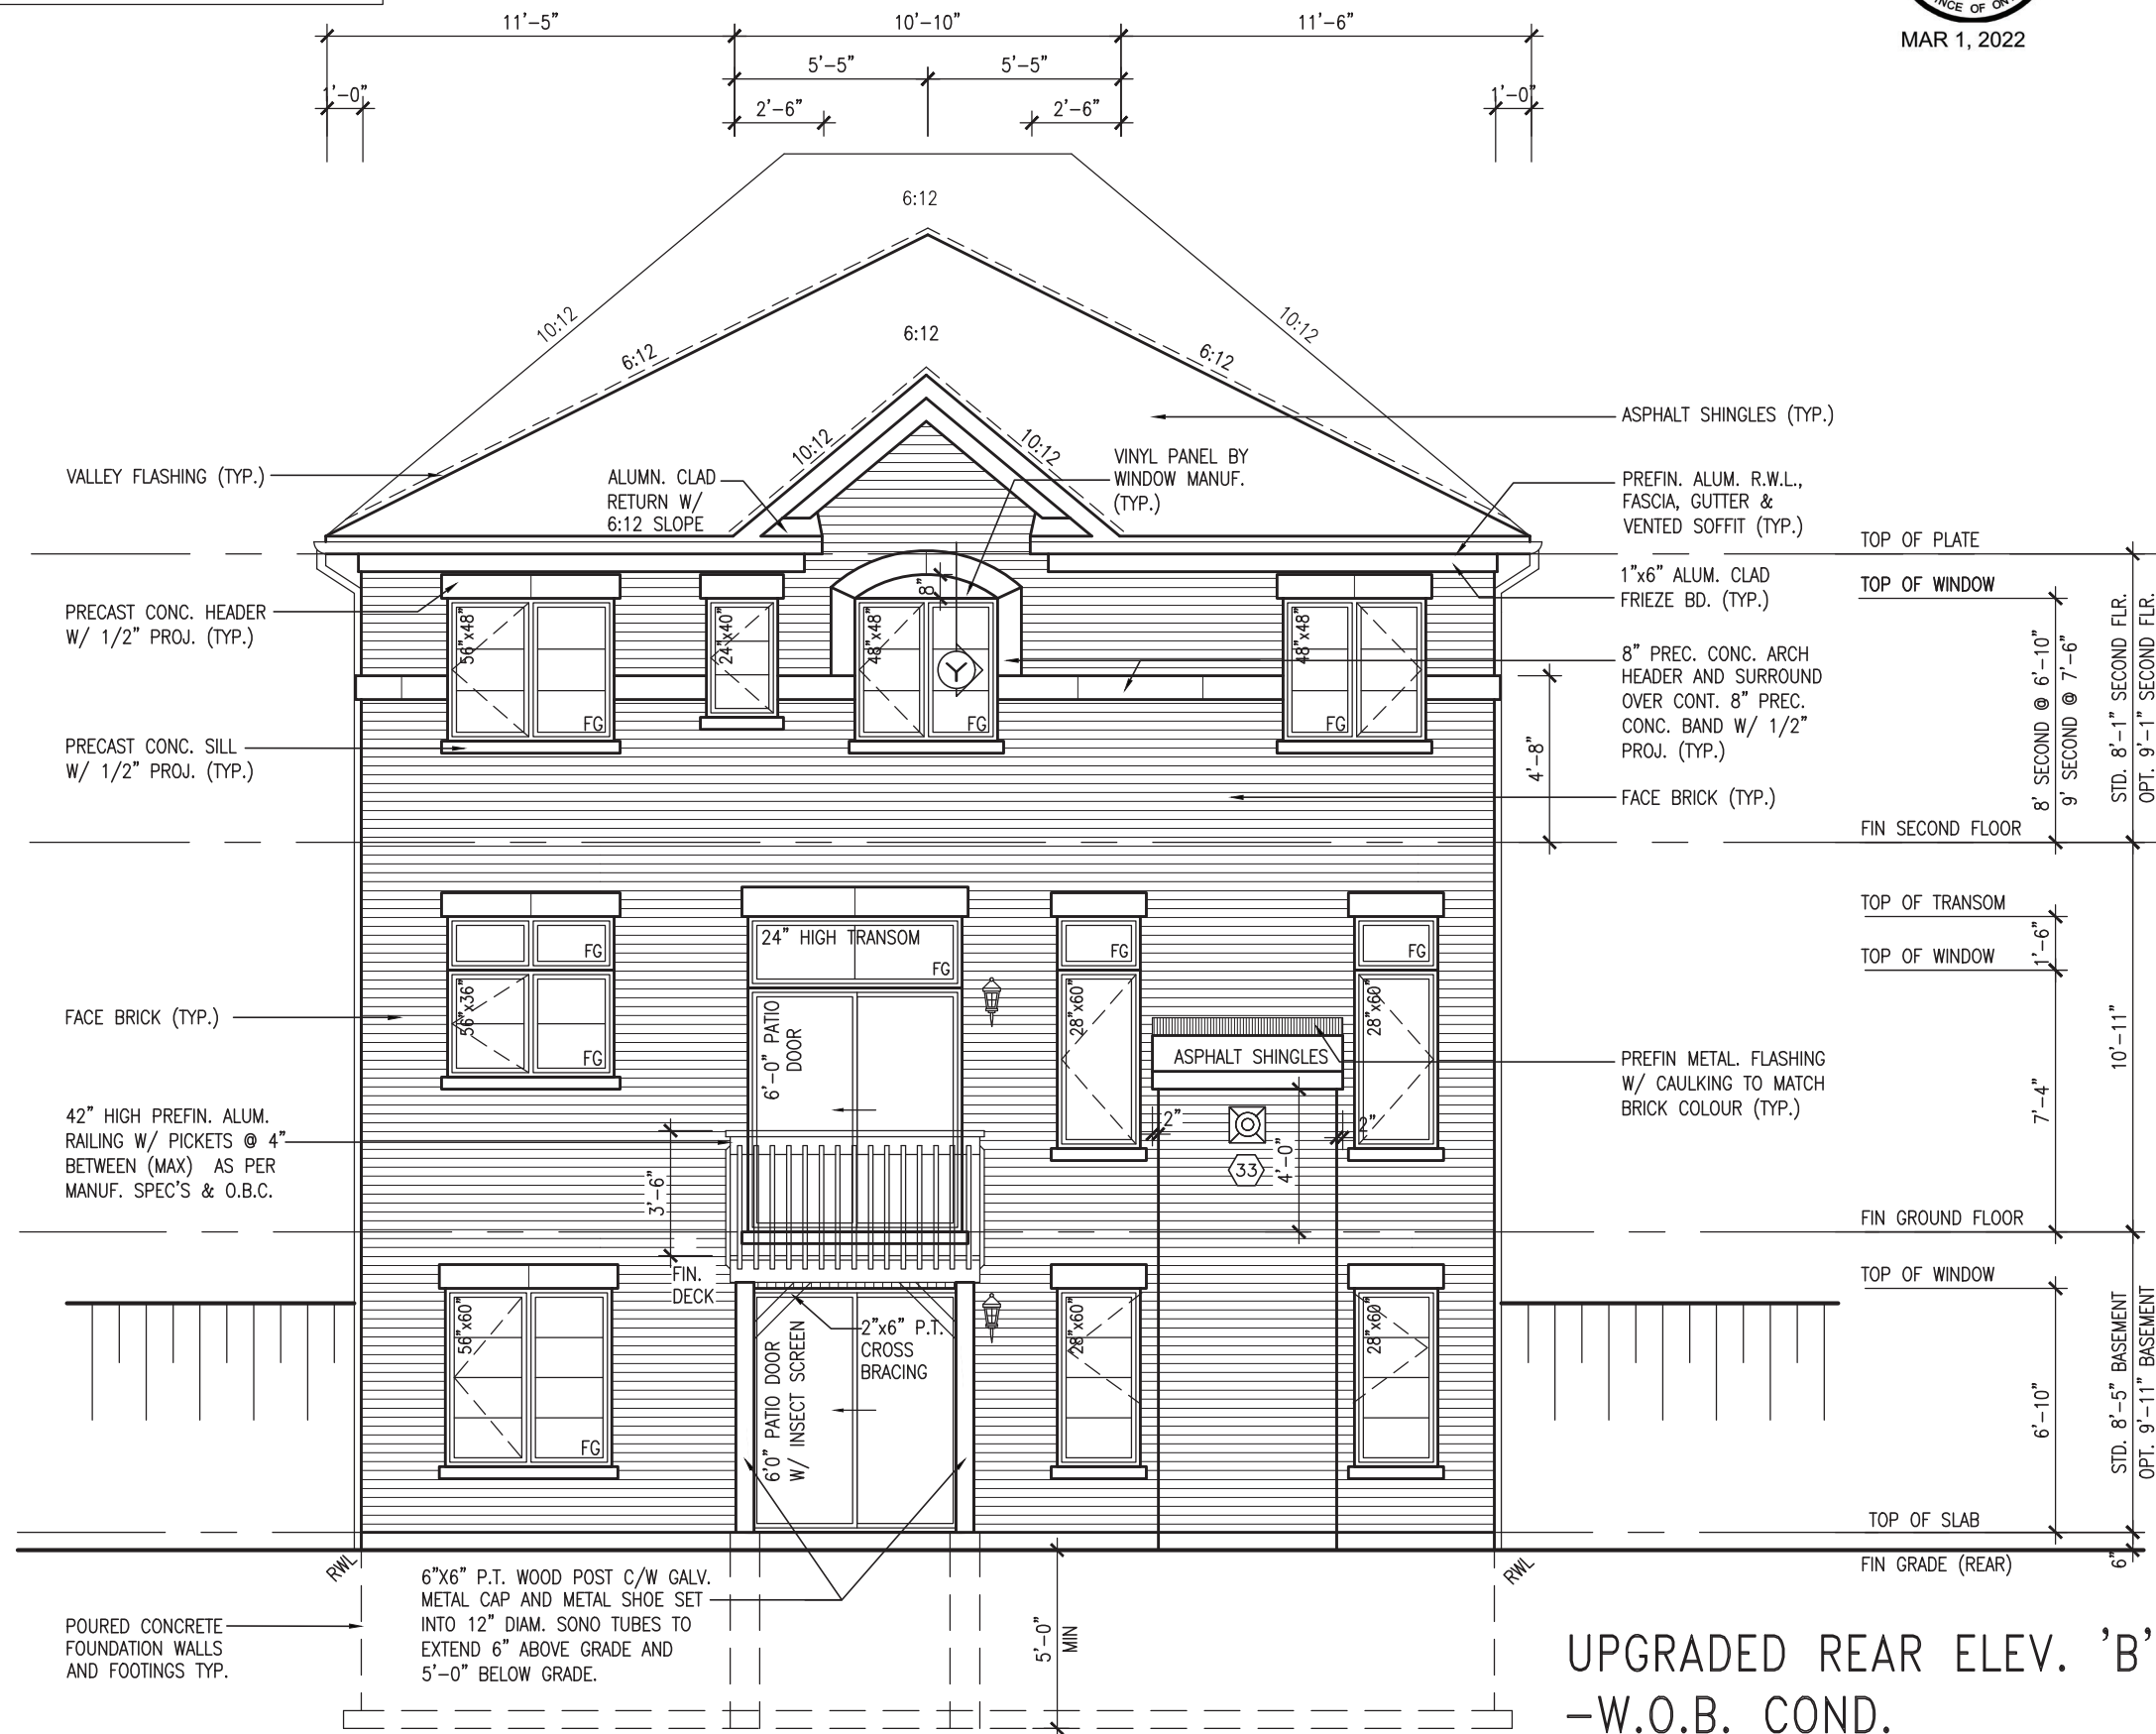Toronto ON M2J 1R4
416.630.2255 f 416.630.4782

va3design.com

specifications, related documents and de

he undersigned has reviewed and takes responsibility for this design and has the qualifications and meets the requirements set out in the

Ontario Building Code to be a Designer.

Qualification information

Wellington Jno-Baptiste 25591

name _____
 registration information _____
 signature _____
 BCIN _____

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
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APPROVED BY: 
DATE: MAR 03, 2022


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10' GROUND



MAR 1, 2022



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| VA3 DESIGN | | 255 Consumers Rd, Suite 120 Toronto, ON M2N 1P4 t 416.630.2255 f 416.630.4782 va3design.com | |
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|--|--|------------------------------|------------------------------|------|--------------------|---------------------------------------|--|------------|--|--------------------|--|------------------------------|--|--|------------------------------|-------------|------------|--|-----------|--|------|-----------|-------------|---------|-------------|------------|---------|--|--|
| STANDARD & REAR UPGRADE STD SEC. FL. | UNINSULATED OPENINGS (PER OBC. SB-12,3.1.1(7)) | | | | | STANDARD & REAR UPGRADE STD SEC. FL. | UNINSULATED OPENINGS (PER OBC. SB-12,3.1.1(7)) | | | | | STANDARD REAR & STD SEC. FL. | UNINSULATED OPENINGS (PER OBC. SB-12,3.1.1(7)) | | | | | | | | | | | | | | | | |
| | S38-20 ELEVATION A | | ENERGY EFFICIENCY – OBC SB12 | | | | S38-20 ELEVATION B | | ENERGY EFFICIENCY – OBC SB12 | | | | S38-20 ELEVATION C | | ENERGY EFFICIENCY – OBC SB12 | | | | | | | | | | | | | | |
| | ELEVATION | | WALL | AREA | S.F. | | OPENING | S.F. | PERCENTAGE | ELEVATION | | | WALL | AREA | S.F. | OPENING | S.F. | PERCENTAGE | ELEVATION | | WALL | AREA | S.F. | OPENING | S.F. | PERCENTAGE | | | |
| | FRONT | | 677 S.F. | | | | 150.28 S.F. | | 22.20 % | | FRONT | | 688 S.F. | | | 152.28 S.F. | | 22.13 % | | FRONT | | 675 S.F. | | | 166.50 S.F. | | 24.67 % | | |
| | LEFT SIDE | | 1274 S.F. | | | | 96.00 S.F. | | 7.54 % | | LEFT SIDE | | 1274 S.F. | | | 96.00 S.F. | | 7.54 % | | LEFT SIDE | | 1316 S.F. | | | 96.00 S.F. | | 7.29 % | | |
| | RIGHT SIDE | | 1260 S.F. | | | | 78.00 S.F. | | 6.19 % | | RIGHT SIDE | | 1260 S.F. | | | 78.00 S.F. | | 6.19 % | | RIGHT SIDE | | 1278 S.F. | | | 78.00 S.F. | | 6.10 % | | |
| | REAR | | 667 S.F. | | | | 168.55 S.F. | | 25.27 % | | REAR | | 667 S.F. | | | 168.55 S.F. | | 25.27 % | | REAR | | 667 S.F. | | | 168.55 S.F. | | 25.27 % | | |
| | * OPENINGS OMITTED AS PER SB-12 3.1.1.9(4) MAX 19.9 S.F. REFER TO ELEVATION FOR LOCATION | | | | | | 0.00 S.F. | | | | * OPENINGS OMITTED AS PER SB-12 3.1.1.9(4) MAX 19.9 S.F. REFER TO ELEVATION FOR LOCATION | | | | | 0.00 S.F. | | | | * OPENINGS OMITTED AS PER SB-12 3.1.1.9(4) MAX 19.9 S.F. REFER TO ELEVATION FOR LOCATION | | | | | 0.00 S.F. | | | | |
| TOTAL SQ. FT. | | 3878.00 S.F. | | | 492.83 S.F. | | 12.71 % | | TOTAL SQ. FT. | | 3889.00 S.F. | | | 494.83 S.F. | | 12.72 % | | TOTAL SQ. FT. | | 3936.00 S.F. | | | 509.05 S.F. | | 12.93 % | | | | |
| TOTAL SQ. M. | | 360.27 S.M. | | | 45.79 S.M. | | 12.71 % | | TOTAL SQ. M. | | 361.30 S.M. | | | 45.97 S.M. | | 12.72 % | | TOTAL SQ. M. | | 365.66 S.M. | | | 47.29 S.M. | | 12.93 % | | | | |
| UNINSULATED OPENINGS (PER OBC. SB-12,3.1.1(7)) | | | | | | STANDARD & REAR UPGRADE OPT. SEC. FL. | UNINSULATED OPENINGS (PER OBC. SB-12,3.1.1(7)) | | | | | | STANDARD REAR & OPT. SEC. FL. | UNINSULATED OPENINGS (PER OBC. SB-12,3.1.1(7)) | | | | | | | | | | | | | | | |
| S38-20 ELEVATION A | | ENERGY EFFICIENCY – OBC SB12 | | | S38-20 ELEVATION B | | ENERGY EFFICIENCY – OBC SB12 | | | S38-20 ELEVATION C | | ENERGY EFFICIENCY – OBC SB12 | | | | | | | | | | | | | | | | | |
| ELEVATION | | WALL | AREA | S.F. | OPENING | | S.F. | PERCENTAGE | ELEVATION | | WALL | AREA | | S.F. | OPENING | S.F. | PERCENTAGE | ELEVATION | | WALL | AREA | S.F. | OPENING | S.F. | PERCENTAGE | | | | |
| FRONT | | 677 S.F. | | | 150.28 S.F. | | 22.20 % | | FRONT | | 688 S.F. | | | 152.28 S.F. | | 22.13 % | | FRONT | | 675 S.F. | | | 166.50 S.F. | | 24.67 % | | | | |
| LEFT SIDE | | 1274 S.F. | | | 96.00 S.F. | | 7.54 % | | LEFT SIDE | | 1274 S.F. | | | 96.00 S.F. | | 7.54 % | | LEFT SIDE | | 1316 S.F. | | | 96.00 S.F. | | 7.29 % | | | | |
| RIGHT SIDE | | 1260 S.F. | | | 87.33 S.F. | | 6.93 % | | RIGHT SIDE | | 1260 S.F. | | | 87.33 S.F. | | 6.93 % | | RIGHT SIDE | | 1278 S.F. | | | 87.33 S.F. | | 6.83 % | | | | |
| REAR | | 667 S.F. | | | 168.55 S.F. | | 25.27 % | | REAR | | 667 S.F. | | | 168.55 S.F. | | 25.27 % | | REAR | | 667 S.F. | | | 168.55 S.F. | | 25.27 % | | | | |
| * OPENINGS OMITTED AS PER SB-12 3.1.1.9(4) MAX 19.9 S.F. REFER TO ELEVATION FOR LOCATION | | | | | 0.00 S.F. | | | | * OPENINGS OMITTED AS PER SB-12 3.1.1.9(4) MAX 19.9 S.F. REFER TO ELEVATION FOR LOCATION | | | | | 0.00 S.F. | | | | * OPENINGS OMITTED AS PER SB-12 3.1.1.9(4) MAX 19.9 S.F. REFER TO ELEVATION FOR LOCATION | | | | | 0.00 S.F. | | | | | | |
| TOTAL SQ. FT. | | 3878.00 S.F. | | | 502.16 S.F. | | 12.95 % | | TOTAL SQ. FT. | | 3889.00 S.F. | | | 504.16 S.F. | | 12.96 % | | TOTAL SQ. FT. | | 3936.00 S.F. | | | 518.38 S.F. | | 13.17 % | | | | |
| TOTAL SQ. M. | | 360.27 S.M. | | | 46.65 S.M. | | 12.95 % | | TOTAL SQ. M. | | 361.30 S.M. | | | 46.84 S.M. | | 12.96 % | | TOTAL SQ. M. | | 365.66 S.M. | | | 48.16 S.M. | | 13.17 % | | | | |
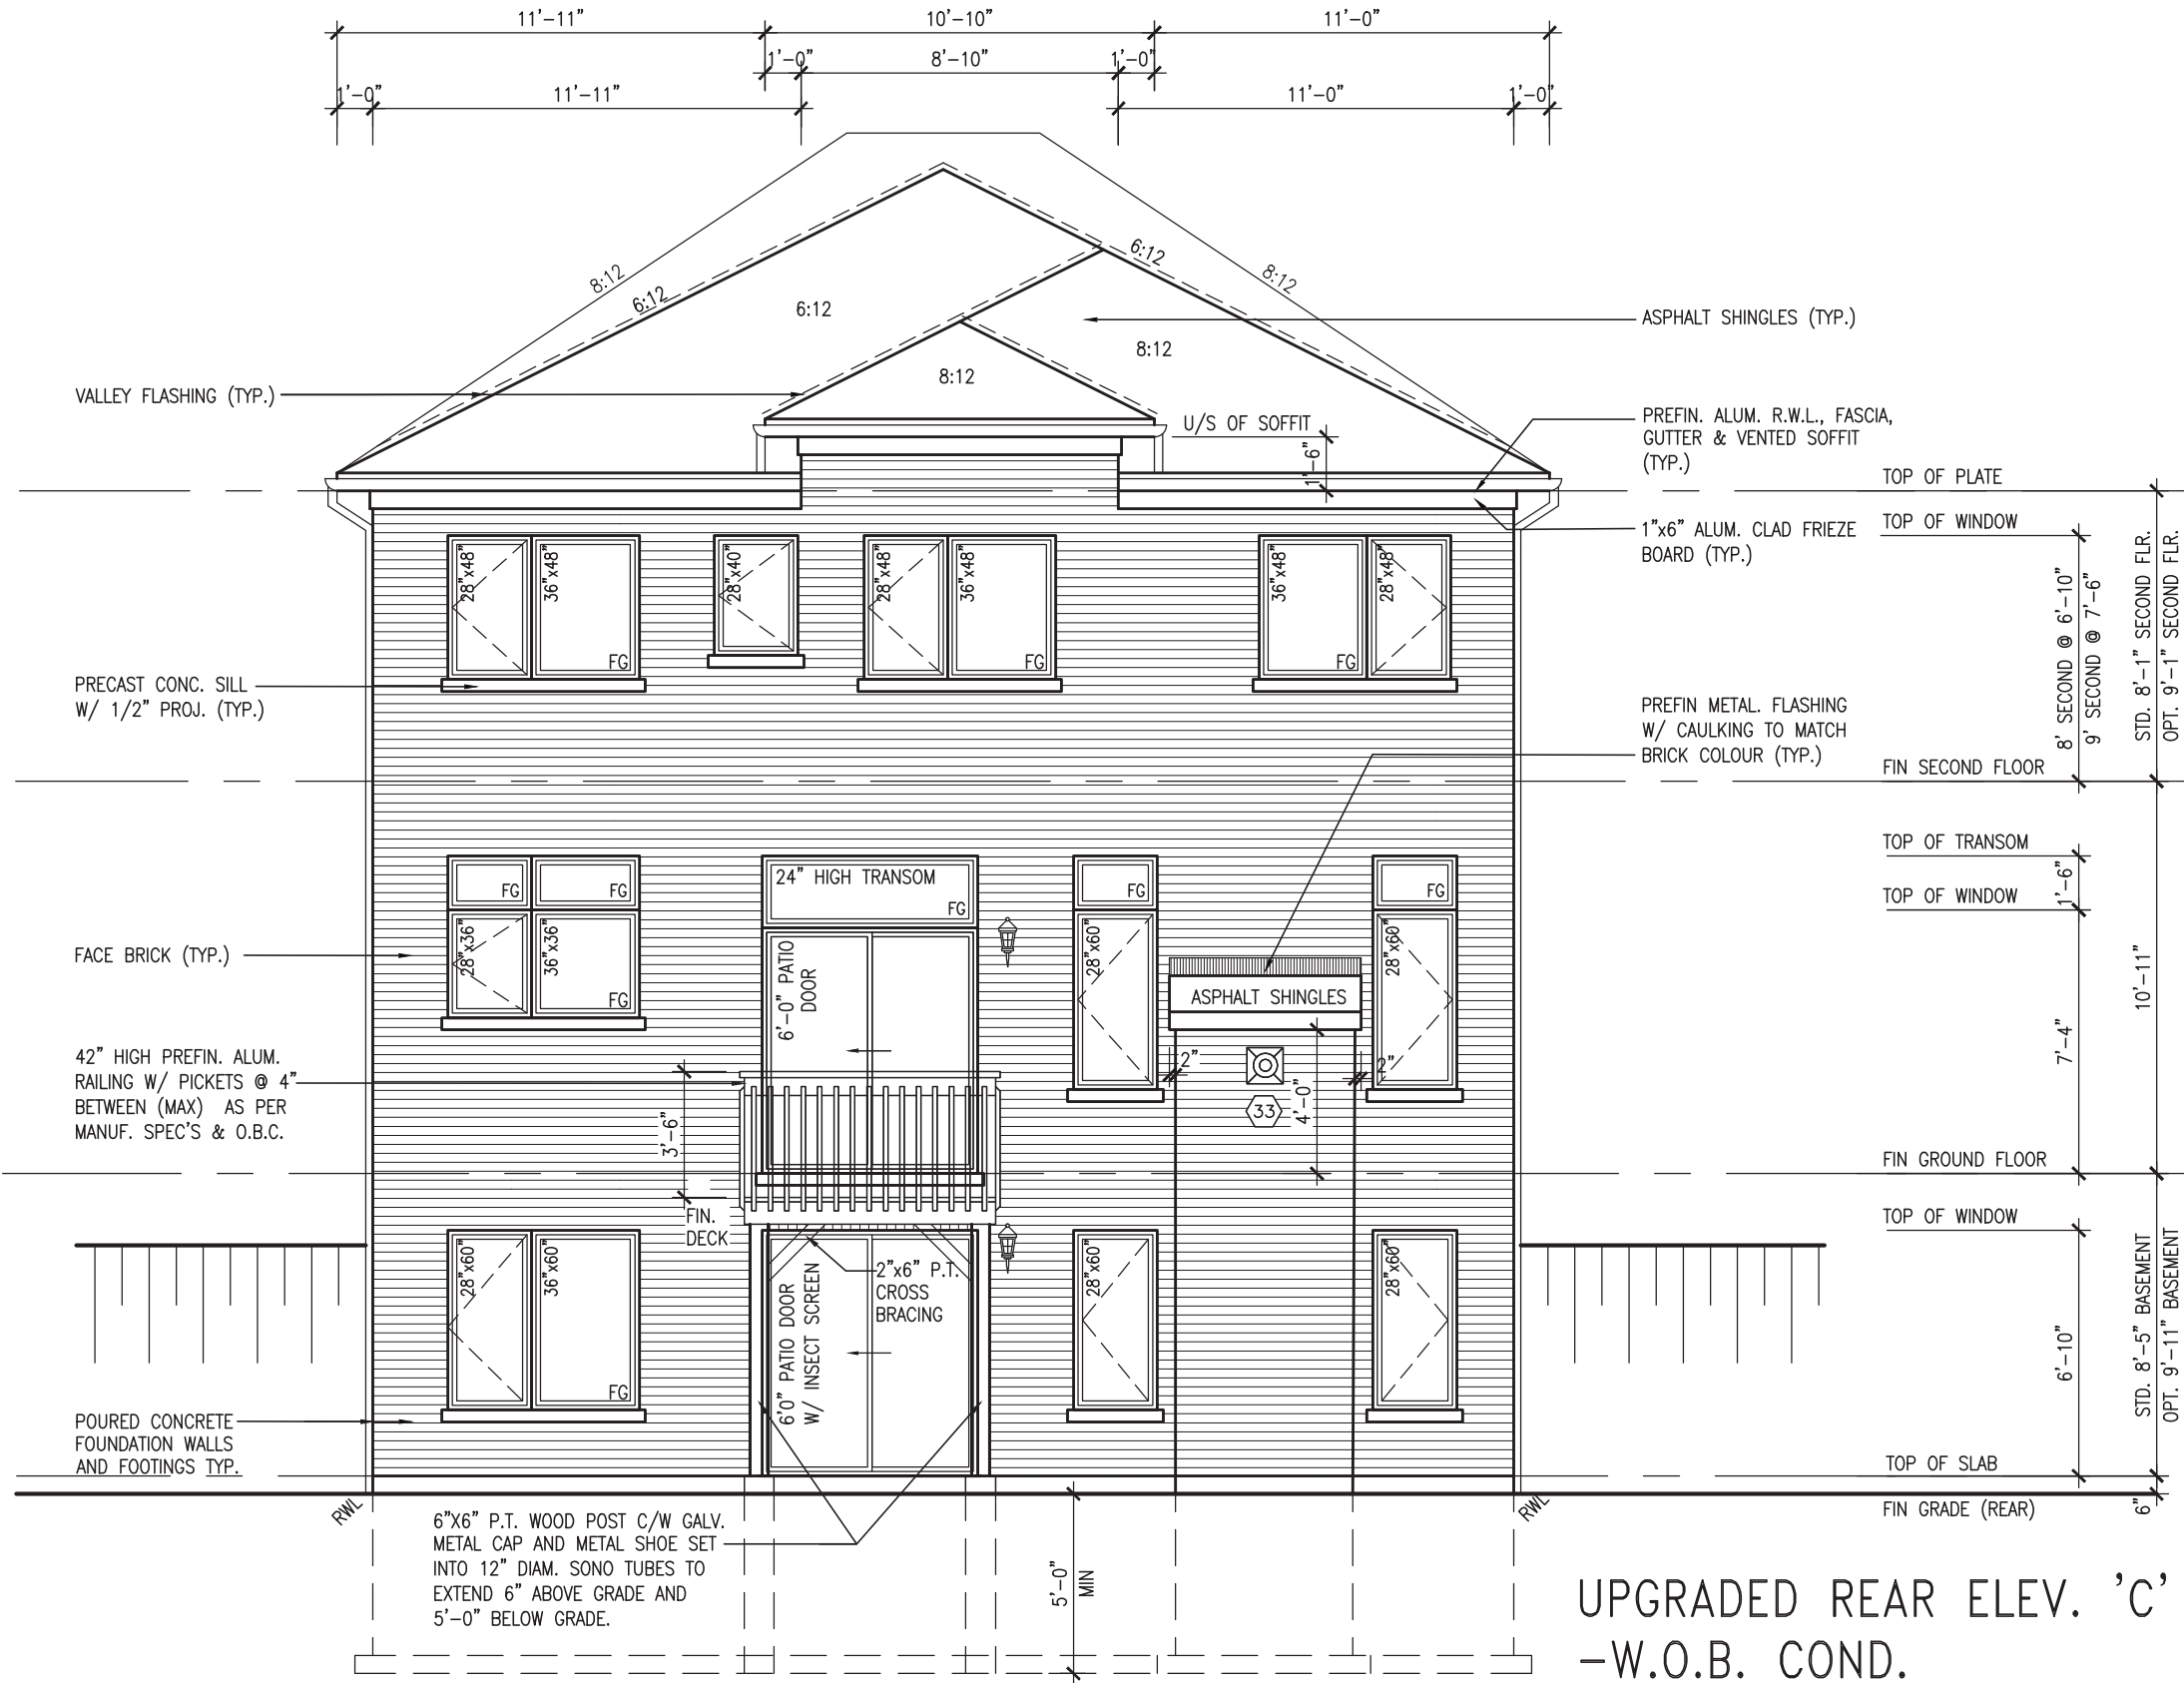
| UNINSULATED OPENINGS (PER OBC. SB-12,3.1.1(7)) | | | | | | UNINSULATED OPENINGS (PER OBC. SB-12,3.1.1(7)) | | | | | | UNINSULATED OPENINGS (PER OBC. SB-12,3.1.1(7)) | | | | | | | | |
|--|--|--|------------------------------|---------|-------|--|------------------------|------|------------------------------|-----------|--|--|------------------------|---------|------------------------------|---------|------|------------|---|--|
| STANDARD & REAR UPGRADE STD SEC. FL. | S38-20 ELEVATION A WOD | | ENERGY EFFICIENCY – OBC SB12 | | | STANDARD & REAR UPGRADE STD SEC. FL. | S38-20 ELEVATION B WOD | | ENERGY EFFICIENCY – OBC SB12 | | | STANDARD REAR & STD SEC. FL. | S38-20 ELEVATION C WOD | | ENERGY EFFICIENCY – OBC SB12 | | | | | |
| | ELEVATION | | WALL | AREA | S.F. | | OPENING | S.F. | PERCENTAGE | ELEVATION | | | WALL | AREA | S.F. | OPENING | S.F. | PERCENTAGE | | |
| | FRONT | | | 677 | S.F. | | 150.28 | S.F. | 22.20 | % | FRONT | | | 688 | S.F. | 152.28 | S.F. | 22.13 | % | |
| | LEFT SIDE | | | 1274 | S.F. | | 96.00 | S.F. | 7.54 | % | LEFT SIDE | | | 1274 | S.F. | 96.00 | S.F. | 7.54 | % | |
| | RIGHT SIDE | | | 1260 | S.F. | | 78.00 | S.F. | 6.19 | % | RIGHT SIDE | | | 1260 | S.F. | 78.00 | S.F. | 6.19 | % | |
| | REAR | | | 794 | S.F. | | 192.79 | S.F. | 24.28 | % | REAR | | | 794 | S.F. | 192.79 | S.F. | 24.28 | % | |
| | * OPENINGS OMITTED AS PER SB-12 3.1.1.9(4) MAX 19.9 S.F. REFER TO ELEVATION FOR LOCATION | | | | | | | 0.00 | S.F. | | * OPENINGS OMITTED AS PER SB-12 3.1.1.9(4) MAX 19.9 S.F. REFER TO ELEVATION FOR LOCATION | | | | | | 0.00 | S.F. | | |
| | TOTAL SQ. FT. | | | 4005.00 | S.F. | | 517.07 | S.F. | 12.91 | % | TOTAL SQ. FT. | | | 4016.00 | S.F. | 519.07 | S.F. | 12.93 | % | |
| TOTAL SQ. M. | | | 372.07 | S.M. | 48.04 | S.M. | 12.91 | % | TOTAL SQ. M. | | | 373.10 | S.M. | 48.22 | S.M. | 12.93 | % | | | |
| UNINSULATED OPENINGS (PER OBC. SB-12,3.1.1(7)) | | | | | | UNINSULATED OPENINGS (PER OBC. SB-12,3.1.1(7)) | | | | | | UNINSULATED OPENINGS (PER OBC. SB-12,3.1.1(7)) | | | | | | | | |
| STANDARD & REAR UPGRADE OPT. SEC. FL. | S38-20 ELEVATION A WOD | | ENERGY EFFICIENCY – OBC SB12 | | | STANDARD & REAR UPGRADE OPT. SEC. FL. | S38-20 ELEVATION B WOD | | ENERGY EFFICIENCY – OBC SB12 | | | STANDARD REAR & OPT. SEC. FL. | S38-20 ELEVATION C WOD | | ENERGY EFFICIENCY – OBC SB12 | | | | | |
| | ELEVATION | | WALL | AREA | S.F. | | OPENING | S.F. | PERCENTAGE | ELEVATION | | | WALL | AREA | S.F. | OPENING | S.F. | PERCENTAGE | | |
| | FRONT | | | 677 | S.F. | | 150.28 | S.F. | 22.20 | % | FRONT | | | 688 | S.F. | 152.28 | S.F. | 22.13 | % | |
| | LEFT SIDE | | | 1274 | S.F. | | 96.00 | S.F. | 7.54 | % | LEFT SIDE | | | 1274 | S.F. | 96.00 | S.F. | 7.29 | % | |
| | RIGHT SIDE | | | 1260 | S.F. | | 87.33 | S.F. | 6.93 | % | RIGHT SIDE | | | 1260 | S.F. | 87.33 | S.F. | 6.83 | % | |
| | REAR | | | 794 | S.F. | | 192.79 | S.F. | 24.28 | % | REAR | | | 794 | S.F. | 192.79 | S.F. | 24.28 | % | |
| | * OPENINGS OMITTED AS PER SB-12 3.1.1.9(4) MAX 19.9 S.F. REFER TO ELEVATION FOR LOCATION | | | | | | | 0.00 | S.F. | | * OPENINGS OMITTED AS PER SB-12 3.1.1.9(4) MAX 19.9 S.F. REFER TO ELEVATION FOR LOCATION | | | | | | 0.00 | S.F. | | |
| | TOTAL SQ. FT. | | | 4005.00 | S.F. | | 526.40 | S.F. | 13.14 | % | TOTAL SQ. FT. | | | 4016.00 | S.F. | 528.40 | S.F. | 13.16 | % | |
| TOTAL SQ. M. | | | 372.07 | S.M. | 48.90 | S.M. | 13.14 | % | TOTAL SQ. M. | | | 373.10 | S.M. | 49.09 | S.M. | 13.16 | % | | | |

[illegible]

| UNINSULATED OPENINGS (PER OBC. SB-12,3.1.1(7)) | | | | | | UNINSULATED OPENINGS (PER OBC. SB-12,3.1.1(7)) | | | | | | UNINSULATED OPENINGS (PER OBC. SB-12,3.1.1(7)) | | |--|--|--------|------------------------------|------|-------|--|-------------------------------|------------------------|------------|------------------------------|--------------|--|--|-------------------------------|------------------------|---------|------------------------------|------------|-----------|------|-------|--------------|------|--|------|------------|-------|------|--------|-------|------|-------|--|---|--|
| UPGRADED REAR & STD SEC. FL. | S38-20 ELEVATION C | | ENERGY EFFICIENCY – OBC SB12 | | | | UPGRADED REAR & STD SEC. FL. | S38-20 ELEVATION C WOD | | ENERGY EFFICIENCY – OBC SB12 | | | | UPGRADED REAR & STD SEC. FL. | S38-20 ELEVATION C WOB | | ENERGY EFFICIENCY – OBC SB12 | | | | | | | | | | | | | | | | | | |
| | ELEVATION | | WALL | AREA | S.F. | OPENING | | S.F. | PERCENTAGE | ELEVATION | | WALL | AREA | | S.F. | OPENING | S.F. | PERCENTAGE | ELEVATION | | WALL | AREA | S.F. | OPENING | S.F. | PERCENTAGE | | | | | | | | | |
| | FRONT | | 675 | | S.F. | 166.50 | | S.F. | 24.67 | | % | FRONT | | | 675 | | S.F. | 166.50 | | S.F. | 24.67 | | % | FRONT | | 675 | | S.F. | 166.50 | | S.F. | 24.67 | | % | |
| | LEFT SIDE | | 1316 | | S.F. | 96.00 | | S.F. | 7.29 | | % | LEFT SIDE | | | 1316 | | S.F. | 96.00 | | S.F. | 7.29 | | % | LEFT SIDE | | 1316 | | S.F. | 96.00 | | S.F. | 7.29 | | % | |
| | RIGHT SIDE | | 1278 | | S.F. | 78.00 | | S.F. | 6.10 | | % | RIGHT SIDE | | | 1278 | | S.F. | 78.00 | | S.F. | 6.10 | | % | RIGHT SIDE | | 1278 | | S.F. | 78.00 | | S.F. | 6.10 | | % | |
| | REAR | | 667 | | S.F. | 185.78 | | S.F. | 27.85 | | % | REAR | | | 794 | | S.F. | 212.44 | | S.F. | 26.76 | | % | REAR | | 886 | | S.F. | 270.11 | | S.F. | 30.49 | | % | |
| | * OPENINGS OMITTED AS PER SB-12 3.1.1.9(4) MAX 19.9 S.F. REFER TO ELEVATION FOR LOCATION | | | | | | | 0.00 | | S.F. | | | * OPENINGS OMITTED AS PER SB-12 3.1.1.9(4) MAX 19.9 S.F. REFER TO ELEVATION FOR LOCATION | | | | | | 0.00 | | S.F. | | | * OPENINGS OMITTED AS PER SB-12 3.1.1.9(4) MAX 19.9 S.F. REFER TO ELEVATION FOR LOCATION | | | | | | 0.00 | | S.F. | | | |
| | TOTAL SQ. FT. | | 3936.00 | | S.F. | 526.28 | | S.F. | 13.37 | | % | TOTAL SQ. FT. | | | 4063.00 | | S.F. | 552.94 | | S.F. | 13.61 | | % | TOTAL SQ. FT. | | 4155.00 | | S.F. | 610.61 | | S.F. | 14.70 | | % | |
| TOTAL SQ. M. | | 365.66 | | S.M. | 48.89 | | S.M. | 13.37 | | % | TOTAL SQ. M. | | 377.46 | | S.M. | 51.37 | | S.M. | 13.61 | | % | TOTAL SQ. M. | | 386.01 | | S.M. | 56.73 | | S.M. | 14.70 | | % | | | |
| UNINSULATED OPENINGS (PER OBC. SB-12,3.1.1(7)) | | | | | | UNINSULATED OPENINGS (PER OBC. SB-12,3.1.1(7)) | | | | | | UNINSULATED OPENINGS (PER OBC. SB-12,3.1.1(7)) | | | UPGRADED REAR & OPT. SEC. FL. | S38-20 ELEVATION C | | ENERGY EFFICIENCY – OBC SB12 | | | | UPGRADED REAR & OPT. SEC. FL. | S38-20 ELEVATION C WOD | | ENERGY EFFICIENCY – OBC SB12 | | | | UPGRADED REAR & OPT. SEC. FL. | S38-20 ELEVATION C WOB | | ENERGY EFFICIENCY – OBC SB12 | | | | | | | | | | | | | | | | | | |
| | ELEVATION | | WALL | AREA | S.F. | OPENING | | S.F. | PERCENTAGE | ELEVATION | | WALL | AREA | | S.F. | OPENING | S.F. | PERCENTAGE | ELEVATION | | WALL | AREA | S.F. | OPENING | S.F. | PERCENTAGE | | | | | | | | | |
| | FRONT | | 675 | | S.F. | 166.50 | | S.F. | 24.67 | | % | FRONT | | | 675 | | S.F. | 166.50 | | S.F. | 24.67 | | % | FRONT | | 675 | | S.F. | 166.50 | | S.F. | 24.67 | | % | |
| | LEFT SIDE | | 1316 | | S.F. | 96.00 | | S.F. | 7.29 | | % | LEFT SIDE | | | 1316 | | S.F. | 96.00 | | S.F. | 7.29 | | % | LEFT SIDE | | 1316 | | S.F. | 96.00 | | S.F. | 7.29 | | % | |
| | RIGHT SIDE | | 1278 | | S.F. | 87.33 | | S.F. | 6.83 | | % | RIGHT SIDE | | | 1278 | | S.F. | 87.33 | | S.F. | 6.83 | | % | RIGHT SIDE | | 1278 | | S.F. | 87.33 | | S.F. | 6.83 | | % | |
| | REAR | | 667 | | S.F. | 185.78 | | S.F. | 27.85 | | % | REAR | | | 794 | | S.F. | 212.44 | | S.F. | 26.76 | | % | REAR | | 883 | | S.F. | 270.11 | | S.F. | 30.59 | | % | |
| | * OPENINGS OMITTED AS PER SB-12 3.1.1.9(4) MAX 19.9 S.F. REFER TO ELEVATION FOR LOCATION | | | | | | | 0.00 | | S.F. | | | * OPENINGS OMITTED AS PER SB-12 3.1.1.9(4) MAX 19.9 S.F. REFER TO ELEVATION FOR LOCATION | | | | | | 0.00 | | S.F. | | | * OPENINGS OMITTED AS PER SB-12 3.1.1.9(4) MAX 19.9 S.F. REFER TO ELEVATION FOR LOCATION | | | | | | 0.00 | | S.F. | | | |
| | TOTAL SQ. FT. | | 3936.00 | | S.F. | 535.61 | | S.F. | 13.61 | | % | TOTAL SQ. FT. | | | 4063.00 | | S.F. | 562.27 | | S.F. | 13.84 | | % | TOTAL SQ. FT. | | 4152.00 | | S.F. | 619.94 | | S.F. | 14.93 | | % | |
| TOTAL SQ. M. | | 365.66 | | S.M. | 49.76 | | S.M. | 13.61 | | % | TOTAL SQ. M. | | 377.46 | | S.M. | 52.24 | | S.M. | 13.84 | | % | TOTAL SQ. M. | | 385.73 | | S.M. | 57.59 | | S.M. | 14.93 | | % | | | |

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| <u>UNINSULATED OPENINGS</u> (PER OBC. SB-12,3.1.1(7)) | | | | | | | |
|---|--|------------------------------|---------|-------|---------|---------|------------|
| UPGRADED REAR & STD SEC. FL. 9'-0" BASEMENT | S38-20 ELEVATION C WOB | ENERGY EFFICIENCY – OBC SB12 | | | | | |
| | ELEVATION | WALL | AREA | S.F. | OPENING | S.F. | PERCENTAGE |
| | FRONT | | 675 | S.F. | 166.50 | S.F. | 24.67 % |
| | LEFT SIDE | | 1316 | S.F. | 96.00 | S.F. | 7.29 % |
| | RIGHT SIDE | | 1278 | S.F. | 78.00 | S.F. | 6.10 % |
| | REAR | | 918 | S.F. | 270.11 | S.F. | 29.42 % |
| | * OPENINGS OMITTED AS PER SB-12 3.1.1.9(4) MAX 19.9 S.F. REFER TO ELEVATION FOR LOCATION | | | | 0.00 | S.F. | |
| | TOTAL SQ. FT. | | 4187.00 | S.F. | 610.61 | S.F. | 14.58 % |
| TOTAL SQ. M. | | 388.98 | S.M. | 56.73 | S.M. | 14.58 % | |
| <u>UNINSULATED OPENINGS</u> (PER OBC. SB-12,3.1.1(7)) | | | | | | | |
| UPGRADED REAR & OPT. SEC. FL. 9'-0" BASEMENT | S38-20 ELEVATION C WOB | ENERGY EFFICIENCY – OBC SB12 | | | | | |
| | ELEVATION | WALL | AREA | S.F. | OPENING | S.F. | PERCENTAGE |
| | FRONT | | 675 | S.F. | 166.50 | S.F. | 24.67 % |
| | LEFT SIDE | | 1316 | S.F. | 96.00 | S.F. | 7.29 % |
| | RIGHT SIDE | | 1278 | S.F. | 87.33 | S.F. | 6.83 % |
| | REAR | | 918 | S.F. | 270.11 | S.F. | 29.42 % |
| | * OPENINGS OMITTED AS PER SB-12 3.1.1.9(4) MAX 19.9 S.F. REFER TO ELEVATION FOR LOCATION | | | | 0.00 | S.F. | |
| | TOTAL SQ. FT. | | 4187.00 | S.F. | 619.94 | S.F. | 14.81 % |
| TOTAL SQ. M. | | 388.98 | S.M. | 57.59 | S.M. | 14.81 % | |

| | |
|---|---|
| BAYVIEW WELLINGTON | S38-20 |
| project name GREEN VALLEY ESTATES | municipality BRADFORD EAST, ON. |
| date SEPT. 2021 | project no. 16023 |
| drawn by NC | drawing no. 58 |
| checked by JWM | SB12 CHARTS |
| scale 3/16" = 1'-0" | file name 16023-S38-20 |
| RICHARD — I:\ARCHIVE\WORKING\2016\16023.BW\Units\38\16023-S38-20.dwg — Tue — Mar 1 2022 — 2:40 PM | |

| UNINSULATED OPENINGS (PER OBC. SB-12,3.1.1(7)) | | | | | | UNINSULATED OPENINGS (PER OBC. SB-12,3.1.1(7)) | | | | | | UNINSULATED OPENINGS (PER OBC. SB-12,3.1.1(7)) | | | | | | |
|--|--|-------------|------------------------------|------------|-------------|--|------------------------|--------------|--|-------------|--------------|--|------------------------|---------|------------------------------|---------|------|------------|
| STANDARD & REAR UPGRADE STD SEC. FL. | S38-20 ELEVATION A WOD | | ENERGY EFFICIENCY – OBC SB12 | | | STANDARD & REAR UPGRADE STD SEC. FL. | S38-20 ELEVATION B WOD | | ENERGY EFFICIENCY – OBC SB12 | | | STANDARD REAR & STD SEC. FL. | S38-20 ELEVATION C WOD | | ENERGY EFFICIENCY – OBC SB12 | | | |
| | ELEVATION | | WALL | AREA | S.F. | | OPENING | S.F. | PERCENTAGE | ELEVATION | | | WALL | AREA | S.F. | OPENING | S.F. | PERCENTAGE |
| | FRONT | | 708 S.F. | | 150.28 S.F. | | 21.23 % | | FRONT | | 719 S.F. | | 152.28 S.F. | | 21.18 % | | | |
| | LEFT SIDE | | 1334 S.F. | | 96.00 S.F. | | 7.20 % | | LEFT SIDE | | 1334 S.F. | | 96.00 S.F. | | 7.20 % | | | |
| | RIGHT SIDE | | 1320 S.F. | | 78.00 S.F. | | 5.91 % | | RIGHT SIDE | | 1320 S.F. | | 78.00 S.F. | | 5.91 % | | | |
| | REAR | | 825 S.F. | | 192.79 S.F. | | 23.37 % | | REAR | | 825 S.F. | | 192.79 S.F. | | 23.37 % | | | |
| | * OPENINGS OMITTED AS PER SB-12 3.1.1.9(4) MAX 19.9 S.F. REFER TO ELEVATION FOR LOCATION | | | | 0.00 S.F. | | | | * OPENINGS OMITTED AS PER SB-12 3.1.1.9(4) MAX 19.9 S.F. REFER TO ELEVATION FOR LOCATION | | | | 0.00 S.F. | | | | | |
| | TOTAL SQ. FT. | | 4187.00 S.F. | | 517.07 S.F. | | 12.35 % | | TOTAL SQ. FT. | | 4198.00 S.F. | | 519.07 S.F. | | 12.36 % | | | |
| TOTAL SQ. M. | | 388.98 S.M. | | 48.04 S.M. | | 12.35 % | | TOTAL SQ. M. | | 390.00 S.M. | | 48.22 S.M. | | 12.36 % | | | | |
| UNINSULATED OPENINGS (PER OBC. SB-12,3.1.1(7)) | | | | | | UNINSULATED OPENINGS (PER OBC. SB-12,3.1.1(7)) | | | | | | UNINSULATED OPENINGS (PER OBC. SB-12,3.1.1(7)) | | | | | | |
| STANDARD & REAR UPGRADE OPT. SEC. FL. | S38-20 ELEVATION A WOD | | ENERGY EFFICIENCY – OBC SB12 | | | STANDARD & REAR UPGRADE OPT. SEC. FL. | S38-20 ELEVATION B WOD | | ENERGY EFFICIENCY – OBC SB12 | | | STANDARD REAR & OPT. SEC. FL. | S38-20 ELEVATION C WOD | | ENERGY EFFICIENCY – OBC SB12 | | | |
| | ELEVATION | | WALL | AREA | S.F. | | OPENING | S.F. | PERCENTAGE | ELEVATION | | | WALL | AREA | S.F. | OPENING | S.F. | PERCENTAGE |
| | FRONT | | 708 S.F. | | 150.28 S.F. | | 21.23 % | | FRONT | | 719 S.F. | | 152.28 S.F. | | 21.18 % | | | |
| | LEFT SIDE | | 1334 S.F. | | 96.00 S.F. | | 7.20 % | | LEFT SIDE | | 1334 S.F. | | 96.00 S.F. | | 7.20 % | | | |
| | RIGHT SIDE | | 1320 S.F. | | 87.33 S.F. | | 6.62 % | | RIGHT SIDE | | 1320 S.F. | | 87.33 S.F. | | 6.62 % | | | |
| | REAR | | 825 S.F. | | 192.79 S.F. | | 23.37 % | | REAR | | 825 S.F. | | 192.79 S.F. | | 23.37 % | | | |
| | * OPENINGS OMITTED AS PER SB-12 3.1.1.9(4) MAX 19.9 S.F. REFER TO ELEVATION FOR LOCATION | | | | 0.00 S.F. | | | | * OPENINGS OMITTED AS PER SB-12 3.1.1.9(4) MAX 19.9 S.F. REFER TO ELEVATION FOR LOCATION | | | | 0.00 S.F. | | | | | |
| | TOTAL SQ. FT. | | 4187.00 S.F. | | 526.40 S.F. | | 12.57 % | | TOTAL SQ. FT. | | 4198.00 S.F. | | 528.40 S.F. | | 12.59 % | | | |
| TOTAL SQ. M. | | 388.98 S.M. | | 48.90 S.M. | | 12.57 % | | TOTAL SQ. M. | | 390.00 S.M. | | 49.09 S.M. | | 12.59 % | | | | |

| UNINSULATED OPENINGS (PER OBC. SB-12,3.1.1(7)) | | | | | UNINSULATED OPENINGS (PER OBC. SB-12,3.1.1(7)) | | | | | UNINSULATED OPENINGS (PER OBC. SB-12,3.1.1(7)) | | | | | | | |
|--|--|-------------|------------------------------|--------------|--|---------------------------------------|--|------------|------------------------------|--|------------|-------------------------------|--|---------|------------------------------|--------------|------------|
| STANDARD & REAR UPGRADE STD SEC. FL. | S38-20 ELEVATION A WOB | | ENERGY EFFICIENCY – OBC SB12 | | | STANDARD & REAR UPGRADE STD SEC. FL. | S38-20 ELEVATION B WOB | | ENERGY EFFICIENCY – OBC SB12 | | | STANDARD REAR & STD SEC. FL. | S38-20 ELEVATION C WOB | | ENERGY EFFICIENCY – OBC SB12 | | |
| | ELEVATION | | WALL AREA S.F. | OPENING S.F. | PERCENTAGE | | ELEVATION | | WALL AREA S.F. | OPENING S.F. | PERCENTAGE | | ELEVATION | | WALL AREA S.F. | OPENING S.F. | PERCENTAGE |
| | FRONT | | 708 S.F. | 150.28 S.F. | 21.23 % | | FRONT | | 719 S.F. | 152.28 S.F. | 21.18 % | | FRONT | | 706 S.F. | 166.50 S.F. | 23.58 % |
| | LEFT SIDE | | 1334 S.F. | 96.00 S.F. | 7.20 % | | LEFT SIDE | | 1334 S.F. | 96.00 S.F. | 7.20 % | | LEFT SIDE | | 1378 S.F. | 96.00 S.F. | 6.97 % |
| | RIGHT SIDE | | 1320 S.F. | 78.00 S.F. | 5.91 % | | RIGHT SIDE | | 1320 S.F. | 78.00 S.F. | 5.91 % | | RIGHT SIDE | | 1340 S.F. | 78.00 S.F. | 5.82 % |
| | REAR | | 918 S.F. | 249.33 S.F. | 27.16 % | | REAR | | 918 S.F. | 249.33 S.F. | 27.16 % | | REAR | | 918 S.F. | 249.33 S.F. | 27.16 % |
| | * OPENINGS OMITTED AS PER SB-12 3.1.1.9(4) MAX 19.9 S.F. REFER TO ELEVATION FOR LOCATION | | | 0.00 S.F. | | | * OPENINGS OMITTED AS PER SB-12 3.1.1.9(4) MAX 19.9 S.F. REFER TO ELEVATION FOR LOCATION | | | 0.00 S.F. | | | * OPENINGS OMITTED AS PER SB-12 3.1.1.9(4) MAX 19.9 S.F. REFER TO ELEVATION FOR LOCATION | | | 0.00 S.F. | |
| | TOTAL SQ. FT. | | 4280.00 S.F. | 573.61 S.F. | 13.40 % | | TOTAL SQ. FT. | | 4291.00 S.F. | 575.61 S.F. | 13.41 % | | TOTAL SQ. FT. | | 4342.00 S.F. | 589.83 S.F. | 13.58 % |
| TOTAL SQ. M. | | 397.62 S.M. | 53.29 S.M. | 13.40 % | TOTAL SQ. M. | | 398.64 S.M. | 53.48 S.M. | 13.41 % | TOTAL SQ. M. | | 403.38 S.M. | 54.80 S.M. | 13.58 % | | | |
| UNINSULATED OPENINGS (PER OBC. SB-12,3.1.1(7)) | | | | | UNINSULATED OPENINGS (PER OBC. SB-12,3.1.1(7)) | | | | | UNINSULATED OPENINGS (PER OBC. SB-12,3.1.1(7)) | | | | | | | |
| STANDARD & REAR UPGRADE OPT. SEC. FL. | S38-20 ELEVATION A WOB | | ENERGY EFFICIENCY – OBC SB12 | | | STANDARD & REAR UPGRADE OPT. SEC. FL. | S38-20 ELEVATION B WOB | | ENERGY EFFICIENCY – OBC SB12 | | | STANDARD REAR & OPT. SEC. FL. | S38-20 ELEVATION C WOB | | ENERGY EFFICIENCY – OBC SB12 | | |
| | ELEVATION | | WALL AREA S.F. | OPENING S.F. | PERCENTAGE | | ELEVATION | | WALL AREA S.F. | OPENING S.F. | PERCENTAGE | | ELEVATION | | WALL AREA S.F. | OPENING S.F. | PERCENTAGE |
| | FRONT | | 708 S.F. | 150.28 S.F. | 21.23 % | | FRONT | | 719 S.F. | 152.28 S.F. | 21.18 % | | FRONT | | 706 S.F. | 166.50 S.F. | 23.58 % |
| | LEFT SIDE | | 1334 S.F. | 96.00 S.F. | 7.20 % | | LEFT SIDE | | 1334 S.F. | 96.00 S.F. | 7.20 % | | LEFT SIDE | | 1378 S.F. | 96.00 S.F. | 6.97 % |
| | RIGHT SIDE | | 1320 S.F. | 87.33 S.F. | 6.62 % | | RIGHT SIDE | | 1320 S.F. | 87.33 S.F. | 6.62 % | | RIGHT SIDE | | 1340 S.F. | 87.33 S.F. | 6.52 % |
| | REAR | | 918 S.F. | 249.33 S.F. | 27.16 % | | REAR | | 918 S.F. | 249.33 S.F. | 27.16 % | | REAR | | 918 S.F. | 249.33 S.F. | 27.16 % |
| | * OPENINGS OMITTED AS PER SB-12 3.1.1.9(4) MAX 19.9 S.F. REFER TO ELEVATION FOR LOCATION | | | 0.00 S.F. | | | * OPENINGS OMITTED AS PER SB-12 3.1.1.9(4) MAX 19.9 S.F. REFER TO ELEVATION FOR LOCATION | | | 0.00 S.F. | | | * OPENINGS OMITTED AS PER SB-12 3.1.1.9(4) MAX 19.9 S.F. REFER TO ELEVATION FOR LOCATION | | | 0.00 S.F. | |
| | TOTAL SQ. FT. | | 4280.00 S.F. | 582.94 S.F. | 13.62 % | | TOTAL SQ. FT. | | 4291.00 S.F. | 584.94 S.F. | 13.63 % | | TOTAL SQ. FT. | | 4342.00 S.F. | 599.16 S.F. | 13.80 % |
| TOTAL SQ. M. | | 397.62 S.M. | 54.16 S.M. | 13.62 % | TOTAL SQ. M. | | 398.64 S.M. | 54.34 S.M. | 13.63 % | TOTAL SQ. M. | | 403.38 S.M. | 55.66 S.M. | 13.80 % | | | |

| UNINSULATED OPENINGS (PER OBC. SB-12,3.1.1(7)) | | | | | UNINSULATED OPENINGS (PER OBC. SB-12,3.1.1(7)) | | | | | UNINSULATED OPENINGS (PER OBC. SB-12,3.1.1(7)) | | | | | | | |
|--|--|-------------|------------------------------|--------------|--|-------------------------------|--|------------|------------------------------|--|------------|-------------------------------|--|---------|------------------------------|--------------|------------|
| UPGRADED REAR & STD SEC. FL. | S38-20 ELEVATION C | | ENERGY EFFICIENCY – OBC SB12 | | | UPGRADED REAR & STD SEC. FL. | S38-20 ELEVATION C WOD | | ENERGY EFFICIENCY – OBC SB12 | | | UPGRADED REAR & STD SEC. FL. | S38-20 ELEVATION C WOB | | ENERGY EFFICIENCY – OBC SB12 | | |
| | ELEVATION | | WALL AREA S.F. | OPENING S.F. | PERCENTAGE | | ELEVATION | | WALL AREA S.F. | OPENING S.F. | PERCENTAGE | | ELEVATION | | WALL AREA S.F. | OPENING S.F. | PERCENTAGE |
| | FRONT | | 706 S.F. | 166.50 S.F. | 23.58 % | | FRONT | | 706 S.F. | 166.50 S.F. | 23.58 % | | FRONT | | 706 S.F. | 166.50 S.F. | 23.58 % |
| | LEFT SIDE | | 1378 S.F. | 96.00 S.F. | 6.97 % | | LEFT SIDE | | 1378 S.F. | 96.00 S.F. | 6.97 % | | LEFT SIDE | | 1378 S.F. | 96.00 S.F. | 6.97 % |
| | RIGHT SIDE | | 1340 S.F. | 78.00 S.F. | 5.82 % | | RIGHT SIDE | | 1340 S.F. | 78.00 S.F. | 5.82 % | | RIGHT SIDE | | 1340 S.F. | 78.00 S.F. | 5.82 % |
| | REAR | | 698 S.F. | 185.78 S.F. | 26.62 % | | REAR | | 825 S.F. | 212.44 S.F. | 25.75 % | | REAR | | 918 S.F. | 270.11 S.F. | 29.42 % |
| | * OPENINGS OMITTED AS PER SB-12 3.1.1.9(4) MAX 19.9 S.F. REFER TO ELEVATION FOR LOCATION | | | 0.00 S.F. | | | * OPENINGS OMITTED AS PER SB-12 3.1.1.9(4) MAX 19.9 S.F. REFER TO ELEVATION FOR LOCATION | | | 0.00 S.F. | | | * OPENINGS OMITTED AS PER SB-12 3.1.1.9(4) MAX 19.9 S.F. REFER TO ELEVATION FOR LOCATION | | | 0.00 S.F. | |
| | TOTAL SQ. FT. | | 4122.00 S.F. | 526.28 S.F. | 12.77 % | | TOTAL SQ. FT. | | 4249.00 S.F. | 552.94 S.F. | 13.01 % | | TOTAL SQ. FT. | | 4342.00 S.F. | 610.61 S.F. | 14.06 % |
| TOTAL SQ. M. | | 382.94 S.M. | 48.89 S.M. | 12.77 % | TOTAL SQ. M. | | 394.74 S.M. | 51.37 S.M. | 13.01 % | TOTAL SQ. M. | | 403.38 S.M. | 56.73 S.M. | 14.06 % | | | |
| UNINSULATED OPENINGS (PER OBC. SB-12,3.1.1(7)) | | | | | UNINSULATED OPENINGS (PER OBC. SB-12,3.1.1(7)) | | | | | UNINSULATED OPENINGS (PER OBC. SB-12,3.1.1(7)) | | | | | | | |
| UPGRADED REAR & OPT. SEC. FL. | S38-20 ELEVATION C | | ENERGY EFFICIENCY – OBC SB12 | | | UPGRADED REAR & OPT. SEC. FL. | S38-20 ELEVATION C WOD | | ENERGY EFFICIENCY – OBC SB12 | | | UPGRADED REAR & OPT. SEC. FL. | S38-20 ELEVATION C WOB | | ENERGY EFFICIENCY – OBC SB12 | | |
| | ELEVATION | | WALL AREA S.F. | OPENING S.F. | PERCENTAGE | | ELEVATION | | WALL AREA S.F. | OPENING S.F. | PERCENTAGE | | ELEVATION | | WALL AREA S.F. | OPENING S.F. | PERCENTAGE |
| | FRONT | | 706 S.F. | 166.50 S.F. | 23.58 % | | FRONT | | 706 S.F. | 166.50 S.F. | 23.58 % | | FRONT | | 706 S.F. | 166.50 S.F. | 23.58 % |
| | LEFT SIDE | | 1378 S.F. | 96.00 S.F. | 6.97 % | | LEFT SIDE | | 1378 S.F. | 96.00 S.F. | 6.97 % | | LEFT SIDE | | 1378 S.F. | 96.00 S.F. | 6.97 % |
| | RIGHT SIDE | | 1340 S.F. | 87.33 S.F. | 6.52 % | | RIGHT SIDE | | 1340 S.F. | 87.33 S.F. | 6.52 % | | RIGHT SIDE | | 1340 S.F. | 87.33 S.F. | 6.52 % |
| | REAR | | 698 S.F. | 185.78 S.F. | 26.62 % | | REAR | | 825 S.F. | 212.44 S.F. | 25.75 % | | REAR | | 918 S.F. | 270.11 S.F. | 29.42 % |
| | * OPENINGS OMITTED AS PER SB-12 3.1.1.9(4) MAX 19.9 S.F. REFER TO ELEVATION FOR LOCATION | | | 0.00 S.F. | | | * OPENINGS OMITTED AS PER SB-12 3.1.1.9(4) MAX 19.9 S.F. REFER TO ELEVATION FOR LOCATION | | | 0.00 S.F. | | | * OPENINGS OMITTED AS PER SB-12 3.1.1.9(4) MAX 19.9 S.F. REFER TO ELEVATION FOR LOCATION | | | 0.00 S.F. | |
| | TOTAL SQ. FT. | | 4122.00 S.F. | 535.61 S.F. | 12.99 % | | TOTAL SQ. FT. | | 4249.00 S.F. | 562.27 S.F. | 13.23 % | | TOTAL SQ. FT. | | 4342.00 S.F. | 619.94 S.F. | 14.28 % |
| TOTAL SQ. M. | | 382.94 S.M. | 49.76 S.M. | 12.99 % | TOTAL SQ. M. | | 394.74 S.M. | 52.24 S.M. | 13.23 % | TOTAL SQ. M. | | 403.38 S.M. | 57.59 S.M. | 14.28 % | | | |

9' SECOND FLOOR

9

8

7

6

5

4

3

2

1

no.

description

date

by

REVISIONS

MAR 01-22 RC

FEB 24-22 RC

NOV 26-21 VA3

3

2

1

REVISED AS PER ENG COMMENTS

REVIEWED AS PER FLOOR / ROOF LAYOUTS

ISSUED FOR CLIENT REVIEW

4

3

2

1

name

registration information

signature

BCIN

Wellington Jno-Baptiste

VA3 Design Inc.

42658

25591

The undersigned has reviewed and takes responsibility for this design and has the qualifications and meets the requirements set out in the Ontario Building Code to be a Designer.

qualification information

25591

BCIN

VA3 DESIGN

255 Consumers Rd Suite 120

Toronto ON M2J 1R4

t 416.630.2255 f 416.630.4782

vo3design.com

project name

project no.

date

checked by

drawn by

scale

file name

drawing no.

BAYVIEW WELLINGTON

GREEN VALLEY ESTATES

SEPT. 2021

JWM

NC

3/16" = 1'-0"

16023-S38-20

60

S38-20

BRADFORD EAST, ON.

9' SEC. FL. SB12 CHARTS

16023

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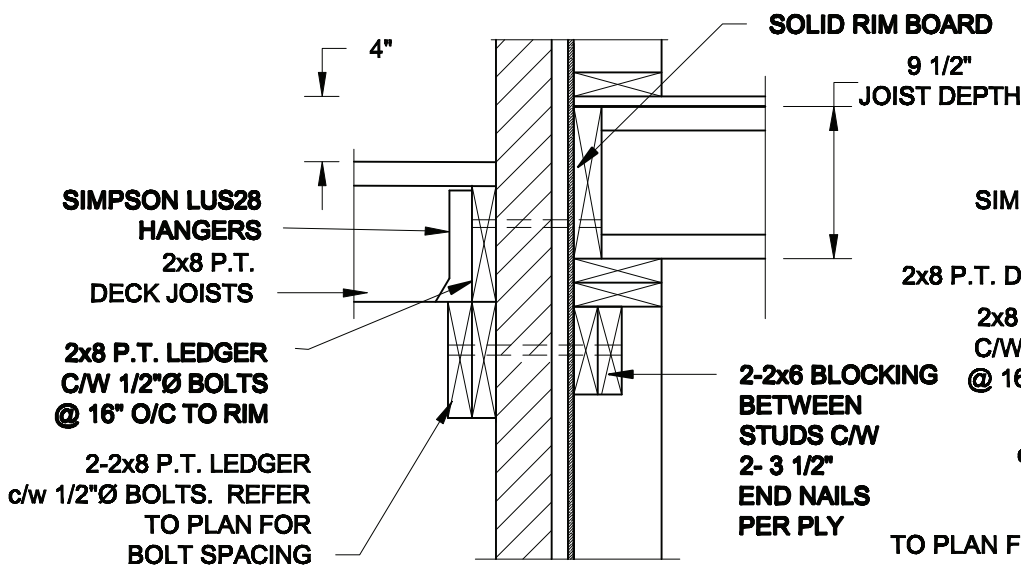
6. FLOW BROOK

VA3
DESIGN
255 Consumers Rd Suite
Toronto ON M2J 1R4
t 416.630.2255 f 416.630
va3design.com

[illegible]

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FOR 9 1/2" JOIST DEPTH



1A
S2


DECK FASTENING DETAIL

SCALE: 1" = 1'-0"


1B
S2

DECK FASTENING DETAIL

SCALE: 1" = 1'-0"

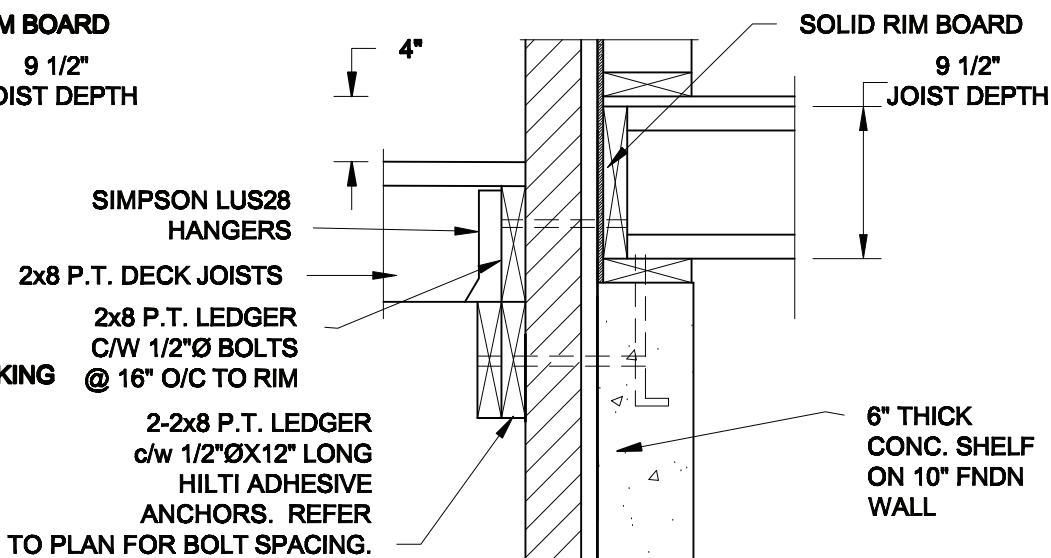


FOR 11 7/8" JOIST DEPTH

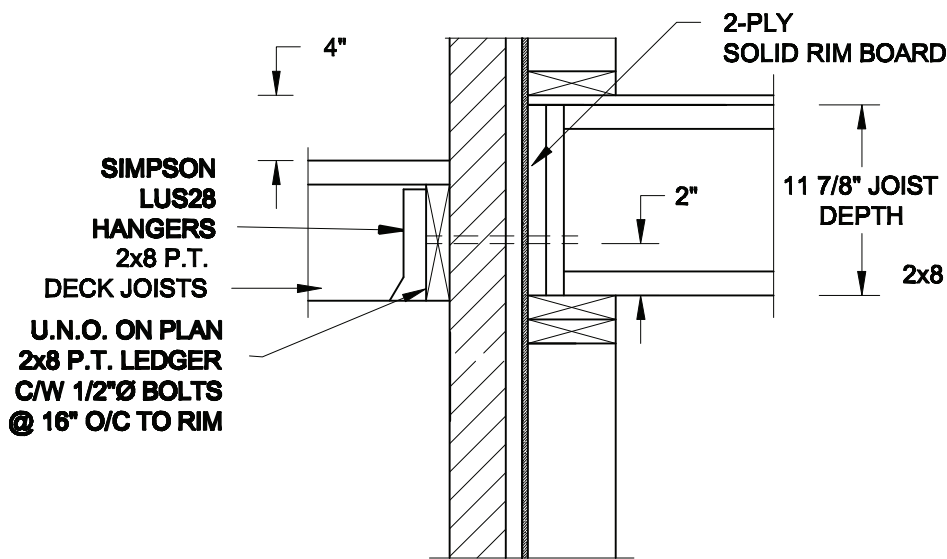

1C
S2

DECK FASTENING DETAIL

SCALE: 1" = 1'-0"

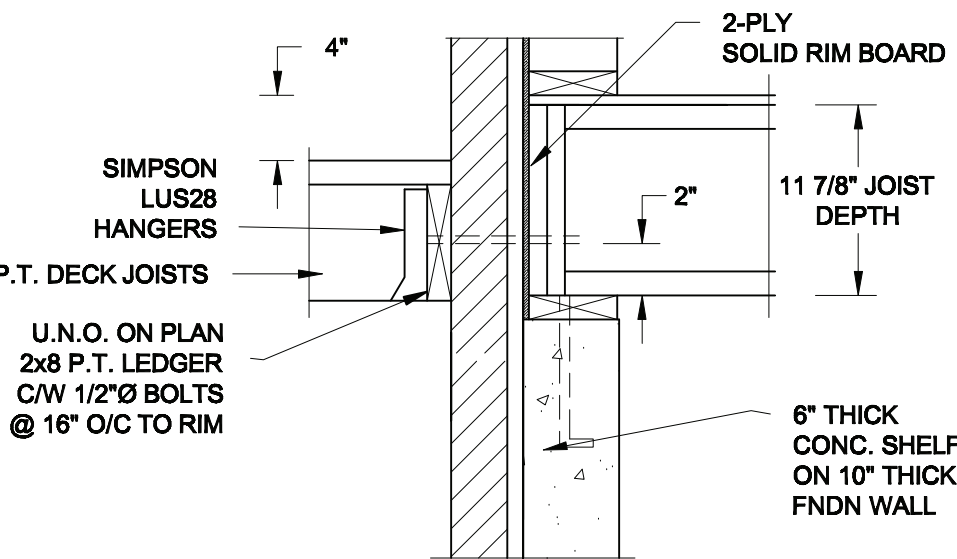


1D
S2

DECK FASTENING DETAIL

SCALE: 1" = 1'-0"

- NOTE: 1. WHERE BACKFILL HEIGHT < 4'-7", PROVIDE 2x6 @ 16" o/c KNEEWALL ON 10" THICK CONC FNDN WALL
2. WHERE BACKFILL HEIGHT > 4'-7", PROVIDE 6" CONC SHELF FOR BRICK VENEER ON 10" THICK CONC FNDN WALL
3. FOOTING TO BE 22"x6" THICK UNLESS NOTED OTHERWISE ON PLAN.

FOR 9 1/2" JOIST DEPTH

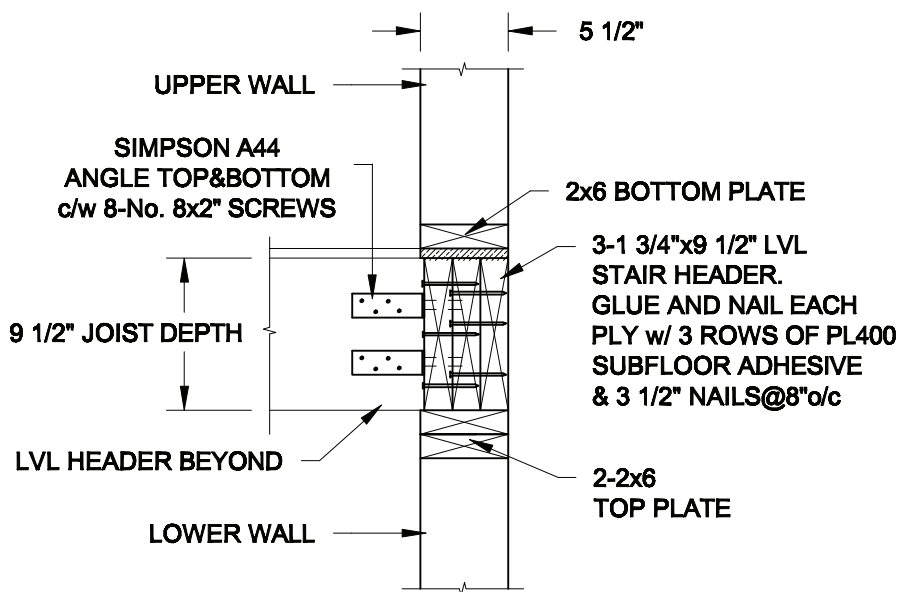


2A
S2

STAIR HEADER

SCALE: 1" = 1'-0"

FOR 11 7/8" JOIST DEPTH

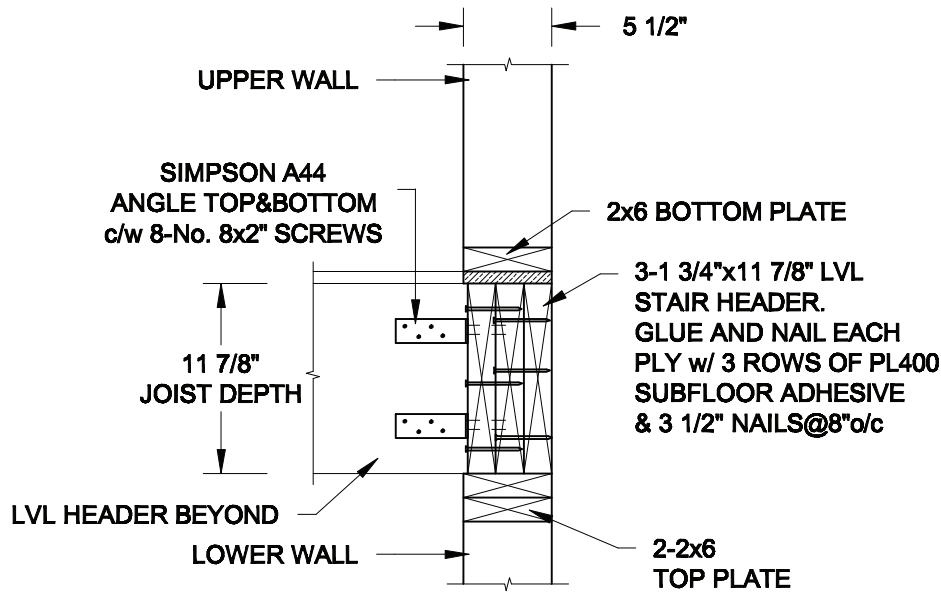

2B
S2

STAIR HEADER

SCALE: 1" = 1'-0"

Scale:
AS NOTED

Date:
MAR-15-2021

Drawn: SC
Checked: SJB

QUAILE ENGINEERING LTD.



38 Parkside Drive, UNIT 7
Newmarket, ON
L3Y 8J9
T: 905-853-8547
E: quaile.eng@rogers.com

Engineer's Seal



MAR 30, 2021

Project:

BAYVIEW WELLINGTON HOMES - GREEN VALLEY ESTATES - SINGLES
BRADFORD, ONTARIO





TYPICAL STRUCTURAL DETAILS



Project No.:


21-038

Drawing No.:

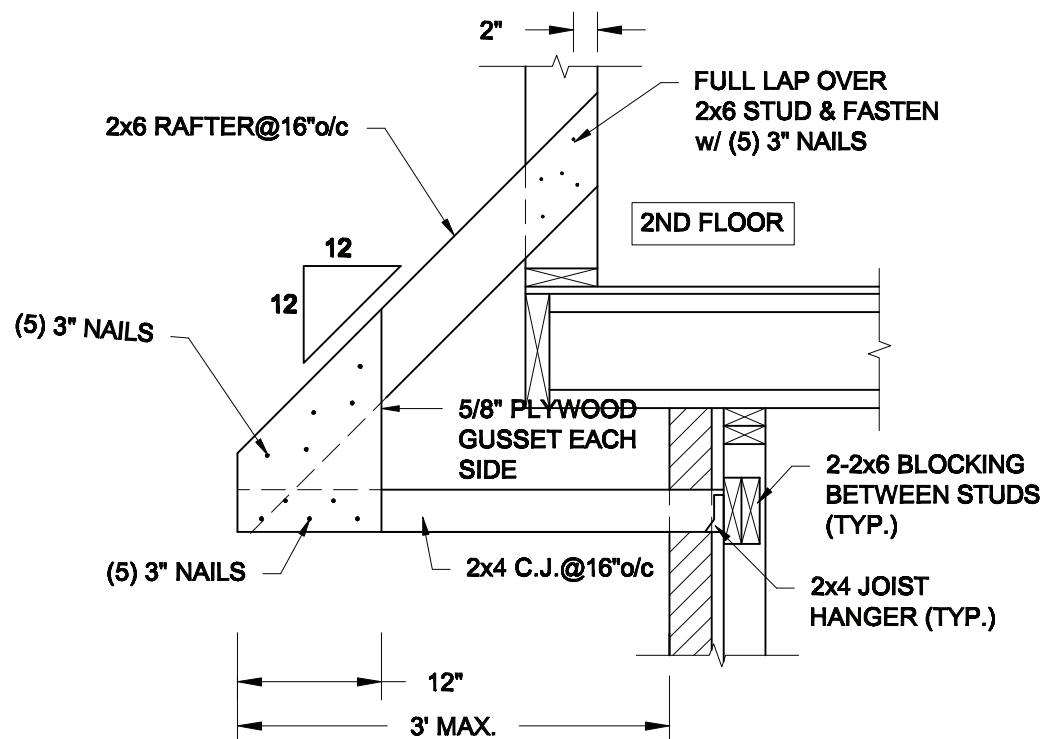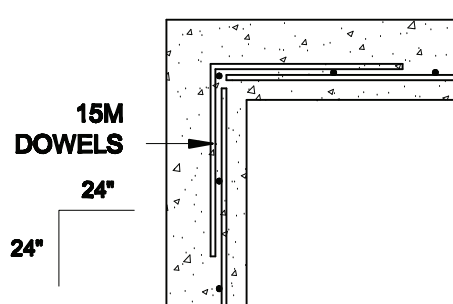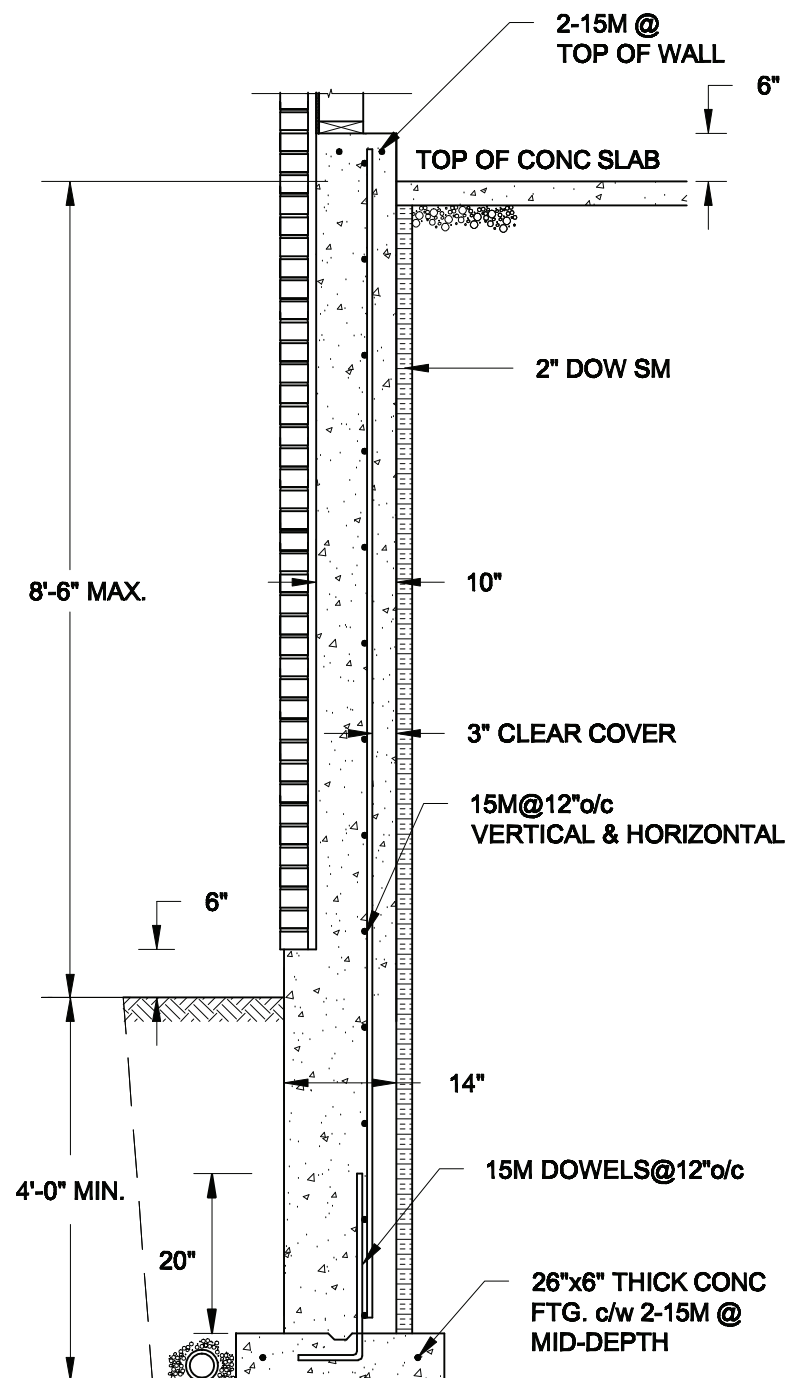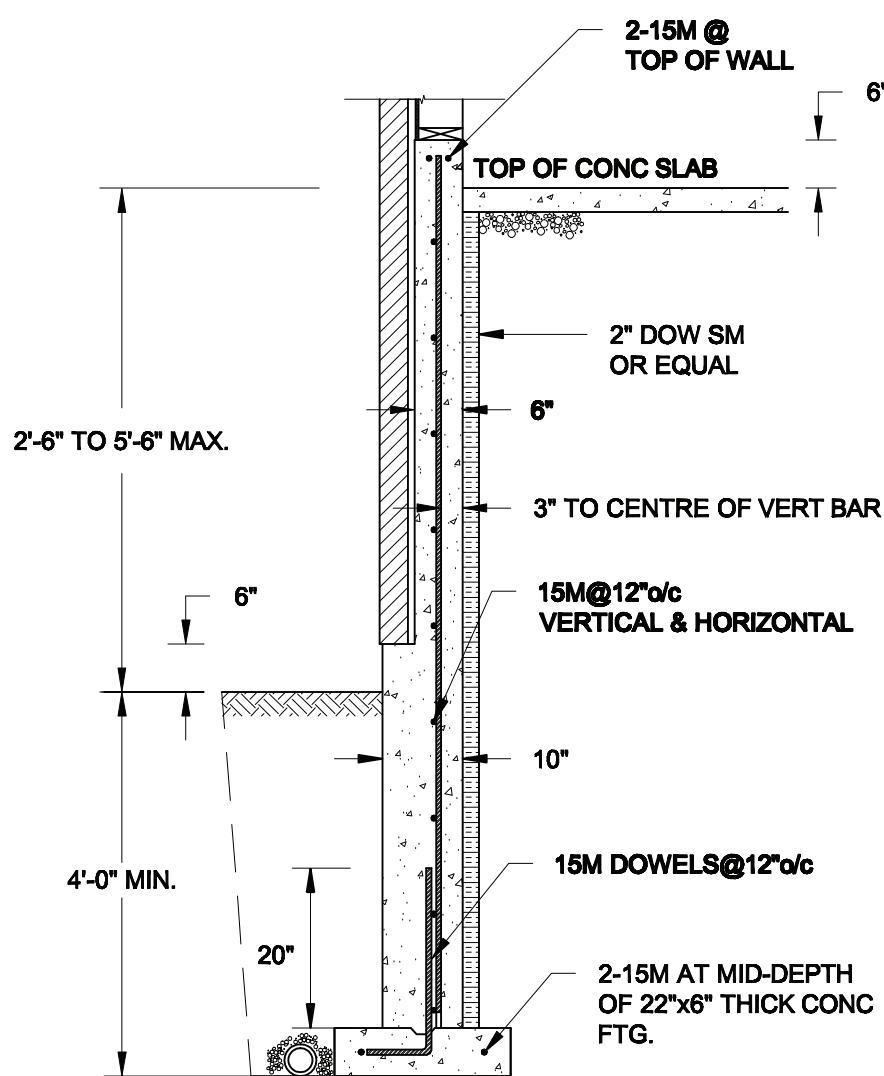
S2




| | | | |
|-----------------------------|---|---|---|
| Scale: AS NOTED | QUAILE ENGINEERING LTD.  38 Parkside Drive, UNIT 7 Newmarket, ON L3Y 8J9 T: 905-853-8547 E: quaile.eng@rogers.com | Engineer's Seal:  FEB 24, 2022 | Project: BAYVIEW WELLINGTON HOMES - GREEN VALLEY ESTATES - SINGLES BRADFORD, ONTARIO |
| Date: FEB-24-2022 | | TYPICAL STRUCTURAL DETAILS | |
| Drawn: SC | | Checked: SJB | Project No.: 21-038 |

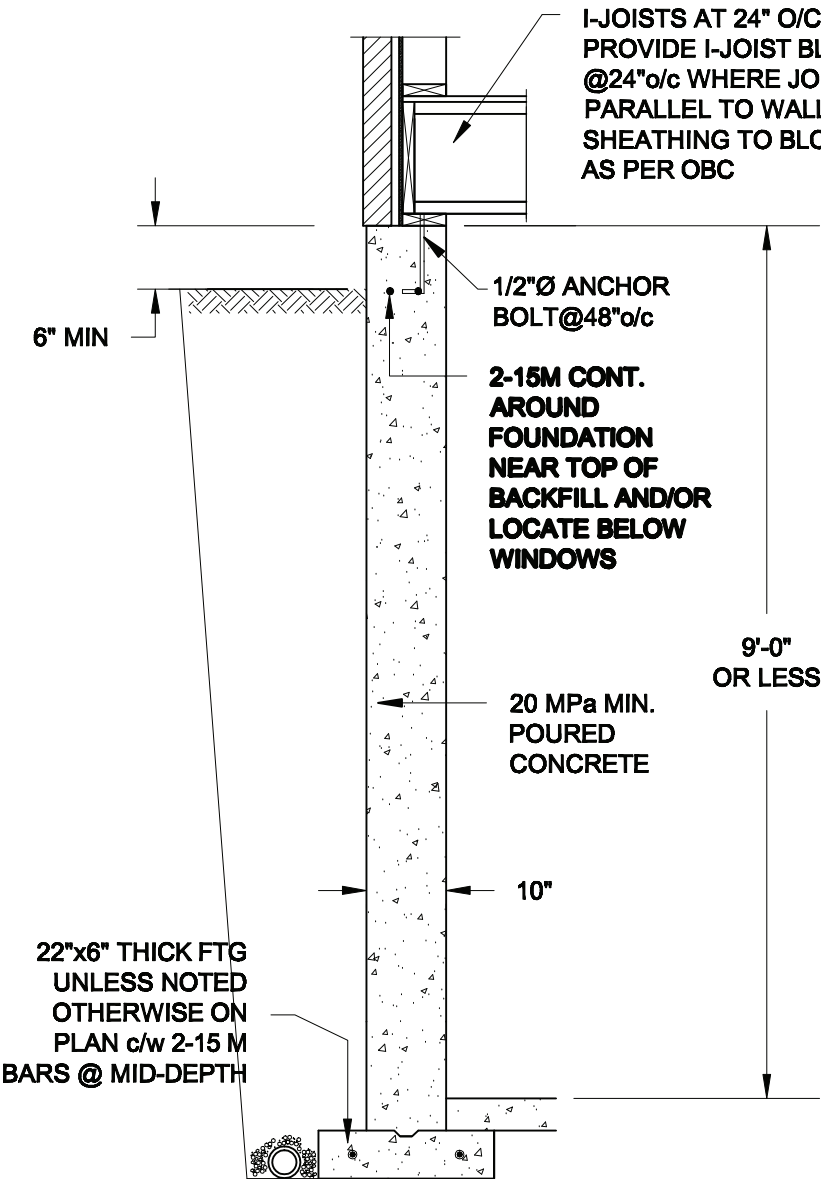

1A
S4 **FOUNDATION WALL**
SCALE: 1/2" = 1'-0"

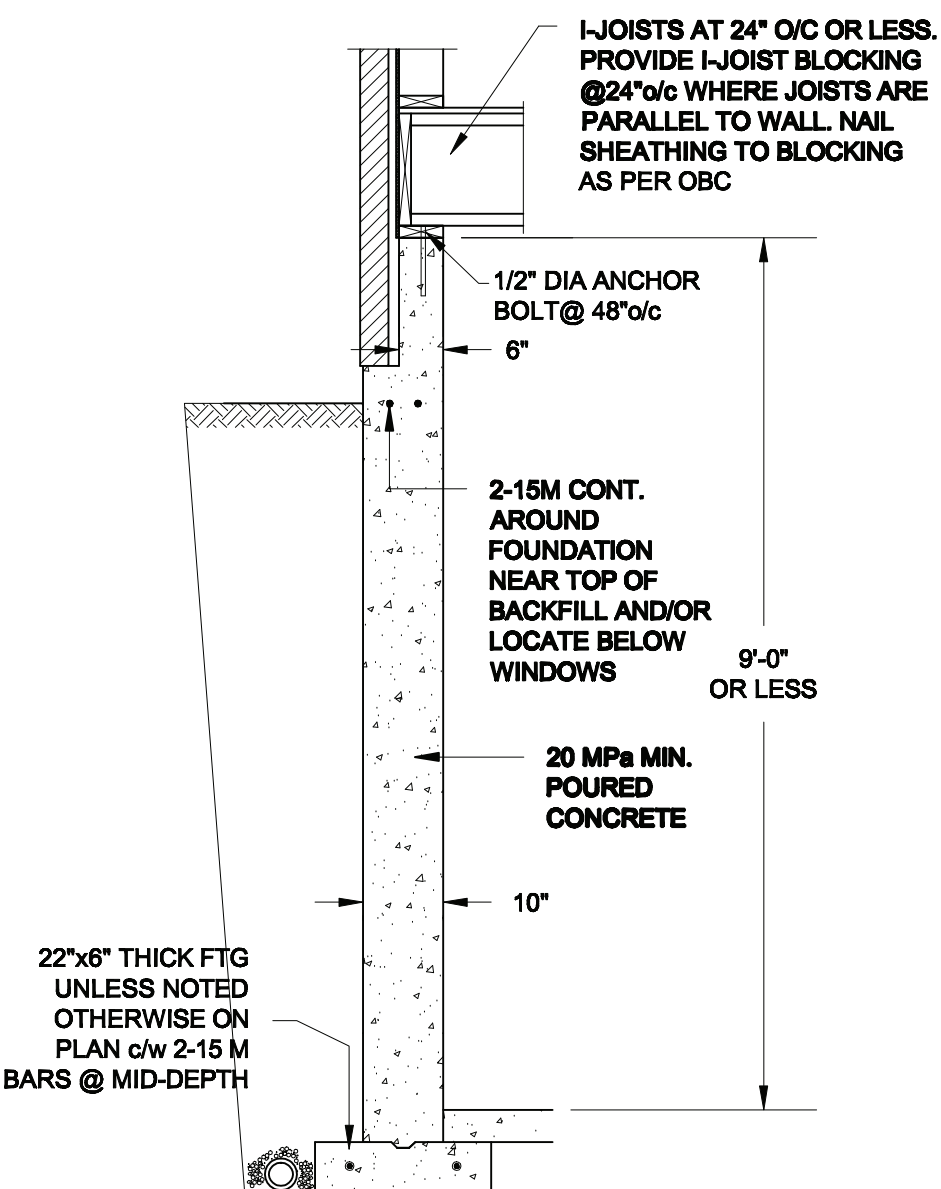

1B
S4 **DROPPED VENEER**
SCALE: 1/2" = 1'-0"

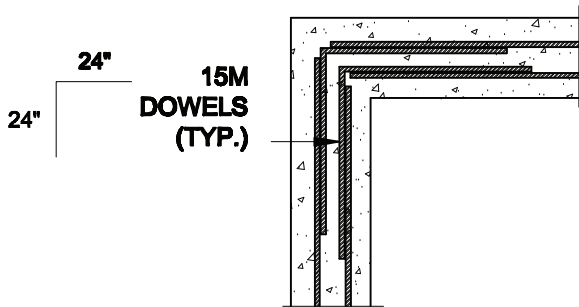



1C
S4 **TYP. PLAN VIEW AT CORNER**
SCALE: 1/2" = 1'-0"

NOTE:
AT ALL WINDOW OPENINGS,
PROVIDE 2-15M VERTICALLY
AT EACH SIDE + 2-15M
HORIZONTALLY 2" BELOW &
EXTEND 24" BEYOND OPENING

NOTES:

1. CONFORM TO THE ONTARIO BUILDING CODE, 2012.
2. CONCRETE TO HAVE A 28 DAY COMPRESSIVE STRENGTH OF 20 MPa.
3. REINFORCING STEEL TO BE GRADE 400.
4. LAP REINFORCING STEEL 24" AT SPLICES. PROVIDE 24"x24" L-SHAPE BARS AT ALL CORNERS - SEE DETAIL 1C/S4.
5. BACKFILL ASSUMED TO BE FREE-DRAINING MATERIAL AS PER PART 9 OF THE OBC.
6. FOUNDATION IS FOR A PART 9 RESIDENTIAL BUILDING.
7. DETAIL IS APPLICABLE TO SITE CLASSES A TO D ONLY AS GIVEN IN TABLE 4.1.8.4.A OF THE OBC (TO BE CONFIRMED BY GEOTECHNICAL ENGINEER).

| | | | | | |
|-----------------------------|------------------------|---|---|---|---------------------------|
| Scale: AS NOTED | | QUAILE ENGINEERING LTD.  38 Parkside Drive, UNIT 7 Newmarket, ON L3Y 8J9 T: 905-853-8547 E: quaile.eng@rogers.com | Engineer's Seal:  MAR 30, 2021 | Project: BAYVIEW WELLINGTON HOMES - GREEN VALLEY ESTATES - SINGLES BRADFORD, ONTARIO | |
| Date: MAR-15-2021 | | | | TYPICAL STRUCTURAL DETAILS | |
| Drawn: SC | Checked: SJB | | | Project No.: 21-038 | Drawing No.: S4 |

CONSTRUCTION NOTES (Unless otherwise noted)

ALL CONSTRUCTION TO ADHERE TO THESE PLANS AND SPEC'S AND TO CONFORM TO THE ONTARIO BUILDING CODE AND ALL OTHER APPLICABLE CODES AND AUTHORITIES HAVING JURISDICTION. THESE REQUIREMENTS ARE TO BE TAKEN AS MINIMUM SPECIFICATIONS. ONT. REG. 332/12-2012 OBC

1. ROOF CONSTRUCTION

NO.210 (10.25kg/m2) ASPHALT SHINGLES, 10mm (3/8") PLYWOOD SHEATHING WITH "H" CLIPS. APPROVED WOOD TRUSSES @ 600mm (24") O.C. MAX. APPROVED EAVES PROTECTION TO EXTEND 900mm (3'-0") FROM EDGE OF ROOF AND MIN. 300mm (12") BEYOND INNER FACE OF EXTERIOR WALL. [EAVES PROTECTION NOT REQ'D FOR ROOF SLOPES 8:12 OR GREATER] 38x89 (2"x4") TRUSS BRACING @ 1830mm (6'-0") O.C. AT BOTTOM CHORD. PREFIN. ALUM. EAVESTROUGH, FASCIA, RVL & VENTED SOFFIT. PROVIDE ICE & WATER SHIELD TO ALL ROOF/WALL SURFACES SUSCEPTIBLE TO ICE DAMMING. ROOF SHEATHING TO BE FASTENED 150 (6") C/C ALONG EDGES & INTERMEDIATE SUPPORTS WHEN TRUSSES SPACED GREATER THAN 406 (16"). ATTIC VENTILATION 1:300 OF INSULATED CEILING AREA WITH MIN. 25% AT EAVES & MIN. 25% AT RIDGE [OBC 9.19.1.2.]. ENSURE ALL OVERLAPPING ROOF SPACES ARE OPEN TO MAIN ROOF ATTIC SPACE FOR VENTING PURPOSES.

2. FRAME WALL CONSTRUCTION (2"x6") (SB-12-TABLE 3.1.1.2.A)

SIDING AS PER ELEV., 19x38 (1"x2") VERTICAL WOOD FURRING, CONTIN. SHEATHING MEMBRANE, 9.5mm (3/8") EXT. TYPE SHEATHING, 38x140 (2"x6") STUDS @ 400mm (16") O.C.. RSI 3.87 (R22) INSULATION AND APPR. VAPOUR BARRIER AND APPR. CONTIN. AIR BARRIER, 13mm (1/2") INT. DRYWALL FINISH. SIDING TO BE MIN. 200mm (8") ABOVE FINISH GRADE. REFER TO OBC SB-12, CHAPTER 3 FOR ADDITIONAL THERMAL INSULATION REQUIREMENTS.

2A. RESERVED

2B. FRAME WALL CONSTRUCTION (2"x4")- GARAGE WALLS

SIDING AS PER ELEV., 19x38 (1"x2") VERTICAL WOOD FURRING, CONTIN. SHEATHING MEMBRANE, 9.5mm (3/8") EXT. TYPE SHEATHING, 38x89 (2"x4") STUDS @ 400mm (16") O.C.. (MAX. HEIGHT 3000mm (9'-10"), WITH APPR. DIAGONAL WALL BRACING. SIDING TO BE MIN. 200mm (8") ABOVE FINISH GRADE.

2C. RESERVED

2D. STUCCO WALL CONSTRUCTION (2"x4")-GARAGE WALLS

STUCCO CLADDING SYSTEM CONFORMING TO O.B.C. 9.27.1.1.(2) & 9.28 THAT EMPLOY A MINIMUM 10mm AIR SPACE BEHIND THE CLADDING WITH POSITIVE DRAINAGE TO THE EXTERIOR AND APPLIED PER MANUFACTURERS SPECIFICATIONS OVER 25mm (1") MIN. EXPANDED OR EXTRUDED RIGID POLYSTYRENE ON APPROVED AIR/MOISTURE BARRIER ON 13mm (1/2") EXT. TYPE SHEATHING ON 38x89 (2"x4") STUDS @ 400 (16") O.C.. STUCCO TO BE MIN. 200 (8") ABOVE FINISH GRADE.

2E. WALLS ADJACENT TO ATTIC SPACE - NO CLADDING

9.5mm (3/8") EXT. TYPE SHEATHING, 38x140 (2"x6") STUDS @ 400mm (16") O.C.. RSI 3.87 (R22) INSULATION AND APPR. VAPOUR BARRIER AND APPR. CONTIN. AIR BARRIER, 13mm (1/2") INTERIOR DRYWALL FINISH. MID-HEIGHT BLOCKING REQ'D. IF NO SHEATHING APPLIED. REFER TO OBC SB-12, CHAPTER 3 FOR ADDITIONAL THERMAL INSULATION REQUIREMENTS.

3. MASONRY VENEER CONSTRUCTION (2"x6") (SB-12-TABLE 3.1.1.2.A)

90mm (4") MASONRY, 25mm (1") AIR SPACE, 22x180x0.76mm (7/8"x7"x0.03") GALV. METAL TIES @ 400mm (16") O.C. HORIZONTAL 600mm (24") O.C. VERTICAL. APPROVED SHEATHING PAPER, 9.5mm (3/8") EXT. TYPE SHEATHING, 38x140 (2"x6") STUDS @ 400mm (16") O.C.. RSI 3.87 (R22) INSULATION & APPR. VAPOUR BARRIER WITH APPR. CONTIN. AIR BARRIER, 13mm (1/2") INTERIOR DRYWALL FINISH. PROVIDE WEEP HOLES @ 800mm (32") O.C. BOTTOM COURSE AND OVER OPENINGS. PROVIDE BASE FLASHING UP MIN. 150mm (6") BEHIND BUILDING PAPER. REFER TO OBC SB-12, CHAPTER 3 FOR ADDITIONAL THERMAL INSULATION REQUIREMENTS. MASONRY TO BE MIN. 150mm (6") ABOVE FINISH GRADE.

3A. RESERVED

3B. MASONRY VENEER CONSTRUCTION (2"x4")- GARAGE WALLS

90mm (4") MASONRY, 25mm (1") AIR SPACE, 22x180x0.76mm (7/8"x7"x0.03") GALV. METAL TIES @ 400mm (16") O.C. HORIZONTAL 600mm (24") O.C. VERTICAL. APPR. SHEATHING PAPER, 9.5mm (3/8") EXT. TYPE SHEATHING, 38x89 (2"x4") STUDS @ 400mm (16") O.C.. (MAX. HEIGHT 3000mm 9'-10") WITH APPR. DIAGONAL WALL BRACING. PROVIDE WEEP HOLES @ 800mm (32") O.C. BOTTOM COURSE AND OVER OPENINGS. PROVIDE BASE FLASHING UP MIN. 150mm (6") BEHIND BUILDING PAPER. MASONRY TO BE MIN. 150mm (6") ABOVE FINISH GRADE.

3C. STUCCO WALL CONSTRUCTION (2"x4") (SB-12-TABLE 3.1.1.2.A)

STUCCO CLADDING SYSTEM CONFORMING TO O.B.C. 9.27.1.1.(2) & 9.28 THAT EMPLOYS A MINIMUM 10mm AIR SPACE BEHIND THE CLADDING WITH POSITIVE DRAINAGE TO THE EXTERIOR AND APPLIED PER MANUFACTURERS SPECIFICATIONS OVER 25mm (1") MIN. EXTRUDED OR EXPANDED RIGID POLYSTYRENE ON APPR. CONTIN. AIR/MOISTURE BARRIER ON 13mm (1/2") EXT. TYPE SHEATHING ON 38x140 (2"x6") STUDS @ 400mm (16") O.C.. RSI 3.87(R22) INSULATION, APPROVED VAPOUR BARRIER, 13mm (1/2") GYPSUM WALLBOARD INTERIOR FINISH. REFER TO OBC SB-12, CHAPTER 3 FOR ADDITIONAL THERMAL INSULATION REQUIREMENTS. STUCCO TO BE MIN. 200 (8") ABOVE FINISH GRADE.

4. INTERIOR STUD PARTITIONS

FOR BEARING PARTITIONS 38x89 (2"x4") @ 400mm (16") O.C. FOR 2 STOREYS AND 300mm (12") O.C. FOR 3 STOREYS, NON-BEARING PARTITIONS 38x89 (2"x4") @ 600mm (24") O.C. PROVIDE 38x89 (2"x4") BOTTOM PLATE AND 2/38x89 (2/2"x4") TOP PLATE, 13mm (1/2") INT. DRYWALL BOTH SIDES OF STUDS, PROVIDE 38x140 (2"x6") STUDS/PLATES WHERE NOTED.

5. FOUNDATION WALL/FOOTINGS:

250mm (10") POURED CONC. FDTN. WALL 20MPa (2900psi) WITH BITUMENOUS DAMPPROOFING AND DRAINAGE LAYER. DRAINAGE LAYER REQ'D. WHEN BASEMENT INSUL. EXTENDS 900 (2'-11") BELOW FIN. GRADE. DRAINAGE LAYER IS NOT REQ'D. WHEN FDTN. WALL IS WATERPROOFED. MAXIMUM POUR HEIGHT 2820 (9'-3") ON 560x155 (22"x6") CONTINUOUS KEYED CONC. FTG. BRACE FDTN. WALL PRIOR TO BACKFILLING. ALL FOOTINGS SHALL REST ON NATURAL UNDISTURBED SOIL OR COMPACTED ENGINEERED FILL, WITH MIN. BEARING CAPACITY OF 150kPa OR GREATER. IF SOIL BEARING DOES NOT MEET MINIMUM CAPACITY, ENGINEERED FOOTINGS ARE REQUIRED. STOREYS SUPPORTED |W/ MASONRY VENEER |W/ SIDING ONLY

| | | |
|---|--------------------|--------------------|
| 1 | 18" WIDE x 6" DEEP | 18" WIDE x 6" DEEP |
| 2 | 22" WIDE x 6" DEEP | 22" WIDE x 6" DEEP |
| 3 | 28" WIDE x 9" DEEP | 22" WIDE x 6" DEEP |

-SEE OBC 9.15.3.
-MAXIMUM FLOOR LIVE LOAD OF 2.4kPa. (50psf.) PER FLOOR, AND MAX. LENGTH OF SUPPORTED FLOOR JOISTS IS 4.9m (16'-1").
-REFER TO SOILS REPORT FOR SOIL CONDITIONS AND BEARING CAPACITY.
STRIP FOOTING SUPPORTING EXTERIOR WALLS (FOR W.O.B.)
-ASSUMING MASONRY VENEER CONSTRUCTION, MAX. FLOOR LIVE LOAD OF 2.4kPa. (50psf.) PER FLOOR, AND MAX. LENGTH OF SUPPORTED FLOOR JOISTS IS 4.9m (16'-1"). THE STRIP FOOTING SIZE IS AS FOLLOWS:
2 STOREY WITH WALK-OUT BASEMENT 545x175 (22"x7")

6. FOUNDATION DRAINAGE OBC. 9.14.2. & 9.14.3.

100mm (4") DIA. FOUNDATION DRAINAGE TILE 150mm (6") CRUSHED STONE OVER AND AROUND DRAINAGE TILES.

7. BASEMENT SLAB OBC. 9.3.1.6.(1)(b). 9.16.4.5.(1). 9.25.3.3.(15)

80mm (3")MIN. 25MPa (3600psi) CONC. SLAB ON 100mm (4") COARSE GRANULAR FILL, OR 20MPa. (3000psi) CONC. WITH DAMPPROOFING BELOW SLAB. UNDER SLAB INSULATION PER SB-12. ALL SLAB JOINTS & PENETRATIONS TO BE CAULKED.

8. EXPOSED FLOOR TO EXTERIOR (SB-12-TABLE 3.1.1.2.A)

PROVIDE RSI 5.46 (R31) INSULATION, APPROVED VAPOUR BARRIER AND CONTINUOUS AIR BARRIER, FINISHED SOFFIT.

9. ATTIC INSULATION (SB-12-TABLE 3.1.1.2.A) (SB-12-3.1.1.8)

RSI 10.56 (R60) BLOWN IN ROOF INSULATION AND APPROVED VAPOUR BARRIER, 16mm (5/8") INT. DRYWALL FINISH OR APPROVED EQUAL. RSI 3.52 (R20) MIN. ABOVE INNER SURFACE OF EXTERIOR WALL

10. ALL STAIRS/EXTERIOR STAIRS -OBC. 9.8.- (PRIVATE STAIRS)

5mm (1/4") MAX BETWEEN ADJACENT TREADS OR LANDINGS
-10mm (3/8") MAX BETWEEN TALLEST & SHORTEST RISE IN FLIGHT
MAX. RISE = 200 (7-7/8")
MIN. RUN = 255 (107") (NOSING TO NOSING)
MAX. TREAD = RUN + 25 (1")
MAX. NOSING = 25 (1")
MIN. HEADROOM = 1950 (6'-5")
RAIL @ LANDING = 900 (2'-11")
RAIL @ STAIR = 865 (2'-10") TO 1070 (3'-6")
MIN. STAIR WIDTH = 860 (2'-10")
FOR CURVED STAIRS (TAPERED TREADS)
MIN. RUN AT INNER RADIUS = 150 (6")
MIN. RUN AT 300 (12") = 255 (10")

11. HANDRAILS -OBC. 9.8.7.-

FINISHED RAILING ON PICKETS SPACED MAXIMUM 100mm (4") BETWEEN PICKETS. CLEARANCE BETWEEN HANDRAIL AND SURFACE BEHIND IT TO BE 50 (2") MIN. HANDRAILS TO BE CONTINUOUS EXCEPT FOR NEWEL POST AT CHANGES OF DIRECTION .
INTERIOR GUARDS -OBC. 9.8.8.-
INTERIOR GUARDS: 900mm (2'-11") MIN. HIGH
EXTERIOR GUARDS -OBC. 9.8.8.
900mm (36") HIGH GUARD WHERE DISTANCE FROM PORCH TO FIN. GRADE IS LESS THAN 1800mm (71"). 1070mm (42") HIGH GUARD IS REQUIRED WHERE DISTANCE EXCEEDS 1800mm (71").
SILL PLATE -OBC. 9.23.7.
38x89 (2"x4") SILL PLATE WITH 13mm (1/2") DIA. ANCHOR BOLTS 200mm (8") LONG. EMBEDDED MIN. 100mm (4") INTO CONC. @ 2400mm (7'-10") O.C.. CAULKING OR 25 (1") MIN. MINERAL WOOL BETWEEN PLATE AND TOP OF FDTN. WALL.
USE NON-SHRINK GROUT TO LEVEL SILL PLATE WHEN REQUIRED.

12. BASEMENT INSULATION (SB-12-3.1.1.7). 9.25.2.3. 9.13.2.6)

FOUNDATION WALLS ENCLOSING HEATED SPACE SHALL BE INSULATED FROM THE UNDERSIDE OF THE SUBFLOOR TO NOT MORE THAN 200mm (8") ABOVE THE FINISHED FLOOR & NO CLOSER THAN 50mm (2") OF THE BASEMENT SLAB. RSI3.52ci (R20ci) BLANKET INSULATION TO HAVE APPROVED VAPOUR BARRIER. RECOMMEND DAMPPROOF WITH BUILDING PAPER BETWEEN THE FOUNDATION WALL AND INSULATION UP TO GRADE LEVEL. NOTE: FULL HEIGHT INSULATION AT COLD CELLAR WALLS, AIR BARRIER TO BE SEALED TO FOUNDATION WALL WITH CAULKING. CONTINUOUS INSULATION (ci) IS NOT TO BE INTERRUPTED BY FRAMING.

14. BEARING STUD PARTITION

38x89 (2"x4") STUDS @ 400mm (16") O.C. 38x89 (2"x4") SILL PLATE ON DAMPPROOFING MATERIAL, 13mm (1/2") DIA. ANCHOR BOLTS 200mm (8") LONG. EMBEDDED MIN. 100mm (4") INTO CONC. @ 2400mm (7'-10") O.C.. 100mm (4") HIGH CONC. CURB ON 350x155 (14"x6") CONC. FOOTING. ADD HORIZ. BLOCKING AT MID-HEIGHT IF WALL IS UNFINISHED.

15. STEEL BASEMENT COLUMN (SEE O.B.C. 9.15.3.3)

89mm (3-1/2") DIA x 3.0mm (0.118) SINGLE WALL TUBE TYPE 2 ADJUSTABLE STL. COL. W/ MIN. CAPACITY OF 71.2kN (16,000lbs.) AT A MAX. EXTENSION OF 2318mm (7'-7 1/2") CONFORMING TO CAN/CGSB-7.2-94. AND WITH 150x150x9.5 (6"x6"x3/8") STL. PLATE TOP & BOTTOM. 870x870x410 (34"x34"x16") CONC. FOOTING ON UNDISTURBED SOIL OR ENGINEERED FILL CAPABLE OF SUSTAINING A PRESSURE OF 150 Kpa. MINIMUM AND AS PER SOILS REPORT.

15A. STEEL BASEMENT COLUMN (SEE O.B.C. 9.15.3.3)

89mm (3-1/2") DIA x 4.78mm(1.88) FIXED STL. COL. WITH 150x150x9.5 (6"x6"x3/8") STL. TOP & BOTTOM PLATE ON 1070x1070x460 (42"x42"x18"). CONC. FOOTING ON UNDISTURBED SOIL OR ENGINEERED FILL CAPABLE OF SUSTAINING A PRESSURE OF 150 Kpa. MIN. AND AS PER SOILS REPORT.

15B. STEEL COLUMN

90mm (3-1/2") DIA x 4.78mm(1.88) NON-ADJUSTABLE STL. COL. TO BE ON 150x150x9.5 (6"x6"x3/8") STL. TOP PLATE, & BOTTOM PLATE. BASE PLATE 120x250x12.5 (4 1/2"x10"x1/2") WITH 2-12mm DIA. x 300mm LONG x50mm HOOK ANCHORS (2-1/2"x12"x2") FIELD WELD COL. TO BASE PLATE.

16. BEAM POCKET OR 300x150 (12"x6") POURED CONC. NIB WALLS. MIN. BEARING 90mm (3-1/2")

17. 19x64 (1"x3") CONTINUOUS WOOD STRAPPING BOTH SIDES OF STEEL BEAM.

18. GARAGE SLAB

100mm (4") 32MPa (4640psi) CONC. SLAB WITH 5-8% AIR ENTRAINMENT ON OPT. 100 (4") COARSE GRANULAR FILL WITH COMPACTED SUB-BASE OR COMPACTED NATIVE FILL. SLOPE TO FRONT.

19. GARAGE CEILING/INTERIOR WALLS

13mm (1/2") GYPSUM BOARD ON WALL AND CEILING BETWEEN HOUSE AND GARAGE. TAPE AND SEAL ALL JOINTS AIRTIGHT PER O.B.C. 9.10.9.16. WALLS (R22), CEILINGS (R31). REFER TO SB-12, TABLE 3.1.1.2.A. FOR REQUIRED THERMAL INSULATION.

20. DOOR AND FRAME GASPROOFED. DOOR EQUIPPED WITH SELF CLOSING DEVICE AND WEATHERSTRIPPING PER OBC 9.10.13.15.

21. EXTERIOR STEP

PRECAST CONCRETE STEP OR WOOD STEP WHERE NOT EXPOSED TO WEATHER. MAX. RISE 200mm (7-7/8") MIN. TREAD 250mm (9'-1/2"). SEE OBC. 9.8.9.2. 9.8.9.3. & 9.8.10.

22. DRYER EXHAUST (OBC-6.2.3.8.(7) & 6.2.4.11.)

CAPPED DRYER EXHAUST VENTED TO EXTERIOR. (USE 100mm (4") DIA. SMOOTH WALL VENT PIPE)

23. INSULATED ATTIC ACCESS (OBC-9.19.2.1. & SB12-3.1.1.8)

ATTIC ACCESS HATCH WITH MIN. DIMENSION OF 545x610mm (21 1/2"x24") & A MIN. AREA OF 0.32 SQ.M. (3.44 SQ.FT.) WITH WEATHERSTRIPPING. RSI 3.52 (R20) RIGID INSUL. BACKING.

24. FIREPLACE CHIMNEYS OBC. 9.21.

TOP OF FIREPLACE CHIMNEY SHALL BE 915mm (3'-0") ABOVE THE HIGHEST POINT AT WHICH IT COMES IN CONTACT WITH THE ROOF AND 610mm (2'-0") ABOVE THE ROOF SURFACE WITHIN A HORIZ. DISTANCE OF 3050mm (10'-0") FROM THE CHIMNEY.

25. LINEN CLOSET, 4 SHELVES MIN. 350mm (14") DEEP.

26. MECHANICAL EXHAUST FAN, VENTED TO EXTERIOR AS REQUIRED BY OBC. 9.32.3.5. & 9.32.3.10.

27. STEEL BEARING PLATE FOR MASONRY WALLS

280x280x16 (11"x11"x5/8") STL. PLATE FOR STL BEAMS AND 280x280x12 (11"x11"x1/2") STL. PLATE FOR WOOD BEAMS BEARING ON CONC. BLOCK PARTYWALL, ANCHORED WITH 2-19mm (3/4") x 200mm (8") LONG GALV. ANCHORS WITHIN SOLID BLOCK COURSE. LEVEL WITH NON-SHRINK GROUT.
OR
SOLID WOOD BEARING FOR WOOD STUD WALLS
SOLID BEARING TO BE AT LEAST AS WIDE AS THE SUPPORTED MEMBER. SOLID WOOD BEARING COMPRISED OF BUILT-UP WOOD STUDS TO BE CONSTRUCTED IN ACCORDANCE WITH OBC 9.17.4(2).

28. RESERVED

29. BEARING WOOD POST (BASEMENT) (OBC 9.17.4.)

3-38x140 (3-2"x6") BUILT-UP-POST ON METAL BASE SHOE ANCHORED TO CONC. WITH 12.7 DIA. BOLT, 610x610x300 (24"x24"x12") CONC. FOOTING.

30. STEPPED FOOTINGS OBC 9.15.3.9.

MIN. HORIZ. STEP = 600mm (24").
MAX. VERT. STEP = 600mm (24")

31. SLAB ON GRADE

MIN. 100mm (4") CONCRETE SLAB ON GRADE ON 100mm (4") COARSE GRANULAR FILL. REINFORCED WITH 4x6-w2x9w2.9 MESH PLACED NEAR MID-DEPTH OF SLAB. CONC. STRENGTH 32 MPa (4640 psi) WITH 5-8% AIR ENTRAINMENT ON COMPACTED SUB-GRADE. WHERE REQUIRED, REFER TO OBC SB-12, TABLE 3.1.1.2.A. FOR REQUIRED MINIMUM INSULATION UNDER SLAB.

32. DIRECT VENTING GAS FURNACE/ H.W.T VENT

DIRECT VENT FURNACE TERMINAL MIN. 900mm (36") FROM A NATURAL GAS REGULATOR, MIN. 300mm (12") ABOVE FIN. GRADE. FROM ALL OPENINGS, EXHAUST AND INTAKE VENTS. HRV INTAKE TO BE A MIN. OF 1830mm (6'-0") FROM ALL EXHAUST TERMINALS. REFER TO GAS UTILIZATION CODE. ALL AIR INTAKES SHALL BE LOCATED SO THAT THEY ARE SEPARATED FROM KITCHEN EXHAUST BY 3.0M IN COMPLIANCE WITH O.B.C. DIV.-B TABLE 6.2.3.12..

33. DIRECT VENTING GAS FIREPLACE VENT

DIRECT VENT GAS FIREPLACE. VENT TO BE A MINIMUM 300mm (12") FROM ANY OPENING AND ABOVE FIN. GRADE. REFER TO GAS UTILIZATION CODE.

34. SUBFLOOR, JOIST STRAPPING AND BRIDGING

16mm (5/8") T & G SUBFLOOR ON WOOD FLOOR JOISTS. FOR CERAMIC TILE APPLICATION (* SEE OBC 9.30.6. *) 6mm (1/4") PANEL TYPE UNDERLAY UNDER RESILIENT & PARQUET FLOORING. (* SEE OBC 9.30.2.*). FLOOR JOISTS WITH SPANS OVER 2100mm (6'-11") TO BE BRIDGED WITH 38x38 (2"x2") CROSS BRACING OR SOLID BLOCKING @ 2100mm (6'-11") O.C. MAX. AND WHERE SPECIFIED BY JOIST TABLES A-1 OR A-2 STRAPPING SHALL BE 19x64 (1"x3") @ 2100mm (6'-11") O.C. UNLESS A PANEL TYPE CEILING FINISH IS APPLIED. (* SEE OBC 9.23.9.4. *)

35. EXPOSED BUILDING FACE OBC. 9.10.15. & SB-2-2.3.5.(2)

EXTERIOR WALLS TO HAVE A FIRE RESISTANCE RATING OF NOT LESS THAN 45 min. WHERE LIMITING DISTANCE (LD) IS LESS THAN 1.2M (3'-11"). WHERE THE LD IS LESS THAN 600mm (1'-11") THE EXPOSING FACE SHALL BE CLAD IN NON-COMBUSTIBLE MATERIAL. SEE ELEVATIONS FOR ADDITIONAL NOTES. OFFENDING GARAGE WALLS INCLUDED.

36. COLD CELLAR PORCH SLAB (OBC 9.39.)

FOR MAX. 2500mm (8'-2") PORCH DEPTH (SHORTEST DIM.), 125mm (5") 32MPa (4640psi) CONC. SLAB WITH 5-8% AIR ENTRAINMENT. REINF. WITH 10M BARS @ 200mm (7 7/8") O.C. EACH WAY IN BOTTOM THIRD OF SLAB. MIN. 30mm (1 1/4") COVER. 600x600 (23 5/8"x23 5/8") 10M DOWELS @ 600mm (23 5/8") O.C.. ANCHORED IN PERIMETER FDTN. WALLS. SLOPE SLAB MIN. 1.0% FROM HOUSE WALL. SLAB TO HAVE MIN. 75mm (3") BEARING ON FDTN. WALLS. PROVIDE (L7) LINTEL OVER CELLAR DOOR WITH 100mm (4") END BEARING.

37. THE FDTN. WALL SHALL NOT BE REDUCED TO LESS THAN 90mm (3-1/2") THICK TO A MAX. DEPTH OF 600mm (24") AND SHALL BE TIED TO THE FACING MATERIAL WITH METAL TIES SPACED 200mm (8") O.C. VERTICALLY AND 900mm (36") O.C. HORIZONTALLY. FILL SPACE BETWEEN WALL AND FACING SILL WITH MORTAR.

38. CONVENTIONAL ROOF FRAMING (2.0Kpg. SNOW LOAD)

38x140 (2"x6") RAFTERS @ 400mm (16"O.C.) FOR MAX 11-7" SPAN, 38x184 (2"x8") RIDGE BOARD. 38x89 (2"x4") COLLAR TIES AT MIDSPANS. CEILING JOISTS TO BE 38x89 (2"x4") @ 400mm (16") O.C. FOR MAX. 2830mm (9'-3") SPAN & 38x140 (2"x6") @ 400 (16") O.C. FOR MAX. 4450mm (14'-7") SPAN.
RAFTERS FOR BUILT-UP ROOF TO BE 38x89 (2"x4") @ 600mm (24") O.C. WITH A 38x89 (2"x4") CENTRE POST TO THE TRUSS BELOW, LATERALLY BRACED @ 1800mm (6'-0") O.C. VERTICALLY.

GENERAL NOTES

WINDOWS: 1) MINIMUM BEDROOM WINDOW -OBC. 9.9.10.1.-
AT LEAST ONE BEDROOM WINDOW ON A GIVEN FLOOR IS TO HAVE MIN. 0.35m2 UNOBSTRUCTED GLAZED OR OPENABLE AREA WITH MIN. CLEAR WIDTH OF 380 mm (1'-3").
2) WINDOW GUARDS -OBC. 9.8.8.1.(6).
A GUARD IS REQUIRED WHERE THE TOP OF THE WINDOW SILL IS LOCATED LESS THAN 480mm (1'-7") ABOVE FIN. FLOOR AND THE DISTANCE FROM THE FIN. FLOOR TO THE ADJACENT GRADE IS GREATER THAN 1800mm (5'-11")
3) EXTERIOR WINDOWS
SHALL COMPLY WITH OBC DIV.-B 9.7.3. & SB12-3.1.1.9
4) GLASS-STRUCTURAL SUFFICIENCY OF GLASS
DOOR & WINDOW MANUFACTURER/ SUPPLIER TO PROVIDE ADEQUATE INFORMATION TO DEMONSTRATE COMPLIANCE WITH OBC DIV.-B 9.6.1.3.
GENERAL: 1) MECHANICAL VENTILATION IS REQUIRED TO COMPLY WITH OBC-DIV. B. 6.2.2. SEE MECHANICAL DRAWINGS.
2) ALL DOWNSPOUTS TO DRAIN AWAY FROM THE BUILDING AS PER OBC 9.9.26.18.2. & 5.6.2.2.(3) AND MUNICIPAL STANDARDS.
3) ALL WINDOW WELLS TO DRAIN TO FOOTING LEVEL PER OBC 9.14.6.3. CHECK WITH THE LOCAL AUTHORITY.
4) STUD WALL REINFORCEMENT FOR FUTURE GRAB BARS IN MAIN BATHROOM
REINFORCEMENT OF STUD WALLS SHALL BE INSTALLED ADJACENT TO WATER CLOSETS AND SHOWER OR BATHTUB IN MAIN BATHROOM. REFER TO OBC. DIV. B-9.5.2.3 & DETAIL PROVIDED.
5) ALL EXTERIOR DOORS TO COMPLY WITH THERMAL RESISTANCE AS STATED IN O.B.C. SB-12-3.1.1.9.
6) ALL AIR BARRIER SYSTEMS ARE REQUIRED TO COMPLY WITH O.B.C. DIV.-B 9.25.3.
7) ALL OUTDOOR AIR INTAKES SHALL BE LOCATED SO THAT THEY ARE SEPARATED FROM SOURCES OF CONTAMINATION (EXHAUST VENTS) IN COMPLIANCE WITH O.B.C. DIV.-B 6.2.3.12. AND TABLE 6.2.3.12.
LUMBER: 1) ALL LUMBER SHALL BE SPRUCE NO.2 GRADE, UNLESS NOTED OTHERWISE.
2) STUDS SHALL BE STUD GRADE SPRUCE, UNLESS NOTED OTHERWISE.
3) LUMBER EXPOSED TO THE EXTERIOR TO BE SPRUCE No.2 GRADE PRESSURE TREATED OR CEDAR, UNLESS NOTED OTHERWISE.
4) ALL LAMINATED VENEER LUMBER (L.V.L) BEAMS, GIRDER TRUSSES, AND METAL HANGER CONNECTIONS SUPPORTING ROOF FRAMING TO BE DESIGNED & CERTIFIED BY TRUSS MANUFACTURER.
5) LVL BEAMS SHALL BE 2.0E -2950Fb MIN.. NAIL EACH PLY OF LVL WITH 89mm (3 1/2") LONG COMMON WIRE NAILS @ 300mm (12") O.C. STAGGERED. IN 2 ROWS FOR 184, 240 & 300mm (7 1/4-9 1/2- 11 7/8") DEPTHS AND STAGGERED IN 3 ROWS FOR GREATER DEPTHS AND FOR 4 PLY MEMBERS ADD 13mm (1/2") DIA. GALVANIZED BOLTS BOLTED AT MID-DEPTH OF BEAM @ 915mm (3'-0") O.C.
6) PROVIDE FACE MOUNT BEAM HANGERS TYPE "SCL" MANUFACTURED BY SIMPSON STRONG-TIE OR EQUAL FOR ALL LVL BEAM TO BEAM CONNECTIONS UNLESS OTHERWISE NOTED. REFER TO ENG. FLOOR LAYOUTS.
7) JOIST HANGERS: PROVIDE METAL HANGERS FOR ALL JOISTS AND BUILT-UP WOOD MEMBERS INTERSECTING FLUSH BUILT-UP WOOD MEMBERS.
8) WOOD FRAMING NOT TREATED WITH A WOOD PRESERVATIVE. IN CONTACT WITH CONCRETE, SHALL BE SEPARATED FROM THE CONCRETE BY AT LEAST 2 mil. POLYETHYLENE FILM, No. 50 (45lbs.) ROLL ROOFING OR OTHER DAMPPROOFING MATERIAL, EXCEPT WHERE THE WOOD MEMBER IS AT LEAST 150mm (6") ABOVE THE GROUND.
STEEL: 1) STRUCTURAL STEEL SHALL CONFORM TO CAN/CSA-G40-21 GRADE 350W. HOLLOW STRUCTURAL SECTIONS SHALL CONFORM TO CSA-G40-21 GRADE 350W CLASS "H" "STRUCTURAL QUALITY STEEL". OBC. B-9-23.4.3.
2) REINFORCING STEEL SHALL CONFORM TO CSA-G30-18M GRADE 400R.
STUCCO: 1) ALL STUCCO WALLS TO HAVE A MINIMUM 10mm AIR SPACE BEHIND THE CLADDING WITH POSITIVE DRAINAGE TO THE EXTERIOR. THE EXTERIOR SHEATHING MUST NOT BE GYPSUM BASED. ALL STUCCO TO BE INSTALLED AS PER MANUFACTURERS SPECIFICATIONS.

LEGEND

CLASS 'B' VENT

EXHAUST FAN TO EXTERIOR

DUPLEX OUTLET (12" ABOVE SURFACE)

DUPLEX OUTLET (HEIGHT A.F.F)

WEATHERPROOF DUPLEX OUTLET

GFI DUPLEX OUTLET (HEIGHT A.F.F)

POT LIGHT

HEAVY DUTY OUTLET (220 volt)

LIGHT FIXTURE (PULL CHAIN)

LIGHT FIXTURE (CEILING MOUNTED)

SWITCH

LIGHT FIXTURE (WALL MOUNTED)

FLOOR DRAIN

HOSE BIB (NON-FREEZE)

SJ SINGLE JOIST

P.T. PRESSURE TREATED LUMBER

DJ DOUBLE JOIST

G.T. GIRDER TRUSS BY ROOF TRUSS MANUF.

TJ TRIPLE JOIST

LVL LAMINATED VENEER LUMBER

POINT LOAD FROM ABOVE

F.A. FLAT ARCH

C.A. CURVED ARCH

M.C. MEDICINE CABINET (RECESSED)

DOUBLE VOLUME WALL. SEE NOTE 39

CONCRETE BLOCK WALL

SOLID WOOD BEARING (SPRUCE No. 2). SOLID BEARING TO BE AS WIDE AS SUPPORTED MEMBER OR AS DIRECTED BY STRUCTURAL ENGINEER. SOLID BEARING TO BE MINIMUM 2 PIECES.

SOLID WOOD BEARING TO MATCH FROM ABOVE

SOIL GAS/ RADON CONTROL (OBC 9.1.1.7. & 9.13.4.)

PROVIDE CONSTRUCTION TO PREVENT LEAKAGE OF SOIL GAS INTO THE BUILDING IF REQUIRED.
CONTRACTOR MUST VERIFY ALL DIMENSIONS ON THE JOB AND REPORT ANY DISCREPANCY TO VA3 DESIGN BEFORE PROCEEDING WITH THE WORK. ALL DRAWINGS AND SPECIFICATIONS ARE INSTRUMENTS OF SERVICE AND THE PROPERTY OF VA3 DESIGN WHICH IF REQUESTED, MUST BE RETURNED AT THE COMPLETION OF THE WORK. ALL DRAWINGS TO BE USED FOR CONSTRUCTION ONLY AFTER BUILDING PERMIT HAS BEEN ISSUED.

TWO STOREY VOLUME SPACES

-FOR A MAXIMUM 5490 mm (18'-0") HEIGHT AND MAXIMUM SUPPORTED ROOF TRUSS LENGTH OF 6.0m, PROVIDE 2-38x140 (2-2"x6") SPR.#2 CONTIN. STUDS @ 300mm (12") O.C. (TRIPLE UP AT EVERY THIRD DOUBLE STUD FOR BRICK WALLS) C/W 9.6 (3/8") THICK EXT. PLYWOOD SHEATHING. PROVIDE SOLID WOOD BLOCKING BETWEEN WOOD STUDS @ 1220 mm (4'-0") O.C. VERTICALLY. -FOR WALLS WITH HORIZ. DISTANCES NOT EXCEEDING 2900 mm (9'-6"). PROVIDE 38x140 (2"x6") STUDS @ 400 (16") O.C. WITH CONTINUOUS 2-38x140 (2-2"x6")TOP PLATES + 1-38x140 (1-2"x6") BOTTOM PLATE & MINIMUM OF 3-38x184 (3-2"x8") CONT. HEADER AT GRND. CEILING LEVEL TOE-NAILED & GLUED AT TOP. BOTTOM PLATES AND HEADERS.
TYPICAL 1 HOUR RATED PARTY WALL.
REFER TO DETAILS FOR TYPE AND SPECIFICATIONS.

FOUNDATION WALL (W.O.D./W.O.B.)

- WHERE GRADE TO T/O BASEMENT SLAB EXCEEDS 1200mm (3'-11") A 250mm (10") WIDE FOUNDATION WALL IS REQUIRED.

EXTERIOR WALLS FOR WALK-OUT CONDITIONS

THE EXTERIOR BASEMENT STUD WALL TO BE 38x140 (2"x6") STUDS @ 400mm (16") o.c. OR 38x89 (2"x4") STUDS @ 300mm (12")o.c.

DRAIN WATER HEAT RECOVERY UNIT (DWHR)

PER SB12-3.1.1.12., A DRAIN WATER HEAT RECOVERY (DWHR) UNIT SHALL BE INSTALLED IN EACH DWELLING UNIT TO RECEIVE DRAIN WATER FROM ALL SHOWERS OR FROM AT LEAST TWO SHOWERS WHERE THERE ARE TWO OR MORE SHOWERS IN THE DWELLING UNIT. DOES NOT APPLY IF THERE ARE NO SHOWERS OR NO STOREY BENEATH ANY OF THE SHOWERS.

UPDATED

ONT. REG. 332/12-2012 OBC
Amendment O, Reg. 88/19
Includes amendments effective Jan. 1, 2022

WOOD LINTELS AND BUILT-UP WOOD BEAMS

| | | |
|----|-------------------------|--------|
| L1 | 2/38 x 184 (2/2" x 8") | SPR.#2 |
| B1 | 3/38 x 184 (3/2" x 8") | SPR.#2 |
| B2 | 4/38 x 184 (4/2" x 8") | SPR.#2 |
| B7 | 5/38 x 184 (5/2" x 8") | SPR.#2 |
| L3 | 2/38 x 235 (2/2" x 10") | SPR.#2 |
| B3 | 3/38 x 235 (3/2" x 10") | SPR.#2 |
| B4 | 4/38 x 235 (4/2" x 10") | SPR.#2 |
| L5 | 2/38 x 286 (2/2" x 12") | SPR.#2 |
| B5 | 3/38 x 286 (3/2" x 12") | SPR.#2 |
| B6 | 4/38 x 286 (4/2" x 12") | SPR.#2 |

LOOSE STEEL LINTELS

| | |
|-----|---|
| L7 | 89 x 89 x 6.4L (3-1/2" x 3-1/2" x 1/4"L) |
| L8 | 89 x 89 x 7.9L (3-1/2" x 3-1/2" x 5/16"L) |
| L9 | 102 x 89 x 7.9L (4" x 3-1/2" x 5/16"L) |
| L10 | 127 x 89 x 7.9L (5" x 3-1/2" x 5/16"L) |
| L11 | 152 x 89 x 10.0L (6" x 3-1/2" x 3/8"L) |
| L12 | 152 x 102 x 11.0L (6"x 4" x 7/16"L) |
| L13 | 178 x 102 x 13.0L (7"x 4" x 1/2"L) |

LAMINATED VENEER LUMBER (LVL) BEAMS

| | |
|-------|-----------------------------|
| LVL1A | 1-1 3/4"x7 1/4" (1-45x184) |
| LVL1 | 2-1 3/4"x7 1/4" (2-45x184) |
| LVL2 | 3-1 3/4"x7 1/4" (3-45x184) |
| LVL3 | 4-1 3/4"x7 1/4" (4-45x184) |
| LVL4A | 1-1 3/4"x9 1/2" (1-45x240) |
| LVL4 | 2-1 3/4"x9 1/2" (2-45x240) |
| LVL5 | 3-1 3/4"x9 1/2" (3-45x240) |
| LVL5A | 4-1 3/4"x9 1/2" (4-45x240) |
| LVL6A | 1-1 3/4"x11 7/8" (1-45x300) |
| LVL6 | 2-1 3/4"x11 7/8" (2-45x300) |
| LVL7 | 3-1 3/4"x11 7/8" (3-45x300) |
| LVL8 | 4-1 3/4"x11 7/8" (4-45x300) |

DOOR SCHEDULE

| | | |
|----|-----------------------------|--|
| 1 | EXTERIOR DOOR | 2'-8" WIDE INSULATED MIN. RSI 0.7 (R4) |
| 1A | EXTERIOR DOOR | 2'-10" WIDE INSULATED MIN. RSI 0.7 (R4) |
| 1B | EXTERIOR DOOR | 3'-0" WIDE INSULATED MIN. RSI 0.7 (R4) |
| 1C | EXTERIOR DOOR | 3'-2" WIDE INSULATED MIN. RSI 0.7 (R4) |
| 2A | EXTERIOR DOOR | 2'-8" wide 20 MIN. RATED DOOR AND FRAME, WITH APPROVED SELF CLOSING DEVICE. INSULATED MIN. RSI 0.7 (R4) |
| 2 | INTERIOR DOOR | 2'-8" WIDE |
| 2B | INTERIOR DOOR (COLD CELLAR) | 2'-8" WIDE (WEATHERSTRIPPING INSTALLED) |
| 2C | INTERIOR DOOR | 3'-0" WIDE |
| 3 | INTERIOR DOOR | 2'-6" WIDE |
| 3A | INTERIOR DOOR | 2'-4" WIDE |
| 4 | INTERIOR DOOR | 2'-0" WIDE |
| 4A | INTERIOR DOOR | 2'-2" WIDE |
| 5 | INTERIOR DOOR | 1'-6" WIDE |

REFER TO ARCHITECTURAL DRAWINGS FOR DOOR HEIGHTS

MECHANICAL SYMBOLS

HEAT PIPE


PLUMBING (TOILET)

PLUMBING (BATH, SINK, SHOWER)

WARM AIR

RETURN AIR DUCT

SMOKE ALARM (REFER TO

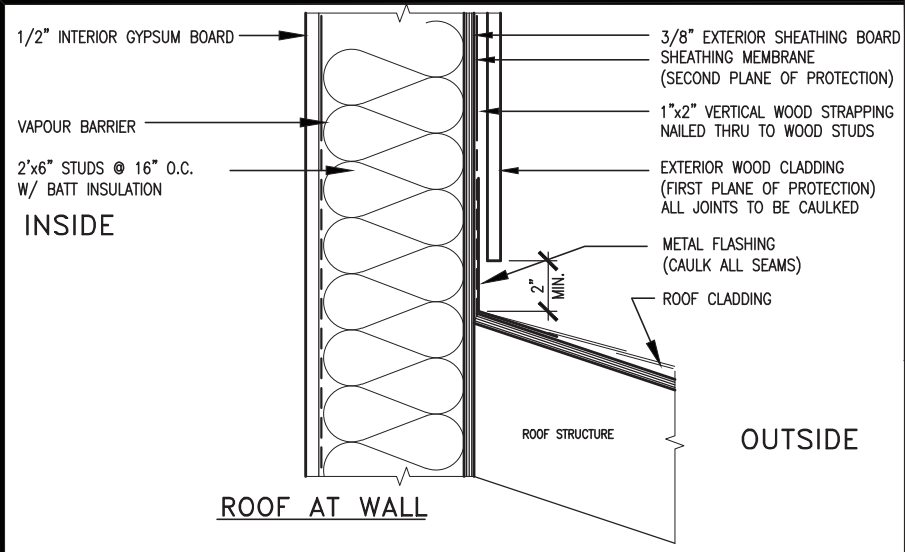

MAX. HEIGHT FOR 2"x4" GARAGE WALL IS AS FOLLOW:
2"x4" @ 16" O.C. - 9'-10"
2-2"x4" @ 12" O.C. - 10'-9"
3-2"x4" @ 16" O.C. - 11'-2"
3-2"x4" @ 12" O.C. - 12'-4"




NOTES:
1. FOR ROOF DESIGN SNOW LOAD OF UP TO 2.5 KPa. SUPPORTED ROOF TRUSS LENGTH OF 6.0m AND FLOOR JOIST LENGTH OF 2.5m OF ONE FLOOR.
2. PROVIDE HORIZONTAL SOLID BLOCKING @ 1200 O.C. (4'-0")
3. PROVIDE A MINIMUM OF 9.5mm (3/8") PLYWOOD OR OSB EXTERIOR SHEATHING ON THE EXTERIOR FACE.
4. FOR A 1/50 YEAR REFERENCE WIND PRESSURE OF 0.6 KPa.
5. STUDS GREATER THAN 9'-10" HIGH TO BE No. 2 SPF.
6. STUD SPECIFICATION IS SUITABLE FOR BRICK VENEER OR SIDING.

** MAX. HEIGHT FOR 2"x6" EXTERIOR WALL IS AS FOLLOW:
2"x6" @ 16" O.C. - 12'-6"
2"x6" @ 12" O.C. - 13'-10"
2-2"x6" @ 16" O.C. - 15'-0"
2-2"x6" @ 12" O.C. - 17'-4"

MAX. HEIGHT FOR 2"x8" EXTERIOR WALL IS AS FOLLOWS:
2"x8" @ 16" O.C. - 16'-0"
2"x8" @ 12" O.C. - 17'-9"
2-2"x8" @ 16" O.C. - 20'-4"
2-2"x8" @ 12" O.C. - 22'-4"

NOTES:
1. FOR ROOF DESIGN SNOW LOAD OF UP TO 2.5 KPa
2. SUPPORTED ROOF TRUSS LENGTH OF 6.0m ONLY.
3. PROVIDE HORIZONTAL SOLID BLOCKING @ 1200 O.C. (4'-0")
4. PROVIDE A MINIMUM OF 9.5mm (3/8") PLYWOOD OR OSB EXTERIOR SHEATHING ON THE EXTERIOR FACE AND 12.5mm (1/2") GYPSUM BOARD ON THE INTERIOR FACE.
5. WALL FRAMING SHALL CONFORM TO OBC 9.2.3.10.1.(2)
6. FOR A 1/50 YEAR REFERENCE WIND PRESSURE OF 0.6 KPa
7. STUDS GREATER THAN 9'-10" HIGH TO BE No. 2 SPF.
8. STUD SPECIFICATION IS SUITABLE FOR BRICK VENEER OR SIDING.

** STUD INFORMATION TAKEN FROM OBC TABLE A-30

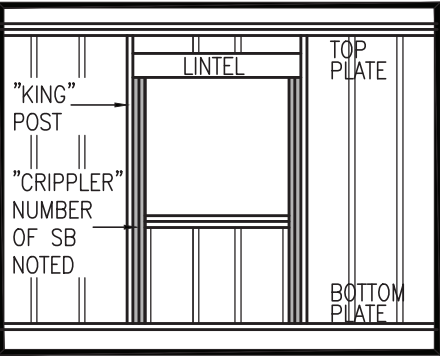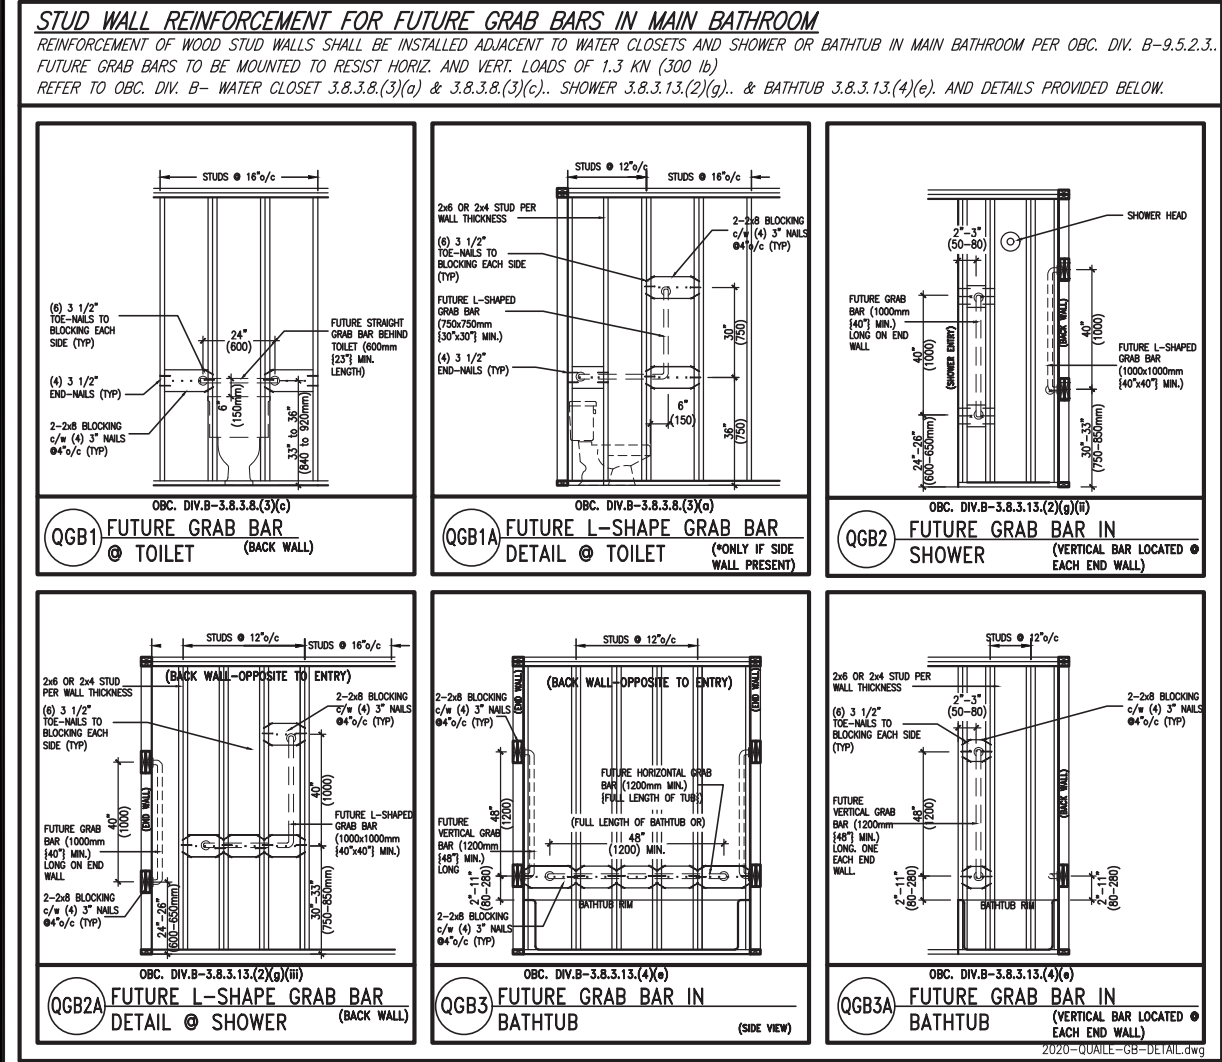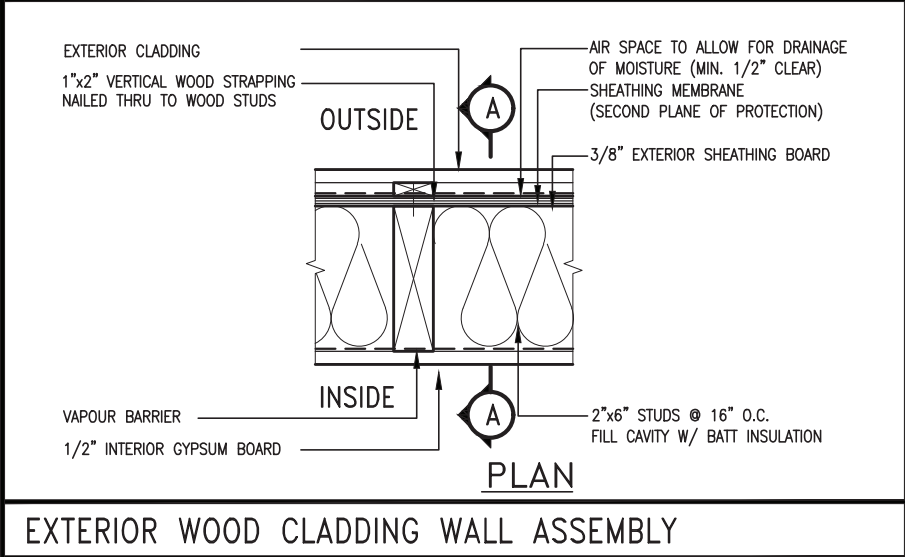


"CRIPPLE" DETAIL



| | | | | |
|-----|-------------------------|-----------|----|---|
| 9 | . | . | . | The undersigned has reviewed and takes responsibility for this design and has the qualifications and meets the requirements set out in the Ontario Building Code to be a Designer. |
| 8 | . | . | . | qualification information |
| 7 | . | . | . | Wellington Jno-Baptiste 25591 |
| 6 | . | . | . | name |
| 5 | . | . | . | registration information |
| 4 | UPDATE TO 2022 | JAN 11-22 | RC | VA3 Design Inc. 42658 |
| 3 | UPDATE TO 2020 | FEB 24-20 | RC | |
| 2 | UPDATE TO 2018 | JAN 11-18 | RC | Contractor must verify all dimensions on the job and report any discrepancy to the Designer before proceeding with the work. All drawings and specifications are instruments of service and the property of the Designer which must be returned at the completion of the work. Drawings are not to be scaled. |
| 1 | ISSUE FOR CLIENT REVIEW | AUG 04-17 | RC | |
| no. | description | date | by | |

VA3 DESIGN
255 Consumers Rd Suite 120
Toronto ON M2J 1R4
t 416.630.2255 f 416.630.4782
va3design.com

| | | | |
|---|-------------------|-------------------|---------------|
| BAYVIEW WELLINGTON | | CONST NOTE | |
| project name | GREEN VALLEY EAST | municipality | BRADFORD |
| date | MAY 2016 | project no. | 16023 |
| drawn by | RC | checked by | scale |
| | | | 3/16" = 1'-0" |
| CONSTRUCTION NOTES | | drawing no. | |
| 16023-CN-2022-A1 | | CN2 | |
| RICHARD - H:\ARCHIVE\WORKING\2016\16023.BW\Units\CN NOTES\16023-CN-2022-A1.dwg - Wed - Jan 26 2022 - 12:05 PM | | | |

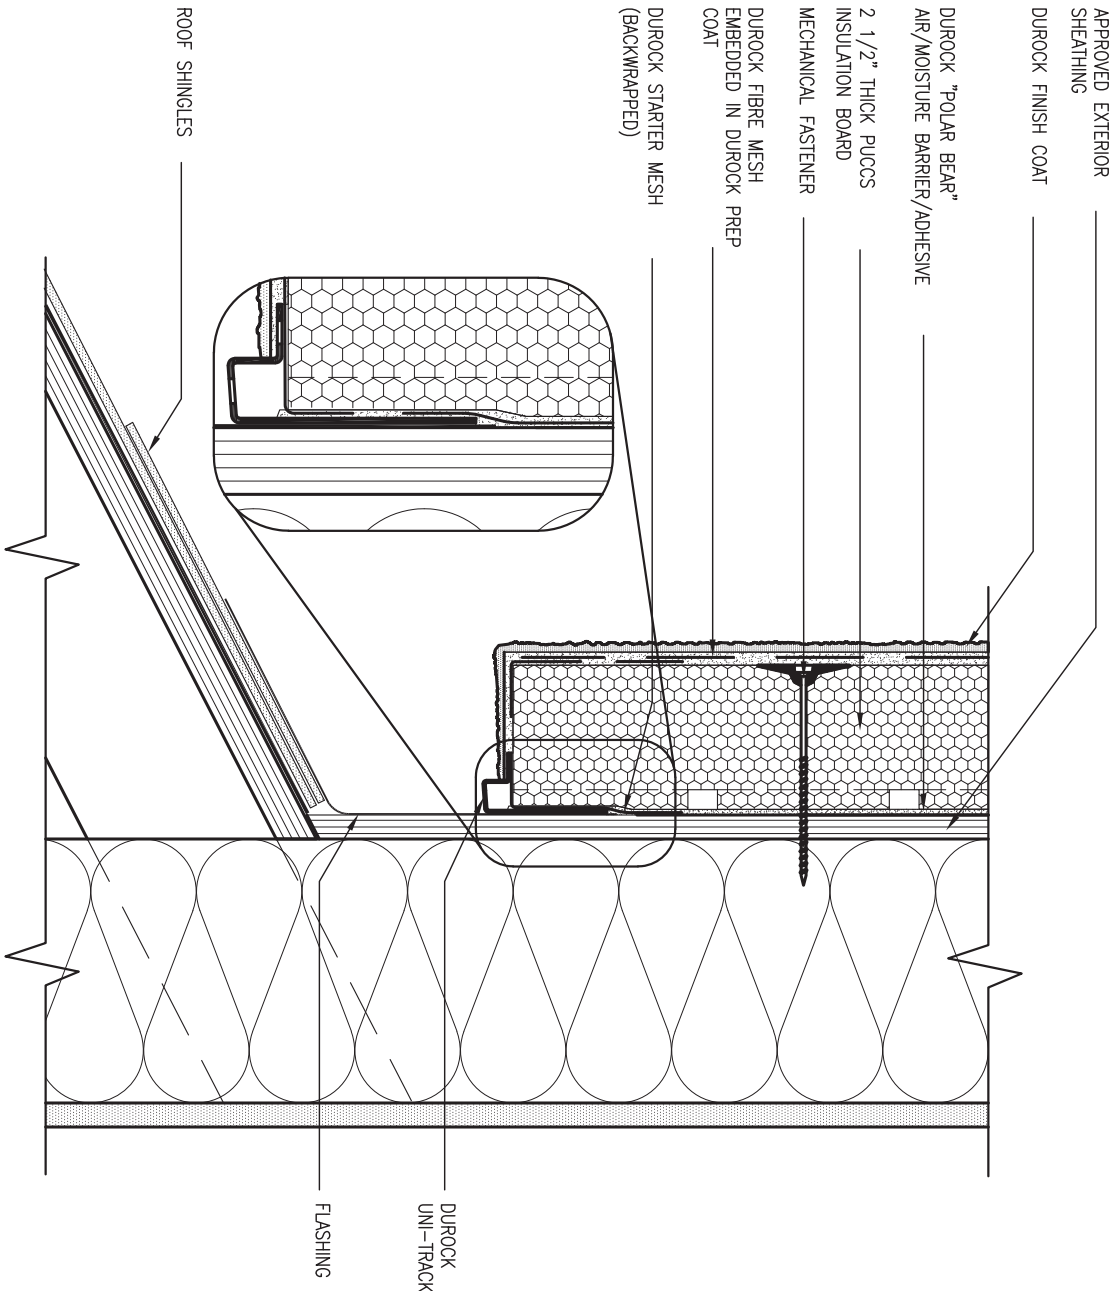


3 STUCCO TERMINATION @ ROOF

CN4 SCALE: 3"=1'-0"

ALL STUCCO WALLS TO HAVE A MINIMUM 10mm AIR SPACE BEHIND THE CLADDING WITH POSITIVE DRAINAGE TO THE EXTERIOR. THE EXTERIOR SHEATHING MUST NOT BE GYPSUM BASED. ALL STUCCO TO BE INSTALLED AS PER MANUFACTURERS SPECIFICATIONS.

DETAILS ARE BASED ON DUROCK PUCCS SYSTEM

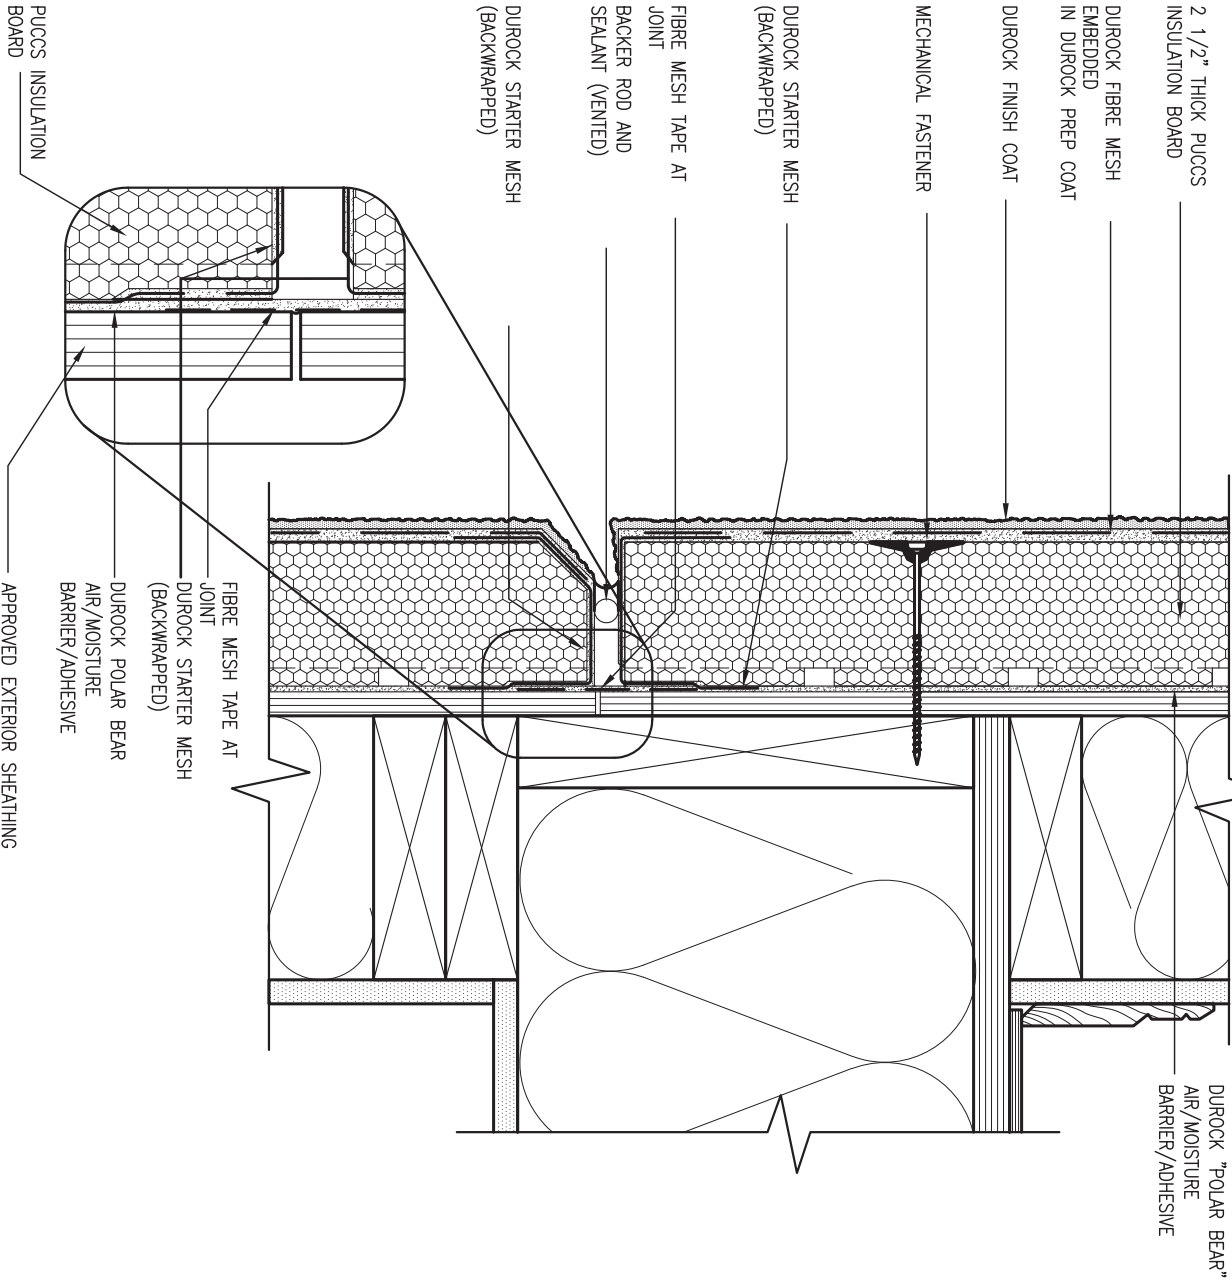

4 HORIZONTAL EXPANSION JOINT

CN4 SCALE: 3"=1'-0"

| | | | |
|-----|-------------------------|-----------|----|
| 9 | . | . | . |
| 8 | . | . | . |
| 7 | . | . | . |
| 6 | . | . | . |
| 5 | . | . | . |
| 4 | UPDATE TO 2022 | JAN 11-22 | RC |
| 3 | UPDATE TO 2020 | FEB 24-20 | RC |
| 2 | UPDATE TO 2018 | JAN 11-18 | RC |
| 1 | ISSUE FOR CLIENT REVIEW | AUG 04-17 | RC |
| no. | description | date | by |

| | | | |
|---|--------------|-------|------|
| The undersigned has reviewed and takes responsibility for this design and has the qualifications and meets the requirements set out in the Ontario Building Code to be a Designer. | | | |
| qualification information | | | |
| Wellington | Jno-Baptiste | 25591 | BCIN |
| name registration information | | 42658 | |
| VA3 Design Inc. | | | |
| Contractor must verify all dimensions on the job and report any discrepancy to the Designer before proceeding with the work. All drawings and specifications are instruments of service and the property of the Designer which must be returned at the completion of the work. Drawings are not to be scaled. | | | |

VA3
DESIGN

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va3design.com

BAYVIEW WELLINGTON

| | | | |
|---|-------------------|--------------|---------------|
| project name | GREEN VALLEY EAST | municipality | BRADFORD |
| date | MAY 2016 | checked by | RC |
| drawn by | RC | scale | 3/16" = 1'-0" |
| RICHARD - H:\ARCHIVE\WORKING\2016\16023.BW\Units\CN NOTES\16023-CN-2022-A1.dwg - Wed - Jan 26 2022 - 12:07 PM | | | |


CONST NOTE

CONSTRUCTION NOTES

16023-CN-2022-A1

drawing no.

CN4

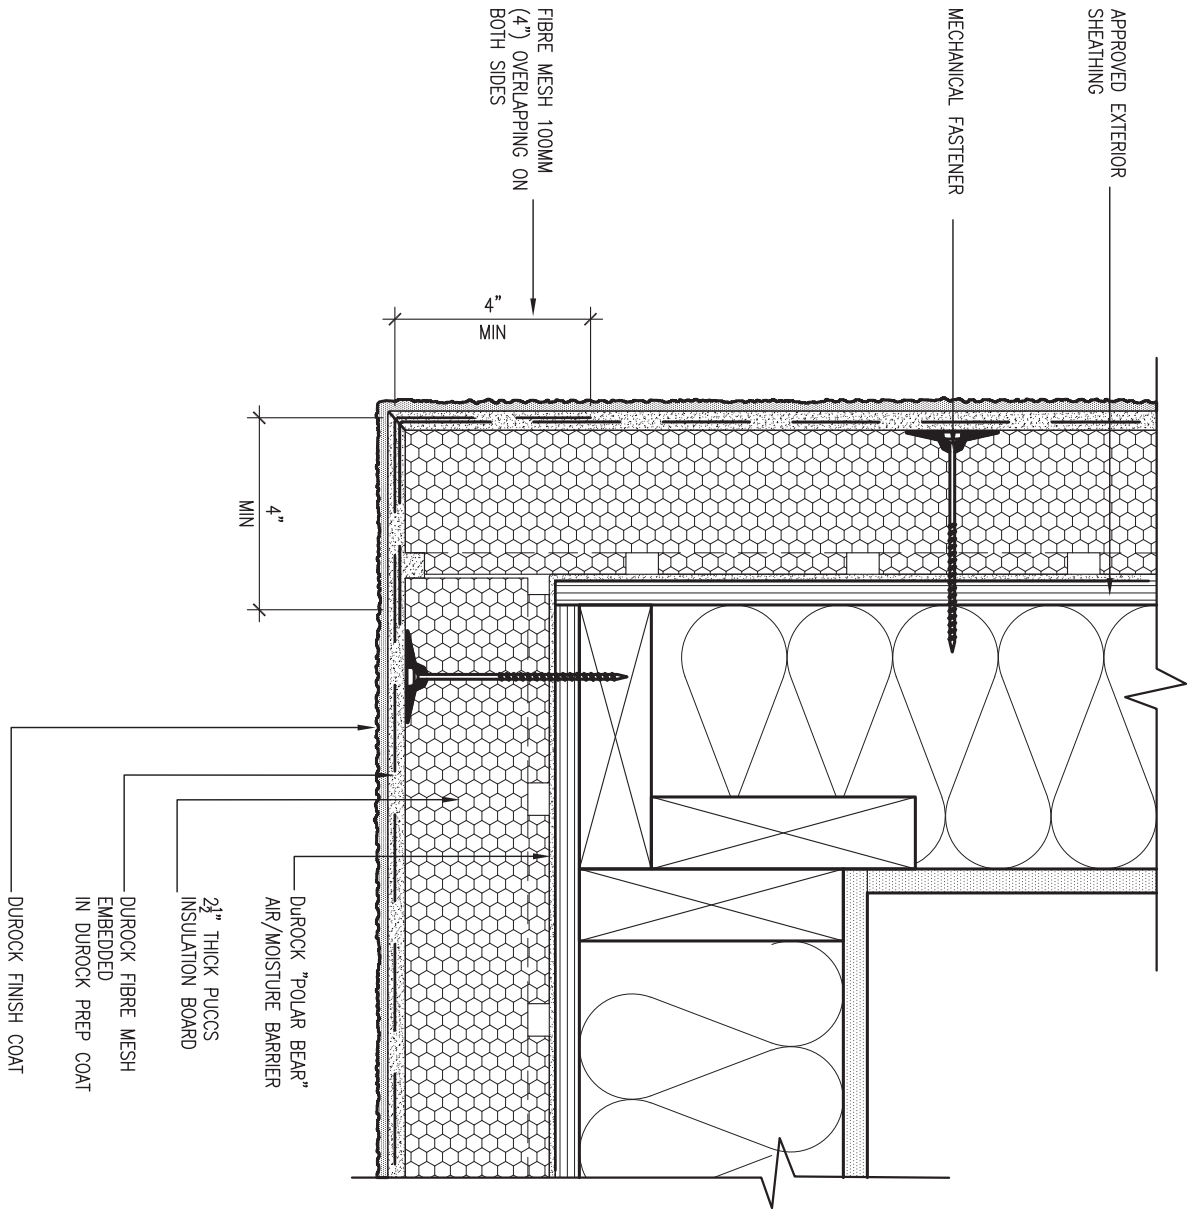


5 CORNER DETAIL

CN5 SCALE: 3"=1'-0"

ALL STUCCO WALLS TO HAVE A MINIMUM 10mm AIR SPACE BEHIND THE CLADDING WITH POSITIVE DRAINAGE TO THE EXTERIOR. THE EXTERIOR SHEATHING MUST NOT BE GYPSUM BASED. ALL STUCCO TO BE INSTALLED AS PER MANUFACTURERS SPECIFICATIONS.

DETAILS ARE BASED ON DUROCK PUCCS SYSTEM

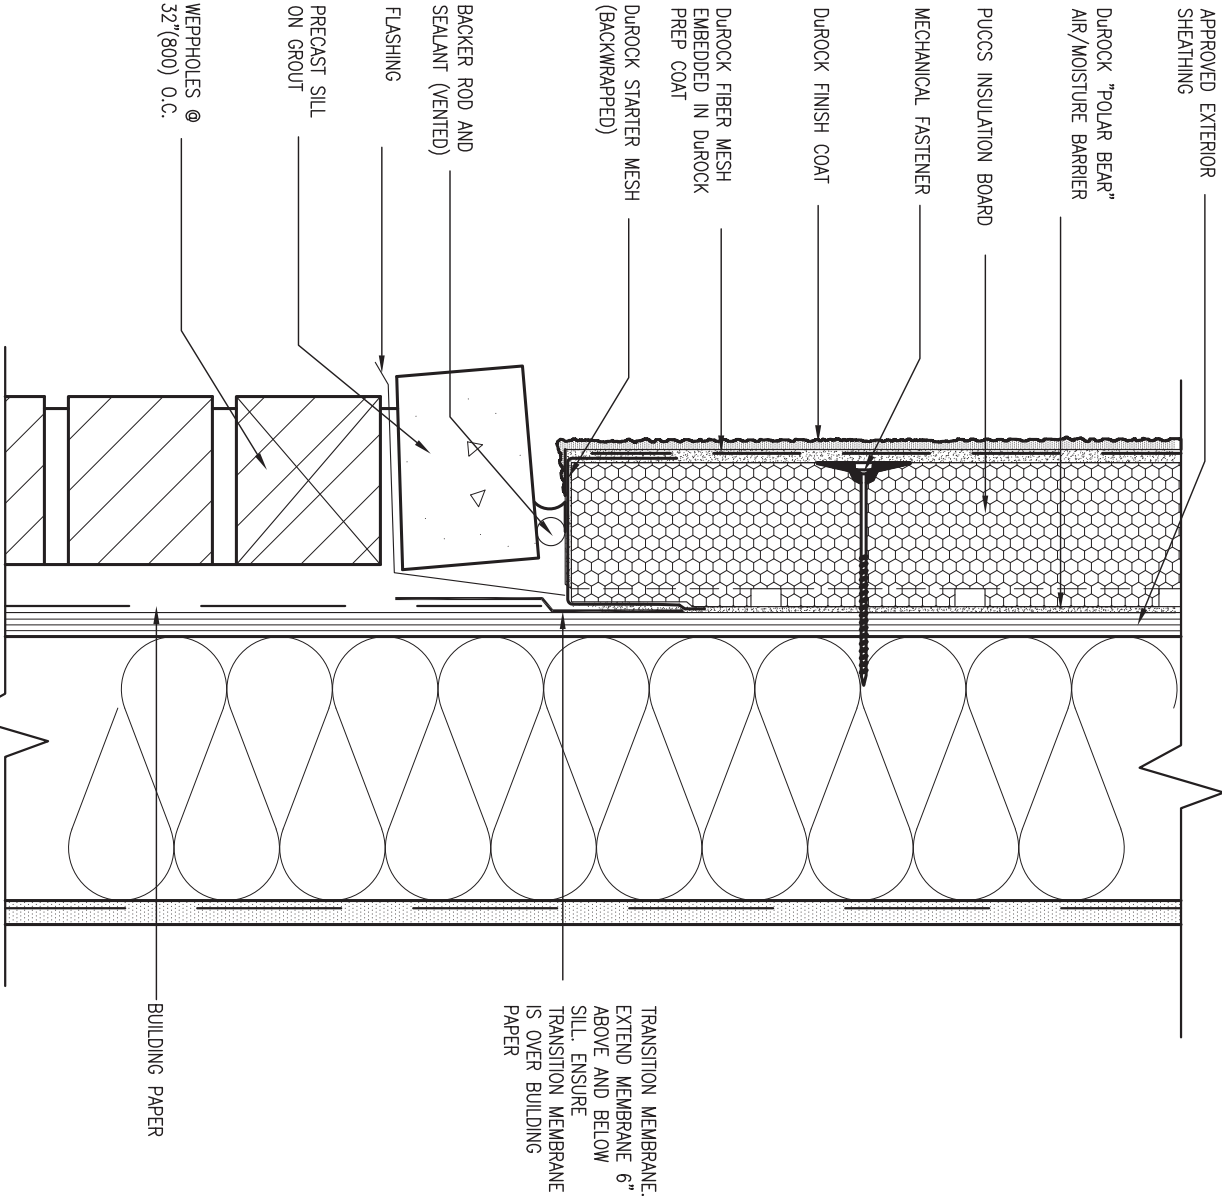


6 STUCCO / MASONRY PLINTH CONNECTION

CN5 SCALE: 3"=1'-0"

| | | | | | | | | | | | | | | |
|---|--|--|---|----|------|---|------------------|--------------------|--|-----------|-------------|--|--|--|
| 9 . | | | <div>The undersigned has reviewed and takes responsibility for this design and has the qualifications and meets the requirements set out in the Ontario Building Code to be a Designer.</div> <div>Wellington Jno-Baptiste 25591</div> <div>signatureBCIN</div> <div>VA3 Design Inc. 42658</div> <div>Contractor must verify all dimensions on the job and report any discrepancy to the Designer before proceeding with the work. All drawings and specifications are instruments of service and the property of the Designer which must be returned at the completion of the work. Drawings are not to be scaled.</div> | | | <div>VA3 DESIGN</div> <div>255 Consumers Rd Suite 120</div> <div>Toronto ON M2J 1R4</div> <div>t 416.630.2255 f 416.630.4782</div> <div>va3design.com</div> | | | <div>BAYVIEW WELLINGTON</div> <div>project nameGREEN VALLEY EAST</div> <div>municipalityBRADFORD</div> <div>project no.16023</div> | | | <div>CONST NOTE</div> <div>-</div> <div>project no.16023</div> | | |
| 8 . | | | | | | | | | | | | | | |
| 7 . | | | | | | | | | | | | | | |
| 6 . | | | | | | | | | | | | | | |
| 5 . | | | | | | | | | | | | | | |
| 4 UPDATE TO 2022 | | | JAN 11-22 | RC | | | | CONSTRUCTION NOTES | | | drawing no. | | | |
| 3 UPDATE TO 2020 | | | FEB 24-20 | RC | | | | MAY 2016 | | | CN5 | | | |
| 2 UPDATE TO 2018 | | | JAN 11-18 | RC | | | | drawn by | | | | | | |
| 1 ISSUE FOR CLIENT REVIEW | | | AUG 04-17 | RC | | | | checked by | | | | | | |
| no. | | | description | | date | by | scale | | | | | | | |
| | | | | | | | 3/16" = 1'-0" | | | file name | | | | |
| | | | | | | | 16023-CN-2022-A1 | | | | | | | |
| RICHARD - H:\ARCHIVE\WORKING\2016\16023.BW\Units\CN NOTES\16023-CN-2022-A1.dwg - Wed - Jan 26 2022 - 12:08 PM | | | | | | | | | | | | | | |

SB12-COMPLIANCE PACKAGE 'A1'

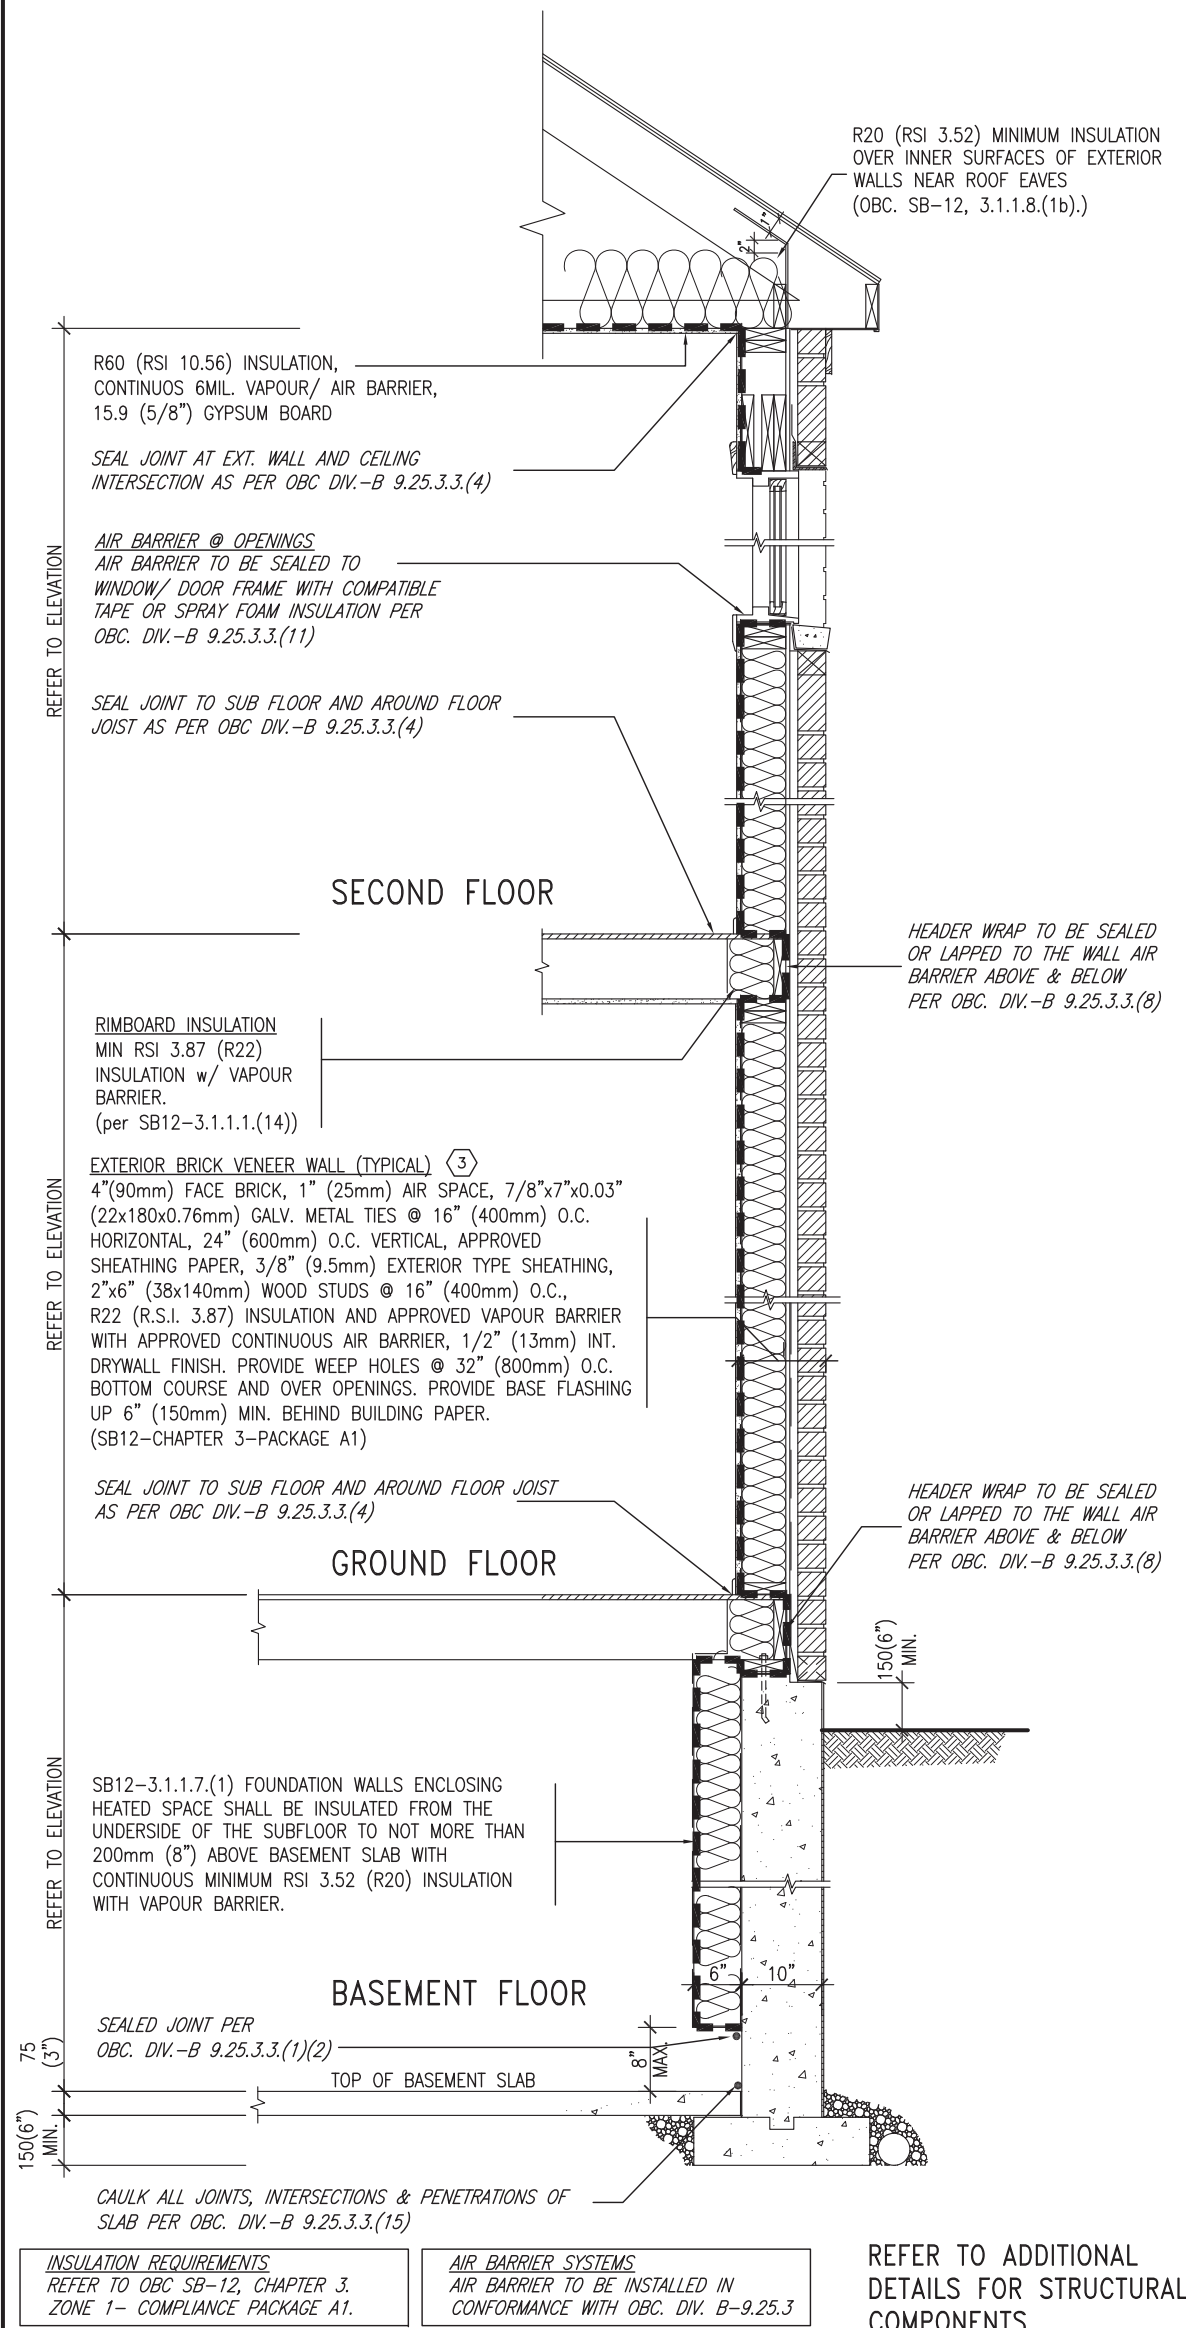


EW TYPICAL EXT. WALL AIR BARRIER CONTINUITY SECTION w/ BRICK VENEER (PACKAGE A1) 10" FOUNDATION WALL SCALE: N.T.S.

THE MINIMAL THERMAL PERFORMANCE OF BUILDING ENVELOPE AND EQUIPMENT SHALL CONFORM TO THE FOLLOWING SB-12 COMPLIANCE PACKAGE AS PER OBC SUPPLEMENTARY STANDARD SB-12, SECTION 3.1.1.1.

USE SB-12 COMPLIANCE PACKAGE (A1):

| COMPONENT | A1 | Notes: |
|---|---|-------------------------------------|
| Ceiling with Attic Space | 10.56 | R20 at inner face of exterior walls |
| Minimum RSI (R) value | (R60) | |
| Ceiling without Attic Space | 5.46 | BATT or SPRAY |
| Minimum RSI (R) value | (R31) | |
| Exposed Floor | 5.46 | BATT or SPRAY |
| Minimum RSI (R) value | (R31) | |
| Walls Above Grade | 3.87 | 6" R22 BATT |
| Minimum RSI (R) value | (R22) | |
| Basement Walls | 3.52ci | OPTION TO USE R12+R10ci. |
| Minimum RSI (R) value | (R20ci) | |
| Edge of Below Grade Slab ≤600mm below grade | 1.76 | RIGID INSUL |
| Minimum RSI (R) value | (R10) | |
| Windows & Sliding glass Doors | 1.6 | |
| Maximum U-value | | |
| Skylights | | |
| Maximum U-value | 2.8U | |
| Space Heating Equipment | 96% Min. | NATURAL GAS |
| Minimum AFUE | | |
| Hot Water Heater | 0.8 | NATURAL GAS |
| Minimum EF | | |
| HRV | 75% | — |
| Minimum Efficiency | | |
| Drain Water Heat Recovery Unit (DWHR) | Minimum 1 OR Maximum 2 Required. Dependent on number of showers installed. Refer to SB12-3.1.1.12 for information | |

ci- Denotes Continuous Insulation without framing interruption.

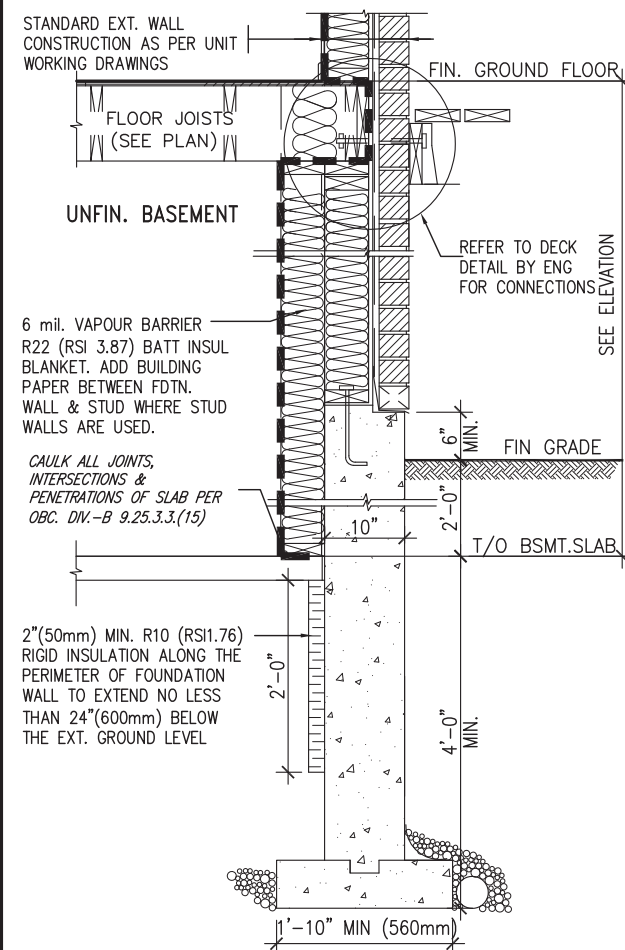

* REVISED-FEB 2017


SECTION AT W.O.D/W.O.B.

| | | | | | | | |
|-----|-------------------------|-----------|----|--|--|--|--|
| 9 | . | . | . | <div>The undersigned has reviewed and takes responsibility for this design and has the qualifications and meets the requirements set out in the Ontario Building Code to be a Designer.</div> <div>qualification information</div> <div>Wellington Jno-Baptiste 25591</div> <div>signature BCIN</div> <div>registration information</div> <div>VA3 Design Inc. 42658</div> | <div>VA3</div> <div>DESIGN</div> <div>255 Consumers Rd Suite 120</div> <div>Toronto ON M2J 1R4</div> <div>t 416.630.2255 f 416.630.4782</div> <div>va3design.com</div> | <div>BAYVIEW WELLINGTON</div> <div>project name</div> <div>GREEN VALLEY EAST</div> <div>municipality</div> <div>BRADFORD</div> <div>project no.</div> <div>16023</div> | <div>CONST NOTE</div> <div>-</div> <div>project no.</div> <div>16023</div> |
| 8 | . | . | . | | | | |
| 7 | . | . | . | | | | |
| 6 | . | . | . | | | | |
| 5 | . | . | . | | | | |
| 4 | UPDATE TO 2022 | JAN 11-22 | RC | | | | |
| 3 | UPDATE TO 2020 | FEB 24-20 | RC | | | | |
| 2 | UPDATE TO 2018 | JAN 11-18 | RC | | | | |
| 1 | ISSUE FOR CLIENT REVIEW | AUG 04-17 | RC | | | | |
| no. | description | date | by | | | | |

| | | |
|---|--|--|
| Contractor must verify all dimensions on the job and report any discrepancy to the Designer before proceeding with the work. All drawings and specifications are instruments of service and the property of the Designer which must be returned at the completion of the work. Drawings are not to be scaled. | | |
|---|--|--|


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| date | | MAY 2016 | | CONSTRUCTION NOTES | | drawing no. |
| drawn by | checked by | scale | 3/16" = 1'-0" | file name | 16023-CN-2022-A1 | CN6 |
| RC | - | | | | | |
| RICHARD - H:\ARCHIVE\WORKING\2016\16023.BW\Units\CN NOTES\16023-CN-2022-A1.dwg - Wed - Jan 26 2022 - 12:08 PM | | | | | | |

SB12-COMPLIANCE PACKAGE 'A1'

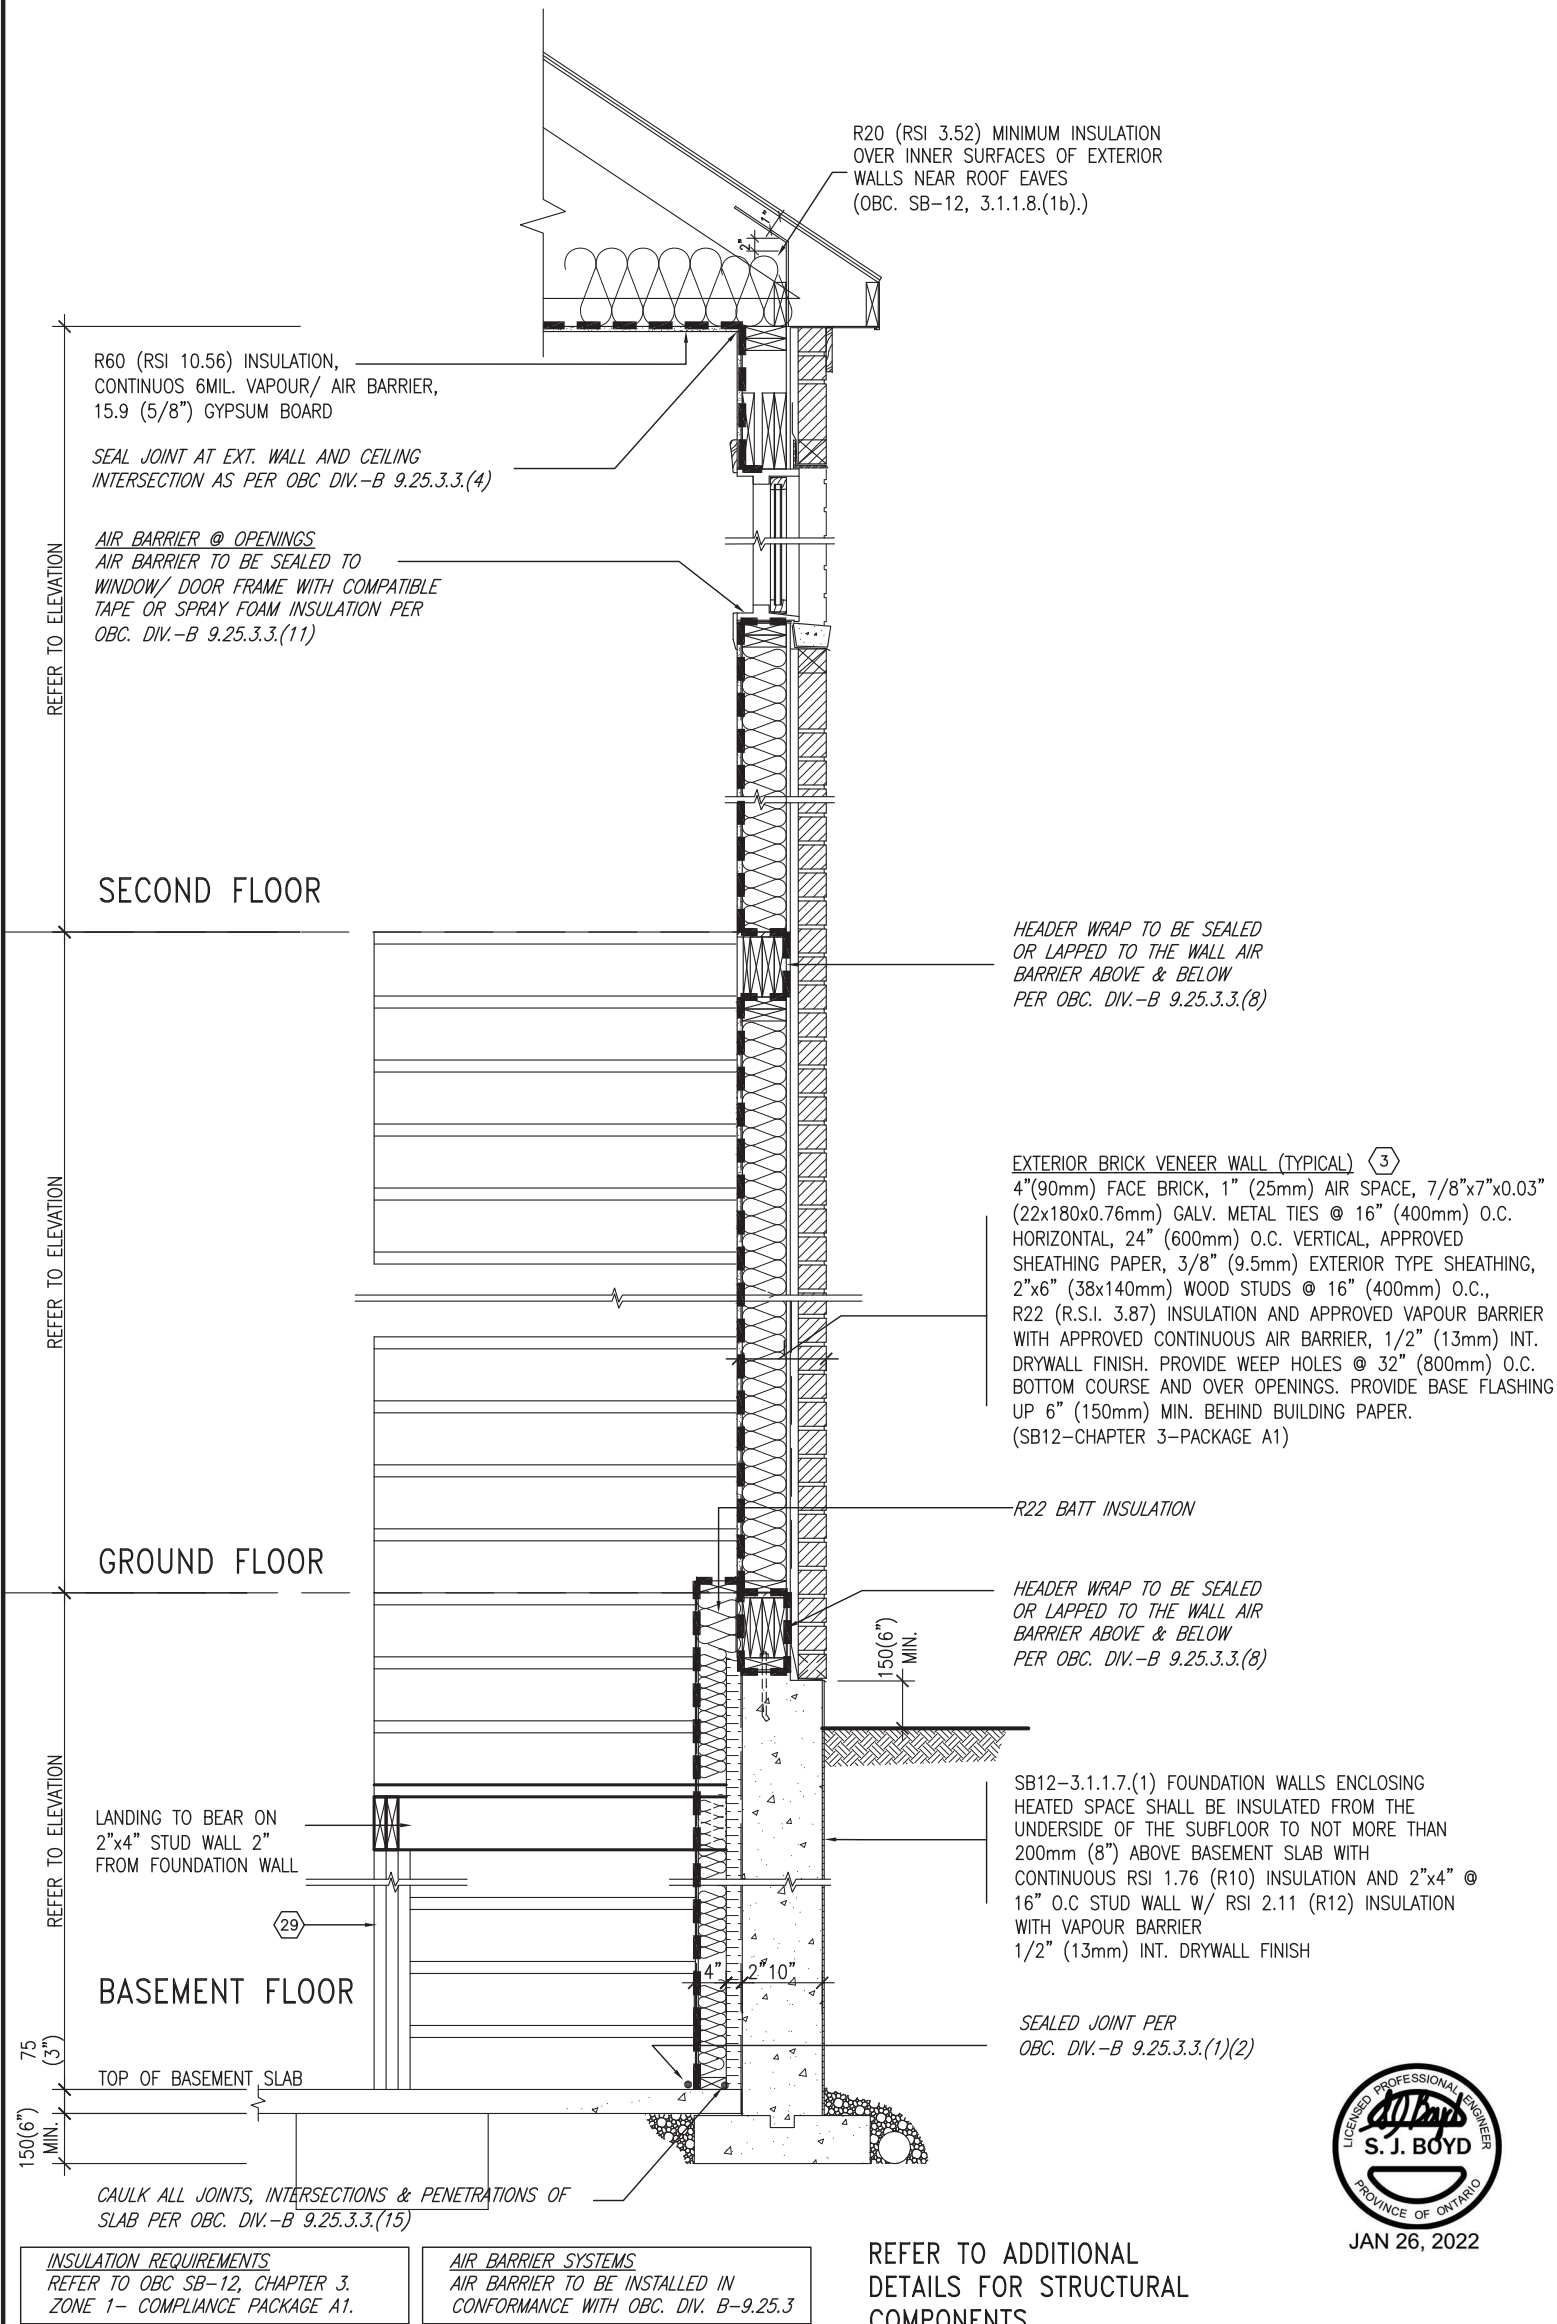

EW STR TYPICAL EXT. WALL AIR BARRIER CONTINUITY SECTION w/
BRICK VENEER AT STAIR AND SUNKEN COND (PACKAGE A1)
10" FOUNDATION WALL
SCALE: N.T.S.

| | | | | | | | | | |
|-----|-------------------------|-----------|----|--|--|--------------------|--|--------------------|--|
| 9 | . | . | . | <div>The undersigned has reviewed and takes responsibility for this design and has the qualifications and meets the requirements set out in the Ontario Building Code to be a Designer.</div> <div>qualification information</div> <div>Wellington Jno-Baptiste 25591</div> <div>signature BCIN</div> <div>VA3 Design Inc. 42658</div> | <div>VA3 DESIGN</div> <div>255 Consumers Rd Suite 120 Toronto ON M2J 1R4 t 416.630.2255 f 416.630.4782 va3design.com</div> | BAYVIEW WELLINGTON | | CONST NOTE | |
| 8 | . | . | . | | | project name | | project no. | |
| 7 | . | . | . | | | GREEN VALLEY EAST | | 16023 | |
| 6 | . | . | . | | | municipality | | BRADFORD | |
| 5 | . | . | . | | | date | | CONSTRUCTION NOTES | |
| 4 | UPDATE TO 2022 | JAN 11-22 | RC | MAY 2016 | | drawing no. | | | |
| 3 | UPDATE TO 2020 | FEB 24-20 | RC | drawn by | | file name | | | |
| 2 | UPDATE TO 2018 | JAN 11-18 | RC | checked by | | 16023-CN-2022-A1 | | | |
| 1 | ISSUE FOR CLIENT REVIEW | AUG 04-17 | RC | scale | | CN7 | | | |
| no. | description | date | by | RICHARD - H:\ARCHIVE\WORKING\2016\16023.BW\Units\CN NOTES\16023-CN-2022-A1.dwg - Wed - Jan 26 2022 - 12:09 PM | | | | | |

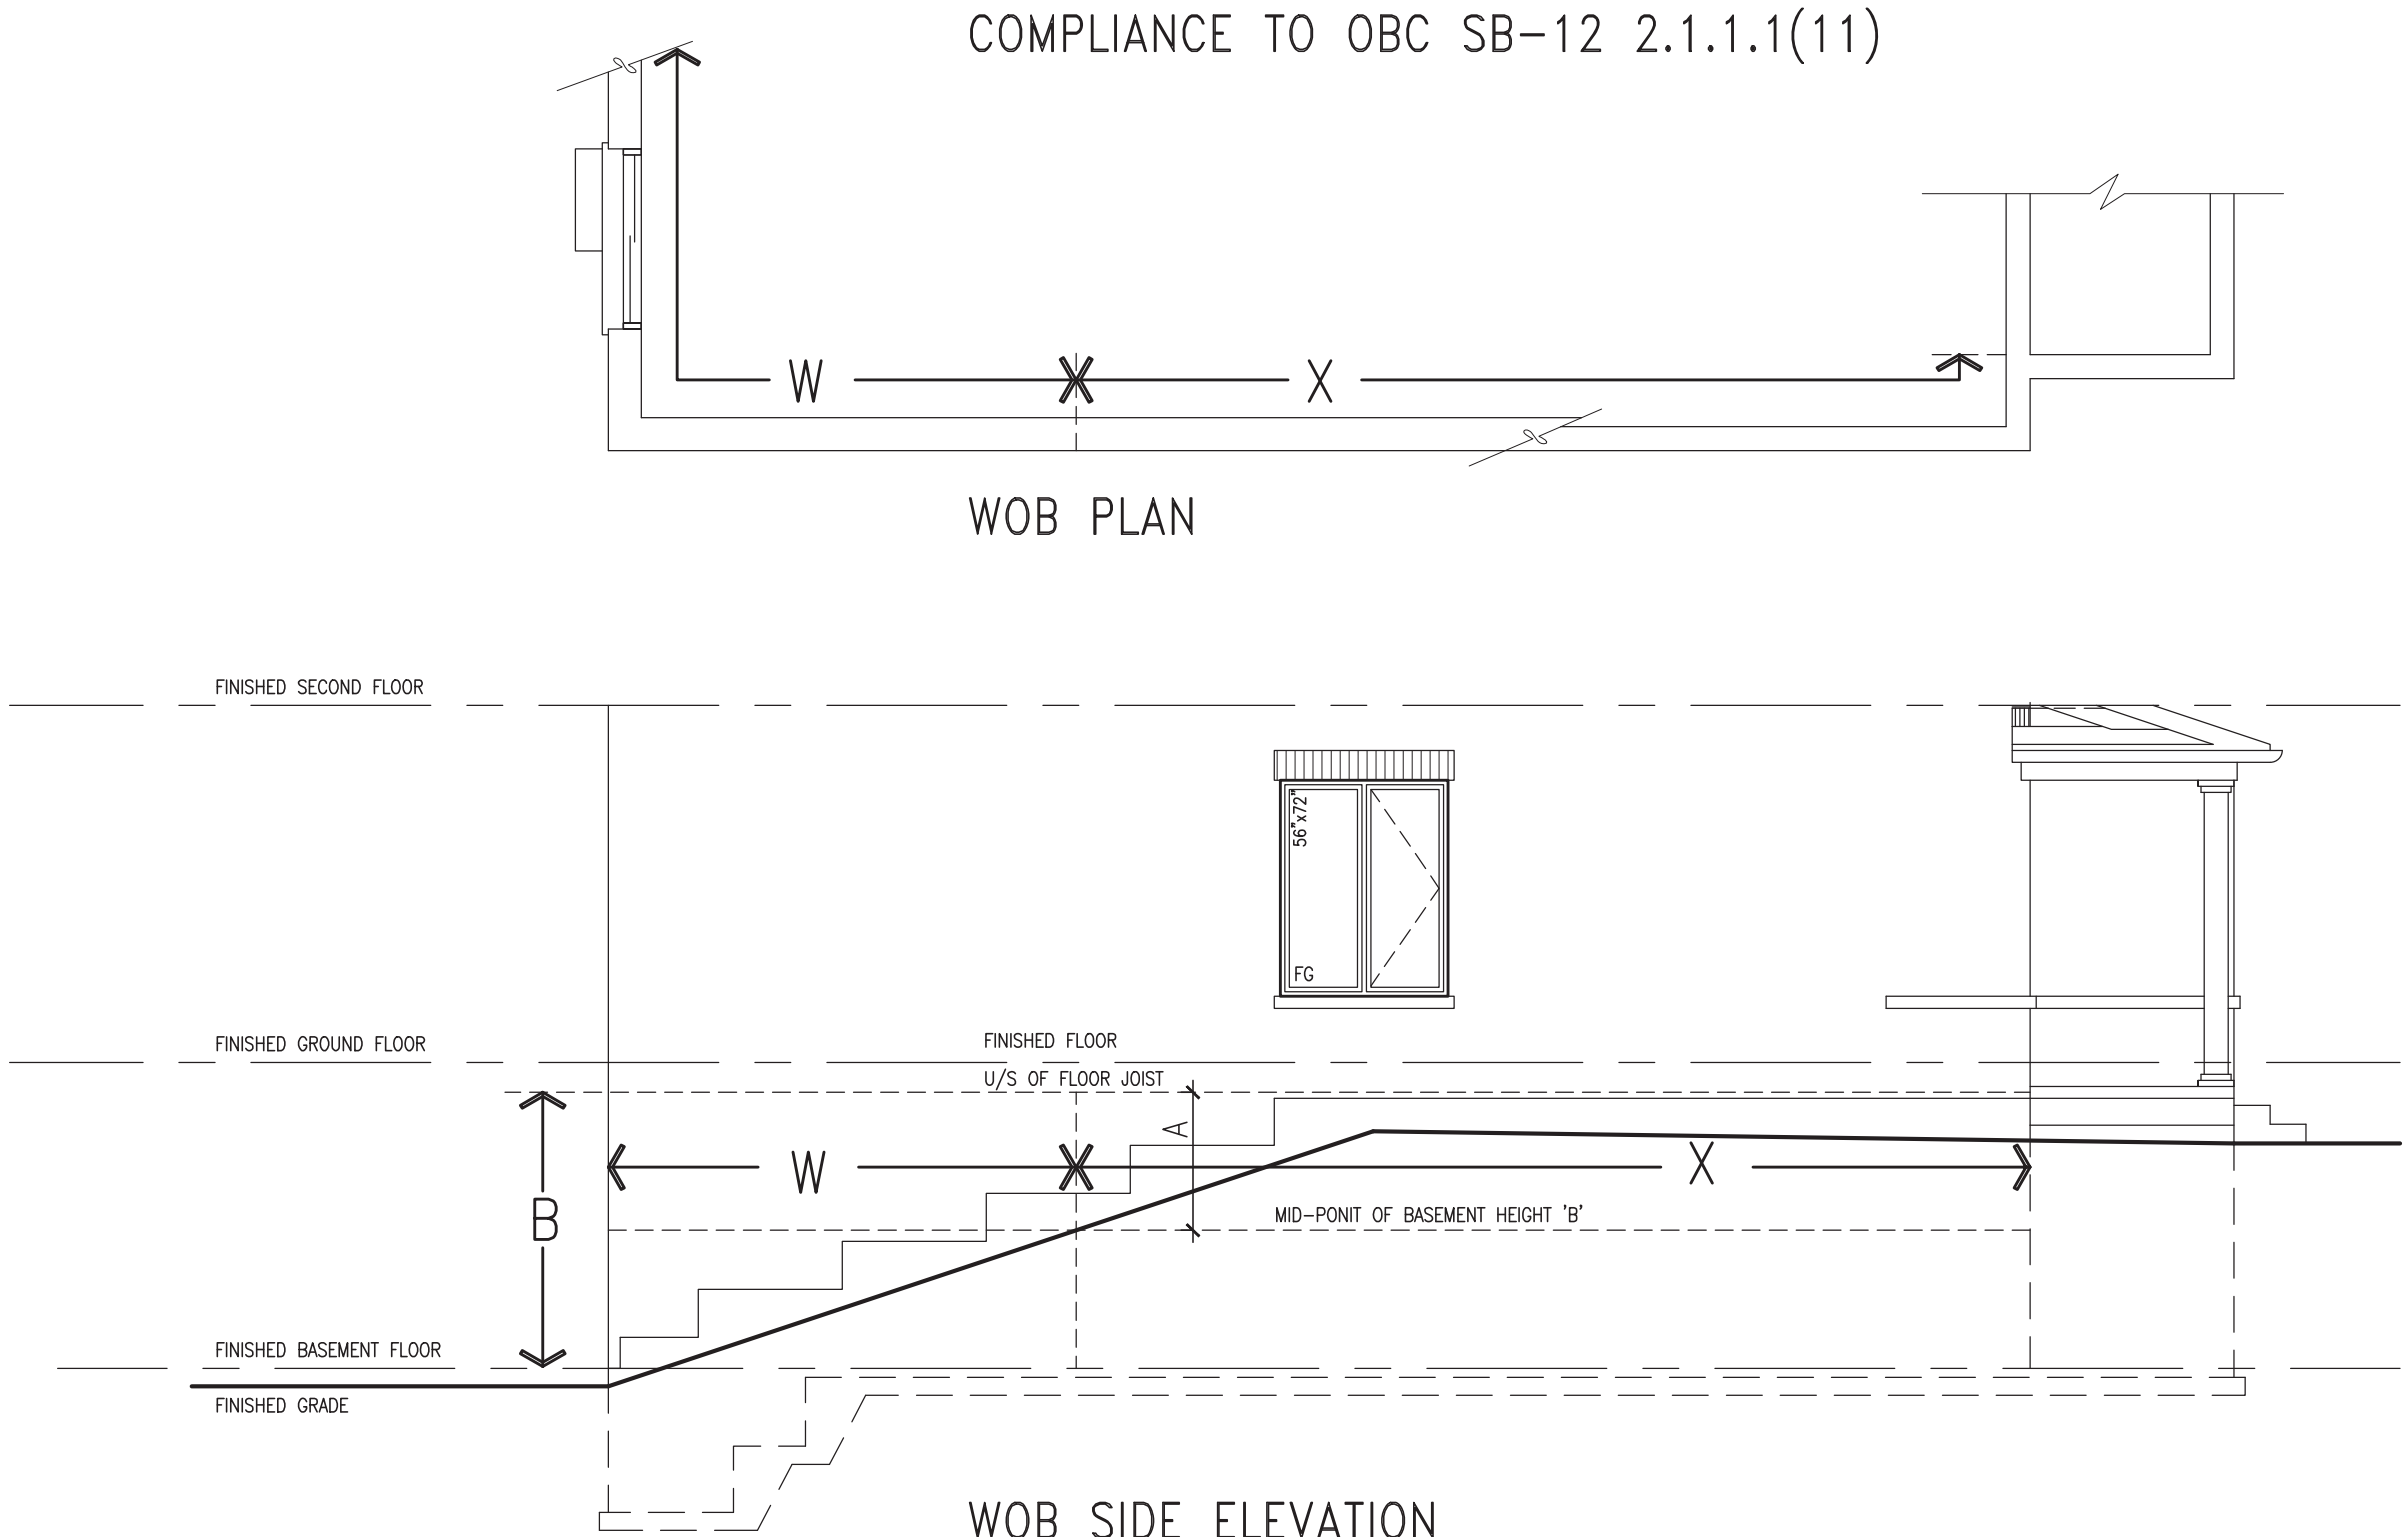

WHEN EXPOSED WALL "A" IS GREATER THAN 50% OF BASEMENT WALL HEIGHT "B" INSULATION VALUE FOR WALL IN SECTION "W" IS NOT LESS THAN IS REQUIRED FOR ABOVE GRADE WALL AS REQUIRED BY TABLE 2.1.1.2A

WHEN EXPOSED WALL "A" IS LESS THAN 50% OF BASEMENT WALL HEIGHT "B" INSULATION VALUE FOR WALL IN SECTION "X" IS NOT LESS THAN BASEMENT WALL AS REQUIRED BY TABLE 2.1.1.2A



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qualification information

Wellington Jno-Baptiste 25591 BCIN

name

registration information

VAS Design Inc. 42658

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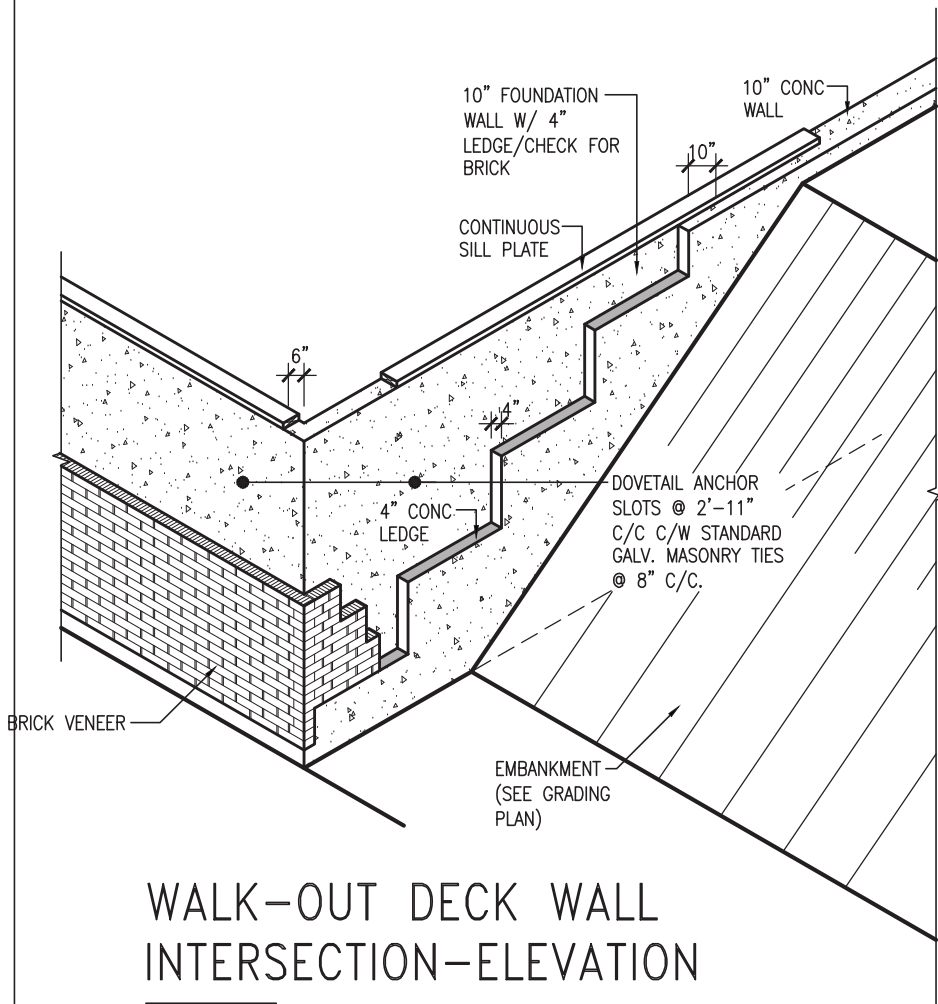
| no. | description | date | by |
|-----|-------------------------|-----------|----|
| 9 | . | . | . |
| 8 | . | . | . |
| 7 | . | . | . |
| 6 | . | . | . |
| 5 | . | . | . |
| 4 | UPDATE TO 2022 | JAN 11-22 | RC |
| 3 | UPDATE TO 2020 | FEB 24-20 | RC |
| 2 | UPDATE TO 2018 | JAN 11-18 | RC |
| 1 | ISSUE FOR CLIENT REVIEW | AUG 04-17 | RC |

| project name | municipality | project no. | drawing no. |
|---|--------------|---------------|------------------|
| GREEN VALLEY EAST | BRADFORD | 16023 | CN8 |
| CONSTRUCTION NOTES | | | |
| drawn by | checked by | scale | file name |
| RC | - | 3/16" = 1'-0" | 16023-CN-2022-A1 |
| RICHARD - H:\ARCHIVE\WORKING\2016\16023.BW\Units\CN NOTES\16023-CN-2022-A1.dwg - Wed - Jan 26 2022 - 12:06 PM | | | |

BAYVIEW WELLINGTON


CONST NOTE

[illegible]



WALK-OUT DECK WALL INTERSECTION-ELEVATION


NOT TO SCALE

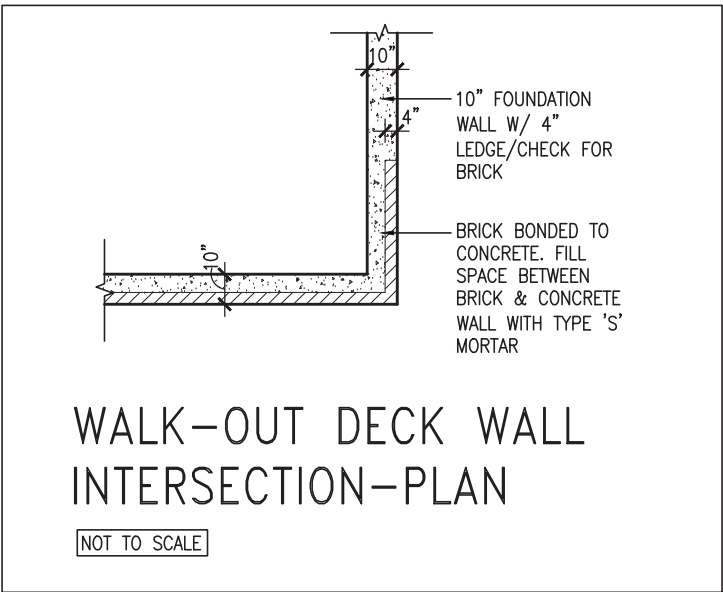

WALK-OUT DECK WALL INTERSECTION-PLAN


NOT TO SCALE

(10" FOUNDATION WALL)

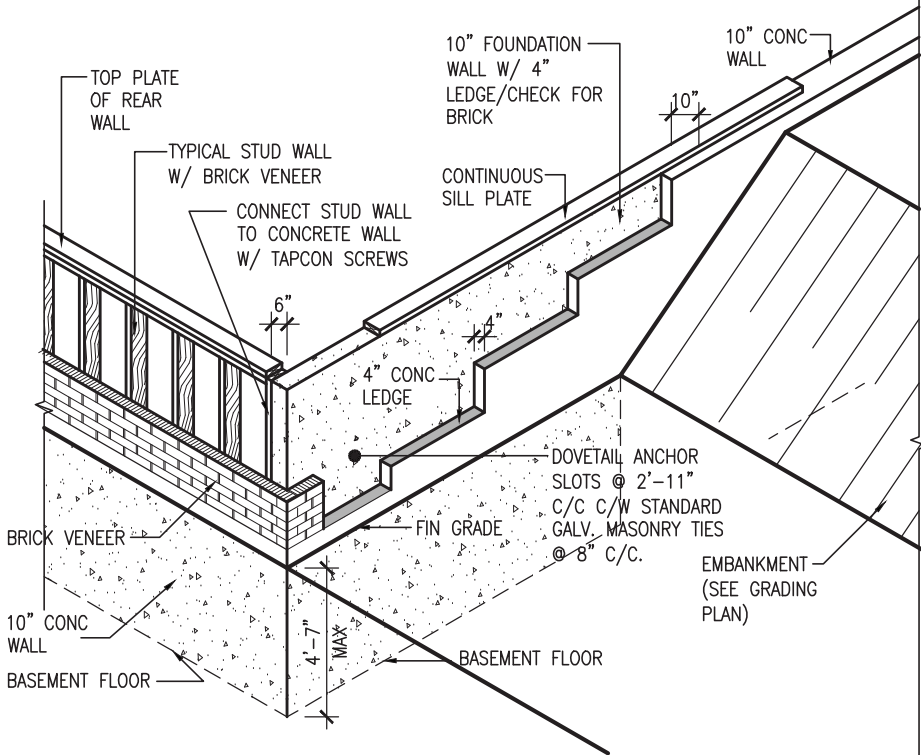

WALK-OUT DECK WALL INTERSECTION-ELEVATION MAX 4'-7" BACKFILL

NOT TO SCALE

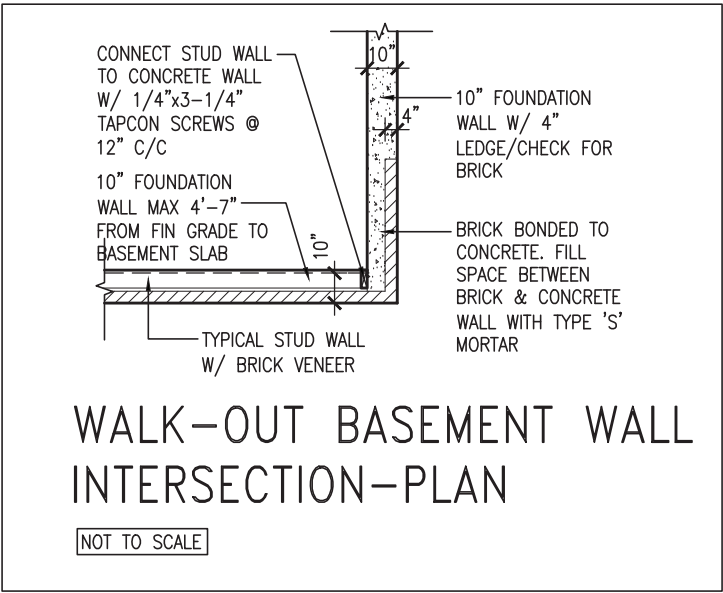

WALK-OUT BASEMENT WALL INTERSECTION-PLAN

NOT TO SCALE

(10" FOUNDATION WALL)



| | | | |
|-----|-------------------------|-----------|----|
| 9. | . | . | . |
| 8. | . | . | . |
| 7. | . | . | . |
| 6. | . | . | . |
| 5. | . | . | . |
| 4. | UPDATE TO 2022 | JAN 11-22 | RC |
| 3. | UPDATE TO 2020 | FEB 24-20 | RC |
| 2. | UPDATE TO 2018 | JAN 11-18 | RC |
| 1. | ISSUE FOR CLIENT REVIEW | AUG 04-17 | RC |
| no. | description | date | by |

| | | | |
|---|--------------------------|-------|------|
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| qualification information | | | |
| Wellington Jno-Baptiste | signature | 25591 | BCIN |
| VA3 Design Inc. | registration information | 42658 | |
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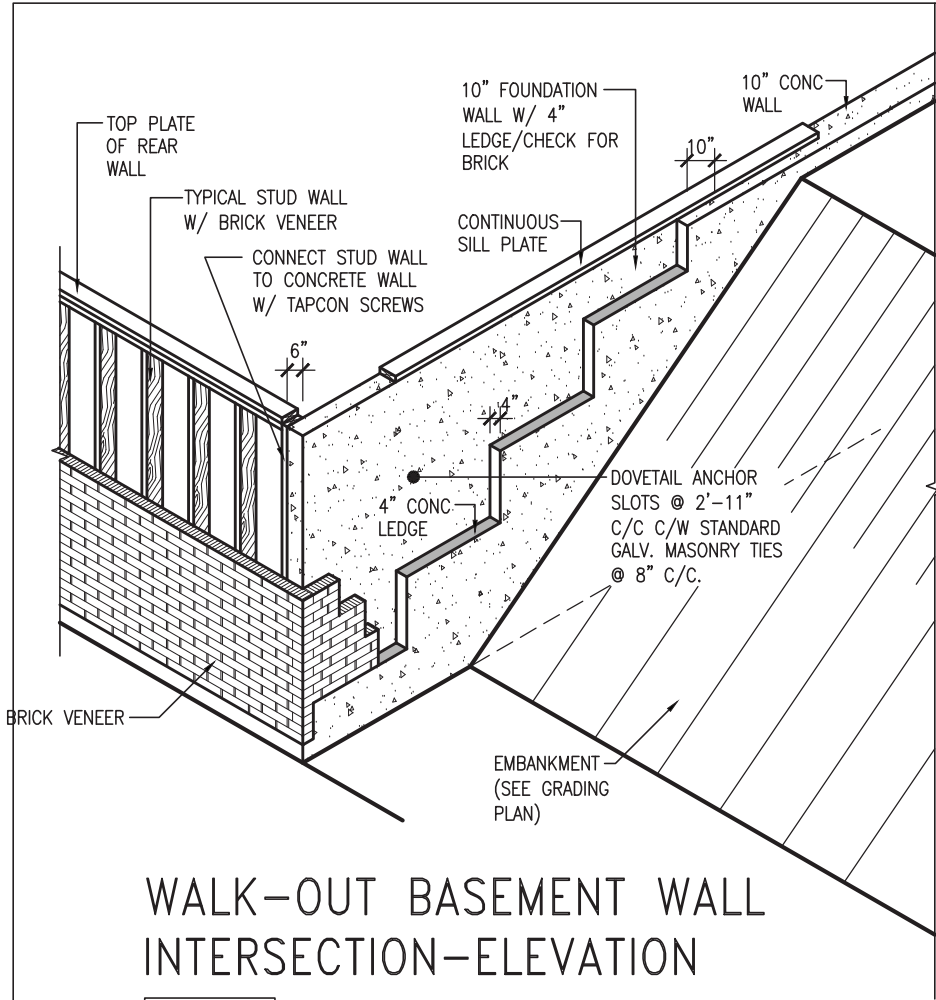


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Toronto ON M2J 1R4
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va3design.com

BAYVIEW WELLINGTON


CONST NOTE

| | | | | | |
|---|-------------------|--------------|---------------|--------------------|-------------|
| project name | GREEN VALLEY EAST | municipality | BRADFORD | project no. | 16023 |
| date | MAY 2016 | checked by | scale | CONSTRUCTION NOTES | drawing no. |
| drawn by | RC | | 3/16" = 1'-0" | 16023-CN-2022-A1 | CN10 |
| RICHARD - H:\ARCHIVE\WORKING\2016\16023.BW\Units\CN NOTES\16023-CN-2022-A1.dwg - Wed - Jan 26 2022 - 12:06 PM | | | | | |



WALK-OUT BASEMENT WALL
INTERSECTION-ELEVATION


NOT TO SCALE

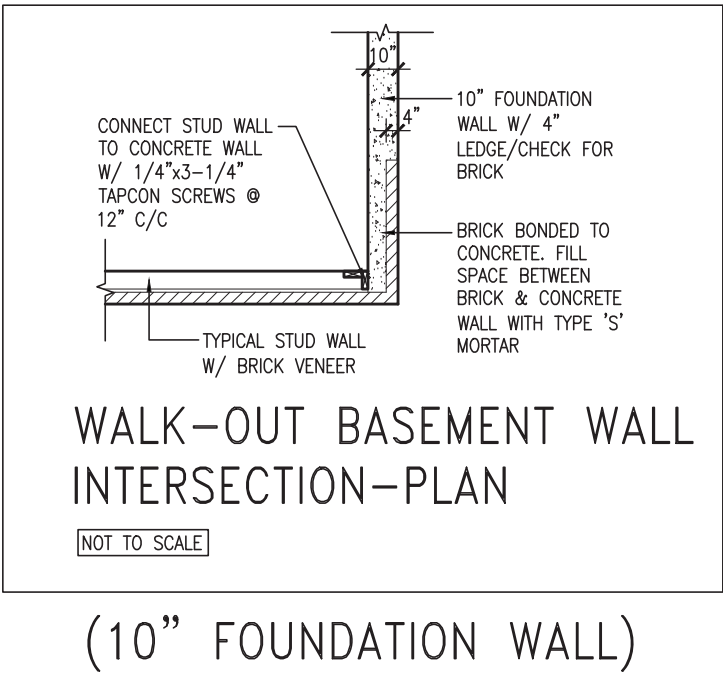

WALK-OUT BASEMENT WALL
INTERSECTION-PLAN


NOT TO SCALE

(10" FOUNDATION WALL)

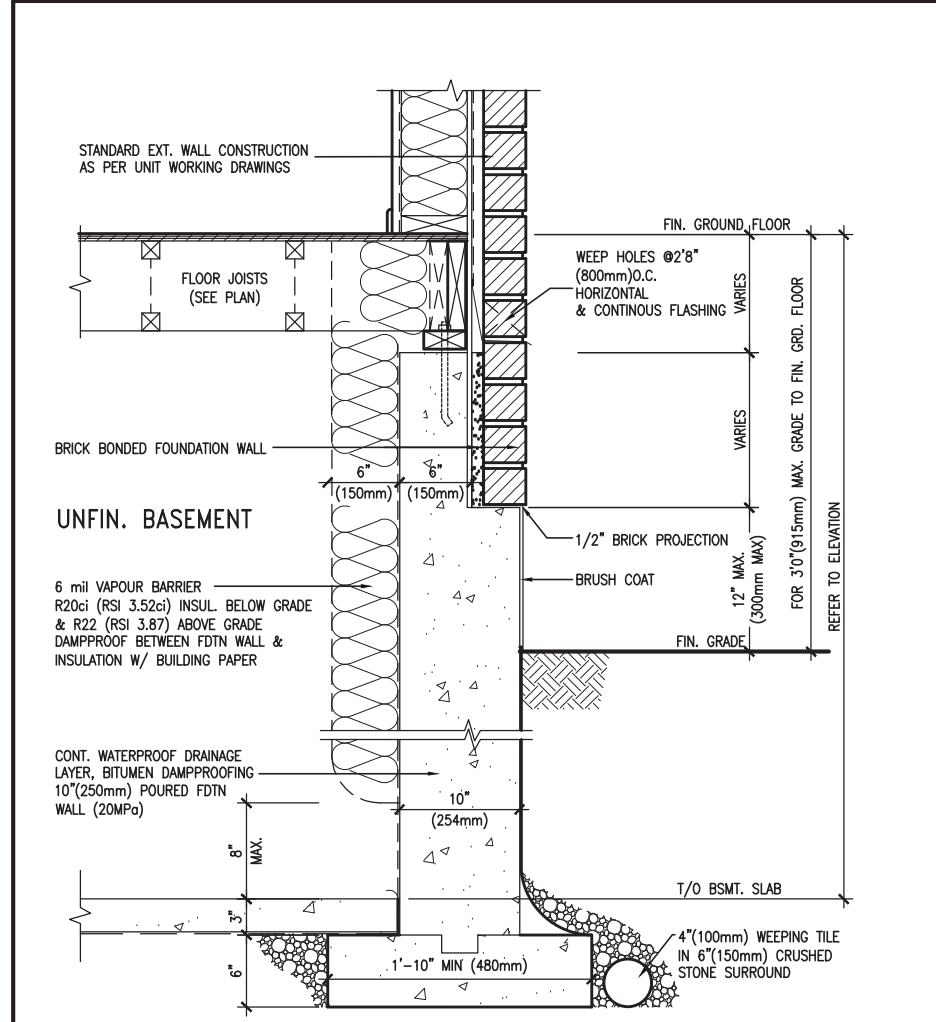

WALL SECTION FOR GRADE TO FIN.
FLOOR MORE THAN 4'7" (1400mm)
HEIGHT DIFFERENCE

SCALE: N.T.S.

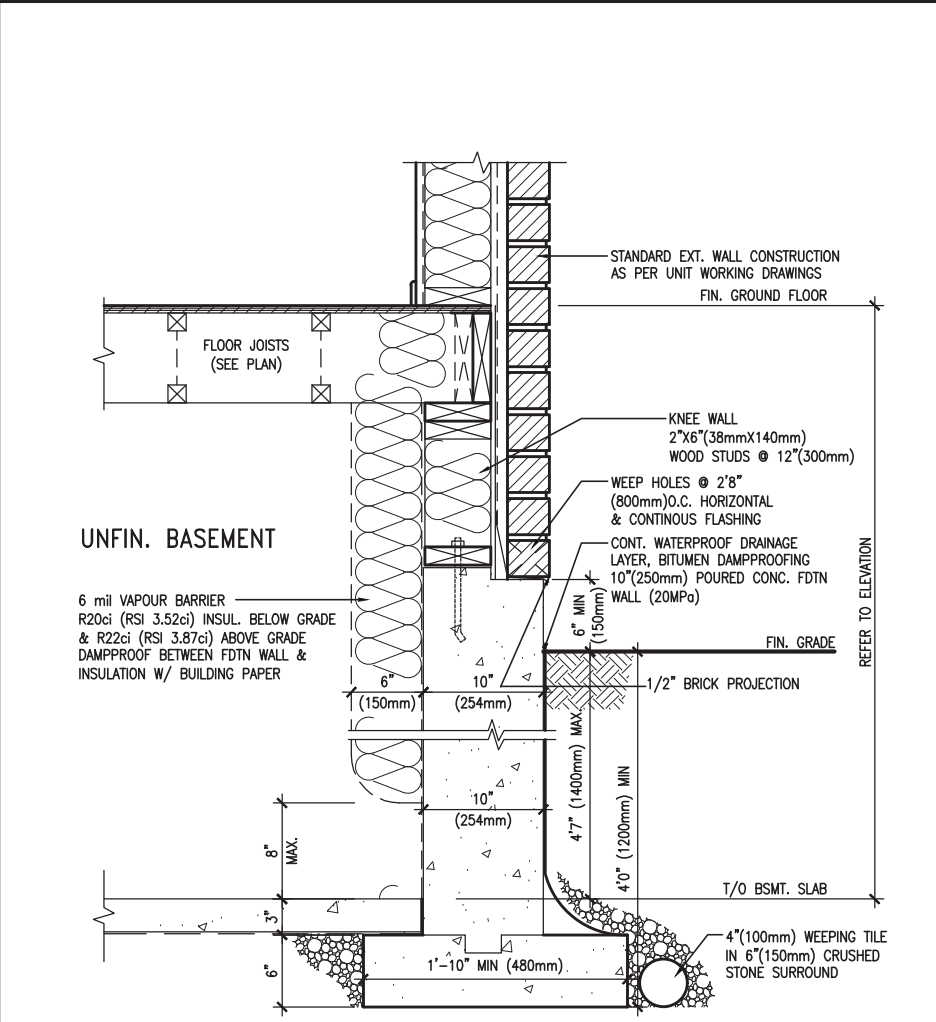

WALL SECTION FOR GRADE TO BASEMENT
SLAB 4'7" (1400mm)
MAX. HEIGHT DIFFERENCE

SCALE: N.T.S.



| | | | |
|-----|-------------------------|-----------|----|
| 9 | . | . | . |
| 8 | . | . | . |
| 7 | . | . | . |
| 6 | . | . | . |
| 5 | . | . | . |
| 4 | UPDATE TO 2022 | JAN 11-22 | RC |
| 3 | UPDATE TO 2020 | FEB 24-20 | RC |
| 2 | UPDATE TO 2018 | JAN 11-18 | RC |
| 1 | ISSUE FOR CLIENT REVIEW | AUG 04-17 | RC |
| no. | description | date | by |

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qualification information

Wellington Jno-Baptiste 25591
signature BCIN

registration information
VA3 Design Inc. 42658

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VA3
DESIGN

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Toronto ON M2J 1R4
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va3design.com

| | | | |
|---|-------------------|-------------------|------------------|
| BAYVIEW WELLINGTON | | CONST NOTE | |
| project name | GREEN VALLEY EAST | municipality | BRADFORD |
| date | MAY 2016 | project no. | 16023 |
| drawn by | RC | checked by | 3/16" = 1'-0" |
| CONSTRUCTION NOTES | | file name | 16023-CN-2022-A1 |
| RICHARD - H:\ARCHIVE\WORKING\2016\16023.BW\Units\CN NOTES\16023-CN-2022-A1.dwg - Wed - Jan 26 2022 - 12:06 PM | | drawing no. | CN11 |

PREFIN. METAL ROOF
CAP OVER WATERPROOF
MEMBRANE

5/8" T&G PLYWOOD
SHEATHING ON 2"x4"
SLOPED TO FRONT

2"x12" LEDGER

2"x12" @ HEADER

3"x3"x1 1/16" GALVANIZED
STANLEY CORNER BRACE
C/W (4) No. 10x1 1/2"
SCREWS AT 4'-0" O.C.

PREFIN. ALUM. FASCIA
AND SOFFIT AT U/S

DRIP EDGE

STL. LINTEL

TYPICAL BRICK VENEER
WALL CONSTRUCTION

HEATED SPACE

ENG. FLOOR JOIST

SECOND FLOOR

MIN. 6" PREFIN. METAL FLASHING W/
CAULKING TO MATCH BRICK/STONE

BUILT-UP CANOPY BOLTED THRU
LVL/WOOD BEAM (SEE UNIT PLANS) W/
1/2" Ø BOLTS STAGGERED @ 24" O.C.
W/ SOLID WD. BLK. BETWEEN STUDS

1


CN12

SECTION THROUGH CANOPY

SCALE 1/2" = 1'-0"



| | | | | | | | | |
|-----|-------------------------|-----------|----|---|--------------------|---|--------------------|--|
| 9 | . | . | . | <div>The undersigned has reviewed and takes responsibility for this design and has the qualifications and meets the requirements set out in the Ontario Building Code to be a Designer.</div> <div>qualification information</div> <div>Wellington Jno-Baptiste  25591</div> <div>name</div> <div>registration information</div> <div>VA3 Design Inc. 42658</div> <div>BCIN</div> | BAYVIEW WELLINGTON | | CONST NOTE | |
| 8 | . | . | . | | project name | | project no. | |
| 7 | . | . | . | | GREEN VALLEY EAST | | 16023 | |
| 6 | . | . | . | | municipality | | BRADFORD | |
| 5 | . | . | . | | date | | CONSTRUCTION NOTES | |
| 4 | UPDATE TO 2022 | JAN 11-22 | RC | MAY 2016 | | drawing no. | | |
| 3 | UPDATE TO 2020 | FEB 24-20 | RC | drawn by | | file name | | |
| 2 | UPDATE TO 2018 | JAN 11-18 | RC | checked by | | 16023-CN-2022-A1 | | |
| 1 | ISSUE FOR CLIENT REVIEW | AUG 04-17 | RC | scale | | CN12 | | |
| no. | description | date | by | 3/16" = 1'-0" | | RICHARD - H:\ARCHIVE\WORKING\2016\16023.BW\Units\CN NOTES\16023-CN-2022-A1.dwg - Wed - Jan 26 2022 - 12:09 PM | | |

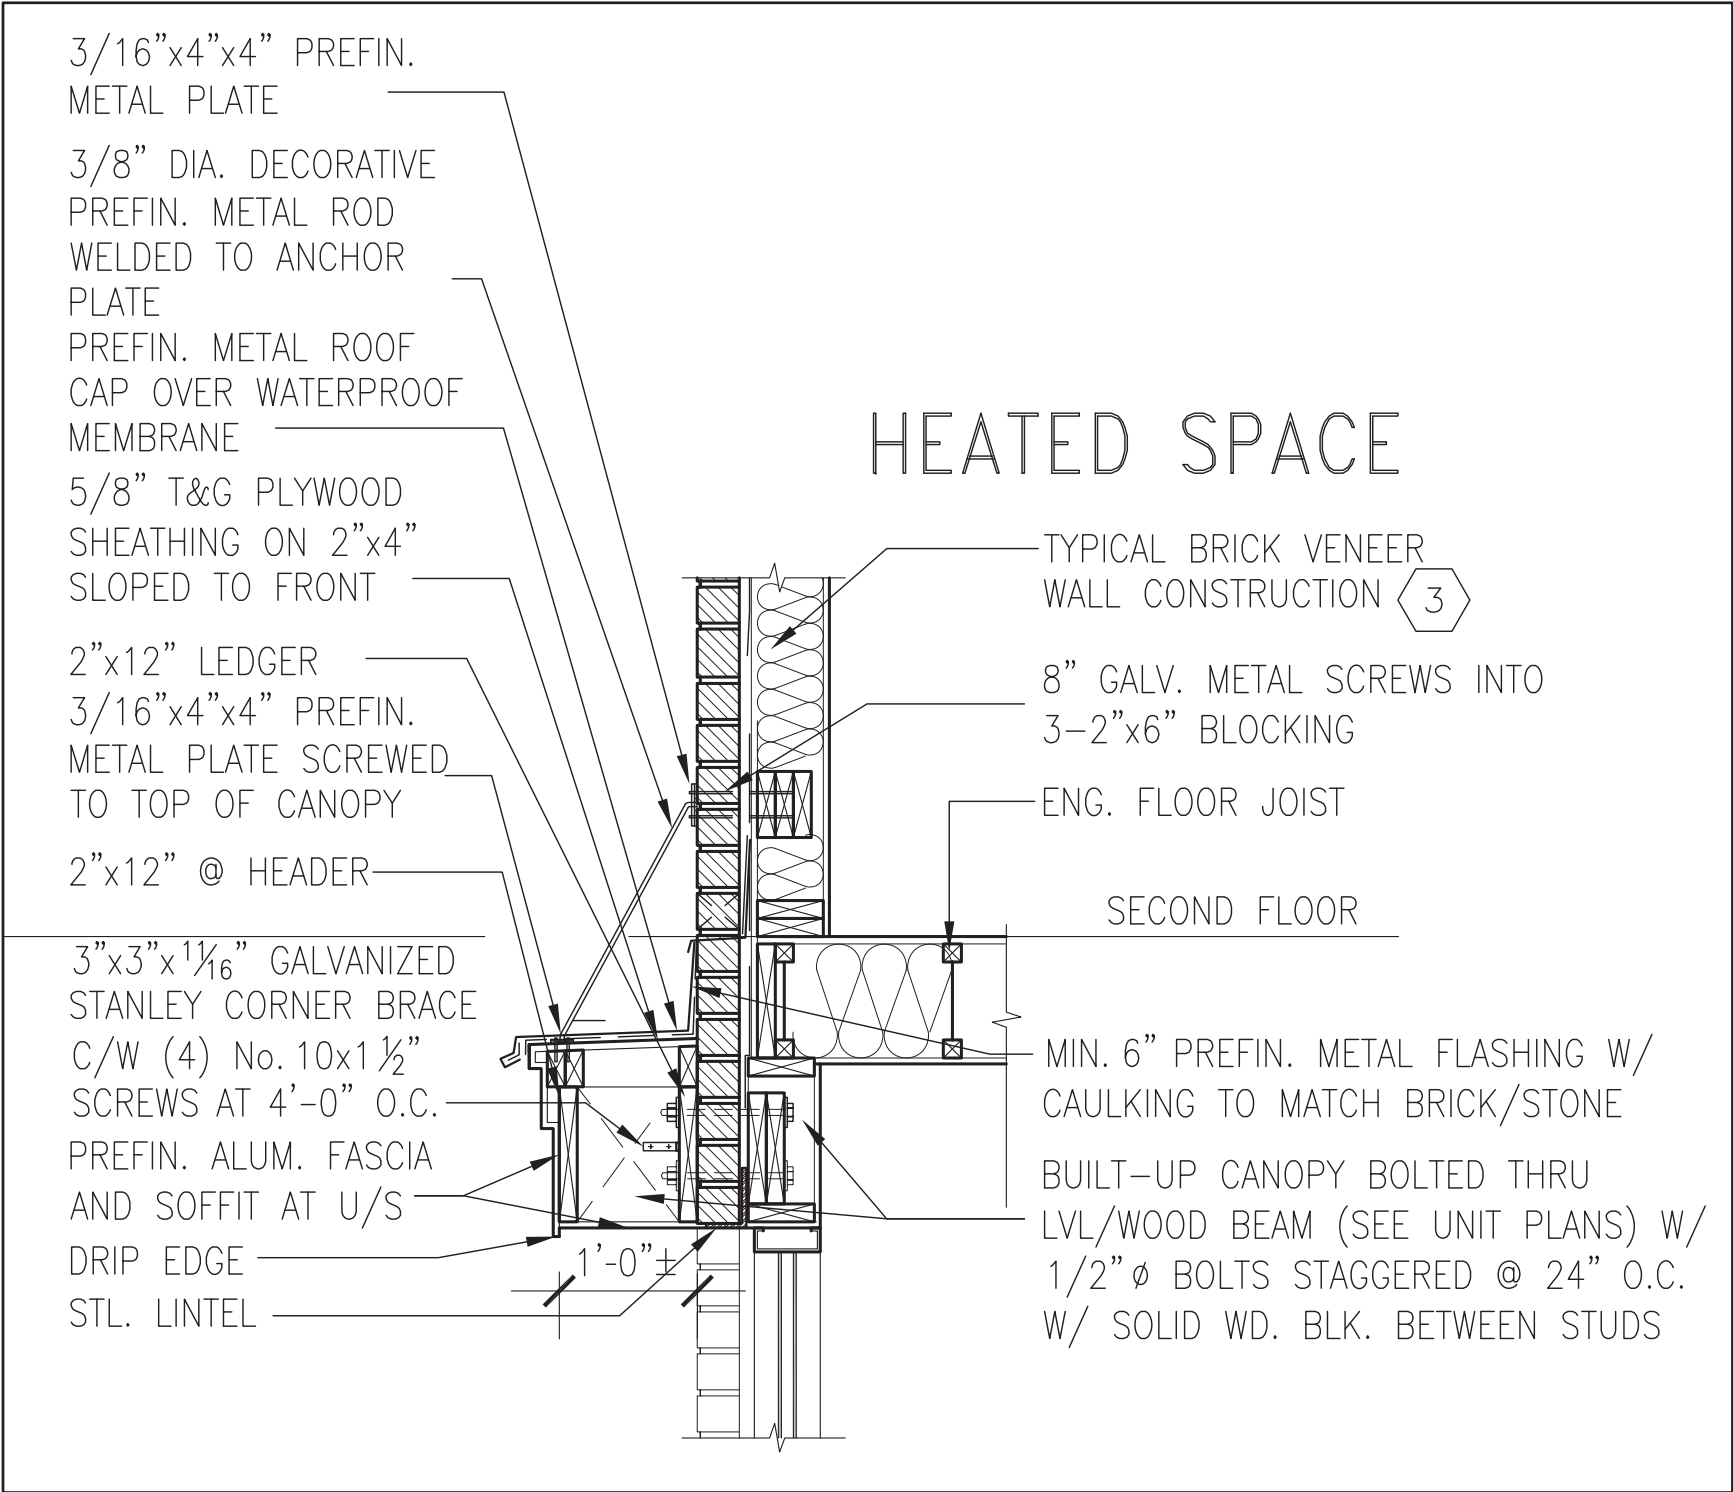

1
CN13

SECTION THROUGH CANOPY
W/ DECORATIVE ROD
SCALE 1/2" = 1'-0"



| | | | | | | | | | |
|-----|-------------------------|-----------|----|---|---|---|---------------------------------|-------------------------------|--------------------------------------|
| 9 | - | - | - | The undersigned has reviewed and takes responsibility for this design and has the qualifications and meets the requirements set out in the Ontario Building Code to be a Designer. |  255 Consumers Rd Suite 120 Toronto ON M2J 1R4 t 416.630.2255 f 416.630.4782 va3design.com | BAYVIEW WELLINGTON | CONST NOTE | | |
| 8 | - | - | - | qualification information | | | | | |
| 7 | - | - | - | Wellington Jno-Baptiste 25591 | | | | | |
| 6 | - | - | - | name registration information VA3 Design Inc. 42658 | | | | | |
| 5 | - | - | - | signature BCIN | | | | | |
| 4 | UPDATE TO 2022 | JAN 11-22 | RC | Contractor must verify all dimensions on the job and report any discrepancy to the Designer before proceeding with the work. All drawings and specifications are instruments of service and the property of the Designer which must be returned at the completion of the work. Drawings are not to be scaled. | | project name GREEN VALLEY EAST | municipality BRADFORD | project no. 16023 | |
| 3 | UPDATE TO 2020 | FEB 24-20 | RC | | | date MAY 2016 | CONSTRUCTION NOTES | | |
| 2 | UPDATE TO 2018 | JAN 11-18 | RC | | | drawn by RC | checked by - | scale 3/16" = 1'-0" | file name 16023-CN-2022-A1 |
| 1 | ISSUE FOR CLIENT REVIEW | AUG 04-17 | RC | | | | | | CN13 |
| no. | description | date | by | | | RICHARD - H:\ARCHIVE\WORKING\2016\16023.BW\Units\CN NOTES\16023-CN-2022-A1.dwg - Wed - Jan 26 2022 - 12:09 PM | | | |

3/16"x4"x4" PREFIN.
METAL PLATE

3/8" DIA. DECORATIVE
PREFIN. METAL ROD
WELDED TO ANCHOR
PLATE

PREFIN. METAL ROOF
CAP OVER WATERPROOF
MEMBRANE

5/8" T&G PLYWOOD
SHEATHING ON 2"x4"
SLOPED TO FRONT

2"x12" LEDGER

3/16"x4"x4" PREFIN.
METAL PLATE SCREWED
TO TOP OF CANOPY

2"x12" @ HEADER

3"x3"x1 1/16" GALVANIZED
STANLEY CORNER BRACE
C/W (4) No. 10x1 1/2"
SCREWS AT 4'-0" O.C.

PREFIN. ALUM. FASCIA
AND SOFFIT AT U/S

DRIP EDGE

STL. LINTEL

8" GALV. METAL SCREWS INTO
3-2"x6" BLOCKING

PREFINISHED METAL FLASHING
OVER WATERPROOF MEMBRANE

2"x6" @ 12" O.C. NAILED TO
2"x8" JOIST BELOW

CANT STRIP

ROOF NOTE R1

SINGLE PLY ROOF MEMBRANE
W/5/8" EXTERIOR GRADE

SHEATHING W/ 2"x4" @ 12"
O.C. DIAGONALLY CUT CROSS
PURLINS 2"x8" @ 16" O.C. W/

MIN. 6" PREFIN. METAL FLASHING W/
CAULKING TO MATCH BRICK/STONE

BUILT-UP CANOPY BOLTED THRU
LVL/WOOD BEAM (SEE UNIT PLANS) W/
1/2" Ø BOLTS STAGGERED @ 24" O.C.
W/ SOLID WD. BLK. BETWEEN STUDS

1

CN14

SECTION THROUGH CANOPY

W/ DECORATIVE ROD

SCALE 1/2" = 1'-0"



| | | | | | | | | | | |
|-----|-------------------------|-----------|----|---|--|--------------------|---------------|--------------------|-------------|--|
| 9 | . | . | . | <div>The undersigned has reviewed and takes responsibility for this design and has the qualifications and meets the requirements set out in the Ontario Building Code to be a Designer.</div> <div>qualification information</div> <div>Wellington Jno-Baptiste <i>J. Baptiste</i> 25591</div> <div>name signature BCIN</div> <div>registration information</div> <div>VA3 Design Inc. 42658</div> <div>Contractor must verify all dimensions on the job and report any discrepancy to the Designer before proceeding with the work. All drawings and specifications are instruments of service and the property of the Designer which must be returned at the completion of the work. Drawings are not to be scaled.</div> | <div><div>VA3</div><div>DESIGN</div><div>255 Consumers Rd Suite 120</div><div>Toronto ON M2J 1R4</div><div>t 416.630.2255 f 416.630.4782</div><div>va3design.com</div></div> | BAYVIEW WELLINGTON | | CONST NOTE | | |
| 8 | . | . | . | | | project name | | municipality | project no. | |
| 7 | . | . | . | | | GREEN VALLEY EAST | | BRADFORD | 16023 | |
| 6 | . | . | . | | | date | | CONSTRUCTION NOTES | | |
| 5 | . | . | . | | | MAY 2016 | | drawing no. | | |
| 4 | UPDATE TO 2022 | JAN 11-22 | RC | drawn by | | checked by | scale | file name | CN14 | |
| 3 | UPDATE TO 2020 | FEB 24-20 | RC | RC | | - | 3/16" = 1'-0" | 16023-CN-2022-A1 | | |
| 2 | UPDATE TO 2018 | JAN 11-18 | RC | RICHARD - H:\ARCHIVE\WORKING\2016\16023.BW\Units\CN NOTES\16023-CN-2022-A1.dwg - Wed - Jan 26 2022 - 12:09 PM | | | | | | |
| 1 | ISSUE FOR CLIENT REVIEW | AUG 04-17 | RC | | | | | | | |
| no. | description | date | by | | | | | | | |