



PLANNING DEPARTMENT

COMPLIES WITH
ZONING BY-LAW: 2010-050
January 12, 2022

DATE REVIEWED:

REVIEWED BY:

ENGINEERING REVIEW

☒ ACCEPTED

☐ ACCEPTED AS NOTED

☐ REQUIRES RE-SUBMISSION

THIS PLAN HAS BEEN REVIEWED WITH RESPECT TO GENERAL CONFORMANCE WITH THE OVERALL LOT GRADING PLAN AND OUR APPROVAL OF THIS PLAN FOR NO OTHER REASON. WE ACCEPT NO RESPONSIBILITY FOR THE ACCURACY OF THE ELEVATIONS AND DIMENSIONS PROVIDED BY OTHERS.

January 20, 2022


DATE REVIEWED BY
(TOWN OF BRADFORD WEST GWILLIMBURY USE ONLY)

SITE COPY

JONKMAN BLVD.

FERRAGINE CRESCENT

- CORNER LOT -
UPGRADE PLANKING AND REAR
(See Approved Streetscape / Unit Working Drawings)

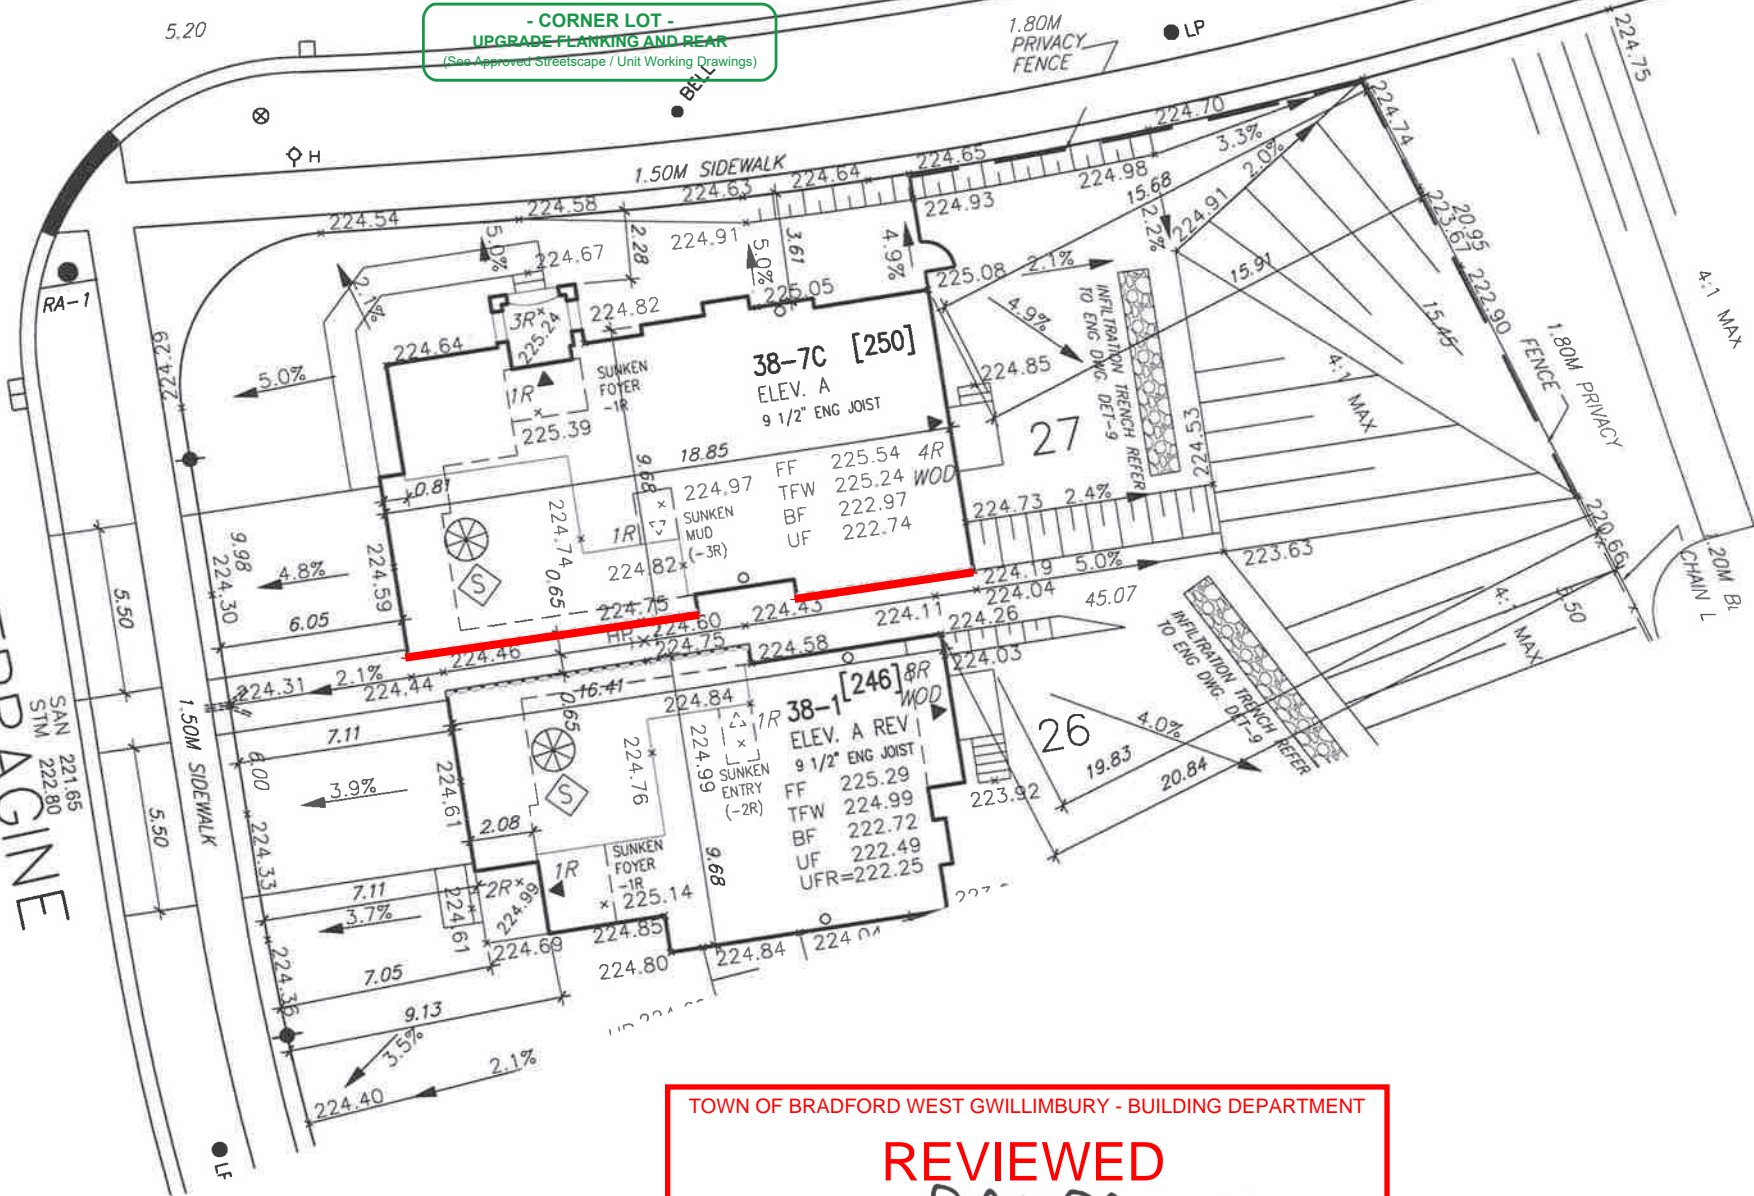

TOWN OF BRADFORD WEST GWILLIMBURY - BUILDING DEPARTMENT

REVIEWED

Helwin Jhu

INSPECTOR:

PERMIT NO.: PRBD202100777R DATE: Jan. 21, 2022

ALL CONSTRUCTION SHALL COMPLY WITH THE
ONTARIO BUILDING CODE AND ALL OTHER APPLICABLE
STATUTORY REGULATIONS. THE REVIEWED DOCUMENTS
MUST BE KEPT ON SITE AT ALL TIMES.

INSPECTION REQUEST EMAIL: BUILDINGINSPECTIONS@TOWNOFBWG.COM
INSPECTION REQUEST FAX: (905) 778-2035
INSPECTION REQUEST TELEPHONE: (905) 778-2055 EXT. 1500

It is the builder's complete responsibility to ensure that all plans submitted for approval fully comply with the Architectural Guidelines and all applicable regulations and requirements including zoning provisions and any provisions in the subdivision agreement. The Control Architect is not responsible in any way for examining or approving site (lotting) plans or working drawings with respect to any zoning or building code or permit matter or that any house can be properly built or located on its lot.

This is to certify that these plans comply with the applicable Architectural Design Guidelines approved by the Town of BRADFORD / WEST GWILLIMBURY.

JOHN G. WILLIAMS LTD., ARCHITECT
ARCHITECTURAL CONTROL REVIEW
AND APPROVAL

APPROVED BY:

DATE: JAN 10, 2022

This stamp certifies compliance with the applicable Design Guidelines only and bears no further professional responsibility.

45 mins. FRR

RICHARD - H:\ARCHIVE\WORKING\2016\16023.BW\Site plan\16023-SP.dwg - Man - Jan 10 2022 - 8:25 AM

project no
16023

MUNICIPAL ADDRESS
250 FERRAGINE CRES.

- PROPOSED VALVE
- LP LIGHT POLE
- WATER SERVICE
- DOUBLE STM./SAN. CONNECTION
- SINGLE STM./SAN. CONNECTION
- CATCH BASIN
- TELEVISION PEDestal
- BELL PEDestal
- TRANSFORMER
- HYDRANT
- NO. OF RISERS
- FINISHED FLOOR ELEVATION
- UNDERSIDE FOOTING ELEVATION
- FIN. BASEMENT FLOOR SLAB
- TOP OF FOUNDATION WALL
- UNDERSIDE FOOTING AT REAR
- UNDERSIDE FOOTING AT FRONT
- UNDERSIDE FOOTING AT SIDE
- DECK
- WALK OUT BASEMENT
- REVERSE PLAN
- STREET SIGN
- MAIL BOX
- RETAINING WALL
- CHAIN LINK FENCE (SEE LANDSCAPE PLAN)
- ACOUSTICAL FENCE (SEE LANDSCAPE PLAN)
- WOOD SCREEN FENCE (SEE LANDSCAPE PLAN)
- HYDRO SERVICE LATERAL
- HYDRO METER
- GAS METER
- EMBANKMENT
- LOTS EQUIPPED WITH SUMP PUMP
- SWALE DIRECTION
- PROVIDE 3/4" DIA. CLEAR STONE IN THIS AREA
- THIS LOT CONTAINS ENGINEERED FILL
- AIR CONDITIONER REQUIRED
- RAIN WATER DOWNSPOUT LOCATION (DISCHARGE ONTO SPLASHPAD)
- SIDE WINDOW LOCATION
- OPT. DOOR LOCATION
- EXTERIOR DOOR LOCATION
- REDUCE SIDE YARD

The undersigned has reviewed and takes responsibility for this design and has the qualifications and meets the requirements set out in the Ontario Building Code to be a Designer.

qualification information

Wellington Jno-Baptiste 25591

name registration information BCIN

VA3 Design Inc. 42658

Builder to verify location of all hydrants, street lights, transformers and other services. If minimum dimensions are not maintained, builder is to relocate at his own expense.

Builder to verify service connection elevations prior to constructing foundations.

VA3 DESIGN

255 Consumers Rd Suite 120
Toronto ON M2J 1R4
t 416.630.2255 f 416.630.4782
va3design.com

URBAN ECOSYSTEMS LTD. HAS REVIEWED THE PROPOSED GRADES AS SHOWN ON THIS PLAN AND HAS FOUND THEM TO BE IN GENERAL CONFORMANCE WITH THE APPROVED PLANS.

LOT NO. 27 resite
DATE Jan 10, 2022



DEVELOPER:
ARG GROUP

BUILDER:
BAYVIEW WELLINGTON

CONSULTANT:
URBAN ECO SYSTEMS- CIVIL ENG
VA3 DESIGN- ARCHITECTURE

MAX BUILDING HEIGHT: 13.0m	LOT AREA: 606.09 m ²	SAN INVERT: 221.65 m
BUILDING HEIGHT: 8.37m	LOT FRONTAGE: 14.82 m	STM INVERT: 222.80 m
AVERAGE GRADE: 224.69m	LOT COVERAGE: N/A %	DESIGNED: -
4		DRAWN: RC
3	RC	SCALE: 1:250
2	REV AS PER TOWN COMMENT	DATE: NOV 23-2021
1	ISSUED FOR CLIENT REVIEW	PLAN: 51M-1137
No.	Revision	Date
SITING & GRADING PLAN		LOT NO: 27