



PARTIAL GROUND FLOOR PLAN (10'-0" GROUND W/ 9'-0" BASEMENT)


AREA CALCULATIONS					
	ELEV. A	ELEV. B	ELEV. C		
GROUND FLOOR AREA	1150.8 SF	1150.8 SF	1150.8 SF		
SECOND FLOOR AREA	1403.0 SF	1403.0 SF	1403.0 SF		
SUBTOTAL	2553.9 SF	2553.9 SF	2553.9 SF		
DEDUCT ALL OPENINGS	16.5 SF	16.5 SF	16.5 SF		
TOTAL NET AREA	2537 SF	2537 SF	2537 SF		
	235.7 m2	235.7 m2	235.7 m2		
FINISHED BSMT AREA	0 SF	0 SF	0 SF		
TOTAL NET AREA	2537 SF	2537 SF	2537 SF		
W/ FIN BSMT	235.7 m2	235.7 m2	235.7 m2		
COVERAGE W/O PORCH	1597.9 SF	1597.9 SF	1597.9 SF		
	148.4 m2	148.4 m2	148.4 m2		
COVERAGE W/PORCH	1690.8 SF	1673.3 SF	1676.4 SF		
	157.1 m2	155.5 m2	155.7 m2		

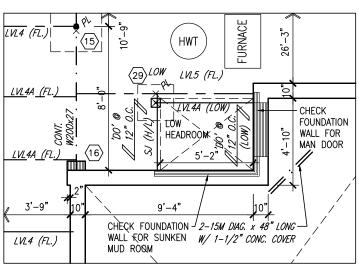

PARTIAL BASEMENT PLAN -1R SUNKEN MUD ROOM

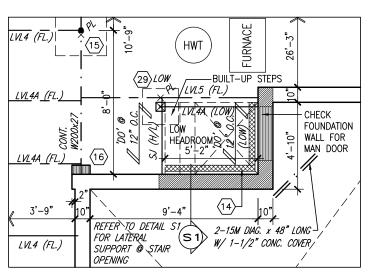


PARTIAL BASEMENT PLAN -2R OR MORE SUNKEN MUD ROOM

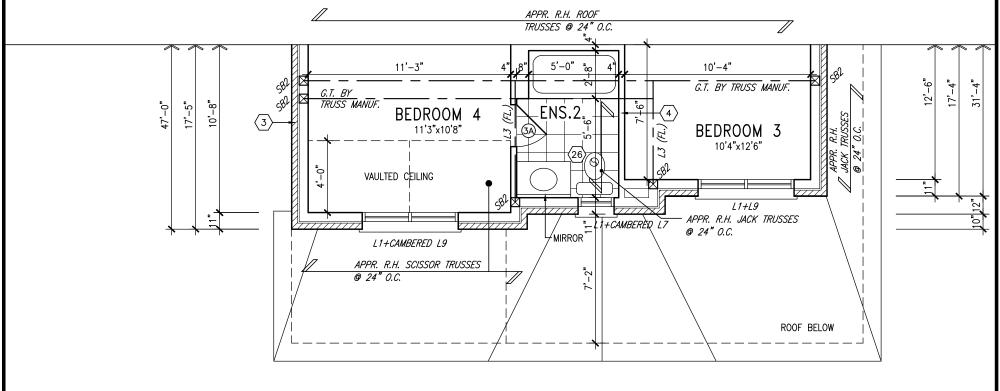

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GRAB BAR NOTE:

STUD WALL REINFORCEMENT FOR FUTURE <u>GRAB BARS IN MAIN BATHROOM</u>

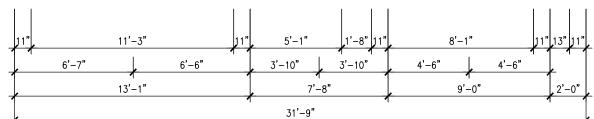REINFORCEMENT OF STUD WALLS SHALL BE INSTALLED ADJACENT TO WATER CLOSETS AND SHOWER OR BATHTUB IN MAIN BATHROOM PER OBC. DIV. B-9.5.2. REFER TO FOLLOWING SECTIONS FOR THE FIXTURES LISTED. WATER CLOSET: 3.8.3.8.(3)(a) & 3.8.3.8.(3)(c). SHOWER 3.8.3.13.(2)(g). BATHTUB 3.8.3.13.(4)(e). FREE STANDING BATHTUB EXCLUDED. SEE DETAILS

PARTIAL SECOND FLOOR PLAN 'B'

REFER TO ROOF TRUSS MANUF. FOR ROOF TRUSS LAYOUTS & BEAM SIZES.

REFER TO FULL PLANS FOR TYPICAL NOTES.

9			
8			
7			
6			
5	10' GROUND FLOOR	MAY 28-21	KL
4	REVISED AS PER ENG COMMENTS	APR 08-21	RC
3	ADD OPT. 9' BASEMENT	APR 06-21	RC :
2	REVISED AS PER ENG'S COMMENTS	JAN 16-18	RC
1	IMPORTED FROM 13045 TO 16023	31-01-17	AJE
no.	description	date	by

Contractor must verify all dimensions on the job and report any discrepancy to the Designer before proceeding with the work. All drawings and specifications are instruments of service and the property of the Designer which must be returned at the completion of the work. Drawings are not to be scaled. va3desian.com


	project name
DECICN	GREEN '
DESIGN 255 Consumers Rd Suite 120	JAN. 2017
Toronto ON M2J 1R4	drawn by
+ 416 630 2255 f 416 630 4782	A.IF


BAYVIEW	WELLINGTON	
roject name GREEN VALLEY EAST	municipality BRADFORD, ON	


3/16" = 1'-0"


PARTIAL FLOOR PLANS 'B' 16023-S38-15-10GRND 16023

S38 - 15BAROSSA 15

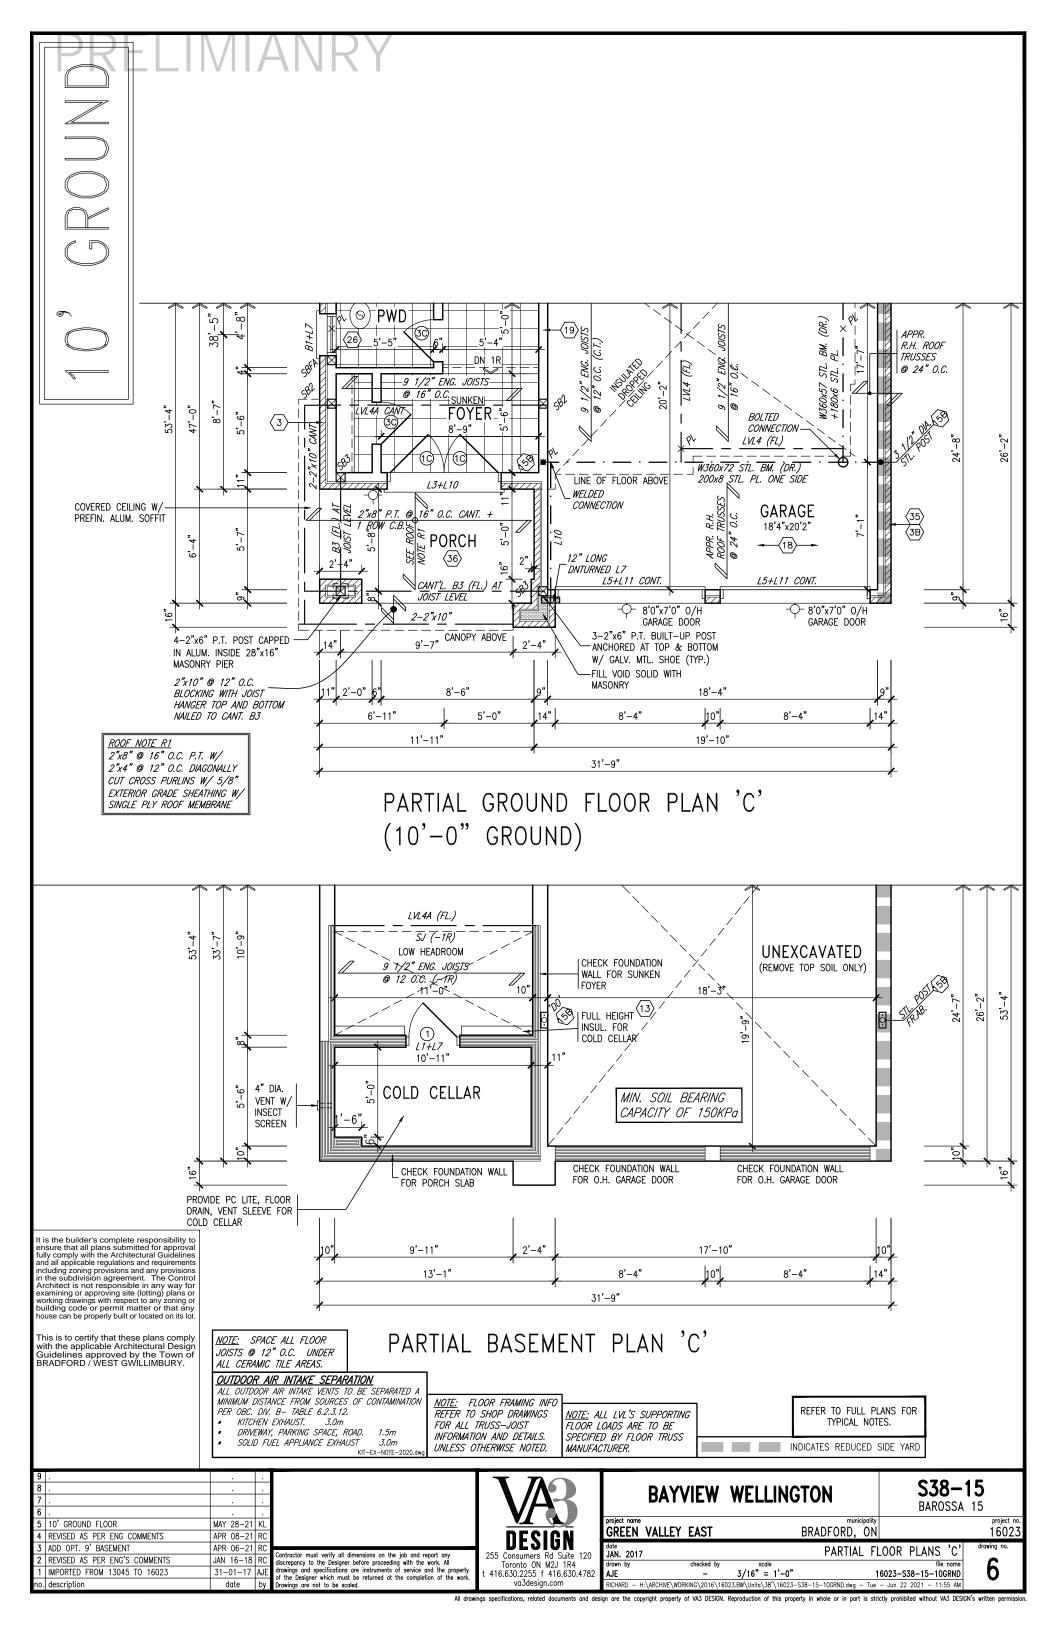

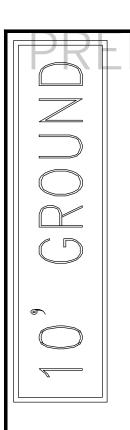

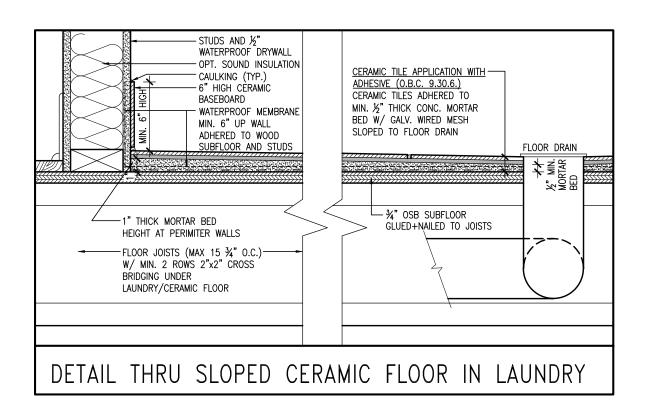

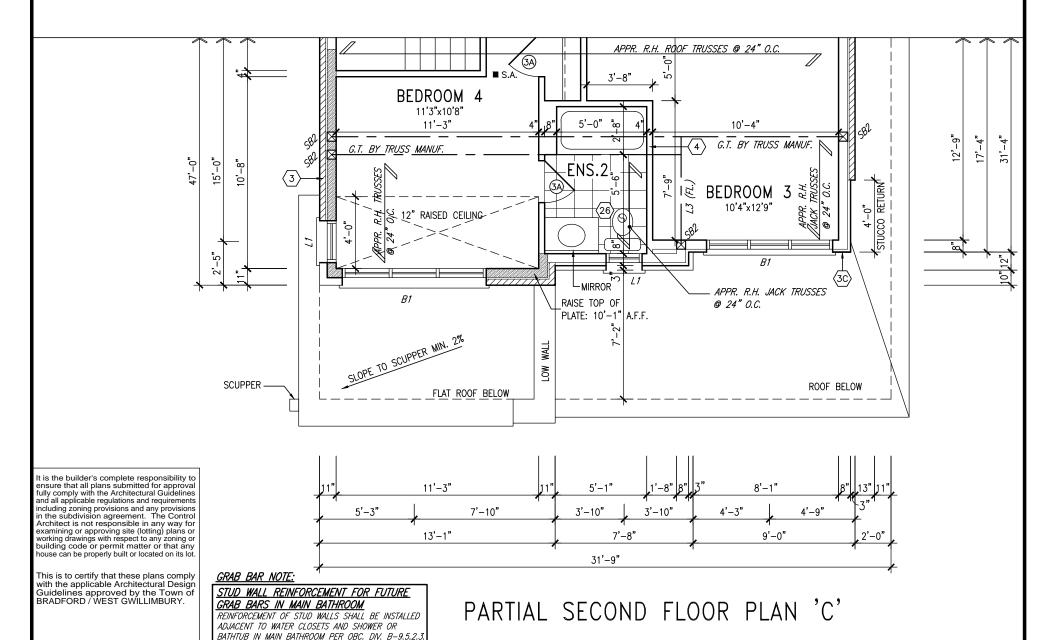

10' GROUND FLOOR MAY 28-21 KL REVISED AS PER ENG COMMENTS APR 08-21 R ADD OPT. 9' BASEMENT APR 06-21 RC REVISED AS PER ENG'S COMMENTS JAN 16-18 RC IMPORTED FROM 13045 TO 16023 31-01-17 AJE description

Contractor must verify all dimensions on the job and report any discrepancy to the Designer before proceeding with the work. All drawings and specifications are instruments of service and the property of the Designer which must be returned at the completion of the work. Drawings are not to be scaled. 255 255 Consumers Rd Suite 120 Toronto ON M2J 1R4 416.630.2255 f 416.630.4782 va3design.com

REFER TO FOLLOWING SECTIONS FOR THE FIXTURES LISTED. WATER CLOSET: 3.8.3.8.(3)(a) & 3.8.3.8.(3)(c). SHOWER 3.8.3.13.(2)(g). BATHTUB 3.8.3.13.(4)(e). FREE STANDING BATHTUB EXCLUDED. SEE DETAILS

120

REFER TO ROOF TRUSS MANUF. FOR ROOF TRUSS LAYOUTS & BEAM SIZES.

BAYVIEW WELLINGTON


REFER TO FULL PLANS FOR


TYPICAL NOTES.


S38 - 15BAROSSA 15


16023


BRADFORD, ON **GREEN VALLEY EAST** JAN. 2017 PARTIAL FLOOR PLANS 'C' drawn by 3/16" = 1'-0" 16023-S38-15-10GRND

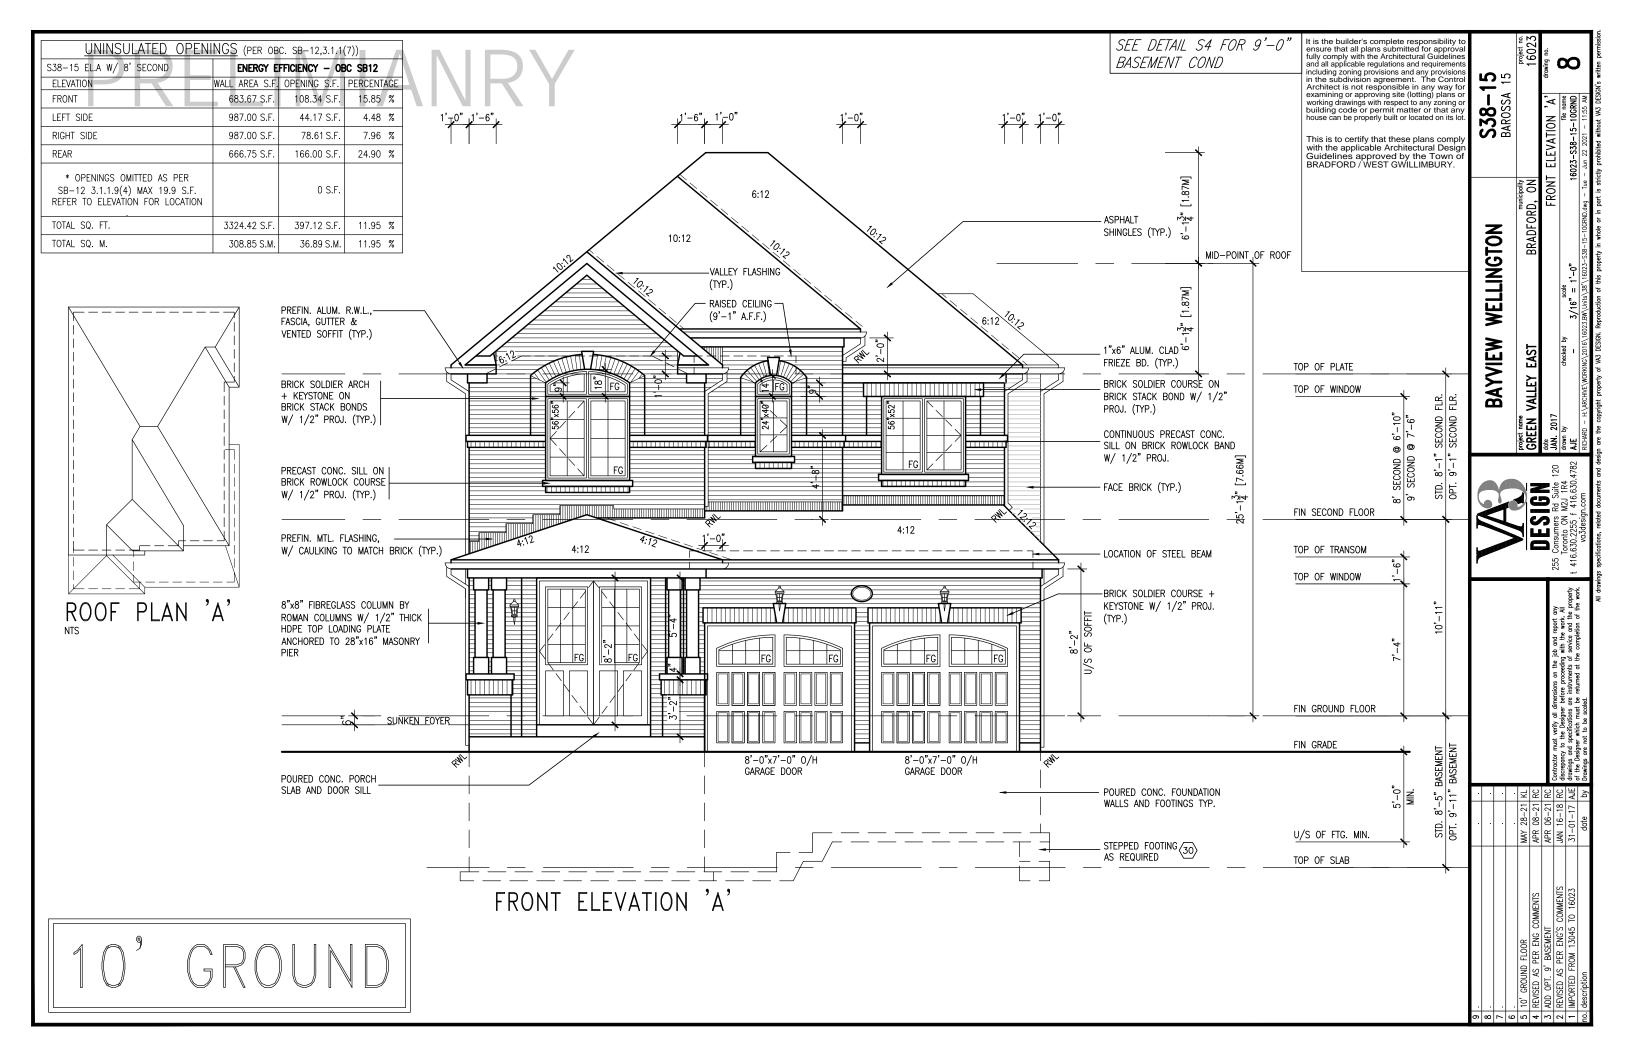


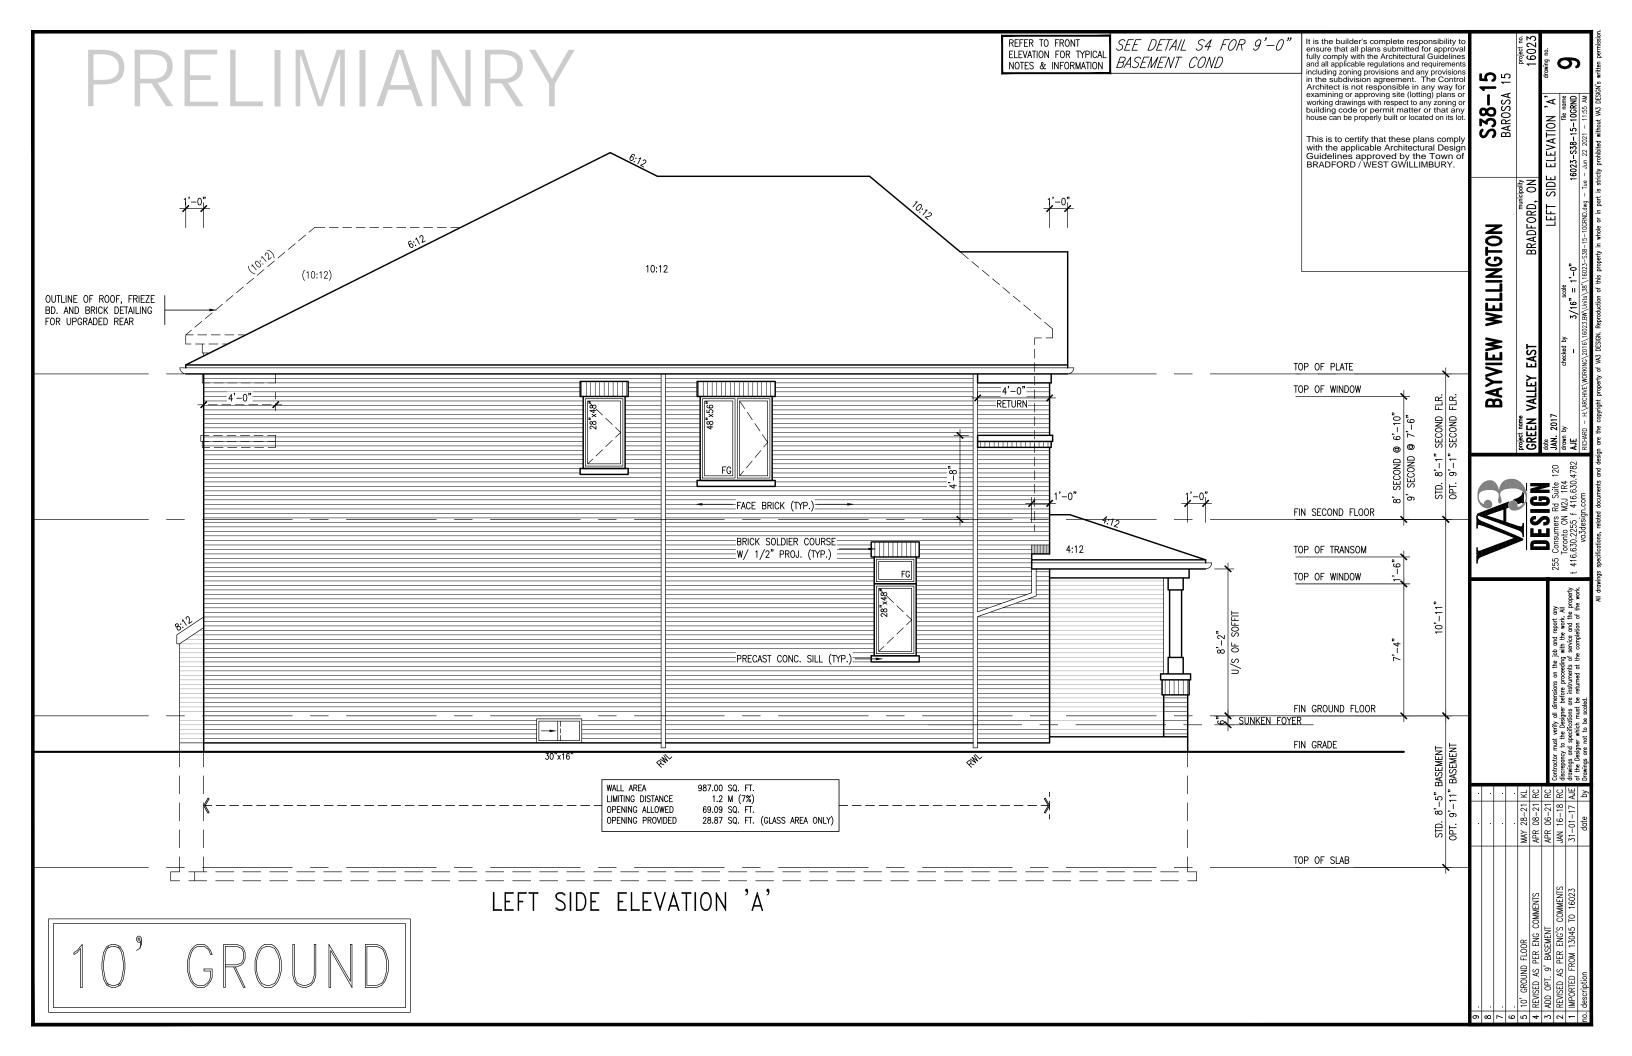


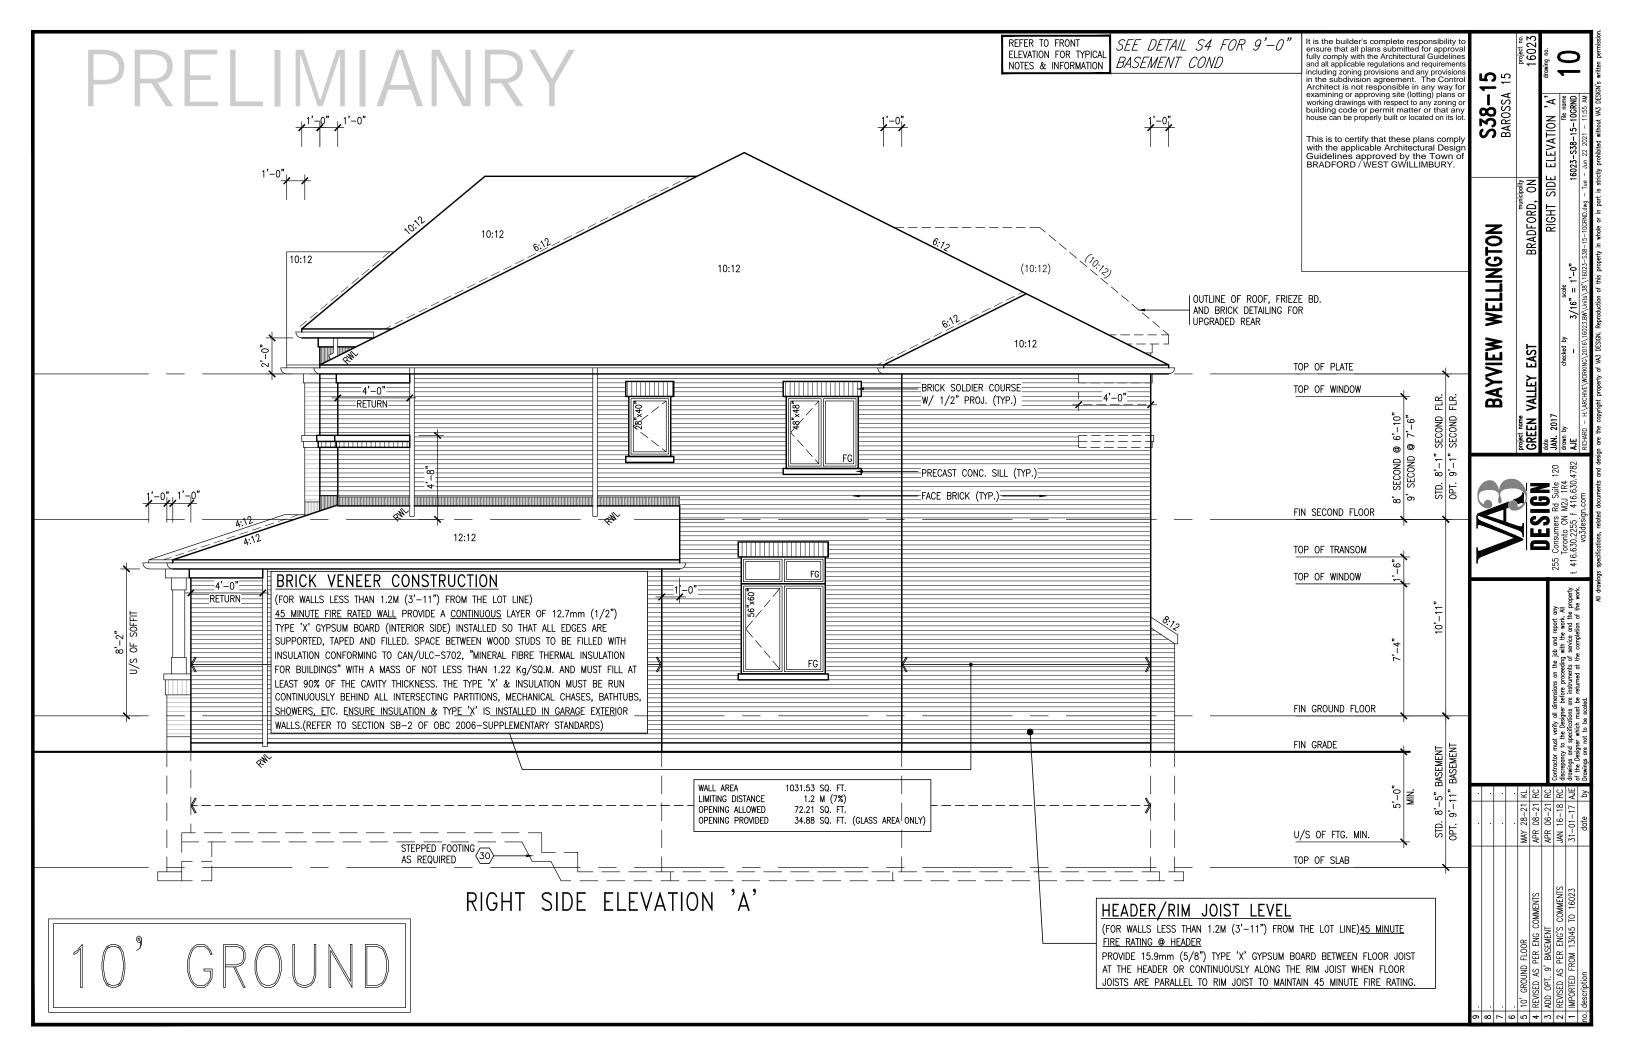


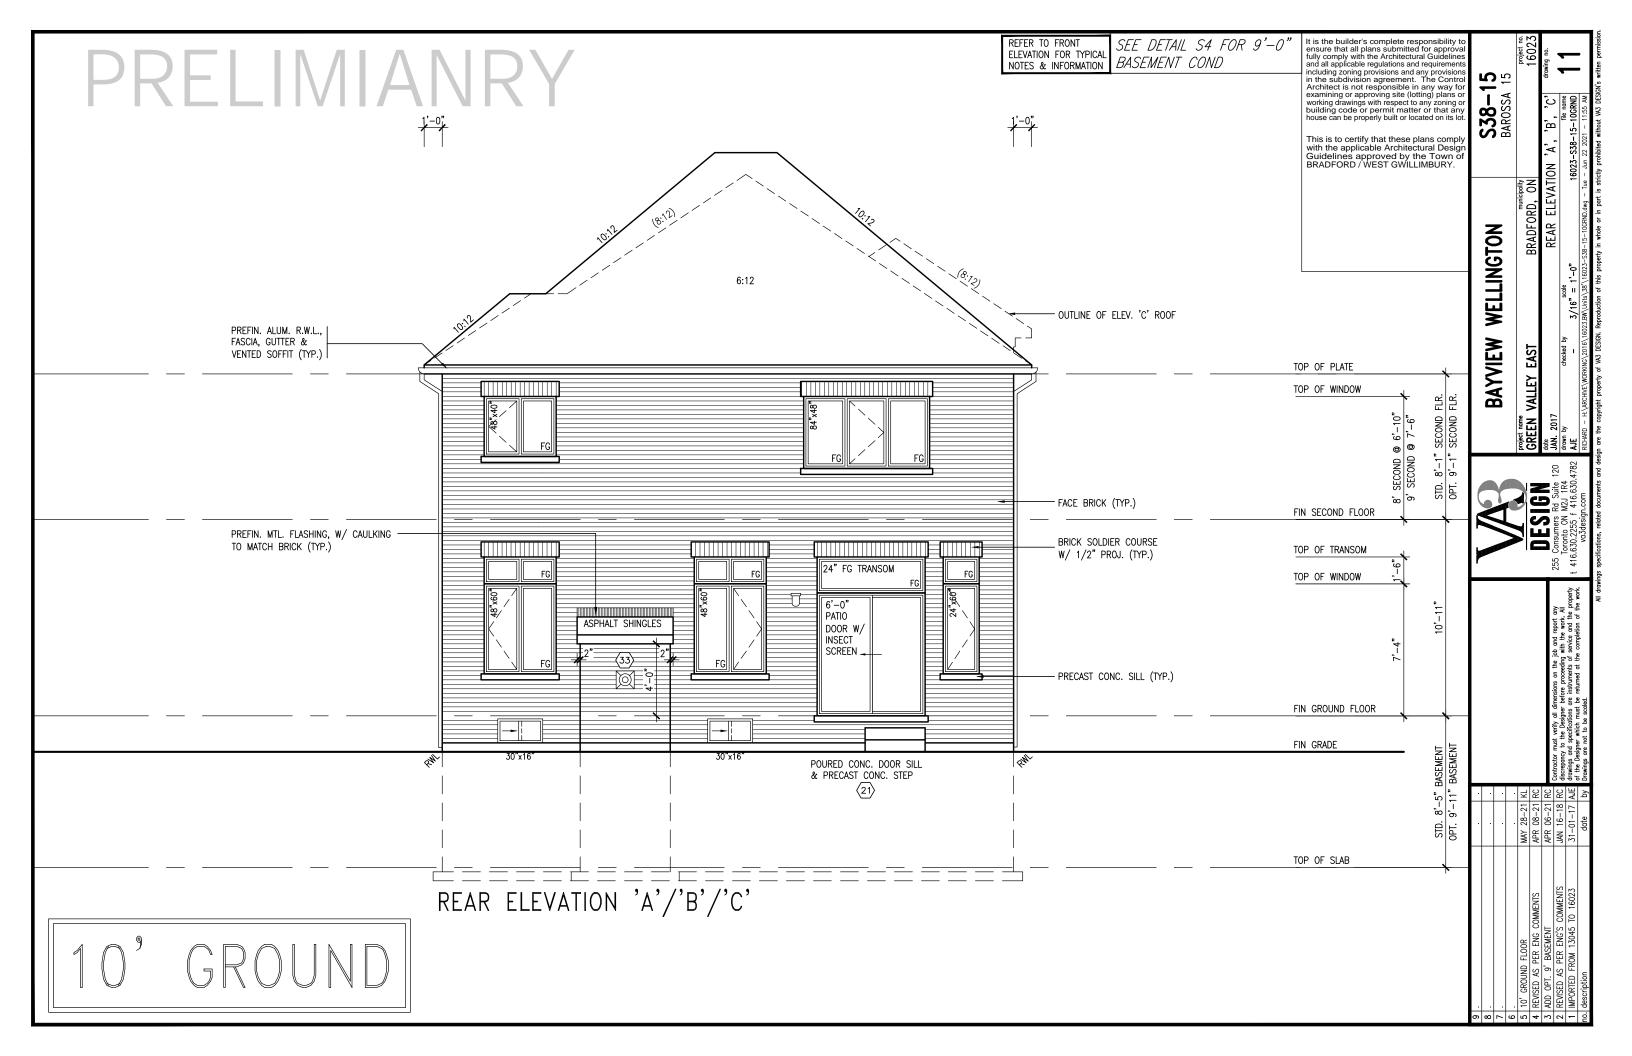


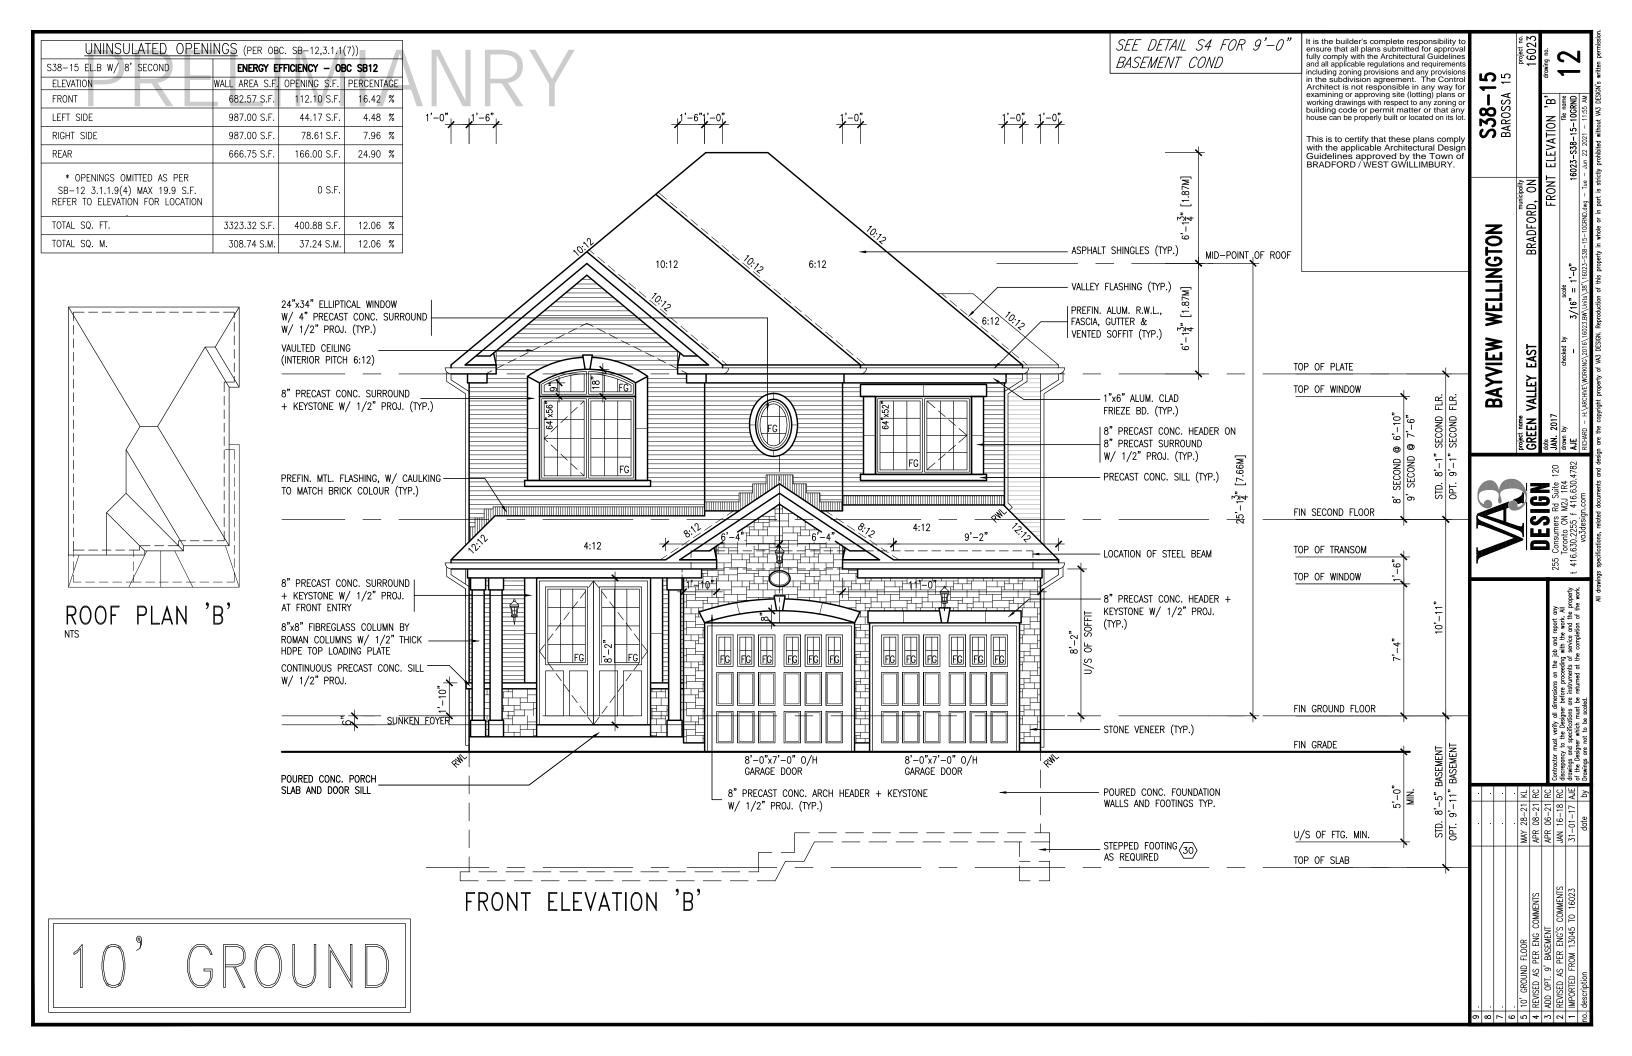


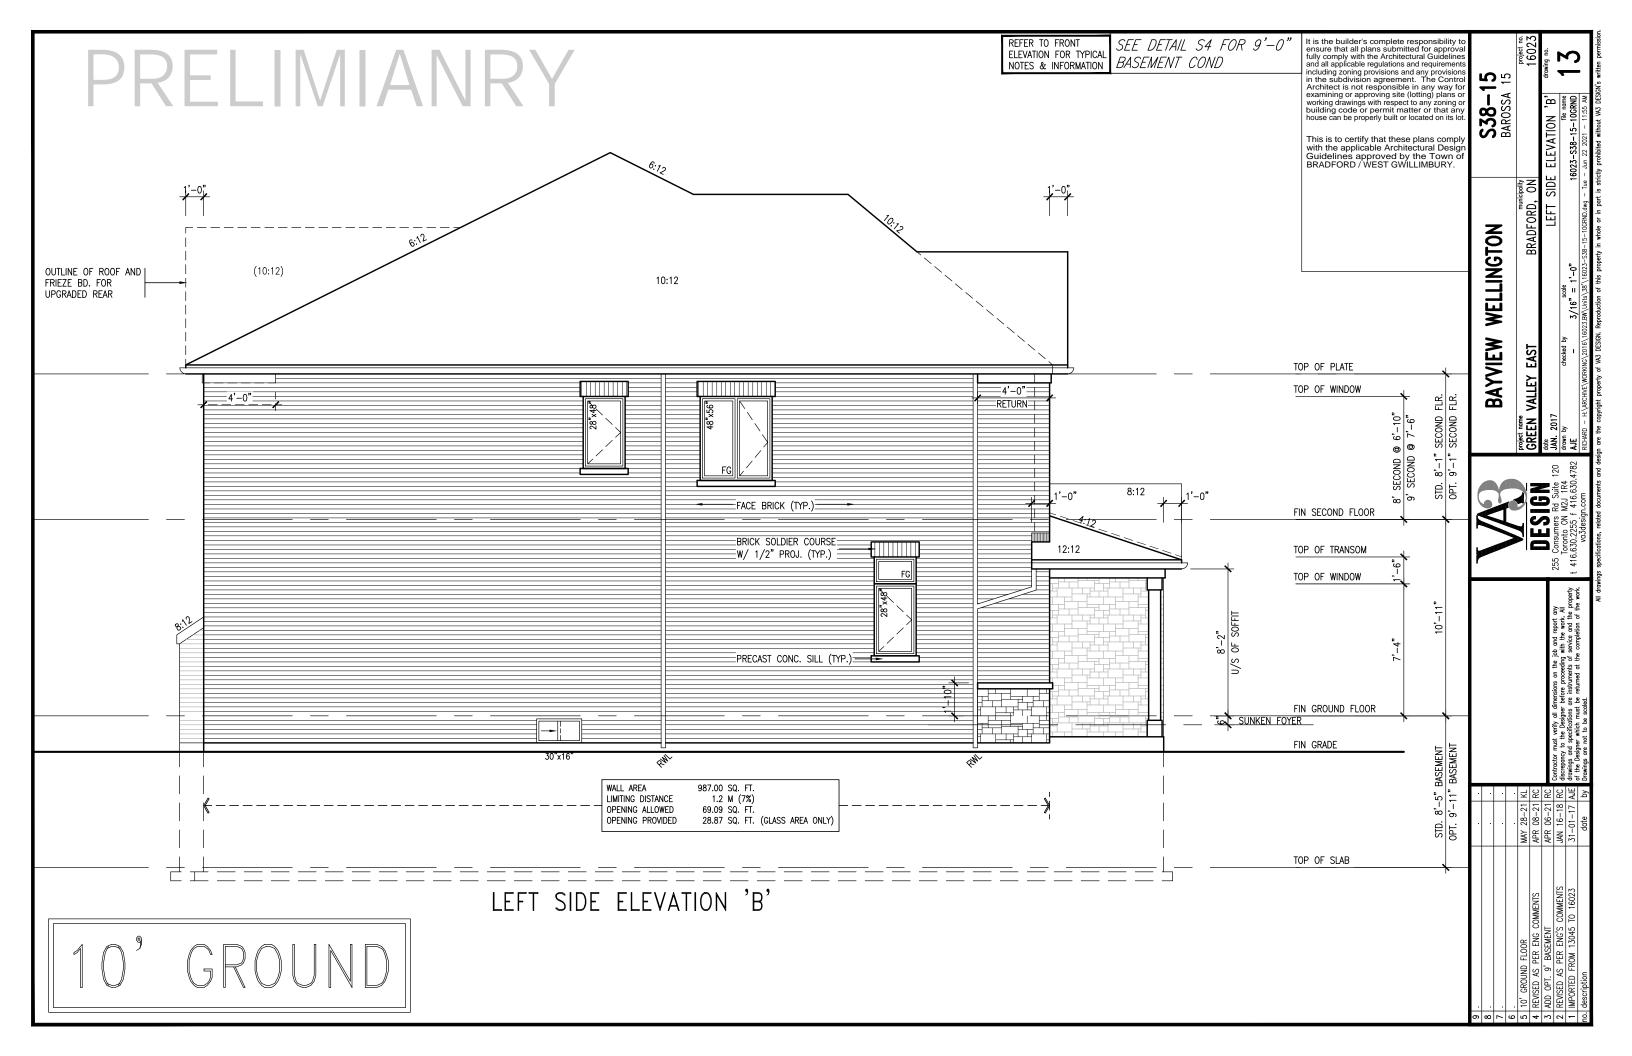


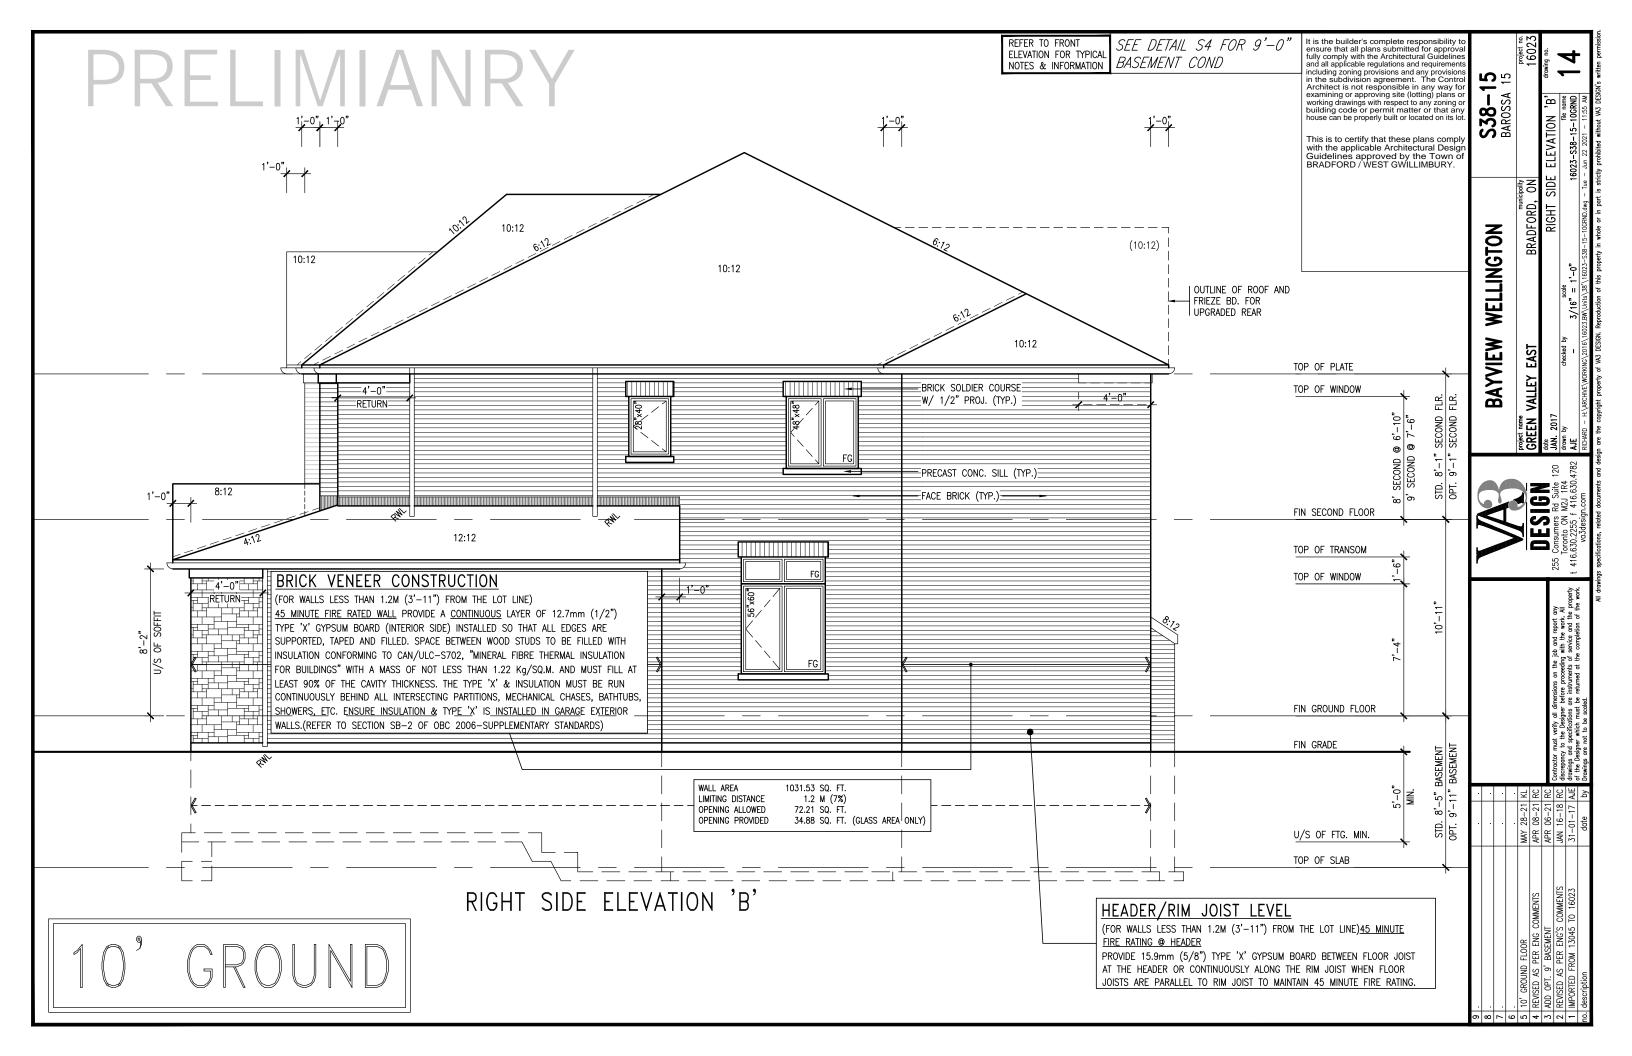


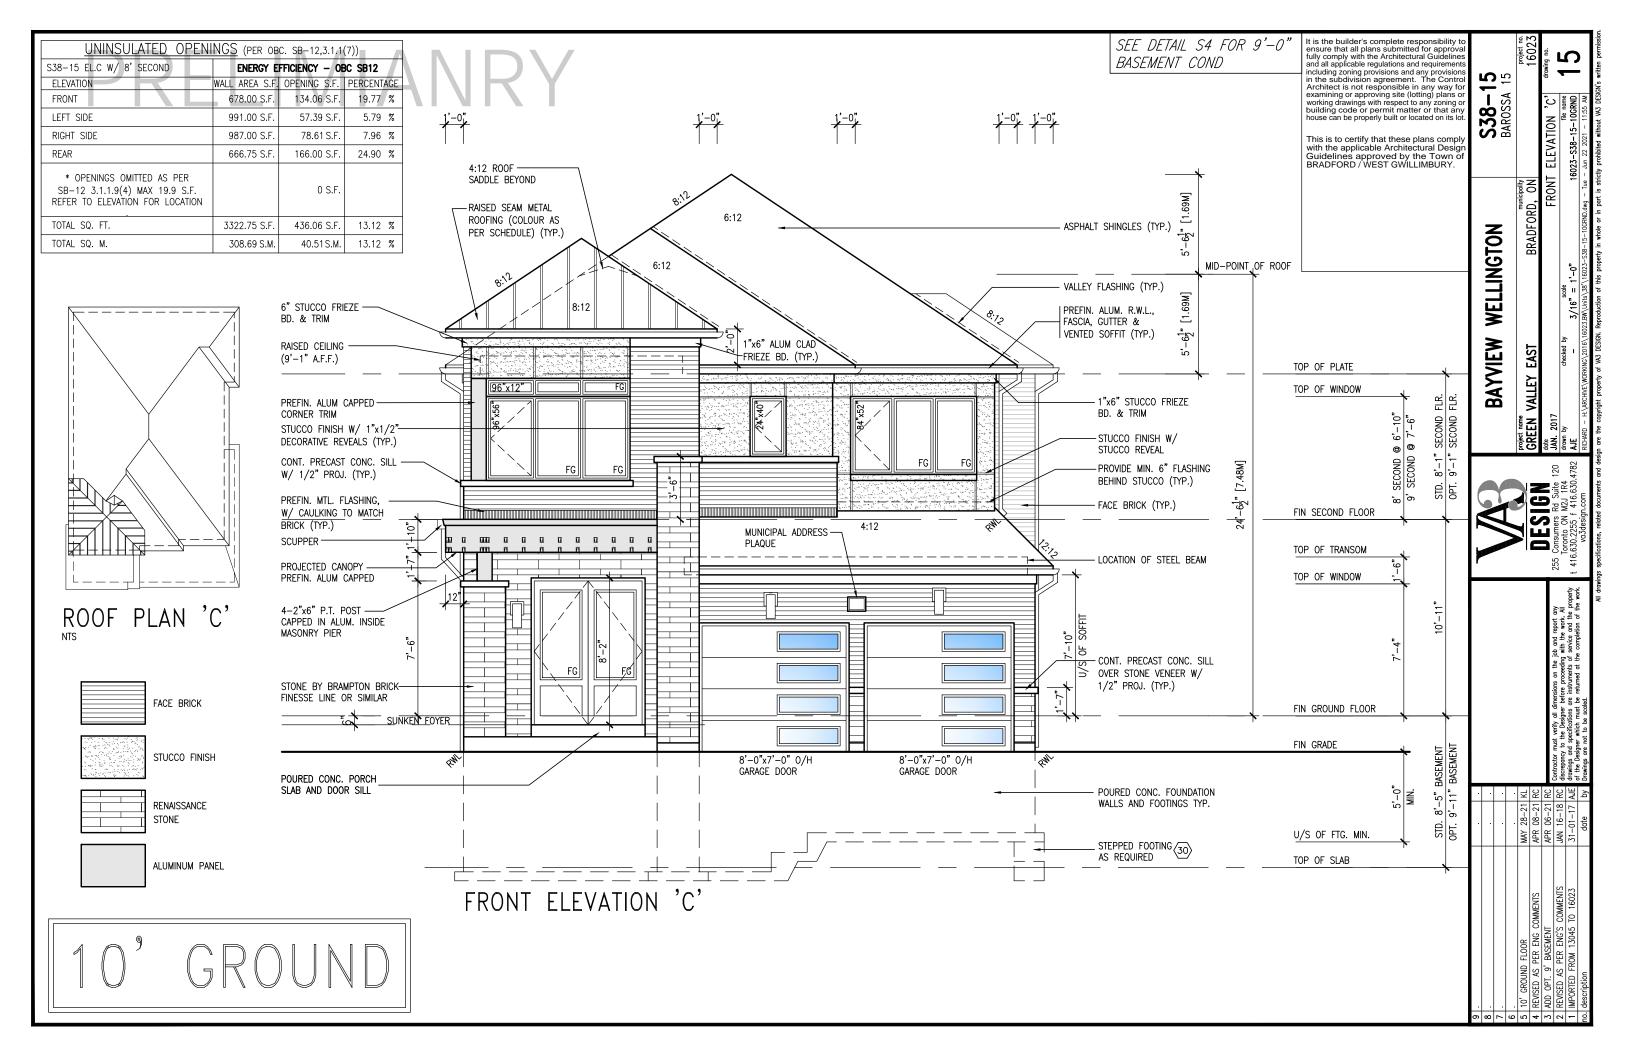

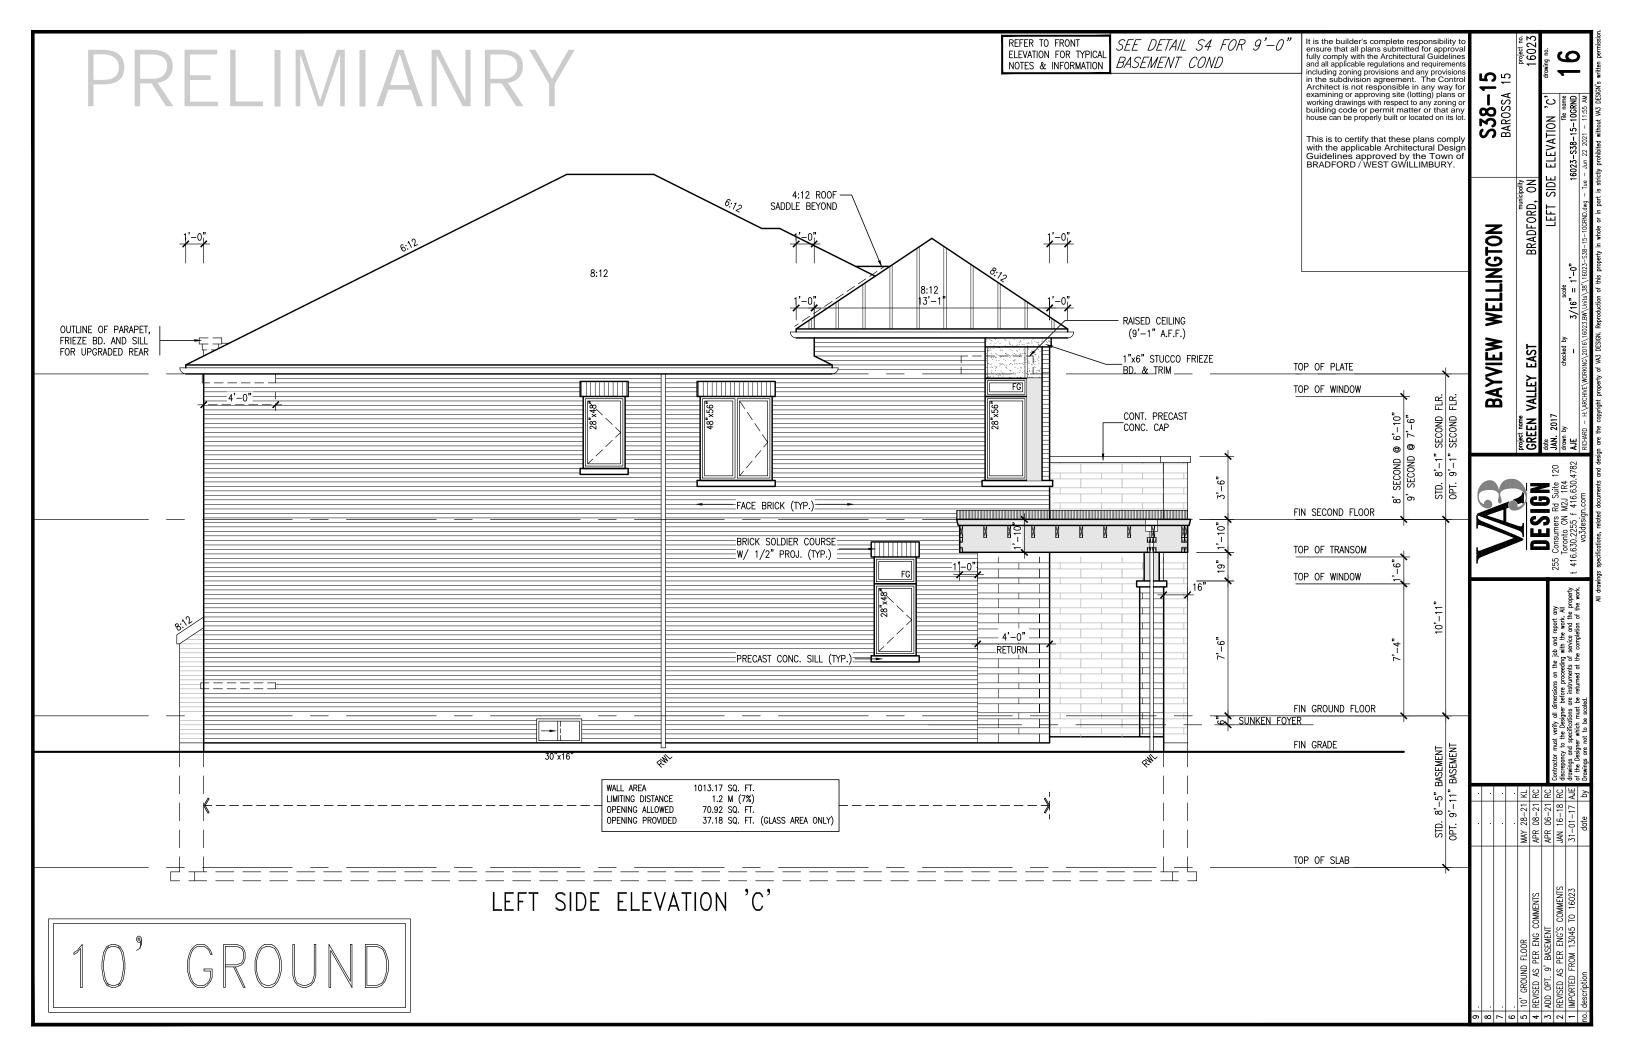

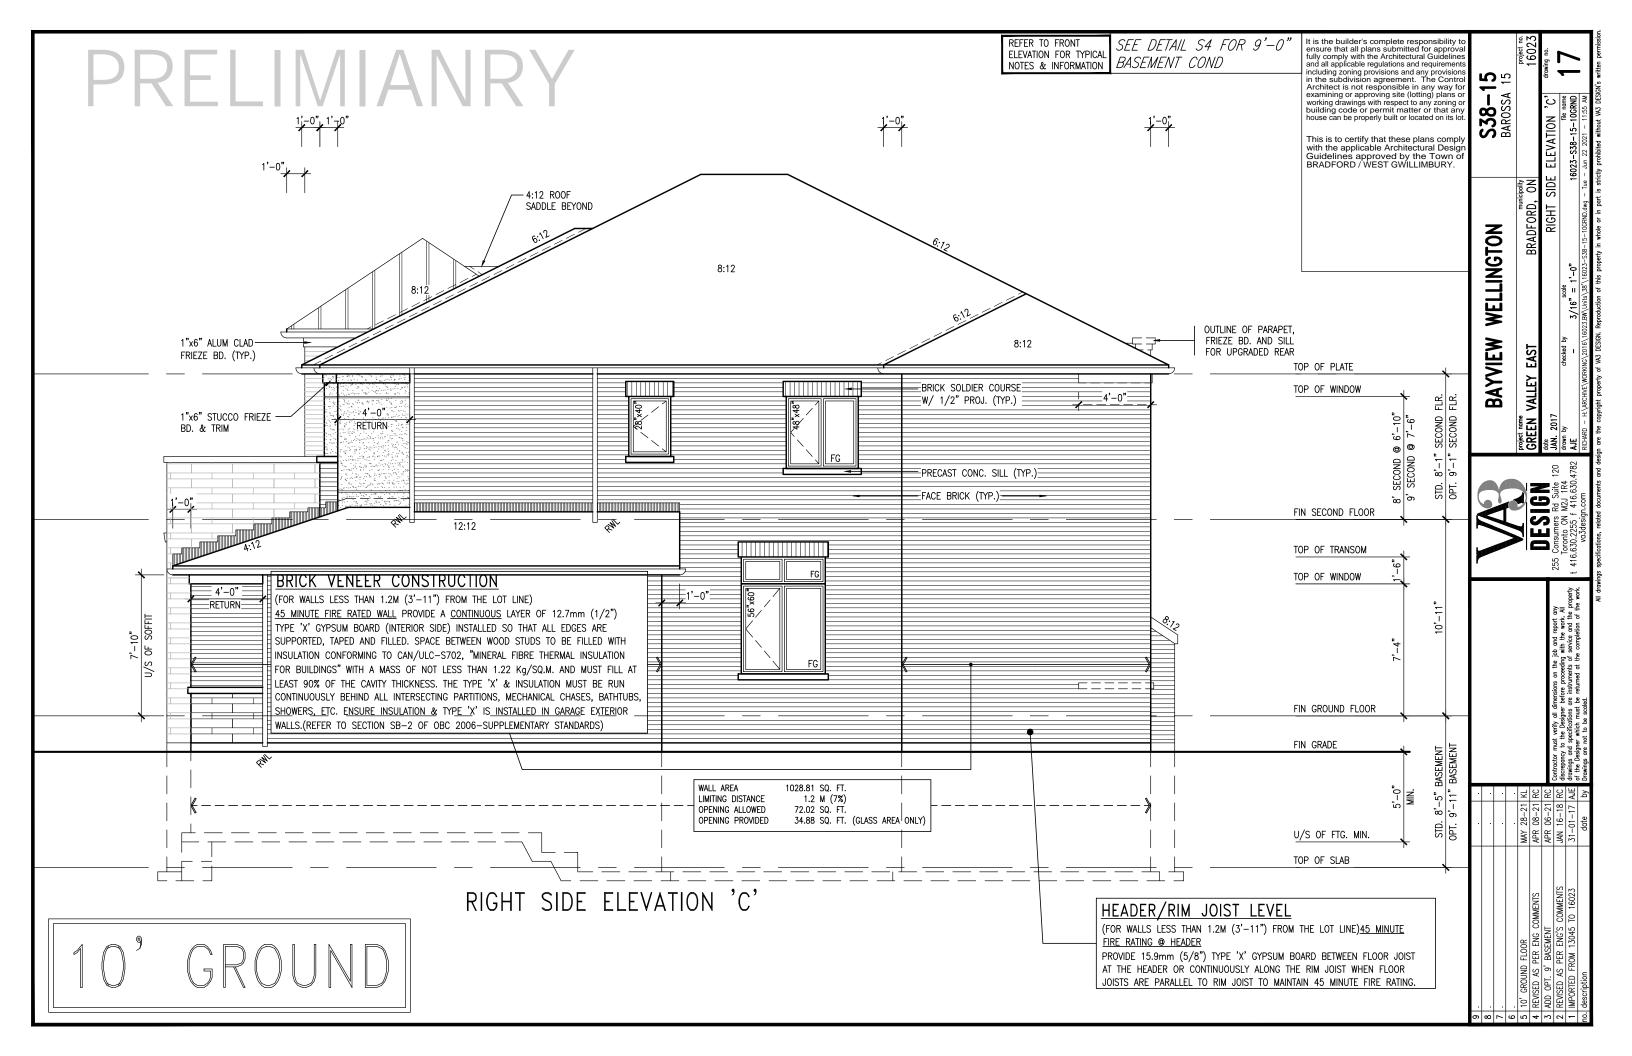


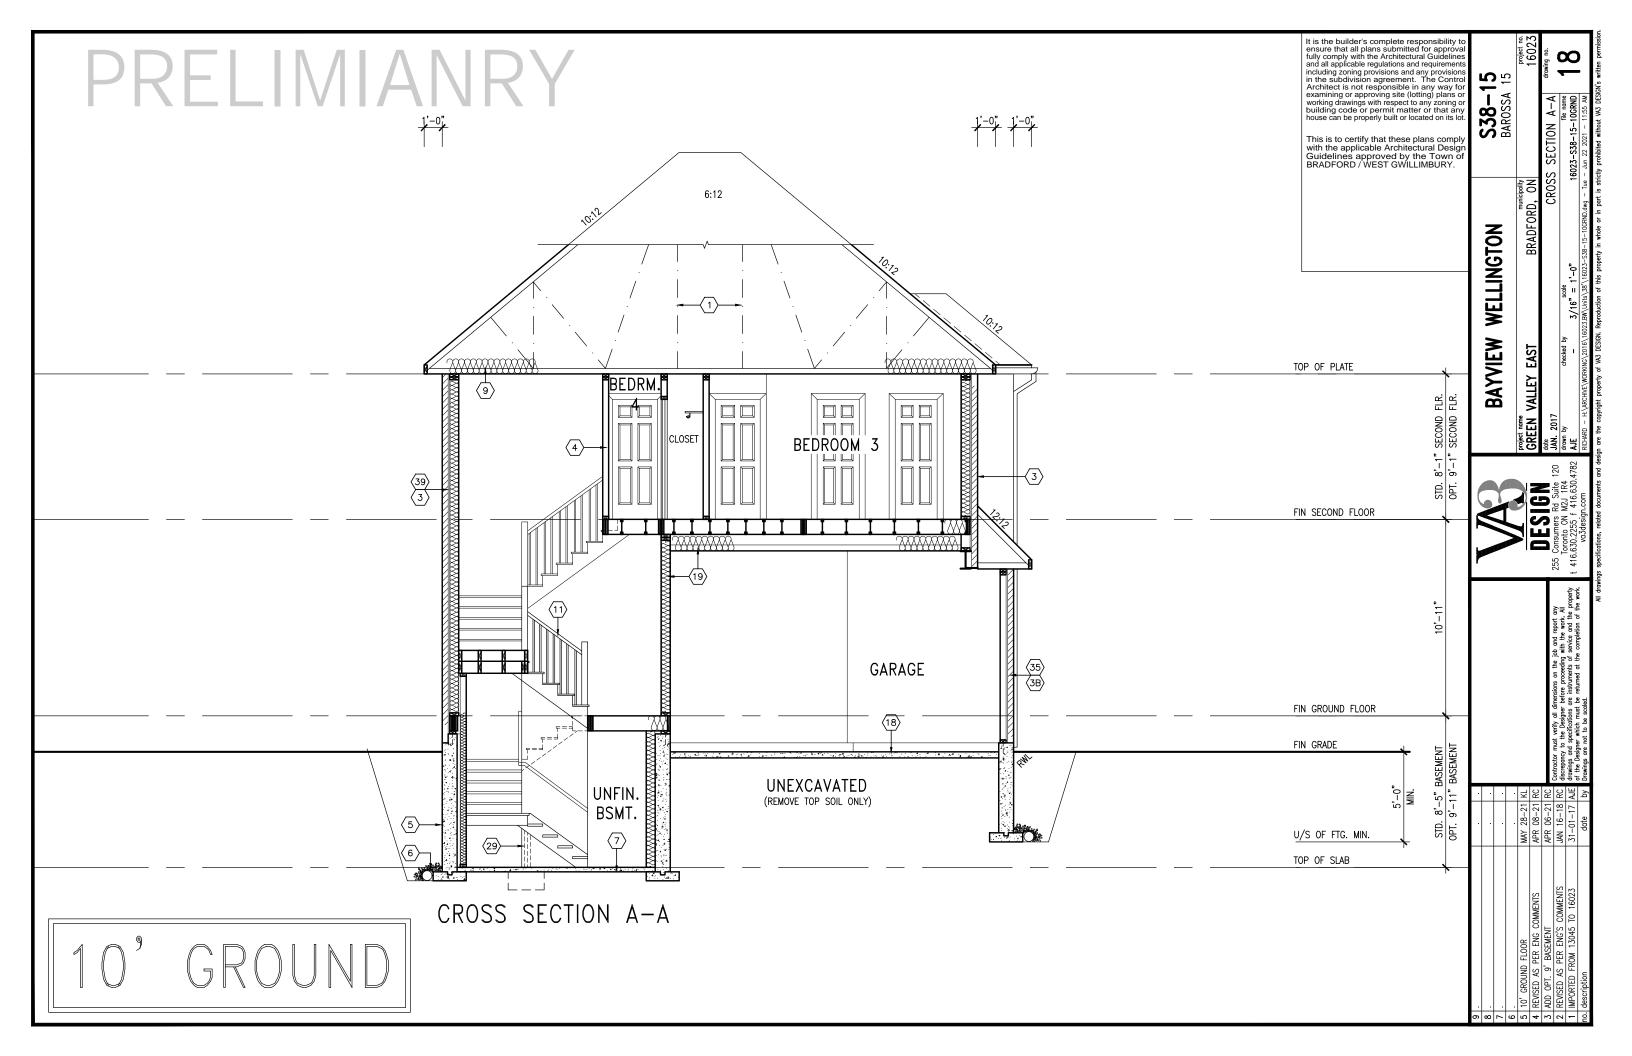

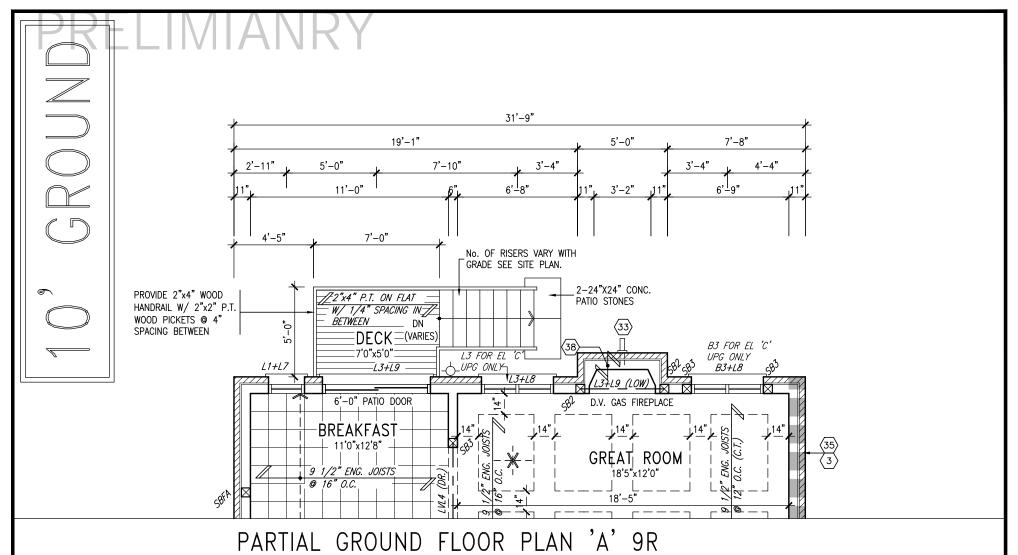

OR MORE W.O.D. CONDITION

ELEVS 'B' & 'C' SIMILAR

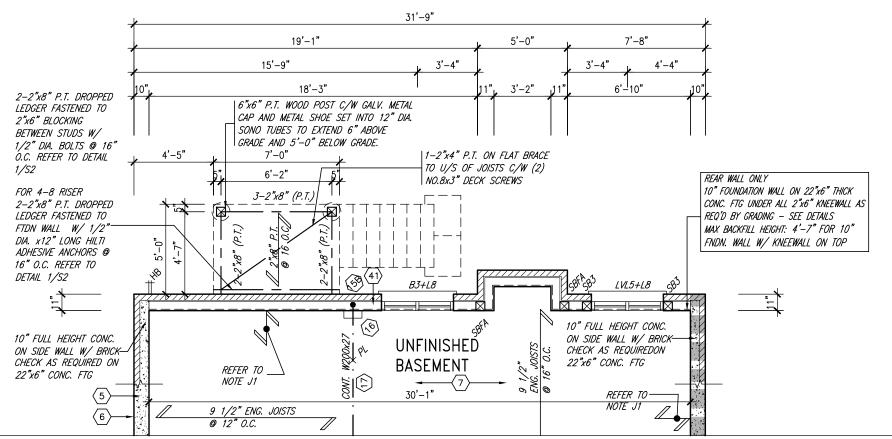

PARTIAL BASEMENT PLAN 'A' 9R OR MORE W.O.D. CONDITION

ELEVS 'B' & 'C' SIMILAR

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REFER TO FULL PLANS FOR TYPICAL NOTES.

NOTE: ALL LVL'S SUPPORTING FLOOR LOADS ARE TO BE SPECIFIED BY FLOOR TRUSS MANUFACTURER.

NOTE: FLOOR FRAMING INFO REFER TO SHOP DRAWINGS FOR ALL TRUSS-JOIST INFORMATION AND DETAILS. UNLESS OTHERWISE NOTED.

<u>NOTE:</u> SPACE ALL FLOOR JOISTS @ 12" O.C. UNDER ALL CERAMIC TILE AREAS.

10' GROUND FLOOR MAY 28-21 KI REVISED AS PER ENG COMMENTS APR 08-21 R APR 06-21 RC ADD OPT. 9' BASEMENT REVISED AS PER ENG'S COMMENTS JAN 16-18 RC 31-01-17 AJE IMPORTED FROM 13045 TO 16023 description

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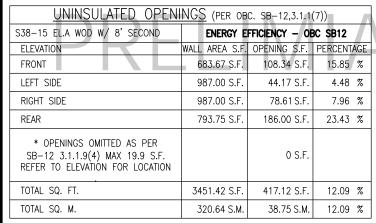


S38 - 15BAROSSA 15

16023

19

GREEN VALLEY EAST BRADFORD, ON JAN. 2017 PARTIAL PLANS - W.O.D. CONDITION 16023-S38-15-10GRND 3/16" = 1'-0" AJE




UNINSULATED OPENINGS (PER OBC. SB-12,3.1.1(7))					
S38-15 EL.B WOD W/ 8' SECOND	ENERGY E	ENERGY EFFICIENCY - OBC SB12			
ELEVATION	WALL AREA S.F.	OPENING S.F.	PERCENTA	٩GE	
FRONT	682.57 S.F.	112.10 S.F.	16.42	%	
LEFT SIDE	987.00 S.F.	44.17 S.F.	4.48	%	
RIGHT SIDE	987.00 S.F.	78.61 S.F.	7.96	%	
REAR	793.75 S.F.	186.00 S.F.	23.43	%	
* OPENINGS OMITTED AS PER SB-12 3.1.1.9(4) MAX 19.9 S.F. REFER TO ELEVATION FOR LOCATION		0 S.F.			
TOTAL SQ. FT.	3450.32 S.F.	420.88 S.F.	12.20	%	
TOTAL SQ. M.	320.54 S.M.	39.10 S.M.	12.20	%	

UNINSULATED OPENINGS (PER OBC. SB-12,3.1.1(7))				
S38-15 EL.C WOD W/ 8' SECOND	ENERGY E	FFICIENCY - OF	C SB12	
ELEVATION	WALL AREA S.F.	OPENING S.F.	PERCENTA	AGE
FRONT	678.00 S.F.	134.06 S.F.	19.77	%
LEFT SIDE	991.00 S.F.	57.39 S.F.	5.79	%
RIGHT SIDE	987.00 S.F.	78.61 S.F.	7.96	%
REAR	793.75 S.F.	186.00 S.F.	23.43	%
* OPENINGS OMITTED AS PER SB-12 3.1.1.9(4) MAX 19.9 S.F. REFER TO ELEVATION FOR LOCATION		0 S.F.		
TOTAL SQ. FT.	3449.75 S.F.	456.06 S.F.	13.22	%
TOTAL SQ. M.	320.49 S.M.	42.37 S.M.	13.22	%




10° GROUND

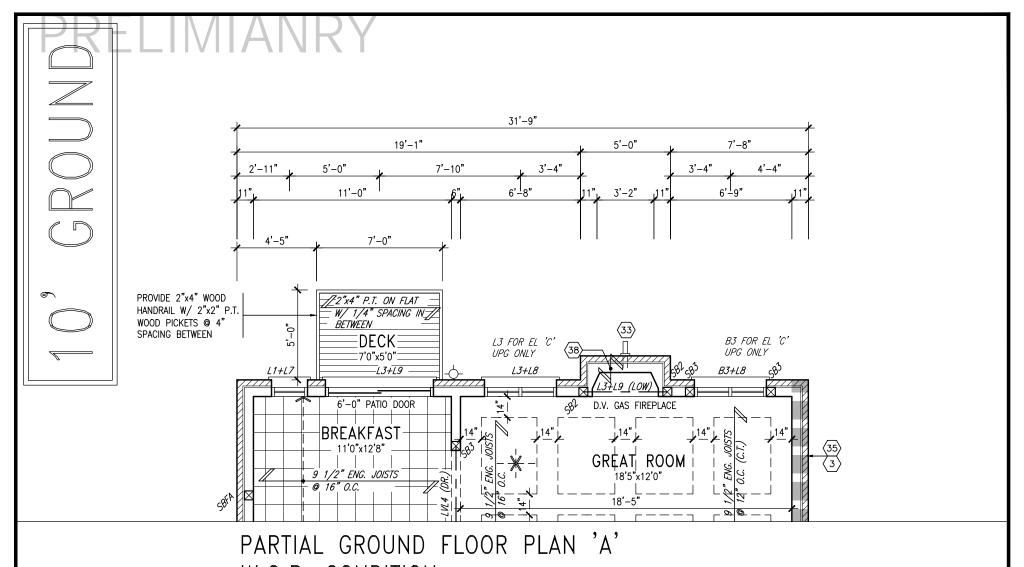

W.O.B. CONDITION

ELEVS 'B' & 'C' SIMILAR

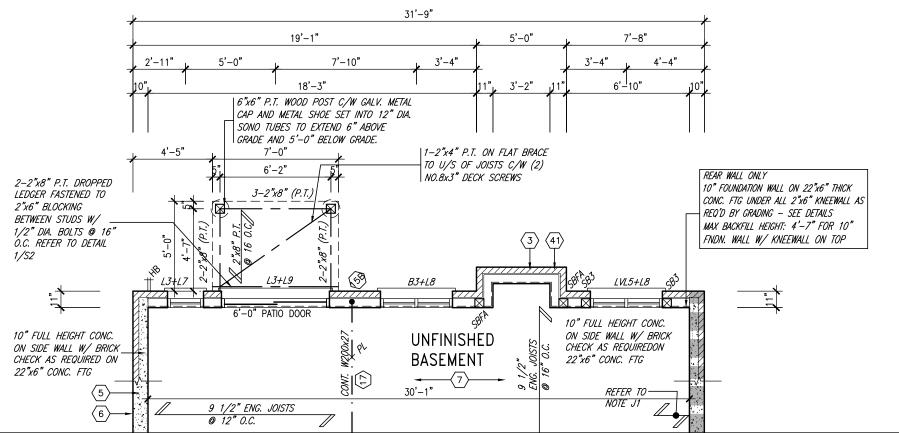

PARTIAL BASEMENT PLAN 'A' W.O.B. CONDITION

ELEVS 'B' & 'C' SIMILAR

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NOTE: FLOOR FRAMING INFO REFER TO SHOP DRAWINGS FOR ALL TRUSS-JOIST INFORMATION AND DETAILS. UNLESS OTHERWISE NOTED.

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10' GROUND FLOOR MAY 28-21 KI REVISED AS PER ENG COMMENTS APR 08-21 R APR 06-21 RC ADD OPT. 9' BASEMENT REVISED AS PER ENG'S COMMENTS JAN 16-18 RC 31-01-17 AJE IMPORTED FROM 13045 TO 16023 description

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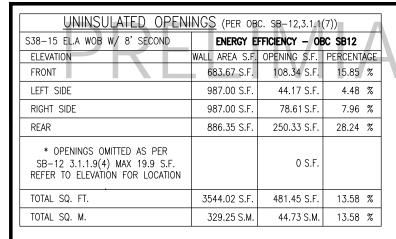


BAYVIEW WELLINGTON

S38-15 BAROSSA 15


16023

GREEN VALLEY EAST BRADFORD, ON JAN. 2017 PARTIAL PLANS - W.O.B. CONDITION drawn by 3/16" = 1'-0" 16023-S38-15-10GRND





AGE
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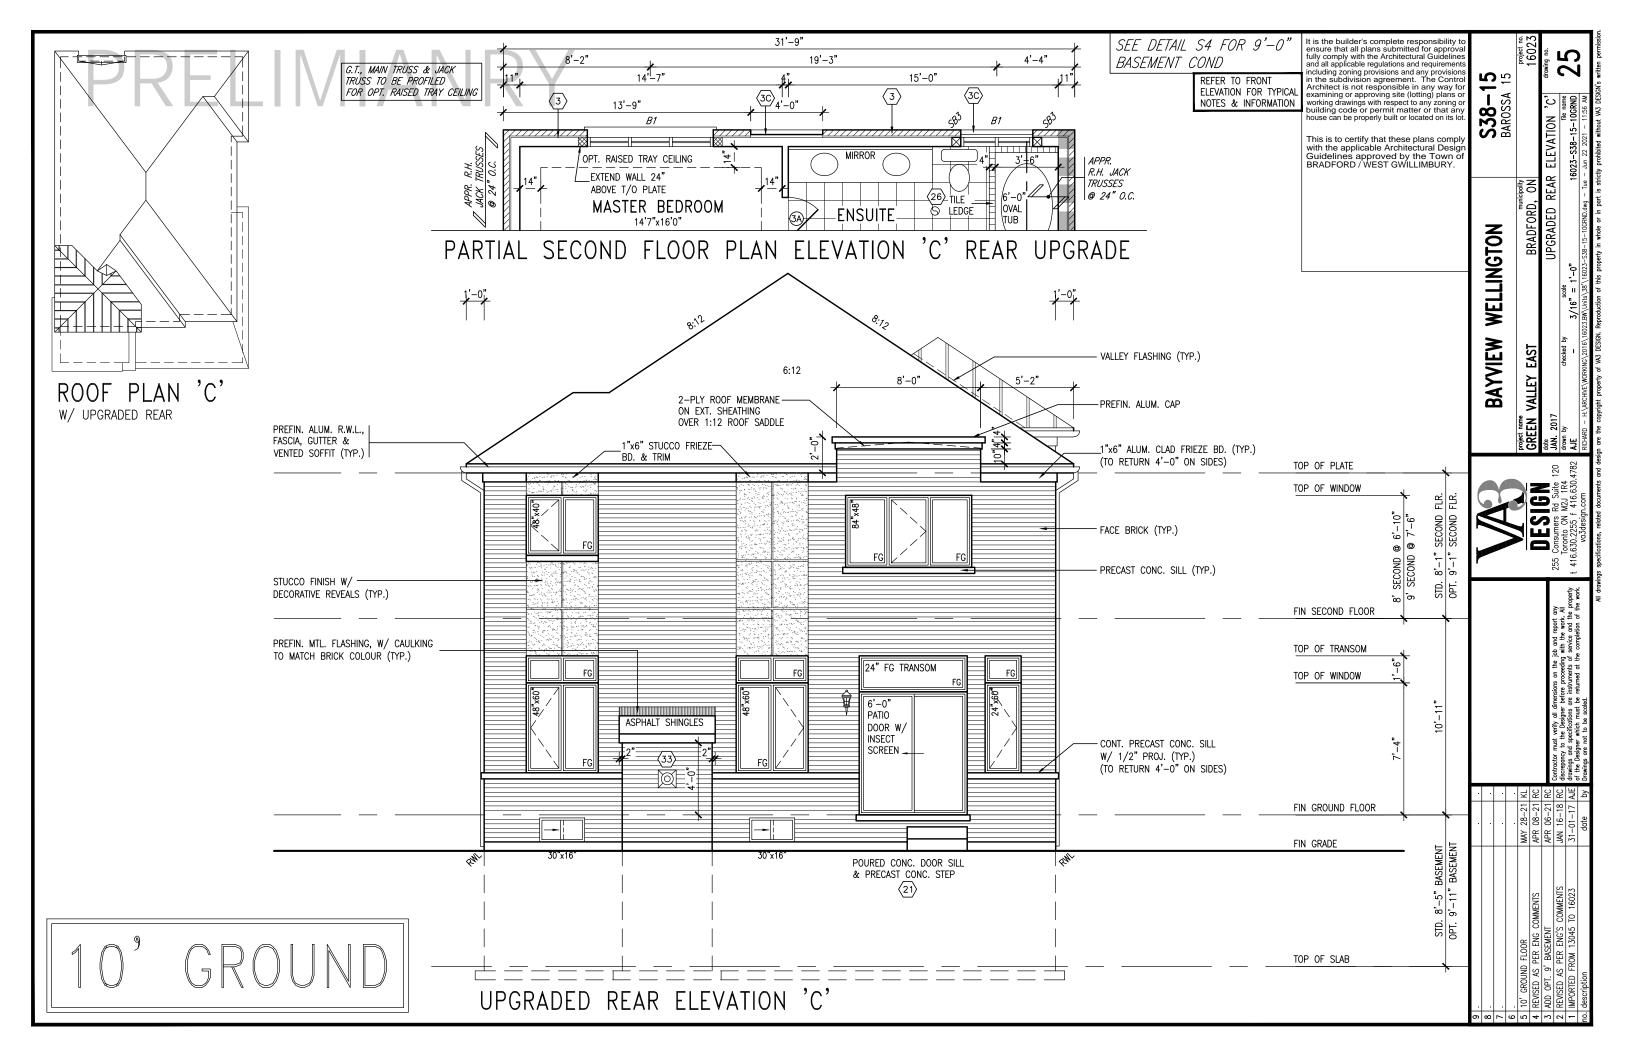
UNINSULATED OPENINGS (PER OBC. SB-12,3.1.1(7))				
S38-15 EL.C WOB W/ 8' SECOND	ENERGY E	FFICIENCY - OF	3C SB12	
ELEVATION	WALL AREA S.F.	OPENING S.F.	PERCENTA	4GE
FRONT	678.00 S.F.	134.06 S.F.	19.77	%
LEFT SIDE	991.00 S.F.	57.39 S.F.	5.79	%
RIGHT SIDE	987.00 S.F.	78.61 S.F.	7.96	%
REAR	886.35 S.F.	250.33 S.F.	28.24	%
* OPENINGS OMITTED AS PER SB-12 3.1.1.9(4) MAX 19.9 S.F. REFER TO ELEVATION FOR LOCATION		0 S.F.		
TOTAL SQ. FT.	3542.35 S.F.	520.39 S.F.	14.69	%
TOTAL SQ. M.	329.09 S.M.	48.35 S.M.	14.69	%

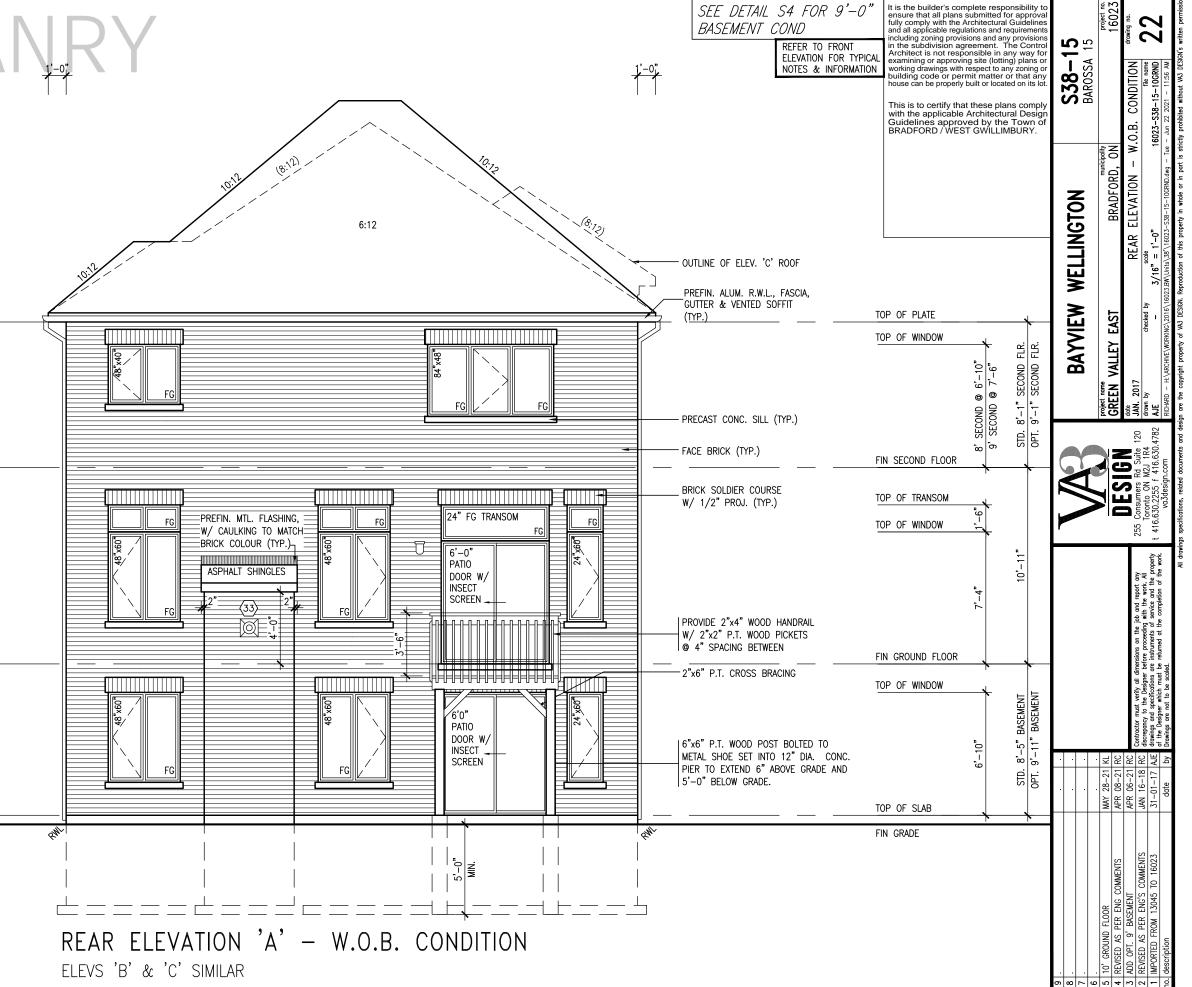



SEE DETAIL S4 FOR 9'-0"




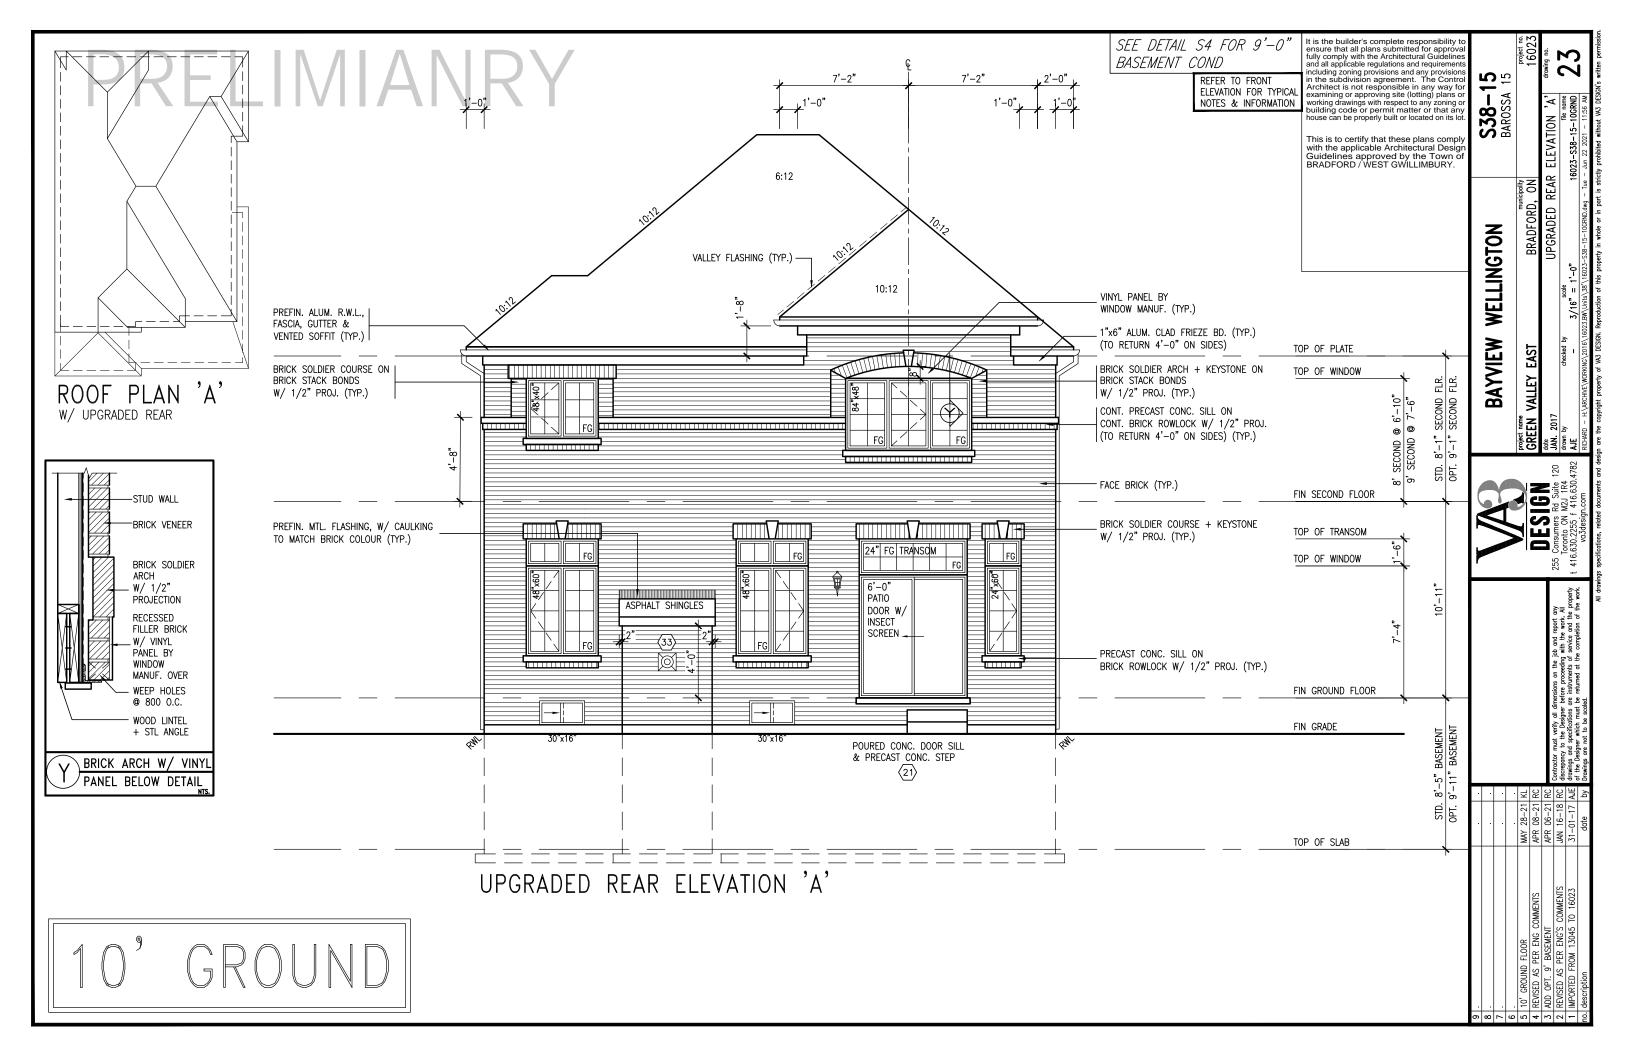


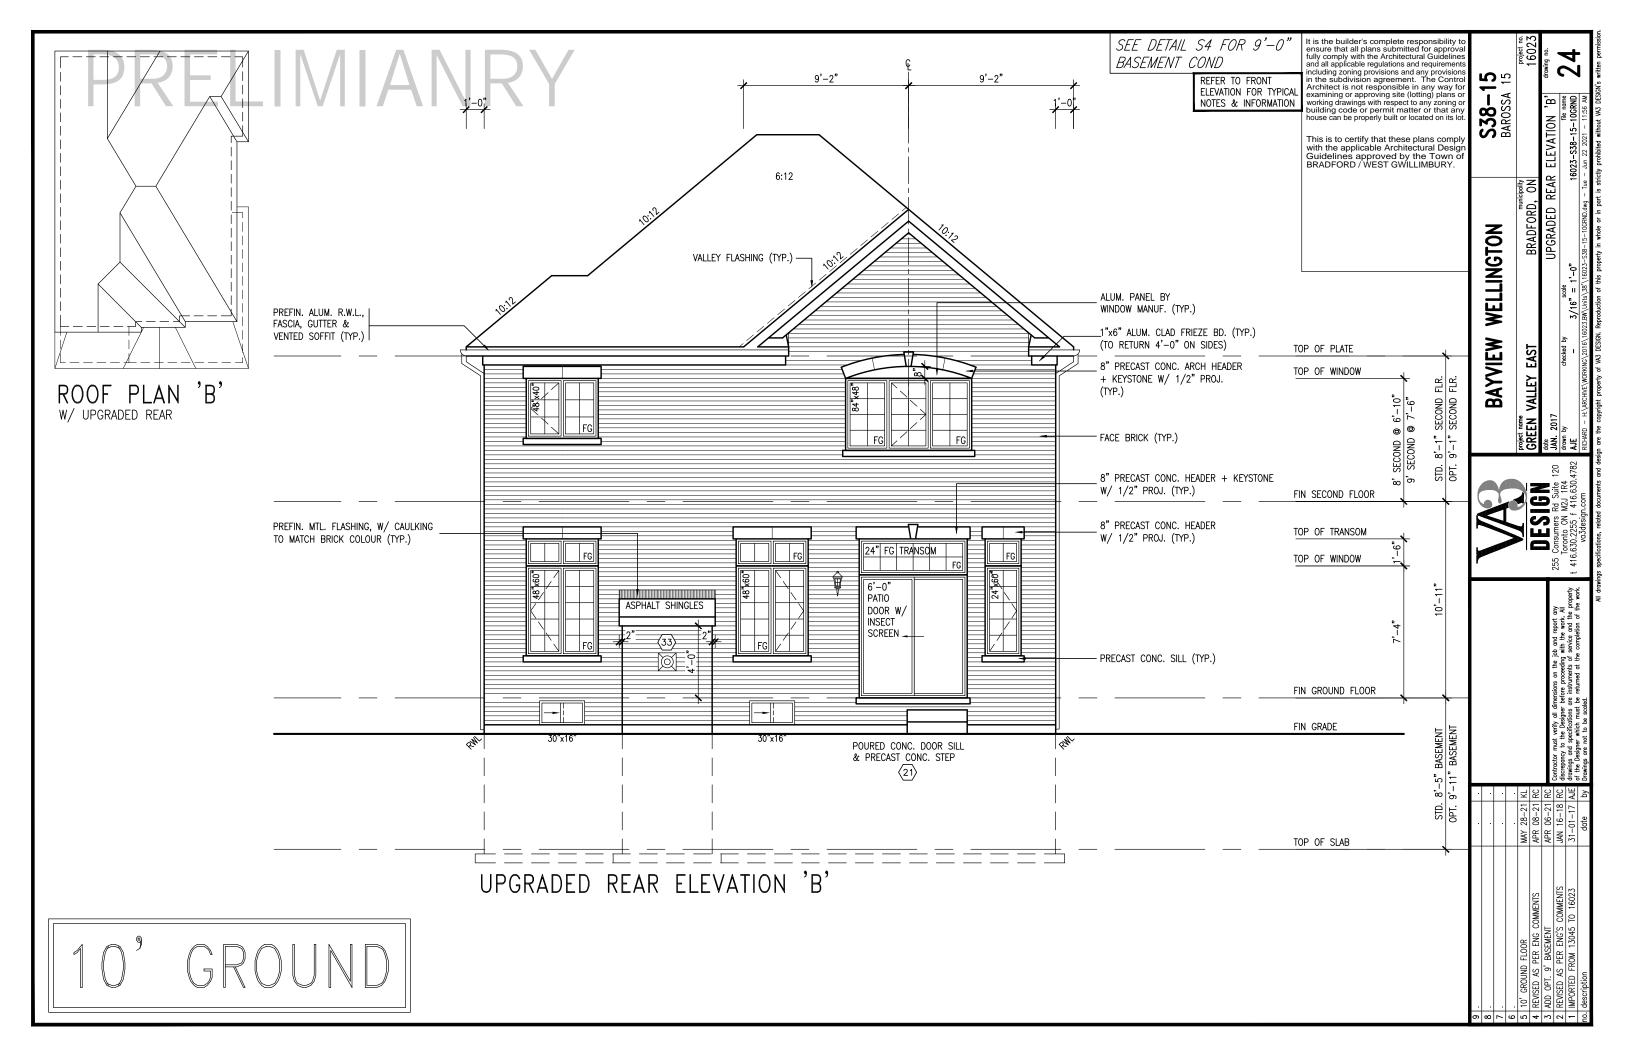


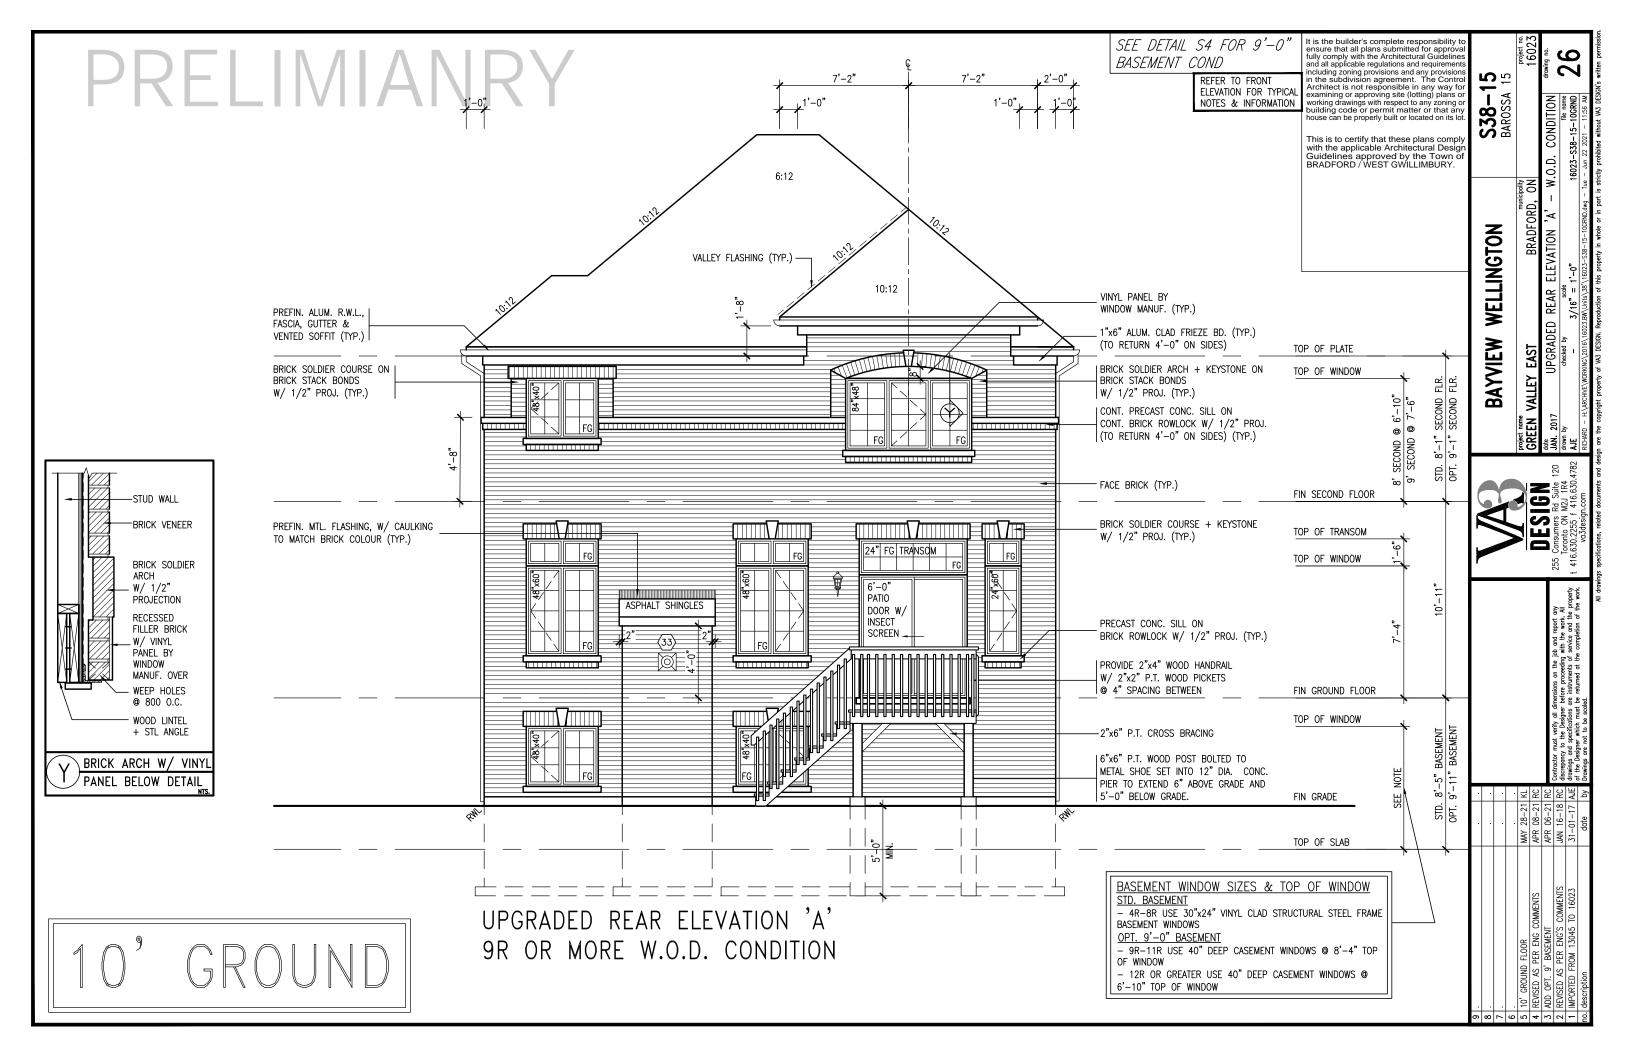


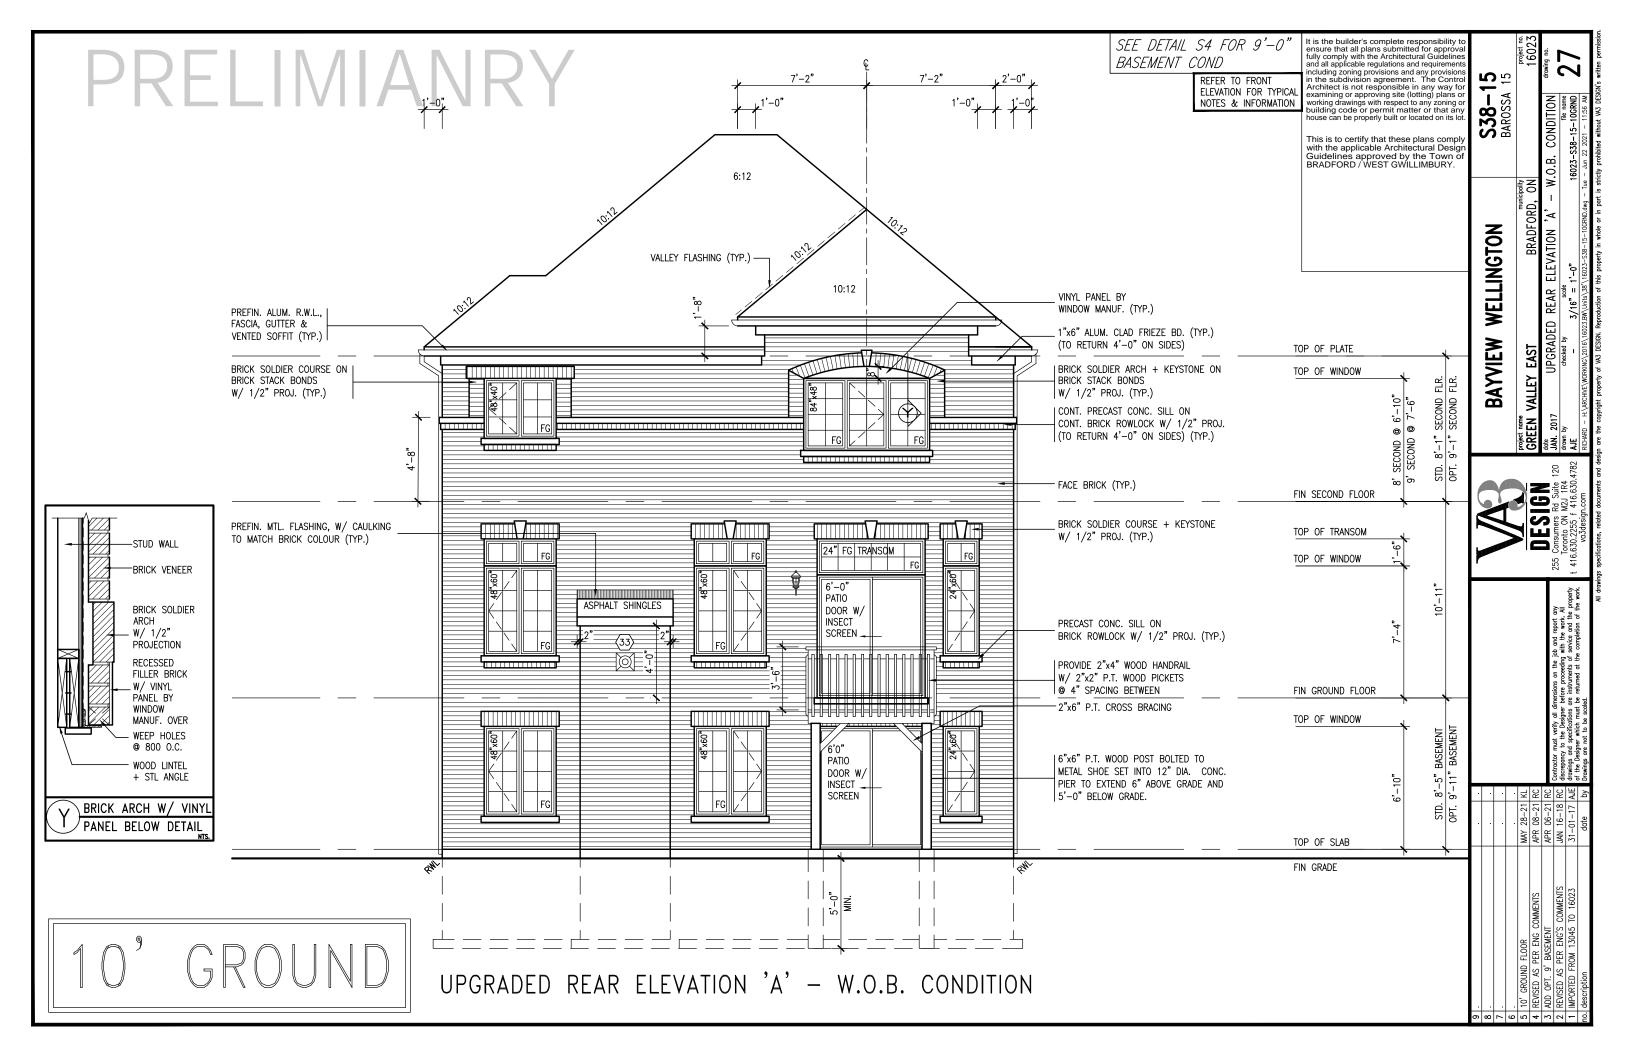

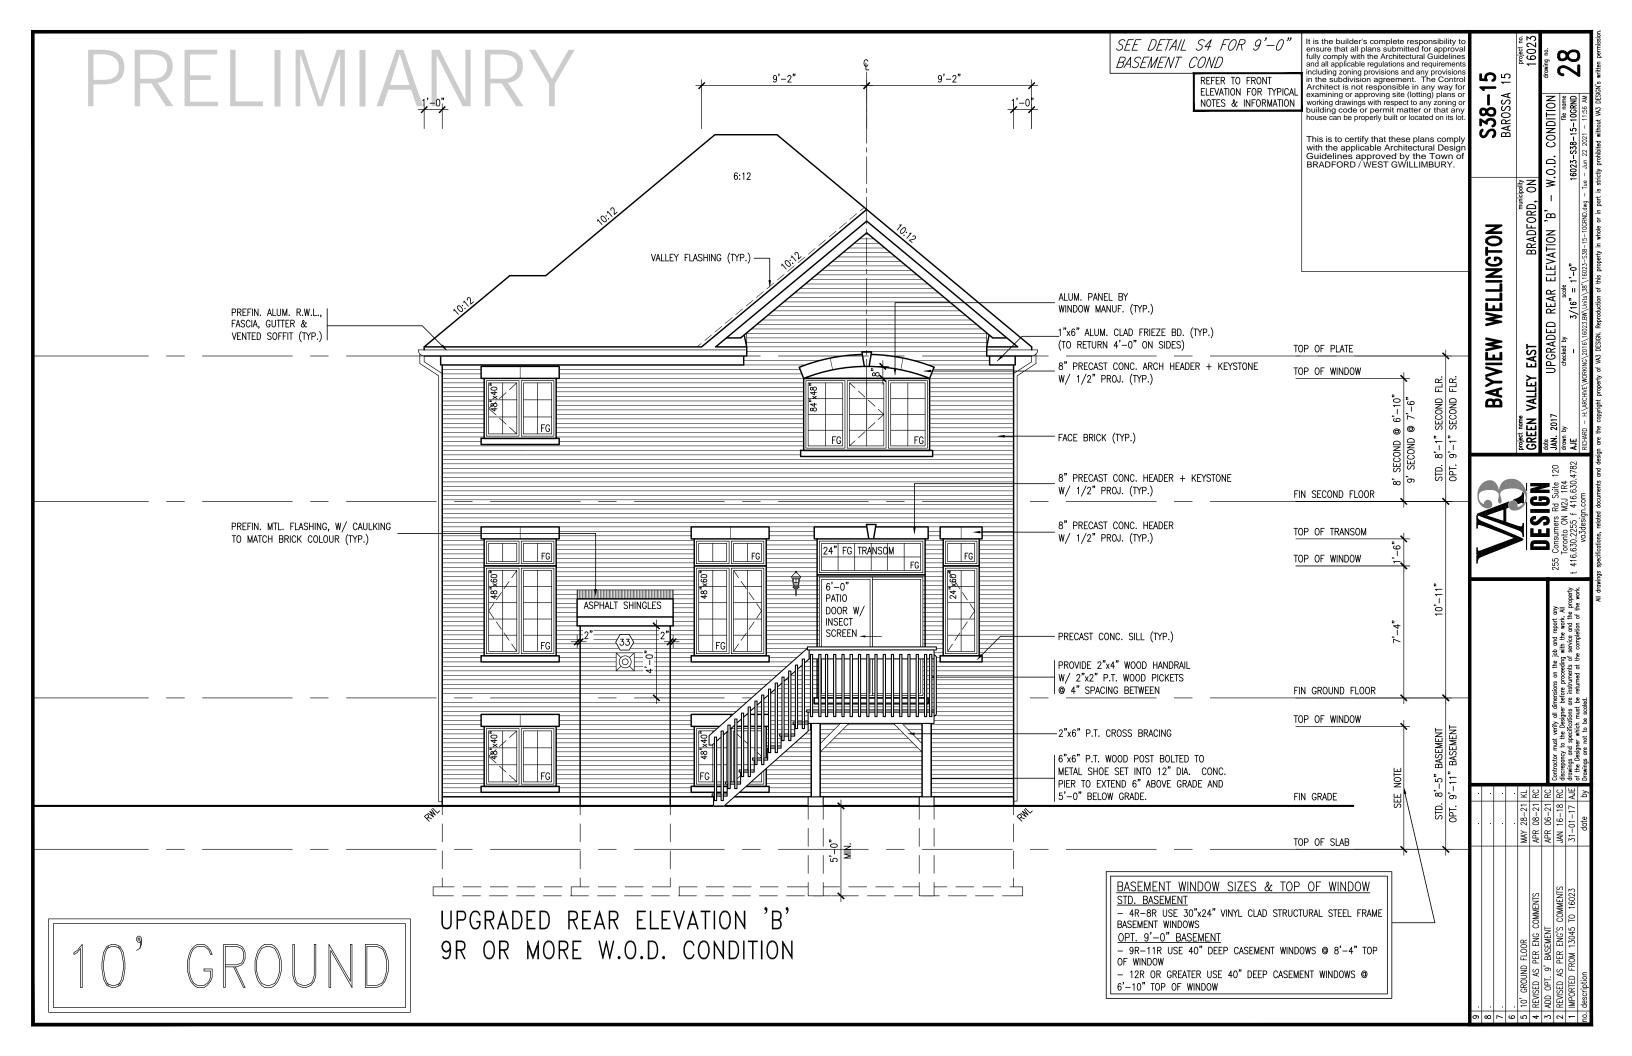

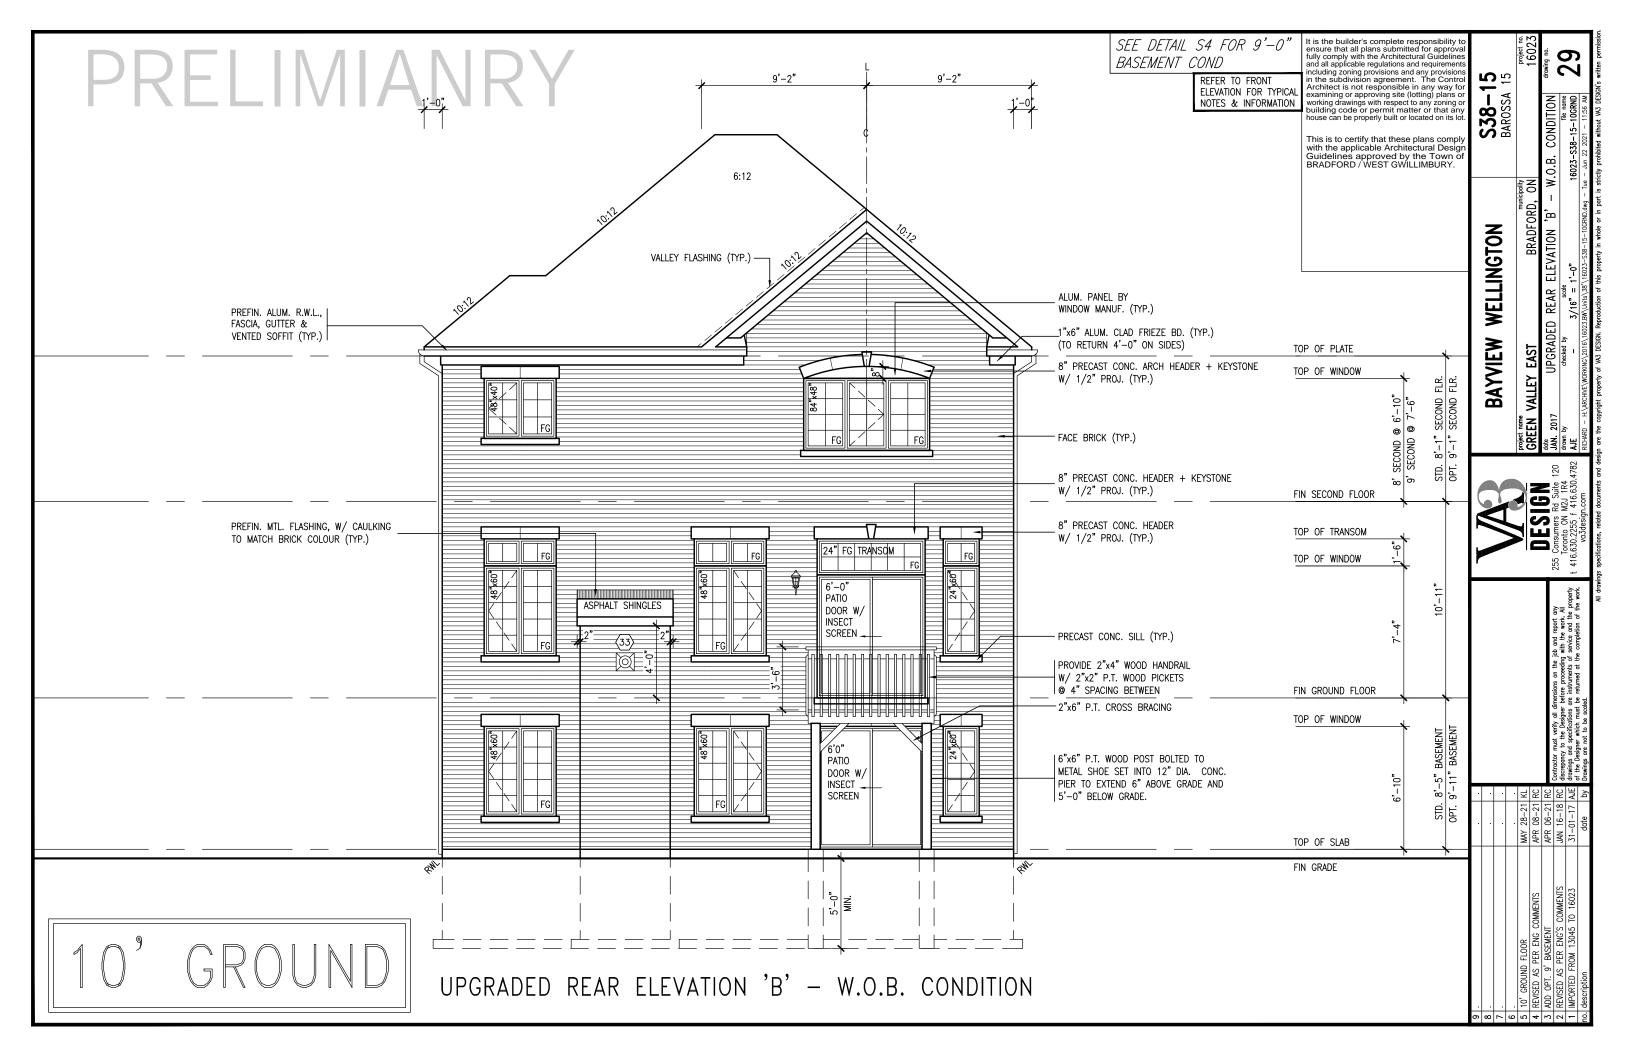

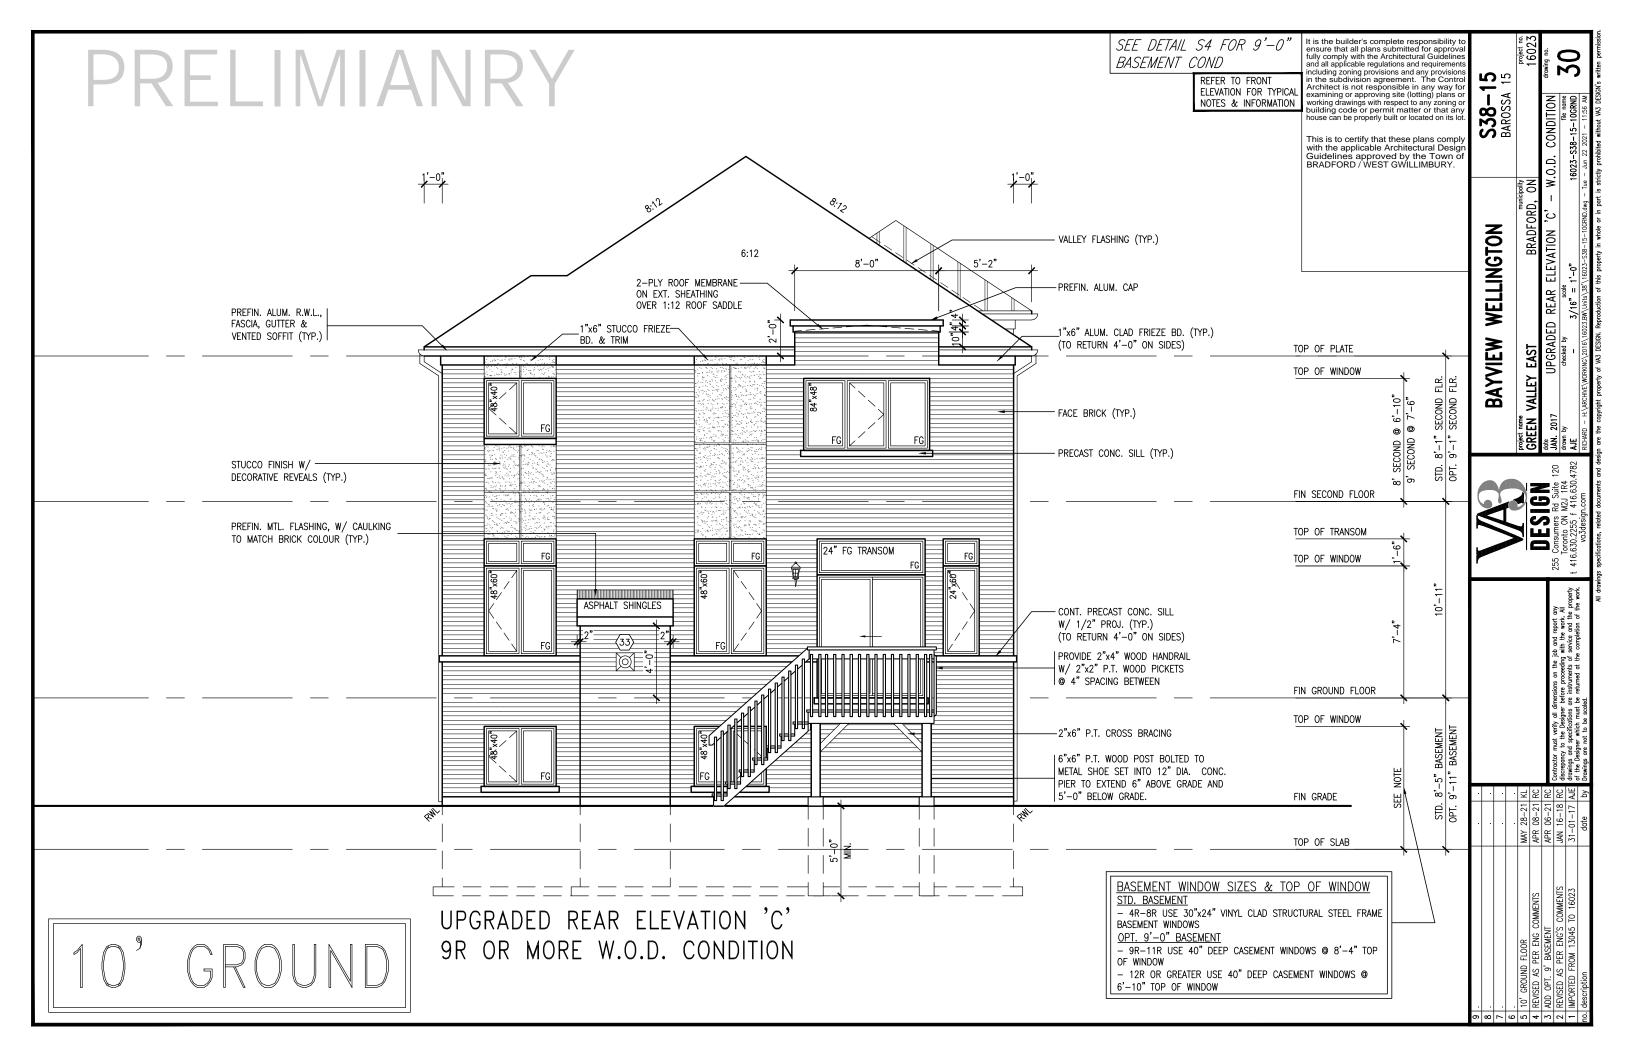

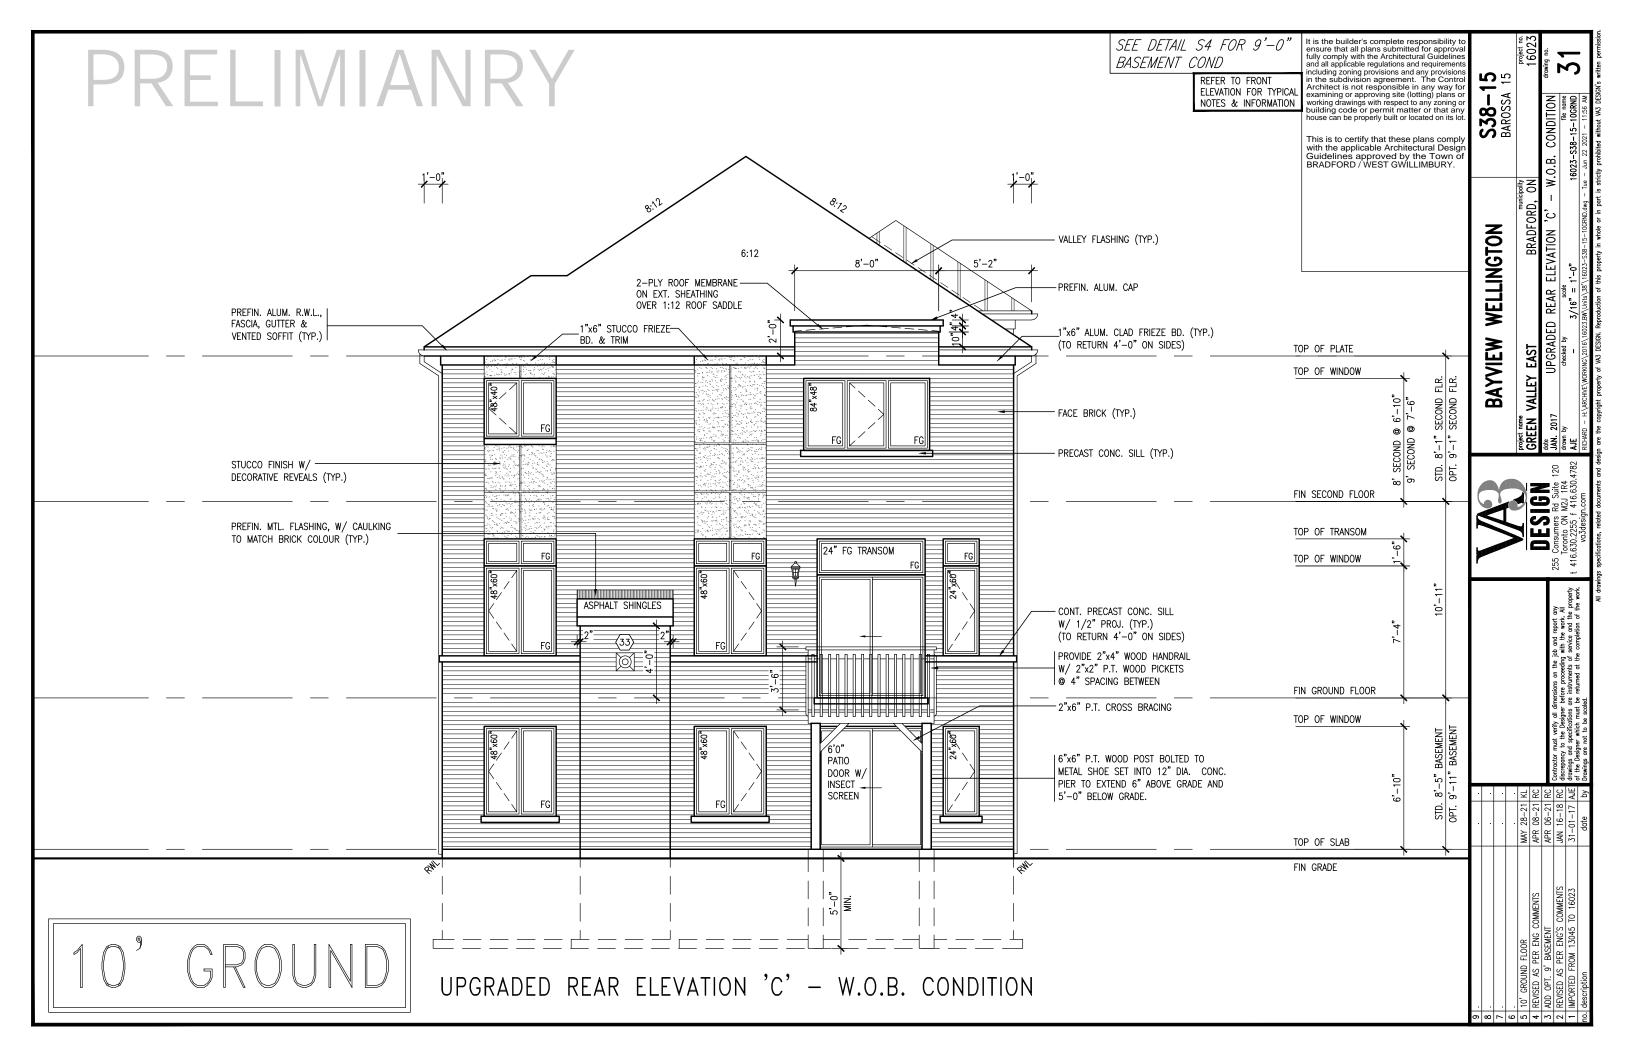

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UNINSULATED OPENINGS (PER OBC. SB-12,3.1.1(7))				
S38-15 EL.A W/ 9' SECOND	ENERGY E	FFICIENCY - OF	SC SB12	
ELEVATION	WALL AREA S.F.	OPENING S.F.	PERCENTA	GE
FRONT	715.42 S.F.	108.34 S.F.	15.14	%
LEFT SIDE	1034.00 S.F.	44.17 S.F.	4.27	%
RIGHT SIDE	1034.00 S.F.	78.61 S.F.	7.60	%
REAR	698.50 S.F.	166.00 S.F.	23.77	%
* OPENINGS OMITTED AS PER SB-12 3.1.1.9(4) MAX 19.9 S.F. REFER TO ELEVATION FOR LOCATION		0 S.F.		
TOTAL SQ. FT.	3481.92 S.F.	397.12 S.F.	11.41	%
TOTAL SQ. M.	323.48 S.M.	36.89 S.M.	11.41	%

UNINSULATED OPENINGS (PER OBC. SB-12,3.1.1(7))				
S38-15 EL.B W/ 9' SECOND	ENERGY E	FFICIENCY - OF	SC SB12	
ELEVATION	WALL AREA S.F.	OPENING S.F.	PERCENTA	AGE
FRONT	714.32 S.F.	106.43 S.F.	14.90	%
LEFT SIDE	1034.00 S.F.	44.17 S.F.	4.27	%
RIGHT SIDE	1034.00 S.F.	78.61 S.F.	7.60	%
REAR	698.50 S.F.	166.00 S.F.	23.77	%
* OPENINGS OMITTED AS PER SB-12 3.1.1.9(4) MAX 19.9 S.F. REFER TO ELEVATION FOR LOCATION		0 S.F.		
TOTAL SQ. FT.	3480.82 S.F.	395.21 S.F.	11.35	%
TOTAL SQ. M.	323.38 S.M.	36.72 S.M.	11.35	%

UNINSULATED OPENINGS (PER OBC. SB-12,3.1.1(7))				
S38-15 EL.C W/ 9' SECOND	ENERGY E	FFICIENCY - OF	SC SB12	
ELEVATION	WALL AREA S.F.	OPENING S.F.	PERCENTAGE	
FRONT	709.75 S.F.	134.06 S.F.	18.89 %	
LEFT SIDE	1038.00 S.F.	57.39 S.F.	5.53 %	
RIGHT SIDE	1034.00 S.F.	78.61 S.F.	7.60 %	
REAR	698.50 S.F.	166.00 S.F.	23.77 %	
* OPENINGS OMITTED AS PER SB-12 3.1.1.9(4) MAX 19.9 S.F. REFER TO ELEVATION FOR LOCATION		0 S.F.		
TOTAL SQ. FT.	3480.25 S.F.	436.06 S.F.	12.53 %	
TOTAL SQ. M.	323.32 S.M.	40.51 S.M.	12.53 %	

<u>UNINSULATED OPENI</u>	NGS (PER OB	C. SB-12,3.1.1	(7))
S38-15 EL.A WOD W/ 9' SECOND	ENERGY E	FFICIENCY - O	3C SB12
ELEVATION	WALL AREA S.F.	OPENING S.F.	PERCENTAGE
FRONT	715.42 S.F.	108.34 S.F.	15.14 %
LEFT SIDE	1034.00 S.F.	44.17 S.F.	4.27 %
RIGHT SIDE	1034.00 S.F.	78.61 S.F.	7.60 %
REAR	825.50 S.F.	186.00 S.F.	22.53 %
* OPENINGS OMITTED AS PER SB-12 3.1.1.9(4) MAX 19.9 S.F. REFER TO ELEVATION FOR LOCATION		0 S.F.	
TOTAL SQ. FT.	3608.92 S.F.	417.12 S.F.	11.56 %
TOTAL SQ. M.	335.28 S.M.	38.75 S.M.	11.56 %

<u>UNINSULATED OPENI</u>	NGS (PER OB	C. SB-12,3.1.1	(7))
S38-15 EL.B WOD W/ 9' SECOND	ENERGY E	FFICIENCY - OE	SC SB12
ELEVATION	WALL AREA S.F.	OPENING S.F.	PERCENTAGE
FRONT	714.32 S.F.	106.43 S.F.	14.90 %
LEFT SIDE	1034.00 S.F.	44.17 S.F.	4.27 %
RIGHT SIDE	1034.00 S.F.	78.61 S.F.	7.60 %
REAR	825.50 S.F.	186.00 S.F.	22.53 %
* OPENINGS OMITTED AS PER SB-12 3.1.1.9(4) MAX 19.9 S.F. REFER TO ELEVATION FOR LOCATION		0 S.F.	
TOTAL SQ. FT.	3607.82 S.F.	415.21 S.F.	11.51 %
TOTAL SQ. M.	335.17 S.M.	38.57 S.M.	11.51 %

LINUNIOU ATED ODEN	11100			
UNINSULATED OPENINGS (PER OBC. SB-12,3.1.1(7))				
S38-15 EL.C WOD W/ 9' SECOND ENERGY EFFICIENCY - OBC SB12				
ELEVATION	WALL AREA S.F.	OPENING S.F.	PERCENTA	AGE
FRONT	709.75 S.F.	134.06 S.F.	18.89	%
LEFT SIDE	1038.00 S.F.	57.39 S.F.	5.53	%
RIGHT SIDE	1034.00 S.F.	78.61 S.F.	7.60	%
REAR	825.50 S.F.	186.00 S.F.	22.53	%
* OPENINGS OMITTED AS PER SB-12 3.1.1.9(4) MAX 19.9 S.F. REFER TO ELEVATION FOR LOCATION		0 S.F.		
TOTAL SQ. FT.	3607.25 S.F.	456.06 S.F.	12.64	%
TOTAL SQ. M.	335.12 S.M.	42.37 S.M.	12.64	%

UNINSULATED OPENI	NGS (PER OB	C. SB-12,3.1.1	(7))
S38-15 EL.A WOB W/ 9' SECOND	ENERGY E	FFICIENCY - OF	BC SB12
ELEVATION	WALL AREA S.F.	OPENING S.F.	PERCENTAGE
FRONT	715.42 S.F.	108.34 S.F.	15.14 %
LEFT SIDE	1034.00 S.F.	44.17 S.F.	4.27 %
RIGHT SIDE	1034.00 S.F.	78.61 S.F.	7.60 %
REAR	918.10 S.F.	250.33 S.F.	27.27 %
* OPENINGS OMITTED AS PER SB-12 3.1.1.9(4) MAX 19.9 S.F. REFER TO ELEVATION FOR LOCATION		0 S.F.	
TOTAL SQ. FT.	3701.52 S.F.	481.45 S.F.	13.01 %
TOTAL SQ. M.	343.88 S.M.	44.73 S.M.	13.01 %

UNINSULATED OPENINGS (PER OBC. SB-12,3.1.1(7))			
S38-15 EL.B WOB W/ 9' SECOND	ENERGY E	FFICIENCY - OF	BC SB12
ELEVATION	WALL AREA S.F.	OPENING S.F.	PERCENTAGE
FRONT	714.32 S.F.	106.43 S.F.	14.90 %
LEFT SIDE	1034.00 S.F.	44.17 S.F.	4.27 %
RIGHT SIDE	1034.00 S.F.	78.61 S.F.	7.60 %
REAR	918.10 S.F.	250.33 S.F.	27.27 %
* OPENINGS OMITTED AS PER SB-12 3.1.1.9(4) MAX 19.9 S.F. REFER TO ELEVATION FOR LOCATION		0 S.F.	
TOTAL SQ. FT.	3700.42 S.F.	479.54 S.F.	12.96 %
TOTAL SQ. M.	343.78 S.M.	44.55 S.M.	12.96 %

UNINSULATED OPENINGS (PER OBC. SB-12,3.1.1(7))				
S38-15 EL.C WOB W/ 9' SECOND ENERGY EFFICIENCY - OBC				
ELEVATION	WALL AREA S.F.	OPENING S.F.	PERCENTA	AGE
FRONT	709.75 S.F.	134.06 S.F.	18.89	%
LEFT SIDE	1038.00 S.F.	57.39 S.F.	5.53	%
RIGHT SIDE	1034.00 S.F.	78.61 S.F.	7.60	%
REAR	918.10 S.F.	250.33 S.F.	27.27	%
* OPENINGS OMITTED AS PER SB-12 3.1.1.9(4) MAX 19.9 S.F. REFER TO ELEVATION FOR LOCATION		0 S.F.		
TOTAL SQ. FT.	3699.85 S.F.	520.39 S.F.	14.07	%
TOTAL SQ. M.	343.72 S.M.	48.35 S.M.	14.07	%

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he builder's complete responsibility to re that all plans submitted for approval comply with the Architectural Guidelines all applicable regulations and requirements in growing provisions and any provisions a subdivision agreement. The Control itect is not responsible in any way for ining or approving site (lotting) plans or ng drawings with respect to any zoning or ing code or permit matter or that any e can be properly built or located on its lot.	S38-15 BAROSSA 15	on toologo
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		70	à		project name	GREEN VALLET EASI	date	JAN. 2017	AJE	
			Y-57/		7			255 Consumers Rd Suite 120	416.630.2255 f 416.630.4782	
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								Contractor must verity all dimensions on the job and report any discrepancy to the Designer before proceeding with the work. All	_	
	<u> </u>			-	8–21 KL	8-21 RC		Contractor must verity all dimensions on the job and report any discrepancy to the Designer before proceeding with the work. All	_	
					MAY 28-21 KL	APR 08-21 RC	Ī		_	

PRELIMIANRY

UNINSULATED OPENI	NGS (PER OB	C. SB-12,3.1.1	(7))
S38-15 EL.A WOB W/9' BSMT+8' 2ND	ENERGY E	FFICIENCY - OF	BC SB12
ELEVATION	WALL AREA S.F.	OPENING S.F.	PERCENTAGE
FRONT	683.67 S.F.	108.34 S.F.	15.85 %
LEFT SIDE	987.00 S.F.	44.17 S.F.	4.48 %
RIGHT SIDE	987.00 S.F.	78.61 S.F.	7.96 %
REAR	933.98 S.F.	250.33 S.F.	26.80 %
* OPENINGS OMITTED AS PER SB-12 3.1.1.9(4) MAX 19.9 S.F. REFER TO ELEVATION FOR LOCATION		0 S.F.	
TOTAL SQ. FT.	3591.65 S.F.	481.45 S.F.	13.40 %
TOTAL SQ. M.	333.67 S.M.	44.73 S.M.	13.40 %

UNINSULATED OPENINGS (PER OBC. SB-12,3.1.1(7))				
S38-15 EL.B WOB W/9' BSMT+8' 2ND	ENERGY E	FFICIENCY - OF	C SB12	
ELEVATION	WALL AREA S.F.	OPENING S.F.	PERCENTA	AGE
FRONT	682.57 S.F.	106.43 S.F.	15.59	%
LEFT SIDE	987.00 S.F.	44.17 S.F.	4.48	%
RIGHT SIDE	987.00 S.F.	78.61 S.F.	7.96	%
REAR	933.98 S.F.	250.33 S.F.	26.80	%
* OPENINGS OMITTED AS PER SB-12 3.1.1.9(4) MAX 19.9 S.F. REFER TO ELEVATION FOR LOCATION		0 S.F.		
TOTAL SQ. FT.	3590.55 S.F.	479.54 S.F.	13.36	%
TOTAL SQ. M.	333.57 S.M.	44.55 S.M.	13.36	%

LININSHI ATED OPENI	NGS (PER OR	C SR_12 3 1 1	(7))	
UNINSULATED OPENINGS (PER OBC. SB-12,3.1.1(7))				
S38-15 EL.C WOB W/9' BSMT+8' 2ND		FFICIENCY - OF		
ELEVATION	WALL AREA S.F.	OPENING S.F.	PERCENT	AGE
FRONT	678.00 S.F.	134.06 S.F.	19.77	%
LEFT SIDE	991.00 S.F.	57.39 S.F.	5.79	%
RIGHT SIDE	987.00 S.F.	78.61 S.F.	7.96	%
REAR	933.98 S.F.	250.33 S.F.	26.80	%
* OPENINGS OMITTED AS PER SB-12 3.1.1.9(4) MAX 19.9 S.F. REFER TO ELEVATION FOR LOCATION		0 S.F.		
TOTAL SQ. FT.	3589.98 S.F.	520.39 S.F.	14.50	%
TOTAL SQ. M.	333.52 S.M.	48.35 S.M.	14.50	%

UNINSULATED OPENI	NGS (PER OB	C. SB-12,3.1.1	(7))	
S38-15 EL.A WOB W/ 9' BSMT+2ND	ENERGY E	FFICIENCY - OF	3C SB12	
ELEVATION	WALL AREA S.F.	OPENING S.F.	PERCENT.	AGE
FRONT	715.42 S.F.	108.34 S.F.	15.14	%
LEFT SIDE	1034.00 S.F.	44.17 S.F.	4.27	%
RIGHT SIDE	1034.00 S.F.	78.61 S.F.	7.60	%
REAR	965.73 S.F.	250.33 S.F.	25.92	%
* OPENINGS OMITTED AS PER SB-12 3.1.1.9(4) MAX 19.9 S.F. REFER TO ELEVATION FOR LOCATION		0 S.F.		
TOTAL SQ. FT.	3749.15 S.F.	481.45 S.F.	12.84	%
TOTAL SQ. M.	348.30 S.M.	44.73 S.M.	12.84	%

UNINSULATED OPENINGS (PER OBC. SB-12,3.1.1(7))							
S38-15 EL.B WOB W/ 9' BSMT+2ND ENERGY EFFICIENCY - OBC SE							
ELEVATION	WALL AREA S.F.	OPENING S.F.	PERCENTA	AGE			
FRONT	714.32 S.F.	106.43 S.F.	14.90	%			
LEFT SIDE	1034.00 S.F.	44.17 S.F.	4.27	%			
RIGHT SIDE	1034.00 S.F.	78.61 S.F.	7.60	%			
REAR	965.73 S.F.	250.33 S.F.	25.92	%			
* OPENINGS OMITTED AS PER SB-12 3.1.1.9(4) MAX 19.9 S.F. REFER TO ELEVATION FOR LOCATION		0 S.F.					
TOTAL SQ. FT.	3748.05 S.F.	479.54 S.F.	12.79	%			
TOTAL SQ. M.	348.20 S.M.	44.55 S.M.	12.79	%			

UNINSULATED OPENINGS (PER OBC. SB-12,3.1.1(7))							
S38-15 EL.C WOB W/ 9' BSMT+2ND	ENERGY EFFICIENCY - OBC SB12						
ELEVATION	WALL AREA S.F.	OPENING S.F.	PERCENTAGE				
FRONT	709.75 S.F.	134.06 S.F.	18.89 %				
LEFT SIDE	1038.00 S.F.	57.39 S.F.	5.53 %				
RIGHT SIDE	1034.00 S.F.	78.61 S.F.	7.60 %				
REAR	965.73 S.F.	250.33 S.F.	25.92 %				
* OPENINGS OMITTED AS PER SB-12 3.1.1.9(4) MAX 19.9 S.F. REFER TO ELEVATION FOR LOCATION		0 S.F.					
TOTAL SQ. FT.	3747.48 S.F.	520.39 S.F.	13.89 %				
TOTAL SQ. M.	348.15 S.M.	48.35 S.M.	13.89 %				

It is the builder's complete responsibility to ensure that all plans submitted for approval fully comply with the Architectural Guidelines and all applicable regulations and requirements including zoning provisions and any provisions in the subdivision agreement. The Control Architect is not responsible in any way for examining or approving site (lotting) plans or working drawings with respect to any zoning or building code or permit matter or that any house can be properly built or located on its lot.

This is to certify that these plans comply with the applicable Architectural Design Guidelines approved by the Town of BRADFORD / WEST GWILLIMBURY.

mply sign n of		SSS DAYNITH WELLINGTON				DEOLD GREEN VALLET EASI BRADFURD, UN	The state of the s	Zoo Consumers Rd Suite 120 Jan. 2017 Toronto ON M21 184 drawn by	t 416.630.2255 f 416.630.4782 AJE - 3/16" = 1'-0" 16023-538-15-	"" vd3design.com RICHARD − H:\ARCHIVE\WORKINC\2016\16023.BW\Units\38\\16023-538−15−10GRND.dwg − Tue − Jun 22 2021 − 11:5	III donuinae enacificatione ratetad documante and design are the consciote reconstruct of UA3 DECIDA Description of this enemants in whole or in and is etricitle authbout UA
								JAN 16-18 RC discrepancy to the Designer before proceeding with the work. All	31-01-17 AJE drawings and specifications are instruments of service and the property	Drawings are not to be s	IV.
				•	MAY 28-21 KL	APR 08-21 RC	APR 06-21 RC	16-18 RC	.01-17 AJE	date by	
	. 6	. 8	7 .	. 9	5 10' GROUND FLOOR MAY	4 REVISED AS PER ENG COMMENTS APR	3 ADD OPT. 9' BASEMENT APR	2 REVISED AS PER ENG'S COMMENTS JAN	1 NMPORTED FROM 13045 TO 16023	no. description	

drawing no.

10° GROUND