


PARTIAL BASEMENT PLAN W/ SUNKEN LAUNDRY 1R CONDITION

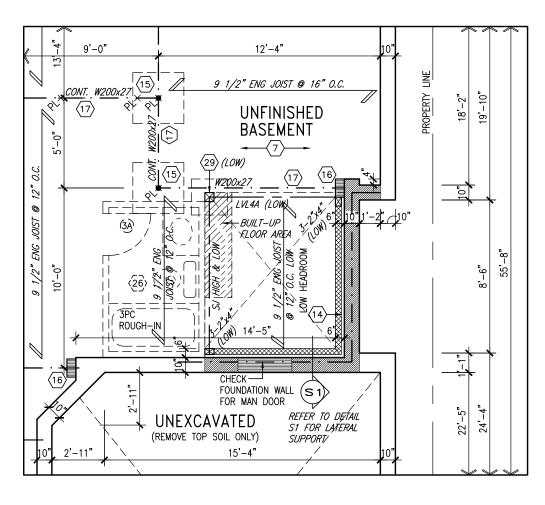

PARTIAL BASEMENT PLAN W/ SUNKEN LAUNDRY 2R-3R CONDITION

ARI	AREA CALCULATIONS					
	ELEV. A	ELEV. B	ELEV. C			
GROUND FLOOR AREA	1151.8 SF	1145.9 SF	1151.8 SF			
SECOND FLOOR AREA	1440.6 SF	1462.6 SF	1425.9 SF			
SUBTOTAL	2592.5 SF	2608.6 SF	2577.7 SF			
DEDUCT ALL OPENINGS	48.7 SF	44.4 SF	48.7 SF			
TOTAL NET AREA	2544 SF	2564 SF	2529 SF			
	236.3 m2	238.2 m2	234.9 m2			
FINISHED BSMT AREA	0 SF	0 SF	0 SF			
TOTAL NET AREA	2544 SF	2564 SF	2529 SF			
W/ FIN BSMT	236.3 m2	238.2 m2	234.9 m2			
COVERAGE W/O PORCH	1601.7 SF	1596.4 SF	1601.7 SF			
	148.8 m2	148.3 m2	148.8 m2			
COVERAGE W/PORCH	1661.8 SF	1655.7 SF	1661.8 SF			
·	154.4 m2	153 <u>.</u> 8 m2	154.4 m2			

NOTE: REFER TO STANDARD FLOOR PLANS FOR ADDITONAL INFORMATION.

<u>NOTE:</u> ALL LVL'S SUPPORTING FLOOR LOADS ARE TO BE SPECIFIED BY FLOOR TRUSS MANUFACTURER.

NOTE: FLOOR FRAMING INFO REFER TO SHOP DRAWINGS FOR ALL TRUSS-JOIST INFORMATION AND DETAILS. UNLESS OTHERWISE NOTED.

<u>NOTE J1:</u> PROVIDE SOLID BLOCKING @ 24" O.C. WHERE FLOOR JOISTS ARE PARALLEL TO FOUNDATION WALL (TYP.)

It is the builder's complete responsibility to ensure that all plans submitted for approval fully comply with the Architectural Guidelines and all applicable regulations and requirements including zoning provisions and any provisions in the subdivision agreement. The Control Architect is not responsible in any way for examining or approving site (lotting) plans or working drawings with respect to any zoning or building code or permit matter or that any house can be properly built or located on its lot.

This is to certify that these plans comply with the applicable Architectural Design Guidelines approved by the Town of BRADFORD / WEST GWILLIMBURY.

	154.4	m2 1	53.	<u>8 m2 154.4 m2 </u>	
	10' GROUND FLOOR	MAY 10-21	RC		
	REVISED AS PER ENG COMMENTS	APR 08-21	RC		
	ADD OPT. 9' BASEMENT	APR 06-21	RC :		•
	REVISED AS PER ENG'S COMMENTS	JAN 05-18	RC	Contractor must verify all dimensions on the job and report any discrepancy to the Designer before proceeding with the work. All	
	ISSUED FOR CLIENT REVIEW			drawings and specifications are instruments of service and the property of the Designer which must be returned at the completion of the work.	
	description	date	by	Drawings are not to be scaled.	
•					d

255 Consumers Rd Suite 120 Toronto ON M2J 1R4 t 416.630.2255 f 416.630.4782 va3design.com

BFARING.

NOTE: SPACE ALL FLOOR

JOISTS @ 12" O.C. UNDER ALL CERAMIC TILE AREAS.

BASEMENT INSULATION AT

-2" (R10) CONTINUOUS INSULATION

-2"x4" @ 16"o.c. w/ R12 BATT INSULATION & 1/2" DRYWALL FINISH -EXTEND EXTERIOR WALL FOOTING TO

SUPPORT 2"x4" WALL WHERE LOAD

STAIR/SUNKEN AREAS

(RIGID or SPRAY FOAM).


BAYVIEW W	ELLINGTON
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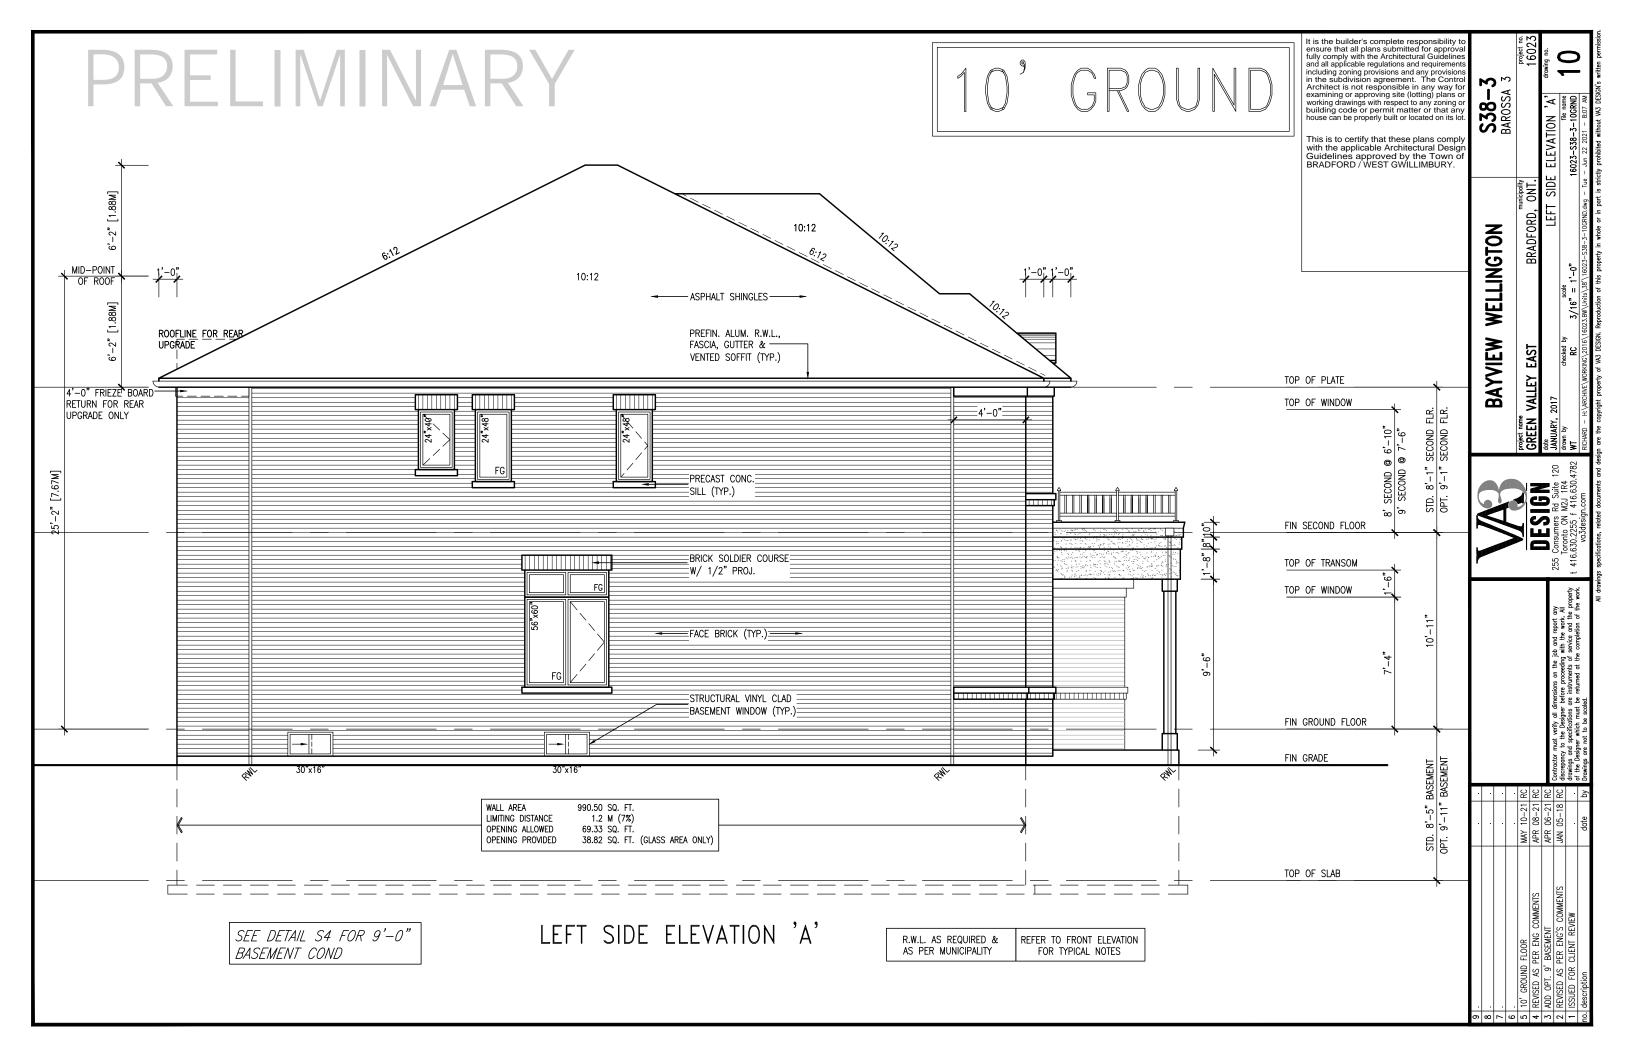
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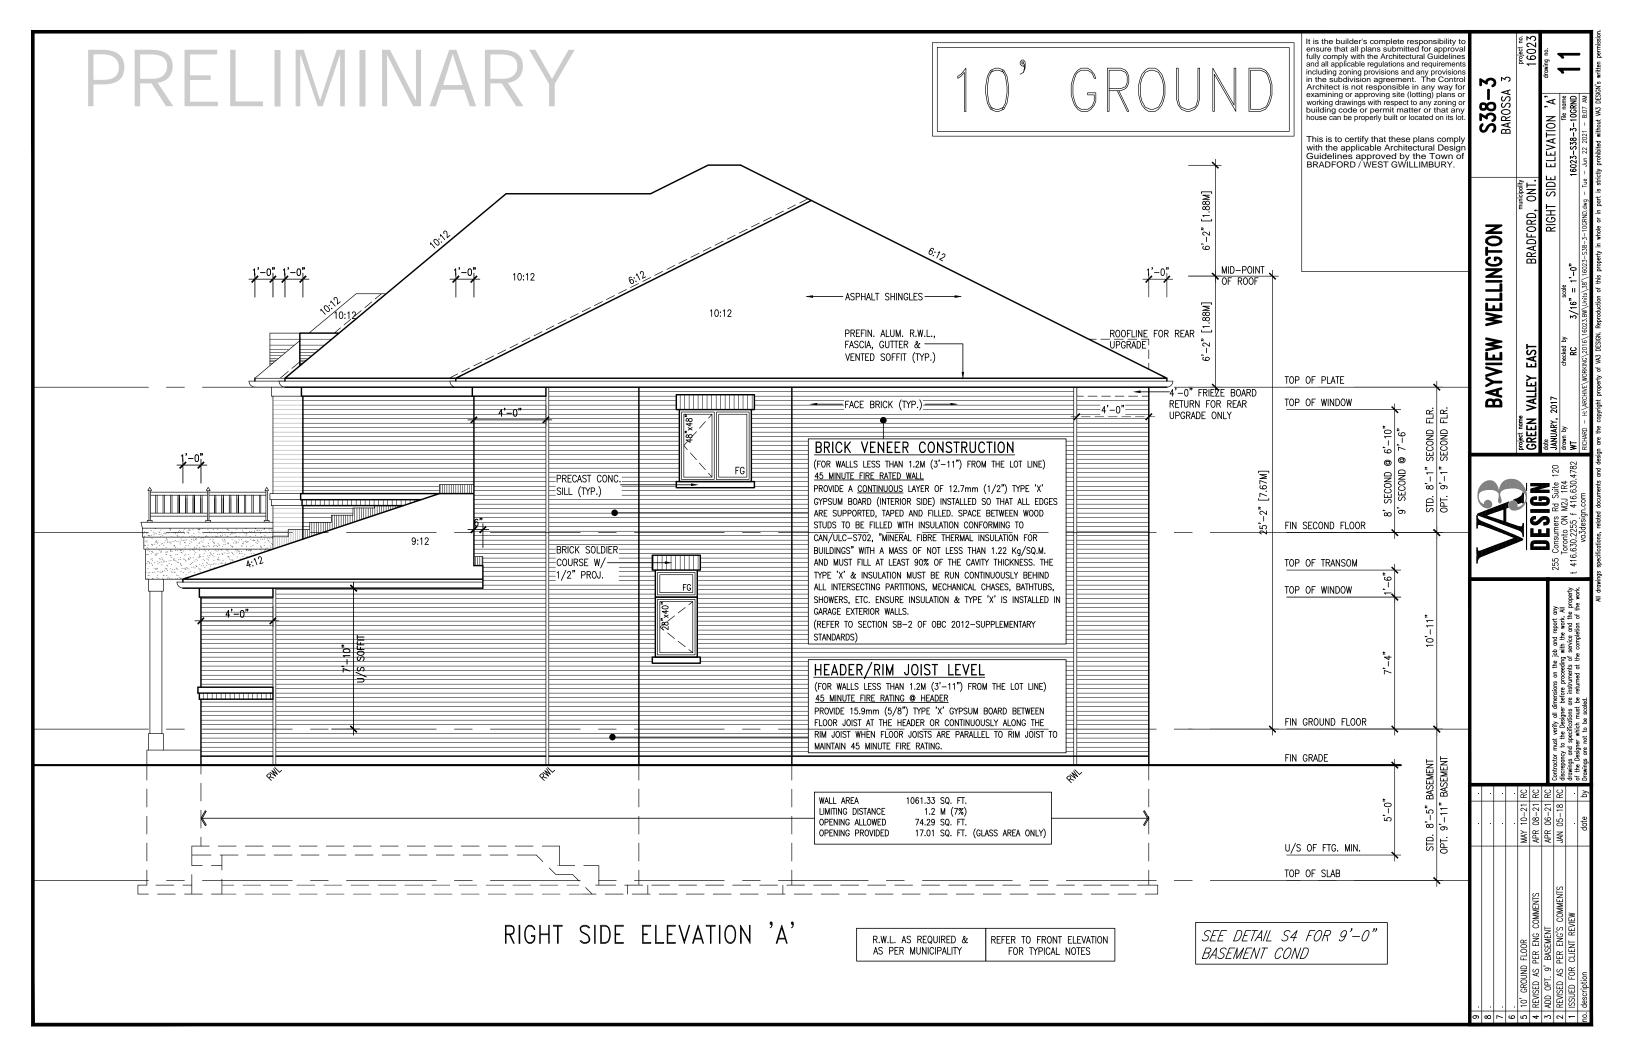
GREEN VALLEY EAST BRADFORD, ONT ^{date} JANUARY, 2017 PART. BASEMENT PLAN W/ SUNKEN LUNDRY 16023-S38-3-10GRND 3/16" = 1'-0"


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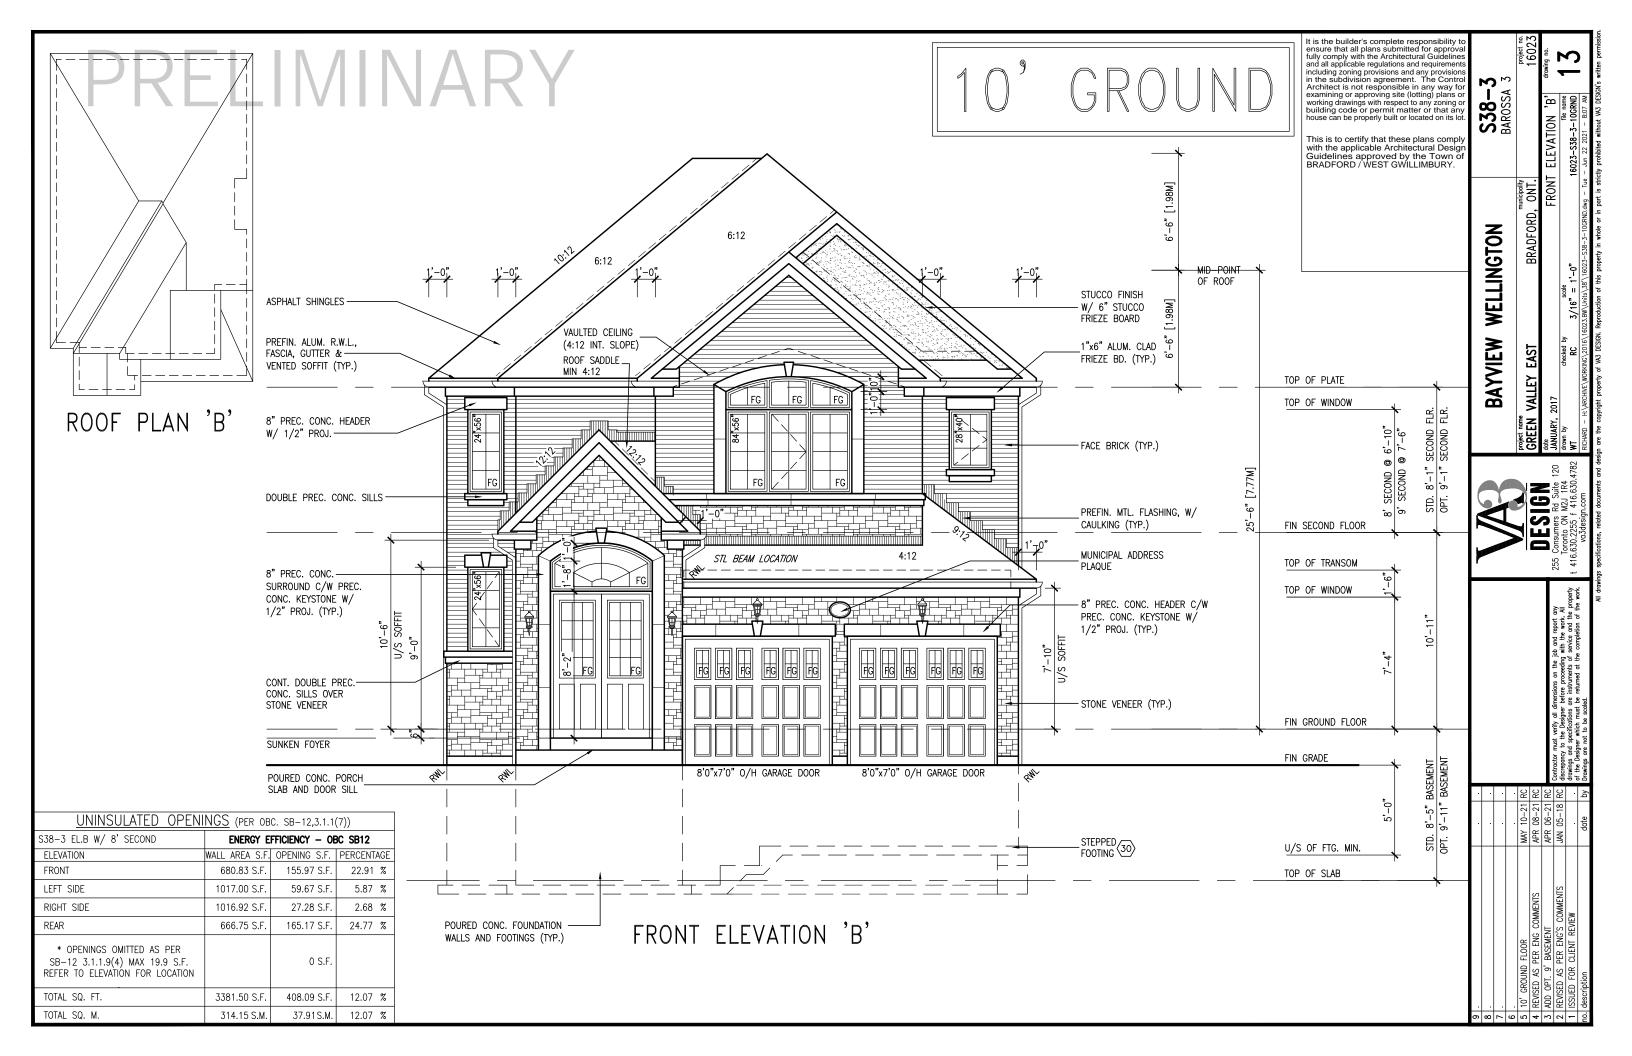
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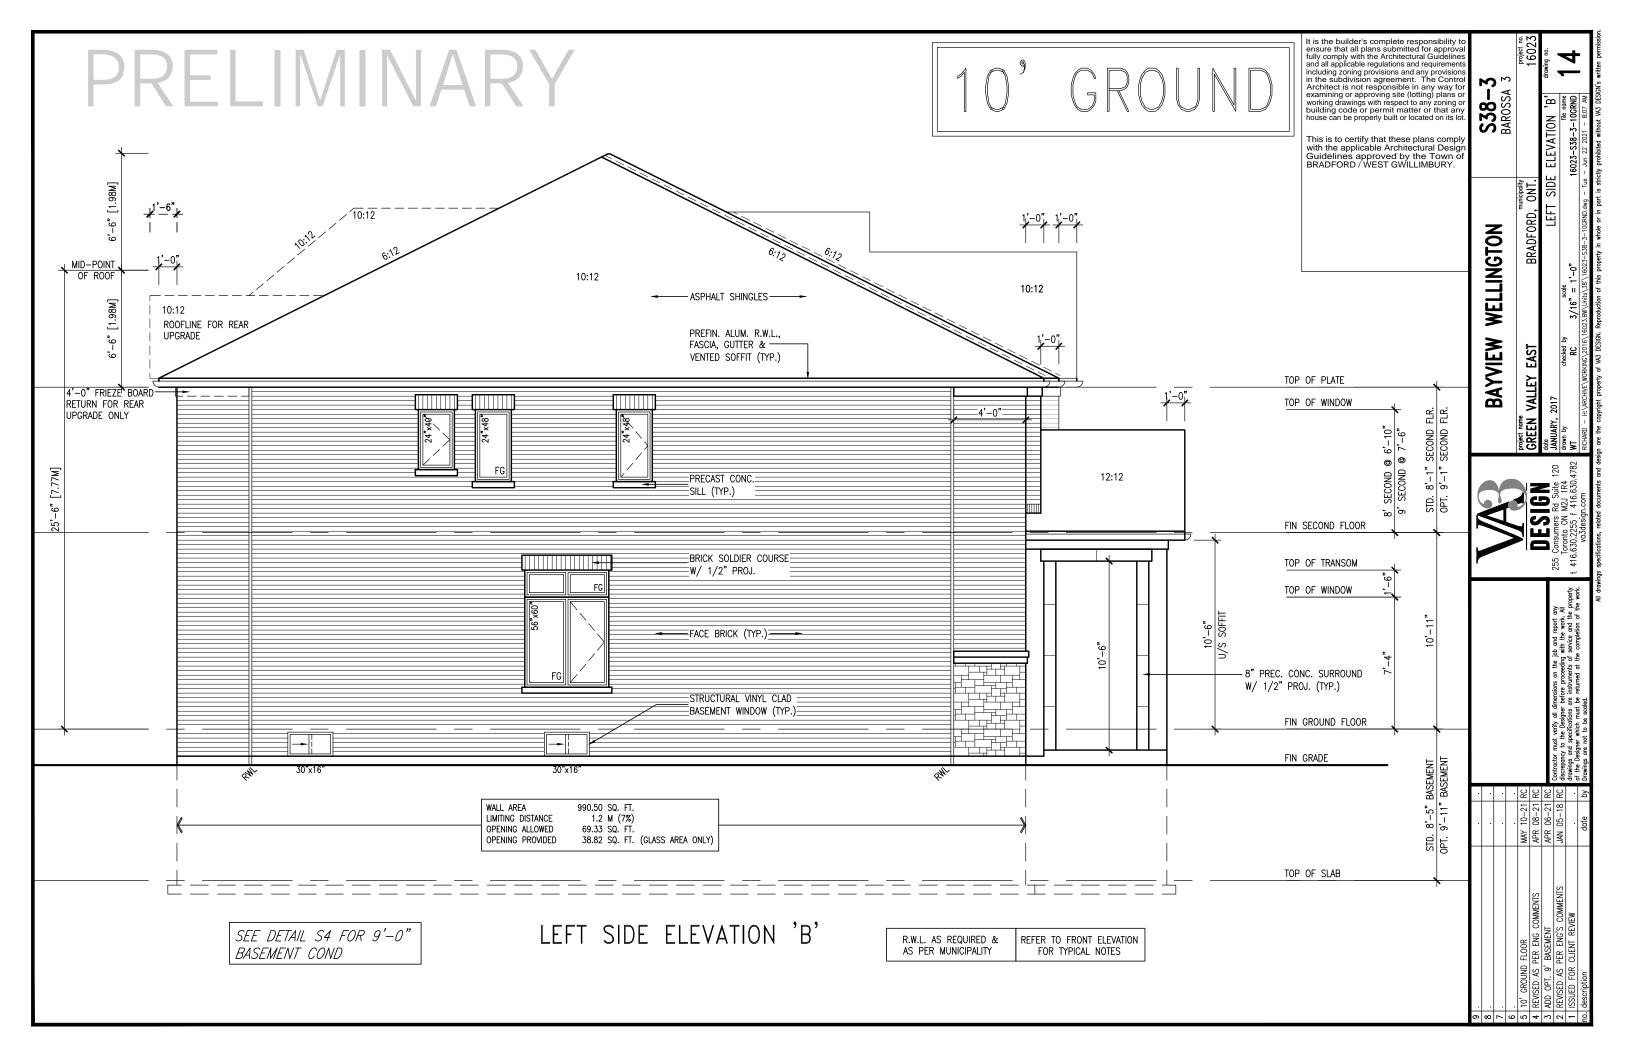











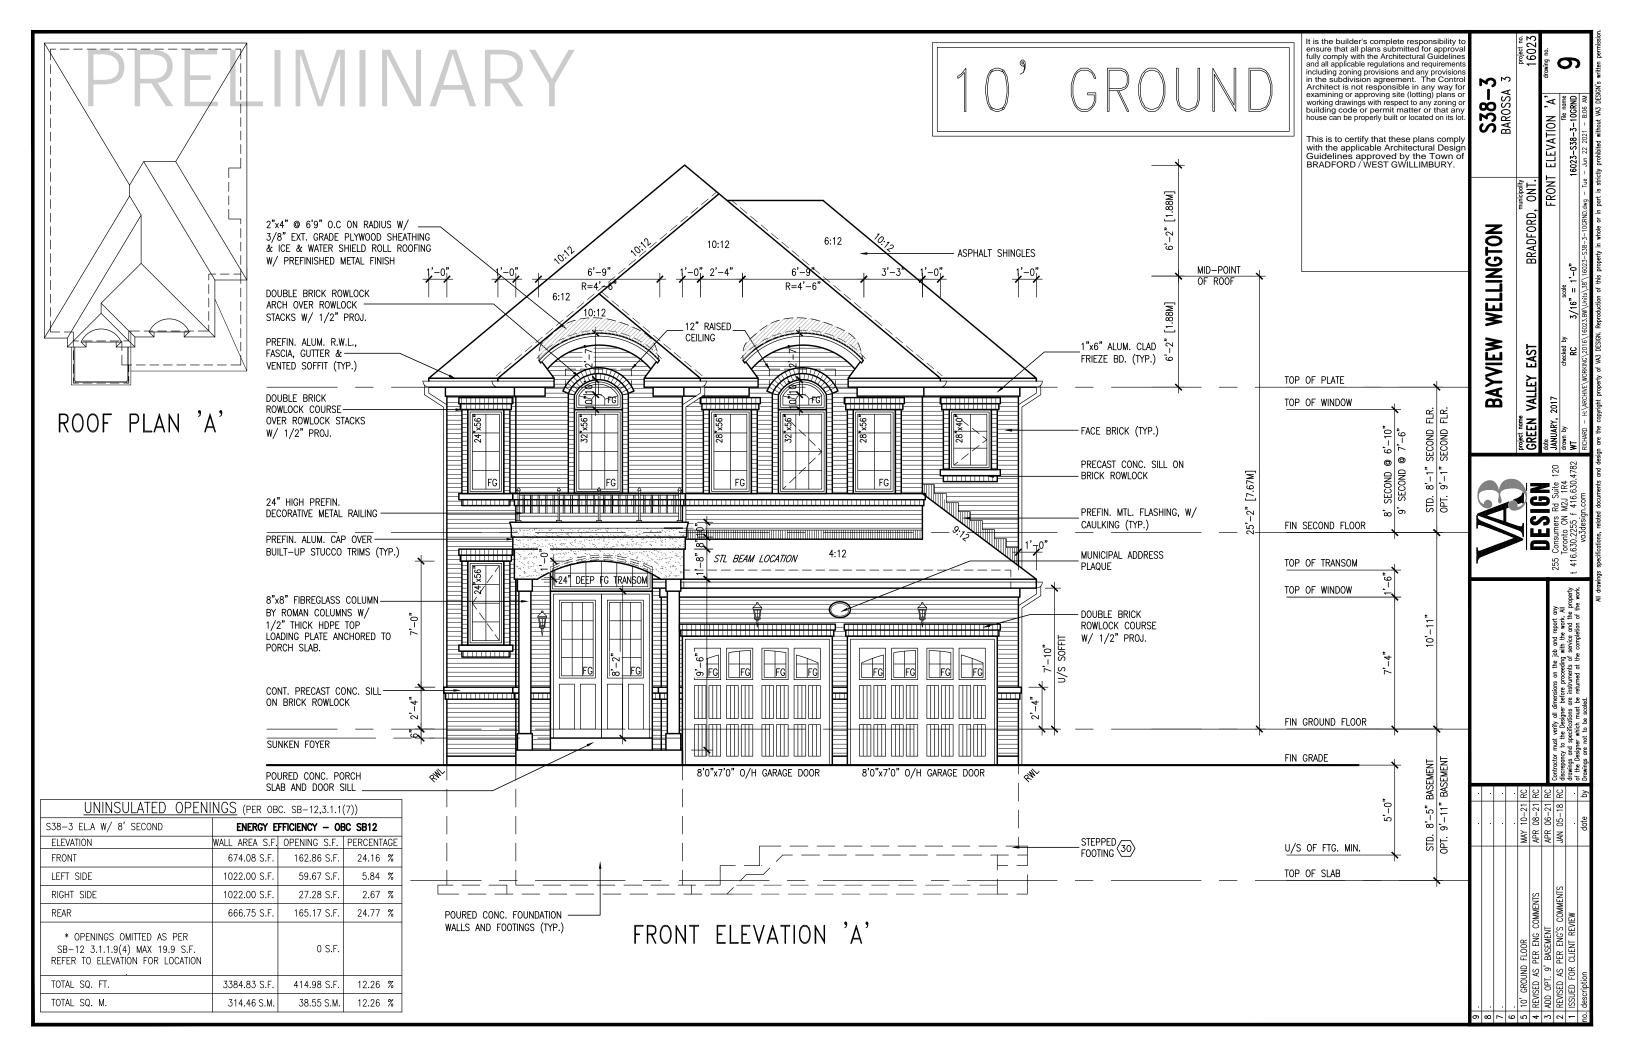


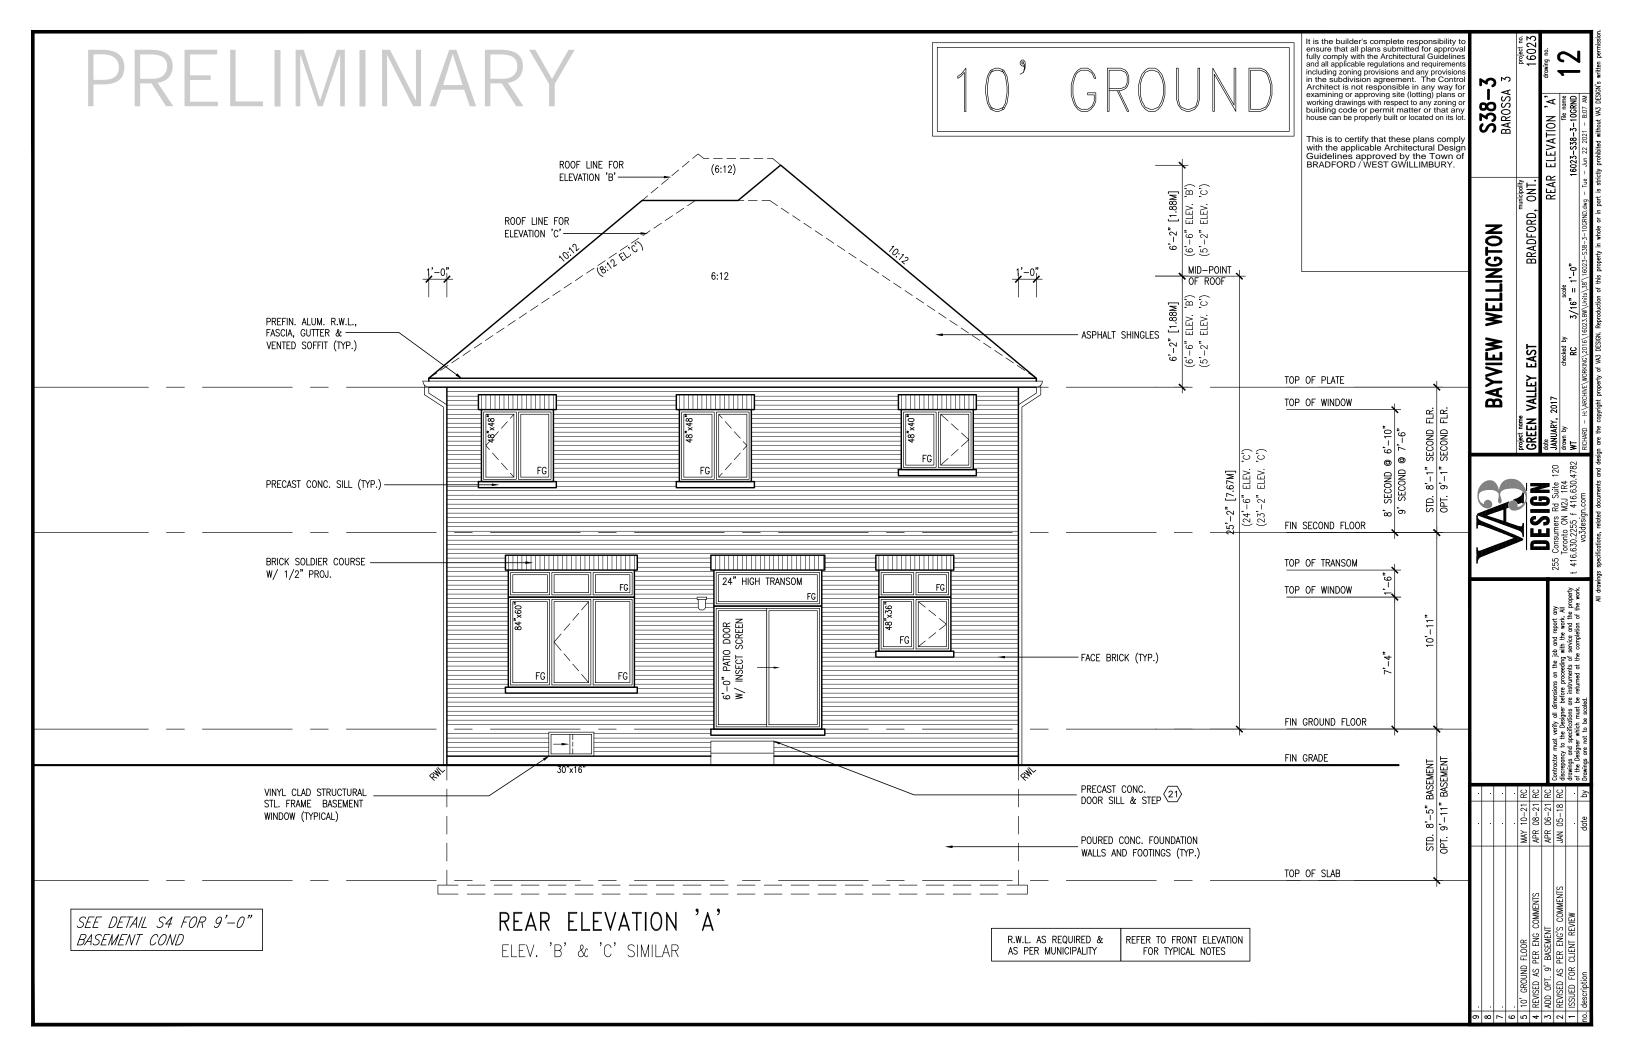


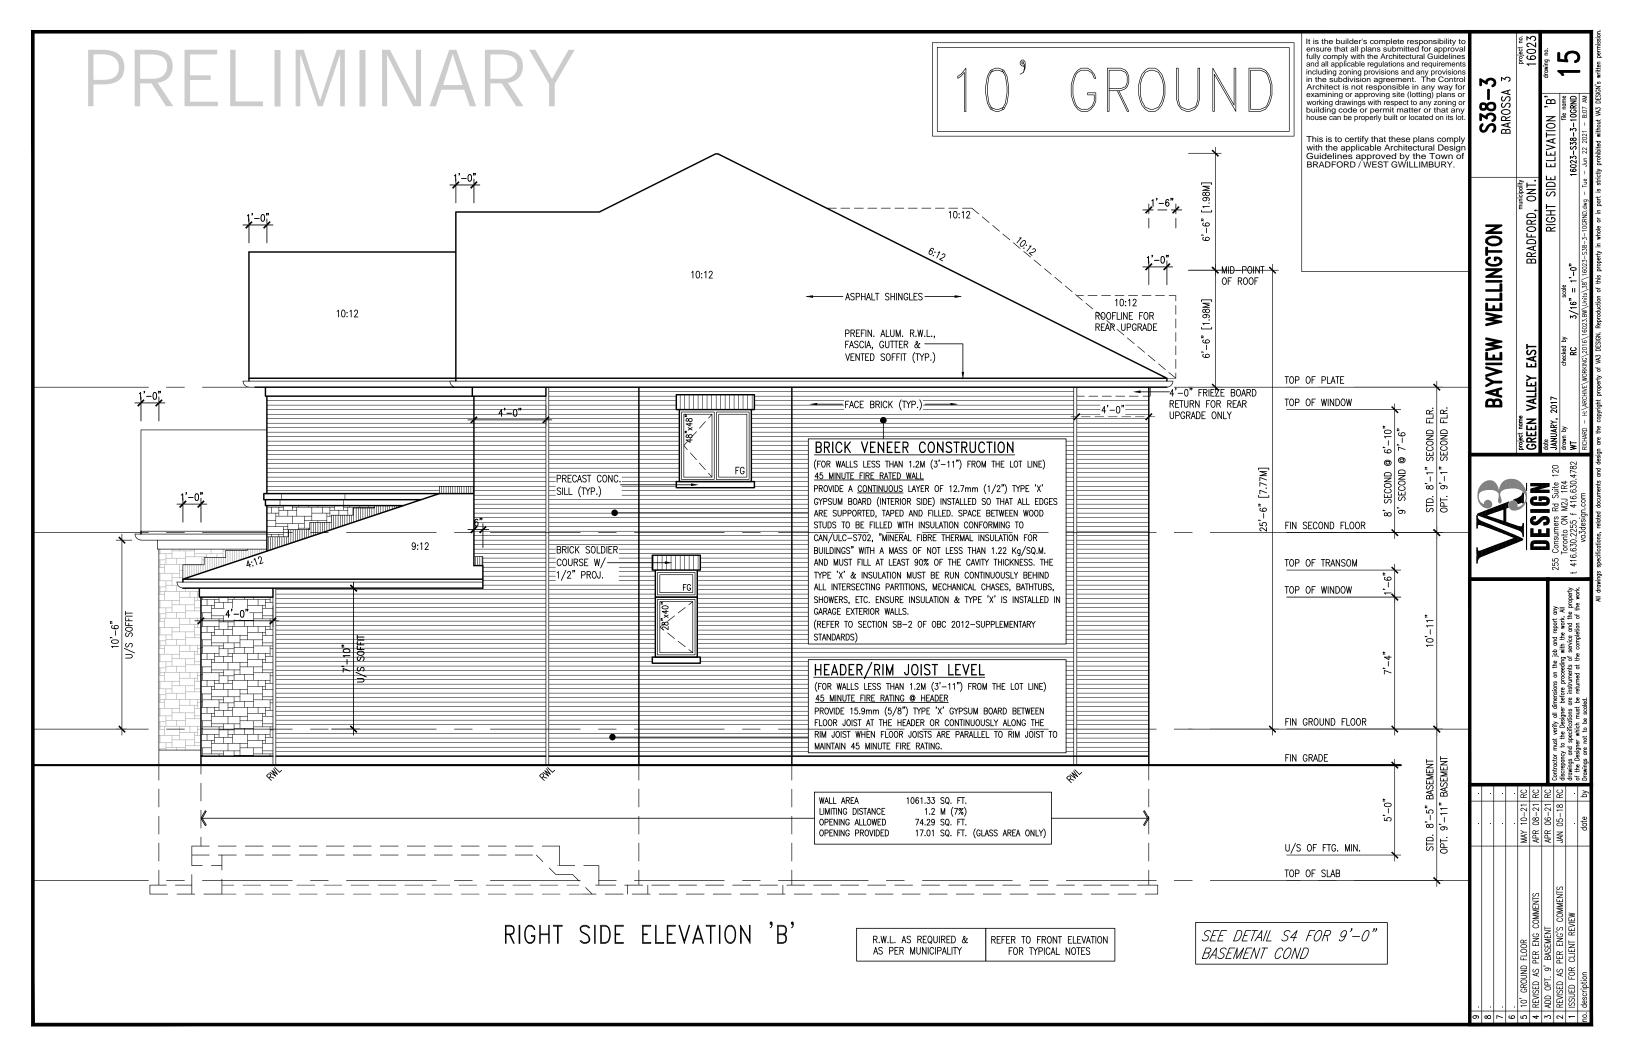


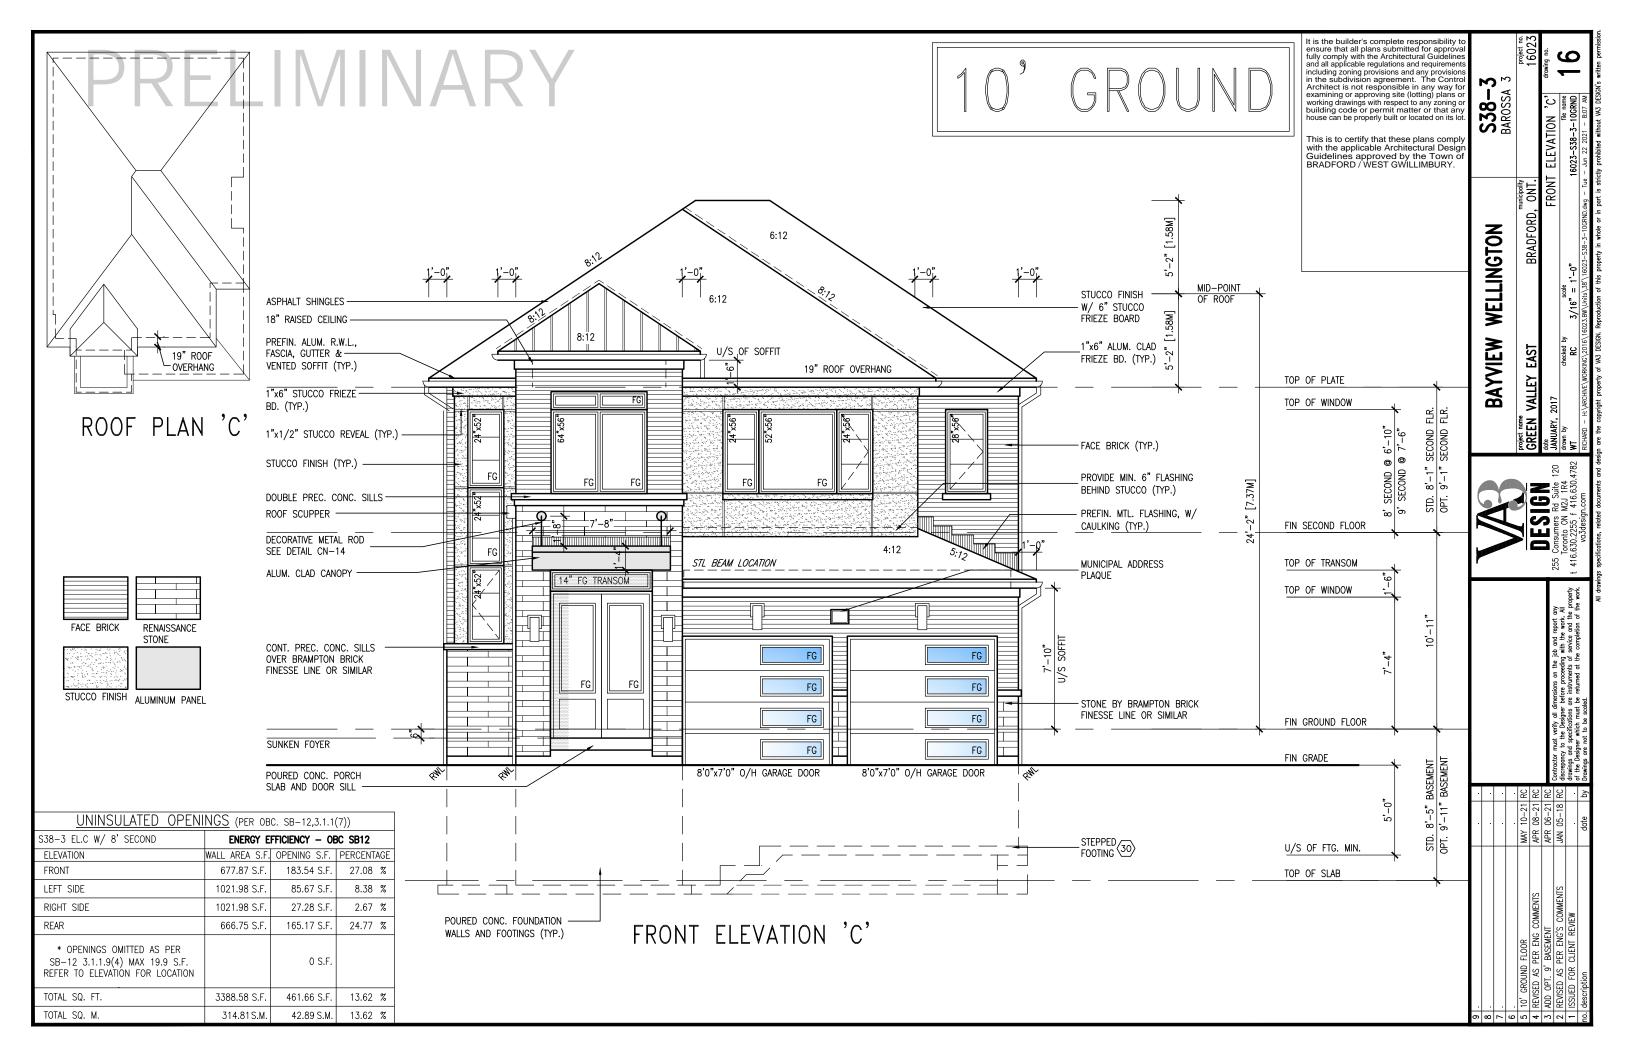


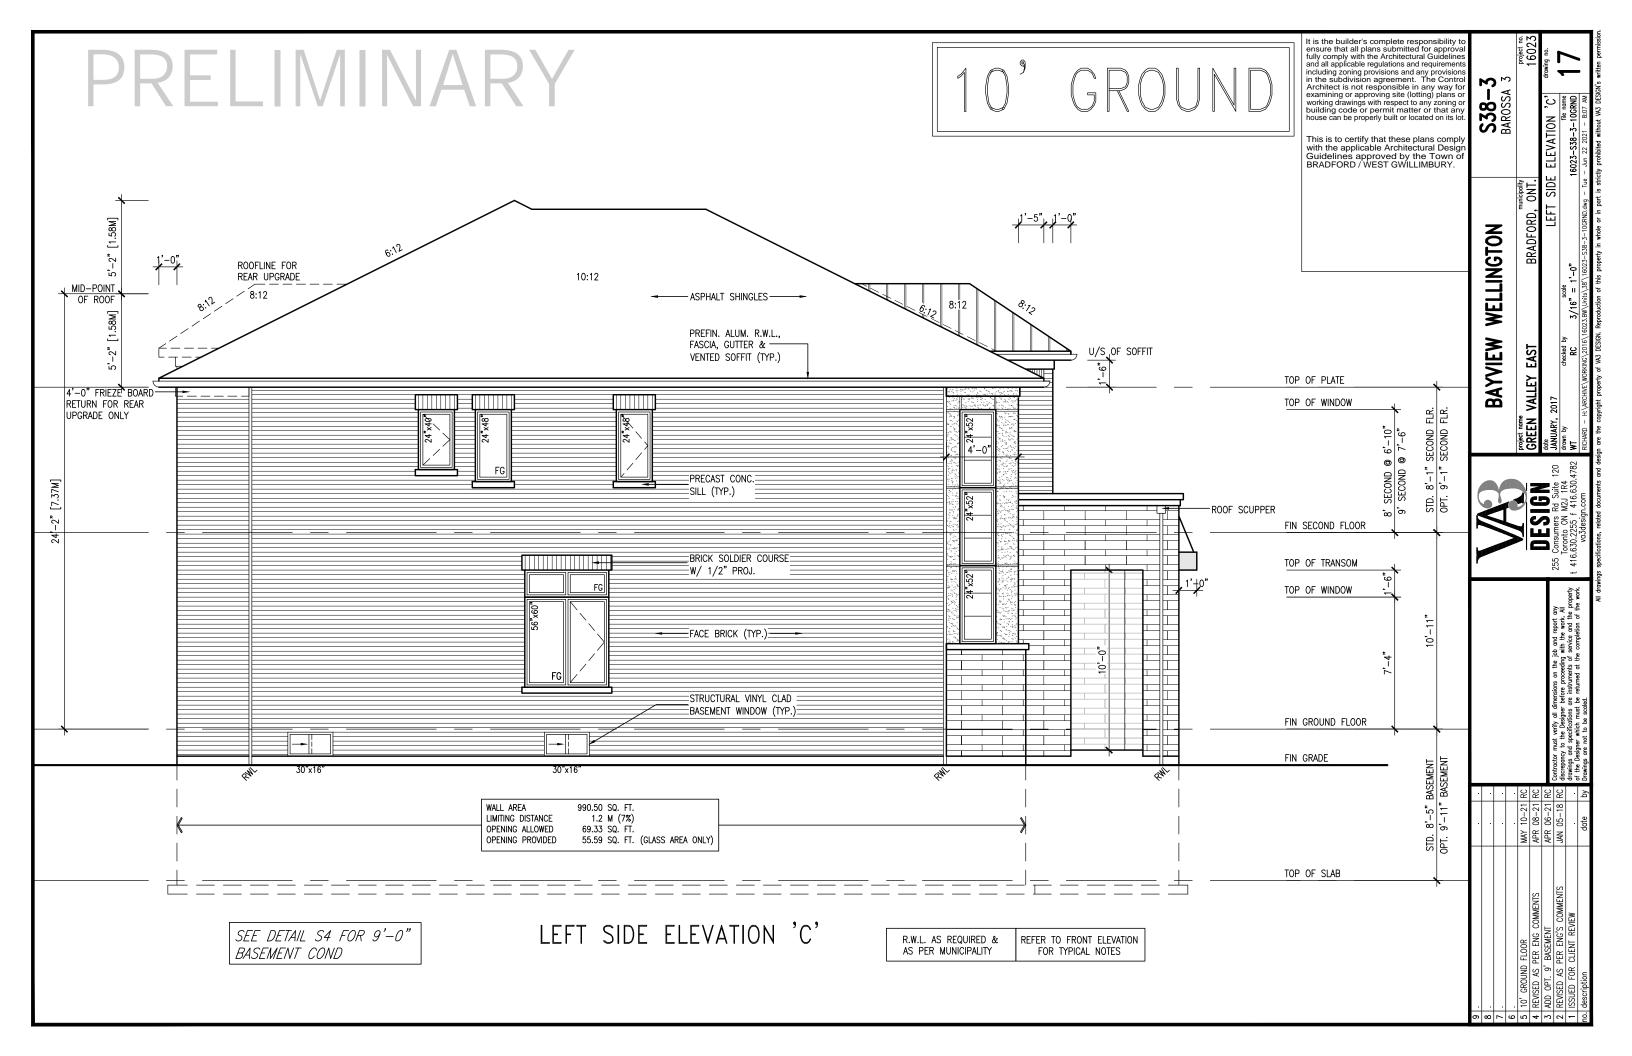


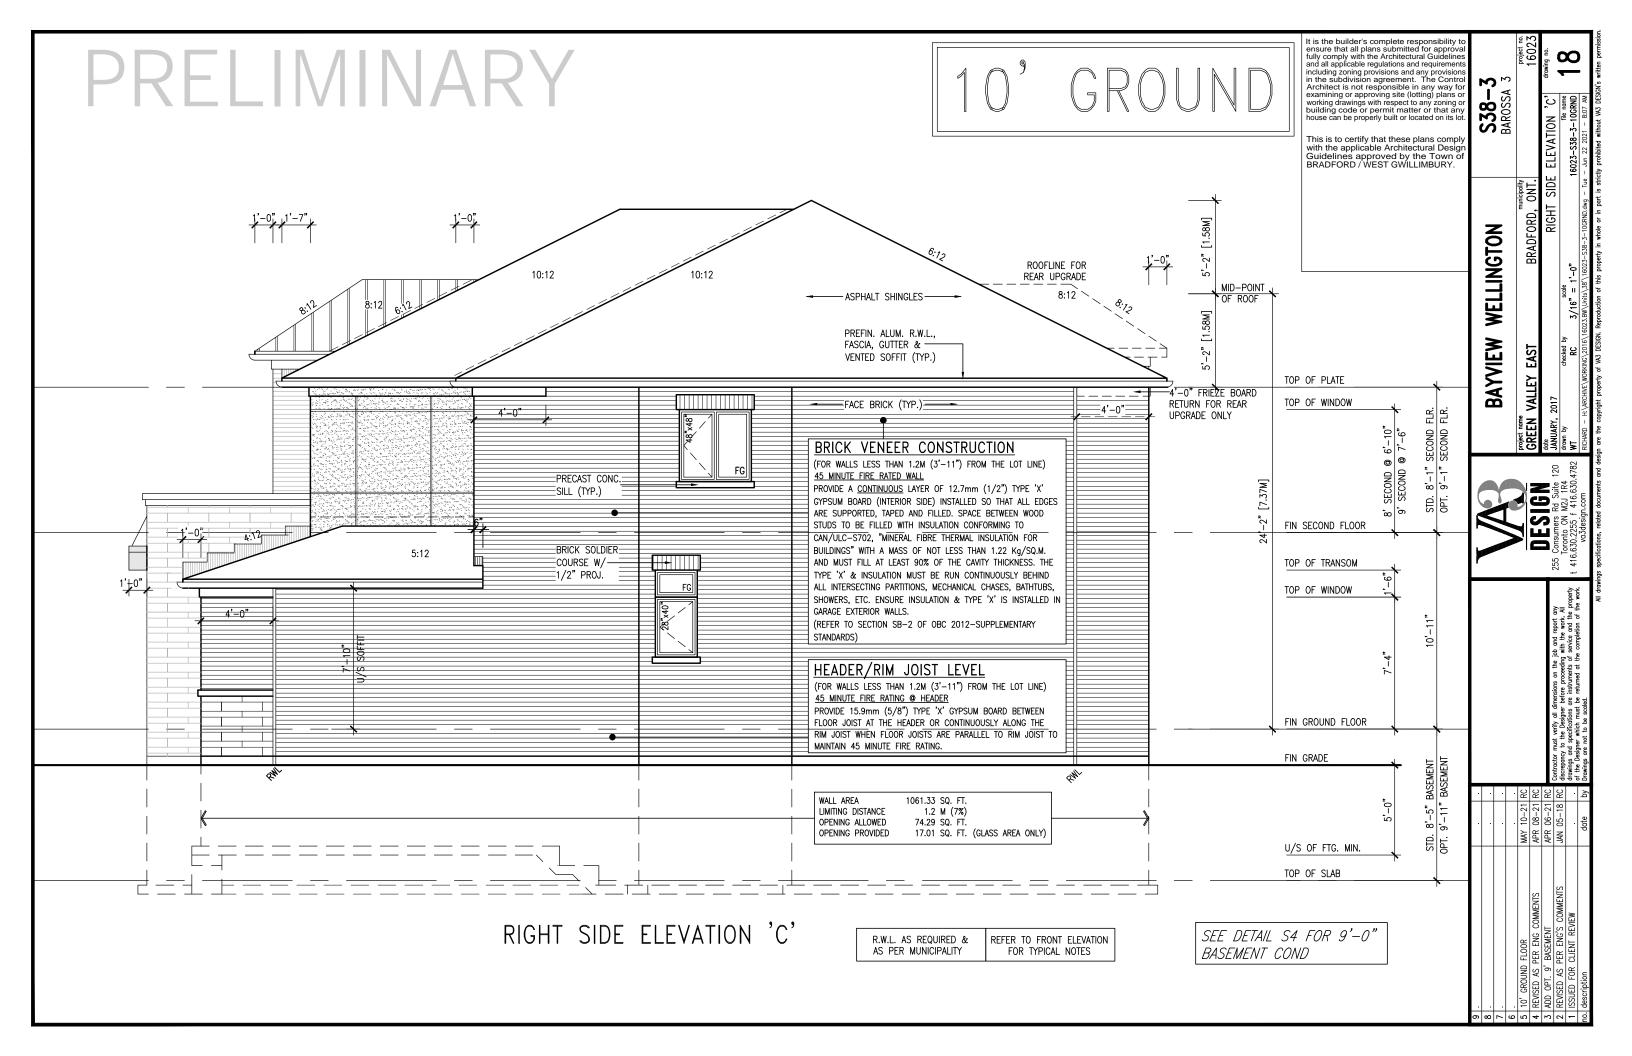


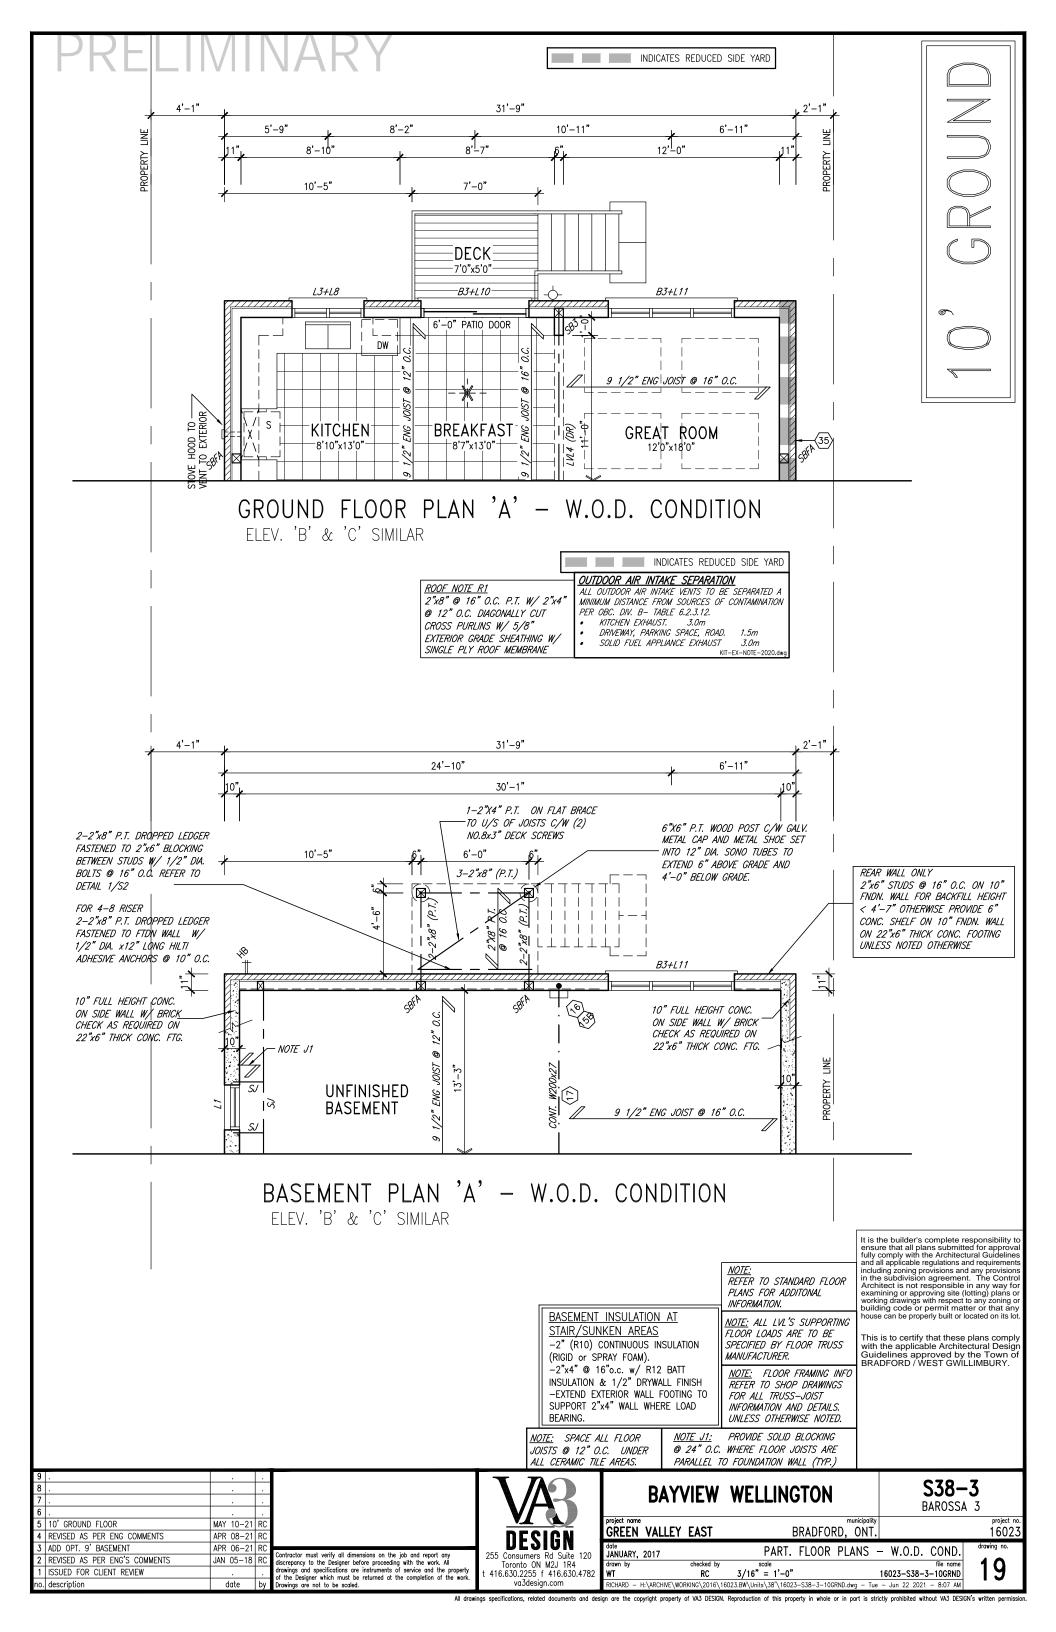


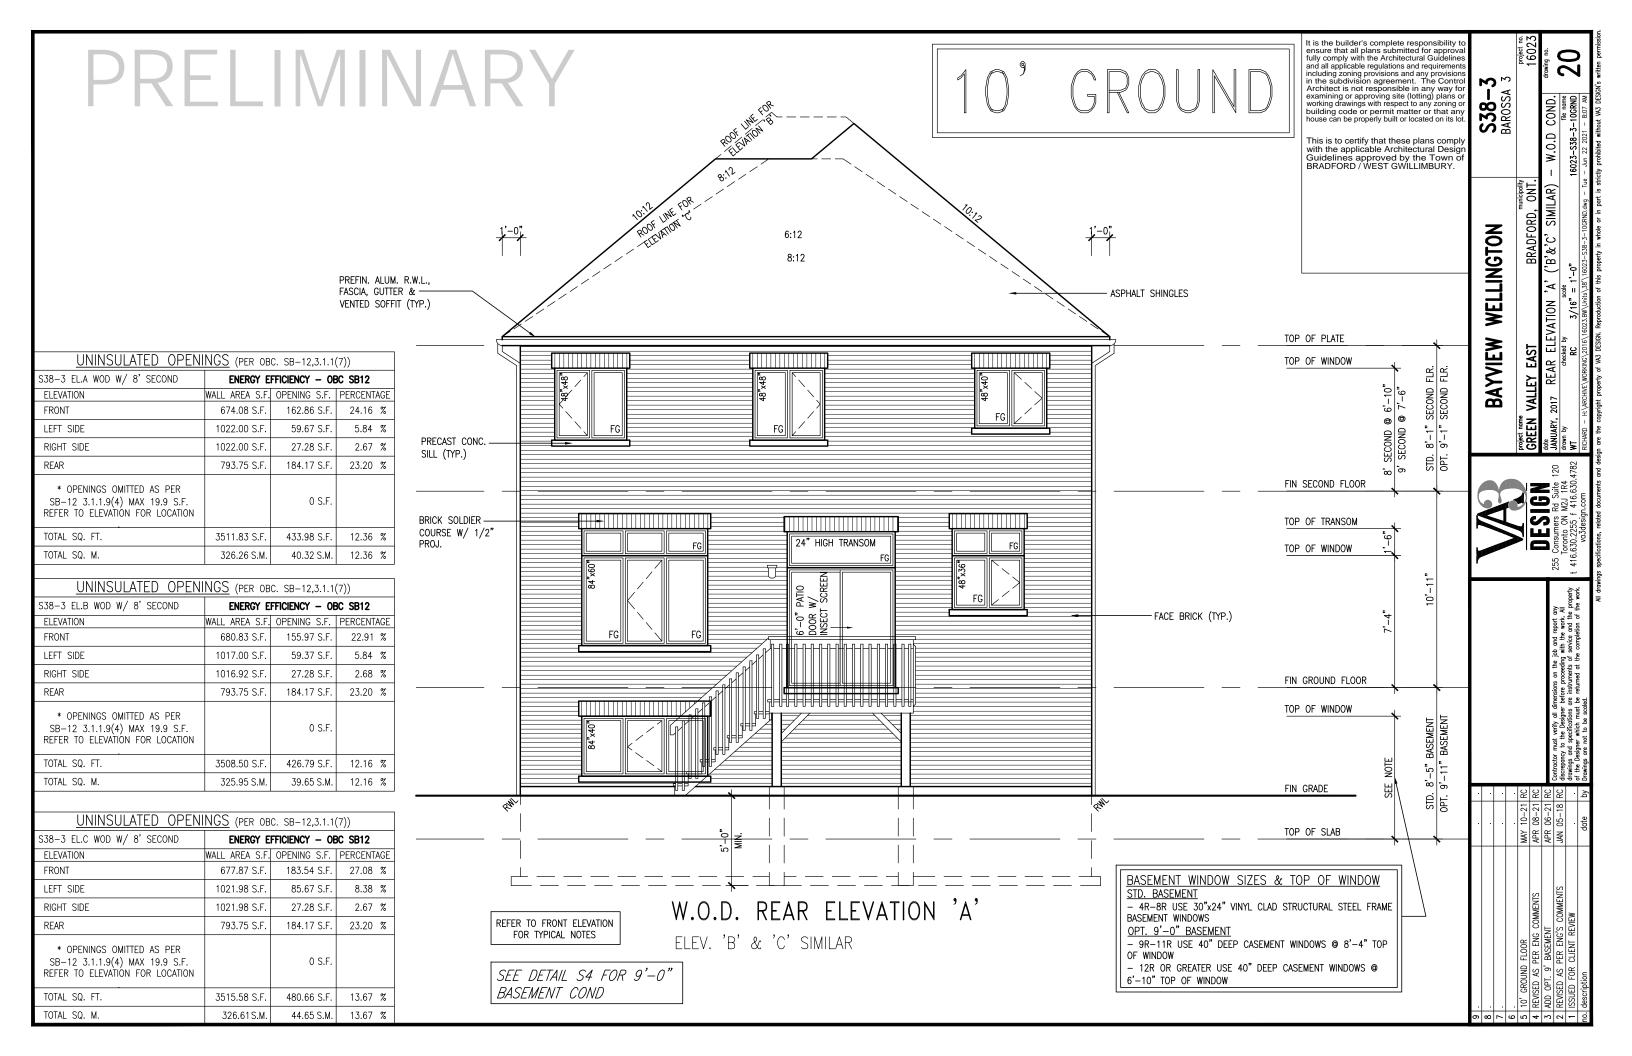


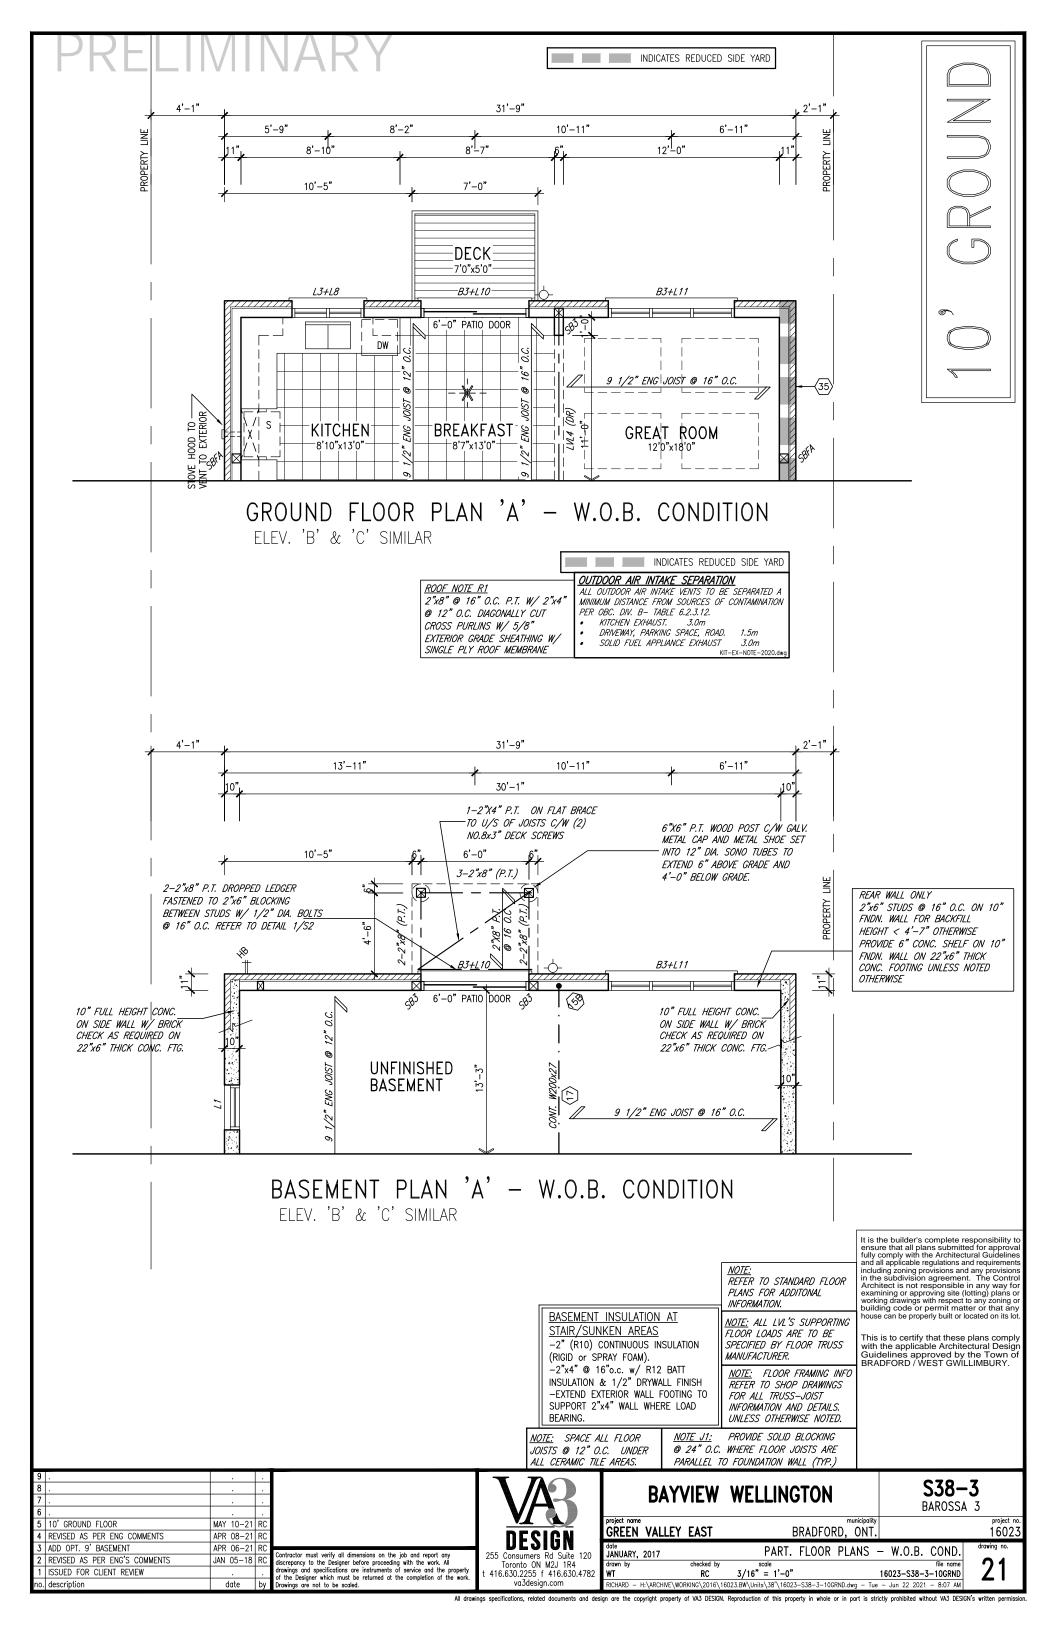


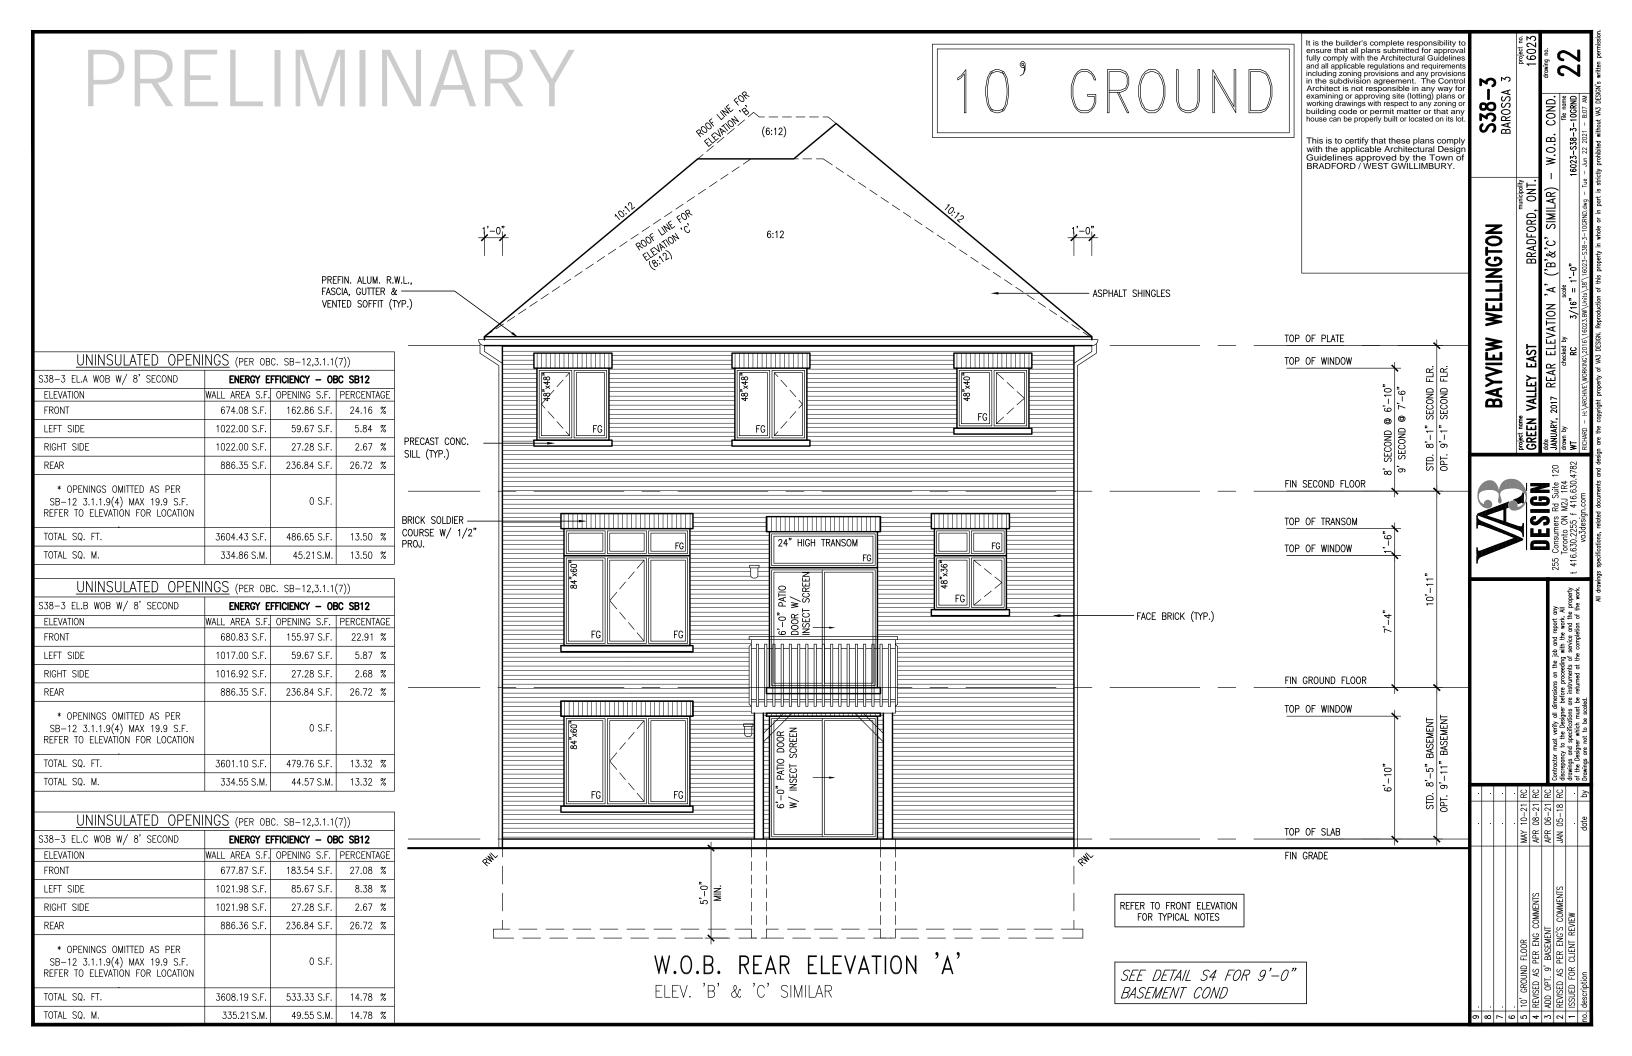


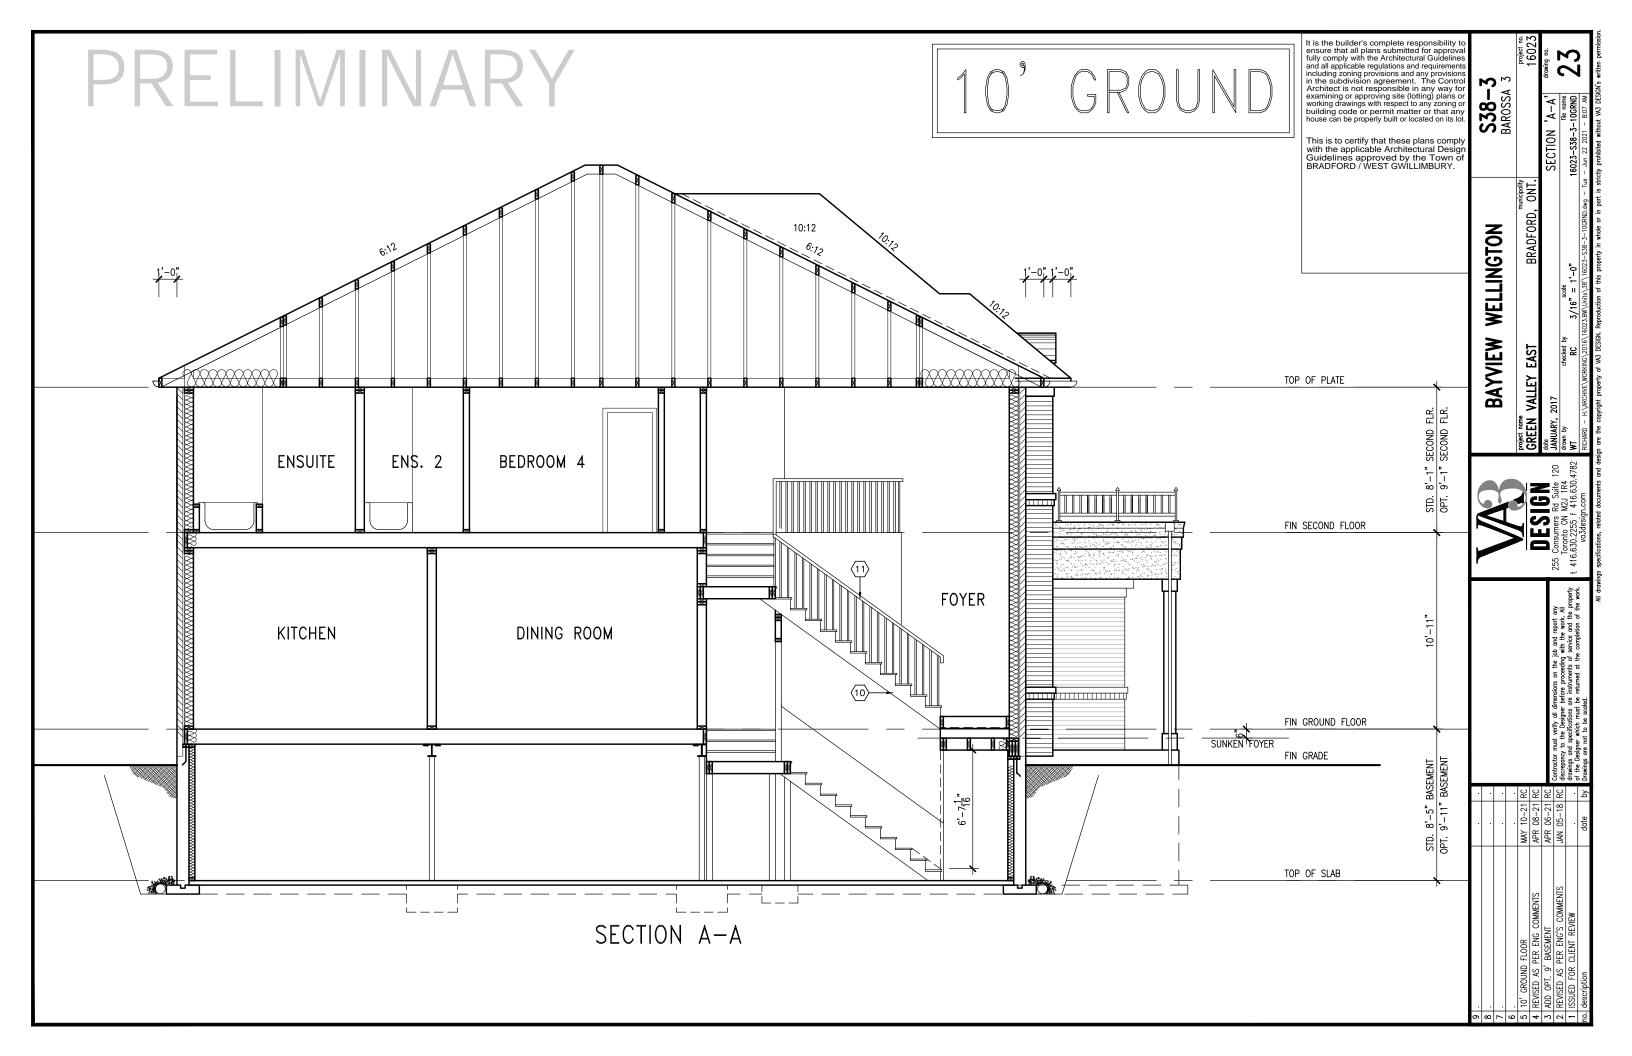


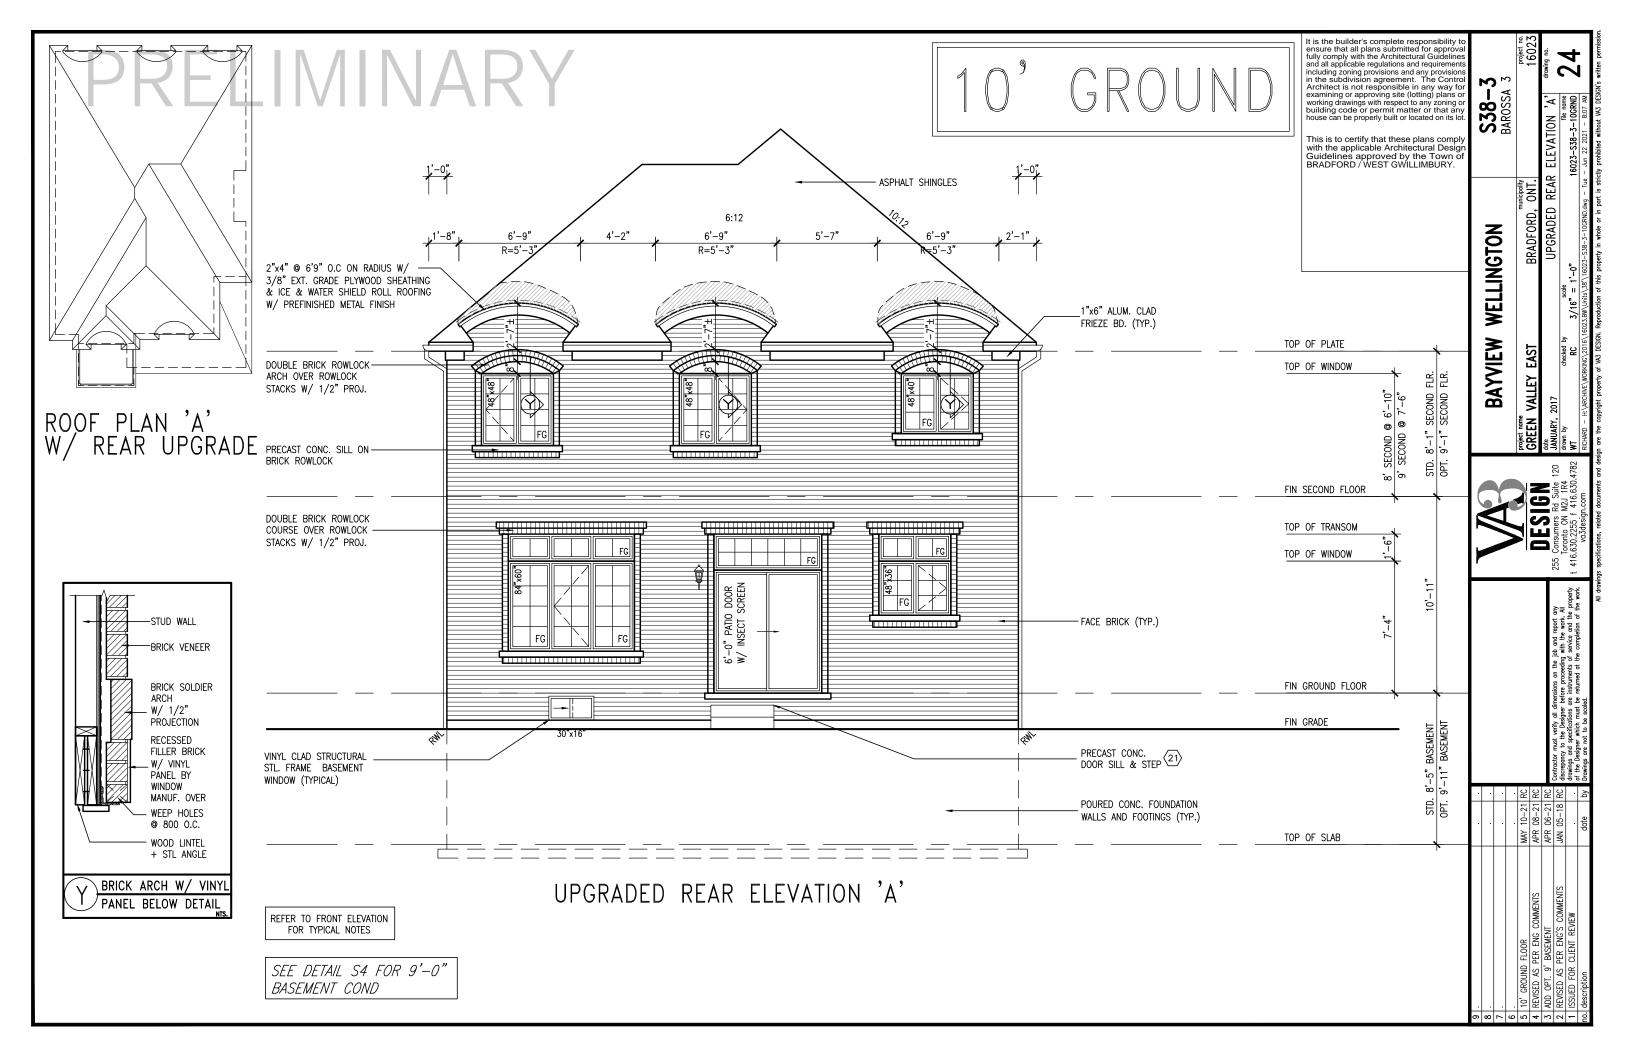


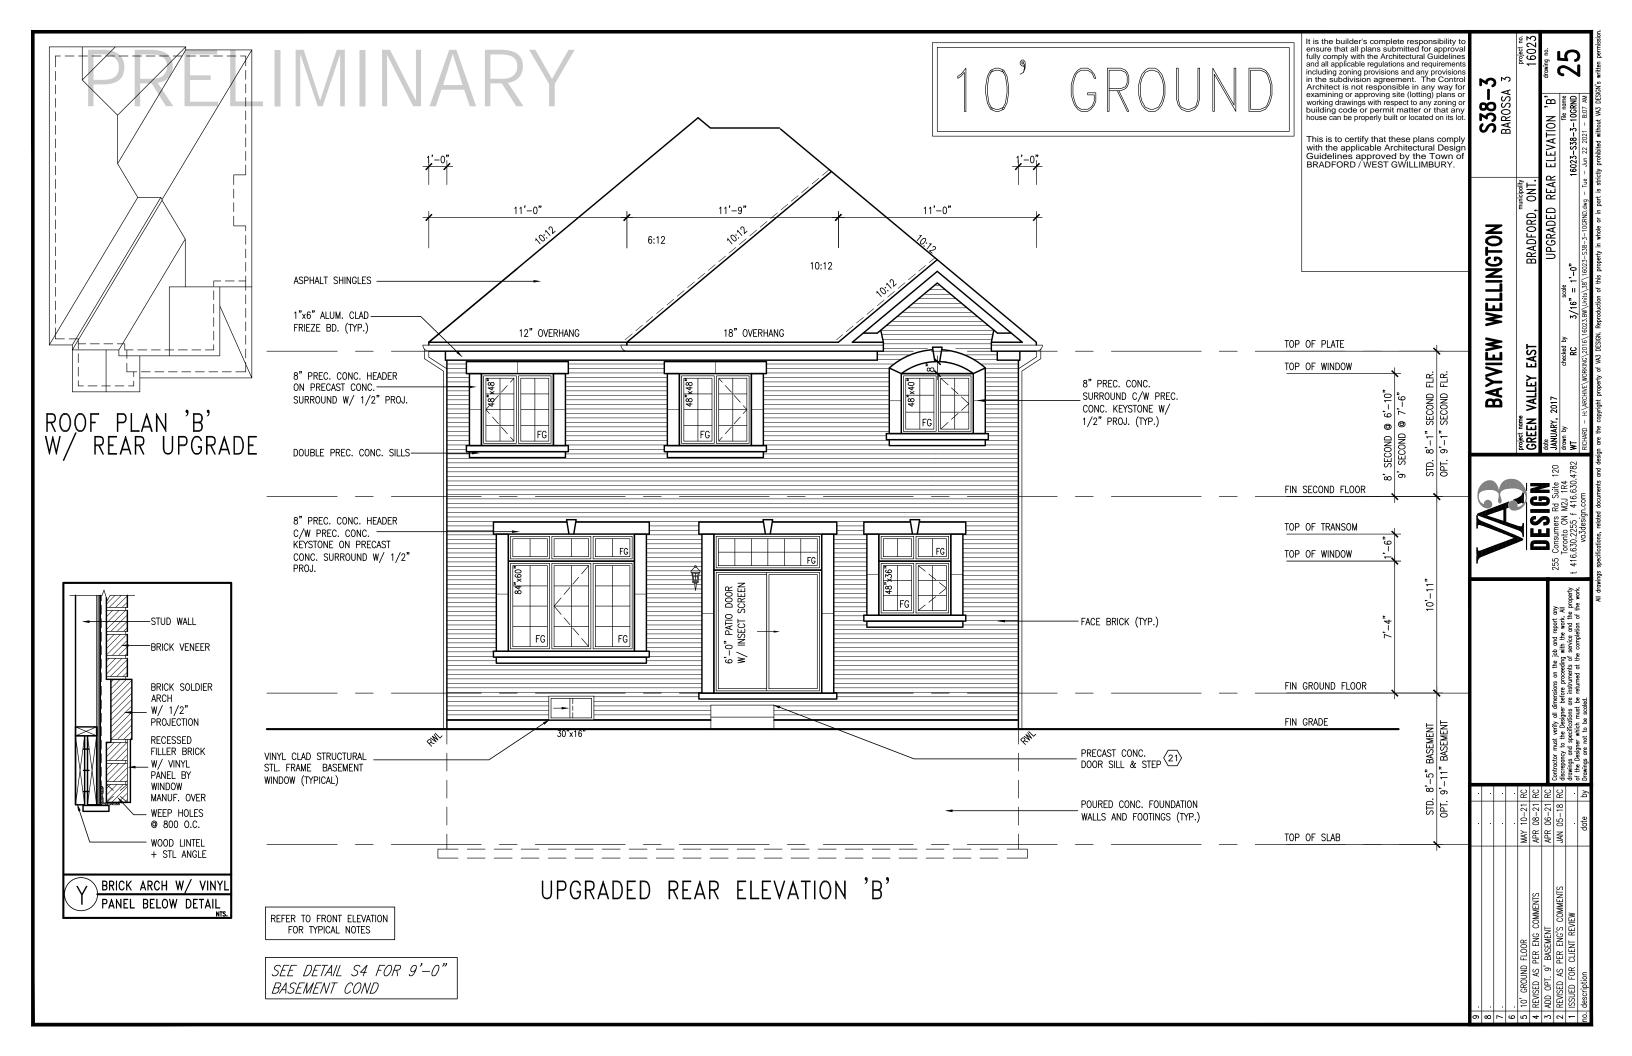


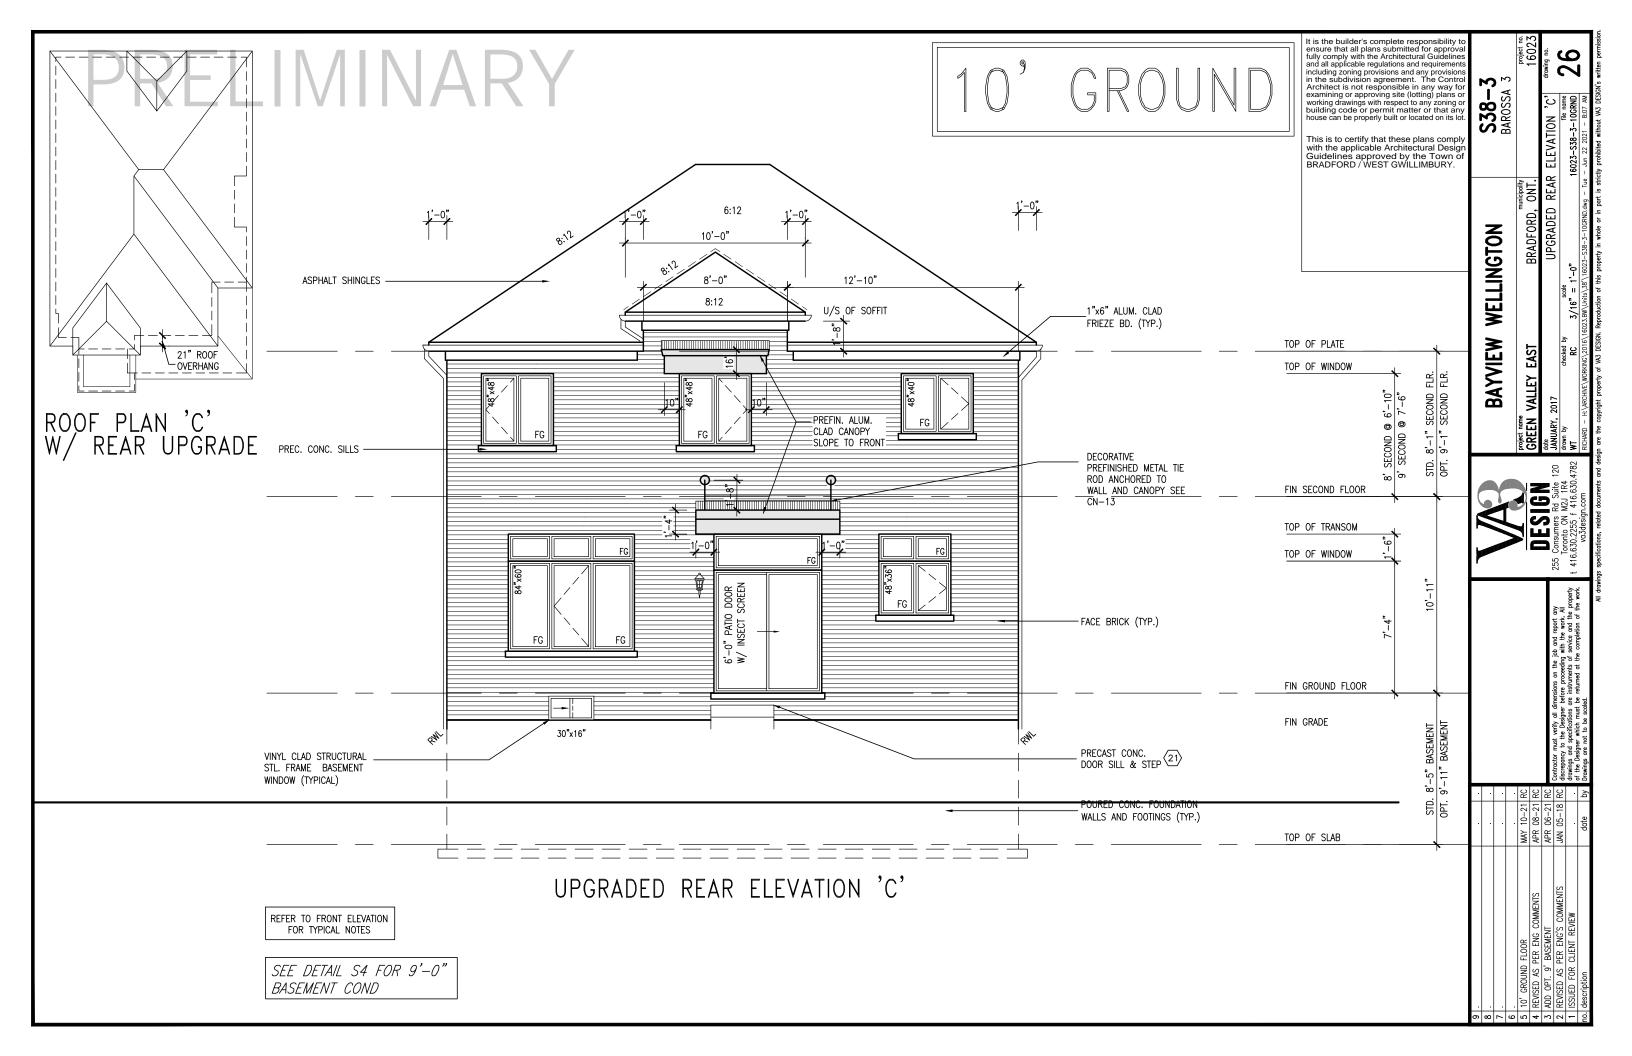


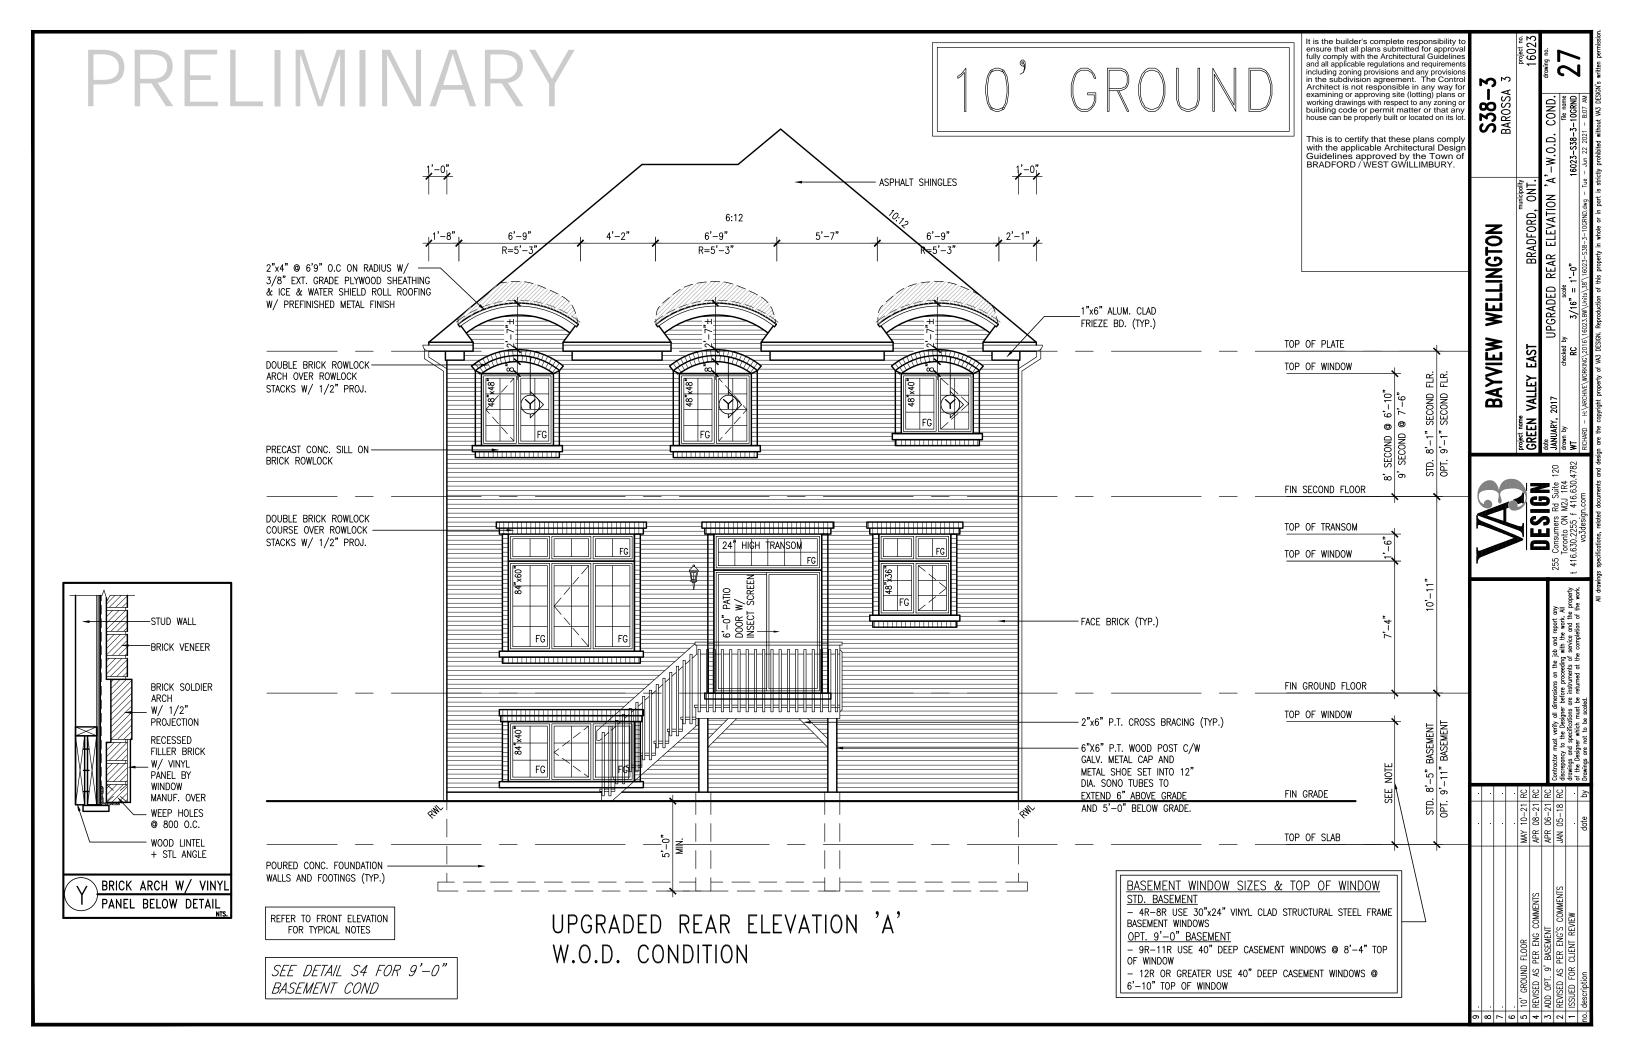


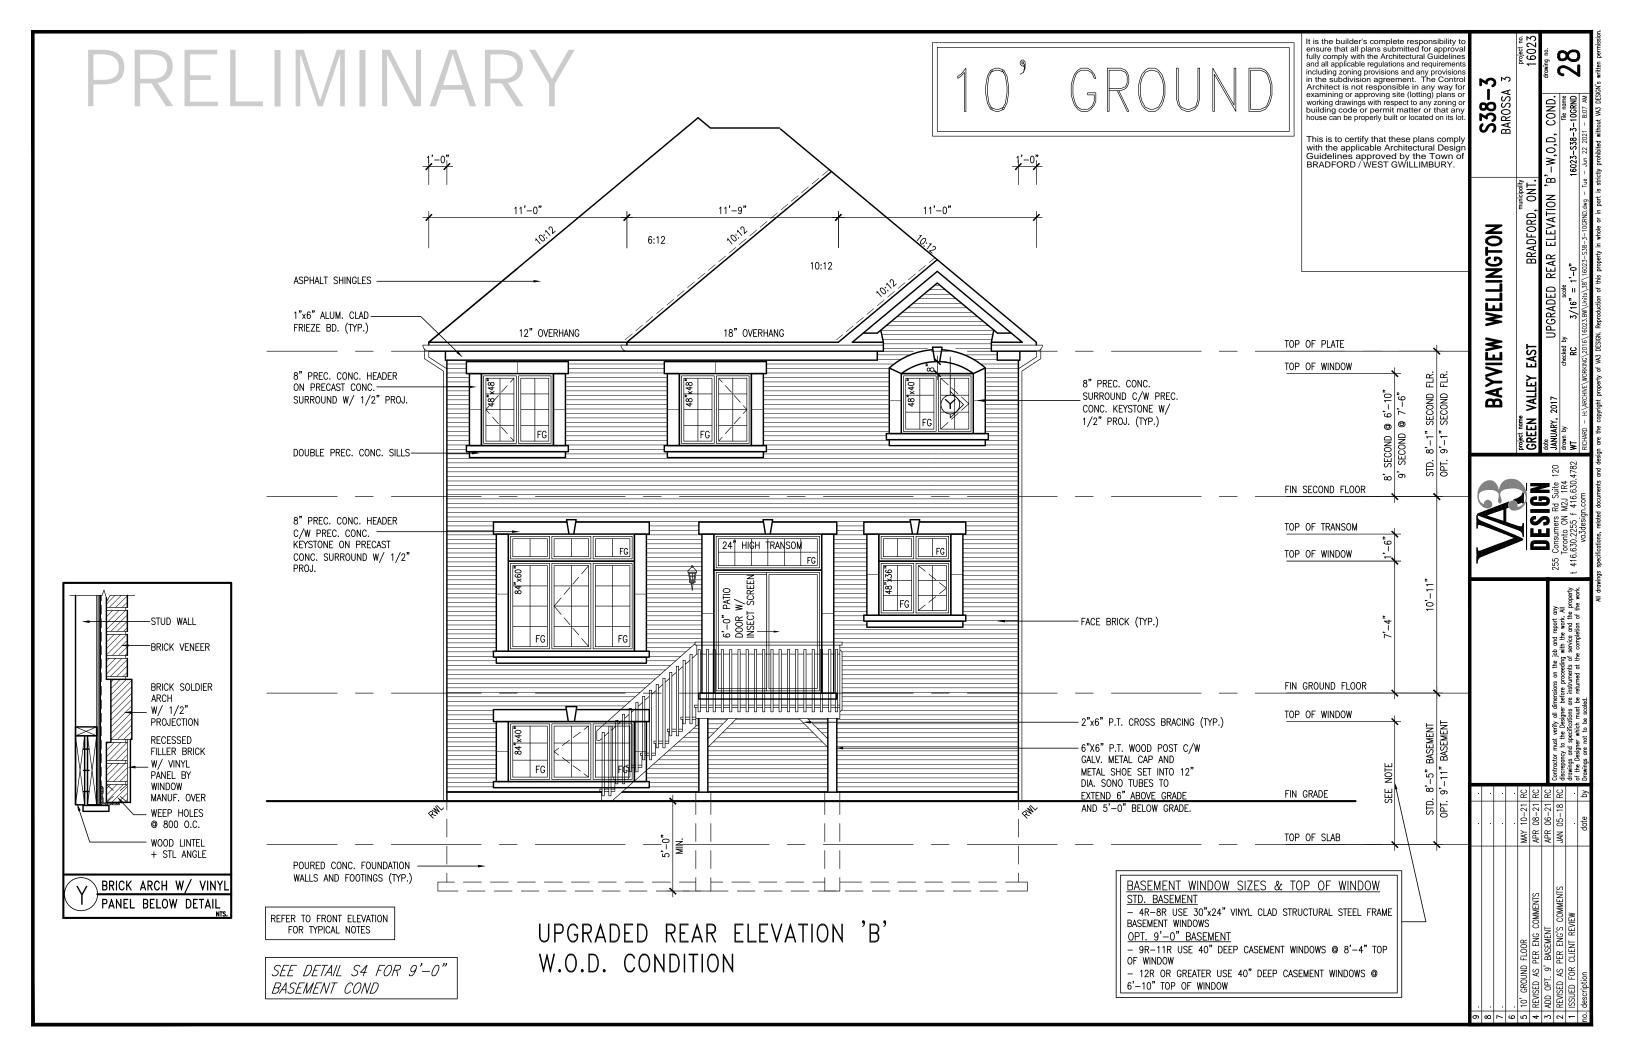

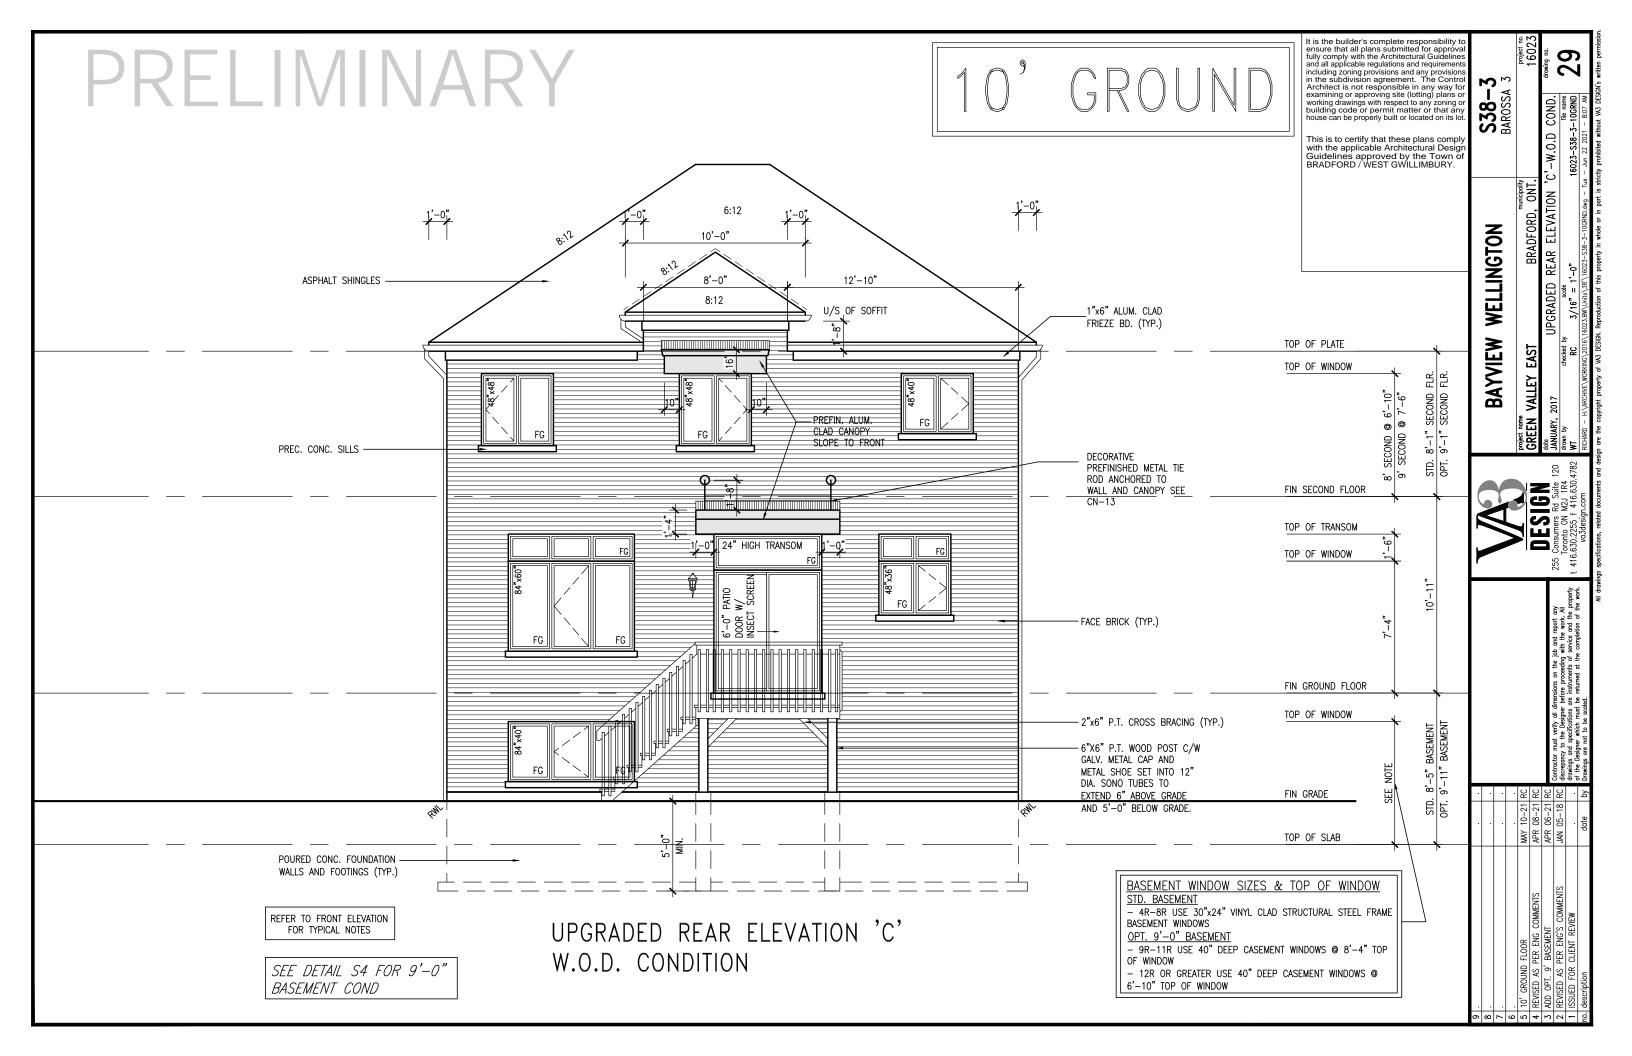

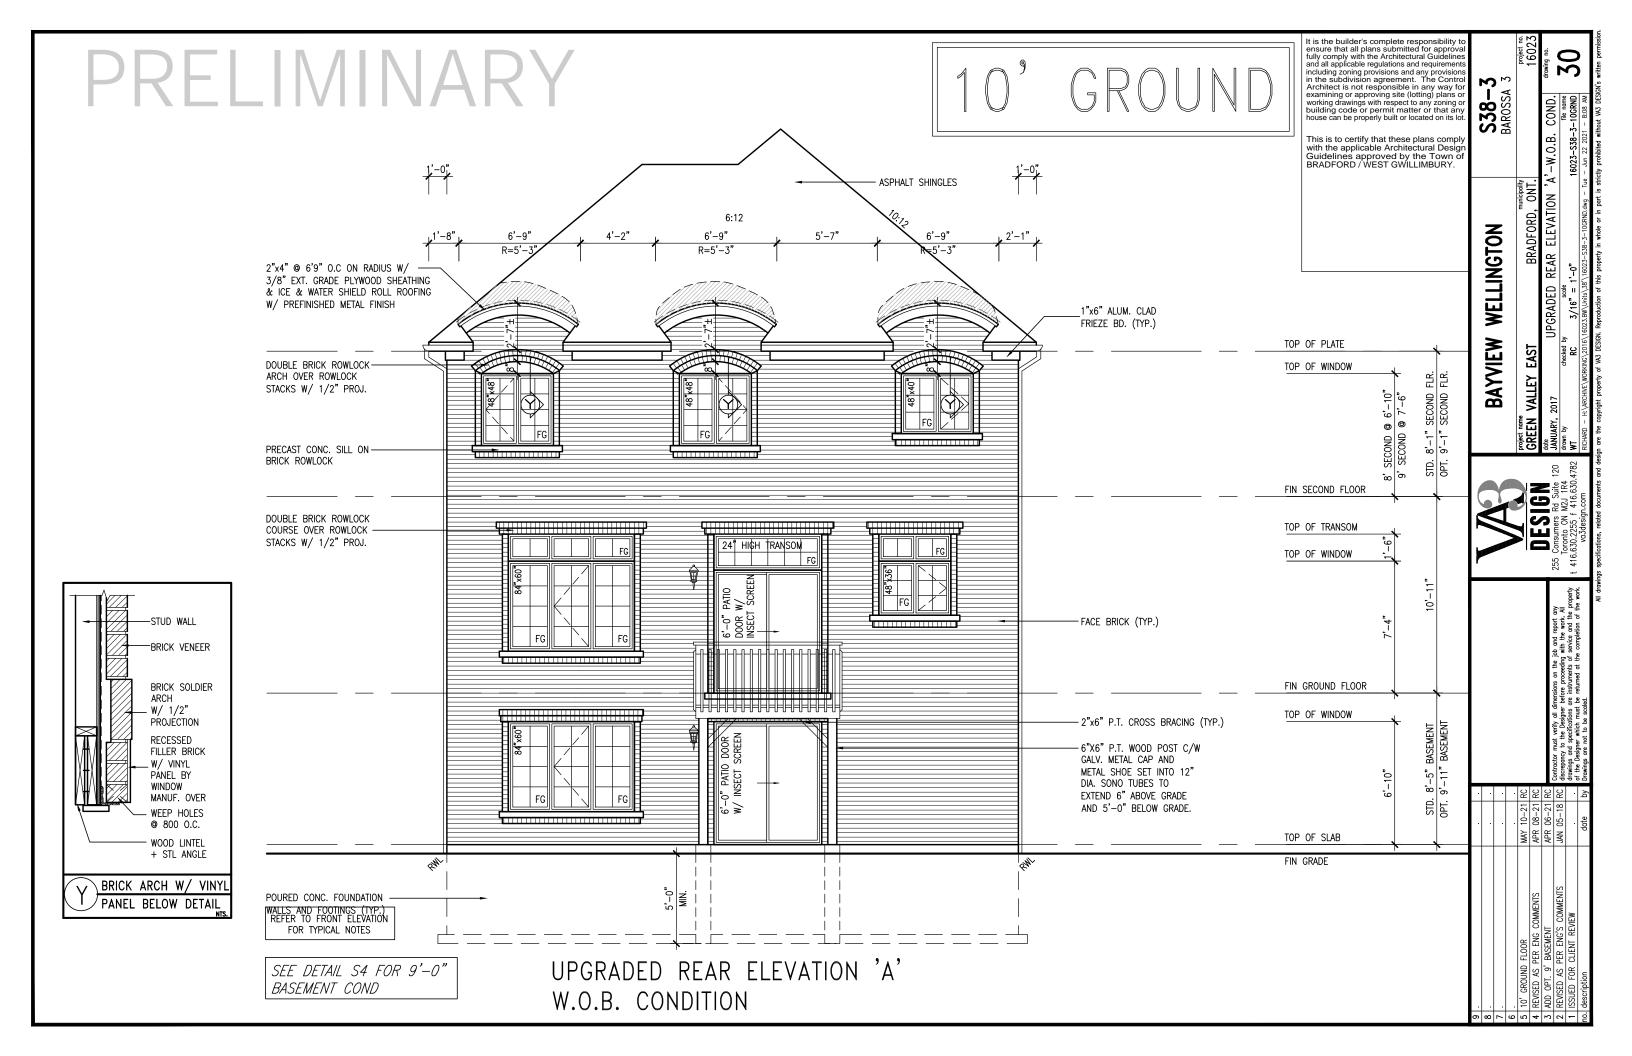

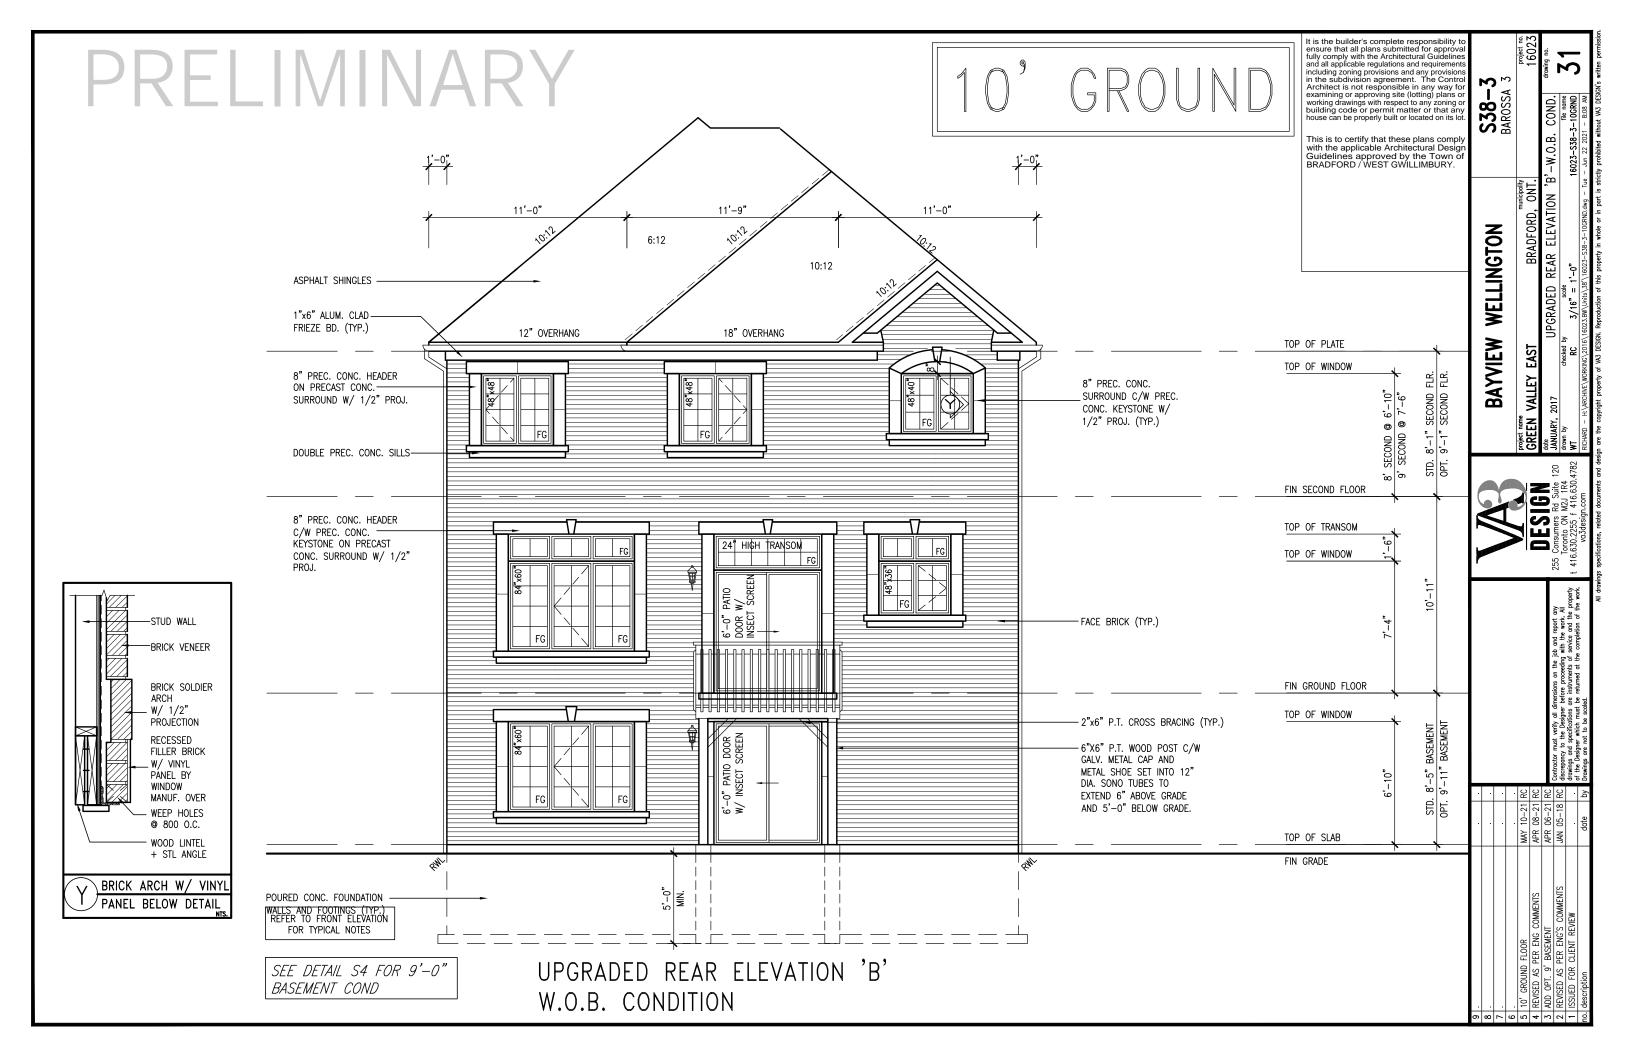

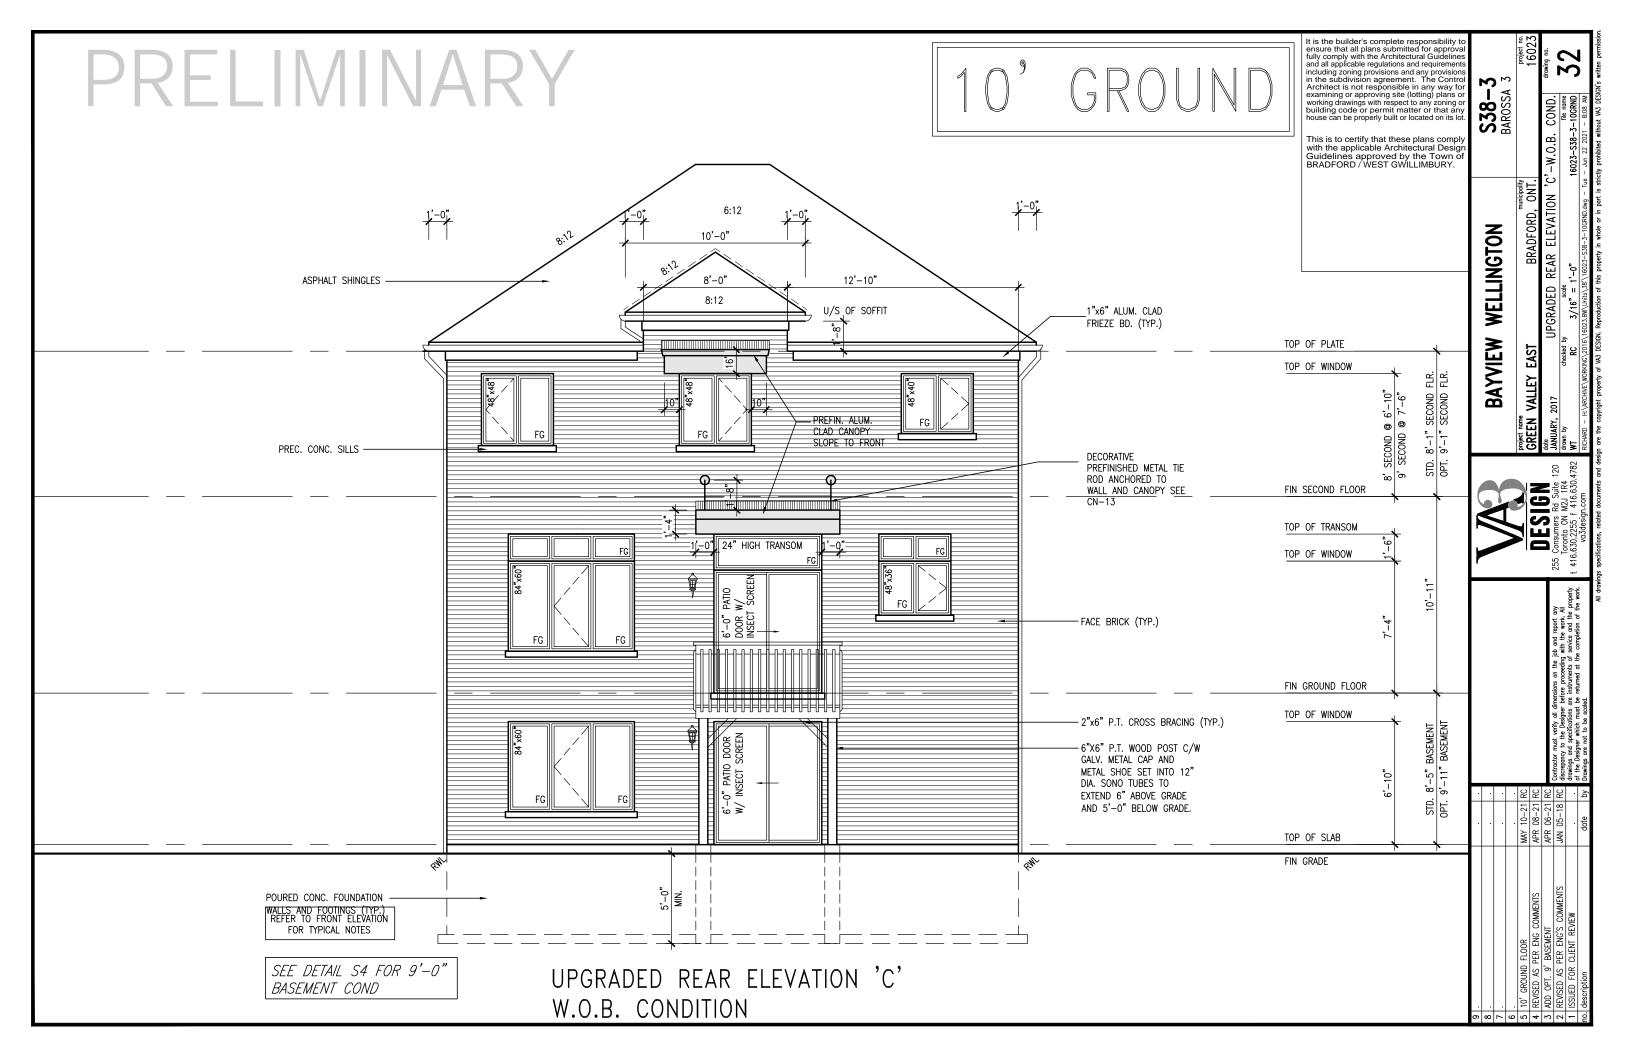

PRELIMINARY

GROUND	
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UNINSULATED OPENINGS (PER OBC. SB-12,3.1.1(7))				
S38-3 EL.A W/ 9' SECOND	ENERGY E	FFICIENCY - OF	BC SB12	
ELEVATION	WALL AREA S.F.	OPENING S.F.	PERCENTAGE	
FRONT	705.83 S.F.	162.86 S.F.	23.07 %	
LEFT SIDE	1070.67 S.F.	59.67 S.F.	5.57 %	
RIGHT SIDE	1070.67 S.F.	27.28 S.F.	2.55 %	
REAR	698.50 S.F.	165.17 S.F.	23.65 %	
* OPENINGS OMITTED AS PER SB-12 3.1.1.9(4) MAX 19.9 S.F. REFER TO ELEVATION FOR LOCATION		0 S.F.		
TOTAL SQ. FT.	3545.67 S.F.	414.98 S.F.	11.70 %	
TOTAL SQ. M.	329.40 S.M.	38.55 S.M.	11.70 %	

S38-3 EL.A WOD W/ 9' SECOND	ENERGY E	FFICIENCY - OE	SC SB12	_
ELEVATION	WALL AREA S.F.	OPENING S.F.	PERCENTAG	Ē
FRONT	705.83 S.F.	162.86 S.F.	23.07 %	
LEFT SIDE	1070.67 S.F.	59.67 S.F.	5.57 %	
RIGHT SIDE	1070.67 S.F.	27.28 S.F.	2.55 %	
REAR	825.50 S.F.	184.17 S.F.	22.31 %	
* OPENINGS OMITTED AS PER SB-12 3.1.1.9(4) MAX 19.9 S.F. REFER TO ELEVATION FOR LOCATION		0 S.F.		
TOTAL SQ. FT.	3672.67 S.F.	433.98 S.F.	11.82 %	
TOTAL SQ. M.	341.20 S.M.	40.32 S.M.	11.82 %	

UNINSULATED OPENINGS (PER OBC. SB-12,3.1.1(7))

	`		(//
S38-3 EL.A WOB W/ 9' SECOND ENERGY EFFICIENCY - OBC SB12			
ELEVATION	WALL AREA S.F.	OPENING S.F.	PERCENTAGE
FRONT	705.83 S.F.	162.86 S.F.	23.07 %
LEFT SIDE	1070.67 S.F.	59.67 S.F.	5.57 %
RIGHT SIDE	1070.67 S.F.	27.28 S.F.	2.55 %
REAR	918.10 S.F.	236.84 S.F.	25.80 %
* OPENINGS OMITTED AS PER SB-12 3.1.1.9(4) MAX 19.9 S.F. REFER TO ELEVATION FOR LOCATION		0 S.F.	
TOTAL SQ. FT.	3765.27 S.F.	486.65 S.F.	12.92 %
TOTAL SQ. M.	349.80 S.M.	45.21 S.M.	12.92 %
TOTAL SQ. M.	349.80 S.M.	45.215.M.	12.92 %

UNINSULATED OPENINGS (PER OBC. SB-12,3.1.1(7))

UNINSULATED OPENI	NGS (DED OR	C CD 10 7 1 1	(7))	
OMINSOLATED OF LIM	1100 (FER OB	C. 3B-12,3.1.1	(/))	
S38-3 EL.B W/ 9' SECOND	ENERGY E	FFICIENCY — OF	3C SB12	
ELEVATION	WALL AREA S.F.	OPENING S.F.	PERCENT	AGE
FRONT	712.58 S.F.	155.97 S.F.	21.89	%
LEFT SIDE	1066.00 S.F.	59.67 S.F.	5.60	%
RIGHT SIDE	1065.92 S.F.	27.28 S.F.	2.56	%
REAR	698.50 S.F.	165.17 S.F.	23.65	%
* OPENINGS OMITTED AS PER SB-12 3.1.1.9(4) MAX 19.9 S.F. REFER TO ELEVATION FOR LOCATION		0 S.F.		
TOTAL SQ. FT.	3543.00 S.F.	408.09 S.F.	11.52	%
TOTAL SQ. M.	329.15 S.M.	37.91S.M.	11.52	%

UNINSULATED OPENINGS (PER OBC. SB-12,3.1.1(7))			
S38-3 EL.B WOD W/ 9' SECOND	ENERGY E	FFICIENCY - OF	SC SB12
ELEVATION	WALL AREA S.F.	OPENING S.F.	PERCENTAGE
FRONT	712.58 S.F.	155.97 S.F.	21.89 %
LEFT SIDE	1066.00 S.F.	59.37 S.F.	5.57 %
RIGHT SIDE	1065.92 S.F.	27.28 S.F.	2.56 %
REAR	825.50 S.F.	184.17 S.F.	22.31 %
* OPENINGS OMITTED AS PER SB-12 3.1.1.9(4) MAX 19.9 S.F. REFER TO ELEVATION FOR LOCATION		0 S.F.	
TOTAL SQ. FT.	3670.00 S.F.	426.79 S.F.	11.63 %
TOTAL SQ. M.	340.95 S.M.	39.65 S.M.	11.63 %

UNINSULATED OPENINGS (PER OBC. SB-12,3.1.1(7))				
S38-3 EL.B WOB W/ 9' SECOND	ENERGY E	FFICIENCY - OF	BC SB12	
ELEVATION	WALL AREA S.F.	OPENING S.F.	PERCENTAGE	
FRONT	712.58 S.F.	155.97 S.F.	21.89 %	
LEFT SIDE	1066.00 S.F.	59.67 S.F.	5.60 %	
RIGHT SIDE	1065.92 S.F.	27.28 S.F.	2.56 %	
REAR	918.10 S.F.	236.84 S.F.	25.80 %	
* OPENINGS OMITTED AS PER SB-12 3.1.1.9(4) MAX 19.9 S.F. REFER TO ELEVATION FOR LOCATION		0 S.F.		
TOTAL SQ. FT.	3762.60 S.F.	479.76 S.F.	12.75 %	
TOTAL SQ. M.	349.55 S.M.	44.57 S.M.	12.75 %	

LINUNIOU LATER ORENI	1100			
UNINSULATED OPENINGS (PER OBC. SB-12,3.1.1(7))				
S38-3 EL.C W/ 9' SECOND	ENERGY E	FFICIENCY - OF	3C SB12	
ELEVATION	WALL AREA S.F.	OPENING S.F.	PERCENT.	AGE
FRONT	709.62 S.F.	183.54 S.F.	25.86	%
LEFT SIDE	1070.65 S.F.	85.67 S.F.	8.00	%
RIGHT SIDE	1070.65 S.F.	27.28 S.F.	2.55	%
REAR	698.50 S.F.	165.17 S.F.	23.65	%
* OPENINGS OMITTED AS PER SB-12 3.1.1.9(4) MAX 19.9 S.F. REFER TO ELEVATION FOR LOCATION		0 S.F.		
TOTAL SQ. FT.	3549.42 S.F.	461.66 S.F.	13.01	%
TOTAL SQ. M.	329.75 S.M.	42.89 S.M.	13.01	%

UNINSULATED OPENINGS (PER OBC. SB-12,3.1.1(7))			
S38-3 EL.C WOD W/ 9' SECOND	ENERGY E	FFICIENCY - OF	3C SB12
ELEVATION	WALL AREA S.F.	OPENING S.F.	PERCENTAGE
FRONT	709.62 S.F.	183.54 S.F.	25.86 %
LEFT SIDE	1070.65 S.F.	85.67 S.F.	8.00 %
RIGHT SIDE	1070.65 S.F.	27.28 S.F.	2.55 %
REAR	825.50 S.F.	184.17 S.F.	22.31 %
* OPENINGS OMITTED AS PER SB-12 3.1.1.9(4) MAX 19.9 S.F. REFER TO ELEVATION FOR LOCATION		0 S.F.	
TOTAL SQ. FT.	3676.42 S.F.	480.66 S.F.	13.07 %
TOTAL SQ. M.	341.55 S.M.	44.65 S.M.	13.07 %

UNINSULATED OPENINGS (PER OBC. SB-12,3.1.1(7))			
S38-3 EL.C WOB W/ 9' SECOND	ENERGY E	FFICIENCY - OF	BC SB12
ELEVATION	WALL AREA S.F.	OPENING S.F.	PERCENTAGE
FRONT	709.62 S.F.	183.54 S.F.	25.86 %
LEFT SIDE	1070.65 S.F.	85.67 S.F.	8.00 %
RIGHT SIDE	1070.65 S.F.	27.28 S.F.	2.55 %
REAR	918.10 S.F.	236.84 S.F.	25.80 %
* OPENINGS OMITTED AS PER SB-12 3.1.1.9(4) MAX 19.9 S.F. REFER TO ELEVATION FOR LOCATION		0 S.F.	
TOTAL SQ. FT.	3769.02 S.F.	533.33 S.F.	14.15 %
TOTAL SQ. M.	350.15 S.M.	49.55 S.M.	14.15 %

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issure that all plans submitted for approval lly comply with the Architectural Guidelines do all applicable regulations and requirements cluding zoning provisions and any provisions the subdivision agreement. The Control richitect is not responsible in any way for ramining or approving site (lotting) plans or the subdiving plans or	5 4
orking drawings with respect to any zoning or uilding code or permit matter or that any puse can be properly built or located on its lot.	S38 BAROSSA

	project name		BAYVIEW WELLINGTON
FOIGN	GREEN	GREEN VALLEY EAST	BRADFORI
Sumers Rd Suite 120	date JANUARY, 2017	2017	SB12 - W/
onto ON M2J 1R4	drawn by	checked by	scale
0.2255 f 416.630.4782	M	S	3/16" = 1'-0"
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organization of the Designer which must be returned at the completion of the by Drawings are not to be scaled.	· Þá	date
of the Designer which must be returned at the completion of the		
drawings and specifications are instruments of service and the pro		
contractor must verify all almensions on the job and report any discrepancy to the Designer before proceeding with the work. All	RC	JAN 05-18 RC
		APR 06-21 RC
	RC	APR 08-21 RC
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PRELIMINARY

	ensure that all plans submitted for approval
	fully comply with the Architectural Guidelines
П	and all applicable regulations and requirements
П	including zoning provisions and any provisions
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	Architect is not responsible in any way for
	examining or approving site (lotting) plans or
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	building code or permit matter or that any
	house can be properly built or located on its lot.

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<u>UNINSULATED OPENI</u>	NGS (PER OB	C. SB-12,3.1.1	(7))
S38-3 EL.A WOB W/ 9' BSMT+8' 2ND	ENERGY E	FFICIENCY - OF	SC SB12
ELEVATION	WALL AREA S.F.	OPENING S.F.	PERCENTAGE
FRONT	674.08 S.F.	162.86 S.F.	24.16 %
LEFT SIDE	1022.00 S.F.	59.67 S.F.	5.84 %
RIGHT SIDE	1022.00 S.F.	27.28 S.F.	2.67 %
REAR	933.98 S.F.	236.84 S.F.	25.36 %
* OPENINGS OMITTED AS PER SB-12 3.1.1.9(4) MAX 19.9 S.F. REFER TO ELEVATION FOR LOCATION		0 S.F.	
TOTAL SQ. FT.	3652.06 S.F.	486.65 S.F.	13.33 %
TOTAL SQ. M.	339.28 S.M.	45.21S.M.	13.33 %

<u>UNINSULATED OPENI</u>	NGS (PER OBC. SB-12,3.1.1(7))			
S38-3 EL.B WOB W/ 9' BSMT+8' 2ND	ENERGY E	FFICIENCY - OE	C SB12	
ELEVATION	WALL AREA S.F.	OPENING S.F.	PERCENTAGE	
FRONT	680.83 S.F.	155.97 S.F.	22.91 %	
LEFT SIDE	1017.00 S.F.	59.67 S.F.	5.87 %	
RIGHT SIDE	1016.92 S.F.	27.28 S.F.	2.68 %	
REAR	933.98 S.F.	236.84 S.F.	25.36 %	
* OPENINGS OMITTED AS PER SB-12 3.1.1.9(4) MAX 19.9 S.F. REFER TO ELEVATION FOR LOCATION		0 S.F.		
TOTAL SQ. FT.	3648.73 S.F.	479.76 S.F.	13.15 %	
TOTAL SQ. M.	338.98 S.M.	44.57 S.M.	13.15 %	

<u>UNINSULATED OPENI</u>	NGS (PER OB	C. SB-12,3.1.1	(7))	
S38-3 EL.C WOB W/ 9' BSMT+8' 2ND	ENERGY E	FFICIENCY - OF	3C SB12	
ELEVATION	WALL AREA S.F.	OPENING S.F.	PERCENT	AGE
FRONT	677.87 S.F.	183.54 S.F.	27.08	%
LEFT SIDE	1021.98 S.F.	85.67 S.F.	8.38	%
RIGHT SIDE	1021.98 S.F.	27.28 S.F.	2.67	%
REAR	933.98 S.F.	236.84 S.F.	25.36	%
* OPENINGS OMITTED AS PER SB-12 3.1.1.9(4) MAX 19.9 S.F. REFER TO ELEVATION FOR LOCATION		0 S.F.		
TOTAL SQ. FT.	3655.81 S.F.	533.33 S.F.	14.59	%
TOTAL SQ. M.	339.63 S.M.	49.55 S.M.	14.59	%

UNINSULATED OPENI	NGS (PER OB	C. SB-12,3.1.1	(7))
S38-3 EL.A WOB W/ 9' BSMT+2ND	ENERGY E	FFICIENCY - OF	SC SB12
ELEVATION	WALL AREA S.F.	OPENING S.F.	PERCENTAGE
FRONT	705.83 S.F.	162.86 S.F.	23.07 %
LEFT SIDE	1070.67 S.F.	59.67 S.F.	5.57 %
RIGHT SIDE	1070.67 S.F.	27.28 S.F.	2.55 %
REAR	965.73 S.F.	236.84 S.F.	24.52 %
* OPENINGS OMITTED AS PER SB-12 3.1.1.9(4) MAX 19.9 S.F. REFER TO ELEVATION FOR LOCATION		0 S.F.	
TOTAL SQ. FT.	3812.90 S.F.	486.65 S.F.	12.76 %
TOTAL SQ. M.	354.23 S.M.	45.21S.M.	12.76 %

UNINSULATED OPENINGS (PER OBC. SB-12,3.1.1(7))				
S38-3 EL.B WOB W/ 9' BSMT+2ND	ENERGY E	FFICIENCY - OE	SC SB12	
ELEVATION	WALL AREA S.F.	OPENING S.F.	PERCENTA	\GE
FRONT	712.58 S.F.	155.97 S.F.	21.89	%
LEFT SIDE	1066.00 S.F.	59.67 S.F.	5.60	%
RIGHT SIDE	1065.92 S.F.	27.28 S.F.	2.56	%
REAR	965.73 S.F.	236.84 S.F.	24.52	%
* OPENINGS OMITTED AS PER SB-12 3.1.1.9(4) MAX 19.9 S.F. REFER TO ELEVATION FOR LOCATION		0 S.F.		
TOTAL SQ. FT.	3810.23 S.F.	479.76 S.F.	12.59	%
TOTAL SQ. M.	353.98 S.M.	44.57 S.M.	12.59	%

UNINSULATED OPEN	INGS (PER OB	C. SB-12,3.1.1	(7))
S38-3 EL.C WOB W/ 9' BSMT+2ND	ENERGY E	FFICIENCY - OF	3C SB12
ELEVATION	WALL AREA S.F.	OPENING S.F.	PERCENTAGE
FRONT	709.62 S.F.	183.54 S.F.	25.86 %
LEFT SIDE	1070.65 S.F.	85.67 S.F.	8.00 %
RIGHT SIDE	1070.65 S.F.	27.28 S.F.	2.55 %
REAR	965.73 S.F.	236.84 S.F.	24.52 %
* OPENINGS OMITTED AS PER SB-12 3.1.1.9(4) MAX 19.9 S.F. REFER TO ELEVATION FOR LOCATION		0 S.F.	
TOTAL SQ. FT.	3816.65 S.F.	533.33 S.F.	13.97 %
TOTAL SQ. M.	354.58 S.M.	49.55 S.M.	13.97 %

is the builder's complete responsibility to sure that all plans submitted for approval lly comply with the Architectural Guidelines id all applicable regulations and requirements cluding zoning provisions and any provisions the subdivision agreement. The Control richitect is not responsible in any way for amining or approving site (lotting) plans or orking drawings with respect to any zoning or uilding code or permit matter or that any use can be properly built or located on its lot.	S38-3 BAROSSA 3
nis is to certify that these plans comply ith the applicable Architectural Design	

	DAVNEW WELLINGTON			GREEN VALLET EASI BRADFURD	dote SB12 - OPT, 9' BASEMENT W	drawn by	(a nomenia
		Y-57/		2U-01C		ZOO CONSUMERS NO SUITE 120 Toronto ON M21 184	TILL ON MIZO TILL
					Contractor must verify all dimensions on the int on report mu	JAN 05-18 RC discrepancy to the Designer before proceeding with the work. All	
			MAY 10-21 RC	APR 08-21 RC	APR 06-21 RC	3 RC	
)-2	1-2	-2	~	١