

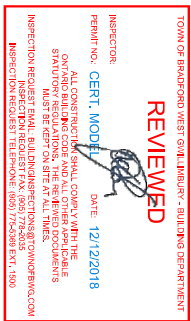
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ARCHITECTURAL REVIEW & APPROVAL

JAN 31 2018

John G. Williams Limited, Architect



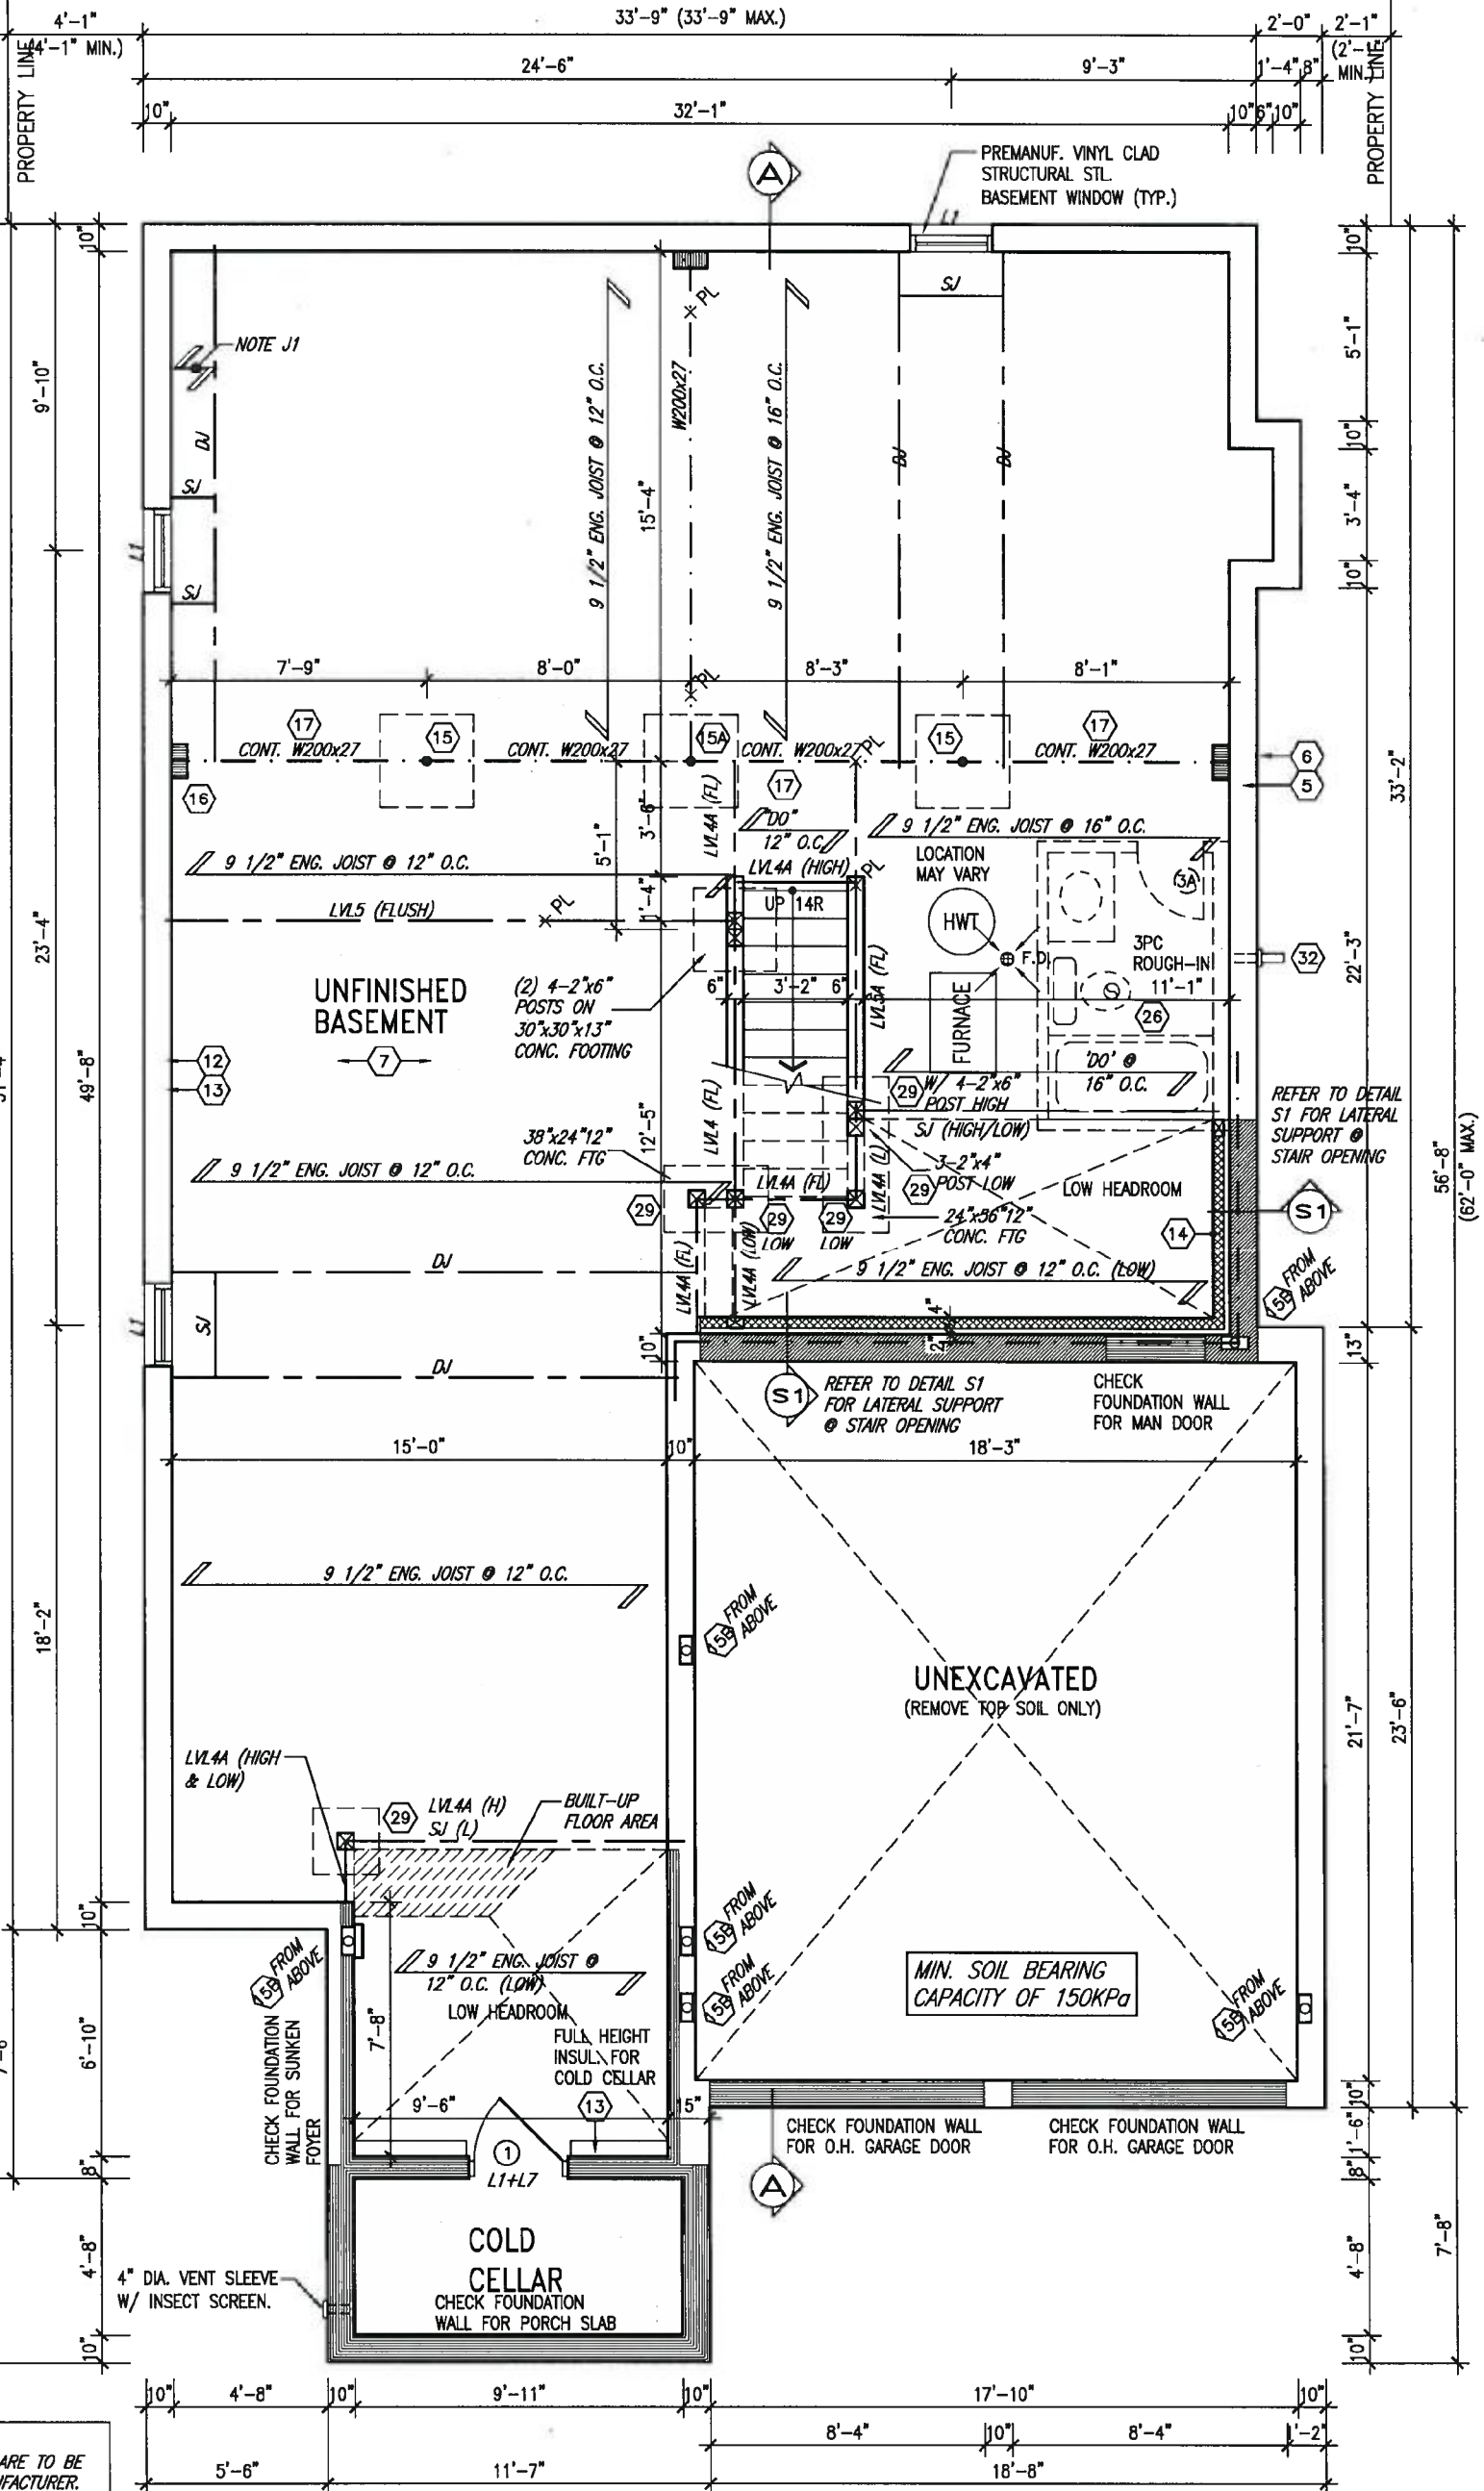
REFER TO  
PAGE 11  
FOR AREA  
CHART

NOTE J1: PROVIDE  
SOLID BLOCKING @ 24"  
O.C. WHERE FLOOR  
JOISTS ARE PARALLEL TO  
FOUNDATION WALL (TYP.)

NOTE:  
SPACE ALL FLOOR JOISTS  
@ 12" O.C. UNDER ALL  
CERAMIC TILE AREAS.

NOTE:  
ALL LVL'S SUPPORTING FLOOR LOADS ARE TO BE  
SPECIFIED BY THE FLOOR TRUSS MANUFACTURER.

NOTE:  
FLOOR FRAMING INFO REFER TO ENG SHOP  
DRAWINGS FOR ALL TRUSS-JOIST INFORMATION AND  
DETAILS. UNLESS OTHERWISE NOTED.



BASEMENT PLAN 'A'

The undersigned has reviewed and takes responsibility for this design and has the qualifications and meets the requirements set out in the Ontario Building Code to be a Designer.

Wellington Jno-Baptiste 25591  
name registration information BCM  
VA3 Design Inc. 42658

Contractor must verify all dimensions on the job and report any discrepancy to the Designer before proceeding with the work. All drawings and specifications are instruments of service and the property of the Designer which must be returned at the completion of the work. Drawings are not to be scaled.

VA3  
DESIGN

255 Consumers Rd Suite 120  
Toronto ON M2J 1R4  
t 416.630.2255 f 416.630.4782  
va3design.com

BAYVIEW WELLINGTON

S42-15  
RIDEAU 15

project name GREEN VALLEY EAST municipality BRADFORD project no. 16023

date MARCH 2017 BASEMENT PLAN ELEVATION 'A' drawing no. 1

drawn by SB checked by 3/16" = 1'-0" scale 16023-S42-15

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NOTE:  
SPACE ALL FLOOR JOISTS @ 12" O.C. UNDER ALL  
CERAMIC TILE AREAS.

INDICATES FIRE RATED WALL ASSEMBLY

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ARCHITECTURAL REVIEW  
AND APPROVAL  
TOWN OF BRADFORD WEST GUILMBURY  
Signed: **JAN 31 2018**  
Date: **JAN 31 2018**  
JOHN G. WILLIAMS LIMITED ARCHITECT



NOTE R3:  
TWO PLY RUBBER  
MEMBRANE ADHERED TO  
EXT. TYPE 5/8" T&G  
PLYWOOD SHEATHING ON  
2"x4" PURLINS LAID PERP.  
TO JOISTS SLOPED TO  
DRAIN, ON 2"x10" SPF.  
JOISTS @ 16" O.C. W/  
SPRAY FOAM INSULATION  
R30 A/V BARRIER 5/8"  
GYPSUM BOARD

ROOF NOTE R2:  
2"x10" @ 16" O.C. P.T. W/ 2"x4" @ 12" O.C.  
DIAGONALLY CUT CROSS PURLINS W/ 5/8"  
EXTERIOR GRADE SHEATHING W/ TWO PLY ROOF  
MEMBRANE

EVS ELECTRIC VEHICLE CHARGING SYSTEM (EVCS)  
ROUGH-IN FOR FUTURE ELECTRIC VEHICLE SUPPLY  
EQUIPMENT (CHARGING SYSTEM) TO BE INSTALLED.  
ROUGH-IN SHALL INCLUDE:  
• A minimum 200 amp Panelboard,  
• Conduit that is not less than 1 1/16" (27mm)  
trade size,  
• A square 4 11/16" (119mm) trade size  
electrical outlet box,  
• Fumeproofed Electrical outlet box to be installed  
in the Garage or carport or adjacent to  
driveway.

REFER TO 2012 OBC, 9.34.4.

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qualification information  
Wellington Jno-Baptiste 25591  
name registration information BCN  
VA3 Design Inc. 42658  
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**VA3**  
**DESIGN**  
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Toronto ON M2J 1R4  
416.630.2255 f 416.630.4782  
vo3design.com

**BAYVIEW WELLINGTON**

**S42-15**  
RIDEAU 15

project name  
**GREEN VALLEY EAST**

municipality  
**BRADFORD**

project no.  
**16023**

date  
**MARCH 2017**

GROUND FLOOR PLAN ELEVATION 'A'

drawing no.  
**2**

drawn by  
**SB**

checked by  
**3/16" = 1'-0"**

scale  
**16023-S42-15**

file name  
**16023-S42-15**

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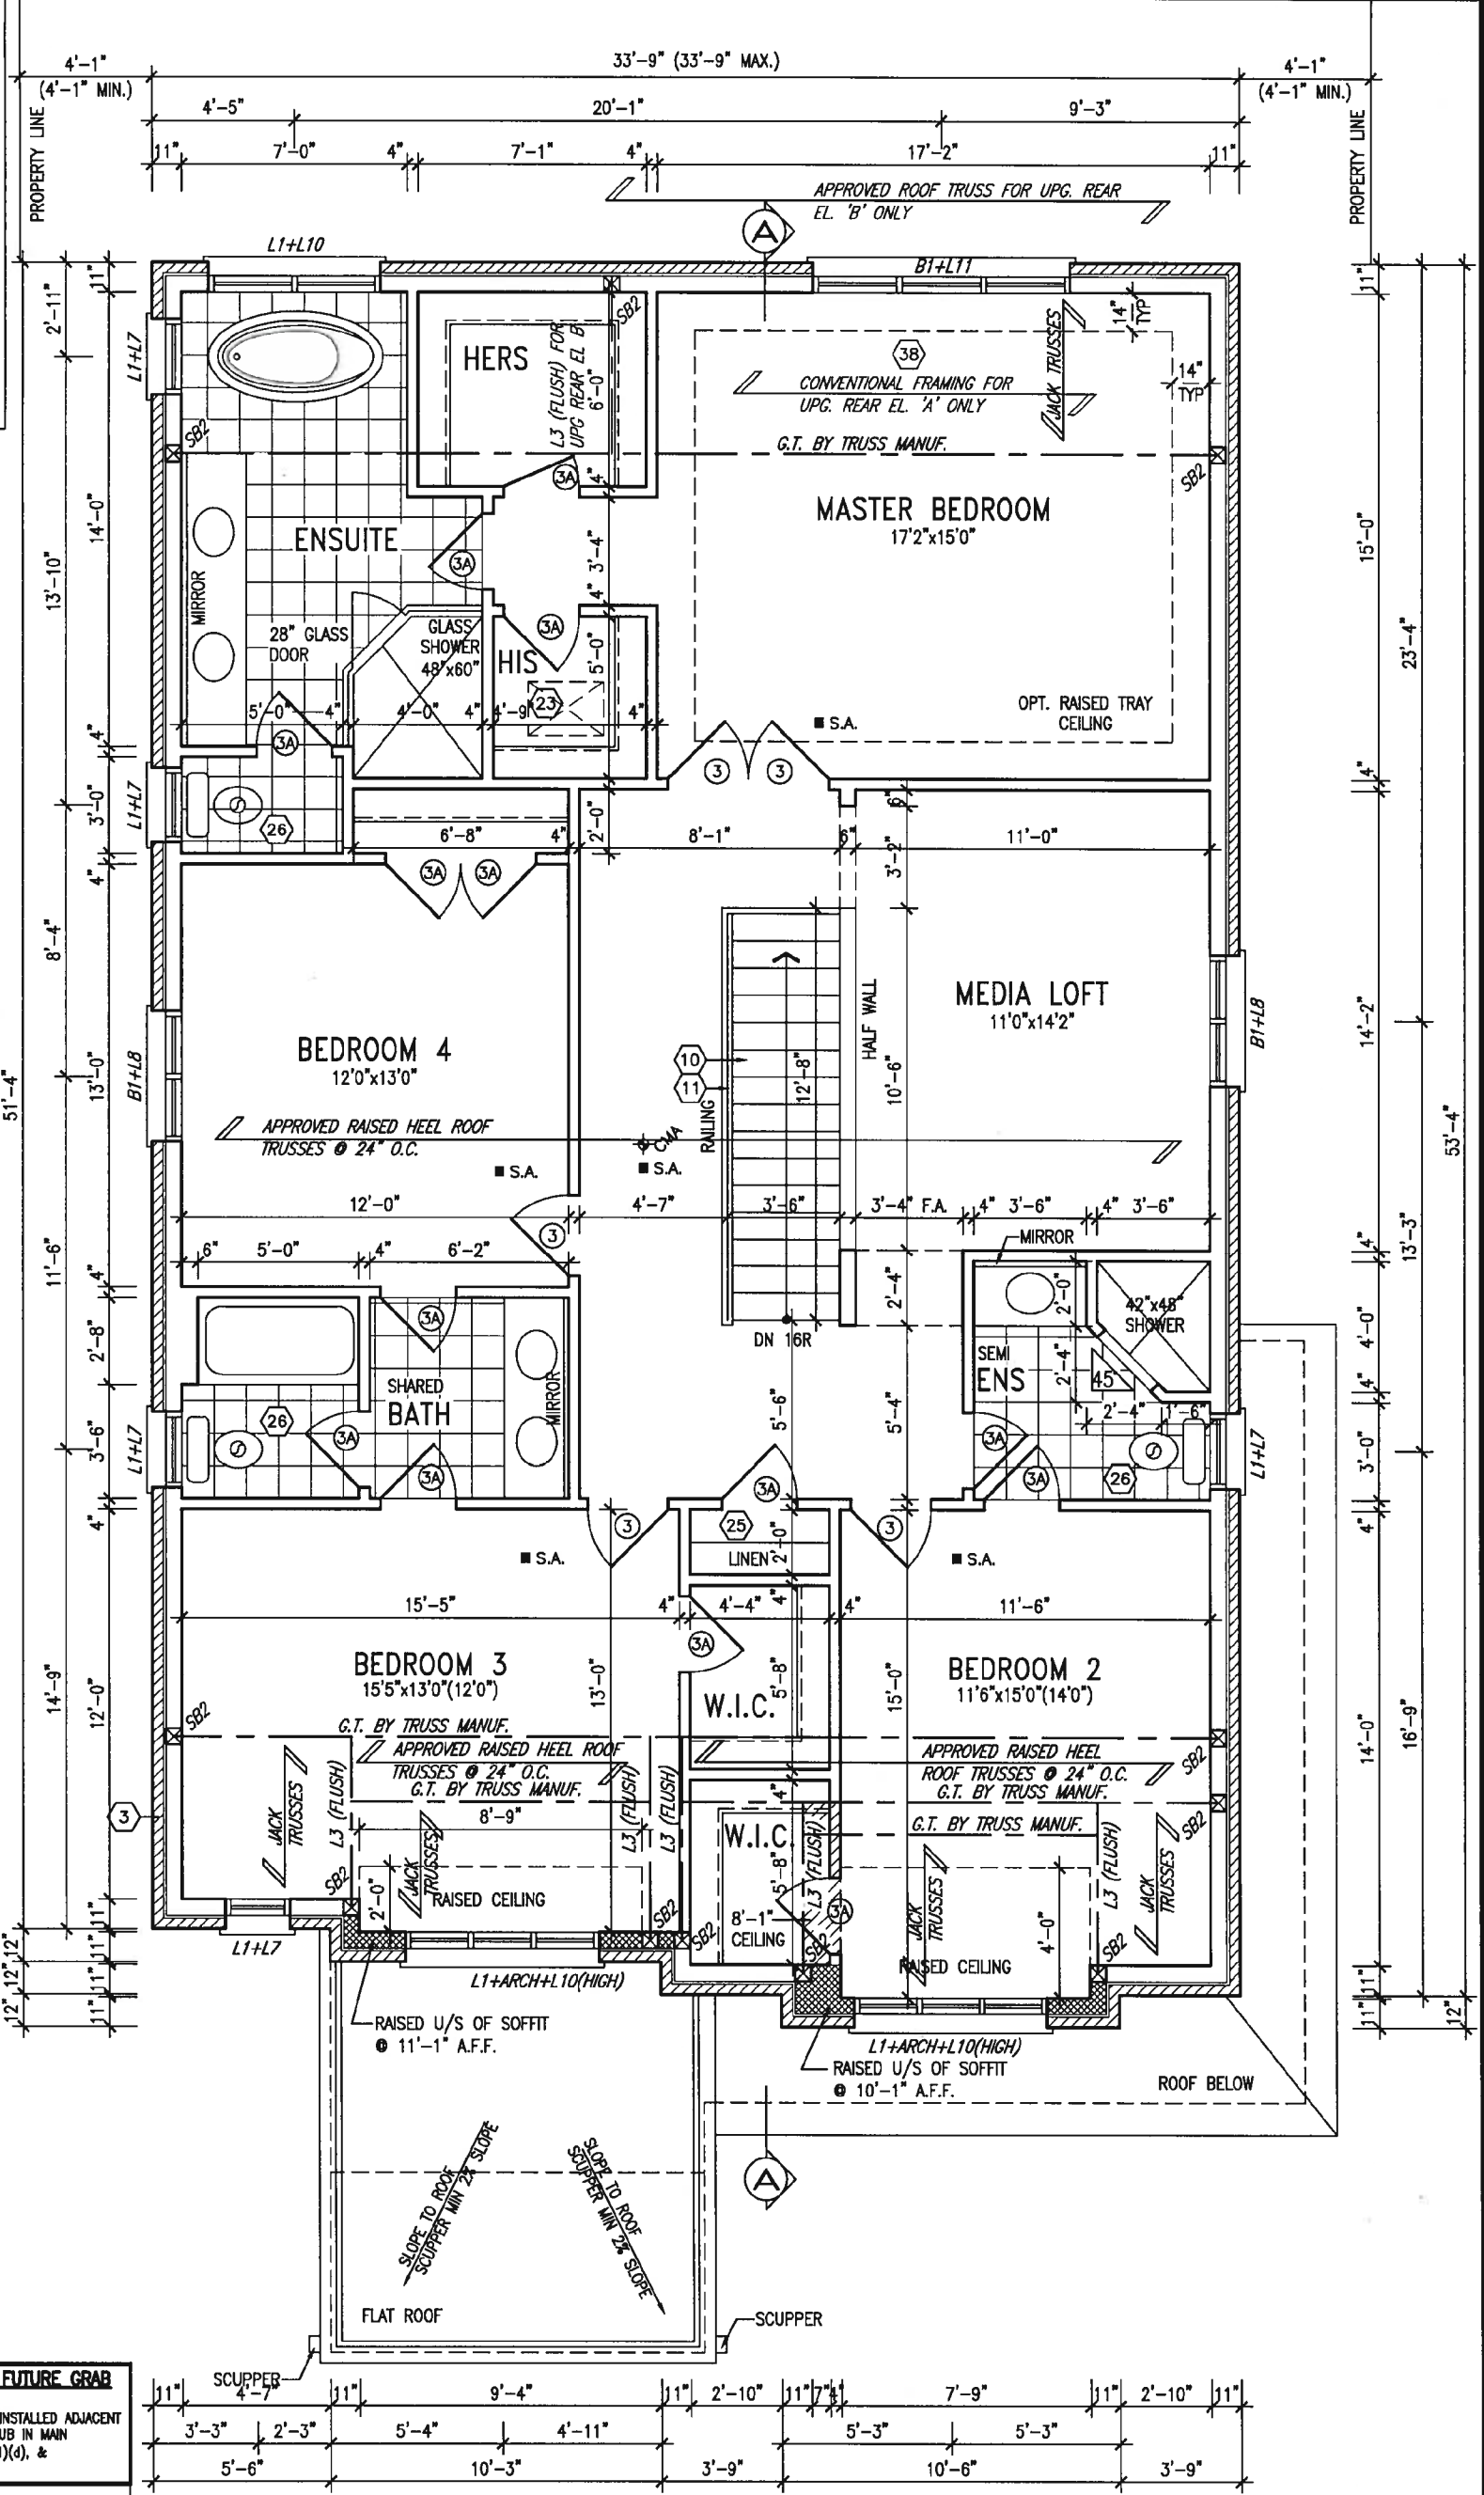
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ARCHITECTURAL REVIEW & APPROVAL  
JAN 31 2018  
John G. Williams Limited, Architect



**STUD WALL REINFORCEMENT FOR FUTURE GRAB BARS IN MAIN BATHROOM**  
REINFORCEMENT OF STUD WALLS SHALL BE INSTALLED ADJACENT TO WATER CLOSETS AND SHOWER OR BATHTUB IN MAIN BATHROOM AS PER O.B.C. 9.5.2.3, 3.8.3.8.(1)(d), & 3.8.3.13.(1)(f) AND DETAILS PROVIDED

**NOTE: ROOF FRAMING**  
ROOF TRUSS INFORMATION REFER TO ROOF TRUSS SHOP DRAWINGS FOR ALL ROOF FRAMING INFORMATION UNLESS OTHERWISE NOTED.

SECOND FLOOR PLAN 'A' 4 BEDROOM + MEDIA LOFT

Site Copy

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3					
2	REVISED AS PER ENG'S COMMENTS	JAN 25-18	RC		
1	ISSUED FOR CLIENT REVIEW				
no.	description	date	by		

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qualification information  
Wellington Jno-Baptiste 25591  
name registration information BCN  
VA3 Design Inc. 42658

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va3design.com

**BAYVIEW WELLINGTON**  
project name  
GREEN VALLEY EAST  
municipality  
BRADFORD  
date  
MARCH 2017  
drawn by  
SB  
checked by  
scale  
3/16" = 1'-0"  
file name  
16023-S42-15  
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**S42-15**  
RIDEAU 15  
project no.  
16023  
drawing no.  
3

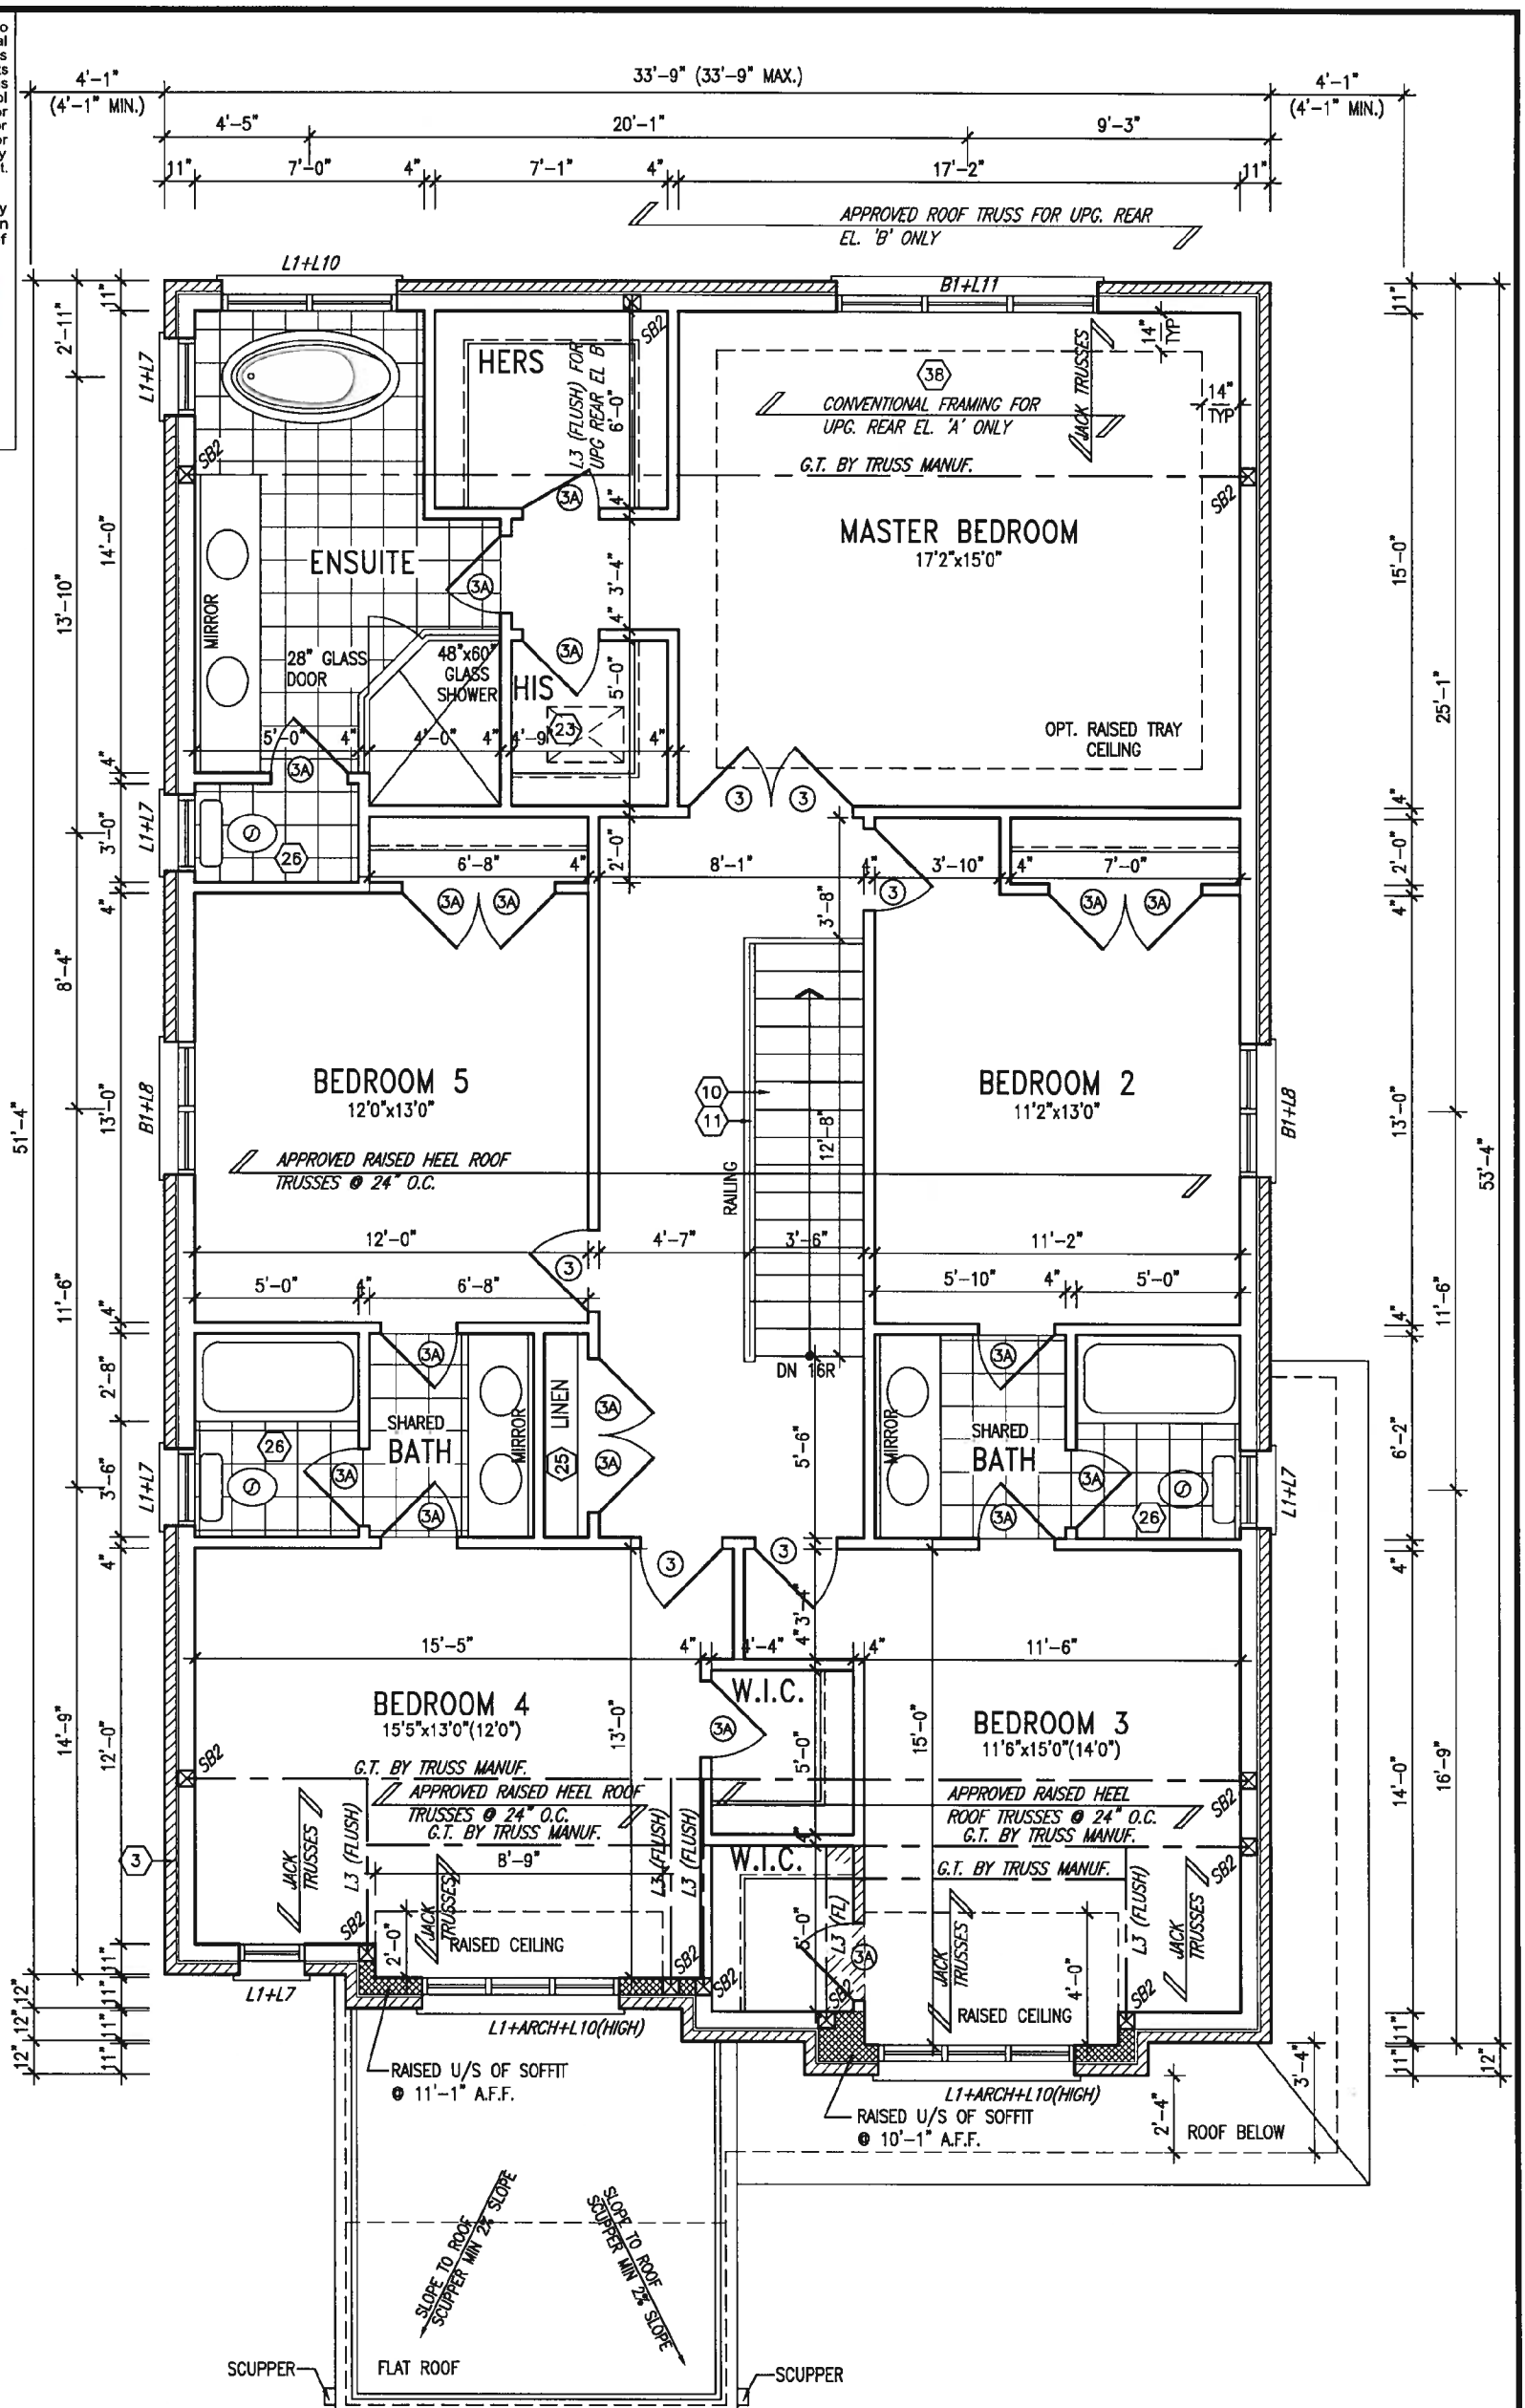
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ARCHITECTURAL REVIEW & APPROVAL

JAN 31 2018

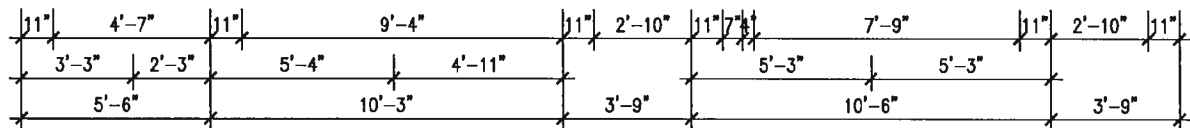
John G. Williams Limited, Architect



JAN 26, 2018

**STUD WALL REINFORCEMENT FOR FUTURE GRAB BARS IN MAIN BATHROOM**  
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ROOF TRUSS INFORMATION REFER TO ROOF TRUSS SHOP DRAWINGS FOR ALL ROOF FRAMING INFORMATION UNLESS OTHERWISE NOTED.



OPT. SECOND FLOOR PLAN 'A' 5 BEDROOM

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2	REVISED AS PER ENG'S COMMENTS	JAN 25-18	RC
1	ISSUED FOR CLIENT REVIEW		
no.	description	date	by

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name registration information  
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BAYVIEW WELLINGTON

project name  
GREEN VALLEY EAST

municipality  
BRADFORD

S42-15  
RIDEAU 15

project no.  
16023

date  
MARCH 2017

drawn by  
SB

checked by

scale  
3/16" = 1'-0"

OPT. SECOND FLOOR PLAN ELEVATION 'A'

file name  
16023-S42-15

drawing no.  
4

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ARCHITECTURAL REVIEW & APPROVAL

JAN 31 2018

John G. Williams Limited, Architect

**ELECTRIC VEHICLE CHARGING SYSTEM (EVCS)**  
ROUGH-IN FOR FUTURE ELECTRIC VEHICLE SUPPLY EQUIPMENT (CHARGING SYSTEM) TO BE INSTALLED.  
ROUGH-IN SHALL INCLUDE:  
• A minimum 200 amp Panelboard,  
• Conduit that is not less than 1 1/16" (27mm) trade size,  
• A square 4 11/16" (119mm) trade size electrical outlet box,  
• Fumeproofed Electrical outlet box to be installed in the Garage or carport or adjacent to driveway.

REFER TO 2012 OBC. 9.34.4.

NOTE:  
REFER TO STANDARD FLOOR PLANS FOR ADDITIONAL INFORMATION.

NOTE: ROOF FRAMING  
ROOF TRUSS INFORMATION REFER TO ROOF TRUSS SHOP DRAWINGS FOR ALL ROOF FRAMING INFORMATION UNLESS OTHERWISE NOTED.



JAN 26, 2018

NOTE R3:  
TWO PLY RUBBER MEMBRANE ADHERED TO EXT. TYPE 5/8" T&G PLYWOOD SHEATHING ON 2"x4" PURLINS LAID PERP. TO JOISTS SLOPED TO DRAIN, ON 2"x10" SPF. JOISTS @ 16" O.C. W/ SPRAY FOAM INSULATION R30 A/V BARRIER 5/8" GYPSUM BOARD

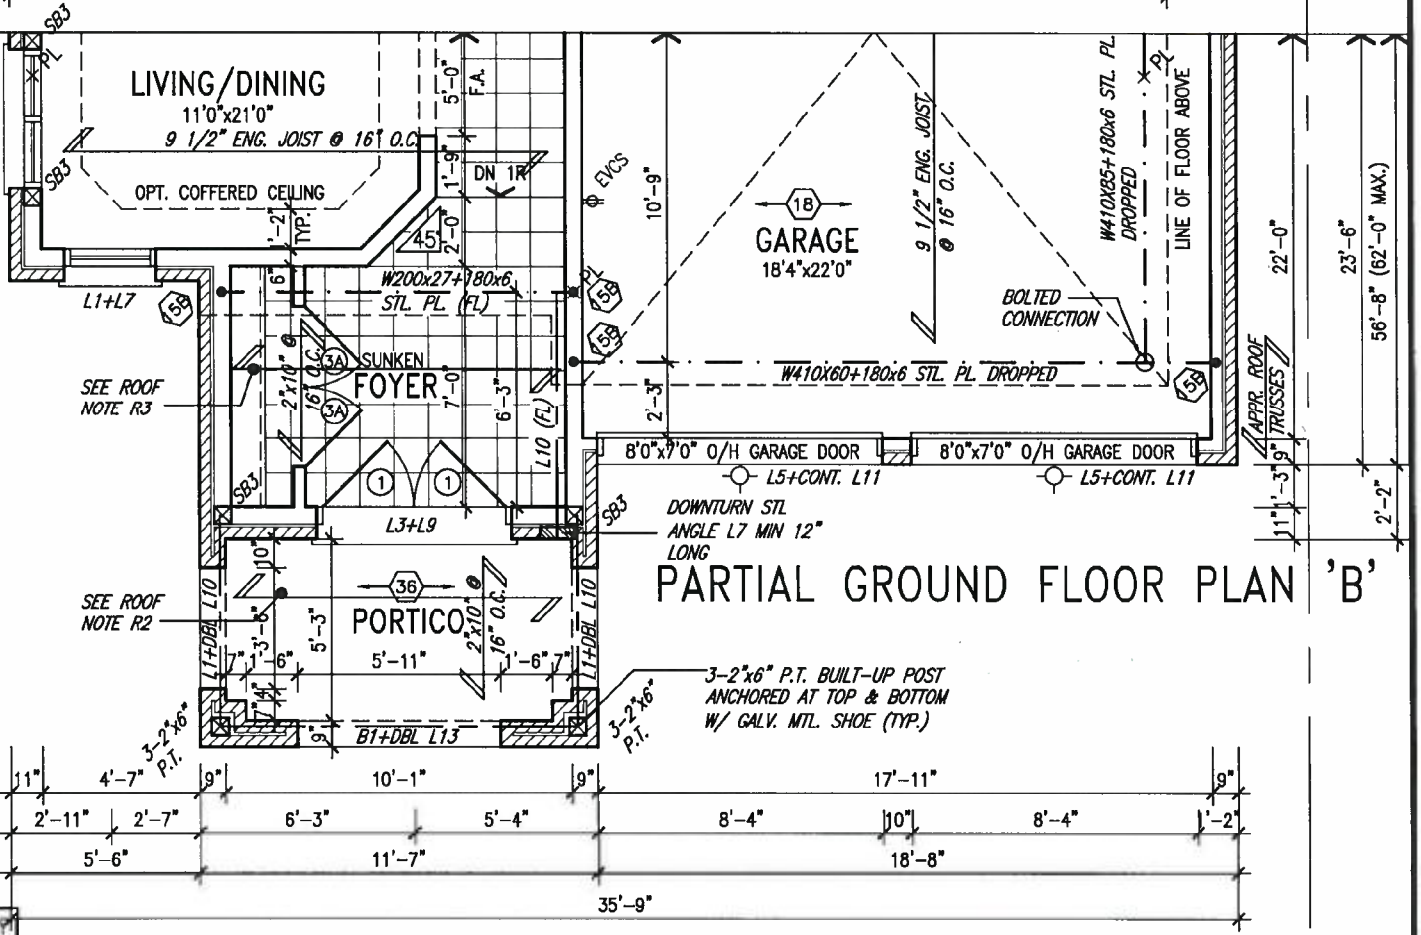
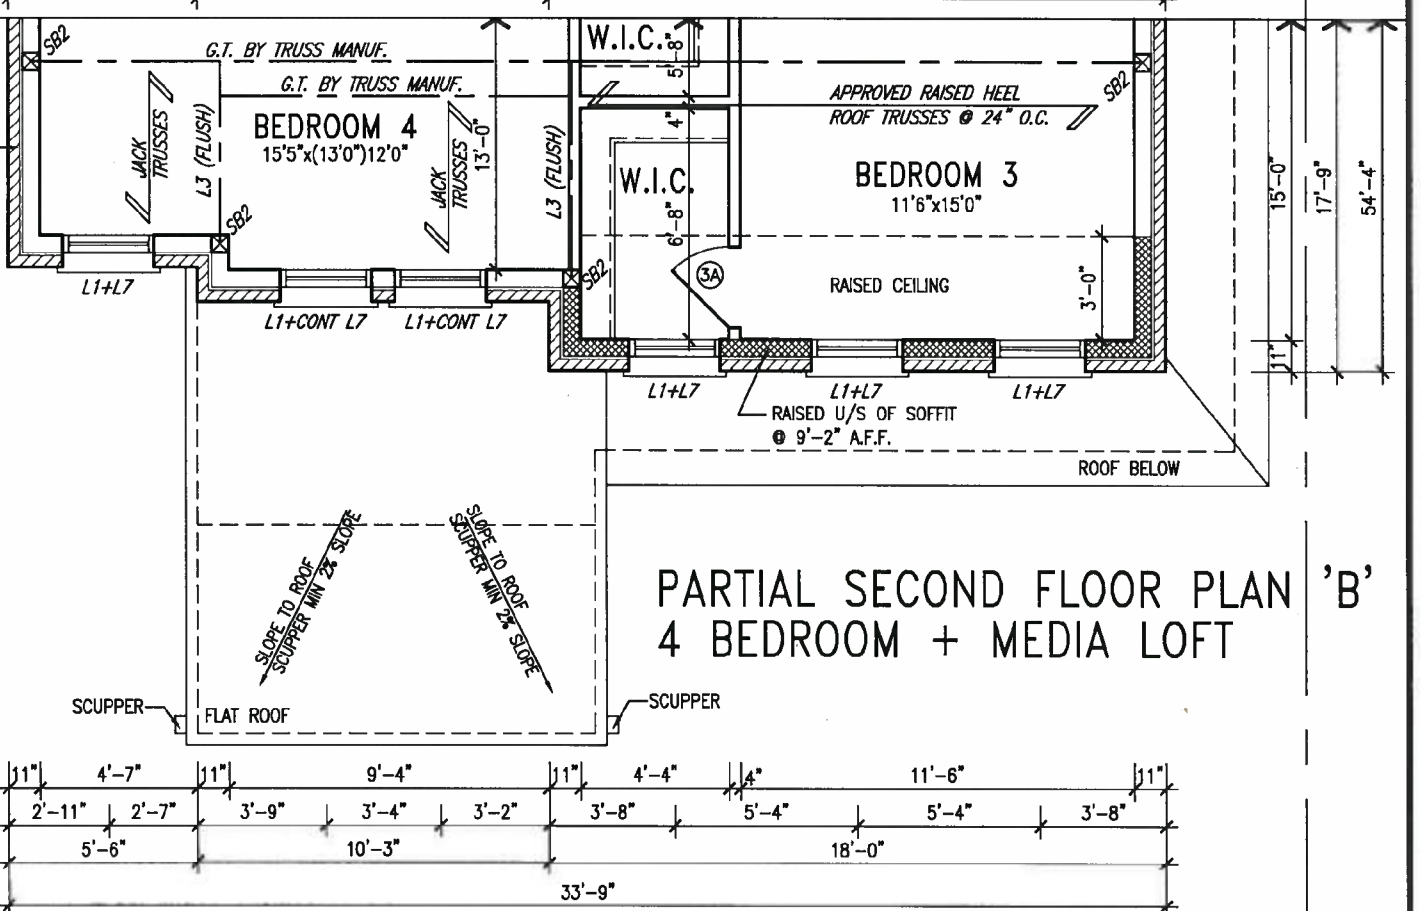
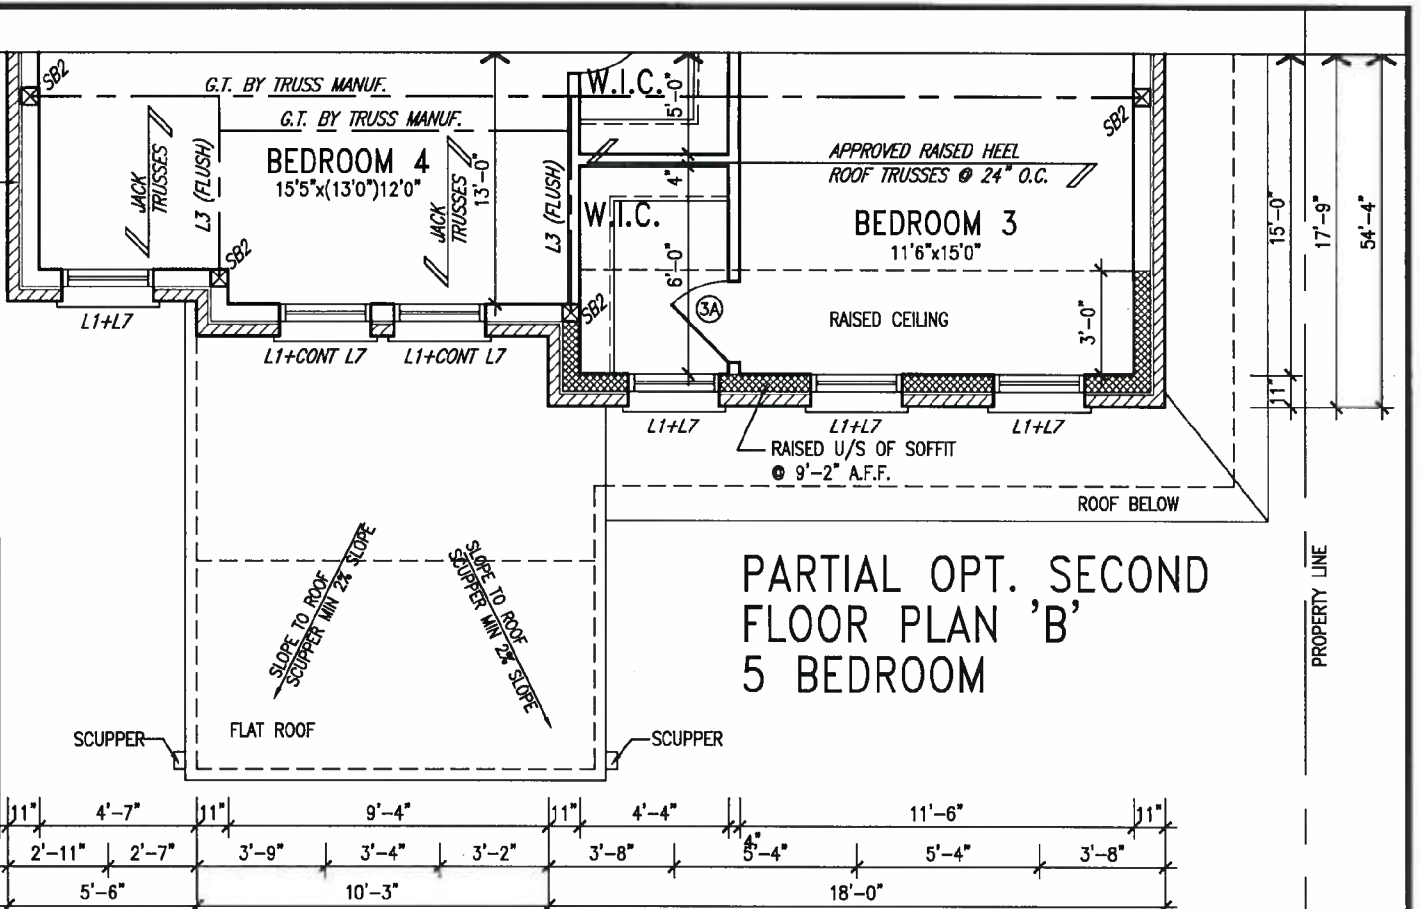
ROOF NOTE R2:  
2"x10" @ 16" O.C. P.T. W/ 2"x4" @ 12" O.C. DIAGONALLY CUT CROSS PURLINS W/ 5/8" EXTERIOR GRADE SHEATHING W/ TWO PLY ROOF MEMBRANE

NOTE:  
SPACE ALL FLOOR JOISTS @ 12" O.C. UNDER ALL CERAMIC TILE AREAS.

NOTE:  
ALL LV'S SUPPORTING FLOOR LOADS ARE TO BE SPECIFIED BY THE FLOOR TRUSS MANUFACTURER.

NOTE:  
FLOOR FRAMING INFO REFER TO ENG SHOP DRAWINGS FOR ALL TRUSS-JOIST INFORMATION AND DETAILS. UNLESS OTHERWISE NOTED.

INDICATES FIRE RATED WALL ASSEMBLY



Site Copy

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2	REVISED AS PER ENG'S COMMENTS	JAN 25-18	RC
1	ISSUED FOR CLIENT REVIEW		
no.	description	date	by

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qualification information  
Wellington Jno-Baptiste 25591  
name registration information  
VA3 Design Inc. 42858  
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VA3  
DESIGN

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Toronto ON M2J 1R4  
t 416.630.2255 f 416.630.4782  
va3design.com

BAYVIEW WELLINGTON

project name  
GREEN VALLEY EAST

municipality  
BRADFORD

S42-15  
RIDEAU 15

project no.  
16023

date  
MARCH 2017

PARTIAL PLANS ELEVATION 'B'

drawing no.

drawn by  
SB

checked by

scale  
3/16" = 1'-0"

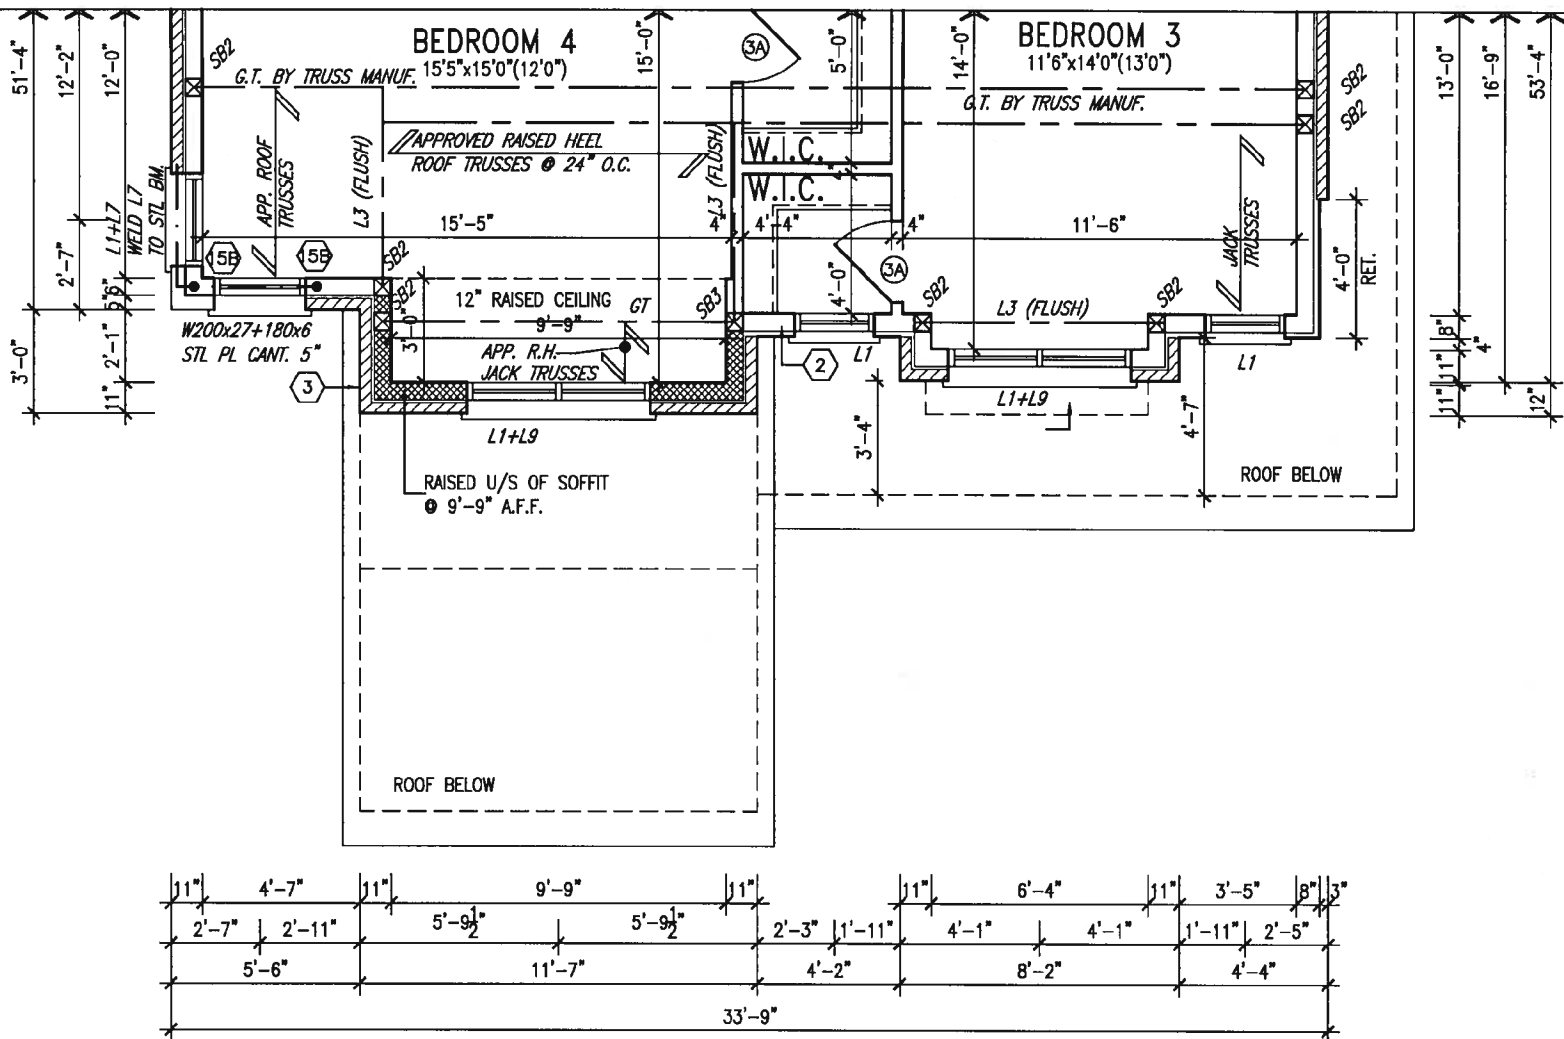
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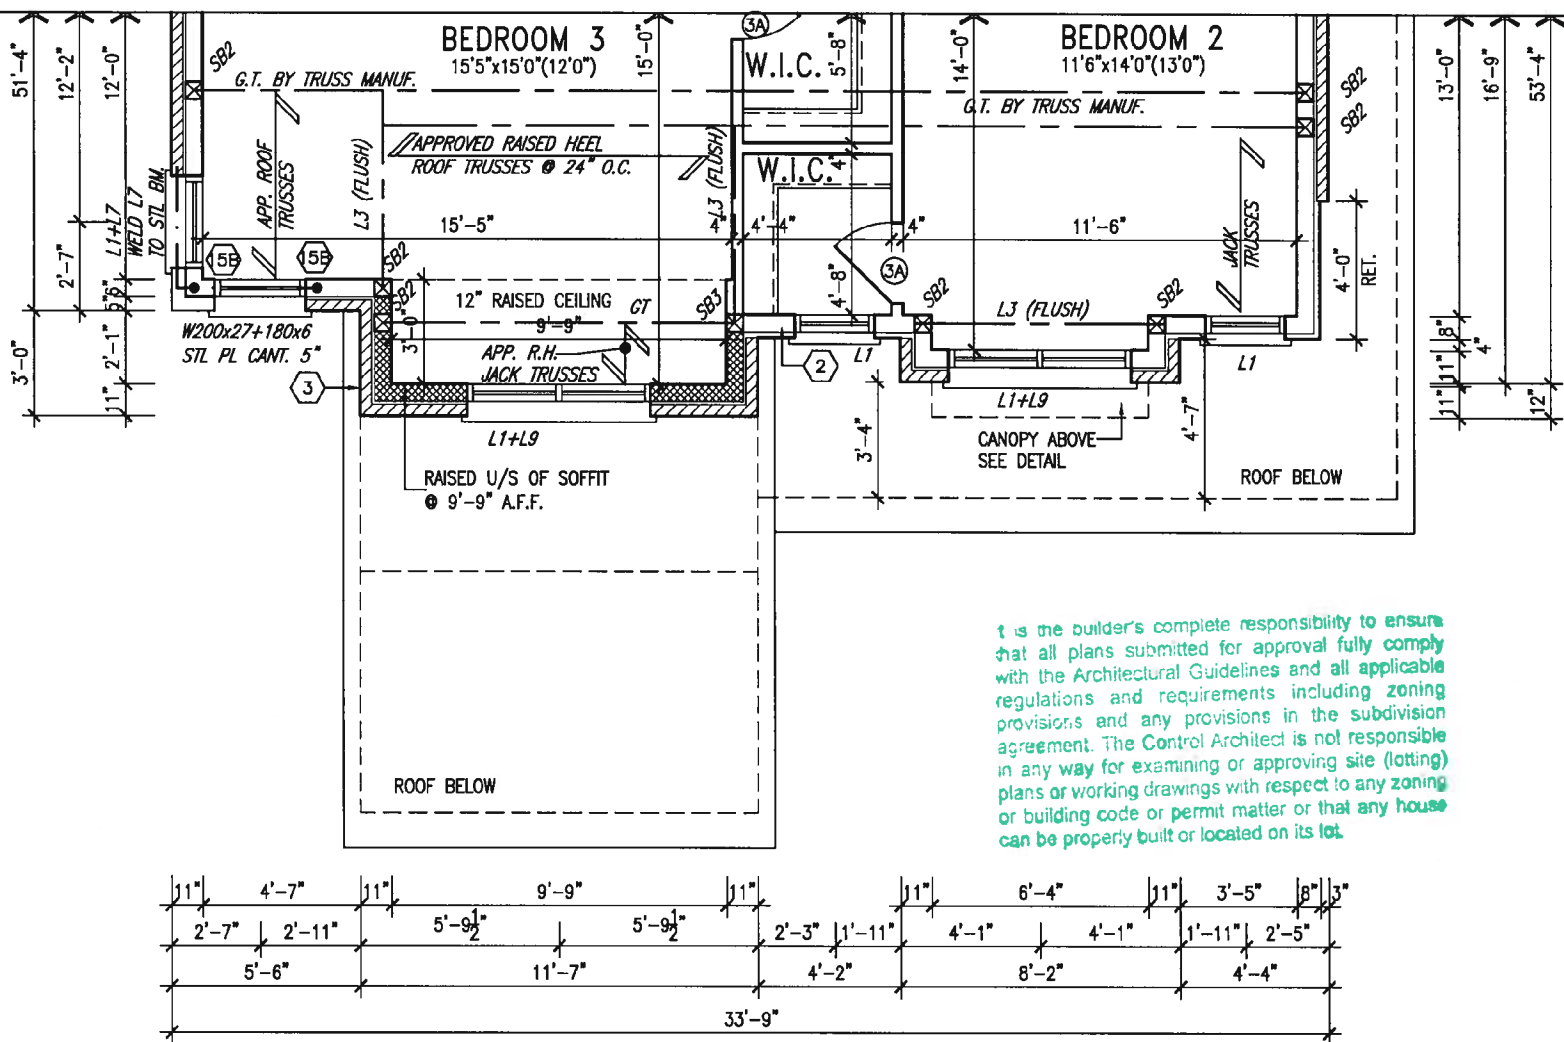
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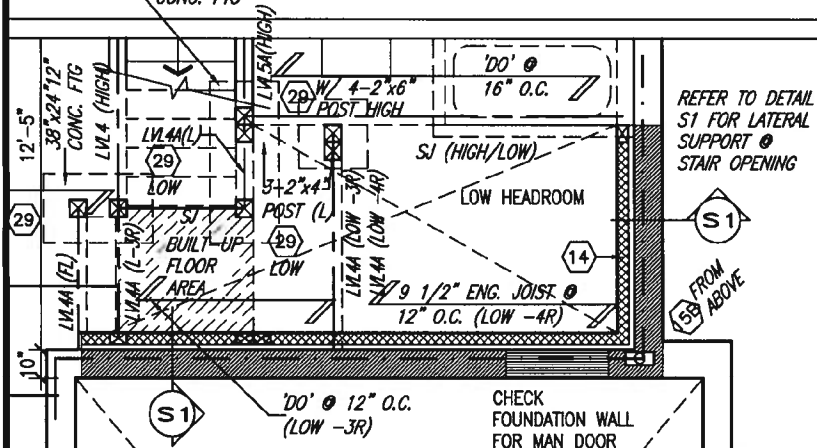




PARTIAL OPT. SECOND FLOOR PLAN 'C' 5 BEDROOM PLAN



PARTIAL SECOND FLOOR PLAN 'C' 4 BEDROOM + MEDIA LOFT



PARTIAL BASEMENT PLAN W/ SUNKEN LAUNDRY - 3R

ARCHITECTURAL REVIEW  
AND APPROVAL  
TOWN OF BRADFORD WEST GUILMBURY  
Signed:   
Date: **JAN 31 2018**  
JOHN G. WILLIAMS LIMITED ARCHITECT



Site Copy

no.	description	date	by
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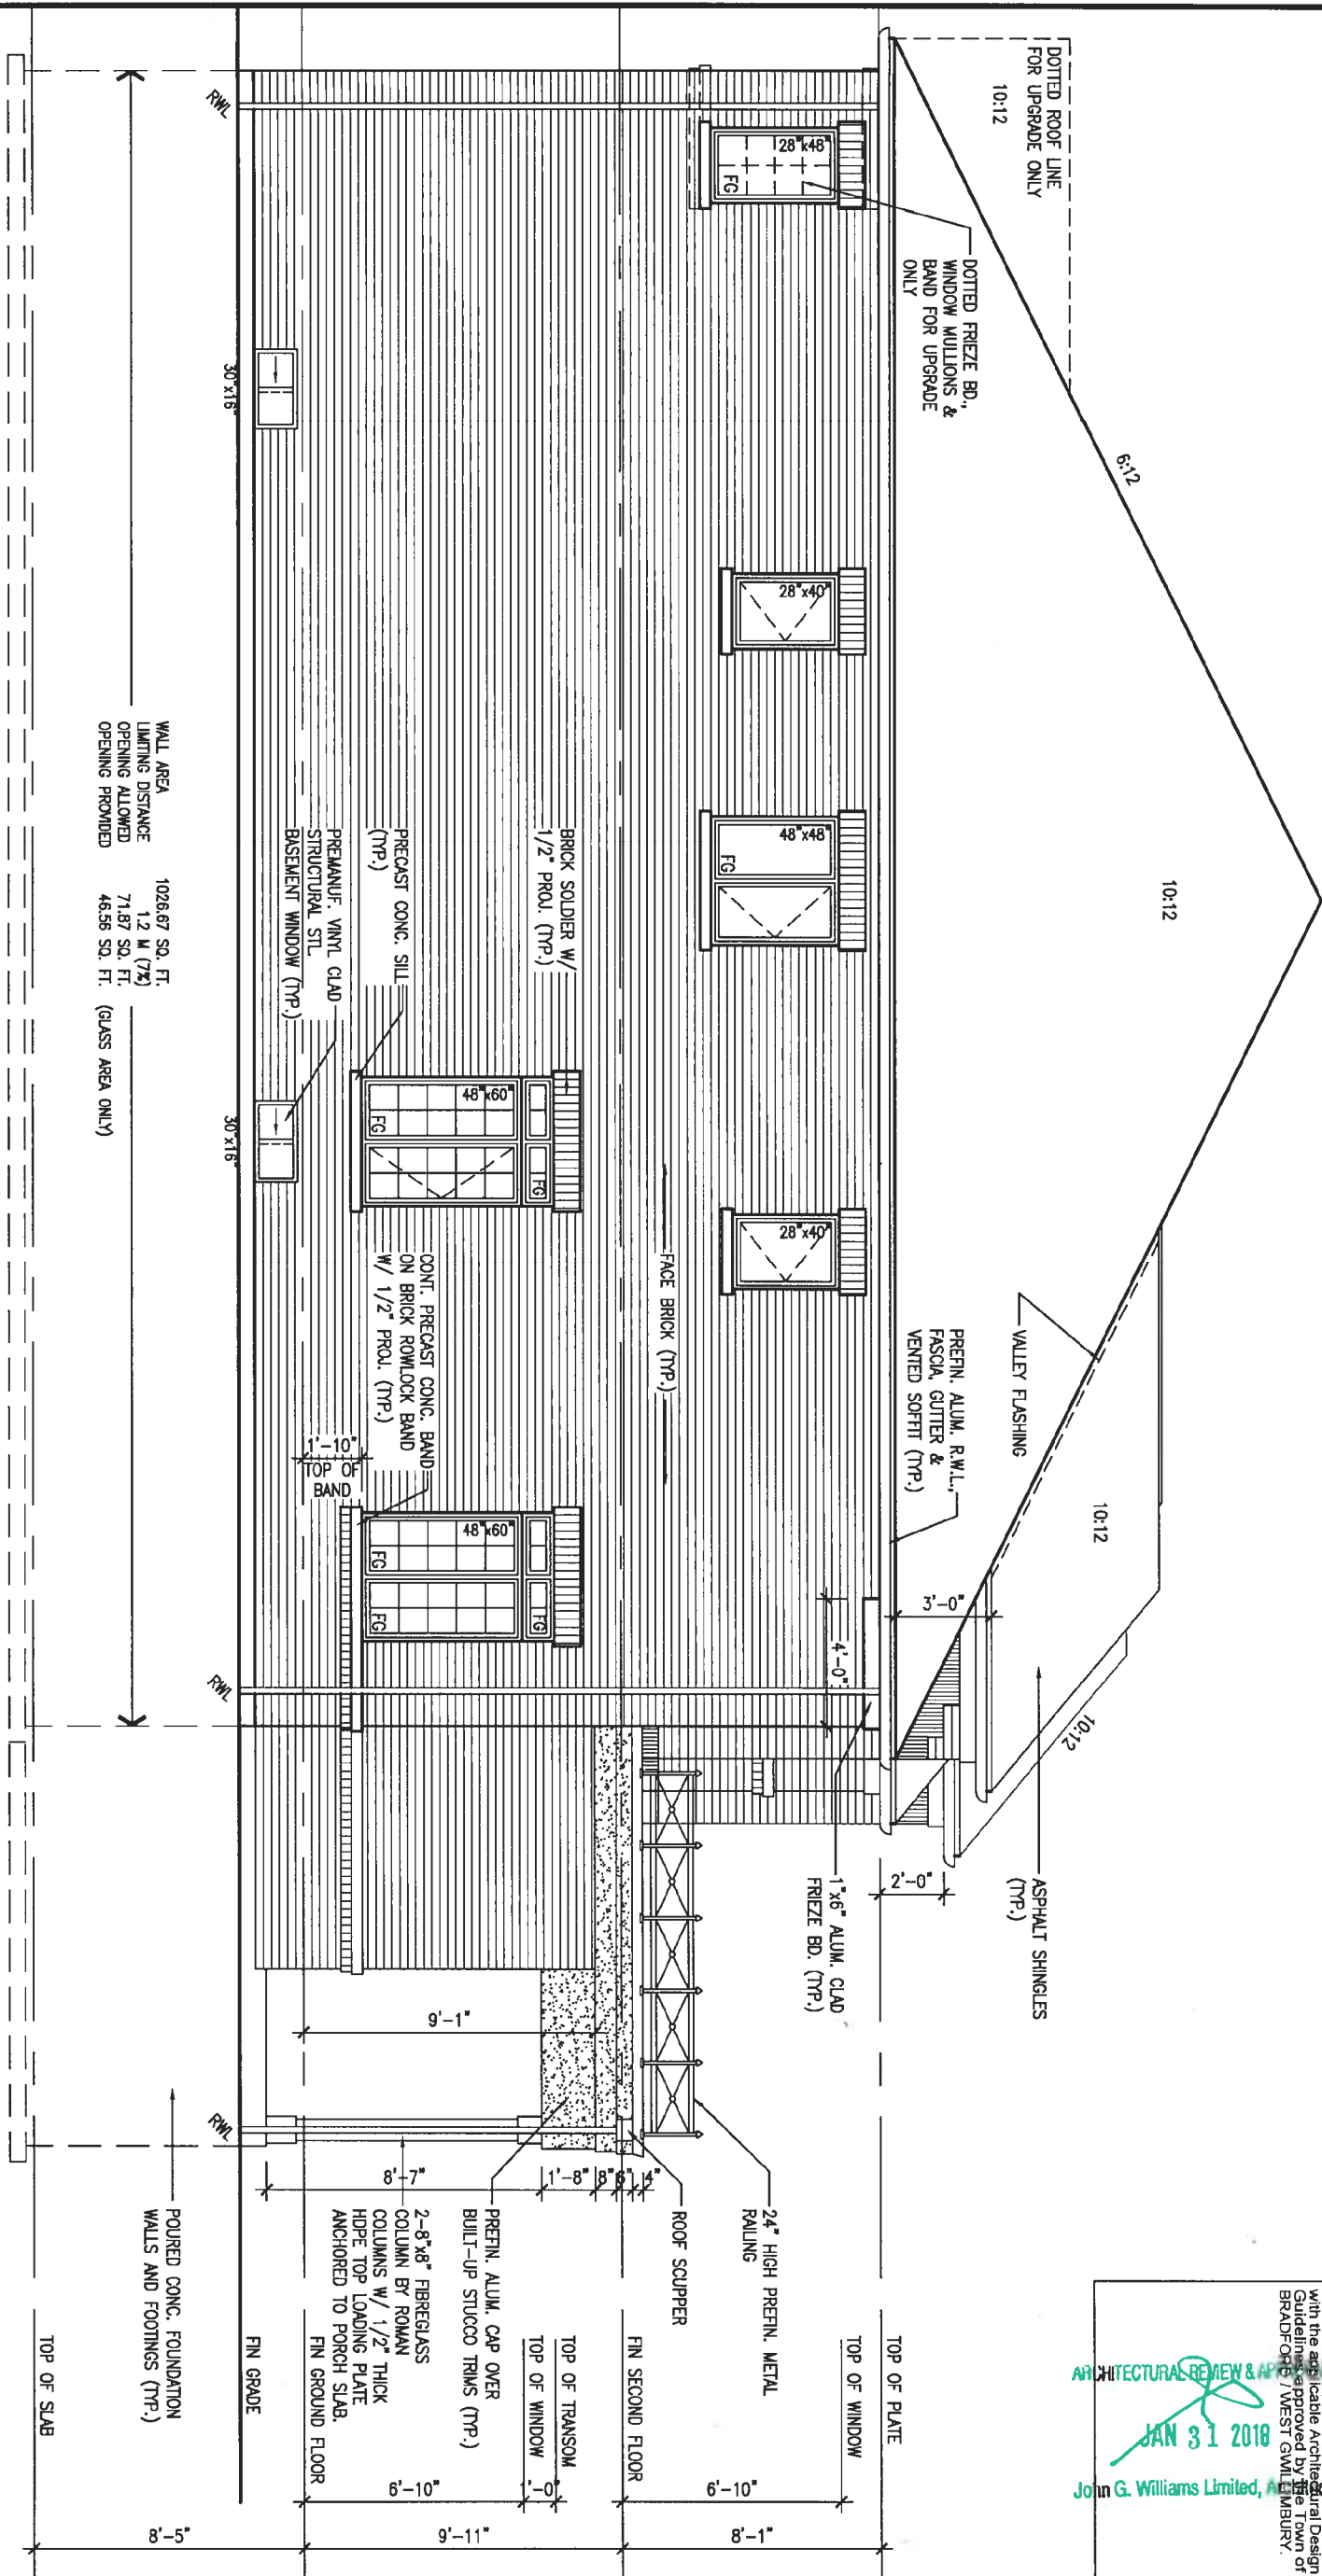
**VA3 DESIGN**  
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Toronto ON M2J 1R4  
t 416.630.2255 f 416.630.4782  
va3design.com

BAYVIEW WELLINGTON		S42-15	project no.
GREEN VALLEY EAST		RIDEAU 15	16023
project name	BRADFORD		
date	MARCH 2017	PARTIAL PLANS ELEVATION 'C'	drawing no.
drawn by	SB	16023-S42-15	7
checked by	scale 3/16" = 1'-0"		
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LEFT SIDE ELEVATION 'A'



WALL AREA  
LIMITING DISTANCE  
OPENING PROVIDED

1026.67 SQ. FT.  
1.2 M (7%)  
71.87 SQ. FT.  
46.56 SQ. FT. (GLASS AREA ONLY)



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ARCHITECTURAL REVIEW & APPROVAL  
JAN 31 2018  
John G. Williams Limited, Architect

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no.	description	date	by

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qualification information  
Wellington Jno-Baptiste 25591  
signature  
name  
registration information  
VA3 Design Inc. 42658

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va3design.com

**BAYVIEW WELLINGTON**

project name  
**GREEN VALLEY EAST**

drawn by  
SB

checked by  
3/16" = 1'-0"

scale

date  
MARCH 2017

file name  
16023-S42-15

16023-S42-15

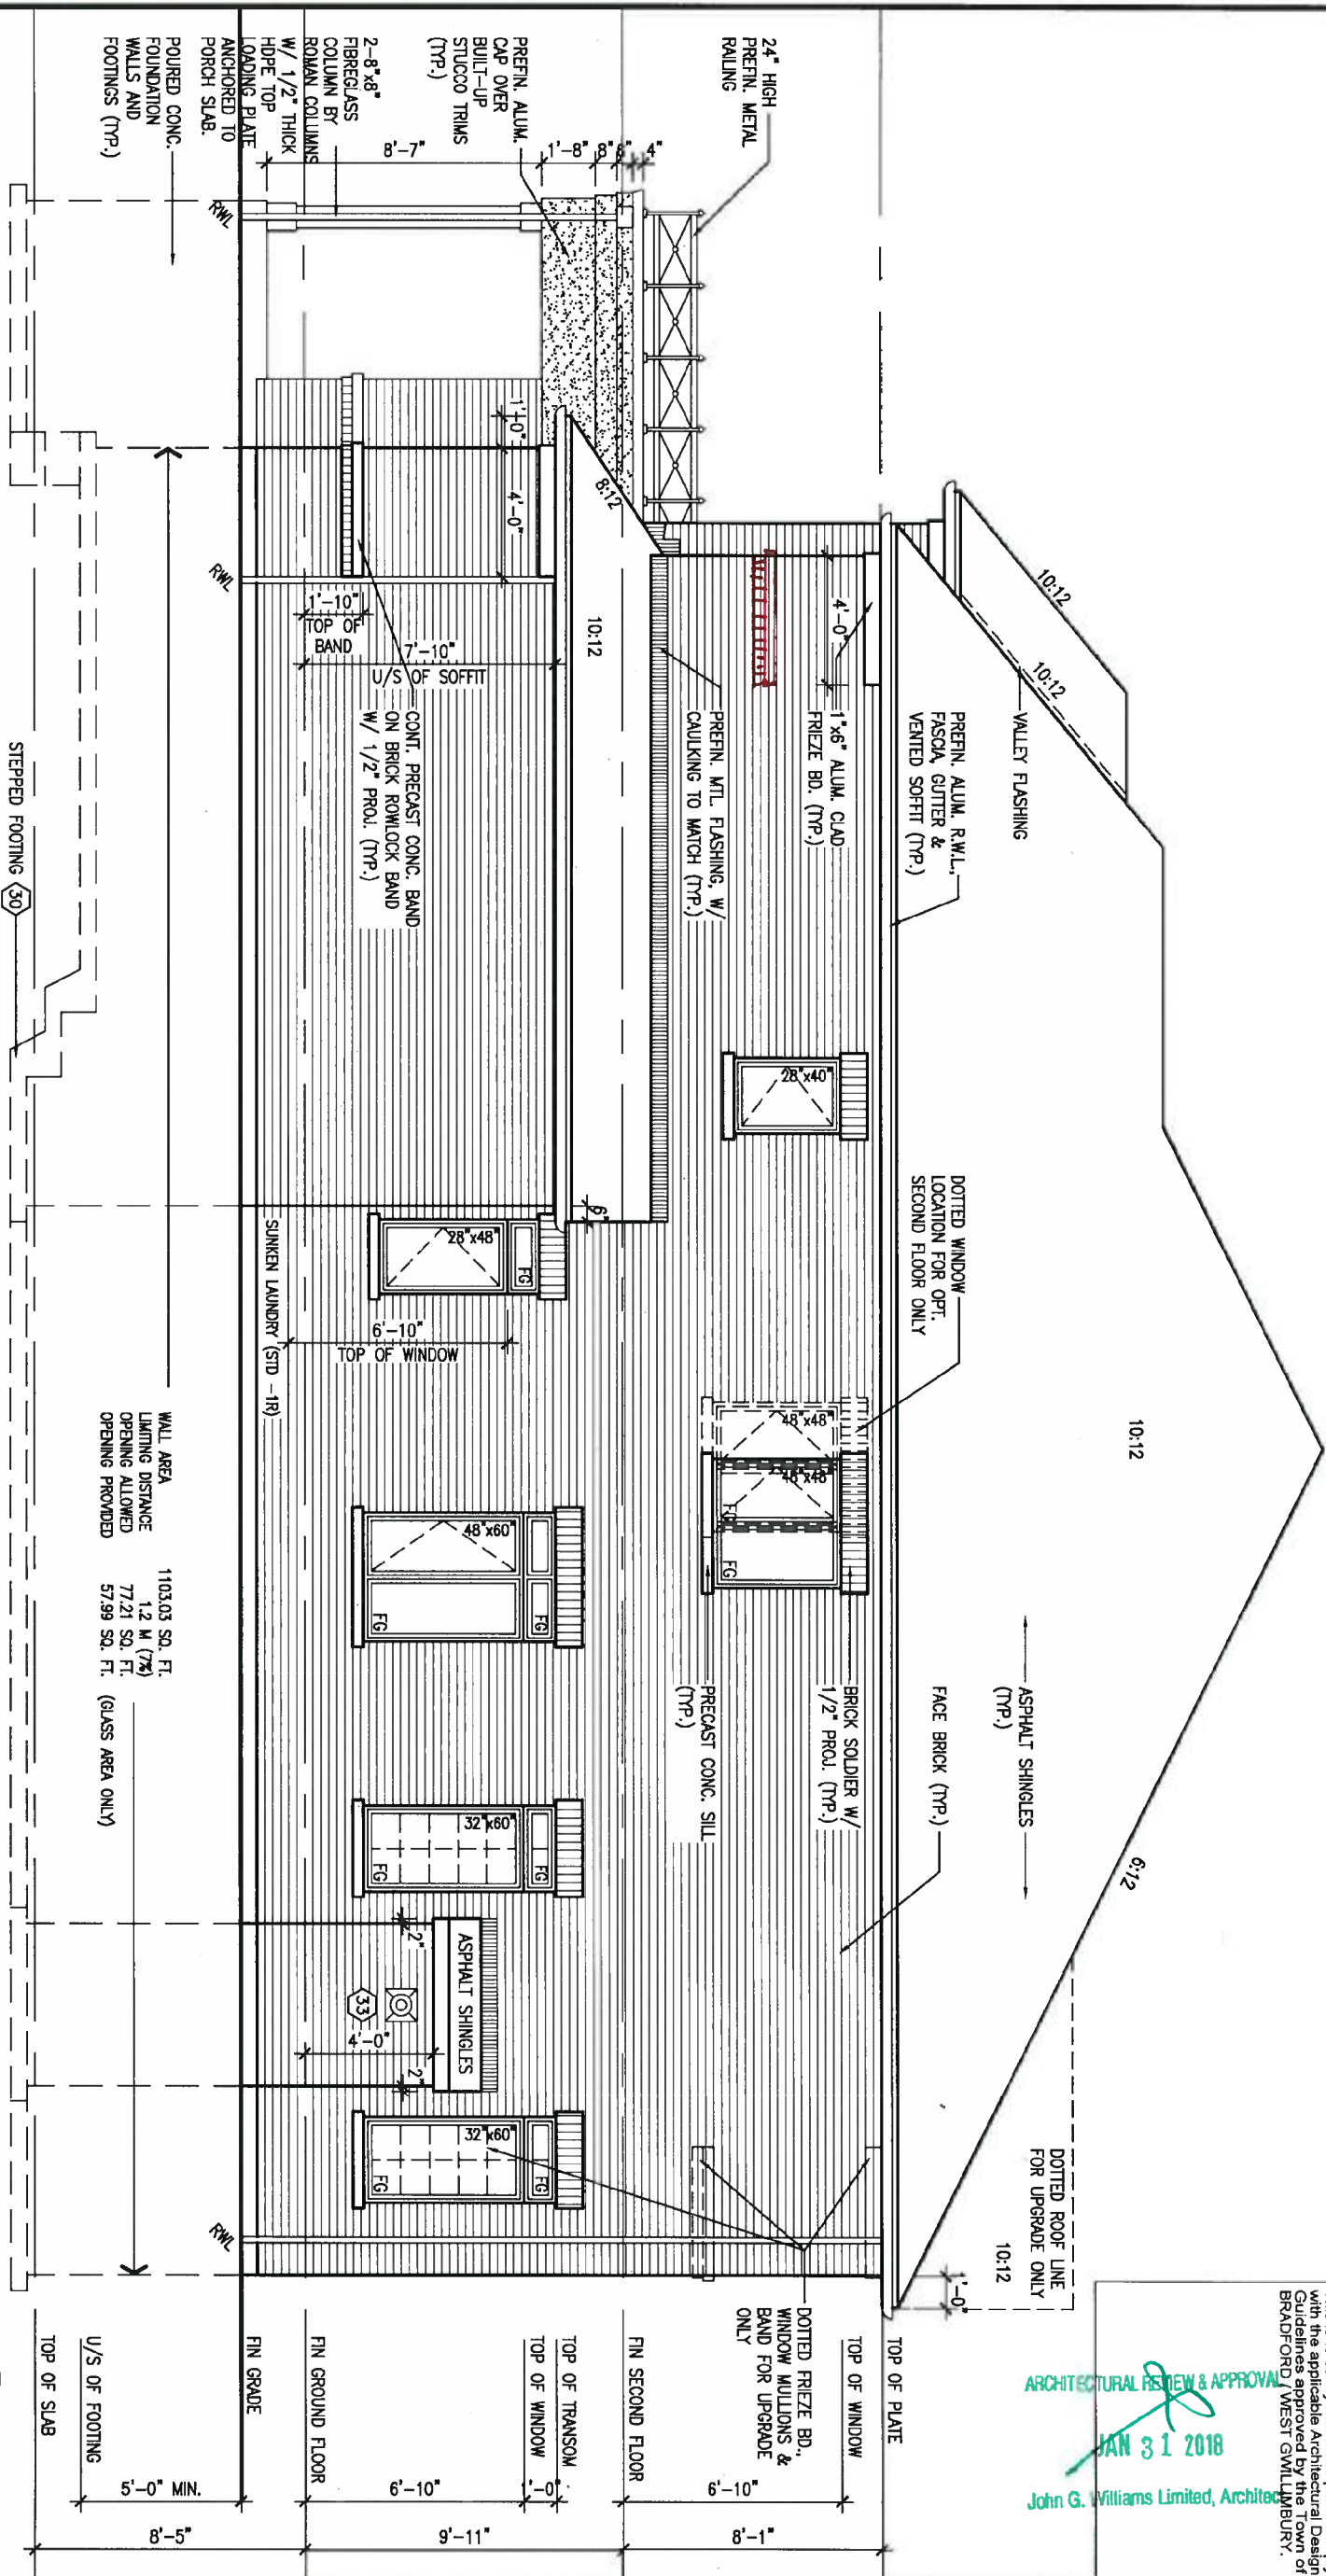
**S42-15**  
RIDEAU 15

project no.  
16023

municipality  
BRADFORD

drawing no.  
9

1'-0" 1'-0"



RIGHT SIDE ELEVATION 'A'



This is to certify that these plans comply with the applicable Architectural Design Guidelines approved by the Town of BRADFORD / WEST GUILMBURY.

ARCHITECTURAL REVIEW & APPROVAL  
JAN 31 2018  
John G. Williams Limited, Architect

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qualification information		
Wellington Jno-Baptiste	25591	
name	BCN	
registration information	42658	
VA3 Design Inc.		
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**VA3 DESIGN**

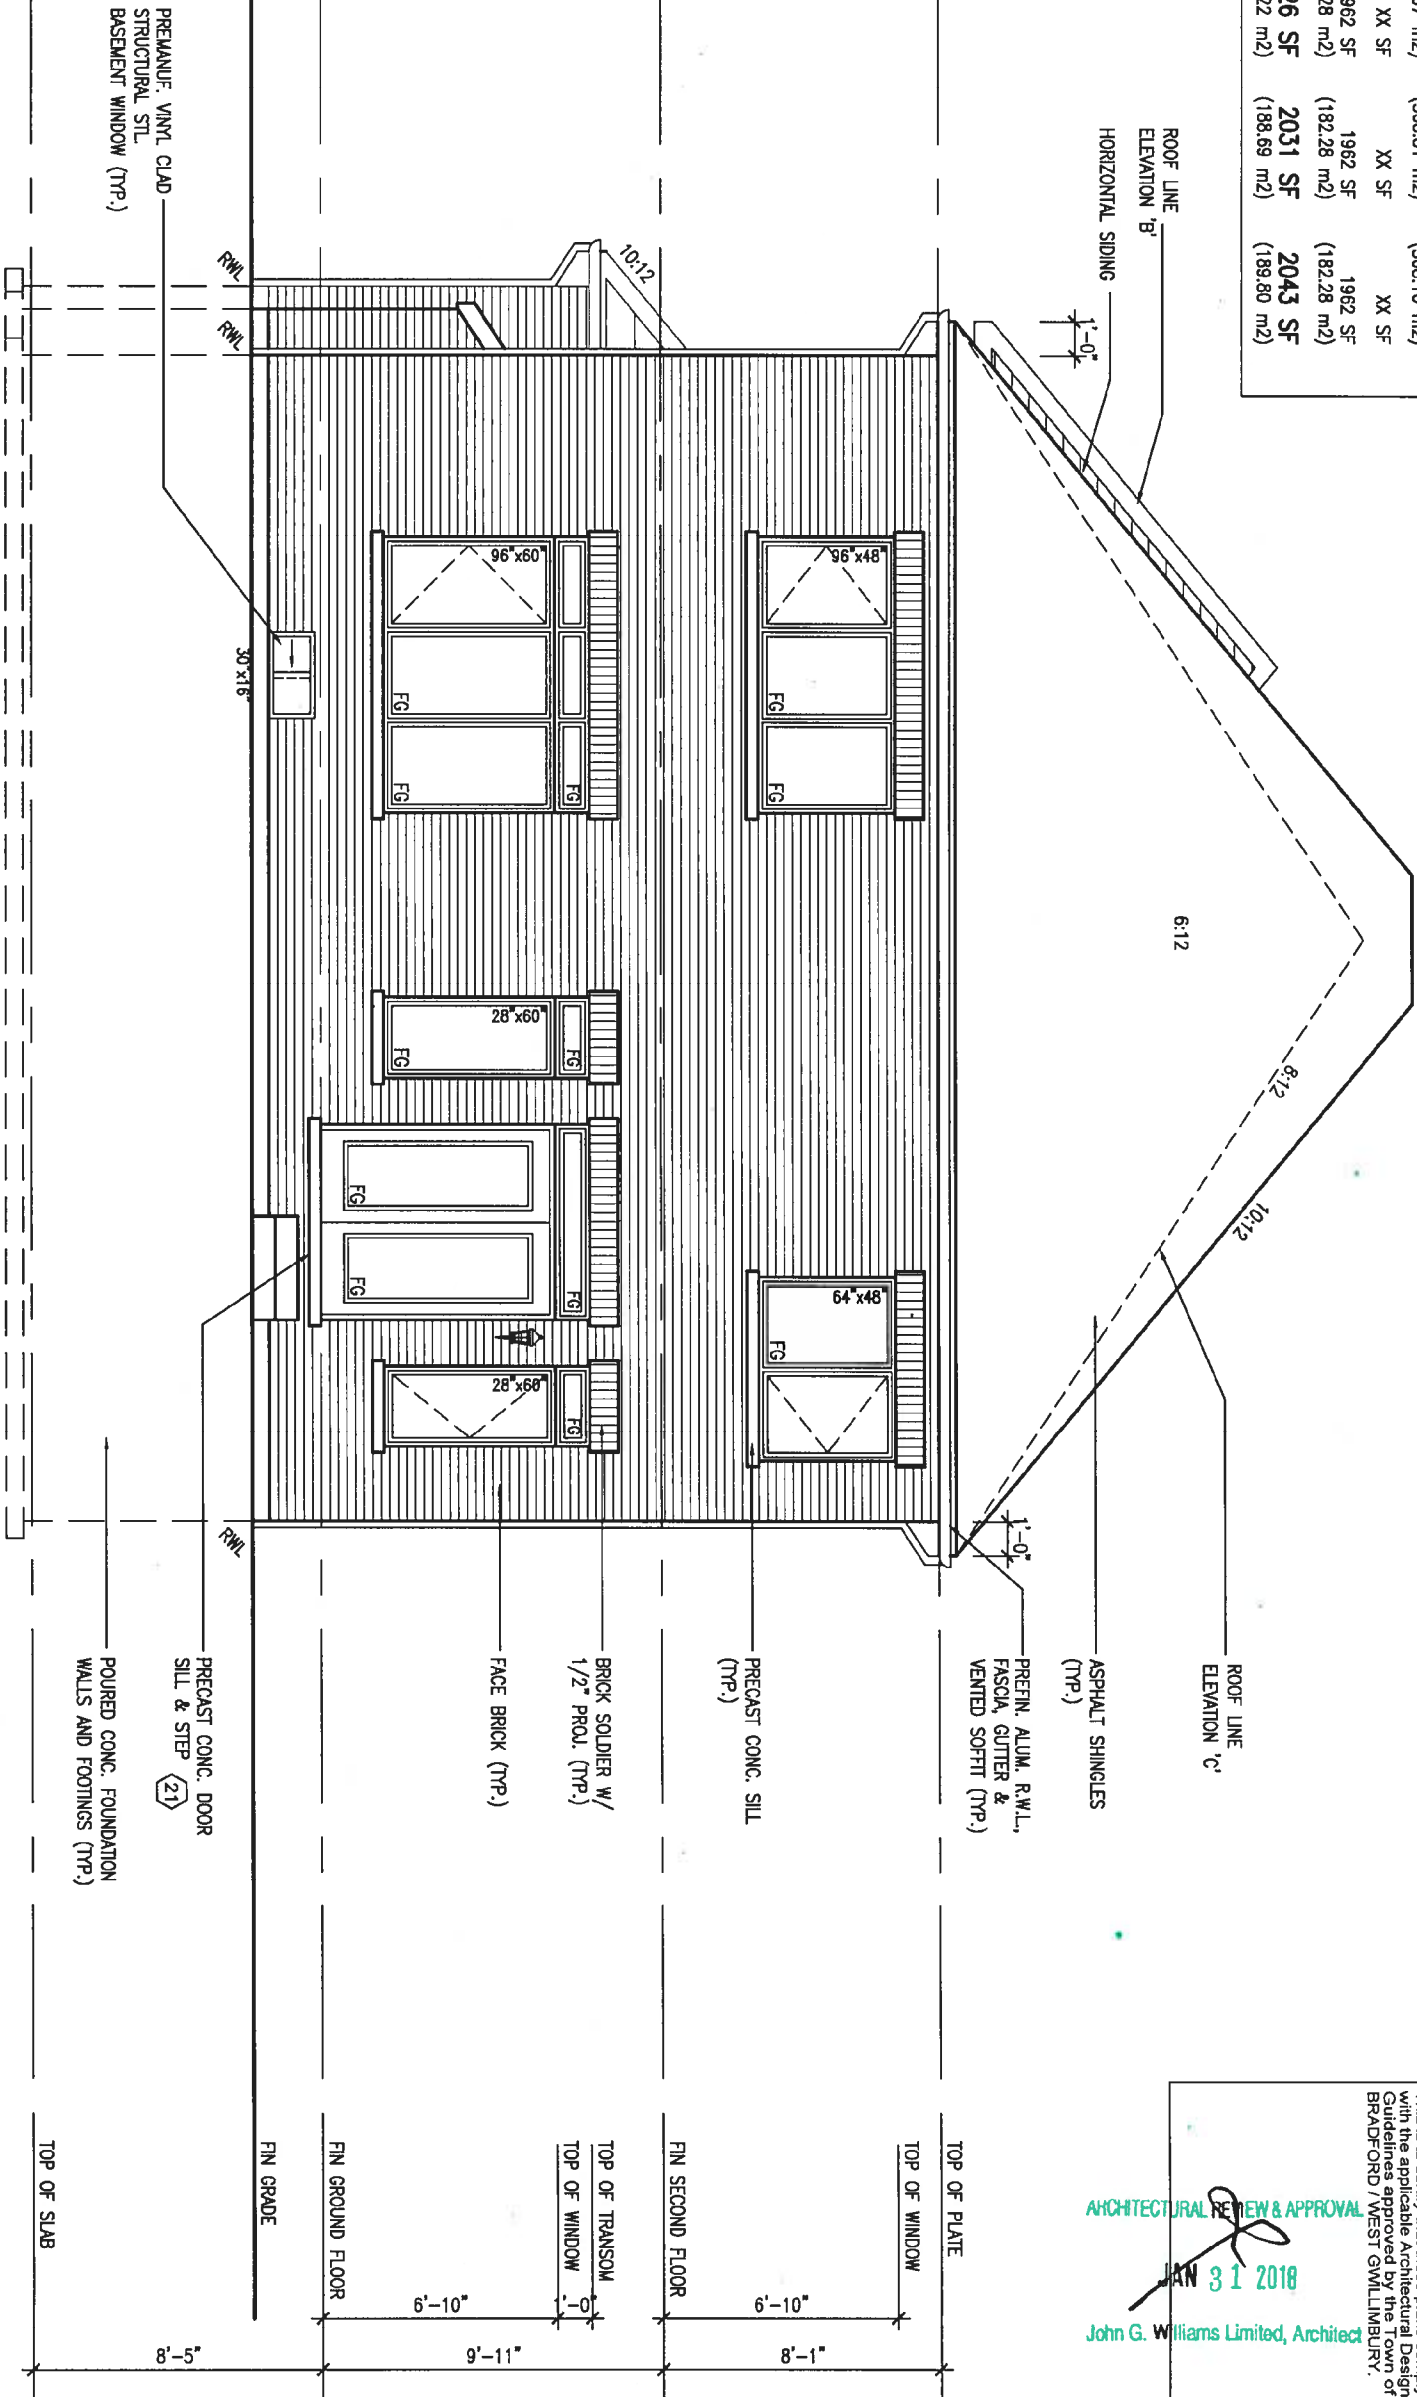
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Toronto ON M2J 1R4  
t 416.630.2255 f 416.630.4782  
va3design.com

<b>BAYVIEW WELLINGTON</b>	
project name	GREEN VALLEY EAST
date	MARCH 2017
drawn by	SB
checked by	3/16" = 1'-0"
scale	
RIGHT SIDE ELEVATION 'A'	
file name	16023-S42-15
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<b>S42-15</b>	project no.
RIDEAU 15	16023
municipality	BRADFORD
drawing no.	10



AREA CALCULATIONS			
	ELEV. A	ELEV. B	ELEV. C
GROUND FLOOR AREA	1527 SF	1527 SF	1527 SF
SECOND FLOOR AREA	1789 SF	1797 SF	1790 SF
SUBTOTAL	3316 SF	3324 SF	3317 SF
DEDUCT ALL OPEN AREAS	0 SF	0 SF	0 SF
<b>TOTAL NET AREA</b>	<b>3316 SF</b> (308.07 m <sup>2</sup> )	<b>3324 SF</b> (308.81 m <sup>2</sup> )	<b>3317 SF</b> (308.16 m <sup>2</sup> )
FINISHED BSMT AREA	XX SF	XX SF	XX SF
COVERAGE W/OUT PORCH	1962 SF (182.28 m <sup>2</sup> )	1962 SF (182.28 m <sup>2</sup> )	1962 SF (182.28 m <sup>2</sup> )
<b>COVERAGE W/ PORCH</b>	<b>2026 SF</b> (188.22 m <sup>2</sup> )	<b>2031 SF</b> (188.69 m <sup>2</sup> )	<b>2043 SF</b> (189.80 m <sup>2</sup> )



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8 .		qualification information		BCIN	
7 .		Wellington Jno-Baptiste		42658	
6 .		name			
5 .		registration information			
4 .		VA3 Design Inc.			
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<b>BAYVIEW WELLINGTON</b>		<b>S42-15</b> RIDEAU 15	
project name	GREEN VALLEY EAST	municipality	BRADFORD
date	MARCH 2017	project no.	16023
drawn by	SB	drawing no.	11
checked by	3/16" = 1'-0"	file name	16023-S42-15
RICHARD - H:\ARCHIVE\WORKING\2016\16023.BW\Units\42\16023-S42-15.dwg - Fri - Jan 26 2018 - 11:30 AM			

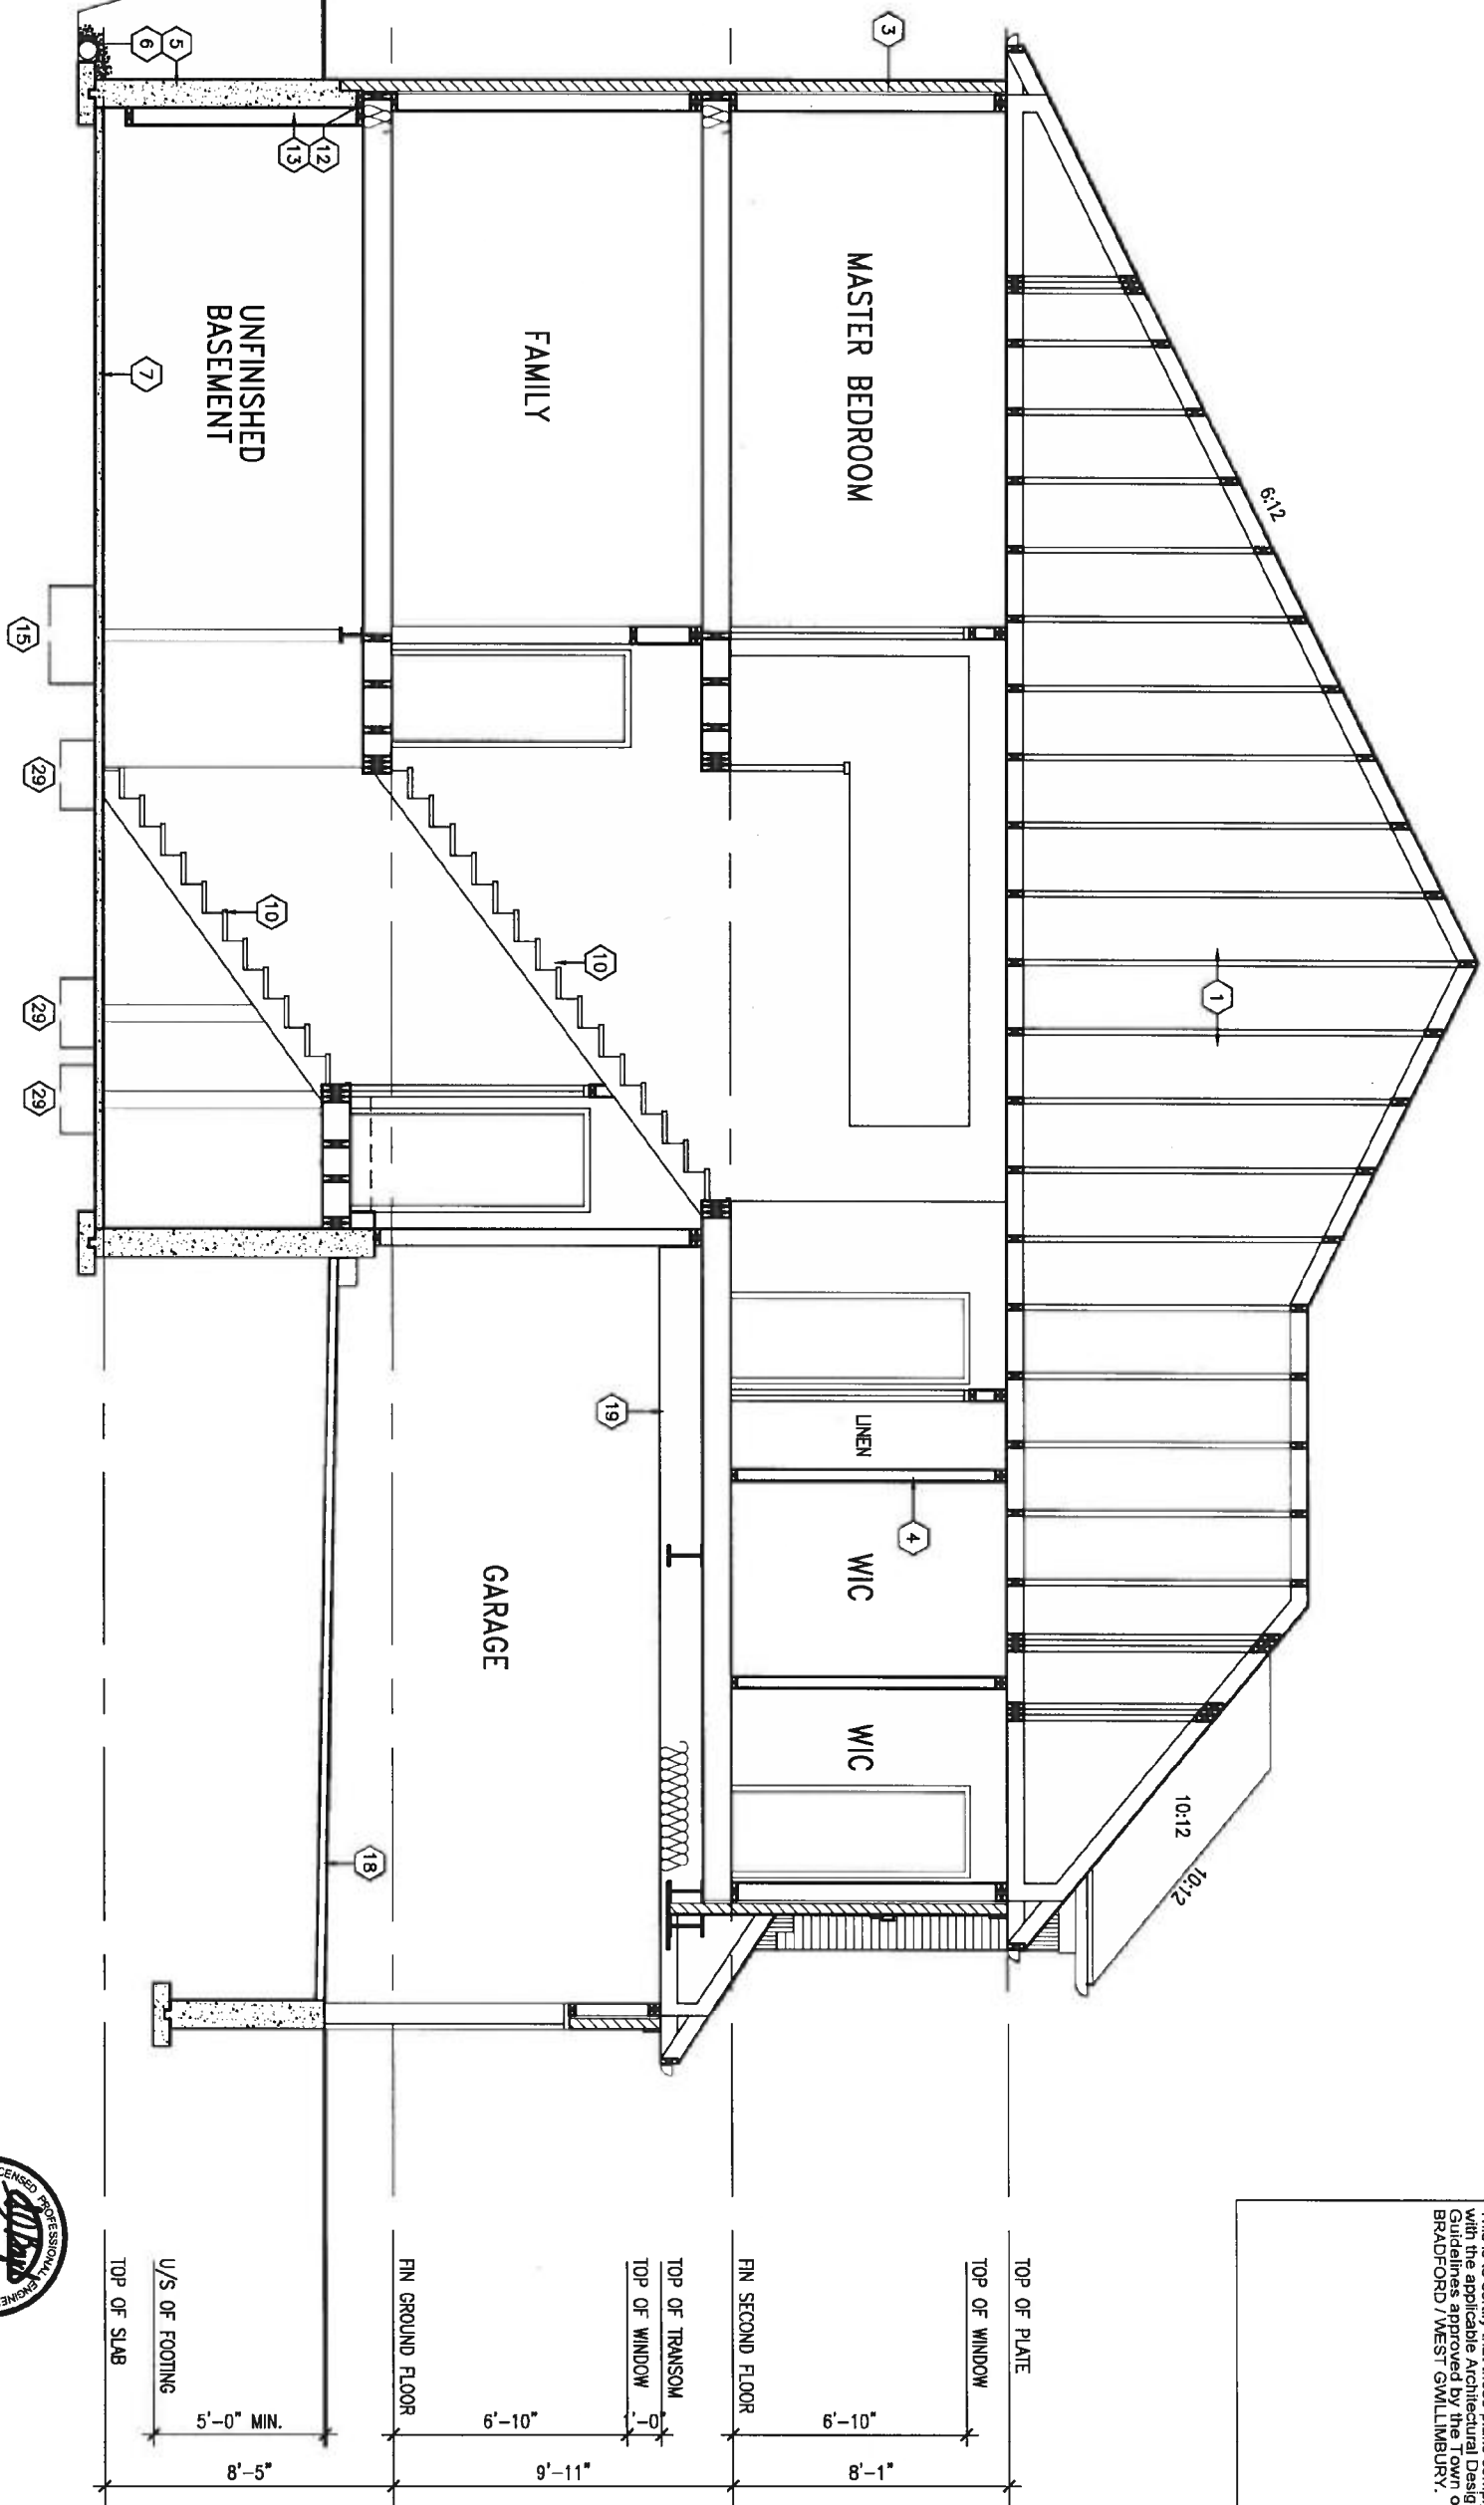
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Site Copy

1'-0"

1'-0" 1'-0"

SECTION A-A



It is the builder's complete responsibility to ensure that all plans submitted for approval fully comply with the Architectural Guidelines and all applicable regulations and requirements including zoning provisions and any provisions in the subdivision agreement. The Control Architect is not responsible in any way for working drawings with respect to any zoning or building code or permit matter or that any house can be properly built or located on its lot.

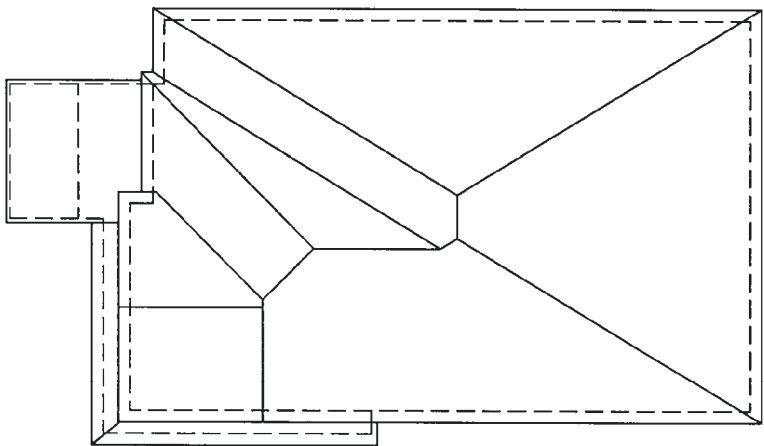
This is to certify that these plans comply with the applicable Architectural Design Guidelines approved by the Council of BRADFORD / WEST GUILDFORD.



Site Copy

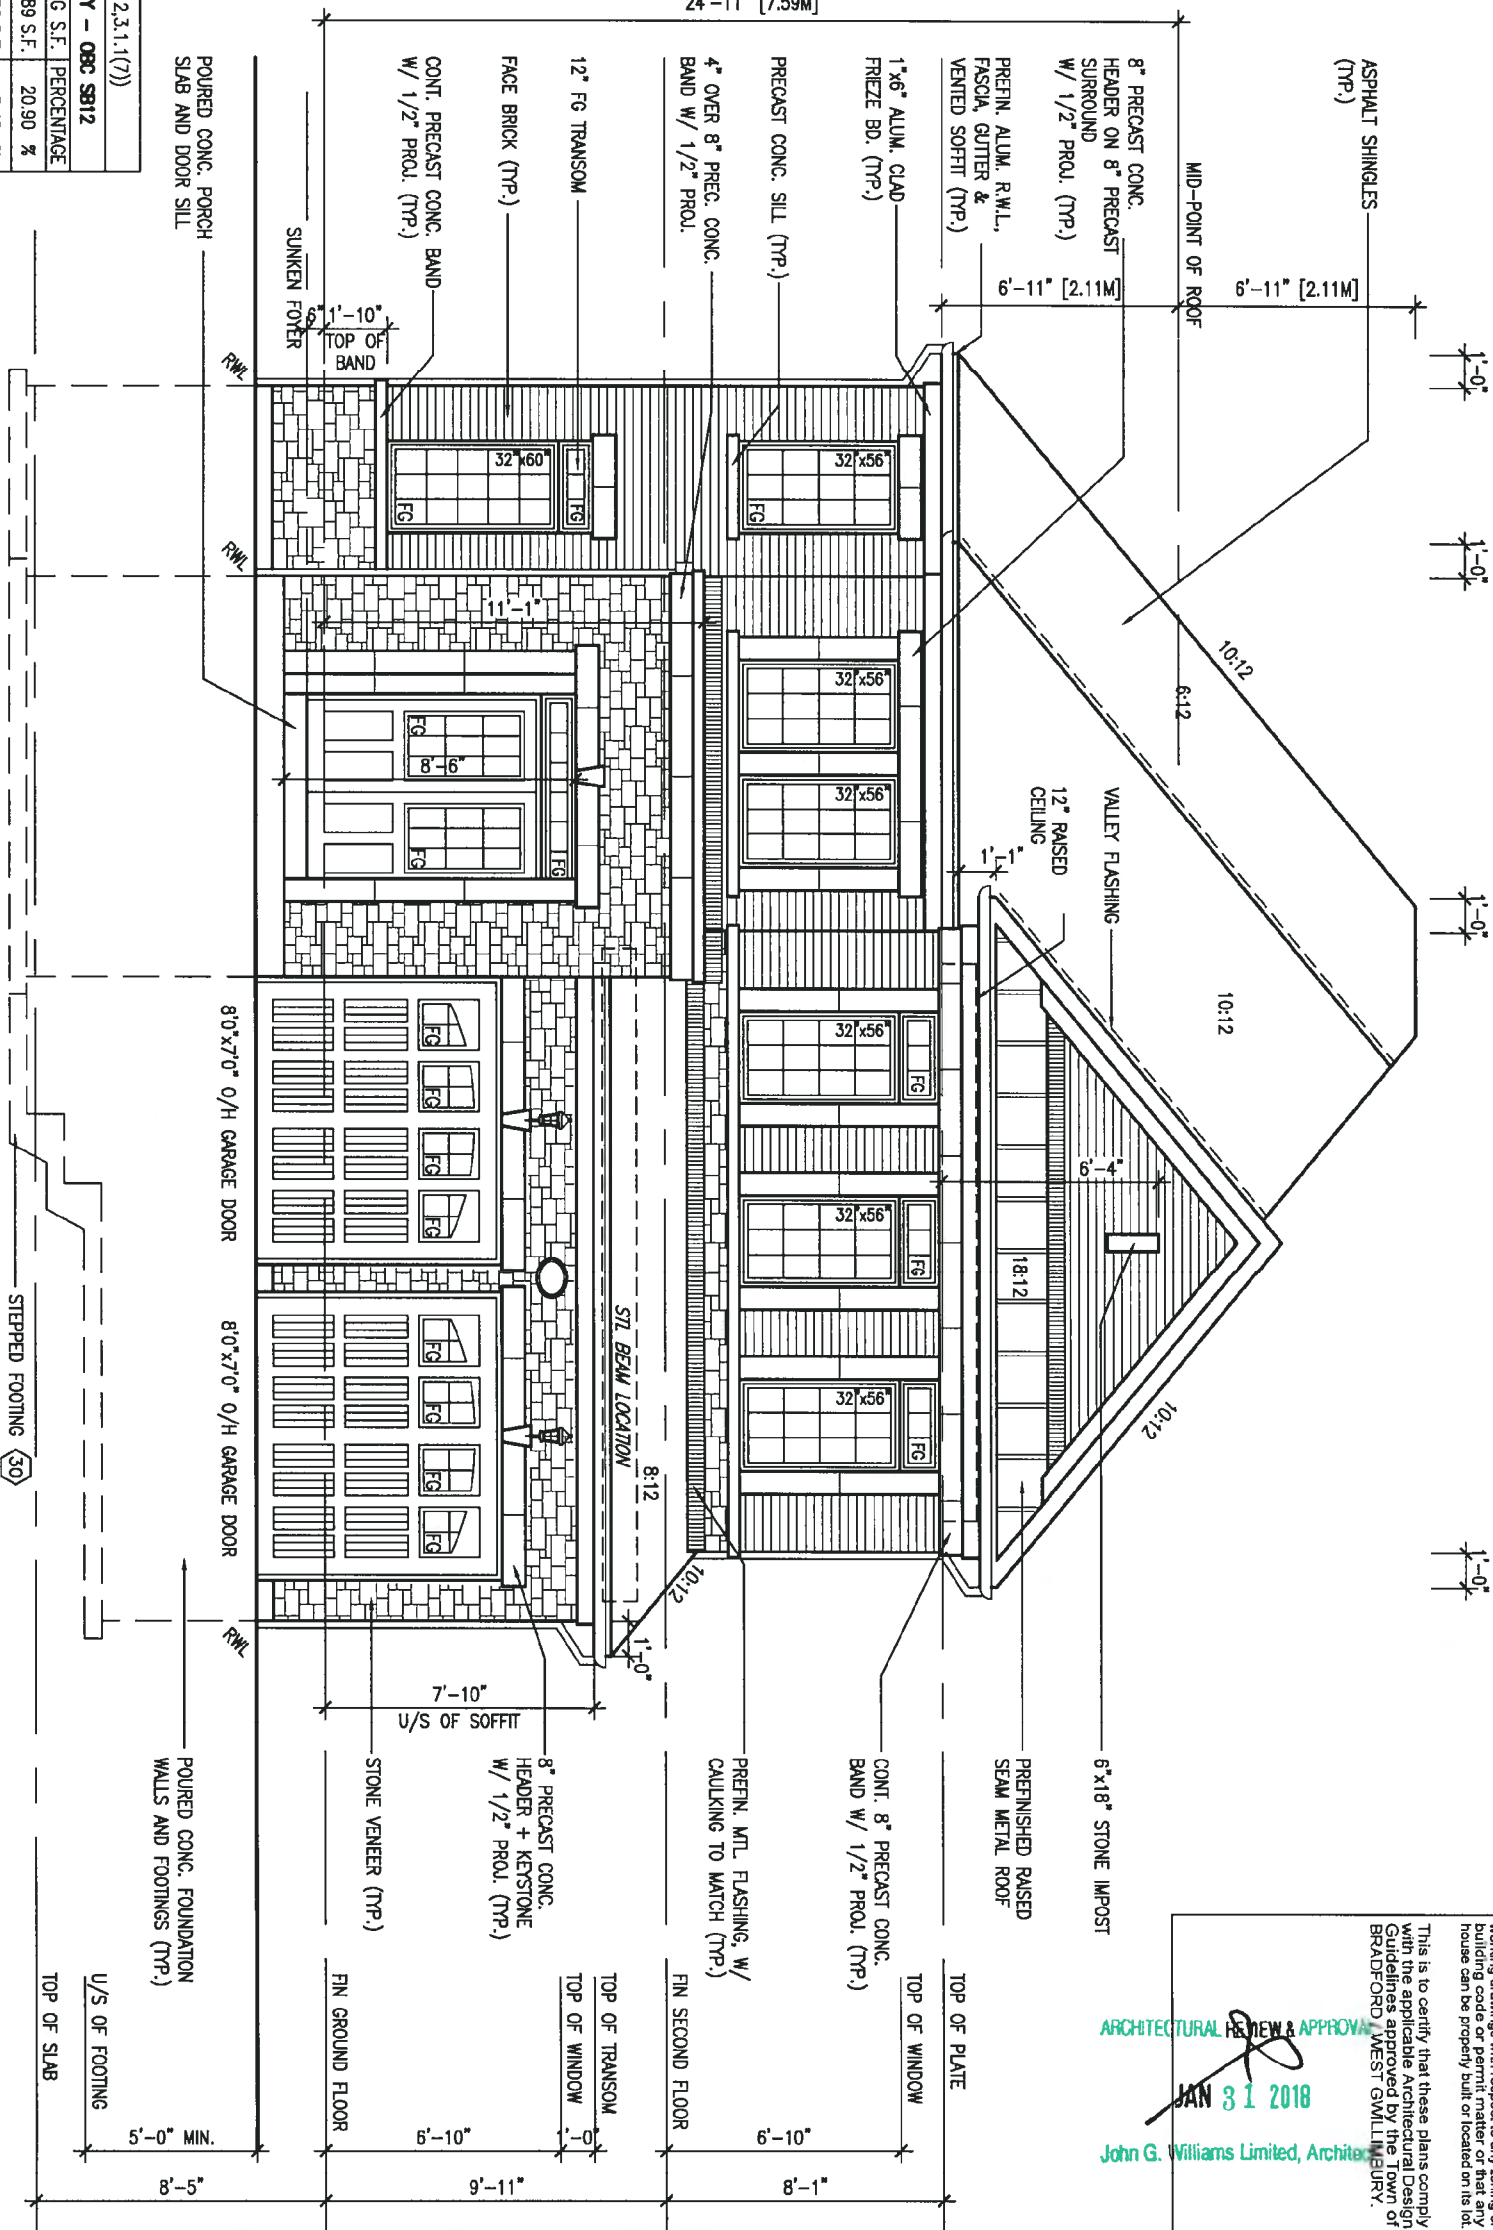
9 .		The undersigned has reviewed and takes responsibility for this design and has the qualifications and meets the requirements set out in the Ontario Building Code to be a Designer.		BAYVIEW WELLINGTON		S42-15	
8 .		qualification information		project name		RIDEAU 15	
7 .		Wellington Jno-Baptiste 25591		GREEN VALLEY EAST		BRADFORD	
6 .		name		date		MARCH 2017	
5 .		registration information		checked by		scale	
4 .		VA3 Design Inc. 42658		SB		3/16" = 1'-0"	
3 .		Contractor must verify all dimensions on the job and report any discrepancy to the Designer before proceeding with the work. All drawings and specifications are instruments of service and the property of the Designer which must be returned at the completion of the work. Drawings are not to be scaled.		drawing no.		12	
2 REVISED AS PER ENG'S COMMENTS		JAN 25-18 RC		file name		16023-S42-15	
1 ISSUED FOR CLIENT REVIEW		date by		no.		description	





ROOF PLAN 'B'

24'-11" [7.59M]



FRONT ELEVATION 'B'

UNINSULATED OPENINGS (PER OBC, SB-12.3.1(7))		
S42-15 ELEVATION B	ENERGY EFFICIENCY - OBC SB12	
ELEVATION	WALL AREA S.F.	OPENING S.F. PERCENTAGE
FRONT	691 S.F.	144,389 S.F. 20.90 %
LEFT SIDE	1137 S.F.	95,556 S.F. 8.40 %
RIGHT SIDE	1137 S.F.	91,444 S.F. 8.04 %
REAR	675 S.F.	177,056 S.F. 26.23 %
* OPENINGS OMITTED AS PER SB-12.3.1.9(4) MAX 19.9 S.F. REFER TO ELEVATION FOR LOCATION		0 S.F.
TOTAL SQ. FT.	3640.00 S.F.	508.45 S.F. 13.97 %
TOTAL SQ. M.	338.16 S.M.	47.24 S.M. 13.97 %

It is the builder's complete responsibility to ensure that all plans submitted for approval fully comply with the Architectural Guidelines and all applicable regulations and requirements including zoning provisions and any provisions in the subdivision agreement. The Control Authority shall not be responsible for examining or approving site (lotting) plans or working drawings with respect to any zoning or building code or permit matter or that any house can be properly built or located on its lot.

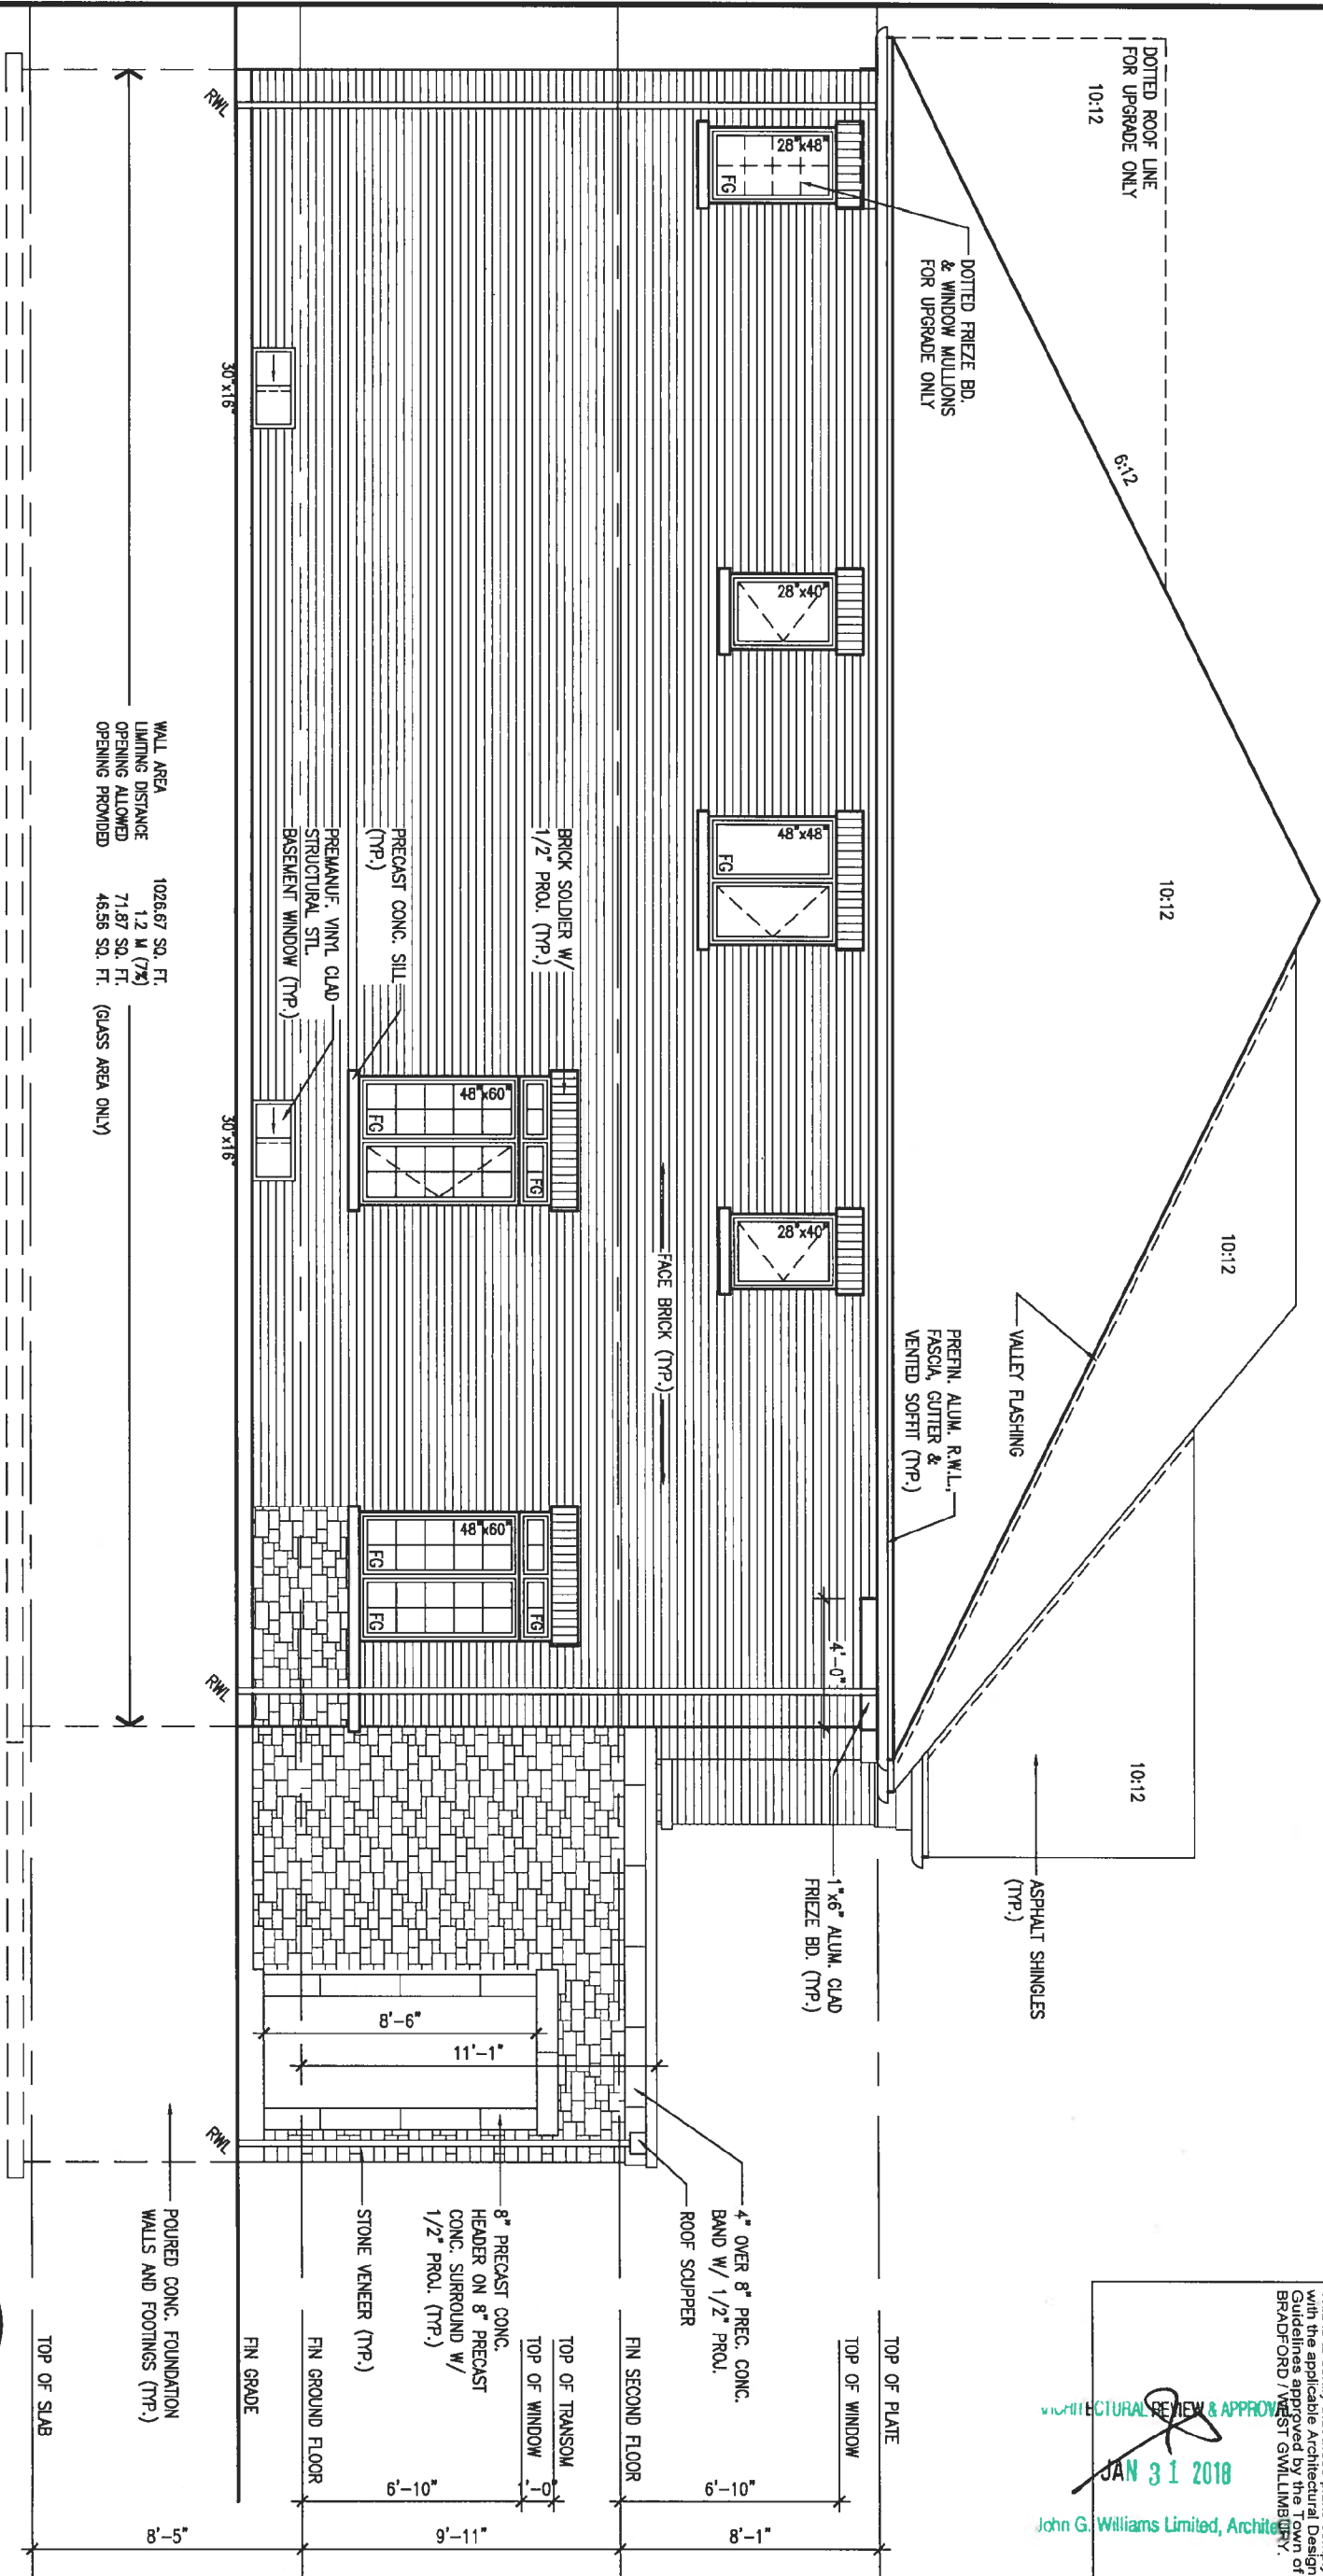
This is to certify that these plans comply with the applicable Architectural Design Guidelines approved by the Town of BRADFORD / WEST GUILDFORD.

ARCHITECTURAL REVIEW & APPROVAL  
JAN 31 2018  
John G. Williams Limited, Architect



9 .		The undersigned has reviewed and takes responsibility for this design and has the qualifications and meets the requirements set out in the Ontario Building Code to be a Designer.		VA3 DESIGN		BAYVIEW WELLINGTON		S42-15	
8 .		qualification information		25591		GREEN VALLEY EAST		RIDEAU 15	
7 .		Wellington Jno-Baptiste		BCIN		municipality		BRADFORD	
6 .		name		42658		project name		project no.	
5 .		registration information		VA3 Design Inc.		date		MARCH 2017	
4 .		Contractor must verify all dimensions on the job and report any discrepancy to the Designer before proceeding with the work. All drawings and specifications are instruments of service and the property of the Designer which must be returned at the completion of the work. Drawings are not to be scaled.		255 Consumers Rd Suite 120 Toronto ON M2J 1R4 t 416.630.2255 f 416.630.4782 va3design.com		checked by		scale	
3 .		2 REVISED AS PER ENG'S COMMENTS		JAN 25-18		drawn by		3/16" = 1'-0"	
2 .		1 ISSUED FOR CLIENT REVIEW		JAN 25-18		SB		file name	
1 .		no. description		date		16023-S42-15		13	

1'-0" 1'-0" 1'-0" 1'-0"



LEFT SIDE ELEVATION 'B'

WALL AREA  
LIMITING DISTANCE  
OPENING ALLOWED  
OPENING PROVIDED

1026.67 SQ. FT.  
1.2 M (7%)  
71.87 SQ. FT.  
46.56 SQ. FT. (GLASS AREA ONLY)



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This is to certify that these plans comply with the applicable Architectural Design Guidelines approved by the Town of BRADFORD / WEST GUILDFORD.

ARCHITECTURAL REVIEW & APPROVAL  
JAN 31 2018  
John G. Williams Limited, Architect

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5.	.	.	.
4.	.	.	.
3.	.	.	.
2.	REVISED AS PER ENG'S COMMENTS	JAN 25-18	RC
1.	ISSUED FOR CLIENT REVIEW	.	.
no.	description	date	by

The undersigned has reviewed and takes responsibility for this design and has the qualifications and meets the requirements set out in the Ontario Building Code to be a Designer.

qualification information  
Wellington Jno-Baptiste 25591  
name  
registration information  
VA3 Design Inc. 42658

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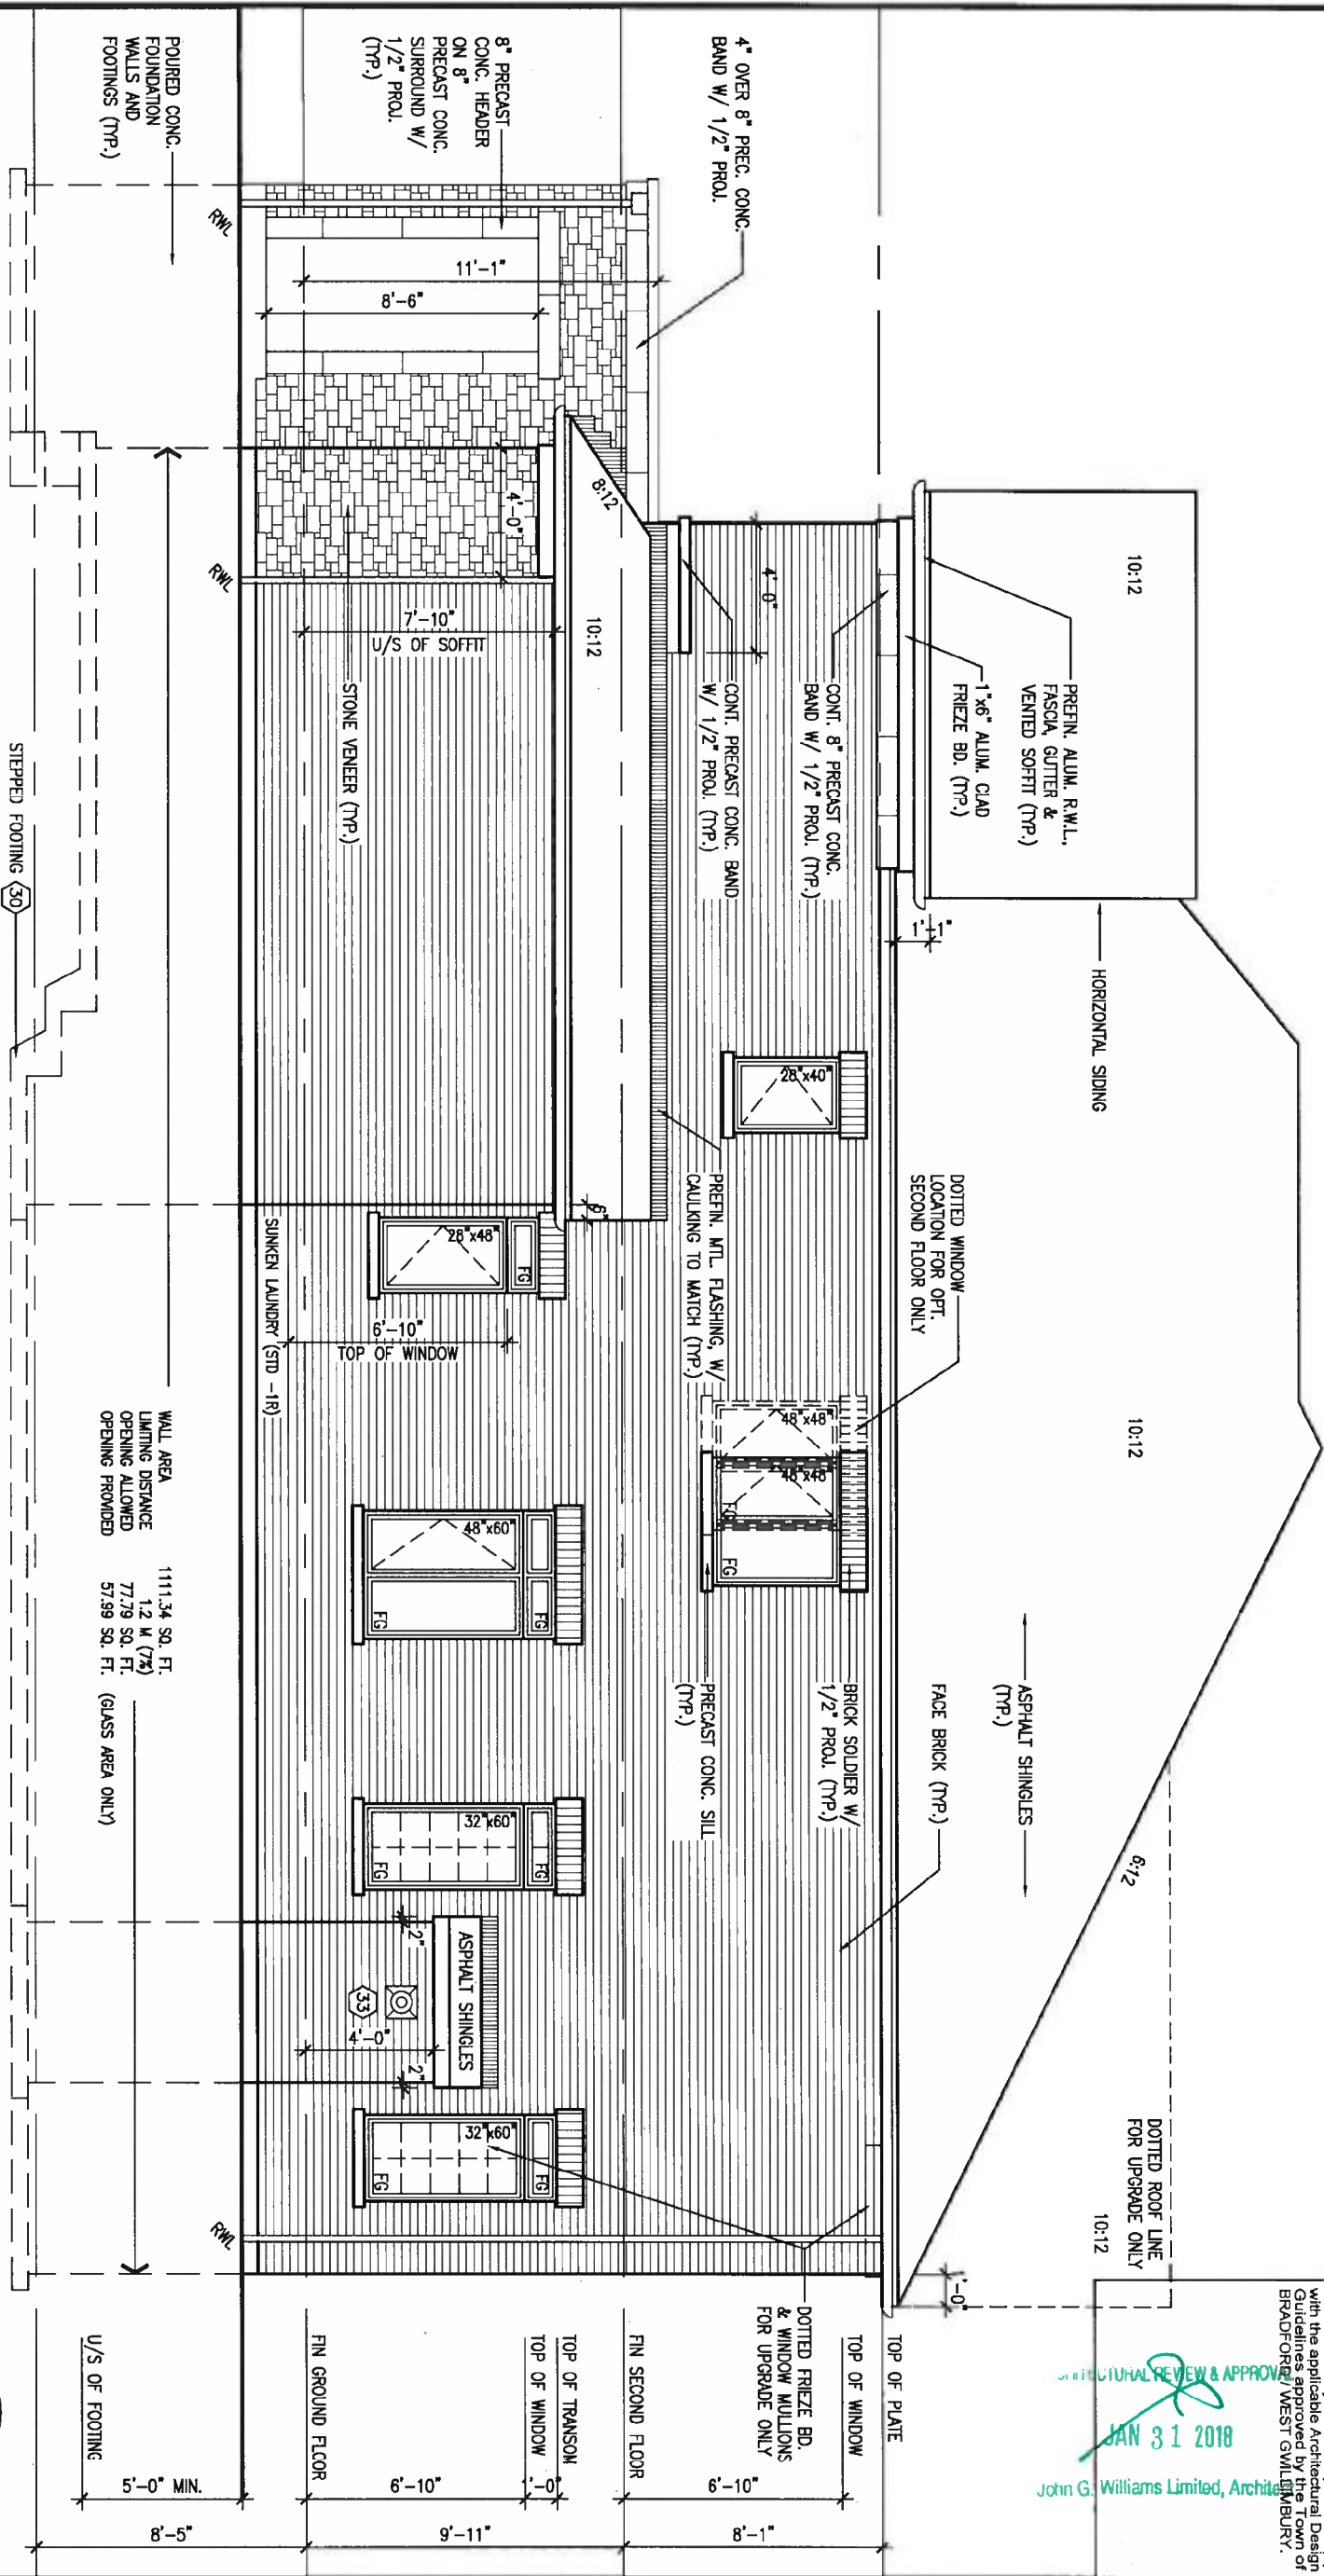
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va3design.com

<b>BAYVIEW WELLINGTON</b>		<b>S42-15</b>	
project name <b>GREEN VALLEY EAST</b>		RIDEAU 15	
site MARCH 2017	checked by SB	municipality BRADFORD	project no. 16023
LEFT SIDE ELEVATION 'B'		scale 3/16" = 1'-0"	drawing no. 14
file name 16023-S42-15 RICHARD - H:\ARCHIVE\WORKING\2016\16023.BW\Units\42\16023-S42-15.dwg - File - Jan 26 2018 - 11:30 AM			



1'-0"

RIGHT SIDE ELEVATION 'B'



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This is to certify that these plans comply with the applicable Architectural Guidelines and all applicable regulations and requirements including zoning provisions and any provisions in the subdivision agreement. The Control Architect is not responsible in any way for any errors or omissions in the drawings or working drawings with respect to any zoning or building code or permit matter or that any house can be properly built or located on its lot.

BRADFORD WEST GVL MBURNT.

STRUCTURAL REVIEW & APPROVAL  
JAN 31 2018  
John G. Williams Limited, Architects



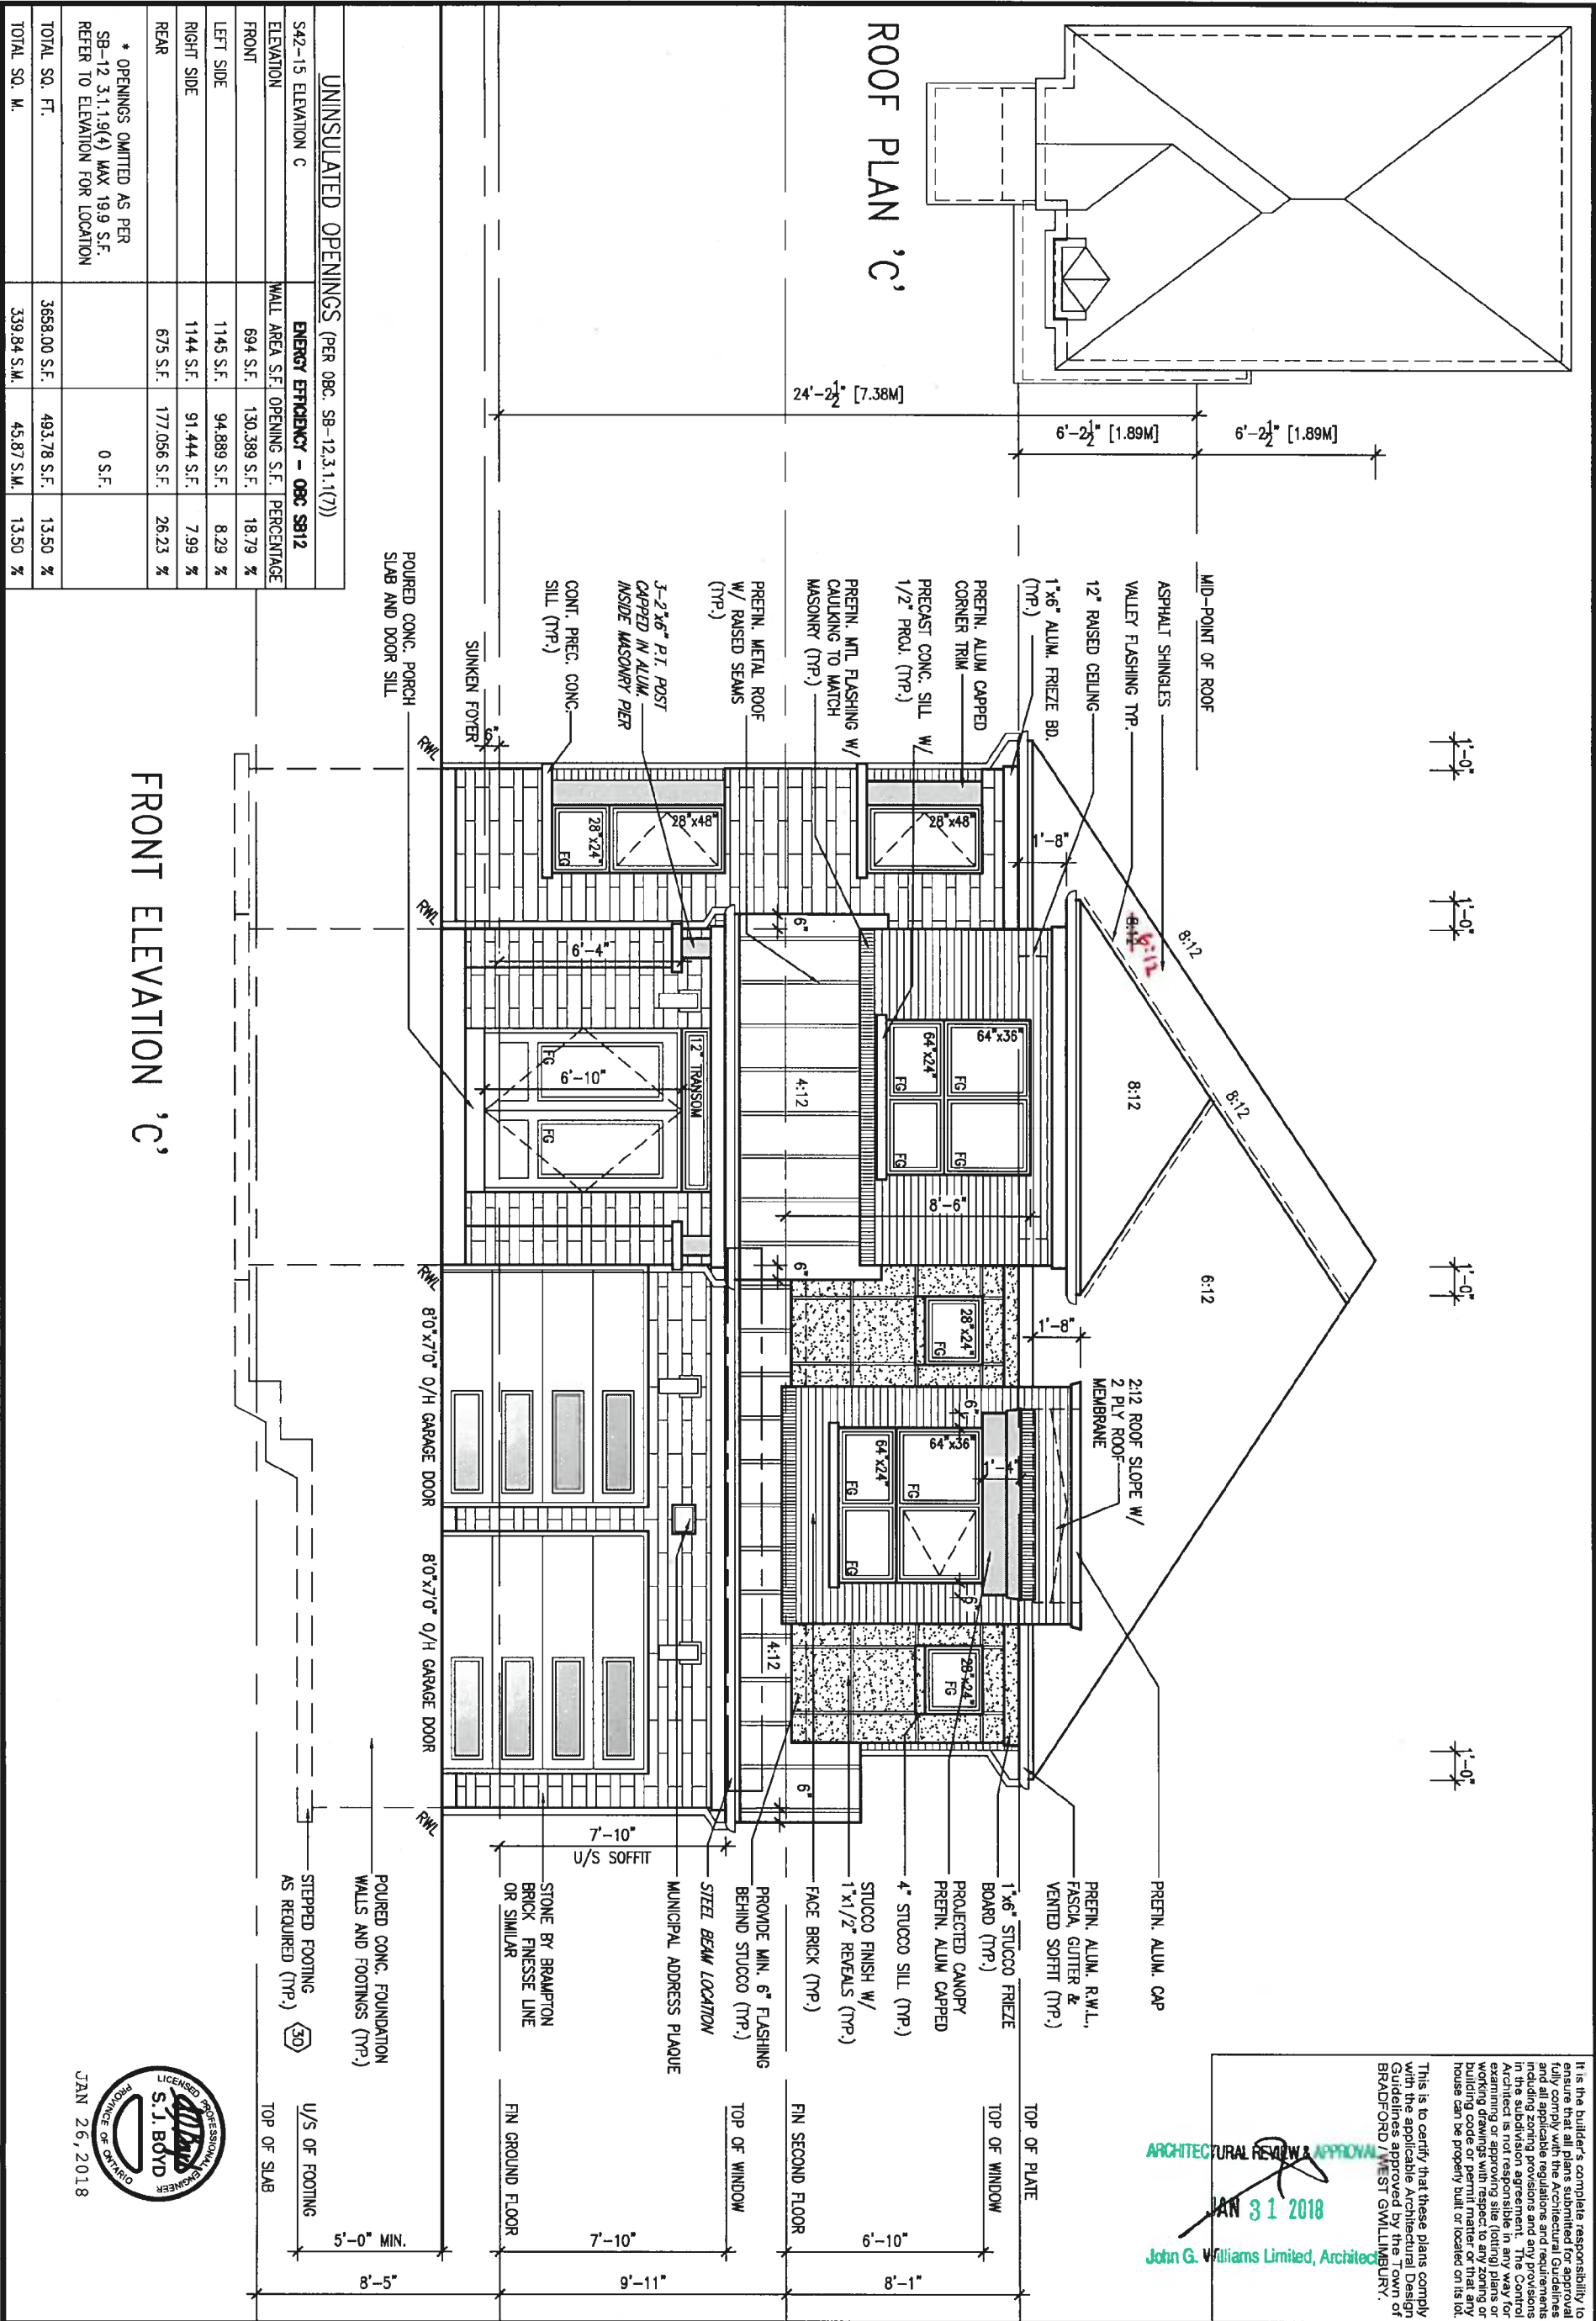
no.	description	date	by
9.			
8.			
7.			
6.			
5.			
4.			
3.			
2.	REVISED AS PER ENG'S COMMENTS	JAN 25-18	RC
1.	ISSUED FOR CLIENT REVIEW		

The undersigned has reviewed and takes responsibility for this design and has the qualifications and meets the requirements set out in the Ontario Building Code to be a Designer.	
qualification information	
Wellington Jno-Baptiste	25591
name	BCN
registration information	
VA3 Design Inc.	42658
Contractor must verify all dimensions on the job and report any discrepancy to the Designer before proceeding with the work. All drawings and specifications are instruments of service and the property of the Designer which must be returned at the completion of the work. Drawings are not to be scaled.	

**VA3 DESIGN**

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Toronto ON M2J 1R4  
t 416.630.2255 f 416.630.4782  
va3design.com

<b>BAYVIEW WELLINGTON</b>		<b>S42-15</b> RIDEAU 15	
project name <b>GREEN VALLEY EAST</b>		municipality <b>BRADFORD</b>	
date <b>MARCH 2017</b>		project no. <b>16023</b>	
drawn by <b>SB</b>		drawing no. <b>15</b>	
checked by <b>3/16" = 1'-0"</b>		RIGHT SIDE ELEVATION 'B'	
scale <b>16023-S42-15</b>		file name <b>16023-S42-15</b>	
RICHARD - H:\ARCHIVE\WORKING\2016\16023.BW\Units\42\16023-S42-15.dwg - Fri - Jan 26 2018 - 11:30 AM			



It is the builder's complete responsibility to ensure that all plans submitted for approval fully comply with the Architectural Guidelines and all applicable regulations and requirements including zoning provisions and any provisions in the subdivision agreement. The Control of Buildings Act requires that the Control of Buildings Department be satisfied that the drawings submitted for approval are true and correct and that they conform with the zoning or building code or permit matter or that any house can be properly built or located on its lot.

This is to certify that these plans comply with the applicable Architectural Design Guidelines approved by the Town of BRADFORD / WEST GUILDFORD.

**ARCHITECTURAL REVIEW & APPROVAL**  
JAN 31 2018  
John G. Williams Limited, Architect

9		The undersigned has reviewed and takes responsibility for this design and has the qualifications and meets the requirements set out in the Ontario Building Code to be a Designer.		25591	
8		qualification information		BCIN	
7		Wellington Jno-Baptiste		42658	
6		name		signature	
5		registration information		VA3 Design Inc.	
4		Contractor must verify all dimensions on the job and report any discrepancy to the Designer before proceeding with the work. All drawings and specifications are instruments of service and the property of the Designer which must be returned at the completion of the work. Drawings are not to be scaled.		255 Consumers Rd Suite 120 Toronto ON M2J 1R4 t 416.630.2255 f 416.630.4782 va3design.com	
3		2		3	
2		1		1	
1		no.		description	

**BAYVIEW WELLINGTON**

project name  
**GREEN VALLEY EAST**

date  
**MARCH 2017**

drawn by  
**SB**

checked by  
**3/16" = 1'-0"**

scale  
**3/16" = 1'-0"**

file name  
**16023-S42-15**

drawn by  
**RICHARD**

checked by  
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date  
**Fri Jan 26 2018 11:30 AM**

**S42-15**

**RIDEAU 15**

project no.  
**16023**

drawing no.  
**16**

**FRONT ELEVATION 'C'**

16023-S42-15

Site Copy





1'-0" 1'-0" 1'-0" 1'-3"



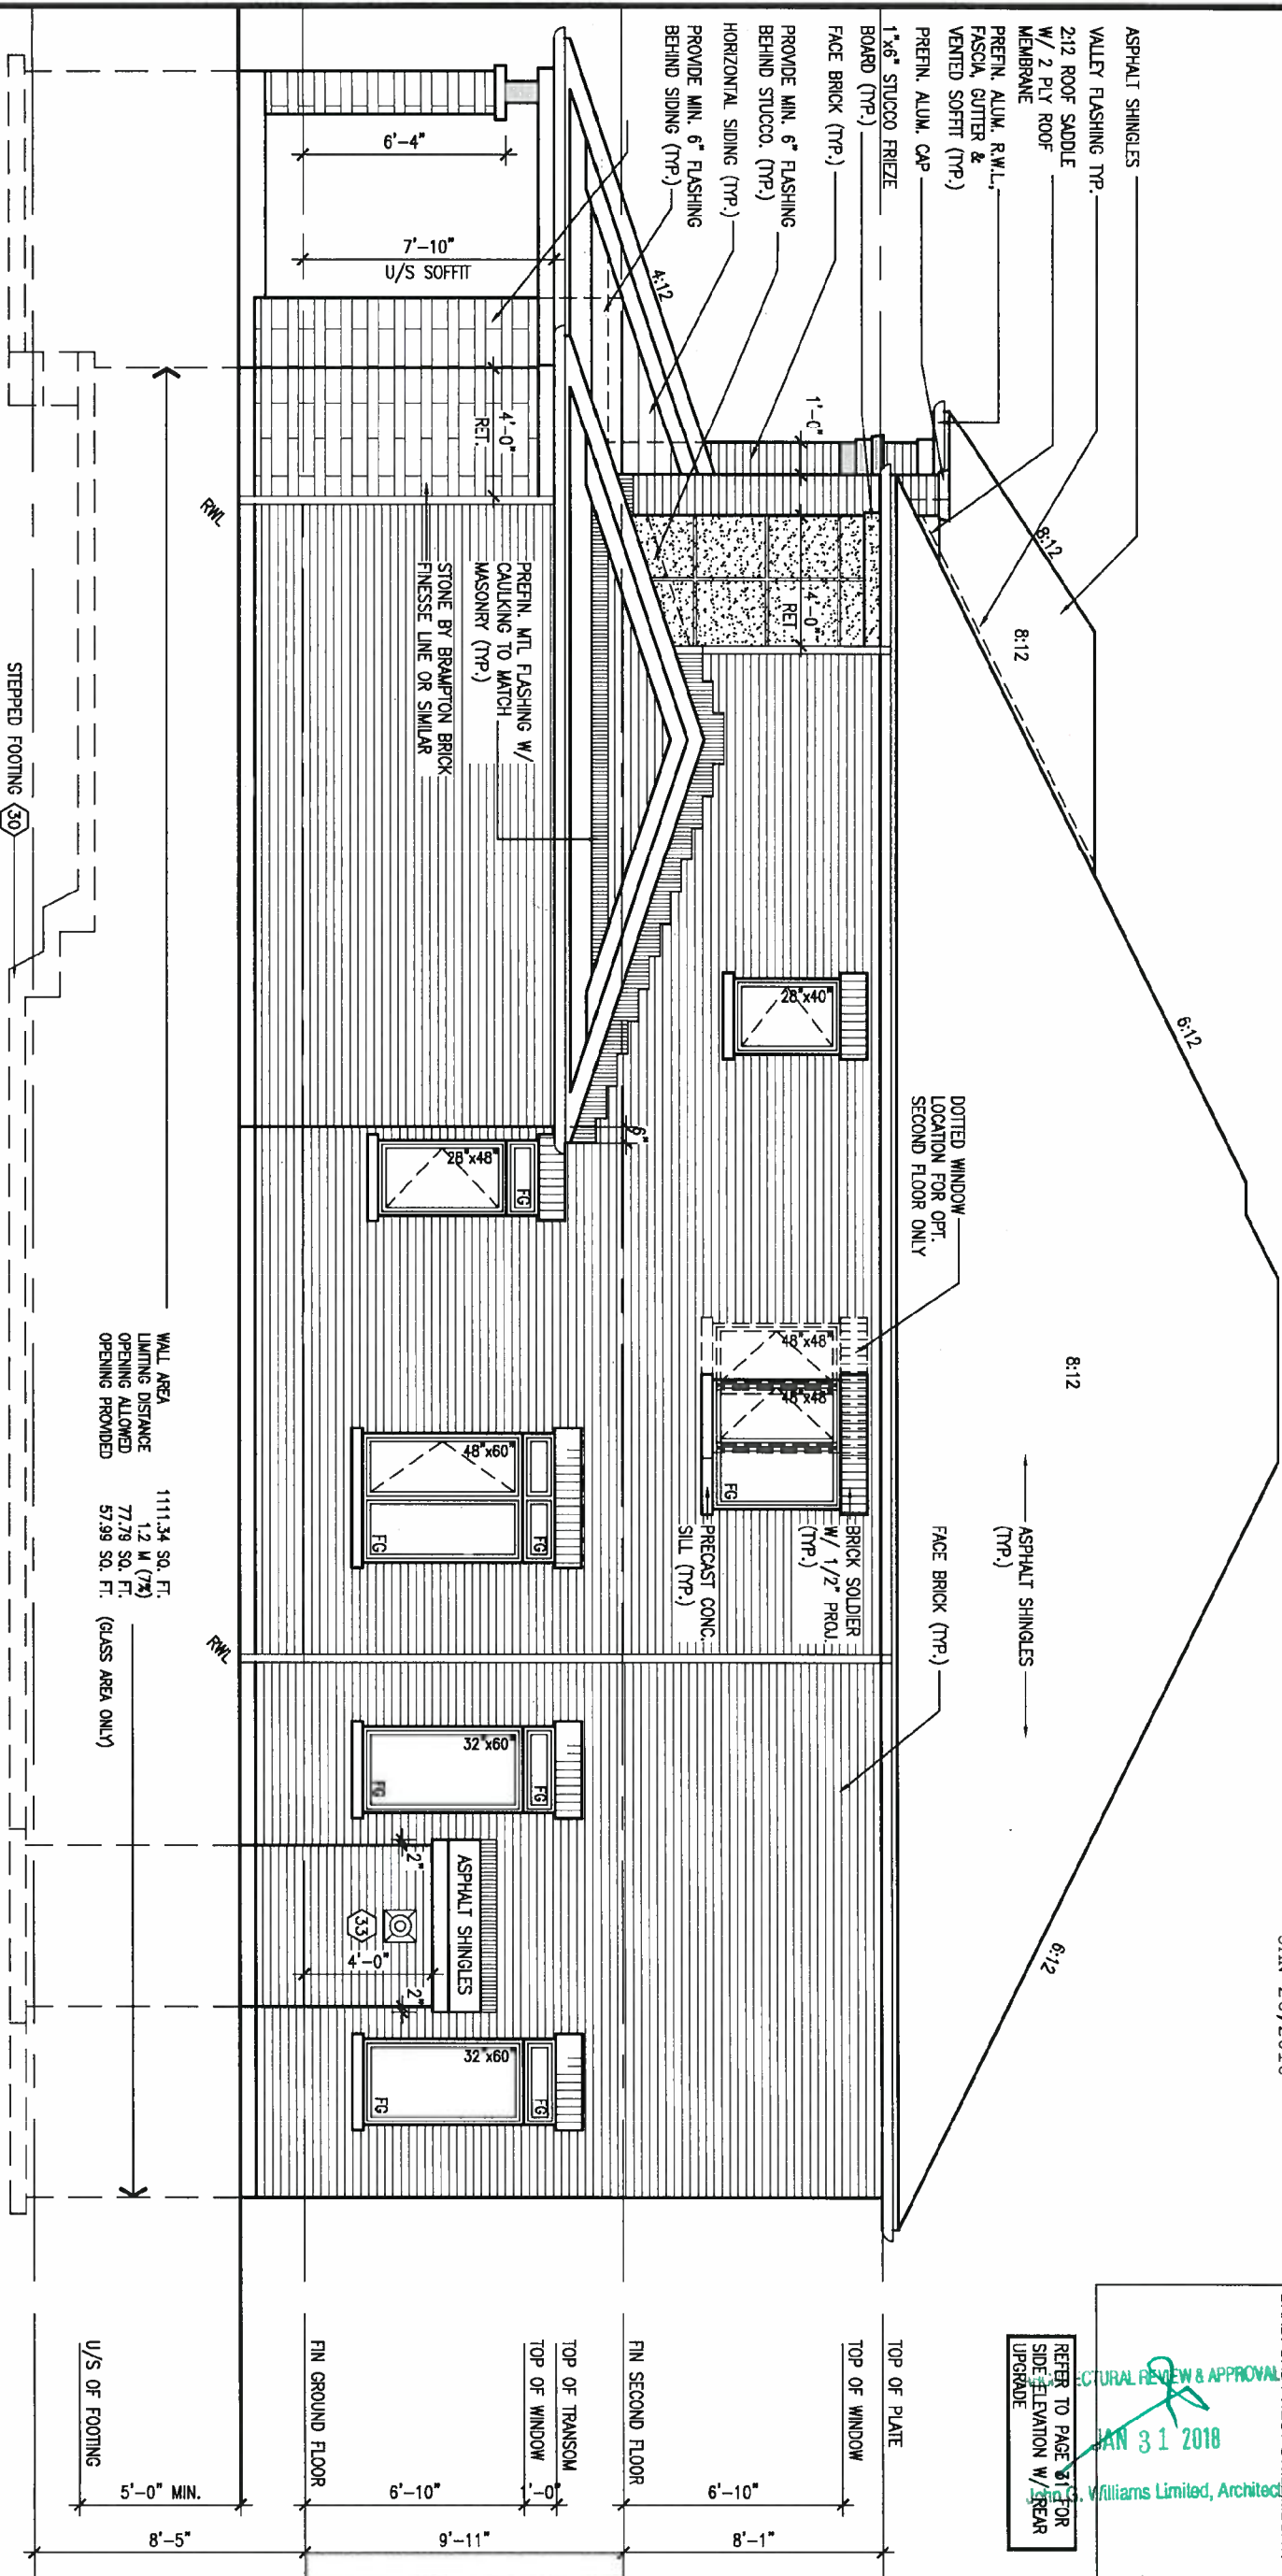
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This is to certify that these plans comply with applicable Architectural Guidelines and are approved by the Town of BRADFORD / WEST GML LMBURY.

JAN 31 2018  
Williams Limited, Architect

REFER TO PAGE 51 FOR  
SIDE ELEVATION W/ REAR  
UPGRADE

## RIGHT SIDE ELEVATION 'C'



WALL AREA 1111.34 SQ. FT.  
LIMITING DISTANCE 1.2 M (7X)  
OPENING ALLOWED 77.78 SQ. FT.  
OPENING PROVIDED 57.99 SQ. FT. (GLASS AREA ONLY)

9.	.	.	.
8.	.	.	.
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3.	.	.	.
2.	REVISED AS PER ENG'S COMMENTS	JAN 25-18	RC
1.	ISSUED FOR CLIENT REVIEW	.	.
no.	description	date	by

The undersigned has reviewed and takes responsibility for this design and has the qualifications and meets the requirements set out in the Ontario Building Code to be a Designer.

qualification information  
Wellington Jno-Baptiste 25591  
name registration information BCIN  
VA3 Design Inc. 42658

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t 416.630.2255 f 416.630.4782  
va3design.com

<b>BAYVIEW WELLINGTON</b>		<b>S42-15</b> RIDEAU 15	
project name <b>GREEN VALLEY EAST</b>	municipality <b>BRADFORD</b>	project no. <b>16023</b>	drawing no. <b>18</b>
date <b>MARCH 2017</b>	checked by <b>SB</b>	scale <b>3/16" = 1'-0"</b>	file name <b>16023-S42-15</b>
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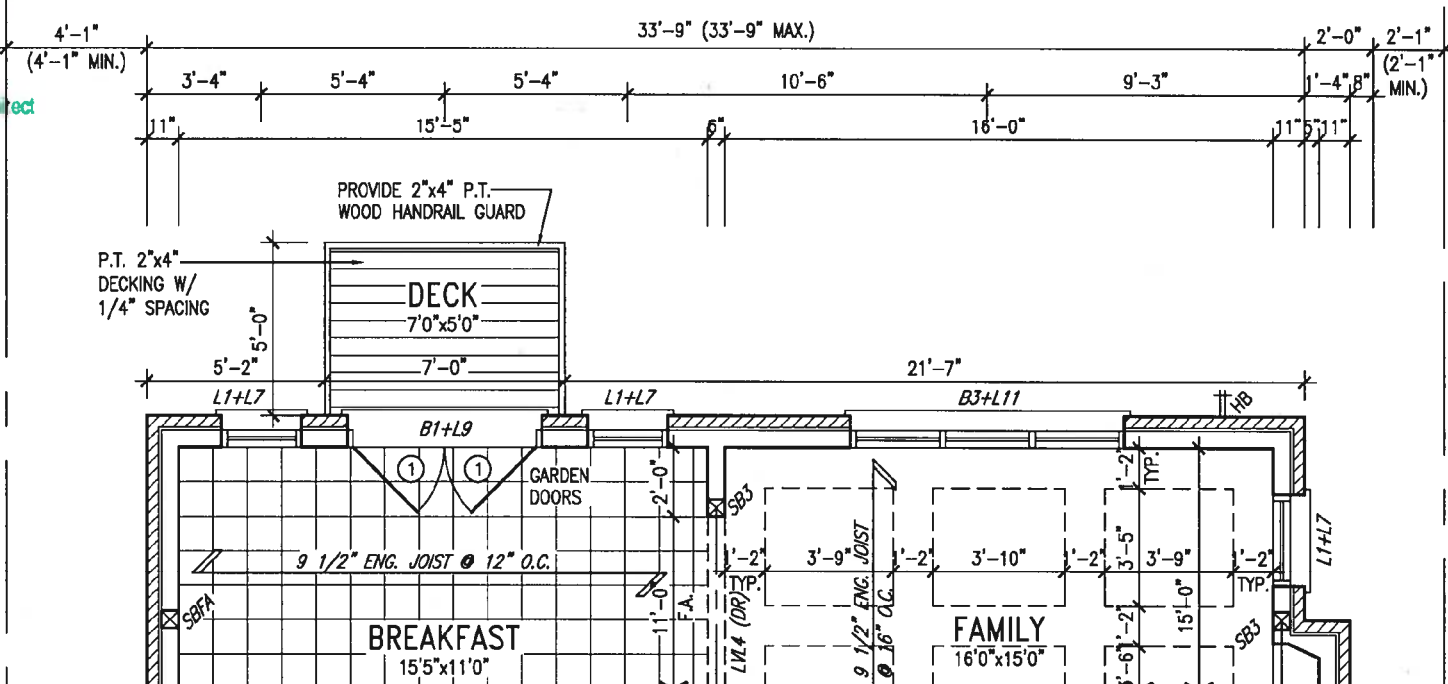




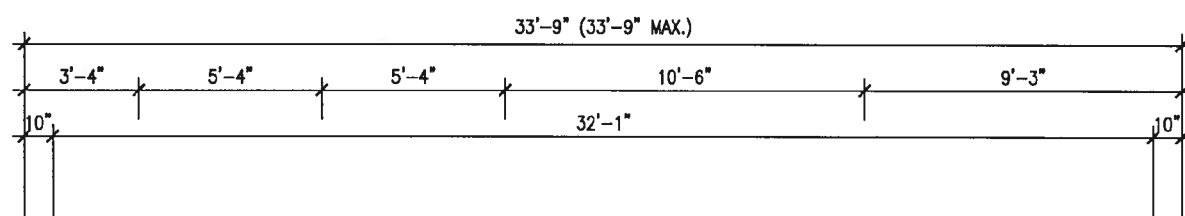
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JAN 31 2018

**John G. Williams Limited, Architects**



PARTIAL GROUND FLOOR PLAN  
W/ W.O.B.



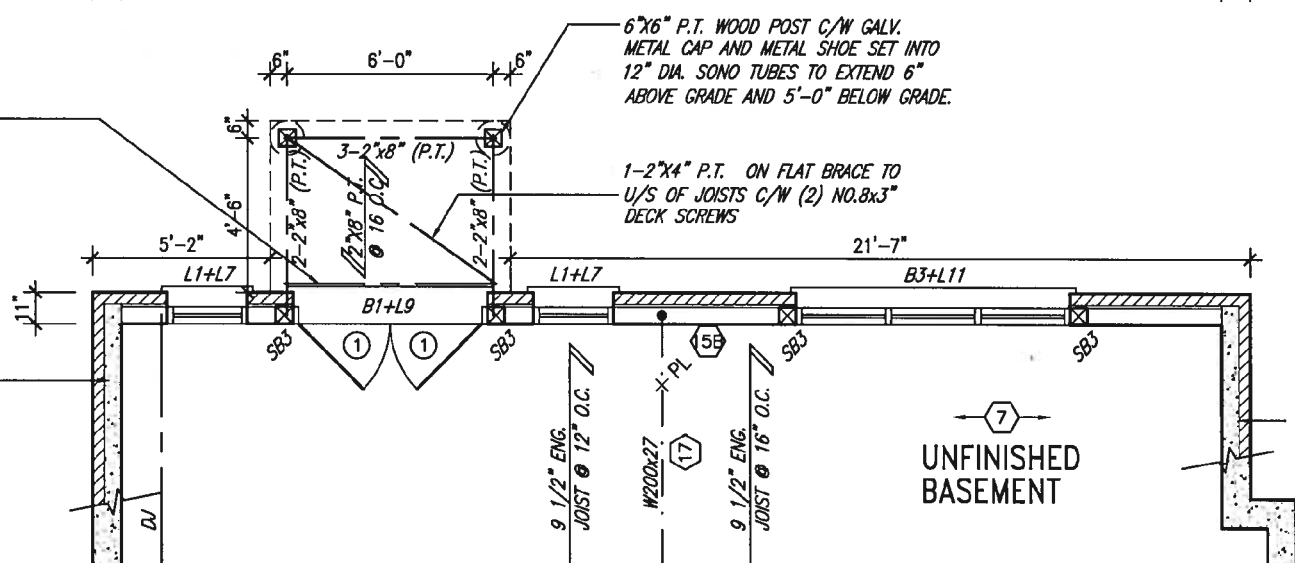
2-2"x8" P.T. DROPPED  
LEDGER FASTENED TO 2"x6"  
BLOCKING BETWEEN STUDS  
W/ 1/2" DIA. BOLTS @ 16"  
O.C. REFER TO DETAIL 1/S2

- 6"x6" P.T. WOOD POST C/W GALV.  
METAL CAP AND METAL SHOE SET INTO  
12" DIA. SONO TUBES TO EXTEND 6"  
ABOVE GRADE AND 5'-0" BELOW GRADE.

1-2"x4" P.T. ON FLAT BRACE TO  
U/S OF JOISTS C/W (2) NO.8x3"  
DECK SCREWS

10" FULL HEIGHT CONC.  
ON SIDE WALL W/ BRICK  
CHECK AS REQUIRED ON  
22"x6" CONC. FTG

10" FULL HEIGHT CONC.  
ON SIDE WALL W/ BRICK  
CHECK AS REQUIRED ON  
22"x6" CONC. FTG



PARTIAL BASEMENT PLAN  
W/ W.O.B.

**NOTE:**  
REFER TO STANDARD FLOOR PLANS  
FOR ADDITIONAL INFORMATION.

NOTE:  
SPACE ALL FLOOR JOISTS @ 12"  
O.C. UNDER ALL CERAMIC TILE  
AREAS.

**NOTE:**  
ALL LVL'S SUPPORTING FLOOR LOADS ARE TO BE SPECIFIED BY THE FLOOR TRUSS MANUFACTURER.

NOTE:  
FLOOR FRAMING INFO REFER TO ENG SHOP  
DRAWINGS FOR ALL TRUSS-JOIST INFORMATION AND  
DETAILS, UNLESS OTHERWISE NOTED.

Wellington Jno-Baptiste	2559
name	BCIN
registration information	42658
VA3 Design Inc.	

Contractor must verify all dimensions on the job and report any discrepancy to the Designer before proceeding with the work. All drawings and specifications are instruments of service and the property of the Designer which must be returned at the completion of the work. Drawings are not to be scaled.

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DESIGN**

**DESIGN**  
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va3design.com

**BAYVIEW WELLINGTON**

project name	municipality
GREEN VALLEY EAST	BRADFORD

date  
MARCH 2017

drawn by

checked by	scale
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$$3/16" = 1'-0"$$

PARTIAL PLANS WOB

file name

16023-S42-15

project no.

16023

drawing no.

04

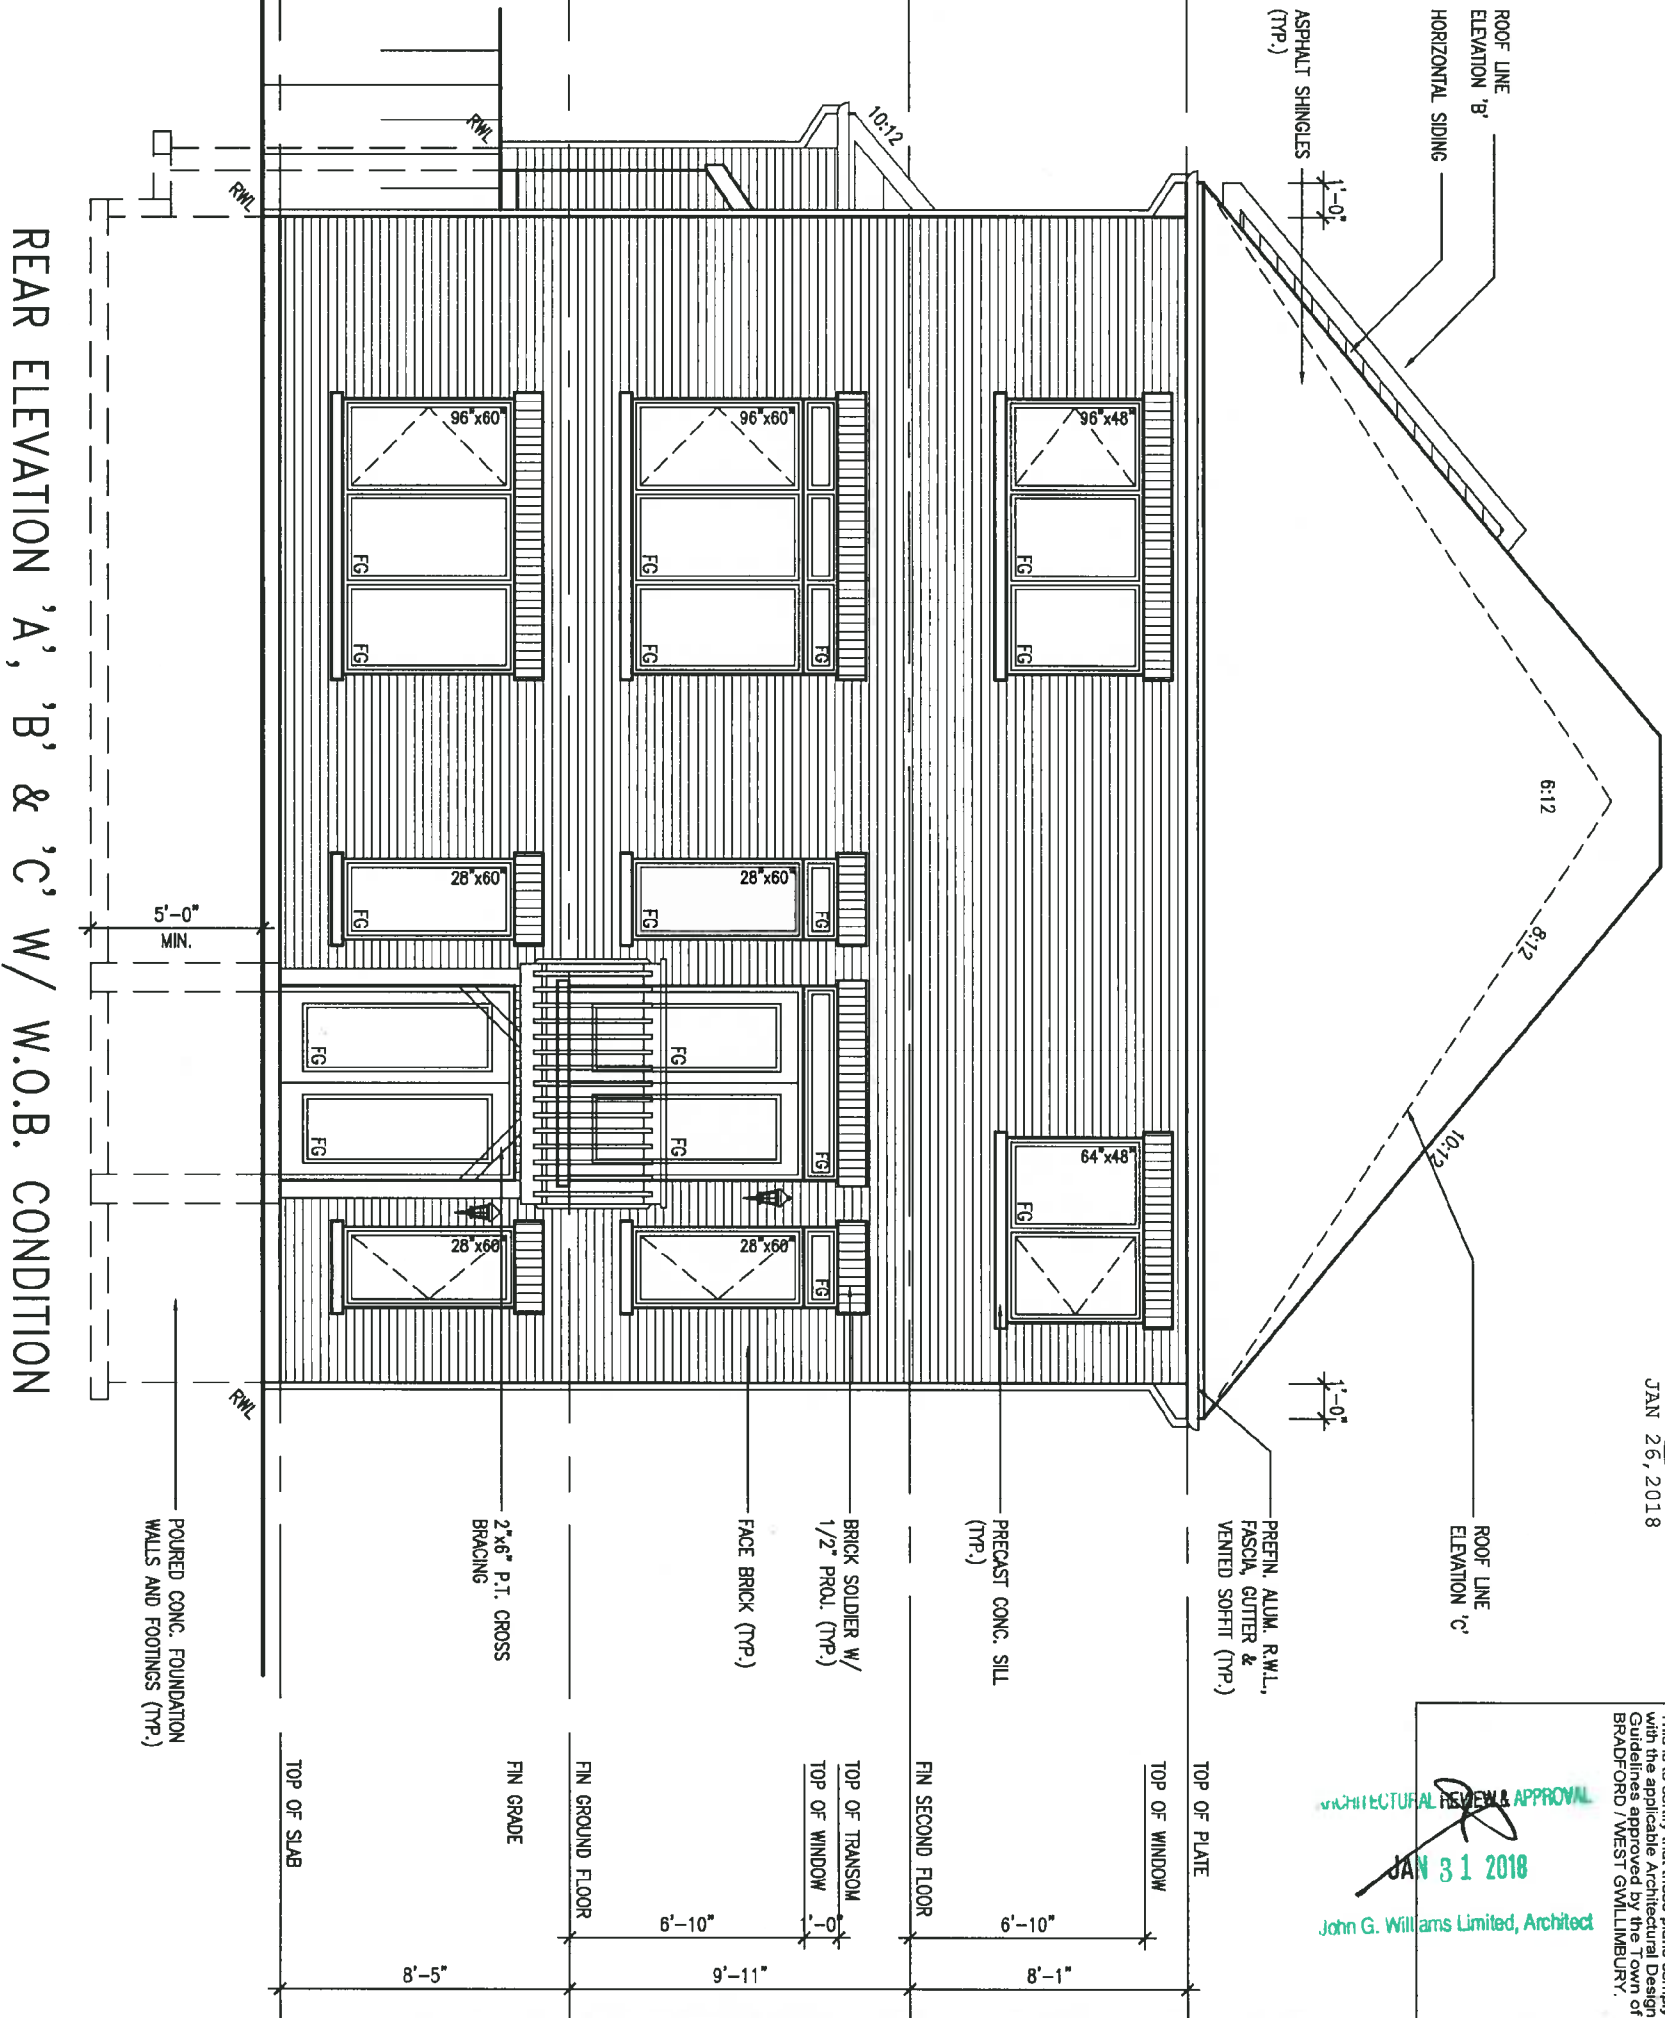
21

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# Site Copy

UNINSULATED OPENINGS (PER OBC: SB-12.3.1.(7))			
S42-15 ELEVATION A WOB	ENERGY EFFICIENCY - OBC SB12		
ELEVATION	WALL AREA S.F.	OPENING S.F.	PERCENTAGE
FRONT	691 S.F.	136.797 S.F.	19.80 %
LEFT SIDE	1137 S.F.	95.556 S.F.	8.40 %
RIGHT SIDE	1137 S.F.	91.444 S.F.	8.04 %
REAR	908 S.F.	275.778 S.F.	30.37 %
* OPENINGS OMITTED AS PER SB-12 3.1.1(9(4) MAX 19.9 S.F. REFER TO ELEVATION FOR LOCATION			
		0 S.F.	
TOTAL SQ. FT.	3873.00 S.F.	599.58 S.F.	15.48 %
TOTAL SQ. M.	359.81 S.M.	55.70 S.M.	15.48 %
UNINSULATED OPENINGS (PER OBC: SB-12.3.1.(7))			
S42-15 ELEVATION B WOB	ENERGY EFFICIENCY - OBC SB12		
ELEVATION	WALL AREA S.F.	OPENING S.F.	PERCENTAGE
FRONT	691 S.F.	144.389 S.F.	20.90 %
LEFT SIDE	1137 S.F.	95.556 S.F.	8.40 %
RIGHT SIDE	1137 S.F.	91.444 S.F.	8.04 %
REAR	908 S.F.	275.778 S.F.	30.37 %
* OPENINGS OMITTED AS PER SB-12 3.1.1(9(4) MAX 19.9 S.F. REFER TO ELEVATION FOR LOCATION			
		0 S.F.	
TOTAL SQ. FT.	3873.00 S.F.	607.17 S.F.	15.68 %
TOTAL SQ. M.	359.81 S.M.	56.41 S.M.	15.68 %
UNINSULATED OPENINGS (PER OBC: SB-12.3.1.(7))			
S42-15 ELEVATION C WOB	ENERGY EFFICIENCY - OBC SB12		
ELEVATION	WALL AREA S.F.	OPENING S.F.	PERCENTAGE
FRONT	694 S.F.	130.389 S.F.	18.79 %
LEFT SIDE	1145 S.F.	94.889 S.F.	8.29 %
RIGHT SIDE	1144 S.F.	91.444 S.F.	7.99 %
REAR	908 S.F.	275.778 S.F.	30.37 %
* OPENINGS OMITTED AS PER SB-12 3.1.1(9(4) MAX 19.9 S.F. REFER TO ELEVATION FOR LOCATION			
		0 S.F.	
TOTAL SQ. FT.	3891.00 S.F.	592.50 S.F.	15.23 %
TOTAL SQ. M.	361.48 S.M.	55.04 S.M.	15.23 %



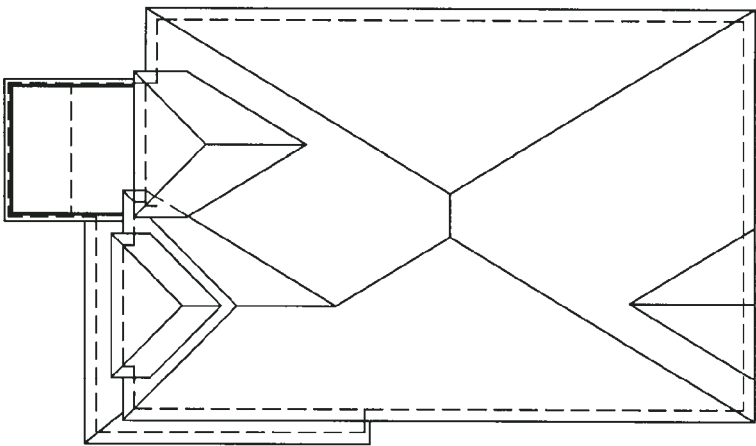
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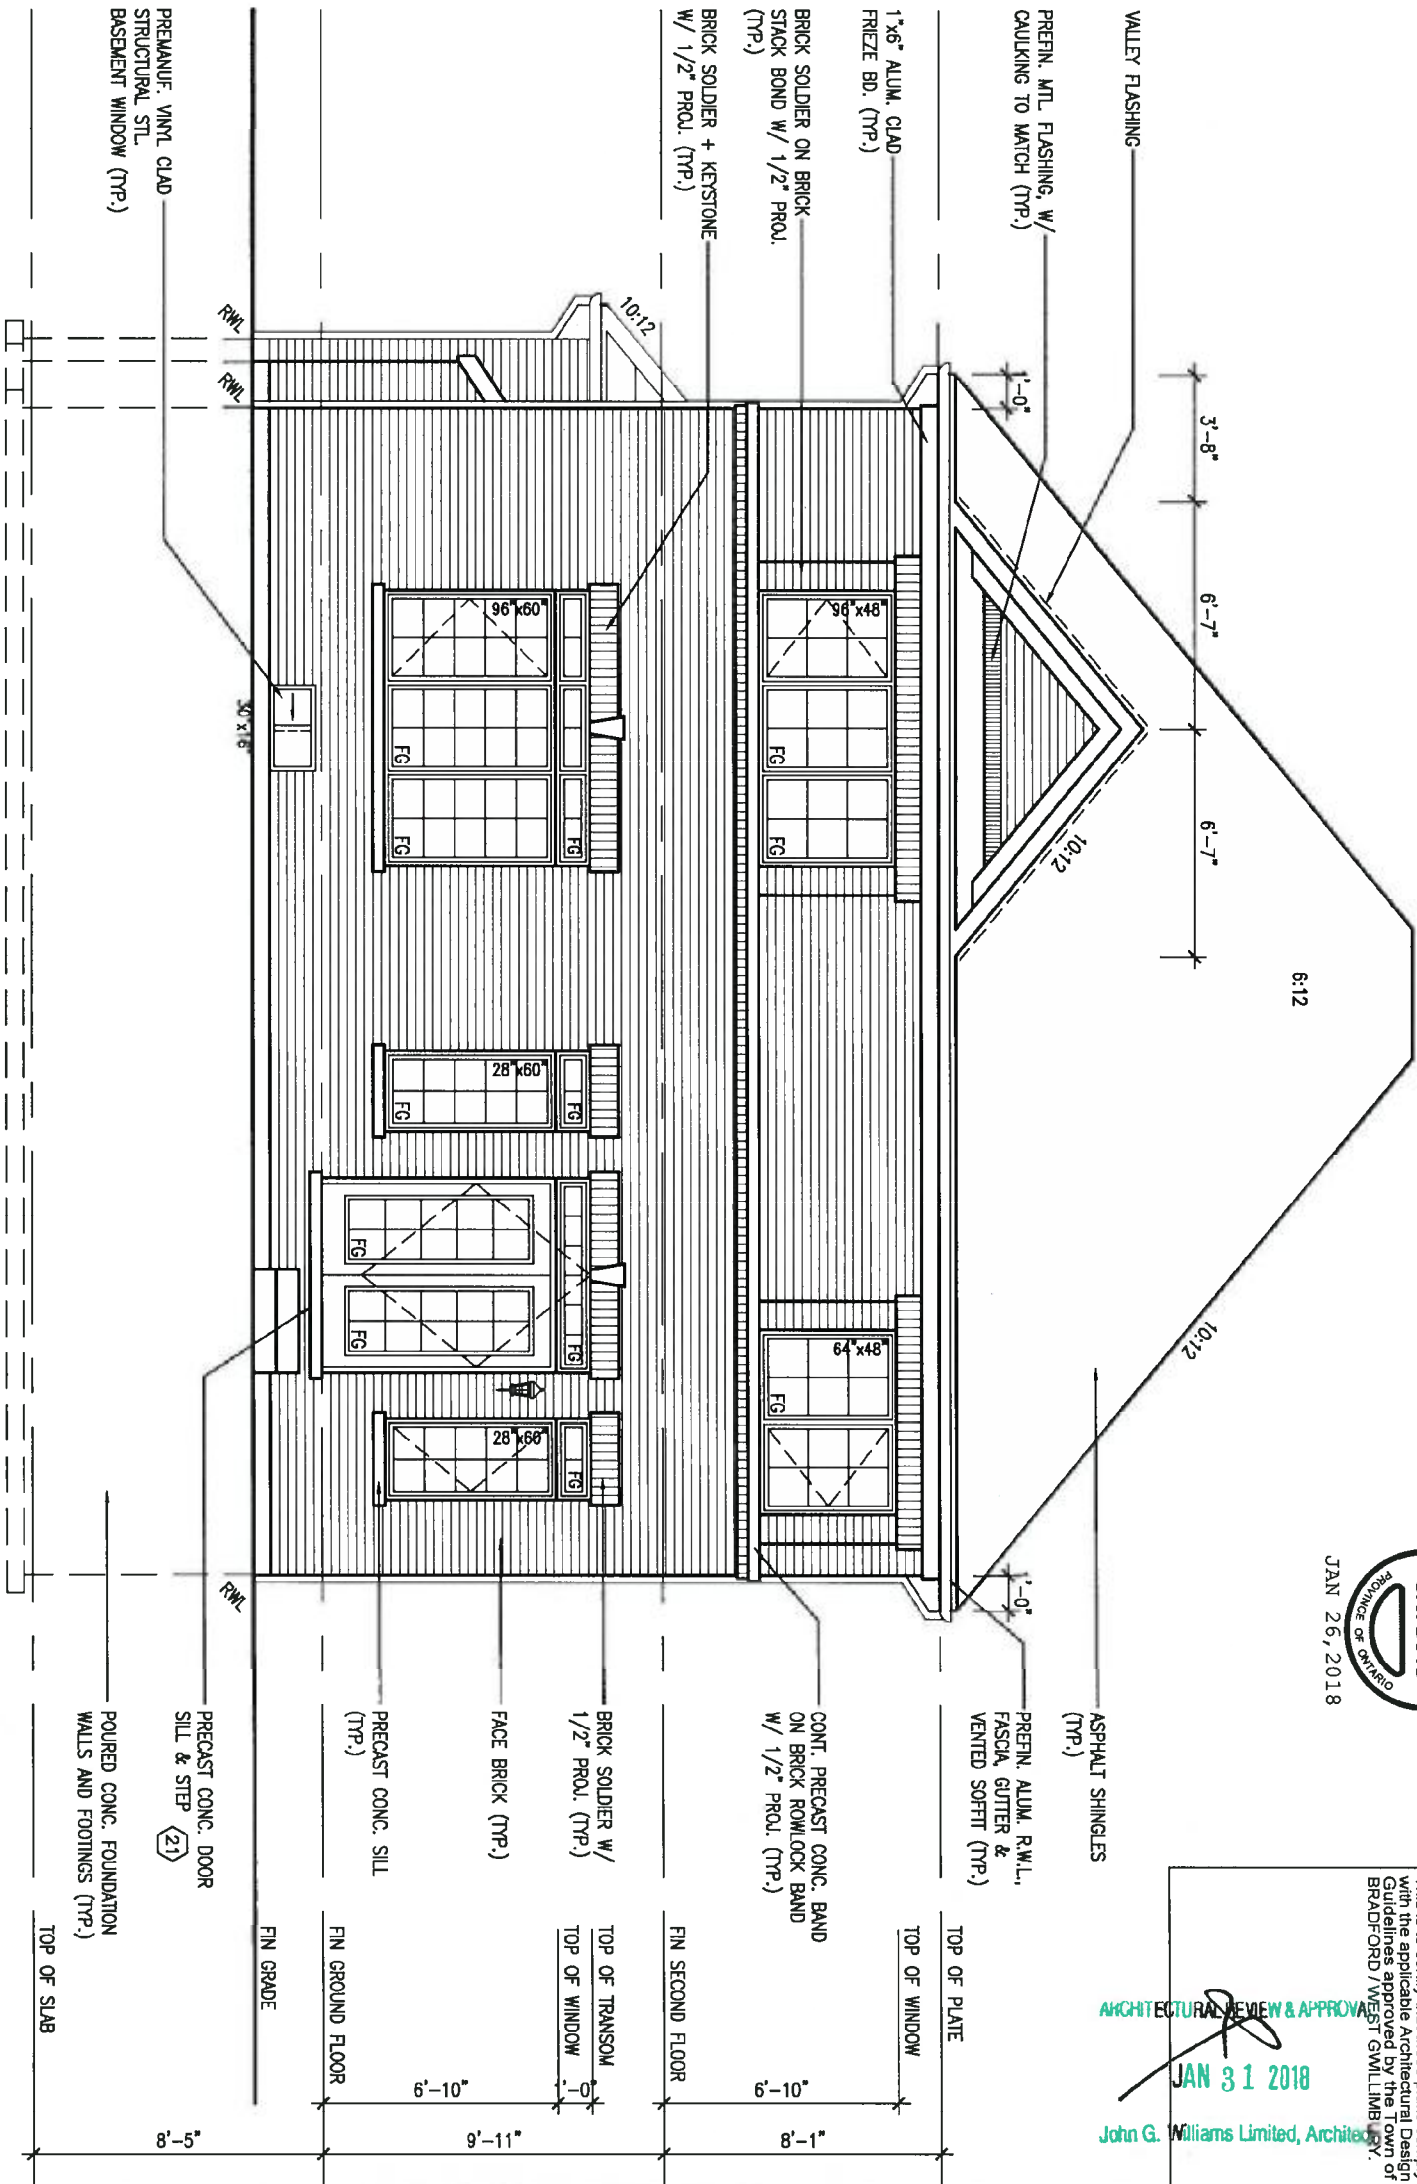
ARCHITECTURAL REVIEW & APPROVAL  
JAN 31 2018  
John G. Williams Limited, Architect

BAYVIEW WELLINGTON		S42-15	
GREEN VALLEY EAST		RIDEAU 15	
project name	BRADFORD	project no.	16023
date	MARCH 2017	file name	16023-S42-15
drawn by	SB	checked by	3/16" = 1'-0"
REAR ELEVATION 'A' 'B' & 'C' WOB			
255 Consumers Rd Suite 120 Toronto ON M2J 1R4 t 416.630.2255 f 416.630.4782 va3design.com		22	
The undersigned has reviewed and takes responsibility for this design and has the qualifications and meets the requirements set out in the Ontario Building Code to be a Designer.		no. description	
qualification information		date	
Wellington Jno-Baptiste		JAN 25-18	
name		RC	
registration information		by	
VA3 Design Inc.		2	
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		ISSUED FOR CLIENT REVIEW	
		REVISED AS PER ENG'S COMMENTS	

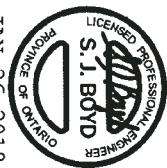
Site Copy



ROOF PLAN 'A'  
W/ UPGRADED REAR



UPGRADED REAR ELEVATION 'A'



ARCHITECTURAL REVIEW & APPROVAL  
JAN 31 2018  
John G. Williams Limited, Architect

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This is to certify that these plans comply with the applicable Architectural Design Guidelines approved by the Town of BRADFORD / WEST GUILDFORD.

9 .		The undersigned has reviewed and takes responsibility for this design and has the qualifications and meets the requirements set out in the Ontario Building Code to be a Designer.		25591		BAYVIEW WELLINGTON		S42-15		project no.	
8 .		Wellington Jno-Baptiste		BCN		GREEN VALLEY EAST		RIDEAU 15		16023	
7 .		name		signature		BRADFORD		municipality		drawing no.	
6 .		registration information		42658		ELEVATION 'A' REAR UPGRADE		file name		23	
5 .		VA3 Design Inc.		Contractor must verify all dimensions on the job and report any discrepancy to the Designer before proceeding with the work. All drawings and specifications are instruments of service and the property of the Designer which must be returned at the completion of the work. Drawings are not to be scaled.		date		by		16023-S42-15	
4 .		2		REVISED AS PER ENG'S COMMENTS		JAN 25-18		RC		1	
3 .		1		ISSUED FOR CLIENT REVIEW		JAN 26-18		RC		2	
no.		description		date		by		no.		description	

**VA3 DESIGN**

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Toronto ON M2J 1R4  
t 416.630.2255 f 416.630.4782  
va3design.com

**BAYVIEW WELLINGTON**

project name  
GREEN VALLEY EAST

date  
MARCH 2017

drawn by  
SB

checked by  
3/16" = 1'-0"

scale  
16023-S42-15.dwg

file name  
16023-S42-15

date  
JAN 26 2018

time  
11:30 AM



It is the builder's complete responsibility to ensure that all plans submitted for approval fully comply with the Architectural Guidelines and all applicable regulations and requirements including zoning provisions and any provisions in the subdivision agreement. The Control Architect is not responsible in any way for existing or proposed building area or building footprint with respect to any zoning or building code or permit matter or that any house can be properly built or located on its lot.

ARCHITECTURAL REVIEW & APPROVAL  
JAN 31 2018  
John G. Williams Limited, Architect



S42-15  
RIDEAU 15

BAYVIEW WELLINGTON

project name GREEN VALLEY EAST municipality BRADFORD

date MARCH 2017 ELEVATION 'A' REAR UPGRADEC 9R WOD  
drawn by SB checked by 3/16" = 1'-0" scale  
file name 16023-S42-15

drawing no. 24



255 Consumers Rd Suite 120  
Toronto ON M2J 1R4  
t 416.630.2255 f 416.630.4782  
va3design.com

The undersigned has reviewed and takes responsibility for this design and has the qualifications and meets the requirements set out in the Ontario Building Code to be a Designer.

qualification information  
Wellington Jno-Baptiste 25591  
signature  
name registration information  
VA3 Design Inc. 42658

Contractor must verify all dimensions on the job and report any discrepancy to the Designer before proceeding with the work. All drawings and specifications are instruments of service and the property of the Designer which must be returned at the completion of the work. Drawings are not to be scaled.

no.	description	date	by
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2	REVISED AS PER ENG'S COMMENTS	JAN 25-18	RC
1	ISSUED FOR CLIENT REVIEW		

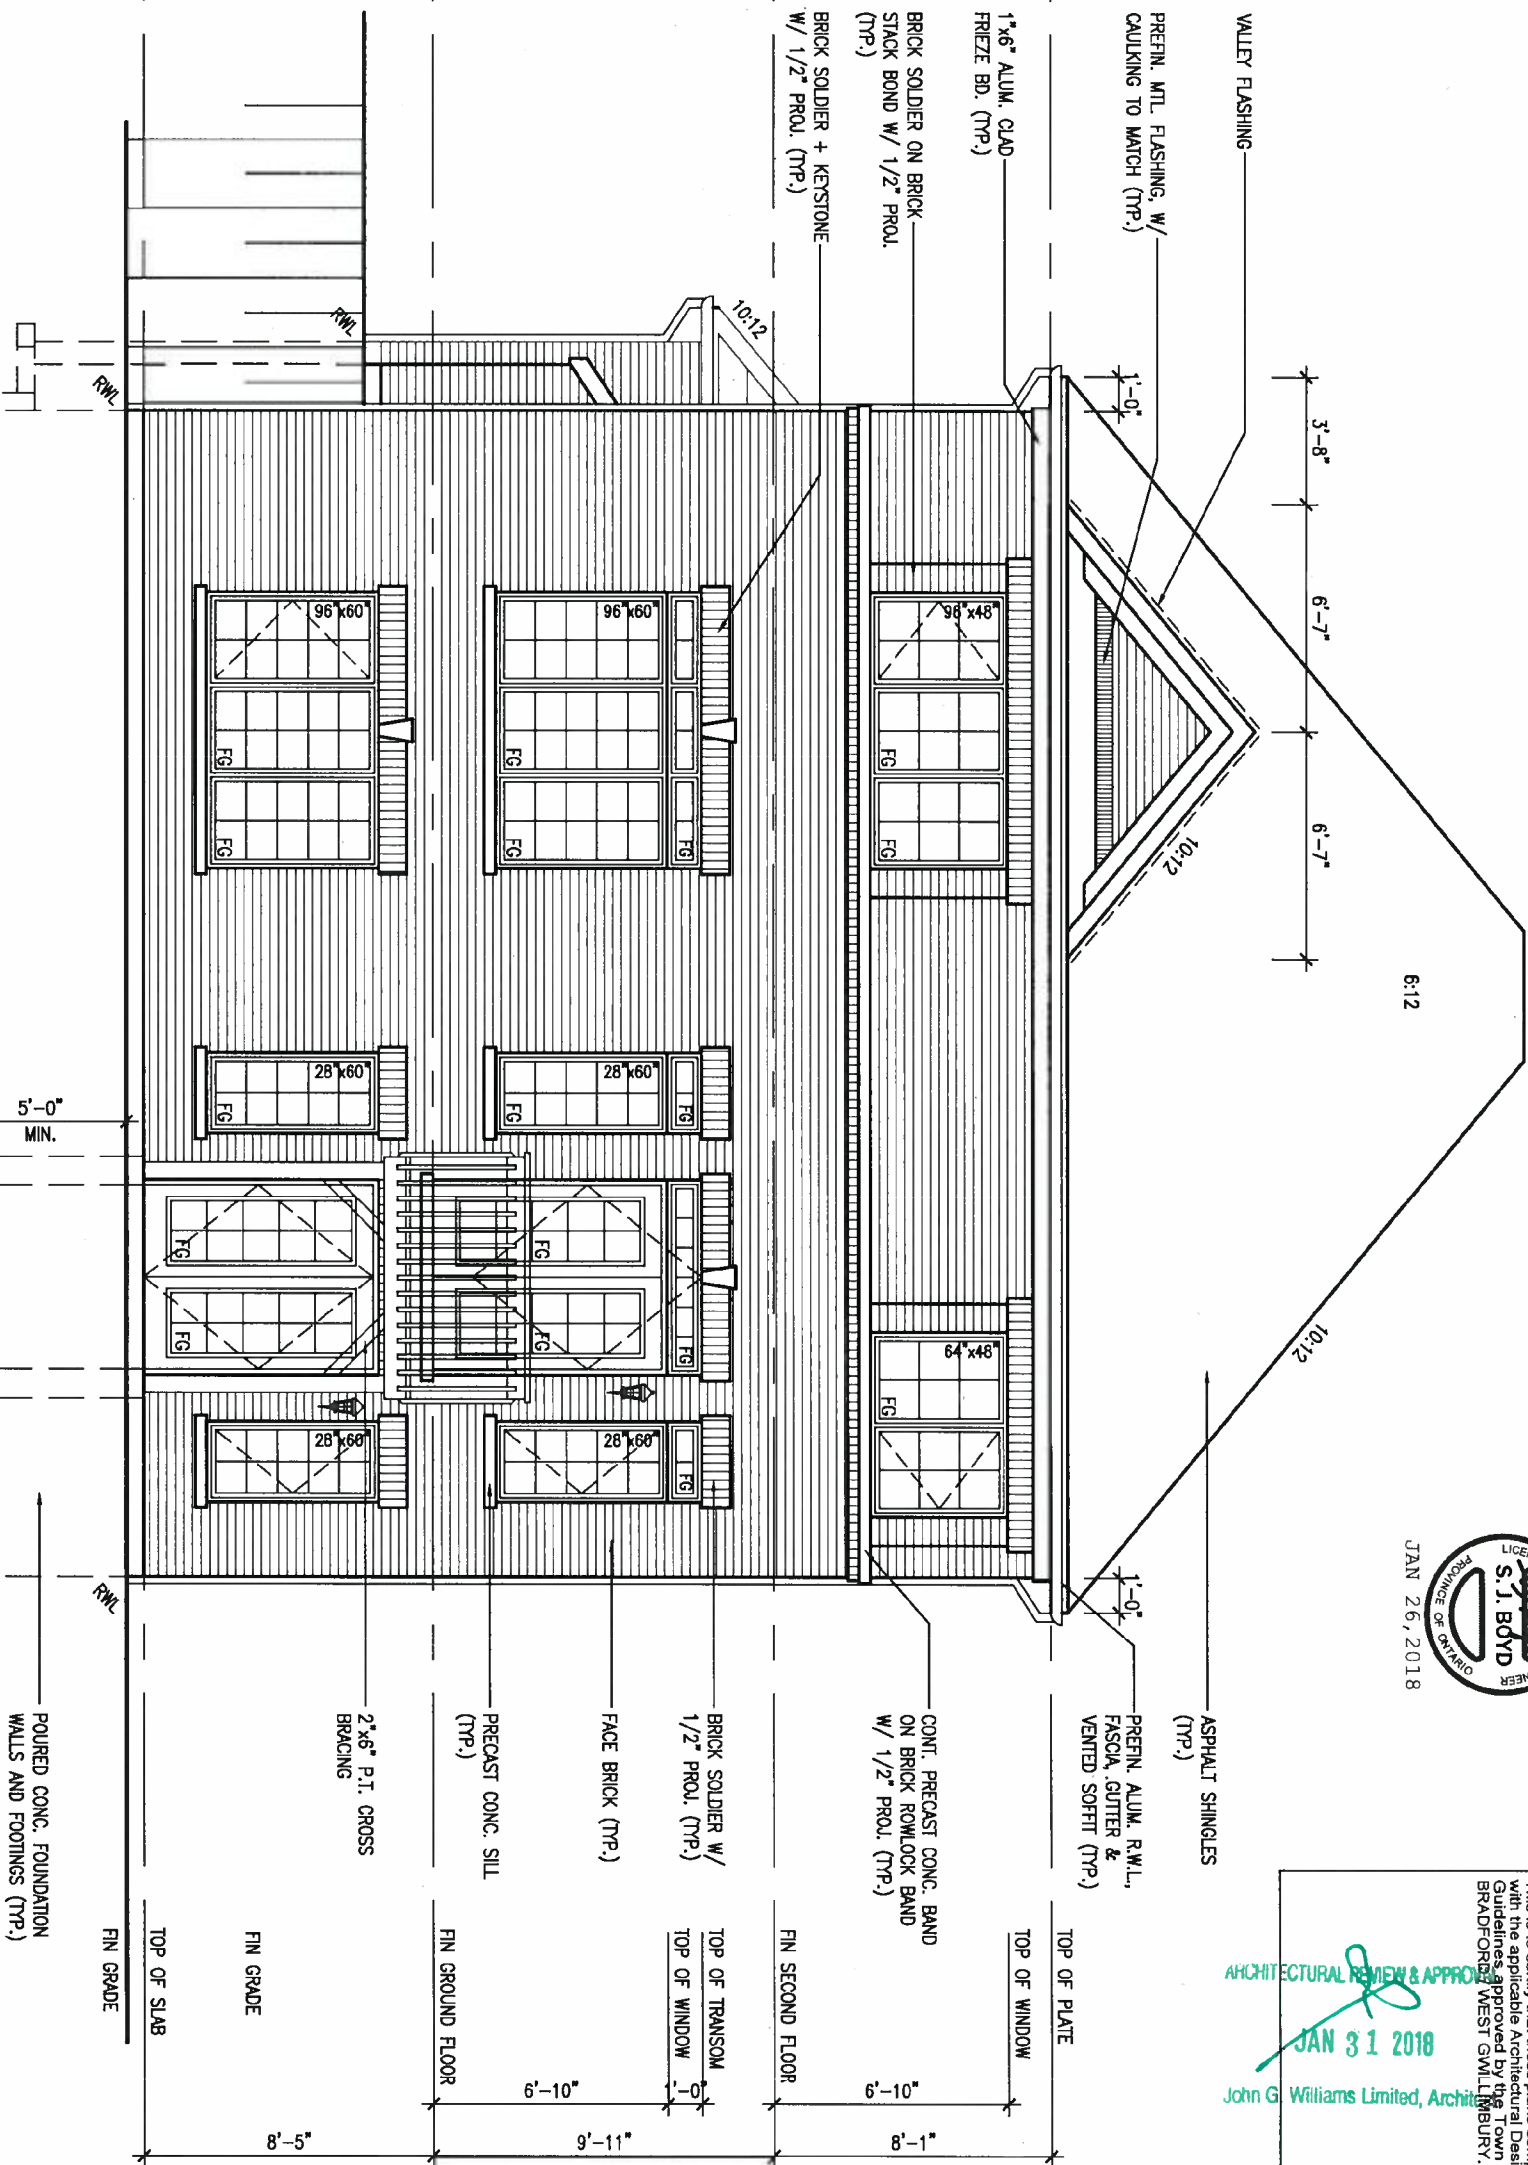
BASEMENT WINDOW SIZES  
4R-8R USE 30"x24" VINYL  
CLAD STRUCTURAL STEEL  
FRAME BASEMENT WINDOWS

Site Copy



ARCHITECTURAL REVIEW & APPROVAL  
JAN 31 2018  
John G. Williams Limited, Architect

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UPGRADED REAR ELEVATION 'A' W/ W.O.B. CONDITION

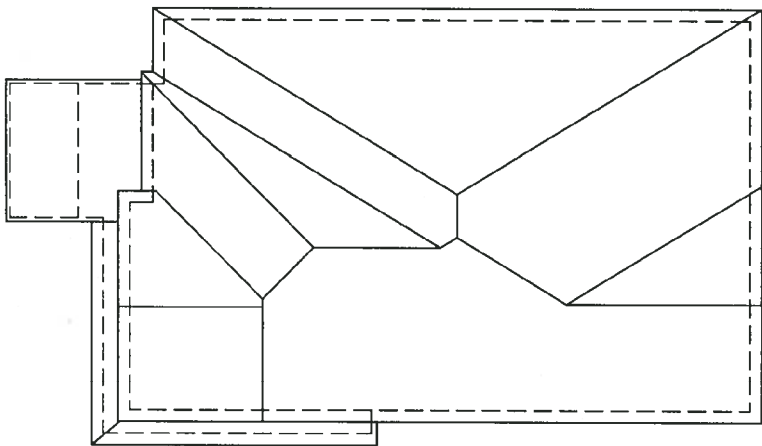
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2.	REVISED AS PER ENG'S COMMENTS	JAN 25-18	RC
1.	ISSUED FOR CLIENT REVIEW		
no.	description	date	by

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qualification information			
Wellington Jno-Baptiste	signature	25591	BCM
name	registration information	VA3 Design Inc.	42658
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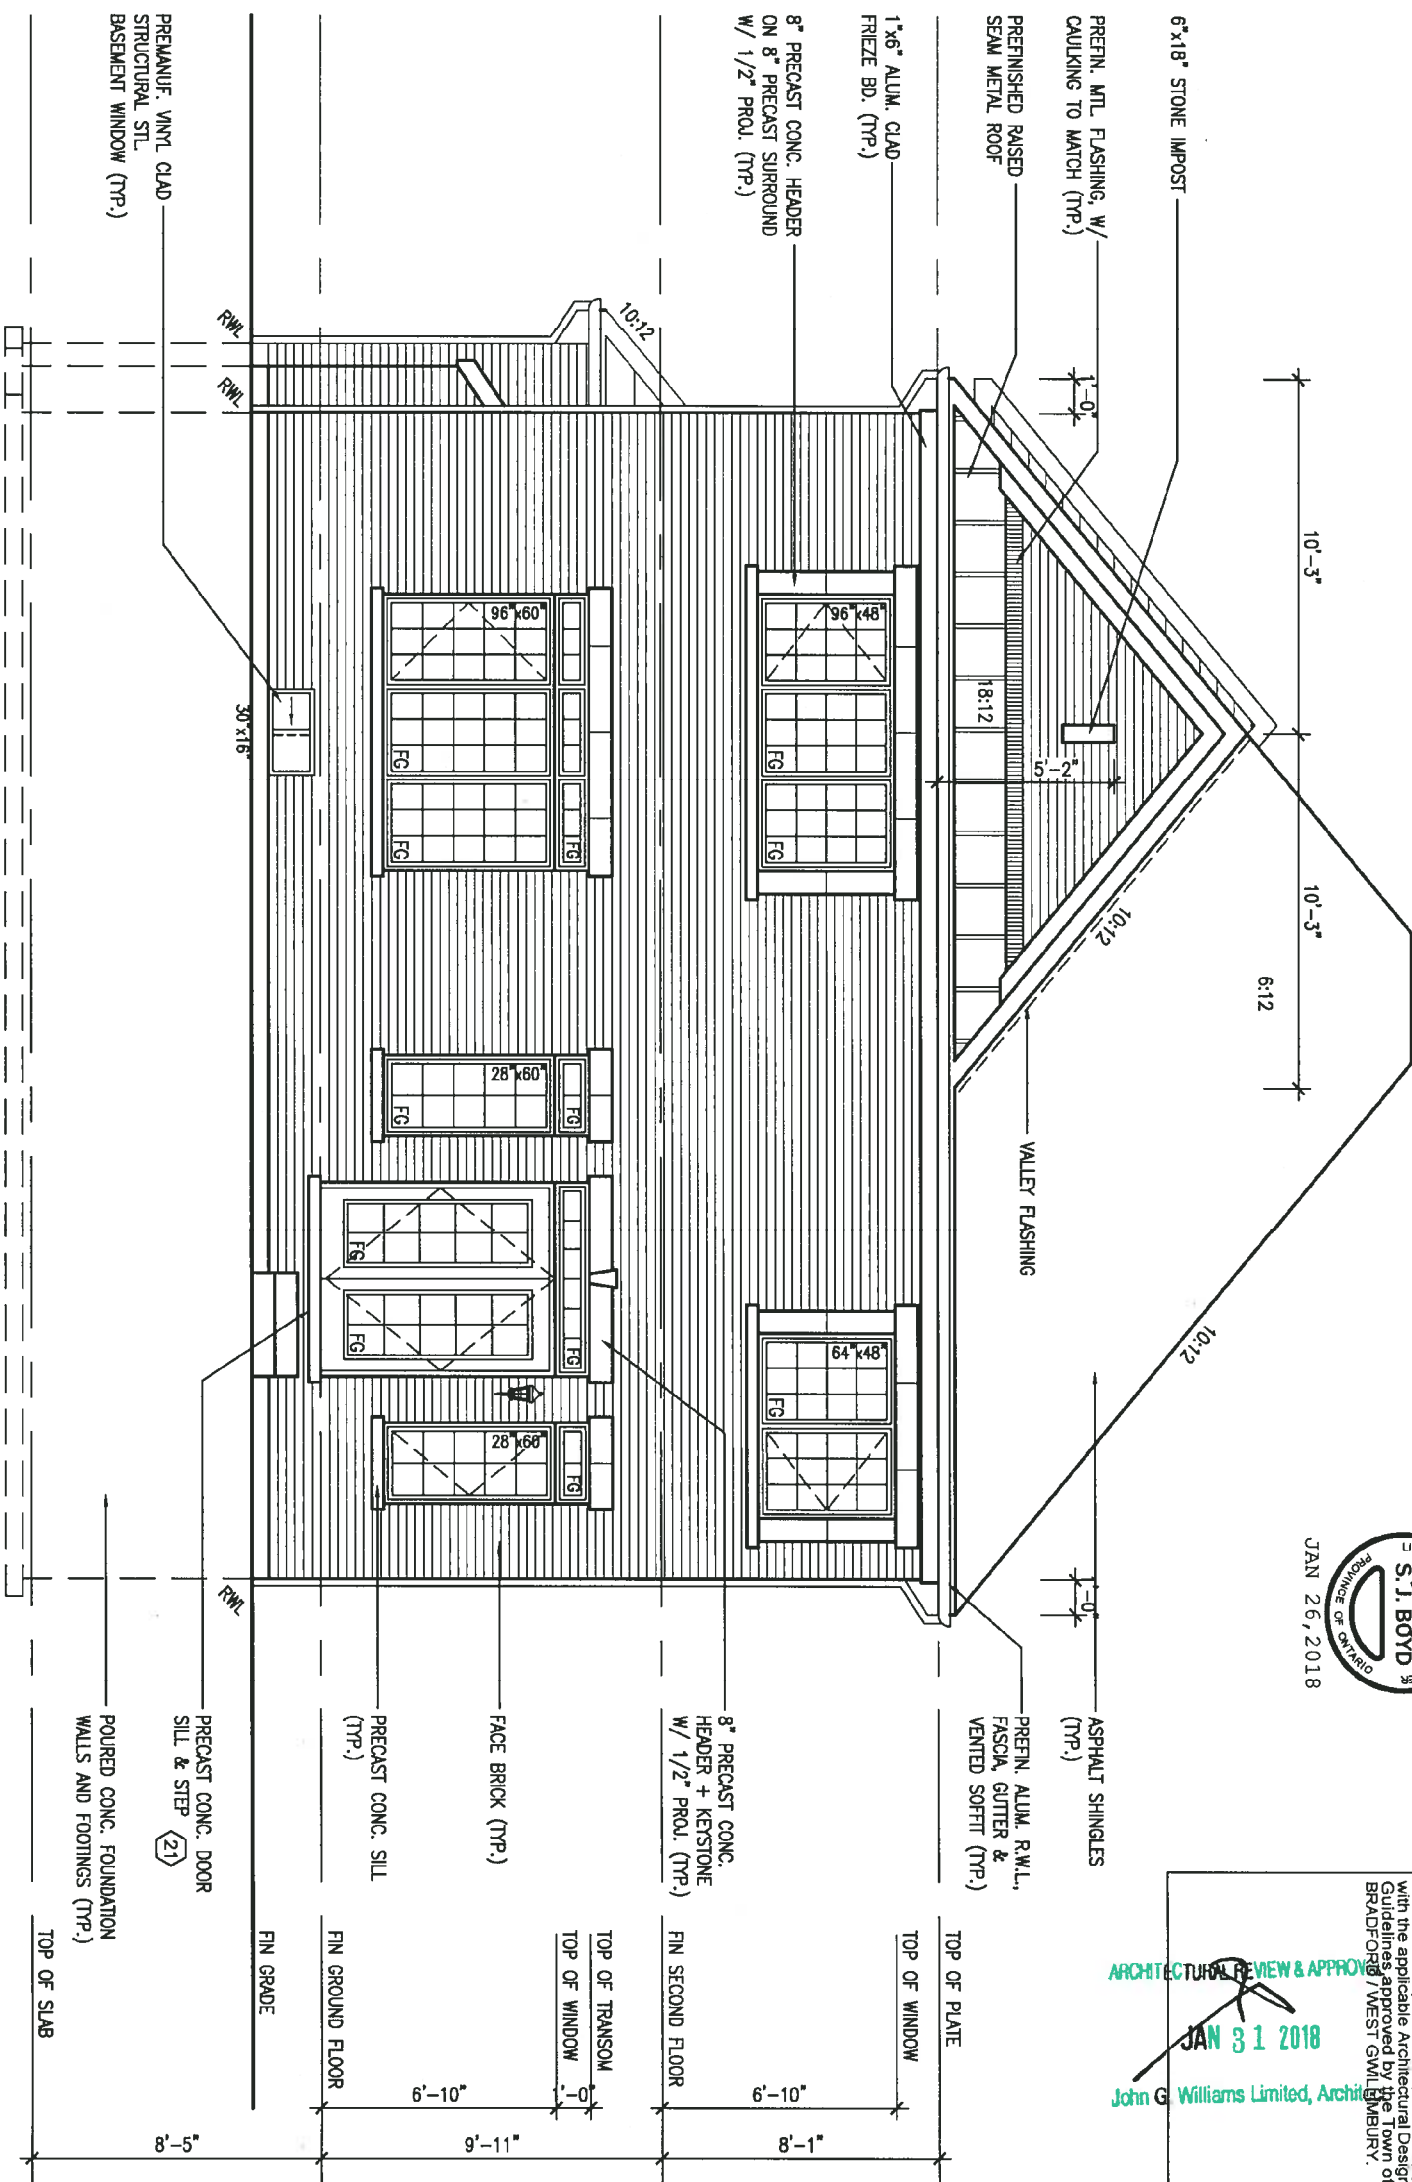
**VA3**  
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
BAYVIEW WELLINGTON		S42-15 RIDEAU 15	
project name GREEN VALLEY EAST	municipality BRADFORD	project no. 16023	drawing no. 25
date MARCH 2017	checked by SB	scale 3/16" = 1'-0"	file name 16023-S42-15
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ROOF PLAN 'B'  
w/ UPGRADED REAR



UPGRADED REAR ELEVATION 'B'



JAN 26, 2018

This is to certify that these plans comply with the applicable Architectural Design Guidelines approved by the Town of Grapeland, West Gwillimbury.

ARCHITECTURAL REVIEW & APPROVAL  
JAN 31 2018  
John G. Williams Limited, Architect

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2	REVISED AS PER ENG'S COMMENTS	JAN 25-18	RC
1	ISSUED FOR CLIENT REVIEW	.	.
no.	description	date	by

The undersigned has reviewed and takes responsibility for this design, and has the qualifications and meets the requirements set out in the Ontario Building Code to be a Designer.	
qualification information	
Wellington Jno-Baptiste	255
name	B
registration information	
VAB3 Design Inc.	426

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va3design.com

**BAYVIEW WELLINGTON**

project name  
**GREEN VALLEY EAST**

BRADFORD

**S42-15**  
RIDEAU 15

project no  
16023

date  
MARCH 2017

### ELEVATION 'B' REAR UPGRADE

drawing no.

drawn by  
CD

checked by \_\_\_\_\_

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26

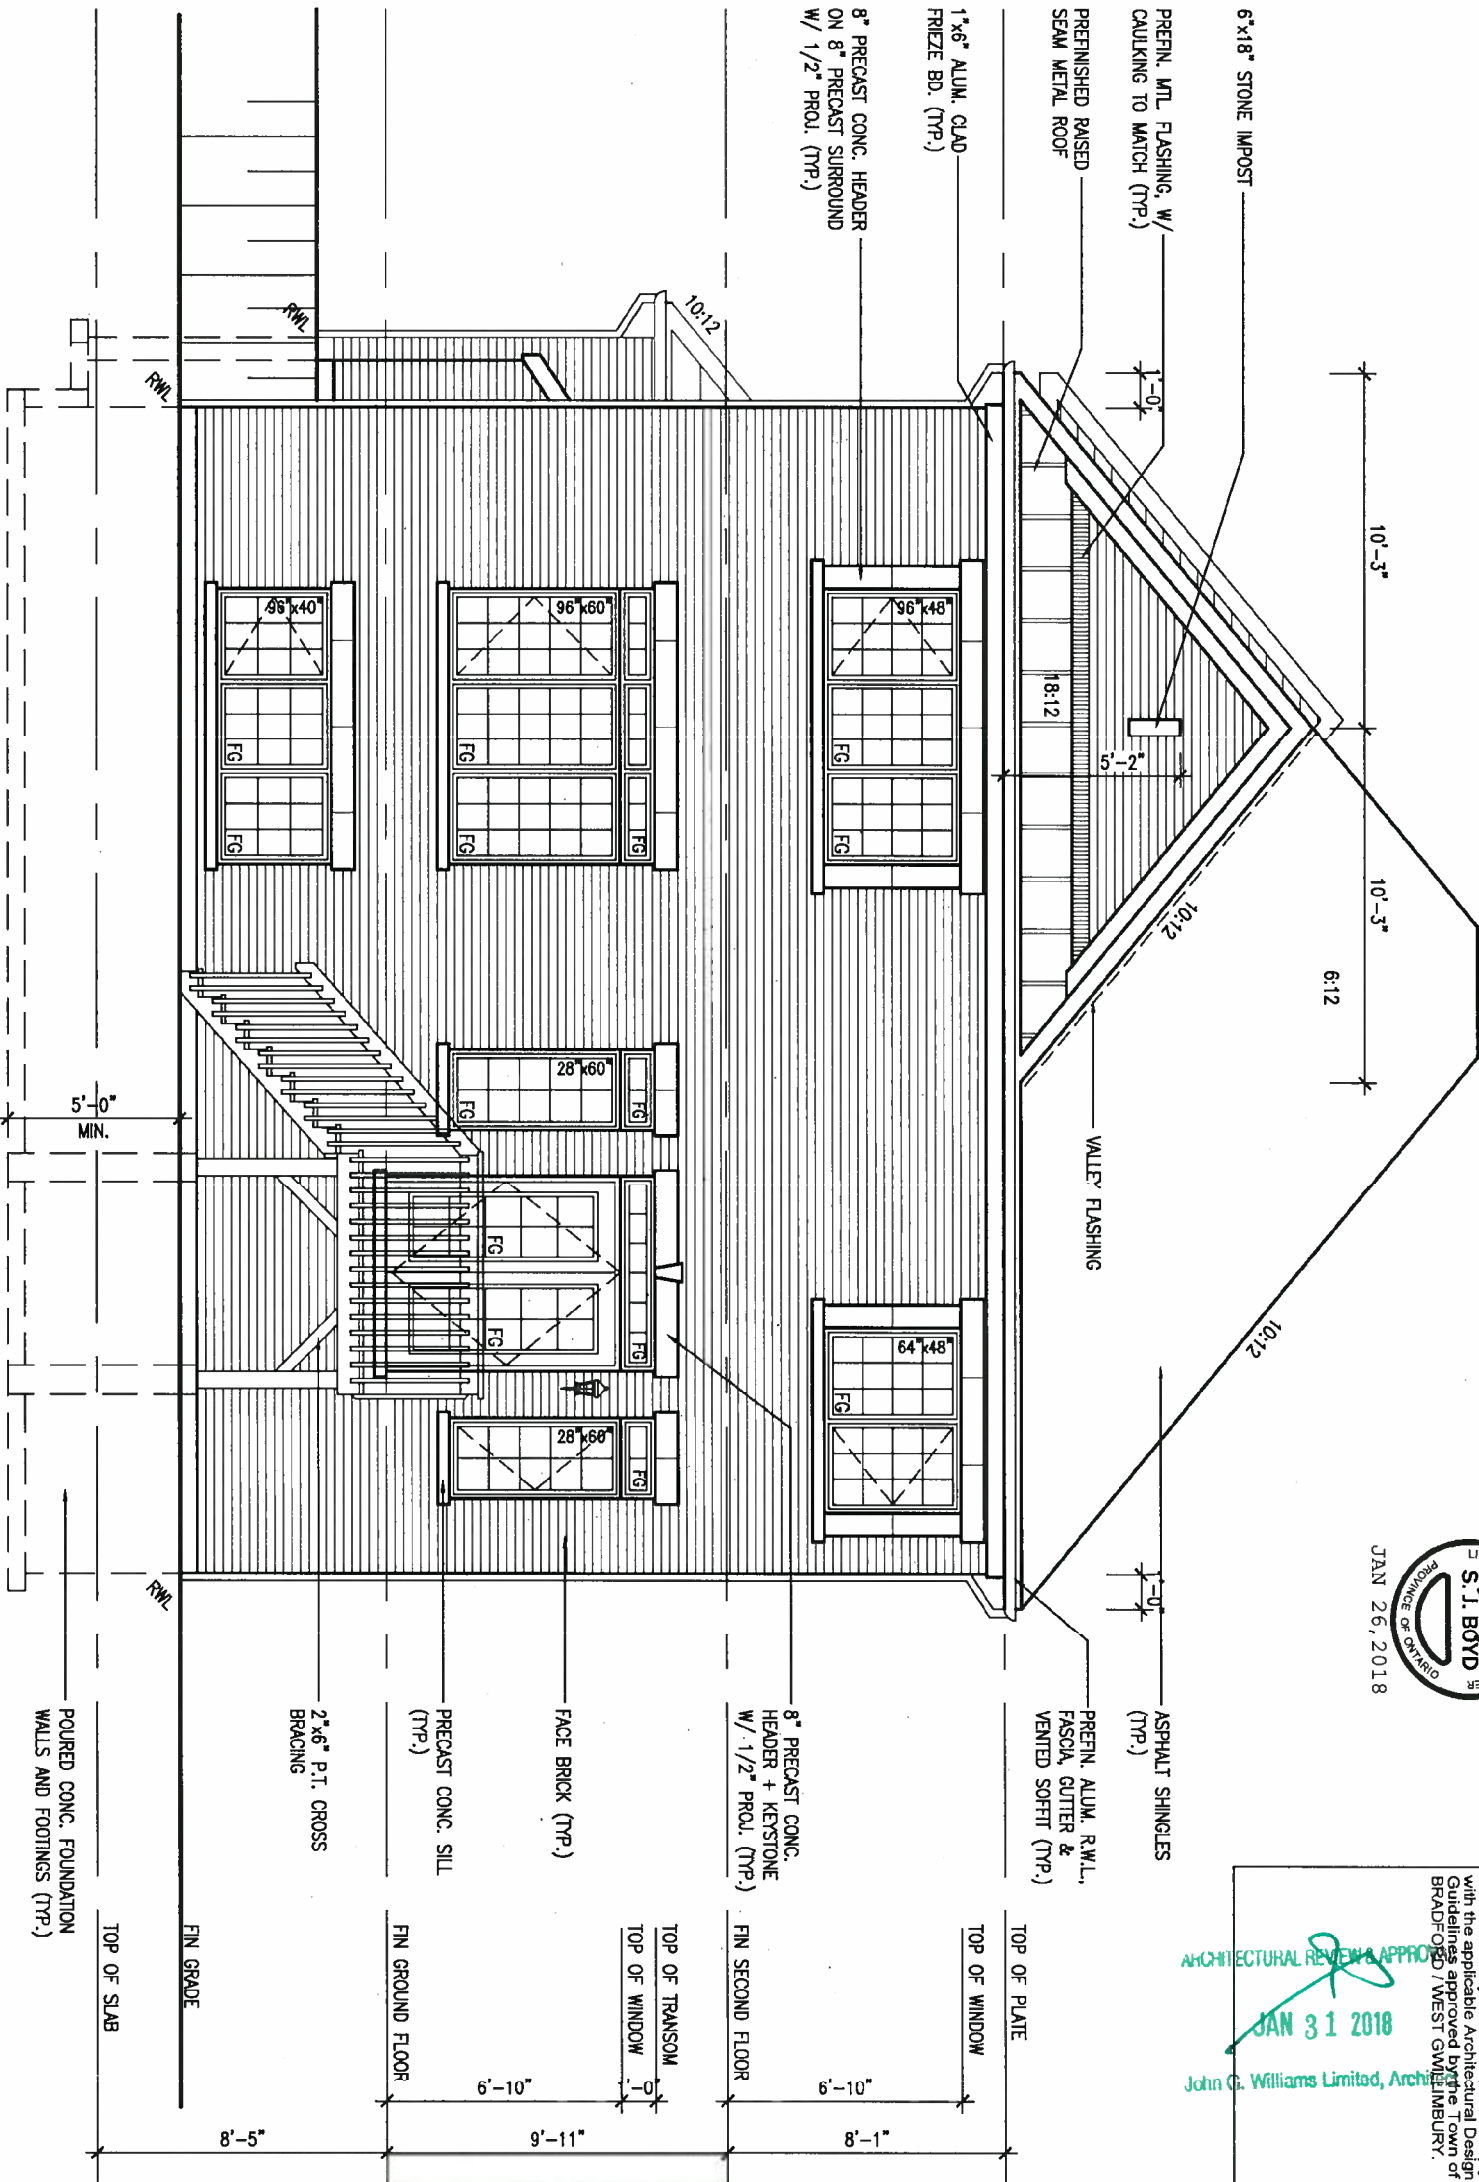
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This is to certify that these plans comply with the applicable Architectural Design Act and the applicable Building Code of the Province of Ontario, and that any house can be properly built or located on its lot.

ARCHITECTURAL REVIEW APPROVED  
JAN 31 2018  
John G. Williams Limited, Architect



UPGRADED REAR ELEVATION 'B' W/ W.O.D. CONDITION  
9R OR MORE

BASEMENT WINDOW SIZES:  
4R-BR USE 30"x24" VINYL  
CLAD STRUCTURAL STEEL  
FRAME BASEMENT WINDOWS

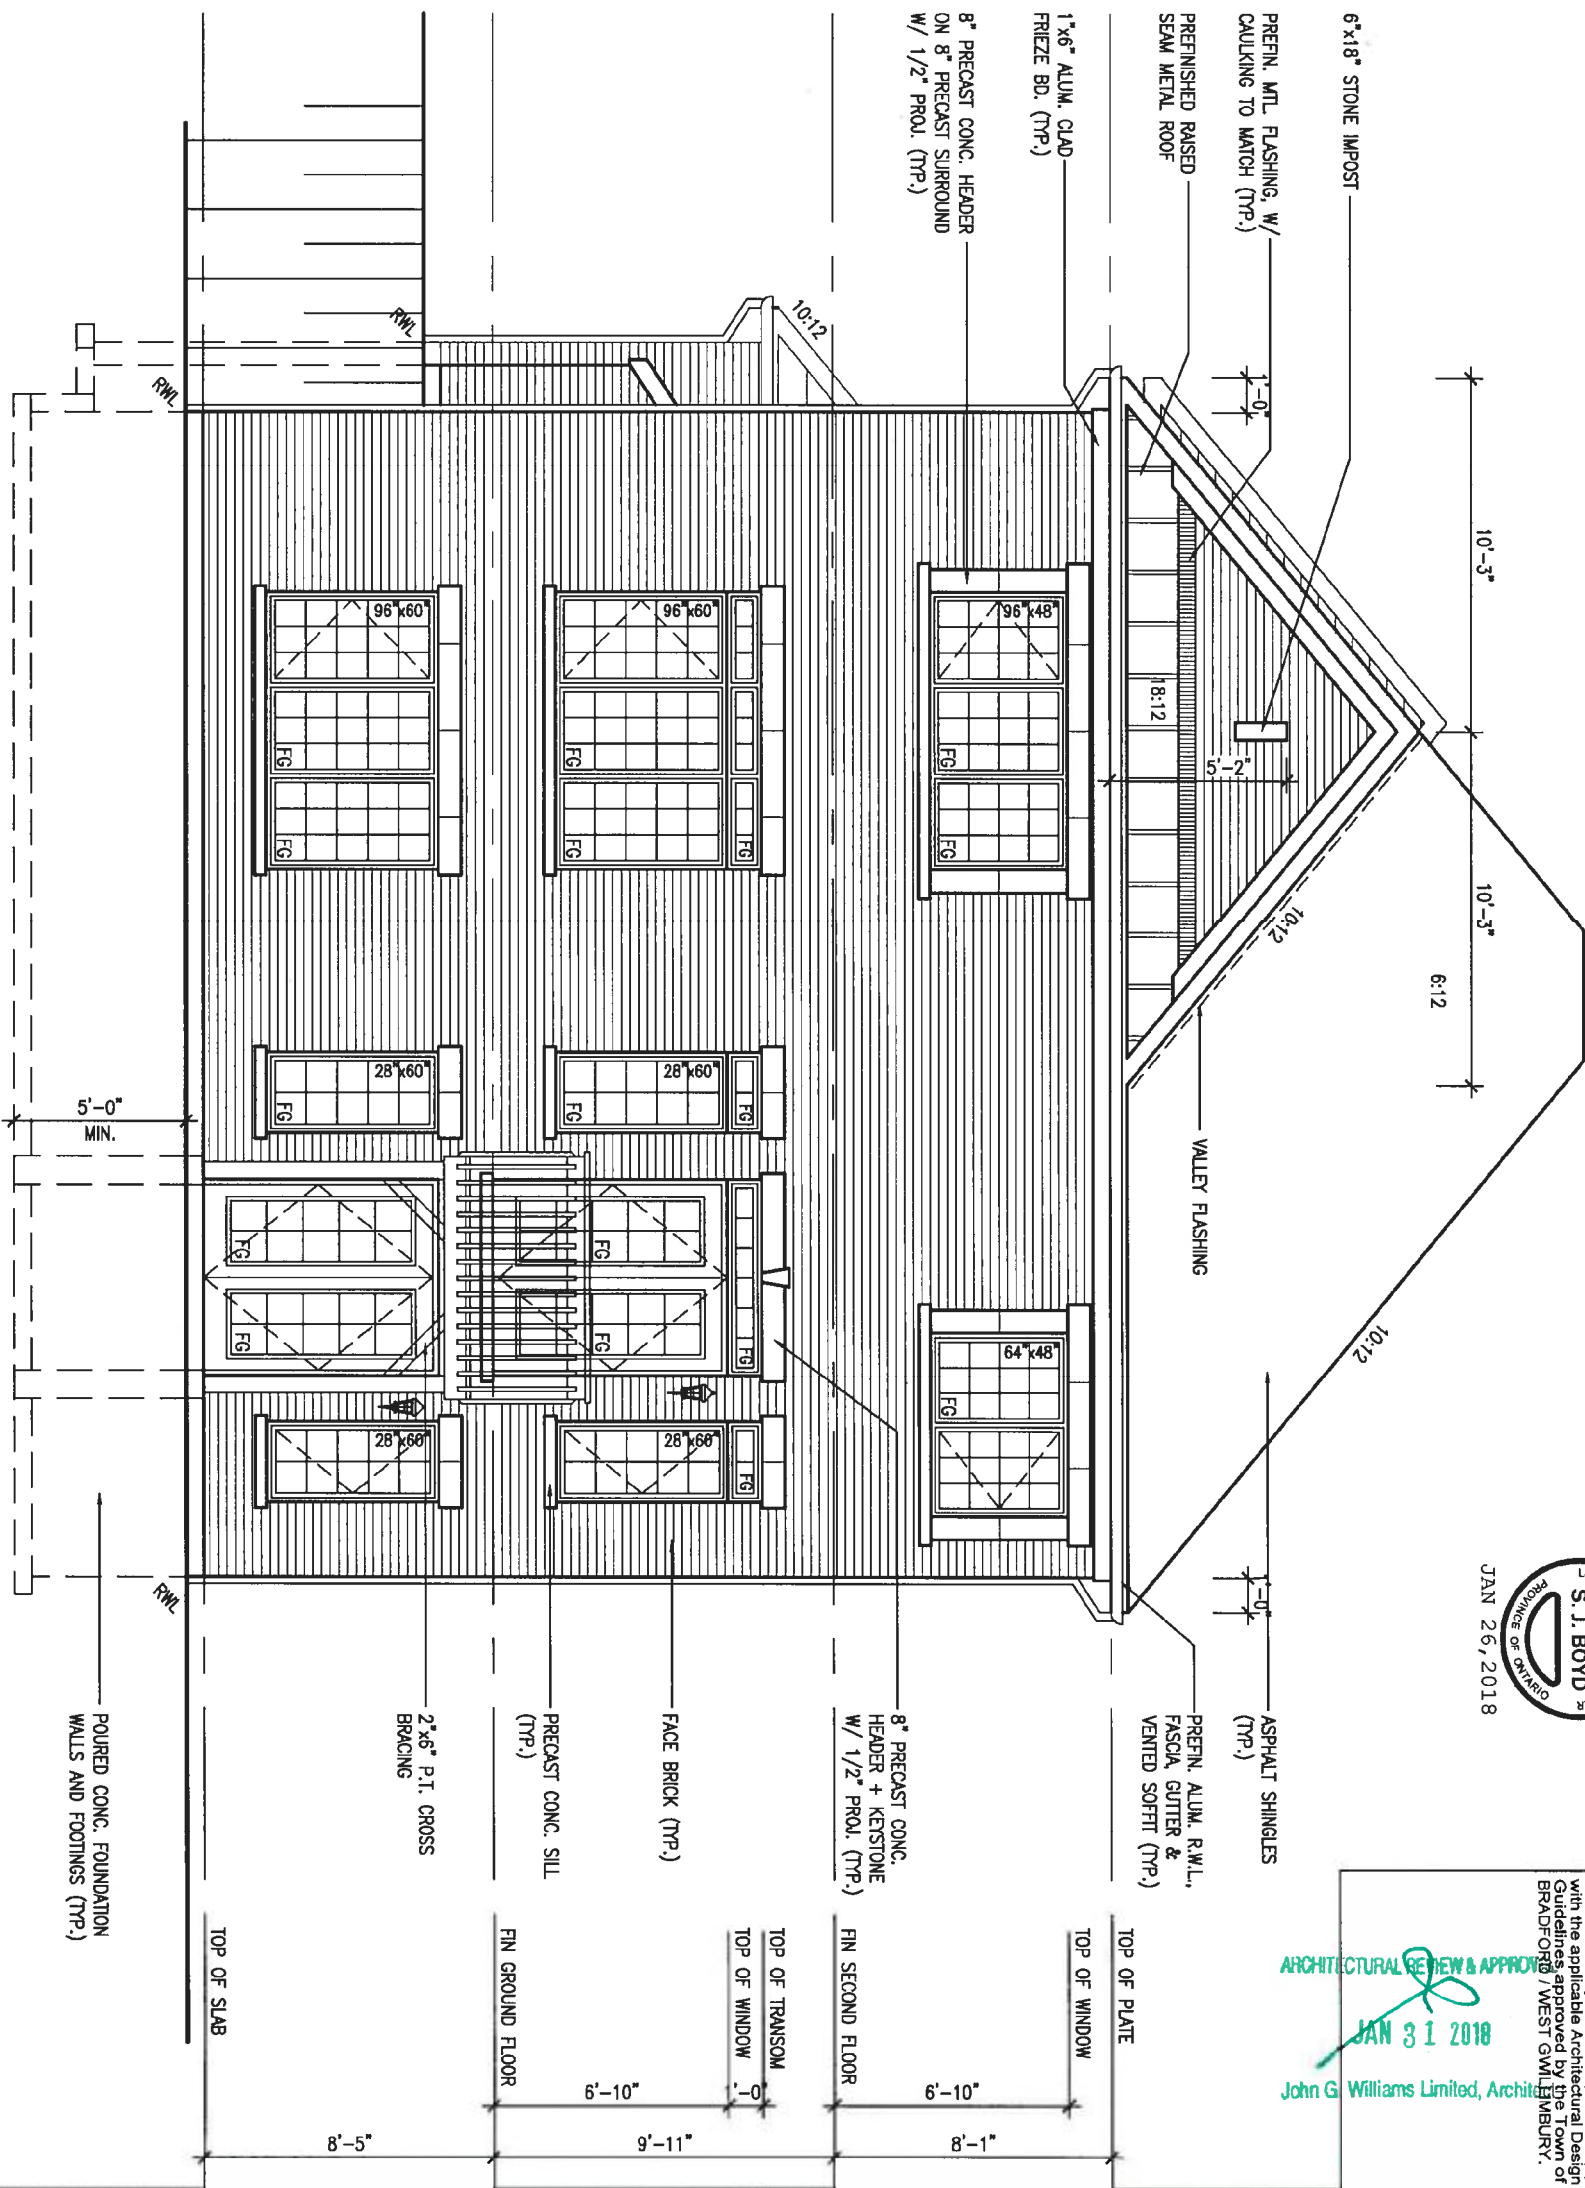
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qualification information			
Wellington Jno-Baptiste	signature	25591	BCIN
name	registration information	VA3 Design Inc.	42658
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BAYVIEW WELLINGTON		S42-15 RIDEAU 15	
project name GREEN VALLEY EAST	municipality BRADFORD	project no. 16023	drawing no. 27
date MARCH 2017	checked by SB	scale 3/16" = 1'-0"	file name 16023-S42-15
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UPGRADED REAR ELEVATION 'B' W/ W.O.B. CONDITION



ARCHITECTURAL REVIEW & APPROVAL  
JAN 31 2018  
John G. Williams Limited, Architect

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registration information			
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BAYVIEW WELLINGTON

project name  
GREEN VALLEY EAST

municipality  
BRADFORD

S42-15  
RIDEAU 15

project no.  
16023

date  
MARCH 2017

drawn by  
SB

checked by

scale  
3/16" = 1'-0"

ELEVATION 'B' REAR UPGRADE WOB

file name  
16023-S42-15

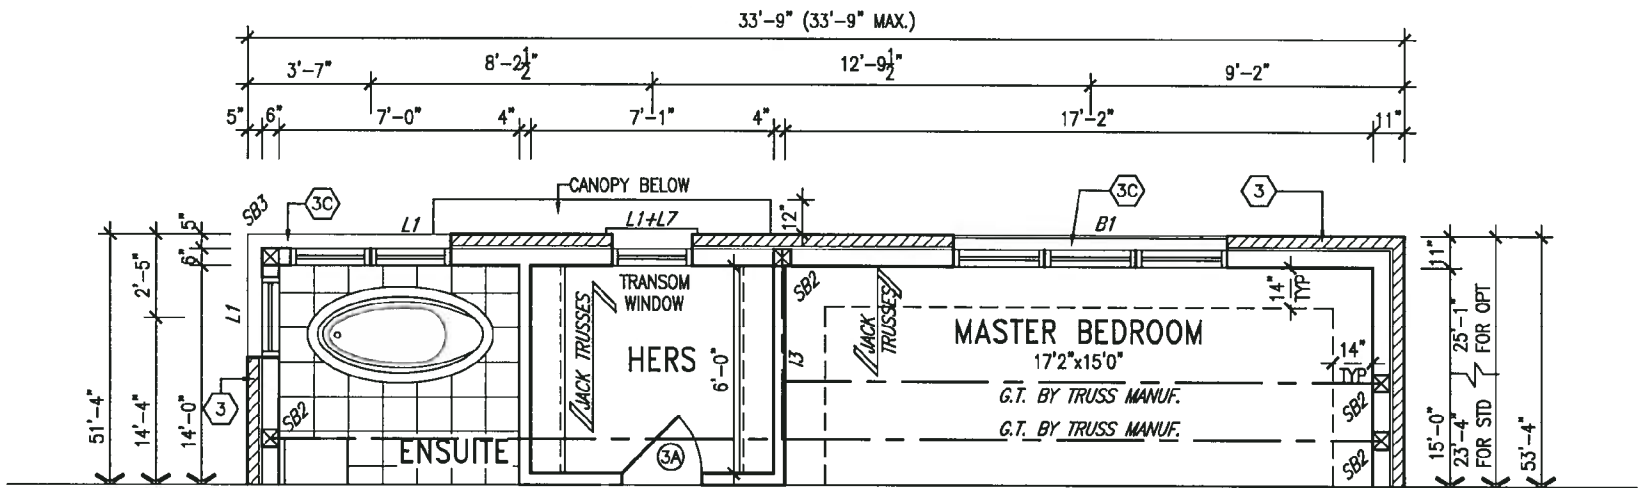
drawing no.  
28

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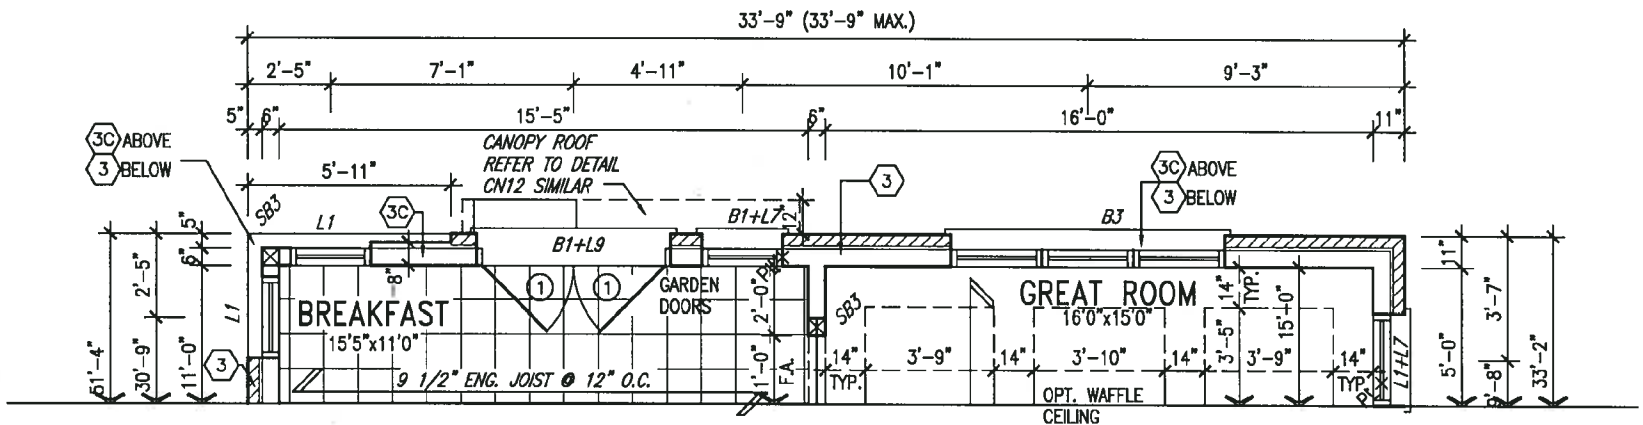
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ARCHITECTURAL REVIEW & APPROVAL  
JAN 31 2018  
John G. Williams Limited, Architect



PARTIAL STD & OPT SECOND FLOOR PLAN ELEVATION 'C' REAR UPGRADE



PARTIAL GROUND FLOOR PLAN ELEVATION 'C' REAR UPGRADE



JAN 26, 2018

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qualification information  
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name  
registration information  
VA3 Design Inc. 42658

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BAYVIEW WELLINGTON

project name  
GREEN VALLEY EAST

municipality  
BRADFORD

S42-15  
RIDEAU 15

project no.  
16023

date  
MARCH 2017

drawn by  
SB

checked by

scale  
3/16" = 1'-0"

ELEVATION 'C' REAR UPGRADE PARTIAL PLANS

file name  
16023-S42-15

drawing no.  
29

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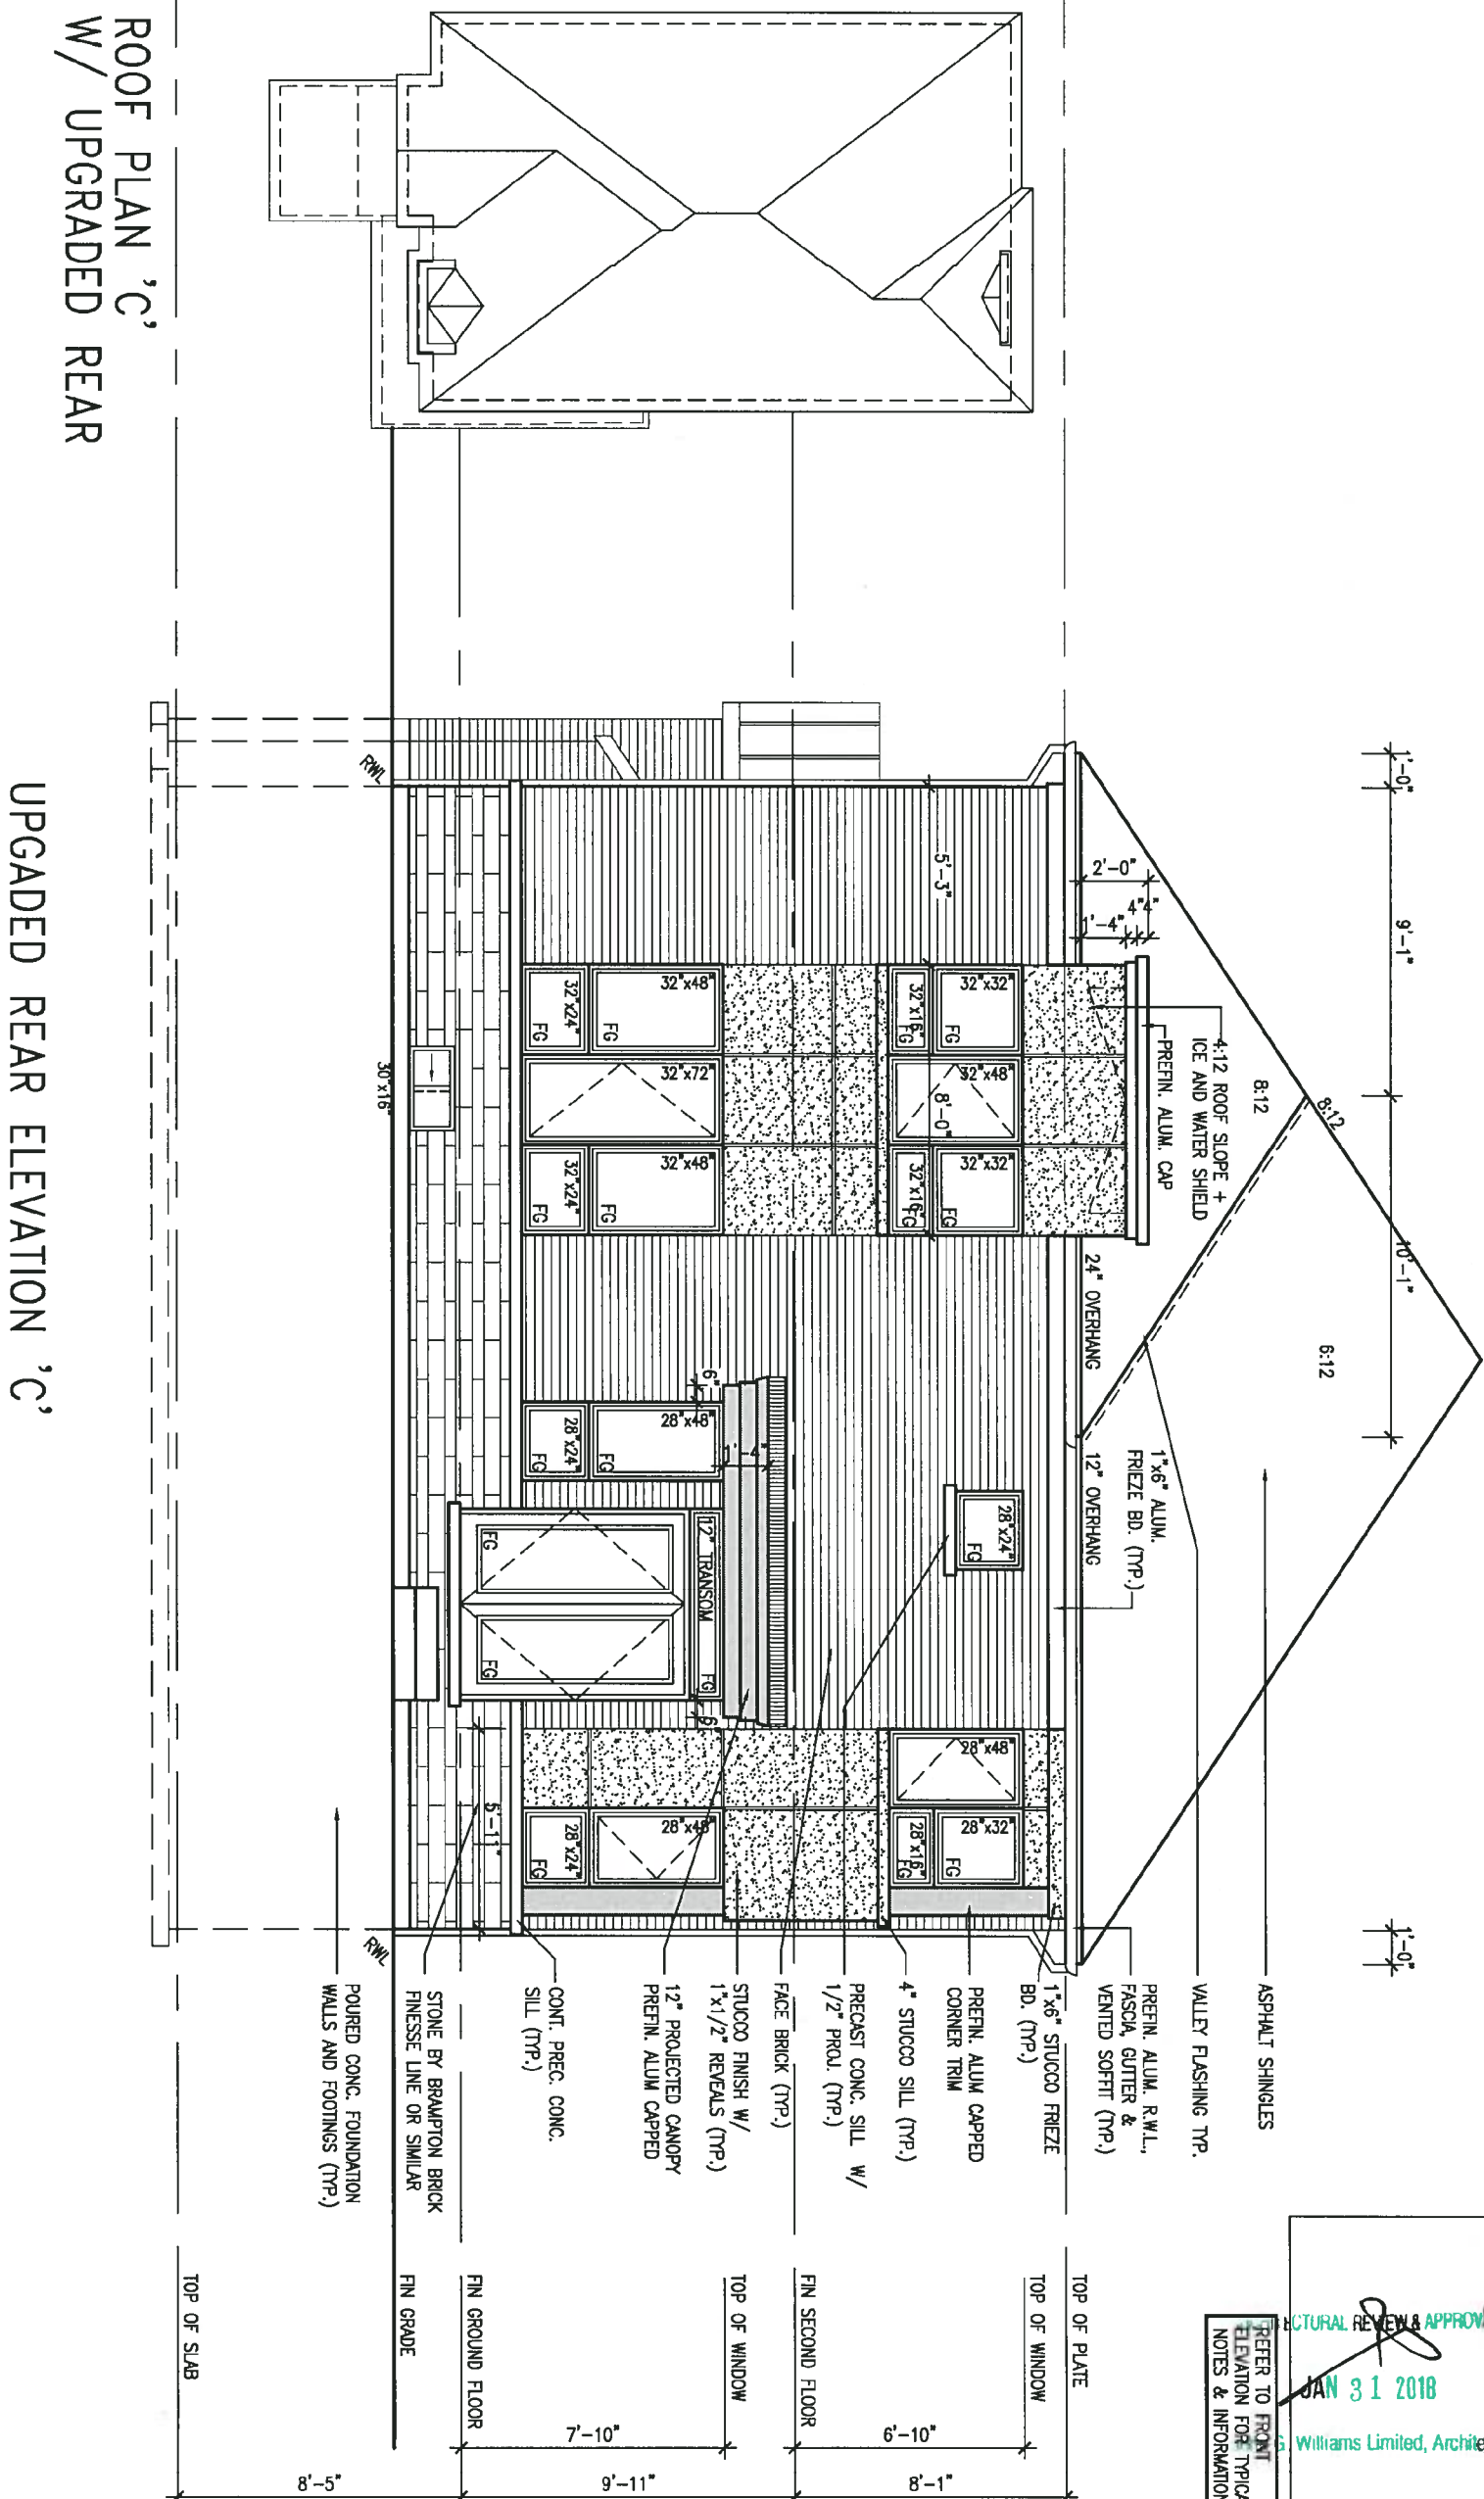


JAN 26, 2018

BRADFORD WEST GILLIMBURY.

STRUCTURAL REVIEW & APPROVAL  
JAN 31 2018  
S. Williams Limited, Architects

PREFER TO FRONT  
ELEVATION FOR TYPICAL  
NOTES & INFORMATION



ROOF PLAN 'C'  
W/ UPGRADED REAR

## UPGRADED REAR ELEVATION 'C'

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no.	description	date	by

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qualification information

Wellington Jno-Baptiste	<i>Jno Baptiste</i>	2559
name	signature	BCR
registration information		
VA3 Design Inc.		42658

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## BAYVIEW WELLINGTON

project name  
**GREEN VALLEY EAST**

BRADFORD

**S42-15**  
RIDEAU 15

project no.  
16023

ELEVATION 'C' REAR UPGRADE

drawing no.  
**30**

date  
MARCH 2017

checked by \_\_\_\_\_ scale  
3/16" = 1'-0"

file name  
16023-S42-15

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# Site Copy

UNINSULATED OPENINGS (PER OBC: SB-12.3.1(7))			
S42-15 ELEVATION C-REAR UPG	ENERGY EFFICIENCY - OBC S912		
ELEVATION	WALL AREA S.F.	OPENING S.F.	PERCENTAGE
FRONT	694 S.F.	130,389 S.F.	18.79 %
LEFT SIDE	1145 S.F.	108,889 S.F.	9.51 %
RIGHT SIDE	1144 S.F.	91,444 S.F.	7.99 %
REAR	675 S.F.	179,056 S.F.	26.53 %
* OPENINGS OMITTED AS PER SB-12 3.1.9(4) MAX 19.9 S.F. REFER TO ELEVATION FOR LOCATION			
TOTAL SQ. FT.	3658.00 S.F.	509.78 S.F.	13.94 %
TOTAL SQ. M.	339.84 S.M.	47.36 S.M.	13.94 %



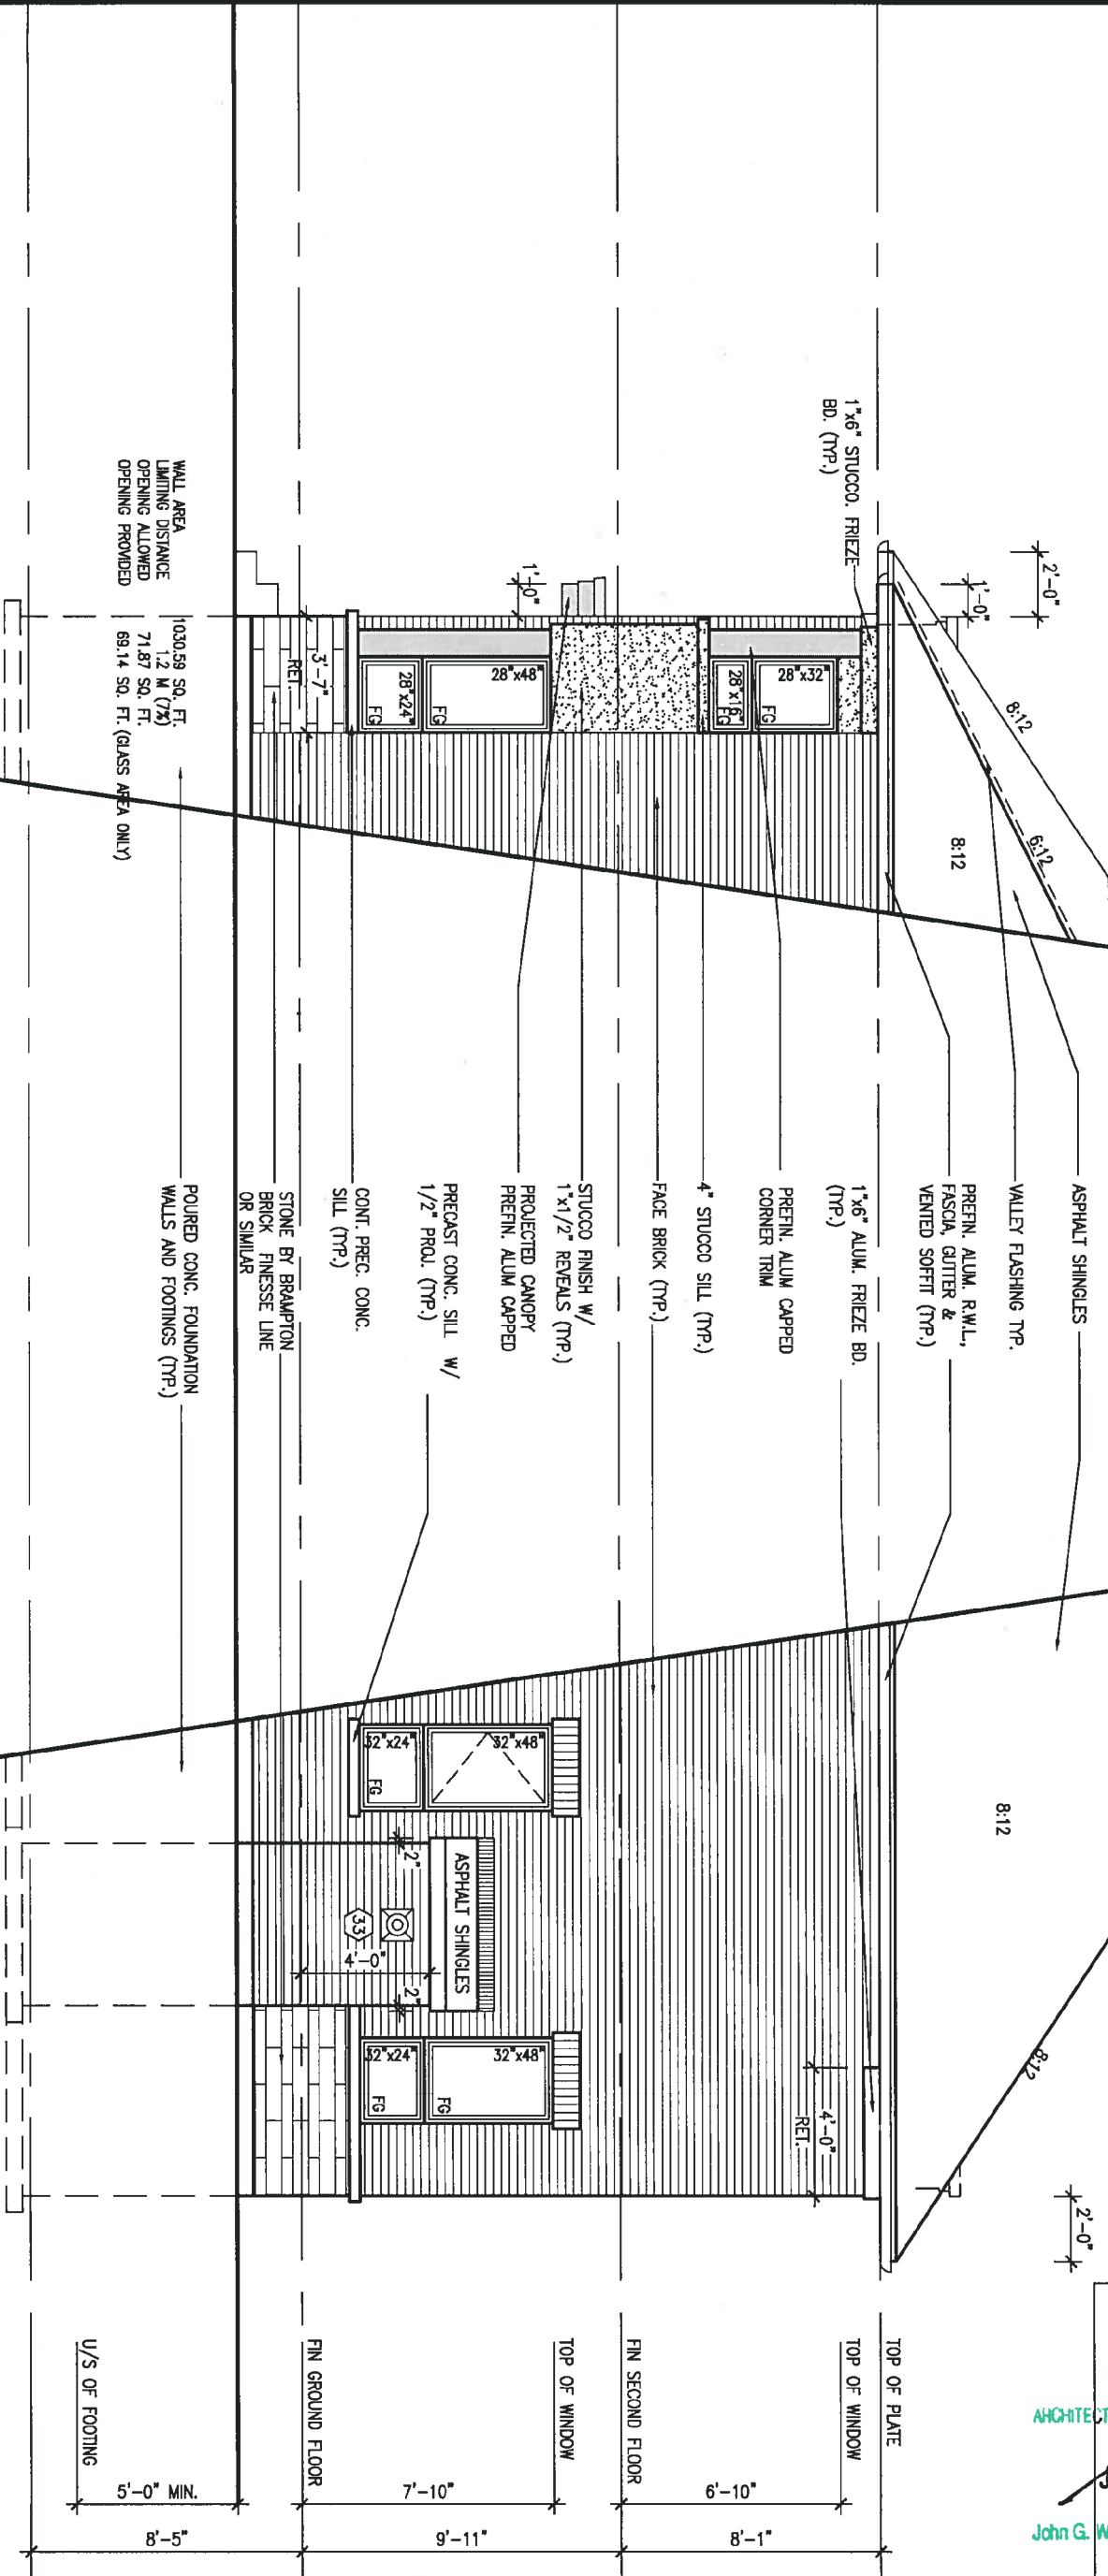
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ARCHITECTURAL REVIEW & APPROVAL  
JAN 31 2018  
John G. Williams Limited, Architect

PART. LEFT SIDE ELEV. 'C'  
W/ REAR UPGRADE

PART. RIGHT SIDE ELEV. 'C'  
W/ REAR UPGRADE



BAYVIEW WELLINGTON		S42-15	
GREEN VALLEY EAST		RIDEAU 15	
project name	BRADFORD	project no.	16023
date	MARCH 2017	drawing no.	31
drawn by	SB	file name	16023-S42-15
checked by	3/16" = 1'-0"	scale	16023-S42-15
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no.	description	date	by
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qualification information	25591
Wellington Jno-Baptiste	BCN
name	42658
registration information	VA3 Design Inc.
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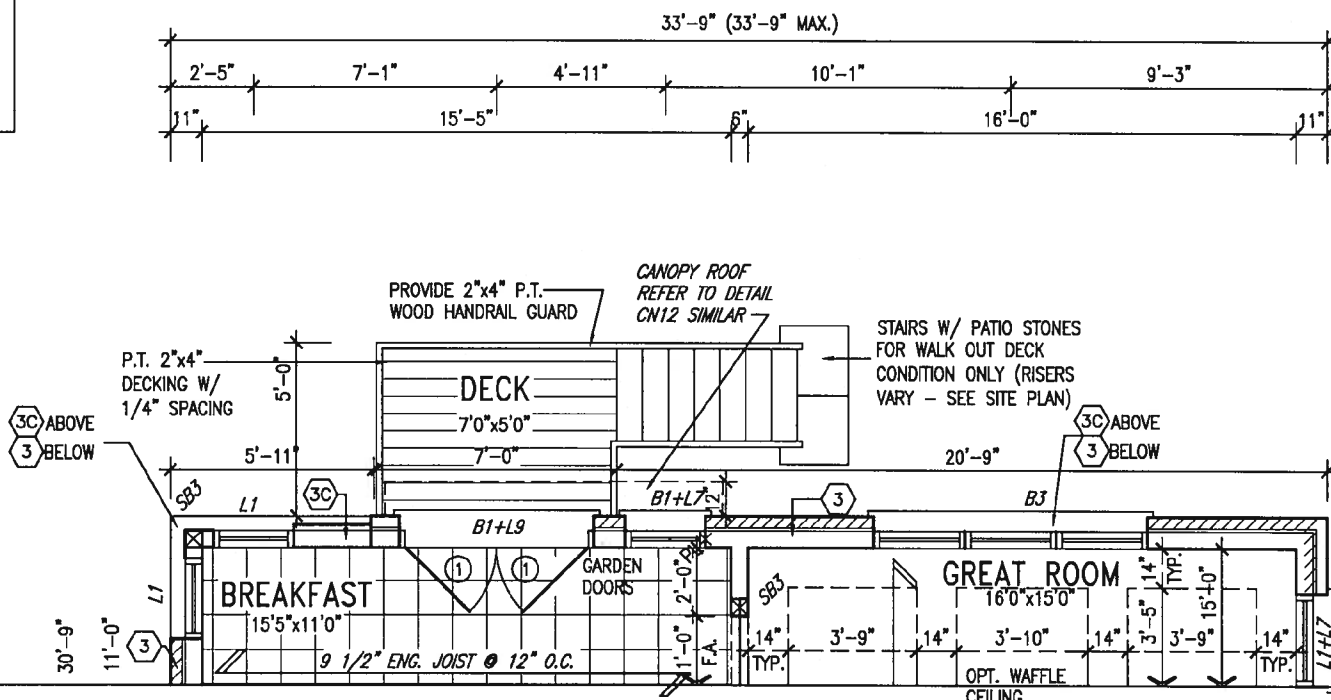
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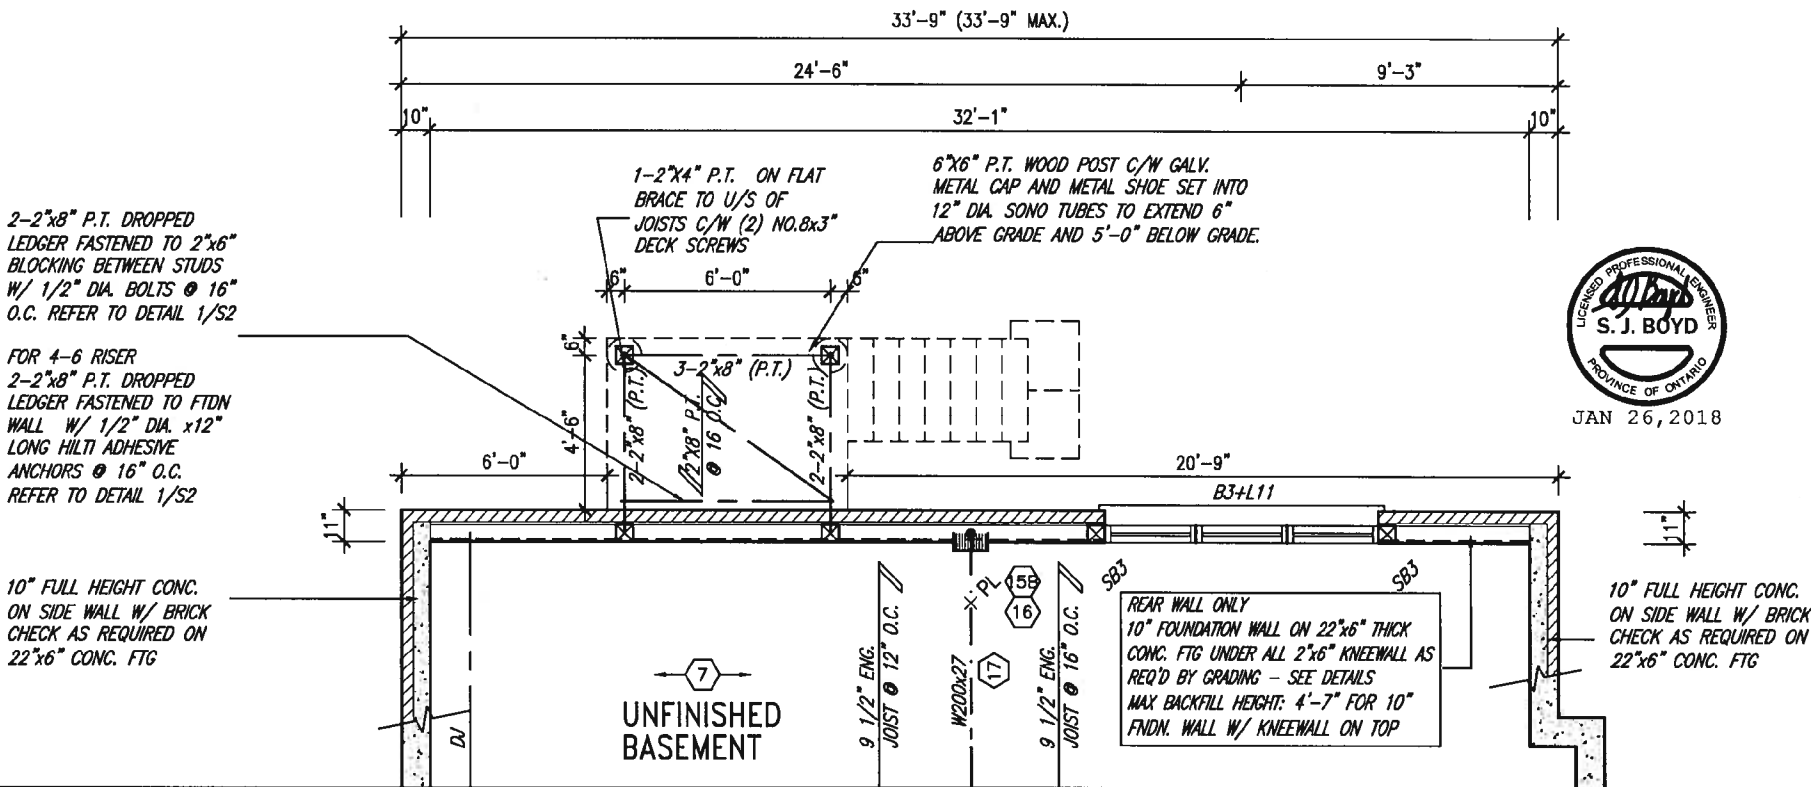
ARCHITECTURAL REVIEW & APPROVAL

JAN 31 2018

John G. Williams Limited, Architect



PARTIAL GROUND FLOOR PLAN ELEVATION 'C' REAR UPGRADE 9R WOD



PARTIAL BASEMENT PLAN ELEVATION C REAR UPGRADE W/ W.O.D. 9R & MORE CONDITION

NOTE:  
REFER TO STANDARD FLOOR PLANS  
FOR ADDITIONAL INFORMATION.

NOTE:  
SPACE ALL FLOOR JOISTS @ 12"  
O.C. UNDER ALL CERAMIC TILE  
AREAS.

NOTE:  
ALL LVL'S SUPPORTING FLOOR LOADS ARE TO BE  
SPECIFIED BY THE FLOOR TRUSS MANUFACTURER.

NOTE:  
FLOOR FRAMING INFO REFER TO ENG SHOP  
DRAWINGS FOR ALL TRUSS-JOIST INFORMATION AND  
DETAILS. UNLESS OTHERWISE NOTED.

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2	REVISED AS PER ENG'S COMMENTS	JAN 25-18	RC
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registration information	
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BAYVIEW WELLINGTON

S42-15  
RIDEAU 15

project name  
GREEN VALLEY EAST

municipality  
BRADFORD

project no.  
16023

date  
MARCH 2017

drawn by  
SB

checked by  
3/16" = 1'-0"

scale

file name  
16023-S42-15

drawing no.  
32

16023-S42-15

16023-S42-15

16023-S42-15

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16023-S42-15



UNINSULATED OPENINGS (PER OBC, SB-12.3.1(7))			
S42-15 ELEV C-REAR UPC 9R WOD	ENERGY EFFICIENCY - OBC SB12		
ELEVATION	WALL AREA S.F.	OPENING S.F.	PERCENTAGE
FRONT	694 S.F.	130,389 S.F.	18.79 %
LEFT SIDE	1145 S.F.	108,889 S.F.	9.51 %
RIGHT SIDE	1144 S.F.	91,444 S.F.	7.99 %
REAR	810 S.F.	202,389 S.F.	24.99 %
* OPENINGS OMITTED AS PER SB-12.3.1.9(4) MAX 19.9 S.F. REFER TO ELEVATION FOR LOCATION			
		0 S.F.	
TOTAL SQ. FT.	3793.00 S.F.	533,111 S.F.	14.06 %
TOTAL SQ. M.	352.38 S.M.	49.53 S.M.	14.06 %

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ARCHITECTURAL REVIEW & APPROVAL  
JAN 31 2018  
G. Williams Limited, Architects

REFER TO FRONT ELEVATION FOR TYPICAL NOTES & INFORMATION

UPGRADED REAR ELEVATION 'C' W/ W.O.D. CONDITION 9R OR MORE

POURED CONC. FOUNDATION WALLS AND FOOTINGS (TYP.)

STONE BY BRAMPTON BRICK FINESSE LINE OR SIMILAR  
2"x6" P.T. CROSS BRACING

CONT. PREC. CONC. SILL (TYP.)

FACE BRICK (TYP.)  
12" PROJECTED CANOPY  
PREFIN. ALUM. CAPPED

STUCCO FINISH W/ 1"x1/2" REVEALS (TYP.)  
PRECAST CONC. SILL W/ 1/2" PROJ. (TYP.)  
4" STUCCO SILL (TYP.)

1"x6" STUCCO FRIEZE BD. (TYP.)  
PREFIN. ALUM. CAPPED CORNER TRIM

PREFIN. ALUM. R.W.L., FASCIA, GUTTER & VENTED SOFFIT (TYP.)

TOP OF PLATE  
TOP OF WINDOW  
FIN SECOND FLOOR  
TOP OF WINDOW  
FIN GROUND FLOOR  
TOP OF WINDOW  
FIN GRADE  
TOP OF SLAB

6'-10"  
8'-1"  
6'-10"  
9'-11"  
7'-10"  
8'-5"  
6'-10"



BASEMENT WINDOW SIZES  
4R-8R USE 30"x24" VINYL CLAD STRUCTURAL STEEL FRAME BASEMENT WINDOWS

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2.	REVISED AS PER ENG'S COMMENTS	JAN 25-18	RC		
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**VA3 DESIGN**  
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Toronto ON M2J 1R4  
t 416.630.2255 f 416.630.4782  
va3design.com

<b>BAYVIEW WELLINGTON</b>			<b>S42-15</b>	
			RIDEAU 15	
project name		municipality		project no.
<b>GREEN VALLEY EAST</b>		<b>BRADFORD</b>		<b>16023</b>
date		drawing no.		
<b>MARCH 2017</b>		<b>33</b>		
drawn by		file name		
SB		16023-S42-15		
checked by		scale		
SB		3/16" = 1'-0"		
RICHARD - H:\ARCHIVE\WORKING\2016\16023.BW\Units\42\16023-S42-15.dwg - Fri - Jan 26 2018 - 11:30 AM				

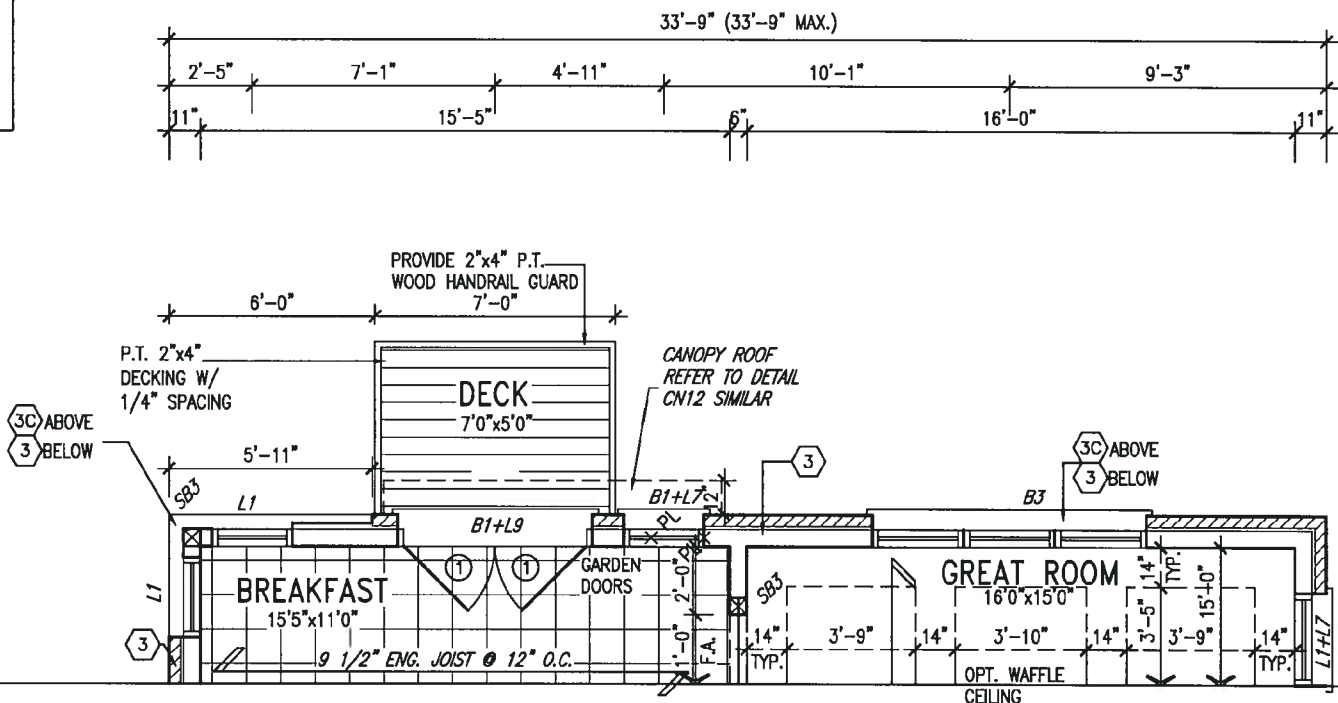
It is the builder's complete responsibility to ensure that all plans submitted for approval fully comply with the Architectural Guidelines and all applicable regulations and requirements including zoning provisions and any provisions in the subdivision agreement. The Control Architect is not responsible in any way for examining or approving site (lotting) plans or working drawings with respect to any zoning or building code or permit matter or that any house can be properly built or located on its lot.

This is to certify that these plans comply with the applicable Architectural Design Guidelines approved by the Town of BRADFORD / WEST GWILLIMBURY.

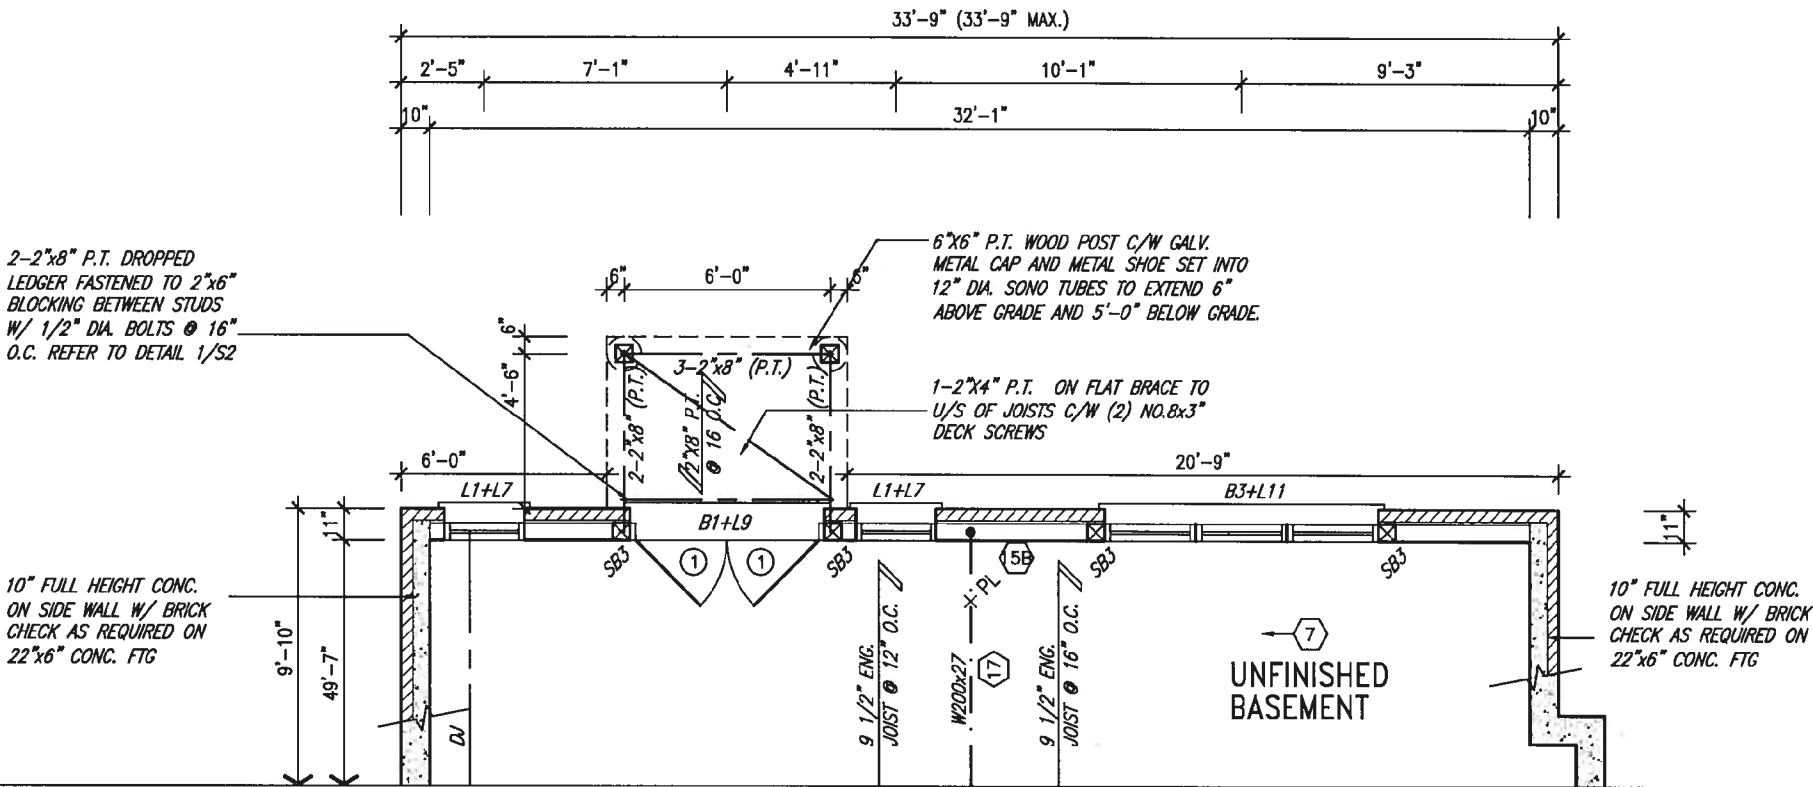
ARCHITECTURAL REVIEW & APPROVAL

JAN 31 2018

John G. Williams Limited, Architect



PARTIAL GROUND FLOOR PLAN ELEVATION 'C' REAR UPGRADE WOB



PARTIAL BASEMENT PLAN ELEVATION 'C' REAR UPGRADE WOB

NOTE:  
REFER TO STANDARD FLOOR PLANS  
FOR ADDITIONAL INFORMATION.

NOTE:  
SPACE ALL FLOOR JOISTS @ 12"  
O.C. UNDER ALL CERAMIC TILE  
AREAS.

NOTE:  
ALL LVL'S SUPPORTING FLOOR LOADS ARE TO BE  
SPECIFIED BY THE FLOOR TRUSS MANUFACTURER.

NOTE:  
FLOOR FRAMING INFO REFER TO ENG SHOP  
DRAWINGS FOR ALL TRUSS-JOIST INFORMATION AND  
DETAILS. UNLESS OTHERWISE NOTED.



JAN 26, 2018

9			
8			
7			
6			
5			
4			
3			
2	REVISED AS PER ENG'S COMMENTS	JAN 25-18	RC
1	ISSUED FOR CLIENT REVIEW		
no.	description	date	by

The undersigned has reviewed and takes responsibility for this design and has the qualifications and meets the requirements set out in the Ontario Building Code to be a Designer.	
qualification information	
Wellington Jno-Baptiste	25591
name	
registration information	
VA3 Design Inc.	42658
Contractor must verify all dimensions on the job and report any discrepancy to the Designer before proceeding with the work. All drawings and specifications are instruments of service and the property of the Designer which must be returned at the completion of the work. Drawings are not to be scaled.	



255 Consumers Rd Suite 120  
Toronto ON M2J 1R4  
t 416.630.2255 f 416.630.4782  
va3design.com

BAYVIEW WELLINGTON

S42-15  
RIDEAU 15

project name  
GREEN VALLEY EAST

municipality  
BRADFORD

project no.  
16023

date  
MARCH 2017

ELEVATION 'C' REAR UPG PARTIAL PLANS WOB

drawing no.  
34

drawn by  
SB

checked by

scale  
3/16" = 1'-0"

file name  
16023-S42-15

RE: HARD - H:\ARCHIVE\WORKING\2016\16023.BW\Units\42\16023-S42-15.dwg - Fri - Jan 26 2018 - 11:31 AM



UNINSULATED OPENINGS (PER OBC, SB-12.3.1(7))				
S42-15 ELEV C-REAR UPG W08	ENERGY EFFICIENCY - OBC S912			
ELEVATION	WALL AREA S.F.	OPENING S.F.	PERCENTAGE	
FRONT	694 S.F.	130.389 S.F.	18.79	%
LEFT SIDE	1145 S.F.	108.889 S.F.	9.51	%
RIGHT SIDE	1144 S.F.	91.444 S.F.	7.99	%
REAR	908 S.F.	277.778 S.F.	30.59	%
* OPENINGS OMITTED AS PER SB-12.3.1.9(4) MAX 19.9 S.F. REFER TO ELEVATION FOR LOCATION				
TOTAL SQ. FT.	3891.00 S.F.	608.50 S.F.	15.64	%
TOTAL SQ. M.	361.48 S.M.	56.53 S.M.	15.64	%

It is the builder's complete responsibility to ensure that all plans submitted for approval fully comply with the Architectural Guidelines and all applicable regulations and requirements including zoning provisions and any provisions in the subdivision agreement. The Council shall not be responsible for any errors or omissions in the drawings or specifications or for any working drawings with respect to any zoning or building code or permit matter or that any house can be properly built or located on its lot.

This is to certify that these plans comply with the applicable Architectural Design Guidelines approved by the Town of BRADFORD, WEST GUILDFORD.

G. Williams Limited, Architect

JAN 31 2018

REFER TO FRONT ELEVATION FOR TYPICAL NOTES & INFORMATION

project name  
GREEN VALLEY EAST

project no.  
16023

drawing no.  
35

BAYVIEW WELLINGTON

S42-15  
RIDEAU 15

municipality  
BRADFORD

date  
MARCH 2017

ELEVATION 'C' REAR UPGRADE

drawn by  
SB

checked by

scale  
3/16" = 1'-0"

file name  
16023-S42-15

RICHARD - H:\ARCHIVE\WORKING\2016\16023.BW\Units\42\16023-S42-15.dwg - Fri - Jan 26 2018 - 11:31 AM

VA3  
DESIGN

255 Consumers Rd Suite 120  
Toronto ON M2J 1R4  
t 416.630.2255 f 416.630.4782  
va3design.com

The undersigned has reviewed and takes responsibility for this design and has the qualifications and meets the requirements set out in the Ontario Building Code to be a Designer.

qualification information  
Wellington Jno-Baptiste 25591  
name  
VA3 Design Inc. 42658  
registration information

Contractor must verify all dimensions on the job and report any discrepancy to the Designer before proceeding with the work. All drawings and specifications are instruments of service and the property of the Designer which must be returned at the completion of the work. Drawings are not to be scaled.

no. description

date by

JAN 25-18 RC

1 ISSUED FOR CLIENT REVIEW

2 REVISED AS PER ENG'S COMMENTS

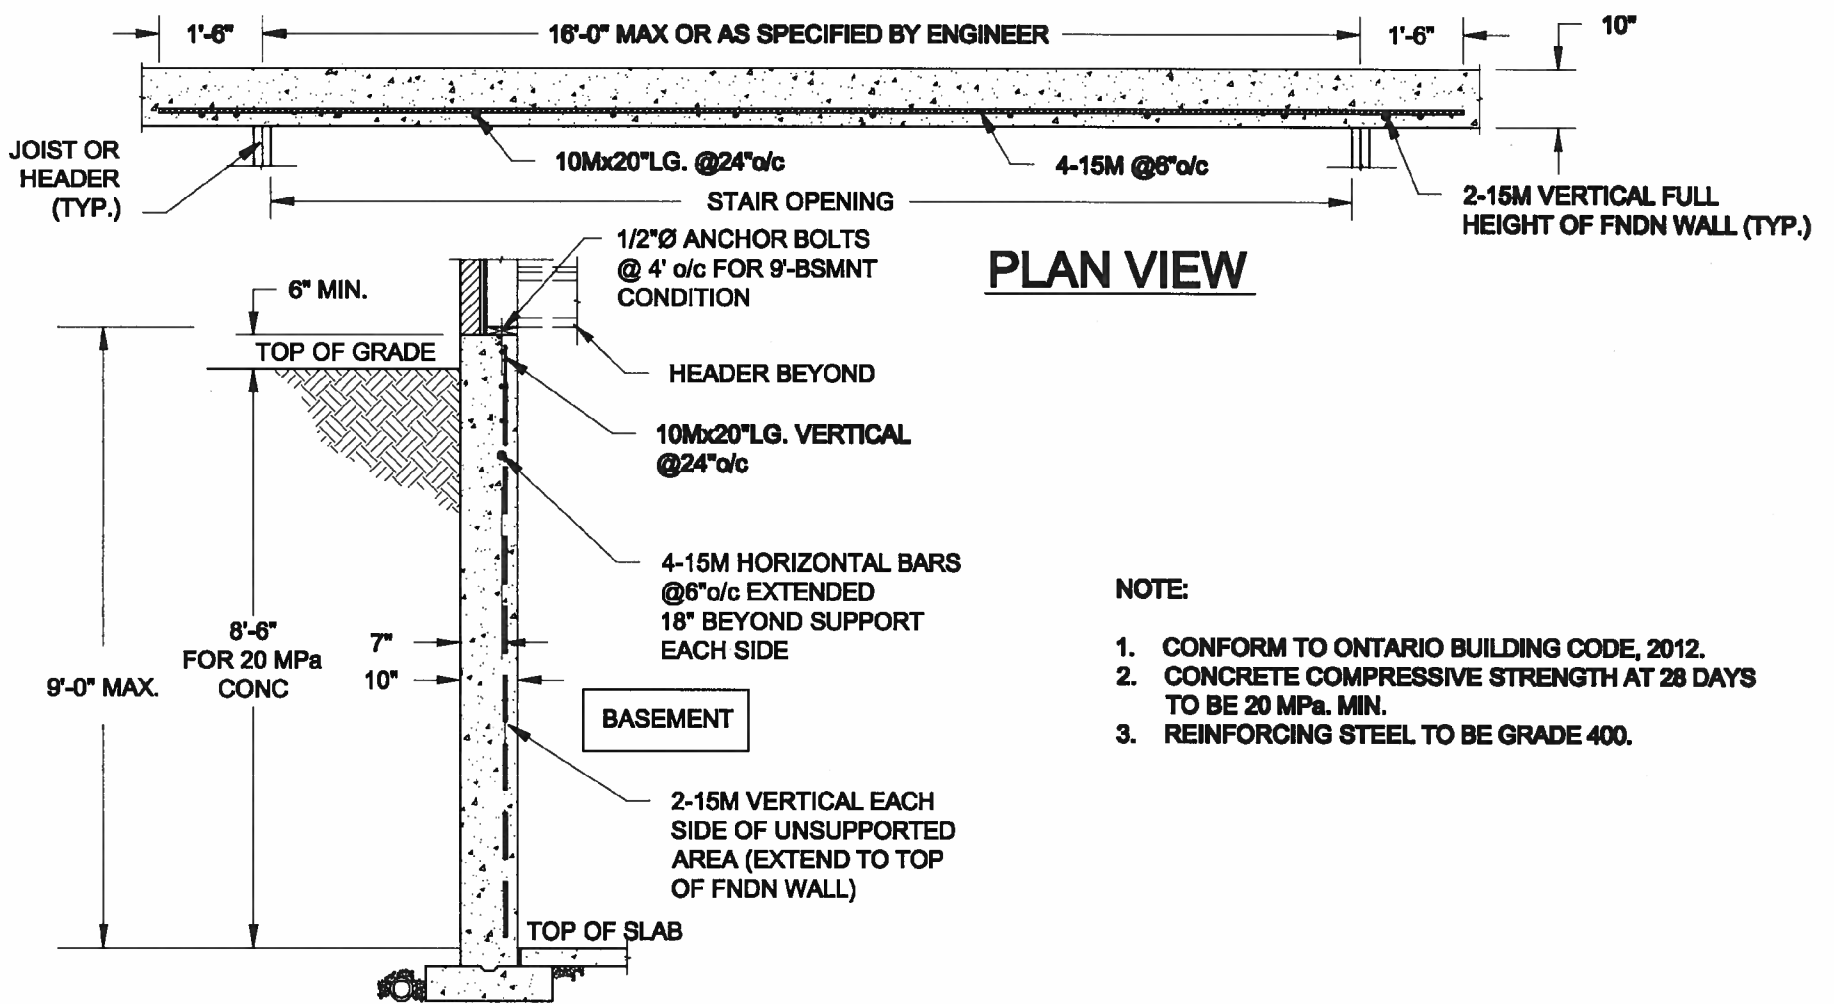
UPGRADED REAR ELEVATION 'C' W/ W.O.D. CONDITION 9R OR MORE

JAN 26, 2018



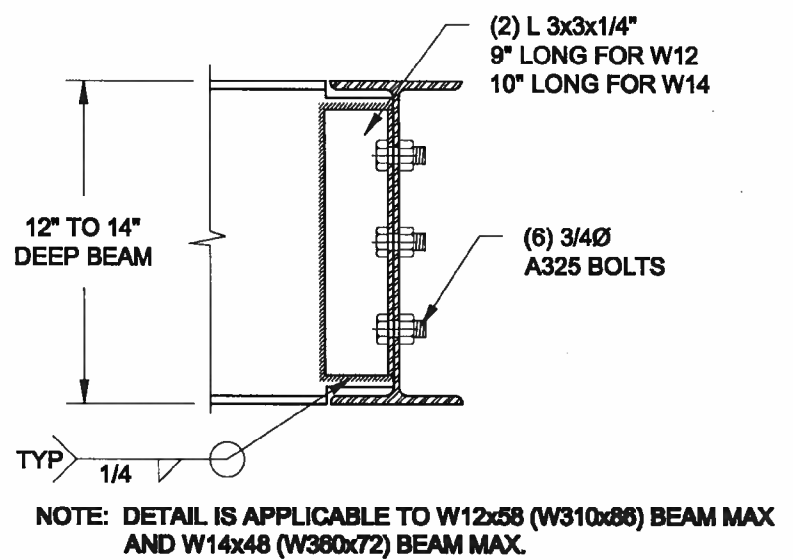
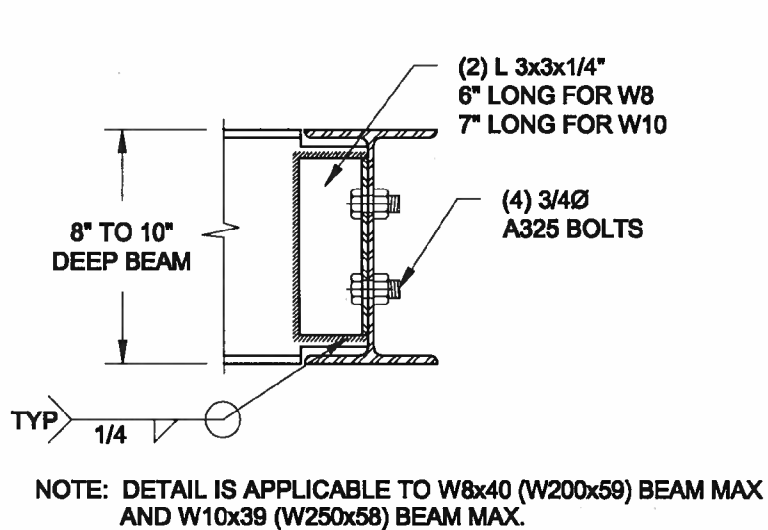
Site Copy






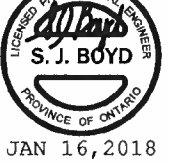
## 1 LATERALLY UNSUPPORTED WALL

SCALE: 3/8" = 1'-0"



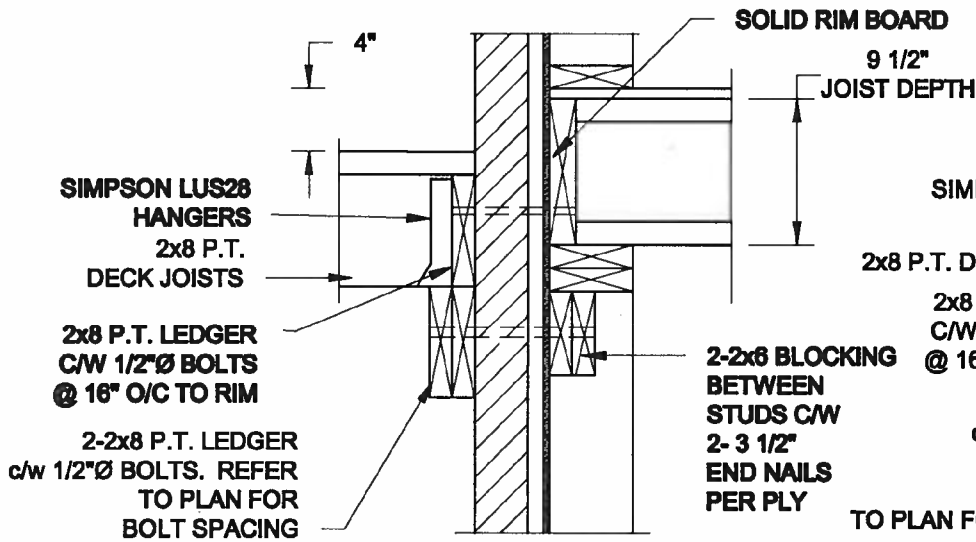
## 2 STEEL BEAM CONNECTION DETAIL

SCALE: 1-1/2" = 1'-0"

<b>Scale:</b> AS NOTED		<b>QUAILE ENGINEERING LTD.</b>    38 Parkside Drive, UNIT 7 Newmarket, ON L3Y 8J9 T: 905-853-8547 E: quaile.eng@rogers.com	<b>Engineer's Seal</b>  JAN 16, 2018		<b>Project:</b>  BAYVIEW WELLINGTON HOMES - GREEN VALLEY ESTATES - SINGLES BRADFORD, ONTARIO	
<b>Date:</b> OCT-28-2017			<b>TYPICAL STRUCTURAL DETAILS</b>			
<b>Drawn:</b> SC	<b>Checked:</b> SJB		<b>Project No.:</b> 17-215		<b>Drawing No.:</b> S1	

Site Copy

FOR 9 1/2" JOIST DEPTH



1A  
S2

## DECK FASTENING DETAIL

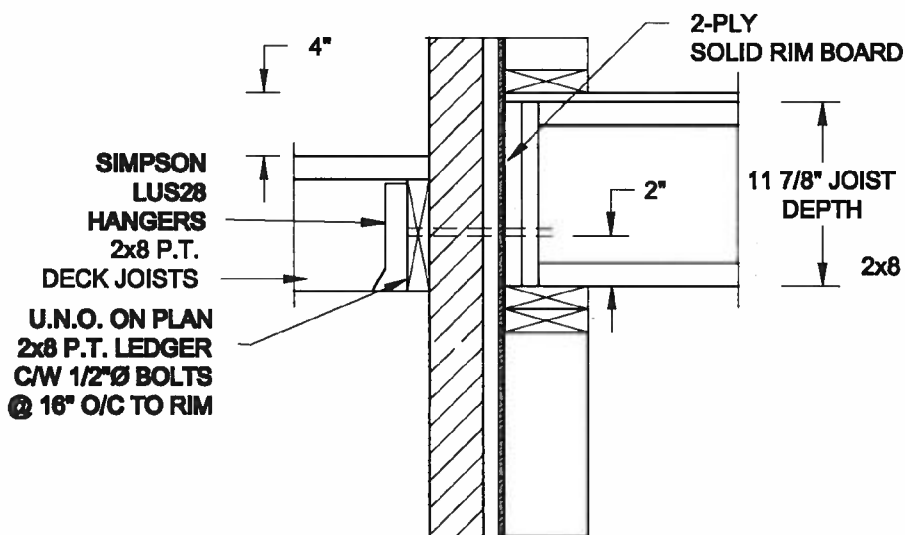
SCALE: 1" = 1'-0"

1B  
S2

## DECK FASTENING DETAIL

SCALE: 1" = 1'-0"

FOR 11 7/8" JOIST DEPTH



1C  
S2

## DECK FASTENING DETAIL

SCALE: 1" = 1'-0"

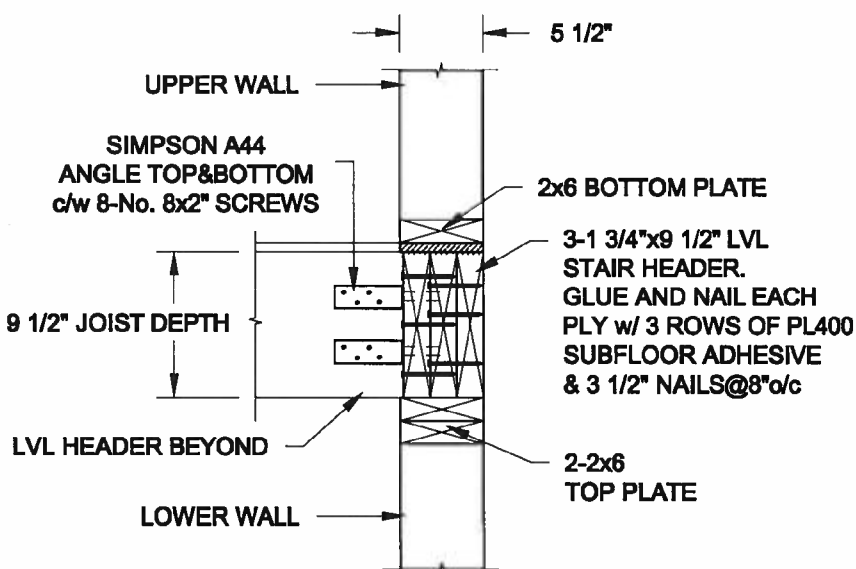
1D  
S2

## DECK FASTENING DETAIL

SCALE: 1" = 1'-0"

- NOTE: 1. WHERE BACKFILL HEIGHT < 4'-7", PROVIDE 2x8 @ 16" o/c KNEEWALL ON 10" THICK CONC FNDN WALL  
2. WHERE BACKFILL HEIGHT > 4'-7", PROVIDE 6" CONC SHELF FOR BRICK VENEER ON 10" THICK CONC FNDN WALL  
3. FOOTING TO BE 22"x6" THICK UNLESS NOTED OTHERWISE ON PLAN.

FOR 9 1/2" JOIST DEPTH

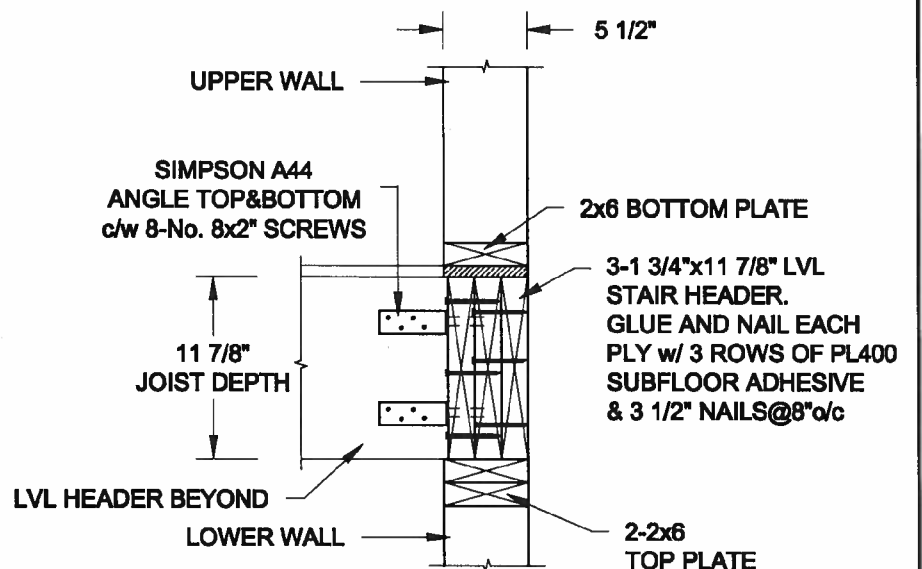


2A  
S2

## STAIR HEADER

SCALE: 1" = 1'-0"

FOR 11 7/8" JOIST DEPTH



2B  
S2

## STAIR HEADER

SCALE: 1" = 1'-0"

Scale:

AS NOTED

Date:

OCT-29-2017

Drawn:

SC

Checked:

SJB

QUAILE ENGINEERING LTD.



38 Parkside Drive, UNIT 7  
Newmarket, ON  
L3Y 8J9  
T: 905-853-8547  
E: quaile.eng@rogers.com

Engineer's Seal



Project:

BAYVIEW WELLINGTON HOMES - GREEN VALLEY ESTATES - SINGLES  
BRADFORD, ONTARIO

TYPICAL STRUCTURAL DETAILS

Project No.:

17-215

Drawing No.:

S2

Site Copy



## CONSTRUCTION NOTES (Unless otherwise noted)

ALL CONSTRUCTION TO ADHERE TO THESE PLANS AND SPEC'S AND TO CONFORM TO THE ONTARIO BUILDING CODE AND ALL OTHER APPLICABLE CODES AND AUTHORITIES HAVING JURISDICTION. THESE REQUIREMENTS ARE TO BE TAKEN AS MINIMUM SPECIFICATIONS. **ONT. REG. 332/12-2012 OBC**

### 1. ROOF CONSTRUCTION

NO.210 (10.25kg/m2) ASPHALT SHINGLES, 10mm (3/8") PLYWOOD SHEATHING WITH "H" CLIPS, APPROVED WOOD TRUSSES @ 600mm (24") O.C. MAX. APPROVED EAVES PROTECTION TO EXTEND 900mm (3'-0") FROM EDGE OF ROOF AND MIN. 300mm (12") BEYOND INNER FACE OF EXTERIOR WALL. (EAVES PROTECTION NOT REQ'D FOR ROOF SLOPES 8:12 OR GREATER) 38x89 (2"x4") TRUSS BRACING @ 1830mm (6'-0") O.C. AT BOTTOM CHORD. PREFIN. ALUM. EAVESTROUGH, FASCIA, RWL & VENTED SOFFIT. PROVIDE ICE & WATER SHIELD TO ALL ROOF/WALL SURFACES SUSCEPTIBLE TO ICE DAMMING. ROOF SHEATHING TO BE FASTENED 150 (6") C/C ALONG EDGES & INTERMEDIATE SUPPORTS WHEN TRUSSES SPACED GREATER THAN 406 (16"). ATTIC VENTILATION 1:300 OF INSULATED CEILING AREA WITH MIN. 25% AT EAVES & MIN. 25% AT RIDGE (OBC 9.19.1.2.).

**2. FRAME WALL CONSTRUCTION (2"x6") (SB-12-TABLE 3.1.1.2A)**  
SIDING AS PER ELEV., 19x38 (1"x2") VERTICAL WOOD FURRING, CONTIN. SHEATHING MEMBRANE, 9.5mm (3/8") EXT. TYPE SHEATHING, 38x140 (2"x6") STUDS @ 400mm (16") O.C., RSI 3.87 (R22) INSULATION AND APPR. VAPOUR BARRIER AND APPR. CONTIN. AIR BARRIER, 13mm (1/2") INT. DRYWALL FINISH. SIDING TO BE MIN. 200mm (8") ABOVE FINISH GRADE. REFER TO OBC SB-12, CHAPTER 3 FOR ADDITIONAL THERMAL INSULATION REQUIREMENTS.

2A. RESERVED

**2B. FRAME WALL CONSTRUCTION (2"x4")- GARAGE WALLS**  
SIDING AS PER ELEV., 19x38 (1"x2") VERTICAL WOOD FURRING, CONTIN. SHEATHING MEMBRANE, 9.5mm (3/8") EXT. TYPE SHEATHING, 38x89 (2"x4") STUDS @ 400mm (16") O.C. (MAX. HEIGHT 3000mm (9'-10"), WITH APPR. DIAGONAL WALL BRACING. SIDING TO BE MIN. 200mm (8") ABOVE FINISH GRADE.

2C. RESERVED

**2D. STUCCO WALL CONSTRUCTION (2"x4")-GARAGE WALLS**  
STUCCO CLADDING SYSTEM CONFORMING TO O.B.C. 9.27.1.1.(2) & 9.28 THAT EMPLOY A MINIMUM 10mm AIR SPACE BEHIND THE CLADDING WITH POSITIVE DRAINAGE TO THE EXTERIOR AND APPLIED PER MANUFACTURERS SPECIFICATIONS OVER 25mm (1") MIN. EXPANDED OR EXTRUDED RIGID POLYSTYRENE ON APPROVED AIR/MOISTURE BARRIER ON 13mm (1/2") EXT. TYPE SHEATHING ON 38x89 (2"x4") STUDS @ 400 (16") O.C.. STUCCO TO BE MIN. 200 (8") ABOVE FINISH GRADE.

**2E. WALLS ADJACENT TO ATTIC SPACE - NO CLADDING**  
9.5mm (3/8") EXT. TYPE SHEATHING, 38x140 (2"x6") STUDS @ 400mm (16") O.C., RSI 3.87 (R22) INSULATION AND APPR. VAPOUR BARRIER AND APPR. CONTIN. AIR BARRIER, 13mm (1/2") INTERIOR DRYWALL FINISH. MID-HEIGHT BLOCKING REQ'D. IF NO SHEATHING APPLIED. REFER TO OBC SB-12, CHAPTER 3 FOR ADDITIONAL THERMAL INSULATION REQUIREMENTS.

**3. BRICK VENEER CONSTRUCTION (2"x6") (SB-12-TABLE 3.1.1.2A)**  
90mm (4") FACE BRICK, 25mm (1") AIR SPACE, 22x180x76mm (7/8"x2"x0.03") GALV. METAL TIES @ 400mm (16") O.C. HORIZONTAL 600mm (24") O.C. VERTICAL. APPROVED SHEATHING PAPER, 9.5mm (3/8") EXT. TYPE SHEATHING, 38x140 (2"x6") STUDS @ 400mm (16") O.C., RSI 3.87 (R22) INSULATION & APPR. VAPOUR BARRIER WITH APPR. CONTIN. AIR BARRIER, 13mm (1/2") INTERIOR DRYWALL FINISH. PROVIDE WEEP HOLES @ 800mm (32") O.C. BOTTOM COURSE AND OVER OPENINGS. PROVIDE BASE FLASHING UP MIN. 150mm (6") BEHIND BUILDING PAPER. REFER TO OBC SB-12, CHAPTER 3 FOR ADDITIONAL THERMAL INSULATION REQUIREMENTS. BRICK TO BE MIN. 150mm (6") ABOVE FINISH GRADE.

3A. RESERVED

**3B. BRICK VENEER CONSTRUCTION (2"x4")- GARAGE WALLS**  
90mm (4") FACE BRICK, 25mm (1") AIR SPACE, 22x180x76mm (7/8"x2"x0.03") GALV. METAL TIES @ 400mm (16") O.C. HORIZONTAL 600mm (24") O.C. VERTICAL. APPR. SHEATHING PAPER, 9.5mm (3/8") EXT. TYPE SHEATHING, 38x89 (2"x4") STUDS @ 400mm (16") O.C. (MAX. HEIGHT 3000mm 9'-10") WITH APPR. DIAGONAL WALL BRACING. PROVIDE WEEP HOLES @ 800mm (32") O.C. BOTTOM COURSE AND OVER OPENINGS. PROVIDE BASE FLASHING UP MIN. 150mm (6") BEHIND BUILDING PAPER. BRICK TO BE MIN. 150mm (6") ABOVE FINISH GRADE.

**3C. STUCCO WALL CONSTRUCTION (2"x6") (SB-12-TABLE 3.1.1.2A)**  
STUCCO CLADDING SYSTEM CONFORMING TO O.B.C. 9.27.1.1.(2) & 9.28 THAT EMPLOYS A MINIMUM 10mm AIR SPACE BEHIND THE CLADDING WITH POSITIVE DRAINAGE TO THE EXTERIOR AND APPLIED PER MANUFACTURERS SPECIFICATIONS OVER 25mm (1") MIN. EXTRUDED OR EXPANDED RIGID POLYSTYRENE ON APPR. CONTIN. AIR/MOISTURE BARRIER ON 13mm (1/2") EXT. TYPE SHEATHING ON 38x140 (2"x6") STUDS @ 400mm (16") O.C., RSI 3.87(R22) INSULATION, APPROVED VAPOUR BARRIER, 13mm (1/2") GYPSUM WALLBOARD INTERIOR FINISH. REFER TO OBC SB-12, CHAPTER 3 FOR ADDITIONAL THERMAL INSULATION REQUIREMENTS. STUCCO TO BE MIN. 200 (8") ABOVE FINISH GRADE.

**4. INTERIOR STUD PARTITIONS**  
FOR BEARING PARTITIONS 38x89 (2"x4") @ 400mm (16") O.C. FOR 2 STOREYS AND 300mm (12") O.C. FOR 3 STOREYS. NON-BEARING PARTITIONS 38x89 (2"x4") @ 600mm (24") O.C. PROVIDE 38x89 (2"x4") BOTTOM PLATE AND 2/38x89 (2"x4") TOP PLATE. 13mm (1/2") INT. DRYWALL BOTH SIDES OF STUDS, PROVIDE 38x140 (2"x6") STUDS/PLATES WHERE NOTED.

**5. FOUNDATION WALL/FOOTINGS: (9.15.3, 9.15.4, 9.13.2, 9.14.2.1.(2))**  
250mm (10") POURED CONC. FDN. WALL 30MPa (4350psi) WITH BITUMINOUS DAMPPROOFING AND DRAINAGE LAYER. DRAINAGE LAYER REQ'D. WHEN BASEMENT INSUL. EXTENDS 900 (2'-11") BELOW FIN. GRADE. DRAINAGE LAYER IS NOT REQ'D. WHEN FDN. WALL IS WATERPROOFED. MAXIMUM POUR HEIGHT 2820 (9'-3") ON 560x155 (22"x6") CONTINUOUS KEYED CONC. FIG. BRACE FDN. WALL PRIOR TO BACKFILLING. ALL FOOTINGS SHALL REST ON NATURAL UNDISTURBED SOIL OR COMPACTED ENGINEERED FILL WITH MIN. BEARING CAPACITY OF 150KPa OR GREATER. IF SOIL BEARING DOES NOT MEET MINIMUM CAPACITY, ENGINEERED FOOTINGS ARE REQUIRED.

STOREYS SUPPORTED	W/ MASONRY VENEER	W/ SIDING ONLY
1	18" wide x 6" DEEP	18" wide x 6" DEEP
2	22" wide x 6" DEEP	22" wide x 6" DEEP
3	28" wide x 9" DEEP	22" wide x 6" DEEP

-SEE OBC 9.15.3.

-MAXIMUM FLOOR LIVE LOAD OF 2.4KPa. (50psf.) PER FLOOR. AND MAX. LENGTH OF SUPPORTED FLOOR JOISTS IS 4.9m (16'-1").

-REFER TO SOILS REPORT FOR SOIL CONDITIONS AND BEARING CAPACITY.

**STRIP FOOTING SUPPORTING EXTERIOR WALLS (FOR W.O.B.)**  
-ASSUMING MASONRY VENEER CONSTRUCTION, MAX. FLOOR LIVE LOAD OF 2.4KPa. (50psf.) PER FLOOR. AND MAX. LENGTH OF SUPPORTED FLOOR JOISTS IS 4.9m (16'-1"). THE STRIP FOOTING SIZE IS AS FOLLOWS:

2 STOREY WITH WALK-OUT BASEMENT 545x175 (22"x27")

**6. FOUNDATION DRAINAGE OBC 9.14.2 & 9.14.3**  
100mm (4") DIA. FOUNDATION DRAINAGE TILE 150mm (6") CRUSHED STONE OVER AND AROUND DRAINAGE TILES.

**7. BASEMENT SLAB OBC 9.1.1.6.(1)(b), 9.16.4.5.(1), 9.25.3.3.(15)**  
80mm (3") MIN. 25MPa (3600psi) CONC. SLAB ON 100mm (4") COARSE GRANULAR FILL, OR 20MPa. (3000psi) CONC. WITH DAMPPROOFING BELOW SLAB. UNDER SLAB INSULATION PER SB-12. ALL SLAB JOINTS & PENETRATIONS TO BE CAULKED.

**8. EXPOSED FLOOR TO EXTERIOR (SB-12-TABLE 3.1.1.2A)**  
PROVIDE RSI 5.46 (R31) INSULATION, APPROVED VAPOUR BARRIER AND CONTINUOUS AIR BARRIER. FINISHED SOFFIT.

**9. ATTIC INSULATION (SB-12-TABLE 3.1.1.2A) (SB-12-3.1.1.8)**  
RSI 10.56 (R60) BLOWN IN ROOF INSULATION AND APPROVED VAPOUR BARRIER, 16mm (5/8") INT. DRYWALL FINISH OR APPROVED EQUAL. RSI 3.32 (R20) MIN. ABOVE INNER SURFACE OF EXTERIOR WALL

**10. ALL STAIRS/EXTERIOR STAIRS -OBC 9.8.-**  
UNIFORM RISE -5mm (1/4") MAX BETWEEN ADJACENT TREADS OR LANDINGS  
-10mm (1/2") MAX BETWEEN TALLEST & SHORTEST RISE IN FLIGHT

MAX. RISE = 200 (7'-7/8")  
MIN. RUN = 210 (8'-1/4")  
MIN. TREAD = 235 (9'-1/4")  
MAX. NOSING = 25 (1")  
MIN. HEADROOM = 1950 (6'-5")  
RAIL @ LANDING = 900 (2'-11")  
RAIL @ STAIR = 865 (2'-10") TO 965 (3'-2")  
MIN. STAIR WIDTH = 860 (2'-10")

**FOR CURVED STAIRS**  
MIN. RUN = 150 (6")  
MIN. AVG. RUN = 200 (8")

**HANDRAILS -OBC 9.8.7.-**

FINISHED RAILING ON PICKETS SPACED MAXIMUM 100mm (4") BETWEEN PICKETS. CLEARANCE BETWEEN HANDRAIL AND SURFACE BEHIND IT TO BE 50 (2") MIN. HANDRAILS TO BE CONTINUOUS EXCEPT FOR NEWEL POST AT CHANGES OF DIRECTION.

**INTERIOR GUARDS -OBC 9.8.8.-**  
INTERIOR GUARDS: 900mm (2'-11") MIN. HIGH  
**EXTERIOR GUARDS - OBC 9.8.8.**  
900mm (36") HIGH GUARD WHERE DISTANCE FROM PORCH TO FIN. GRADE IS LESS THAN 1800mm (7'1"). 1070mm (42") HIGH GUARD IS REQUIRED WHERE DISTANCE EXCEEDS 1800mm (7'1").

**SILL PLATE - OBC 9.23.7.**  
38x89 (2"x4") SILL PLATE WITH 13mm (1/2") DIA. ANCHOR BOLTS 200mm (8") LONG, EMBEDDED MIN. 100mm (4") INTO CONC. @ 2400mm (7'-10") O.C., CAULKING OR 25 (1") MIN. MINERAL WOOL BETWEEN PLATE AND TOP OF FDN. WALL.

USE NON-SHRINK GROUT TO LEVEL SILL PLATE WHEN REQUIRED.  
**BASEMENT INSULATION (SB-12-3.1.1.7), 9.25.2.3, 9.13.2.6)**  
FOUNDATION WALLS ENCLOSING HEATED SPACE SHALL BE INSULATED FROM THE UNDERSIDE OF THE SUBFLOOR TO NOT MORE THAN 200mm (8") ABOVE THE FINISHED FLOOR & NO CLOSER THAN 50mm (2") OF THE BASEMENT SLAB. RSI3.52ci (R20ci) BLANKET INSULATION TO HAVE APPROVED VAPOUR BARRIER. RECOMMEND DAMPPROOF WITH BUILDING PAPER BETWEEN THE FOUNDATION WALL AND INSULATION UP TO GRADE LEVEL. NOTE: FULL HEIGHT INSULATION AT COLD CELLAR WALLS. AIR BARRIER TO BE SEALED TO FOUNDATION WALL WITH CAULKING. CONTINUOUS INSULATION (ci) IS NOT TO BE INTERRUPTED BY FRAMING.

**BEARING STUD PARTITION**  
38x89 (2"x4") STUDS @ 400mm (16") O.C. 38x89 (2"x4") SILL PLATE ON DAMPPROOFING MATERIAL, 13mm (1/2") DIA. ANCHOR BOLTS 200mm (8") LONG, EMBEDDED MIN. 100mm (4") INTO CONC. @ 2400mm (7'-10") O.C. 100mm (4") HIGH CONC. CURB ON 350x155 (14"x6") CONC. FOOTING. ADD HORIZ. BLOCKING AT MID-HEIGHT IF WALL IS UNFINISHED.

**14. STEEL BASEMENT COLUMN (SEE O.B.C. 9.15.3.3)**  
89mm (3-1/2") DIA x 3.0mm (0.118) SINGLE WALL TUBE TYPE 2 ADJUSTABLE STL. COL. W/ MIN. CAPACITY OF 71.2kN (16,000lbs.) AT A MAX. EXTENSION OF 2318mm (7'-7 1/2") CONFORMING TO CAN/CGSB-7-2.94. AND WITH 150x150x9.5 (6"x6"x3/8") STL. PLATE TOP & BOTTOM. 870x870x410 (34"x34"x16") CONC. FOOTING ON UNDISTURBED SOIL OR ENGINEERED FILL CAPABLE OF SUSTAINING A PRESSURE OF 150 Kpa. MINIMUM AND AS PER SOILS REPORT.

**15. STEEL BASEMENT COLUMN (SEE O.B.C. 9.15.3.3)**  
89mm (3-1/2") DIA x 4.78mm (188) FIXED STL. COL. WITH 150x150x9.5 (6"x6"x3/8") STL. TOP & BOTTOM PLATE ON 1070x1070x460 (42"x42"x18") CONC. FOOTING ON UNDISTURBED SOIL OR ENGINEERED FILL CAPABLE OF SUSTAINING A PRESSURE OF 150 Kpa. MIN. AND AS PER SOILS REPORT.

**15A. STEEL BASEMENT COLUMN (SEE O.B.C. 9.15.3.3)**  
89mm (3-1/2") DIA x 4.78mm (188) FIXED STL. COL. WITH 150x150x9.5 (6"x6"x3/8") STL. TOP & BOTTOM PLATE ON 1070x1070x460 (42"x42"x18") CONC. FOOTING ON UNDISTURBED SOIL OR ENGINEERED FILL CAPABLE OF SUSTAINING A PRESSURE OF 150 Kpa. MIN. AND AS PER SOILS REPORT.

**15B. STEEL COLUMN**  
90mm (3-1/2") DIA x 4.78mm (188) NON-ADJUSTABLE STL. COL. TO BE ON 150x150x9.5 (6"x6"x3/8") STEEL TOP PLATE, & BOTTOM PLATE. BASE PLATE 120x250x12.5 (4 1/2"x10"x1/2") WITH 2-12mm DIA. x 300mm LONG x50mm HOOK ANCHORS (2-1/2"x12"x2") FIELD WELD COL. TO BASE PLATE.

**16. BEAM POCKET OR 300x150 (12"x6") POURED CONC. NIB WALLS. MIN. BEARING 90mm (3'-1/2")**

**17. 19x64 (1"x3") CONTINUOUS WOOD STRAPPING BOTH SIDES OF STEEL BEAM.**

**18. GARAGE SLAB**  
100mm (4") 32MPa (4640psi) CONC. SLAB WITH 5-8% AIR ENTRAINMENT ON OPT. 100 (4") COARSE GRANULAR FILL WITH COMPACTED SUB-BASE OR COMPACTED NATIVE FILL. SLOPE TO FRONT.

**19. GARAGE CEILINGS/INTERIOR WALLS**  
13mm (1/2") GYPSUM BOARD ON WALL AND CEILING BETWEEN HOUSE AND GARAGE. TAPE AND SEAL ALL JOINTS AIRTIGHT PER O.B.C. 9.10.9.1.6. WALLS (R22), CEILINGS (R31). REFER TO SB-12, TABLE 3.1.1.2.A. FOR REQUIRED THERMAL INSULATION.

DOOR AND FRAME GASPROOFED. DOOR EQUIPPED WITH SELF CLOSING DEVICE AND WEATHERSTRIPPING PER OBC 9.10.13.15.

**20. EXTERIOR STEP**  
PRECAST CONCRETE STEP OR WOOD STEP WHERE NOT EXPOSED TO WEATHER. MAX. RISE 200mm (7'-7/8") MIN. TREAD 250mm (9'-1/2"). SEE OBC. 9.8.9.2., 9.8.9.3. & 9.8.10.

**21. DRYER EXHAUST (OBC-6.2.3.8.(7) & 6.2.4.11)**  
CAPPED DRYER EXHAUST VENTED TO EXTERIOR.

(USE 100mm (4") DIA. SMOOTH WALL VENT PIPE)

**22. INSULATED ATTIC ACCESS (OBC-9.19.2.1. & SB12-3.1.1.8)**  
ATTIC ACCESS HATCH WITH MIN. DIMENSION OF 545x610mm (21 1/2"x24") & A MIN. AREA OF 0.32 SQ.M. (3.44 SQ.Ft.) WITH WEATHERSTRIPPING. RSI 3.52 (R20) RIGID INSUL. BACKING.

**23. FIREPLACE CHIMNEYS OBC 9.21.**

HIGH OF FIREPLACE CHIMNEY SHALL BE 915mm (3'-0") ABOVE THE HIGHEST POINT AT WHICH IT COMES IN CONTACT WITH THE ROOF AND 610mm (2'-0") ABOVE THE ROOF SURFACE WITHIN A HORIZ. DISTANCE OF 3050mm (10'-0") FROM THE CHIMNEY.

**24. LINEN CLOSET, 4 SHELVES MIN. 350mm (14") DEEP.**

**25. MECHANICAL EXHAUST FAN, VENTED TO EXTERIOR AS REQUIRED BY OBC. 9.32.3.5. & 9.32.3.10.**

**26. STEEL BEARING PLATE FOR MASONRY WALLS**  
280x280x16 (11"x11"x5/8") STL. PLATE FOR STL BEAMS AND 280x280x12 (11"x11"x1/2") STL. PLATE FOR WOOD BEAMS BEARING ON CONC. BLOCK PARTYWALL. ANCHORED WITH 2-19mm (3/4") x 200mm (8") LONG GALV. ANCHORS WITHIN SOLID BLOCK COURSE. LEVEL WITH NON-SHRINK GROUT.

**SOLID WOOD BEARING FOR WOOD STUD WALLS**  
SOLID BEARING TO BE AT LEAST AS WIDE AS THE SUPPORTED MEMBER. SOLID WOOD BEARING COMPRISED OF BUILT-UP WOOD STUDS TO BE CONSTRUCTED IN ACCORDANCE WITH OBC 9.17.4.2.(2).

28. RESERVED

**29. BEARING WOOD POST (BASEMENT) (OBC 9.17.4.)**  
3-38x140 (3-2"x6") BUILT-UP-POST ON METAL BASE SHOE ANCHORED TO CONC. WITH 12.7 DIA. BOLT. 610x610x300 (24"x24"x12") CONC. FOOTING.

**30. STEPPED FOOTINGS OBC 9.15.3.9.**  
MIN. HORIZ. STEP = 600mm (24").  
MAX. VERT. STEP = 600mm (24")

**31. SLAB ON GRADE**  
MIN. 100mm (4") CONCRETE SLAB ON GRADE ON 100mm (4") COARSE GRANULAR FILL. REINFORCED WITH 6x6-W2.9xW2.9 MESH PLACED NEAR MID-DEPTH OF SLAB. CONC. STRENGTH 32 MPa (4640 psi) WITH 5-8% AIR ENTRAINMENT ON COMPACTED SUB-GRADE. WHERE REQUIRED, REFER TO OBC SB-12, TABLE 3.1.1.2.A. FOR REQUIRED MINIMUM INSULATION UNDER SLAB.

**32. DIRECT VENTING GAS FURNACE/ H.W.T VENT**  
DIRECT VENT FURNACE TERMINAL MIN. 900mm (36") FROM A GAS REGULATOR. MIN. 300mm (12") ABOVE FIN. GRADE. FROM ALL OPENINGS, EXHAUST AND INTAKE VENTS. HRV INTAKE TO BE A MIN. OF 1830mm (6'-0") FROM ALL EXHAUST TERMINALS. REFER TO GAS UTILIZATION CODE.

**33. DIRECT VENTING GAS FIREPLACE VENT**  
DIRECT VENT GAS FIREPLACE. VENT TO BE A MINIMUM 300mm (12") FROM ANY OPENING AND ABOVE FIN. GRADE. REFER TO GAS UTILIZATION CODE.

**34. SUBFLOOR JOIST STRAPPING AND BRIDGING**  
16mm (5/8") I & G SUBFLOOR ON WOOD FLOOR JOISTS. FOR CERAMIC TILE APPLICATION (\* SEE OBC 9.30.6. \* ) 5mm (1/4") PANEL TYPE UNDERLAY UNDER RESILIENT & PARQUET FLOORING. (\* SEE OBC 9.30.2. \*)  
FLOOR JOISTS WITH SPANS OVER 2100mm (6'-11") TO BE BRIDGED WITH 38x38 (2"x2") CROSS BRACING OR SOLID BLOCKING @ 2100mm (6'-11") O.C. MAX. AND WHERE SPECIFIED BY JOIST TABLES A-1 OR A-2 STRAPPING SHALL BE 19x64 (1"x3") @ 2100mm (6'-11") O.C. UNLESS A PANEL TYPE CEILING FINISH IS APPLIED. (\* SEE OBC 9.23.9.4. \*)

**35. EXPOSED BUILDING FACE OBC 9.10.15. & SB-2-2.3.5.(2)**  
EXTERIOR WALLS TO HAVE A FIRE RESISTANCE RATING OF NOT LESS THAN 45 min. WHERE LIMITING DISTANCE (LD) IS LESS THAN 1.2M (3'-11"). WHERE THE LD IS LESS THAN 600mm (1'-11") THE EXPOSING FACE SHALL BE CLAD IN NON-COMBUSTIBLE MATERIAL. SEE ELEVATIONS FOR ADDITIONAL NOTES. OFFENDING GARAGE WALLS INCLUDED.

**36. COLD CELLAR PORCH SLAB (OBC 9.39.)**  
FOR MAX. 2500mm (8'-2") PORCH DEPTH (SHORTEST DIM.), 125mm (5") 32MPa (4640psi) CONC. SLAB WITH 5-8% AIR ENTRAINMENT. REINF. WITH 10M BARS @ 200mm (7 7/8") O.C. EACH WAY IN BOTTOM THIRD OF SLAB. MIN. 30mm (1 1/4") COVER. 600x600 (23 5/8"x23 5/8") 10M DOWELS @ 600mm (23 5/8") O.C.. ANCHORED IN PERIMETER FDN. WALLS. SLOPE SLAB MIN. 1.0% FROM HOUSE WALL. SLAB TO HAVE MIN. 75mm (3") BEARING ON FDN. WALLS. PROVIDE (L7) LINTEL OVER CELLAR DOOR WITH 100mm (4") END BEARING.

THE FDN. WALL SHALL NOT BE REDUCED TO LESS THAN 90mm (3-1/2") THICK TO A MAX. DEPTH OF 600mm (24") AND SHALL BE TIED TO THE FACING MATERIAL WITH METAL TIES SPACED 200mm (8") O.C. VERTICALLY AND 900mm (36") O.C. HORIZONTALLY. FILL SPACE BETWEEN WALL AND FACING SOLID WITH MORTAR.

**CONVENTIONAL ROOF FRAMING (2.0Kpa. SNOW LOAD)**  
38x140 (2"x6") RAFTERS @ 400mm (16") O.C. FOR MAX 11'-7" SPAN. 38x184 (2"x8") RIDGE BOARD. 38x89 (2"x4") COLLAR TIES AT MIDSPANS. CEILING JOISTS TO BE 38x89 (2"x4") @ 400mm (16") O.C. FOR MAX. 2830mm (9'-3") SPAN & 38x140 (2"x6") @ 400 (16") O.C. FOR MAX. 4450mm (14'-7") SPAN.  
RAFTERS FOR BUILT-UP ROOF TO BE 38x89 (2"x4") @ 600mm (24") O.C. WITH A 38x89 (2"x4") CENTRE POST TO THE TRUSS BELOW, LATERALLY BRACED @ 1800mm (6'-0") O.C. VERTICALLY.

## GENERAL NOTES

**WINDOWS:1) MINIMUM BEDROOM WINDOW -OBC 9.9.10.1.-**  
AT LEAST ONE BEDROOM WINDOW ON A GIVEN FLOOR IS TO HAVE MIN. 0.35m2 UNOBSTRUCTED GLAZED OR OPENABLE AREA WITH MIN. CLEAR WIDTH OF 380 mm (1'-3").

**2) WINDOW GUARDS -OBC 9.8.8.1.(6).**  
A GUARD IS REQUIRED WHERE THE TOP OF THE WINDOW SILL IS LOCATED LESS THAN 480mm (1'-7") ABOVE FIN. FLOOR AND THE DISTANCE FROM THE FIN. FLOOR TO THE ADJACENT GRADE IS GREATER THAN 180mm (5'-11")

**3) EXTERIOR WINDOWS**  
SHALL COMPLY WITH OBC DIV.-8 9.7.3. & SB12-3.1.1.9

**GENERAL: 1)** MECHANICAL VENTILATION IS REQUIRED TO COMPLY WITH OBC-DIV. 8, 6.2.2. SEE MECHANICAL DRAWINGS.  
**2)** ALL DOWNSPOUTS TO DRAIN AWAY FROM THE BUILDING AS PER OBC 9.26.18.2. & 6.2.2.3.(3) AND MUNICIPAL STANDARDS.  
**3)** ALL WINDOW WELLS TO DRAIN TO FOOTING LEVEL PER OBC 9.14.6.3. CHECK WITH THE LOCAL AUTHORITY.  
**4)** STUD WALL REINFORCEMENT FOR FUTURE GRAB BARS IN MAIN BATHROOM  
REINFORCEMENT OF STUD WALLS SHALL BE INSTALLED ADJACENT TO WATER CLOSETS AND SHOWER OR BATHTUB IN MAIN BATHROOM. REFER TO OBC. 9.5.2.3.3. 3.8.3.8.1.(1)(c) & 3.8.3.13.(1)(f). SEE DETAIL.  
**5)** ALL EXTERIOR DOORS TO COMPLY WITH THERMAL RESISTANCE AS STATED IN O.B.C. SB-12-3.1.1.9.

**6)** ALL AIR BARRIER SYSTEMS ARE REQUIRED TO COMPLY WITH O.B.C. DIV.-8 9.25.3.

**LUMBER: 1)** ALL LUMBER SHALL BE SPRUCE NO.2 GRADE, UNLESS NOTED OTHERWISE.  
**2)** STUDS SHALL BE STUD GRADE SPRUCE, UNLESS NOTED OTHERWISE.  
**3)** LUMBER EXPOSED TO THE EXTERIOR TO BE SPRUCE NO.2 GRADE PRESSURE TREATED OR CEDAR, UNLESS NOTED OTHERWISE.  
**4)** ALL LAMINATED VENEER LUMBER (L.V.L.) BEAMS, GIRDER TRUSSES, AND METAL HANGER CONNECTIONS SUPPORTING ROOF FRAMING TO BE DESIGNED & CERTIFIED BY TRUSS MANUFACTURER.

**5)** LVL BEAMS SHALL BE 2.0E -2950Fb MIN.. NAIL EACH PLY OF LVL WITH 89mm (3 1/2") LONG COMMON WIRE NAILS @ 300mm (12") O.C. STAGGERED IN 2 ROWS FOR 184, 240 & 300mm (7 1/4, 9 1/2, 11 7/8") DEPTHS AND STAGGERED IN 3 ROWS FOR GREATER DEPTHS AND FOR 4 PLY MEMBERS ADD 13mm (1/2") DIA. GALVANIZED BOLTS BOLTED AT MID-DEPTH OF BEAM @ 915mm (3'-0") O.C.

**6)** PROVIDE FACE MOUNT BEAM HANGERS TYPE "SCL" MANUFACTURED BY SIMPSON STRONG-TIE OR EQUAL FOR ALL LVL BEAM TO BEAM CONNECTIONS UNLESS OTHERWISE NOTED. REFER TO ENG. FLOOR LAYOUTS.






















**7)** JOIST HANGERS: PROVIDE METAL HANGERS FOR ALL JOISTS AND BUILT-UP WOOD MEMBERS INTERSECTING FLUSH BUILT-UP WOOD MEMBERS.

**8)** WOOD FRAMING NOT TREATED WITH A WOOD PRESERVATIVE. IN CONTACT WITH CONCRETE, SHALL BE SEPARATED FROM THE CONCRETE BY AT LEAST 2 mil. POLYETHYLENE FILM, No. 30 (45lbs.) ROLL ROOFING OR OTHER DAMPPROOFING MATERIAL. EXCEPT WHERE THE WOOD MEMBER IS AT LEAST 150mm (6") ABOVE THE GROUND.

**STEEL 1)** STRUCTURAL STEEL SHALL CONFORM TO CAN/CSA-G40-21 GRADE 300W. HOLLOW STRUCTURAL SECTIONS SHALL CONFORM TO CSA-G40-21 GRADE 350W STRUCTURAL QUALITY STEEL. OBC. 9.9.23.4.3.

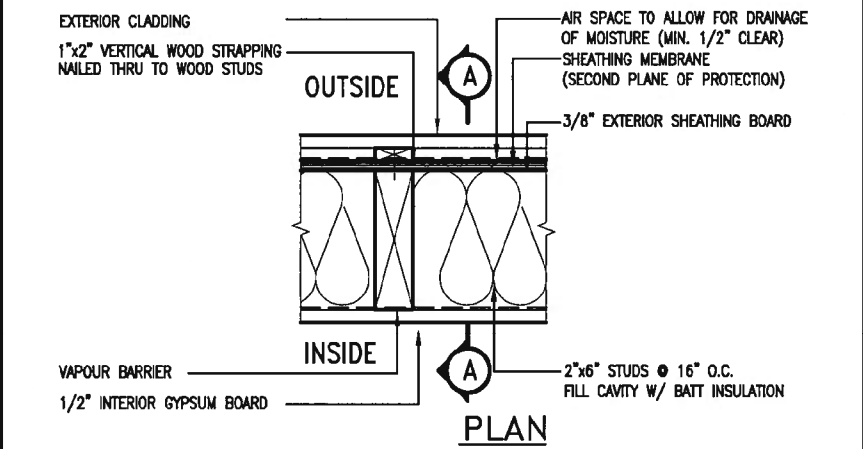
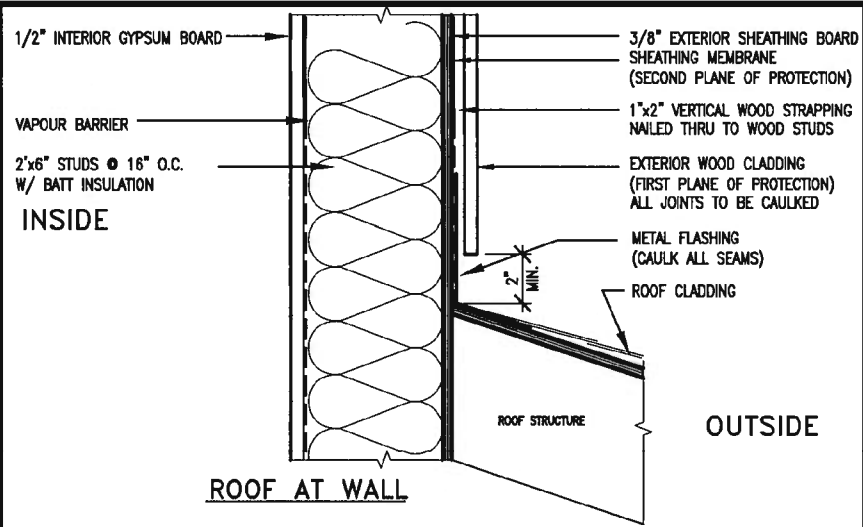
**2)** REINFORCING STEEL SHALL CONFORM TO CSA-G30-18M GRADE 400R.

**STUCCO: 1)** ALL STUCCO WALLS TO HAVE A MINIMUM 10mm AIR SPACE BEHIND THE CLADDING WITH POSITIVE DRAINAGE TO THE EXTERIOR. THE EXTERIOR SHEATHING MUST NOT BE GYPSUM BASED. ALL STUCCO TO BE INSTALLED AS PER MANUFACTURERS SPECIFICATIONS.

LEGEND			
	CLASS 'B' VENT		EXHAUST FAN TO EXTERIOR
	DUPLEX OUTLET (12" ABOVE SURFACE)		DUPLEX OUTLET (HEIGHT A.F.F.)
	WEATHERPROOF DUPLEX OUTLET		GFI DUPLEX OUTLET (HEIGHT A.F.F.)
	POT LIGHT		HEAVY DUTY OUTLET (220 volt)
	LIGHT FIXTURE (PULL CHAIN)		LIGHT FIXTURE (CEILING MOUNTED)
	SWITCH		LIGHT FIXTURE (WALL MOUNTED)
	FLOOR DRAIN		HOSE BIB (NON-FREEZE)
	SJ SINGLE JOIST		P.T. PRESSURE TREATED LUMBER
	DJ DOUBLE JOIST		G.T. GIRDER TRUSS BY ROOF TRUSS MANUF.
	TJ TRIPLE JOIST		
	LVL LAMINATED VENEER LUMBER		
	POINT LOAD FROM ABOVE		

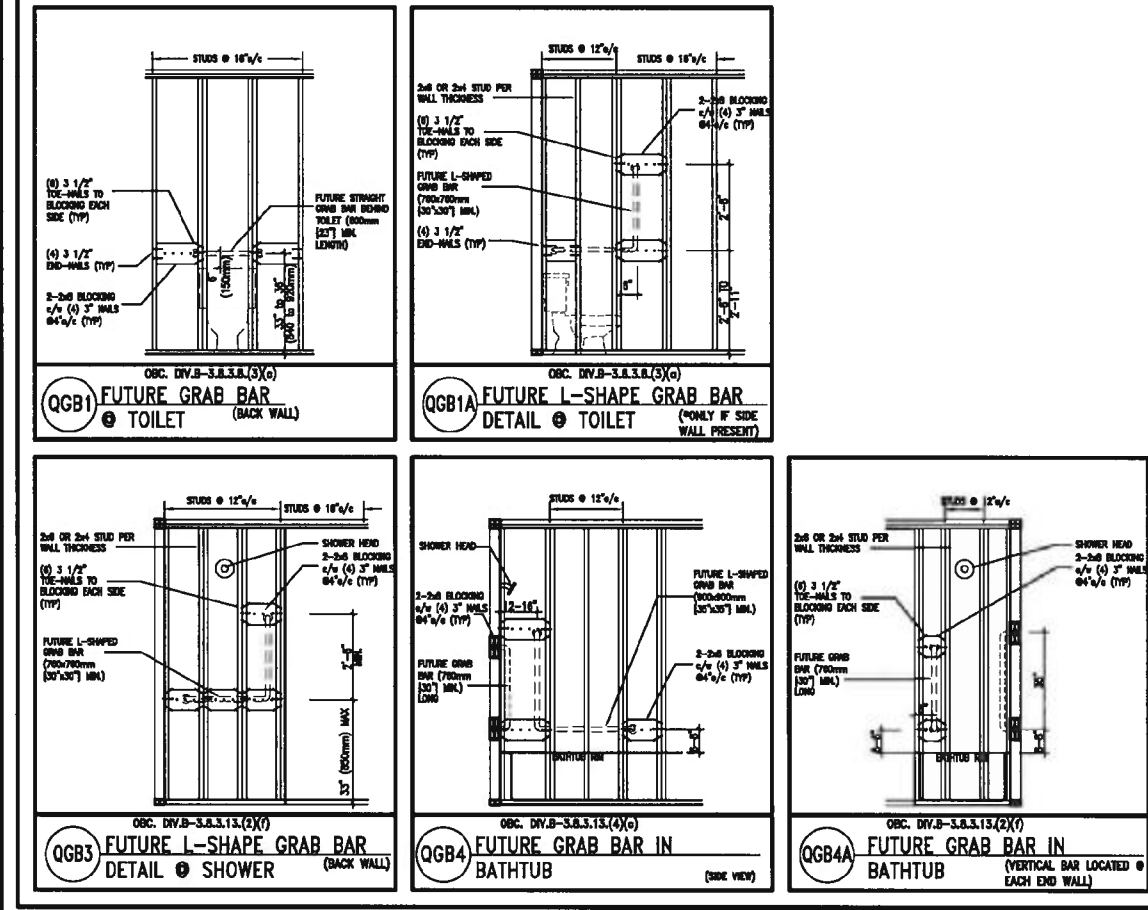
LUMBER	
+ PL	POINT LOAD FROM ABOVE
	FLAT ARCH
	CURVED ARCH
	MEDICINE CABINET (RECESSED)
	DOUBLE VOLUME WALL. SEE NOTE 39
	CONCRETE BLOCK WALL
	SOLID WOOD BEARING (SPRUCE No. 2). SOLID BEARING TO BE AS WIDE AS SUPPORTED MEMBER OR AS DIRECTED BY STRUCTURAL ENGINEER. SOLID BEARING TO BE MINIMUM 2 PIECES.
	SOLID WOOD BEARING TO MATCH FROM ABOVE



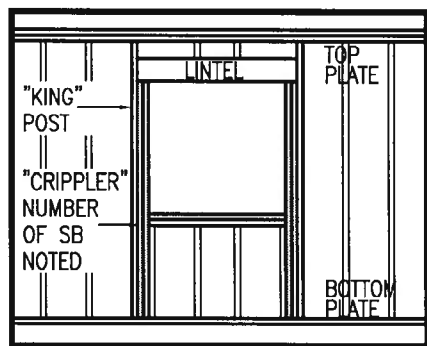


EXTERIOR WOOD CLADDING WALL ASSEMBLY

**STUD WALL REINFORCEMENT FOR FUTURE GRAB BARS IN MAIN BATHROOM**  
REINFORCEMENT OF STUD WALLS SHALL BE INSTALLED ADJACENT TO WATER CLOSETS AND SHOWER OR BATHTUB IN MAIN BATHROOM.  
FUTURE GRAB BARS TO BE MOUNTED TO RESIST HORIZ. AND VERT. LOADS OF 1.3 KN (300 lb)  
REFER TO OBC DIV. B- 9.5.2.3. WATER CLOSET 3.8.3.8.(3)(c) & 3.8.3.8.(3)(c). SHOWER 3.8.3.13.(2)(f). BATHTUB & 3.8.3.13.(4)(c). AND DETAILS PROVIDED.



LICENCED PROFESSIONAL ENGINEER  
S. J. BOYD  
PROVINCE OF ONTARIO  
JAN 11, 2018



"CRIPPLE" DETAIL

MAX. HEIGHT FOR 2"x4" GARAGE WALL IS AS FOLLOW:  
2"x4" @ 16" O.C. - 9'-10"  
2-2"x4" @ 12" O.C. - 10'-9"  
3-2"x4" @ 16" O.C. - 11'-2"  
3-2"x4" @ 12" O.C. - 12'-4"

- NOTES:
- FOR ROOF DESIGN SNOW LOAD OF UP TO 2.5 KPa, SUPPORTED ROOF TRUSS LENGTH OF 6.0m AND FLOOR JOIST LENGTH OF 2.5m OF ONE FLOOR.
  - PROVIDE HORIZONTAL SOLID BLOCKING @ 1200 O.C. (4'-0")
  - PROVIDE A MINIMUM OF 9.5mm (3/8") PLYWOOD OR OSB EXTERIOR SHEATHING ON THE EXTERIOR FACE.
  - FOR A 1/50 YEAR REFERENCE WIND PRESSURE OF 0.6 KPa.
  - STUDS GREATER THAN 9'-10" HIGH TO BE No. 2 SPF
  - STUD SPECIFICATION IS SUITABLE FOR BRICK VENEER OR SIDING.

\*\* MAX. HEIGHT FOR 2"x6" EXTERIOR WALL IS AS FOLLOW:  
2"x6" @ 16" O.C. - 12'-6"  
2"x6" @ 12" O.C. - 13'-10"  
2-2"x6" @ 16" O.C. - 15'-0"  
2-2"x6" @ 12" O.C. - 17'-4"

- MAX. HEIGHT FOR 2"x8" EXTERIOR WALL IS AS FOLLOWS:  
2"x8" @ 16" O.C. - 16'-0"  
2"x8" @ 12" O.C. - 17'-9"  
2-2"x8" @ 16" O.C. - 20'-4"  
2-2"x8" @ 12" O.C. - 22'-4"
- NOTES:
- FOR ROOF DESIGN SNOW LOAD OF UP TO 2.5 KPa
  - SUPPORTED ROOF TRUSS LENGTH OF 6.0m ONLY.
  - PROVIDE HORIZONTAL SOLID BLOCKING @ 1200 O.C. (4'-0")
  - PROVIDE A MINIMUM OF 9.5mm (3/8") PLYWOOD OR OSB EXTERIOR SHEATHING ON THE EXTERIOR FACE AND 12.5mm (1/2") GYPSUM BOARD ON THE INTERIOR FACE.
  - WALL FRAMING SHALL CONFORM TO OBC 9.23.10.1.(2)
  - FOR A 1/50 YEAR REFERENCE WIND PRESSURE OF 0.6 KPa
  - STUDS GREATER THAN 9'-10" HIGH TO BE No. 2 SPF.
  - STUD SPECIFICATION IS SUITABLE FOR BRICK VENEER OR SIDING.

\*\* STUD INFORMATION TAKEN FROM OBC TABLE A-30

9.	.	.
8.	.	.
7.	.	.
6.	.	.
5.	.	.
4.	.	.
3.	.	.
2.	UPDATE TO 2018	JAN 11-18 RC
1.	ISSUE FOR CLIENT REVIEW	AUG 04-17 RC
no.	description	date by

The undersigned has reviewed and takes responsibility for this design and has the qualifications and meets the requirements set out in the Ontario Building Code to be a Designer.	
qualification information	
Wellington Jno-Baptiste	25591
name	BCIN
registration information	
VA3 Design Inc.	42658
Contractor must verify all dimensions on the job and report any discrepancy to the Designer before proceeding with the work. All drawings and specifications are instruments of service and the property of the Designer which must be returned at the completion of the work. Drawings are not to be scaled.	

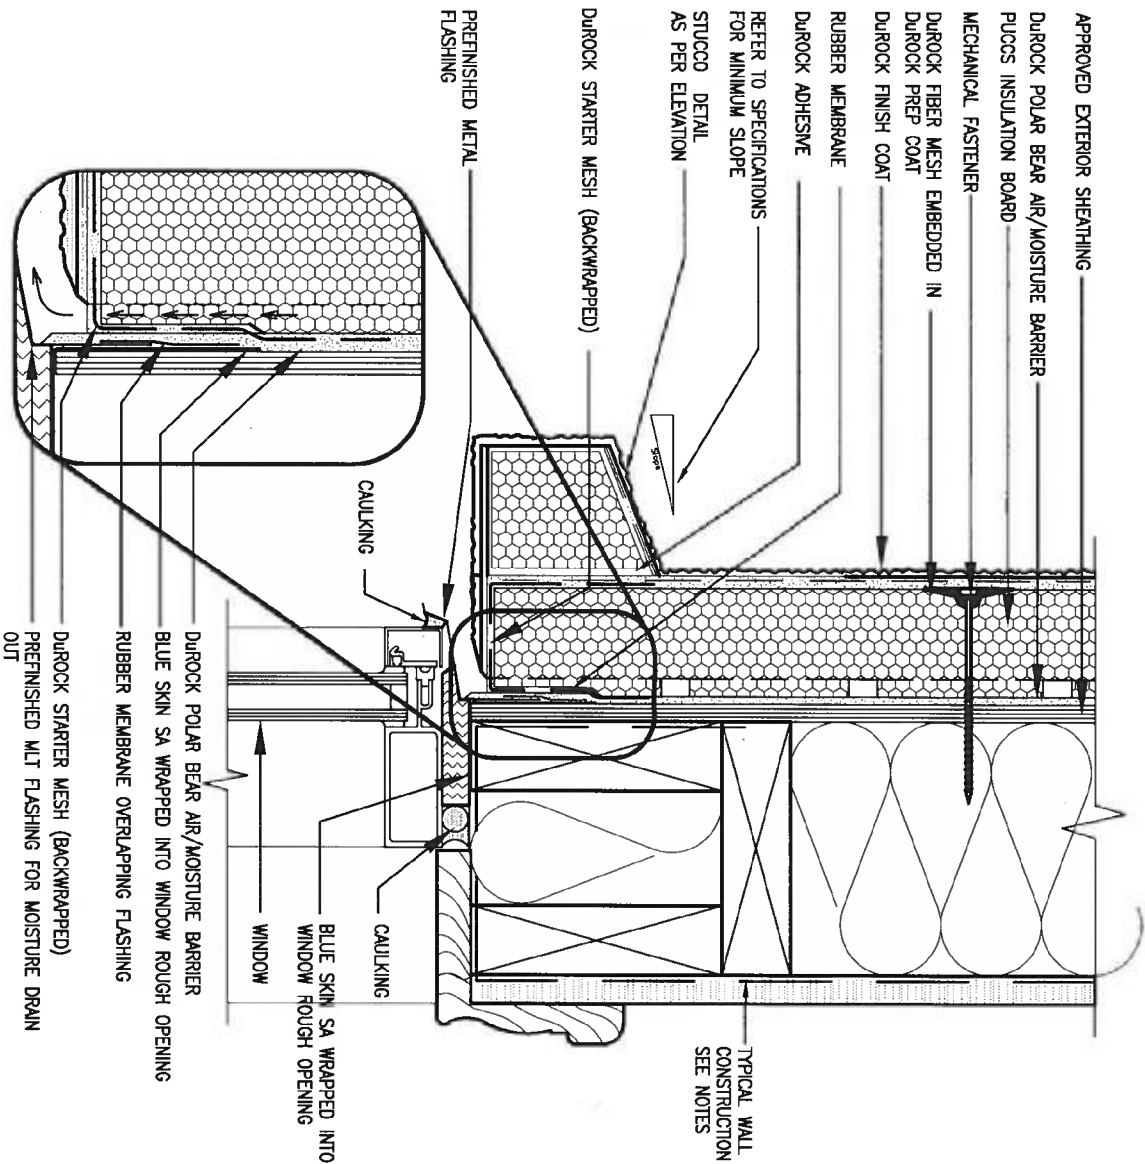
**VA3 DESIGN**

255 Consumers Rd Suite 120  
Toronto ON M2J 1R4  
t 416.630.2255 f 416.630.4782  
va3design.com

**BAYVIEW WELLINGTON**

**CONST NOTE**

project name GREEN VALLEY EAST	municipality BRADFORD	project no. 16023
date MAY 2016	scale 3/16" = 1'-0"	drawing no. CN2
drawn by RC	checked by	CONSTRUCTION NOTES
16023-CN-A1		
RICHARD - H:\ARCHIVE\WORKING\2016\16023.BW\Units\CN NOTES\16023-CN-A1.dwg - Thu - Jan 11 2018 - 10:08 AM		

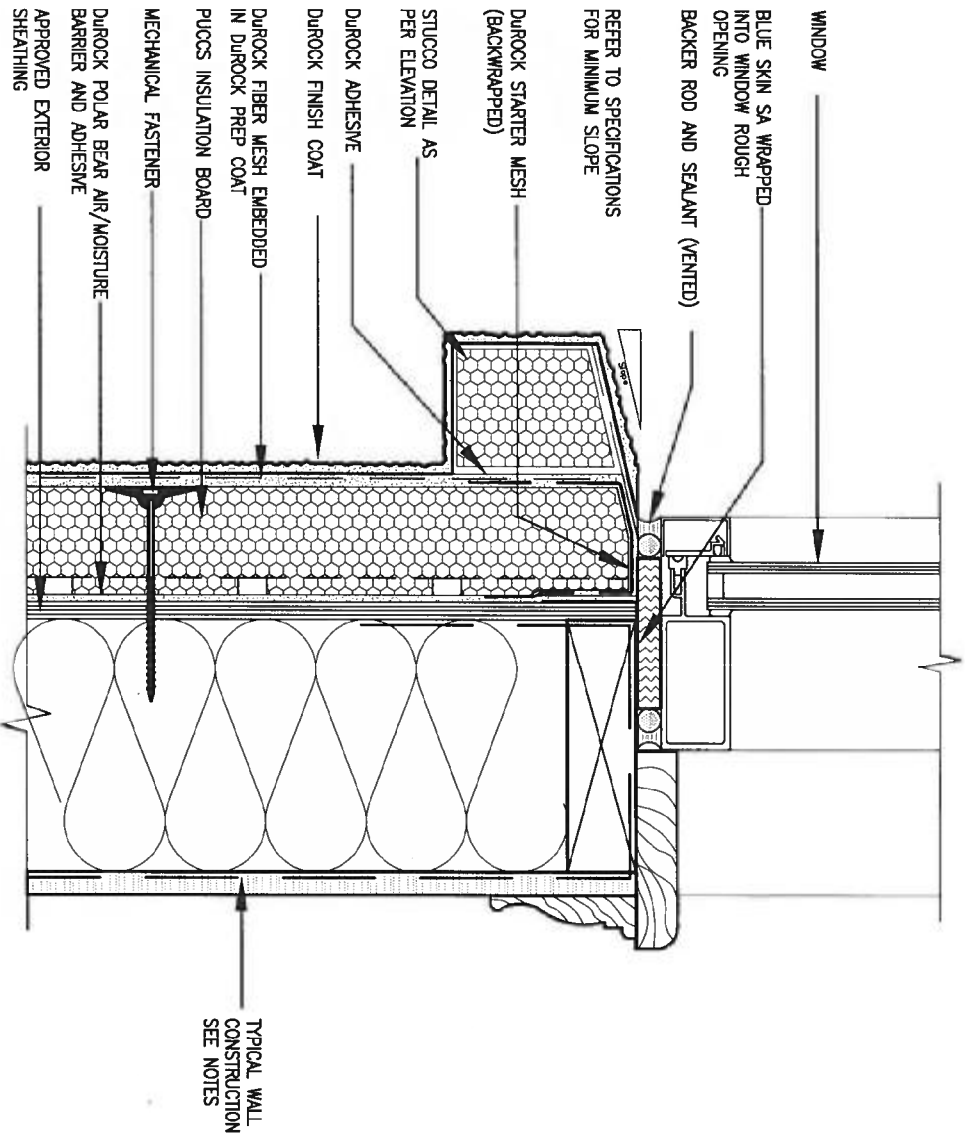


## 1 WINDOW HEADER

CN3 SCALE: 3"=1'-0"

ALL STUCCO WALLS TO HAVE A MINIMUM 10mm AIR SPACE BEHIND THE CLADDING WITH POSITIVE DRAINAGE TO THE EXTERIOR. THE EXTERIOR SHEATHING MUST NOT BE GYPSUM BASED. ALL STUCCO TO BE INSTALLED AS PER MANUFACTURERS SPECIFICATIONS.

DETAILS ARE BASED ON DUROCK PUCCS SYSTEM



## 2 WINDOW SILL

CN3 SCALE: 3"=1'-0"

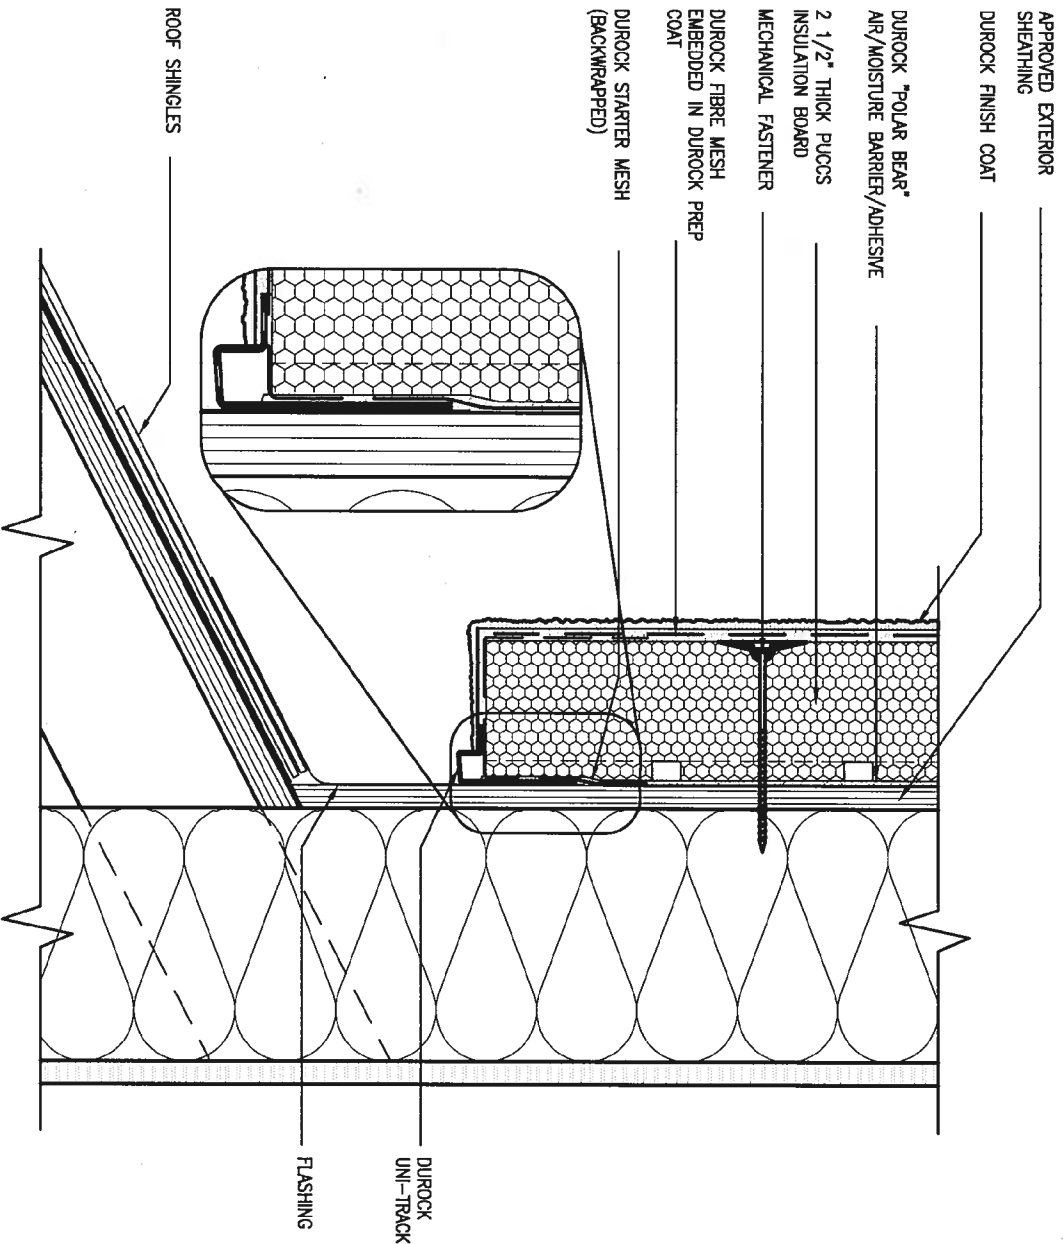
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8	.	.	qualification information		project name GREEN VALLEY EAST		municipality BRADFORD	project no. 16023
7	.	.	Wellington Jno-Baptiste		date MAY 2016		CONSTRUCTION NOTES	
6	.	.	name VA3 Design Inc.		drawn by RC	checked by -	scale 3/16" = 1'-0"	file name 16023-CN-A1
5	.	.	registration information VA3 Design Inc.		drawing no. CN3		drawing no. CN3	
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no.	description	date	by					



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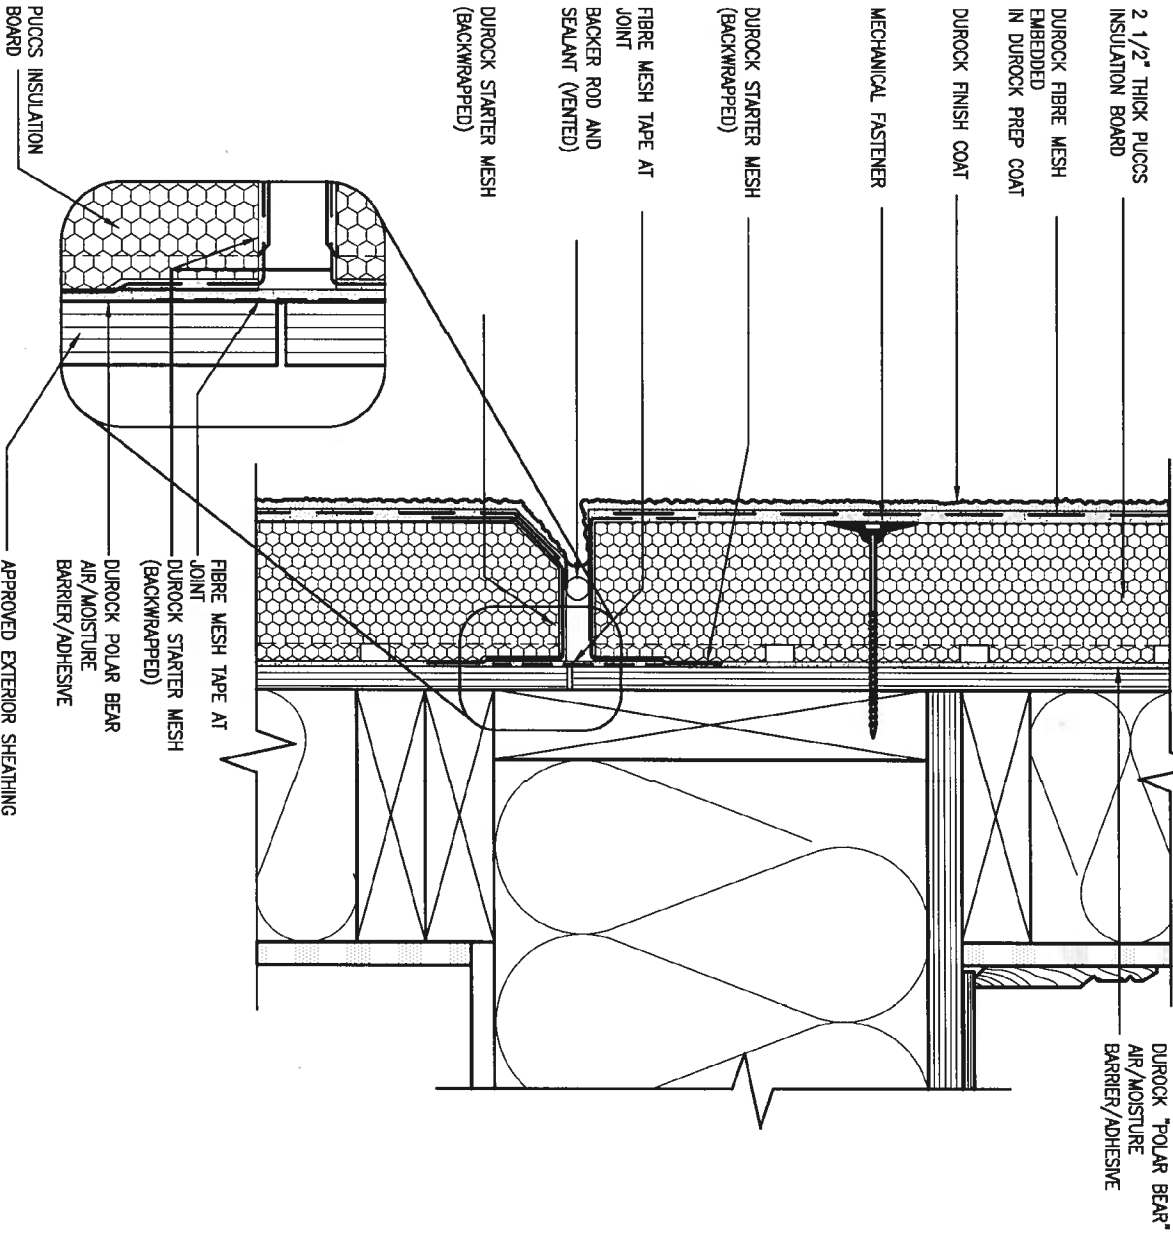
Site Copy



3 STUCCO TERMINATION @ ROOF

SCALE: 3"=1'-0"

ALL STUCCO WALLS TO HAVE A MINIMUM 10mm AIR SPACE BEHIND THE CLADDING WITH POSITIVE DRAINAGE TO THE EXTERIOR. THE EXTERIOR SHEATHING MUST NOT BE GYPSUM BASED. ALL STUCCO TO BE INSTALLED AS PER MANUFACTURERS SPECIFICATIONS. DETAILS ARE BASED ON DUROCK PUCCS SYSTEM



4 HORIZONTAL EXPANSION JOINT

SCALE: 3"=1'-0"

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8.	.	.	.
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4.	.	.	.
3.	.	.	.
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qualification information			
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name		signature	42658
registration information			
VA3 Design Inc.			
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VA3

DESIGN

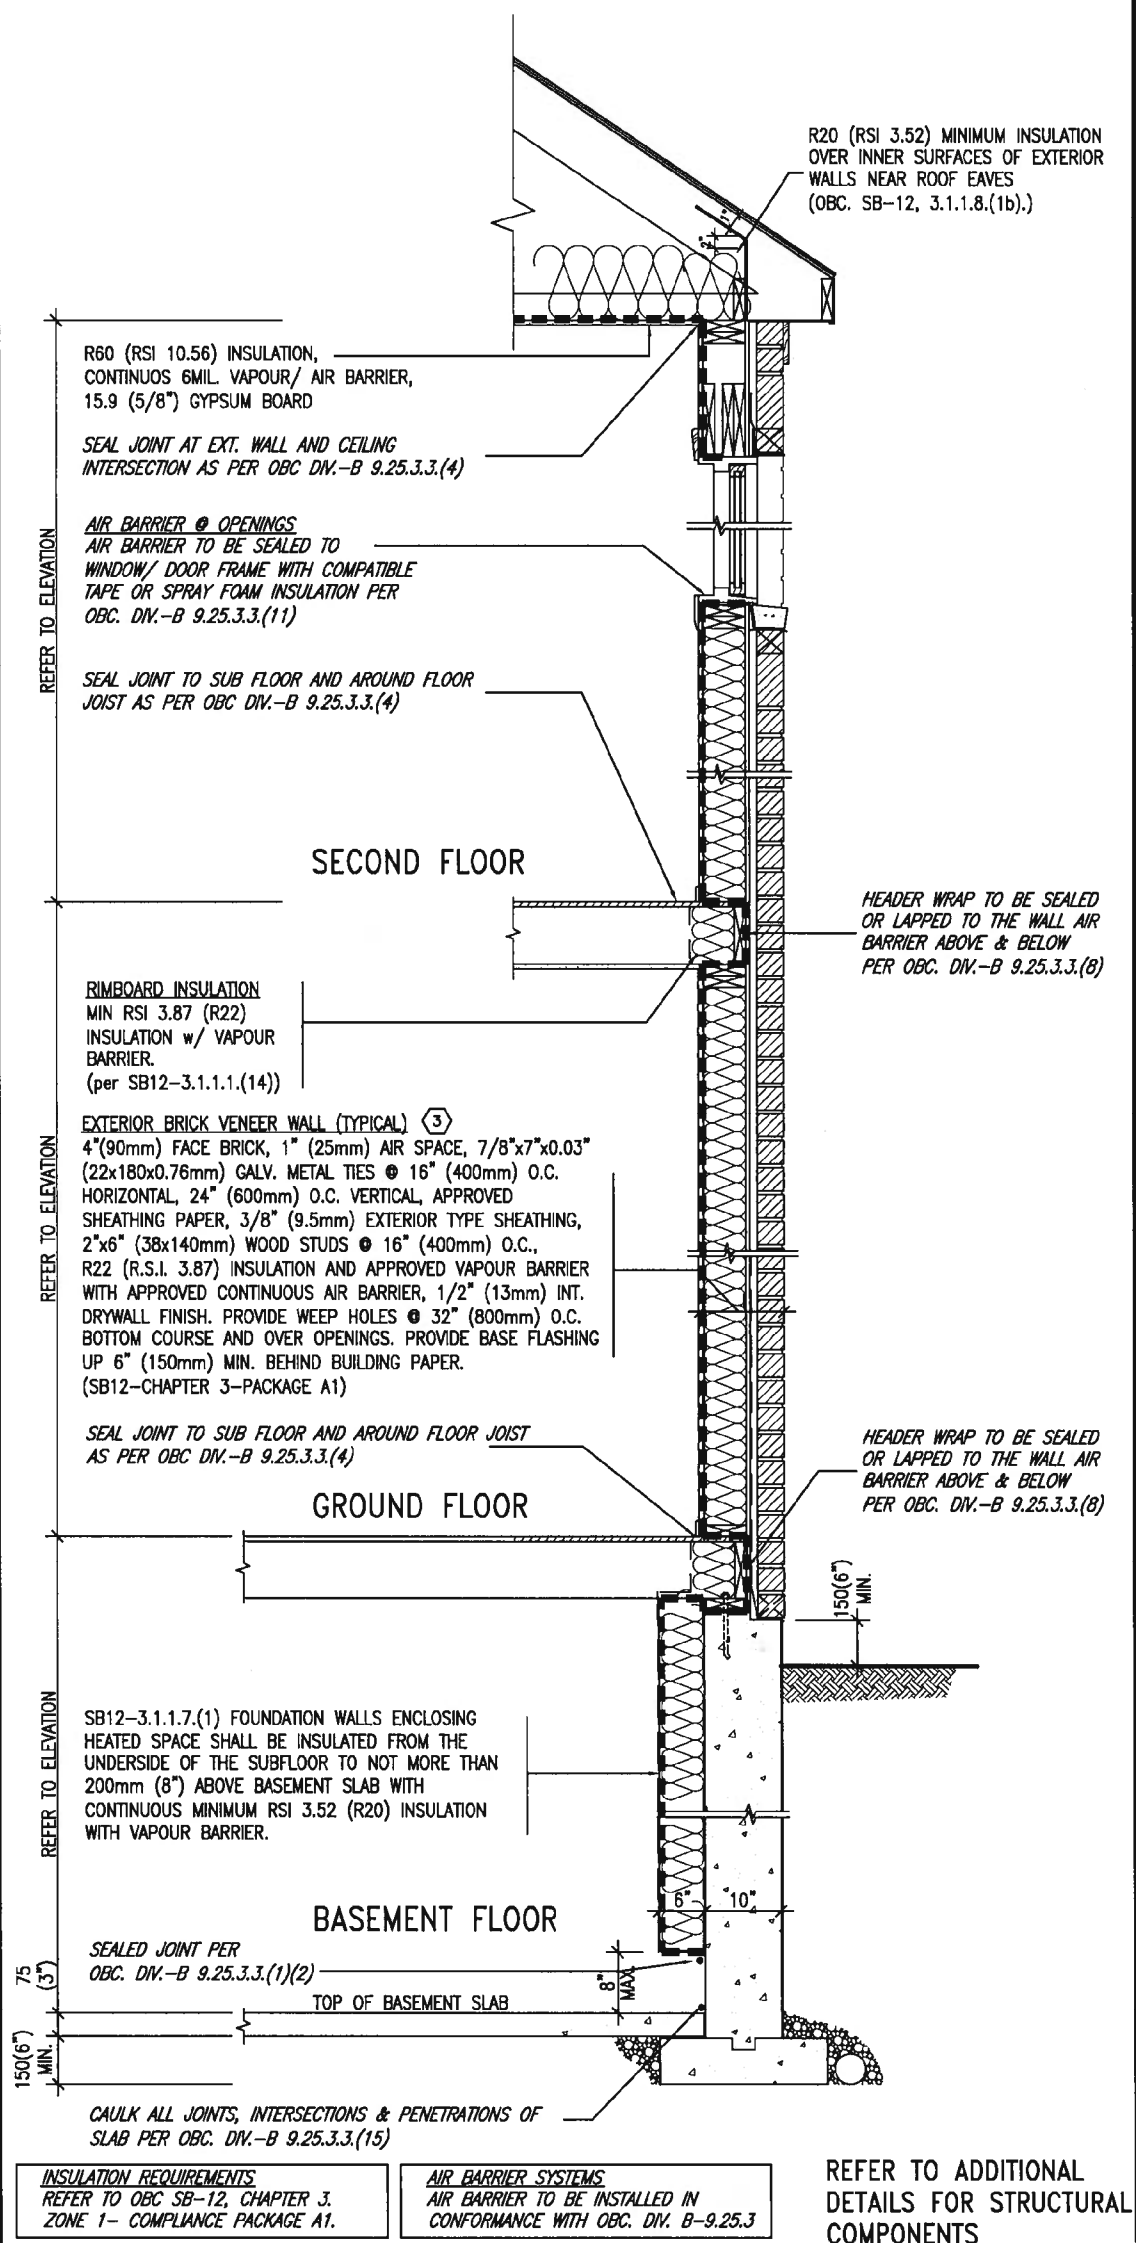
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BAYVIEW WELLINGTON		CONST NOTE	
project name	GREEN VALLEY EAST	municipality	BRADFORD
date	MAY 2016	scale	3/16" = 1'-0"
drawn by	RC	checked by	-
CONSTRUCTION NOTES		file name	16023-CN-A1
drawing no.		16023	
CN4		CN4	





SB12-COMPLIANCE PACKAGE 'A1'

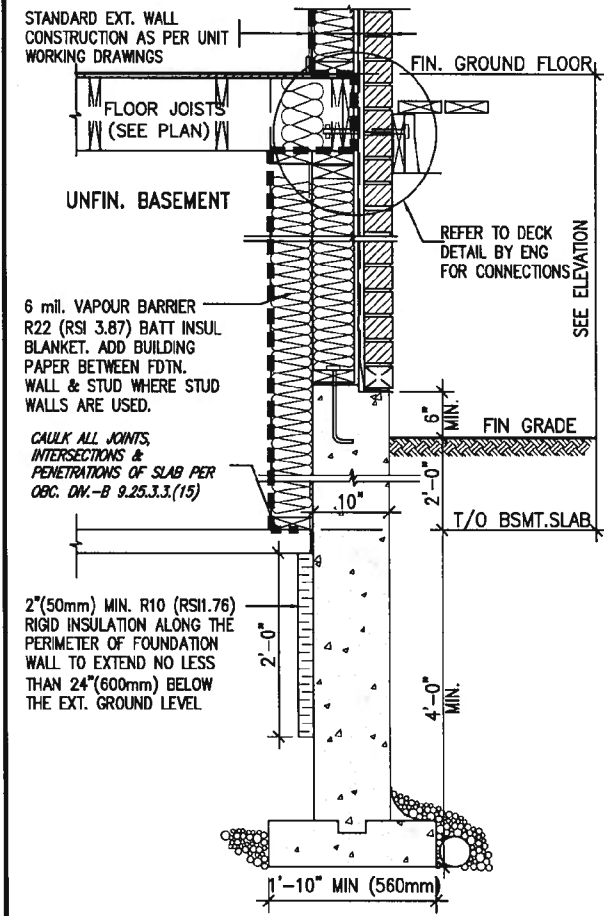


EW TYPICAL EXT. WALL AIR BARRIER CONTINUITY SECTION w/ BRICK VENEER (PACKAGE A1) 10" FOUNDATION WALL SCALE: N.T.S.

THE MINIMAL THERMAL PERFORMANCE OF BUILDING ENVELOPE AND EQUIPMENT SHALL CONFORM TO THE FOLLOWING SB-12 COMPLIANCE PACKAGE AS PER OBC SUPPLEMENTARY STANDARD SB-12, SECTION 3.1.1.1.

USE SB-12 COMPLIANCE PACKAGE (A1):		
COMPONENT	A1	Notes:
Ceiling with Attic Space	10.56 (R60)	R20 at inner face of exterior walls
Minimum RSI (R) value		
Ceiling without Attic Space	5.46 (R31)	BATT or SPRAY
Minimum RSI (R) value		
Exposed Floor	5.46 (R31)	BATT or SPRAY
Minimum RSI (R) value		
Walls Above Grade	3.87 (R22)	6" R22 BATT
Minimum RSI (R) value		
Basement Walls	3.52ci (R20ci)	OPTION TO USE R12+R10ci.
Minimum RSI (R) value		
Edge of Below Grade Slab ≤600mm below grade	1.76 (R10)	RIGID INSUL
Minimum RSI (R) value		
Windows & Sliding glass Doors	1.6	
Maximum U-value		
Skylights	2.8U	
Maximum U-value		
Space Heating Equipment	96% Min.	NATURAL GAS
Minimum AFUE		
Hot Water Heater	0.8	NATURAL GAS
Minimum EF		
HRV	75%	-
Minimum Efficiency		
Drain Water Heat Recovery Unit (DWHR)		Minimum 1 OR Maximum 2 Required. Dependent on number of showers installed. Refer to SB12-3.1.1.12 for information.

ci- Denotes Continuous Insulation without framing interruption.



SECTION AT W.O.D/W.O.B. \* REVISED-FEB 2017

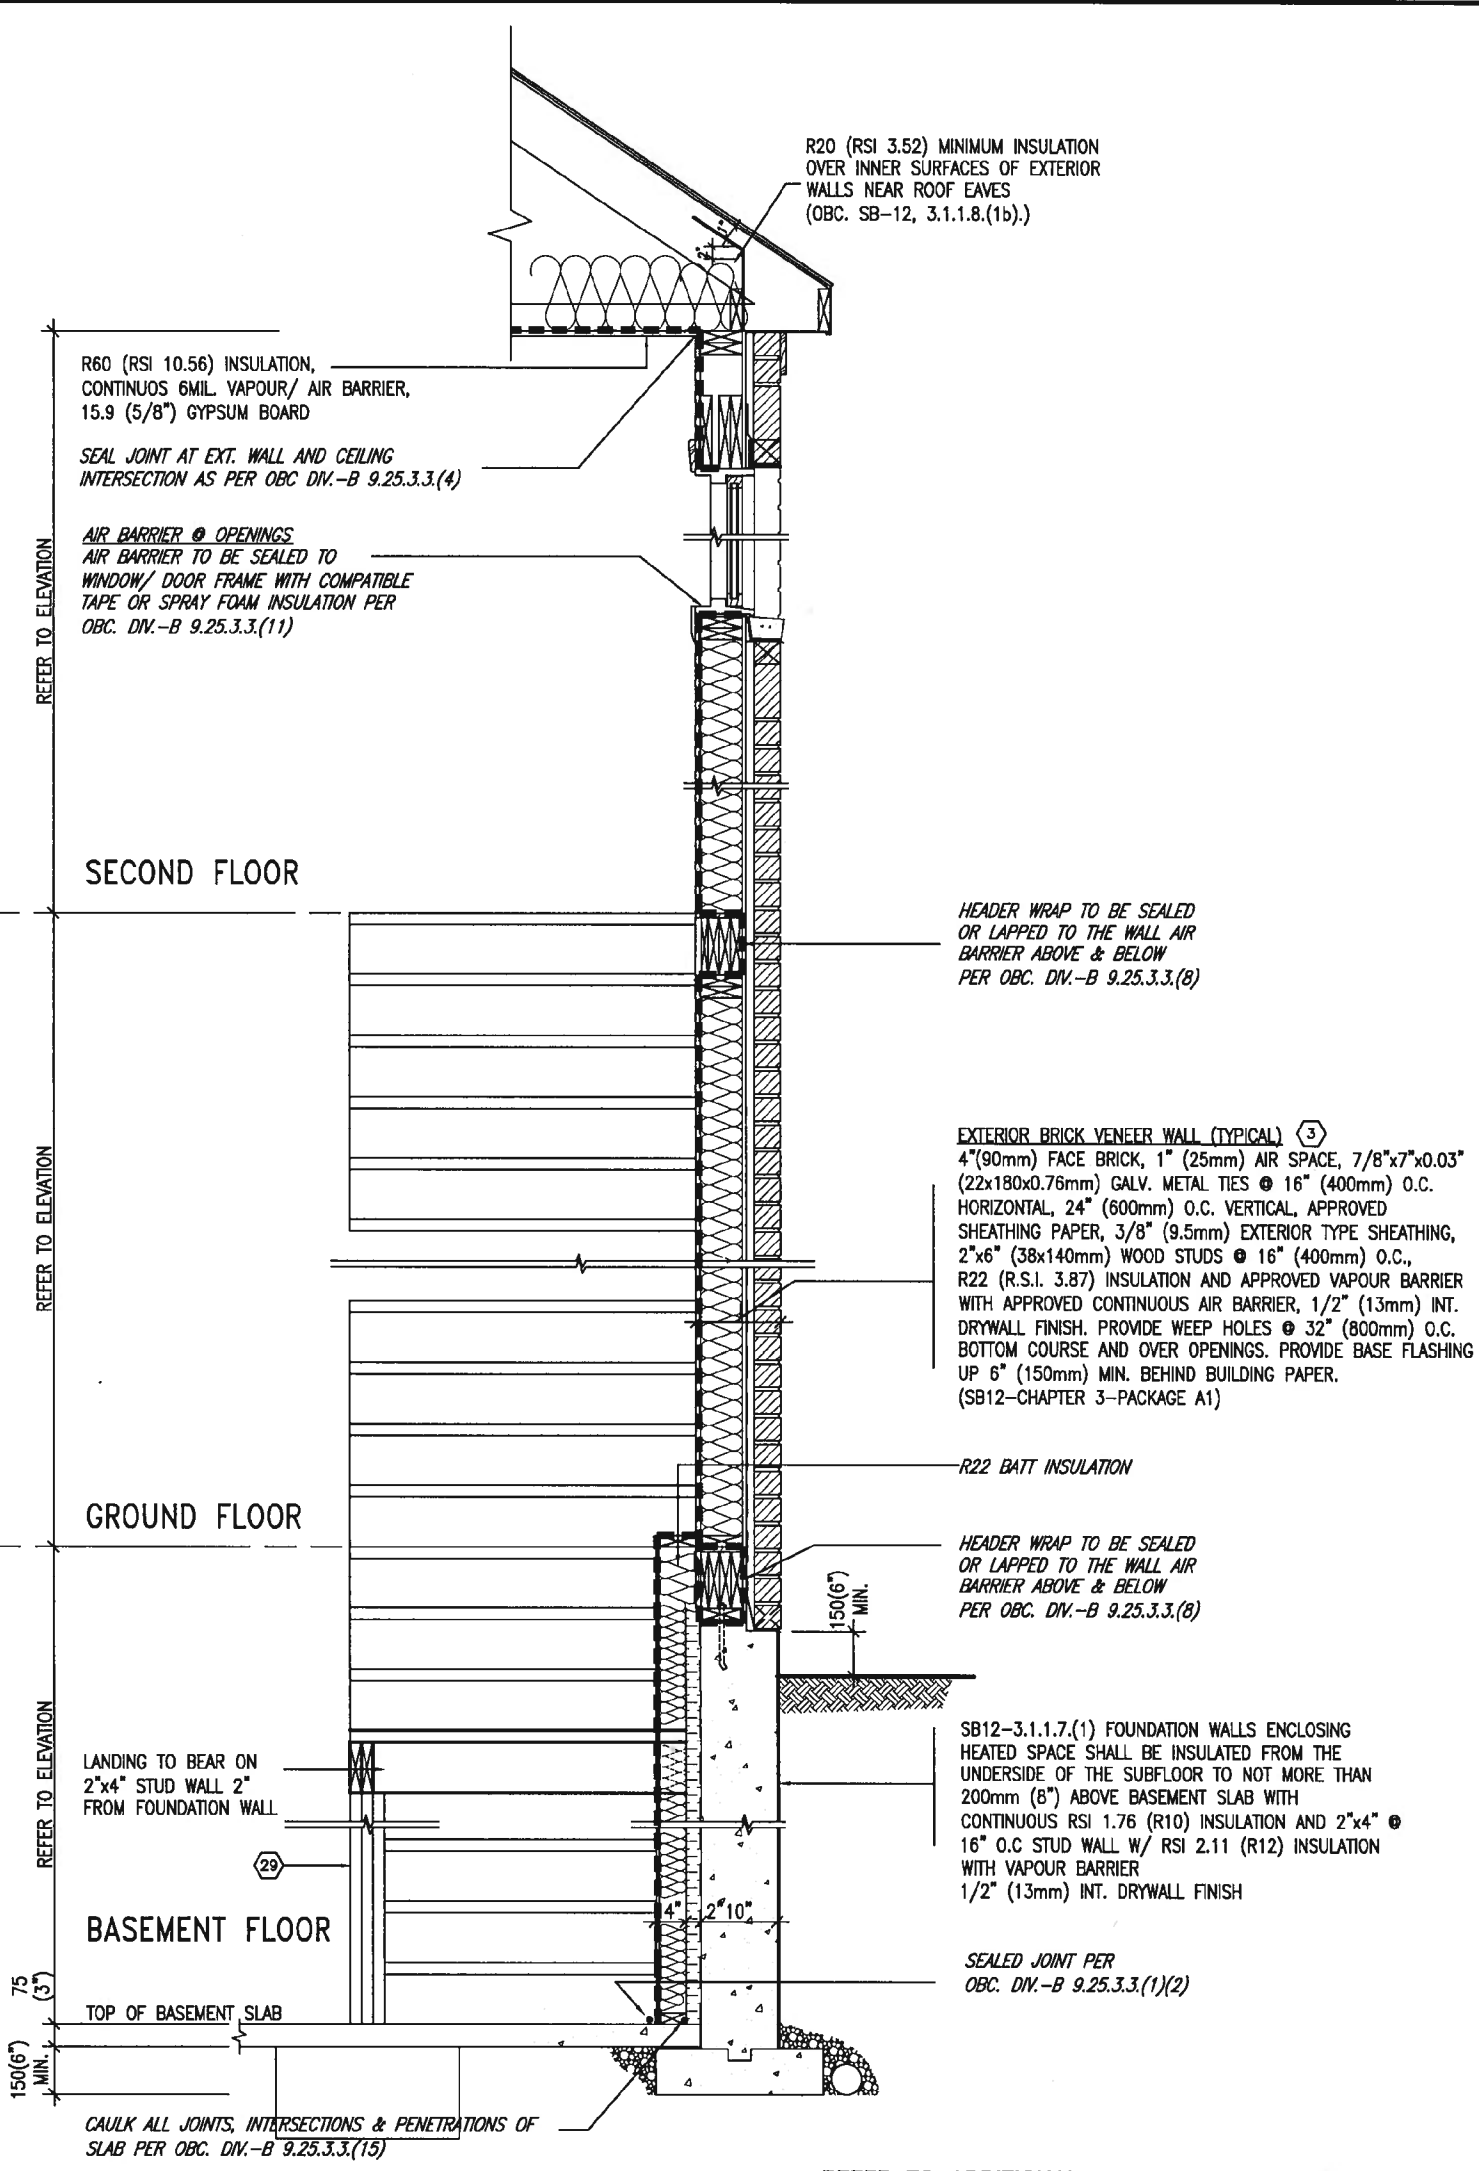
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6.				signature	BCN
5.				name	42658
4.				registration information	
3.				VAS Design Inc.	
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no.	description	date	by		

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project name	GREEN VALLEY EAST	municipality	BRADFORD
date	MAY 2016	scale	3/16" = 1'-0"
drawn by	RC	checked by	
file name	16023-CN-A1	drawing no.	CN6
CONSTRUCTION NOTES			
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SB12-COMPLIANCE PACKAGE 'A1'



**INSULATION REQUIREMENTS**  
REFER TO OBC SB-12, CHAPTER 3.  
ZONE 1- COMPLIANCE PACKAGE A1.

**AIR BARRIER SYSTEMS**  
AIR BARRIER TO BE INSTALLED IN  
CONFORMANCE WITH OBC, DIV. B-9.25.3

REFER TO ADDITIONAL  
DETAILS FOR STRUCTURAL  
COMPONENTS



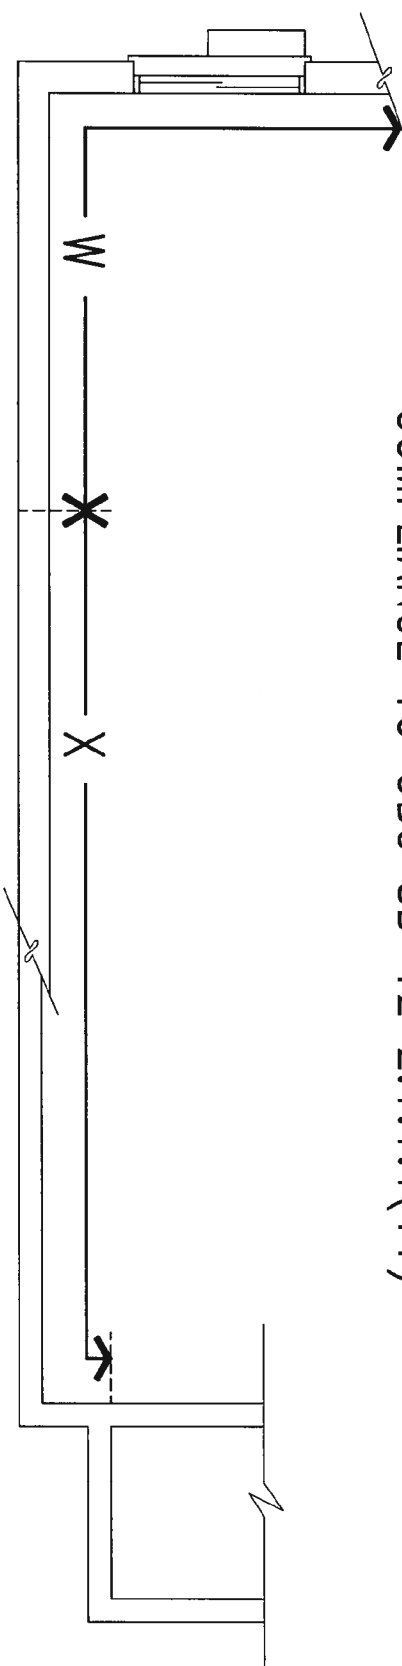
**EW STR** TYPICAL EXT. WALL AIR BARRIER CONTINUITY SECTION w/  
BRICK VENEER AT STAIR AND SUNKEN COND (PACKAGE A1)  
10" FOUNDATION WALL  
SCALE: N.T.S.

Site Copy

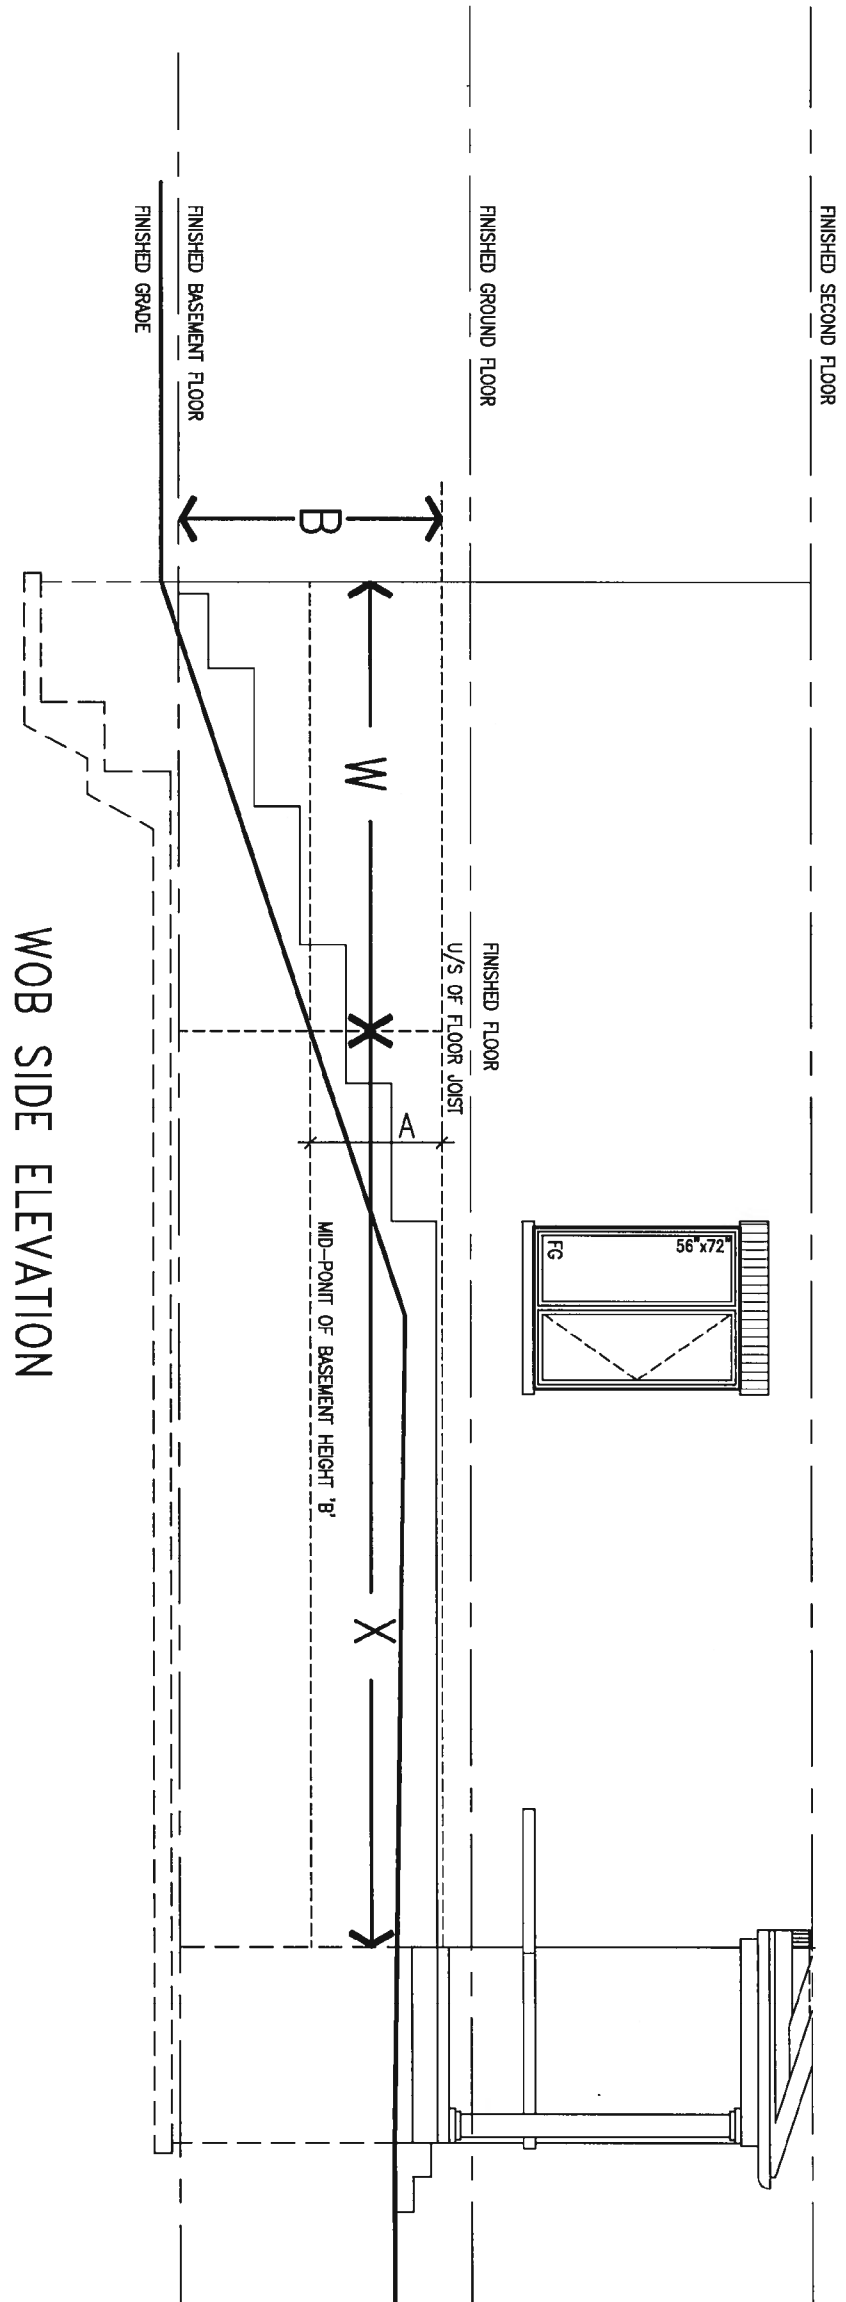
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8.	-	-	qualification information		project name		municipality	project no.
7.	-	-	Wellington Jno-Baptiste		GREEN VALLEY EAST		BRADFORD	16023
6.	-	-	signature		date		CONSTRUCTION NOTES	
5.	-	-	name		MAY 2016		drawing no.	
4.	-	-	registration information		drawn by		file name	
3.	-	-	VA3 Design Inc.		checked by		16023-CN-A1	
2.	UPDATE TO 2018	JAN 11-18	RC	scale		CN7		
1.	ISSUE FOR CLIENT REVIEW	AUG 04-17	RC	3/16" = 1'-0"				
no.	description	date	by	RICHARD - H:\ARCHIVE\WORKING\2016\16023.BW\Units\CN NOTES\16023-CN-A1.dwg - Thu - Jan 11 2018 - 10:10 AM				
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COMPLIANCE TO OBC SB-12 2.1.1.1(11)



WOB PLAN

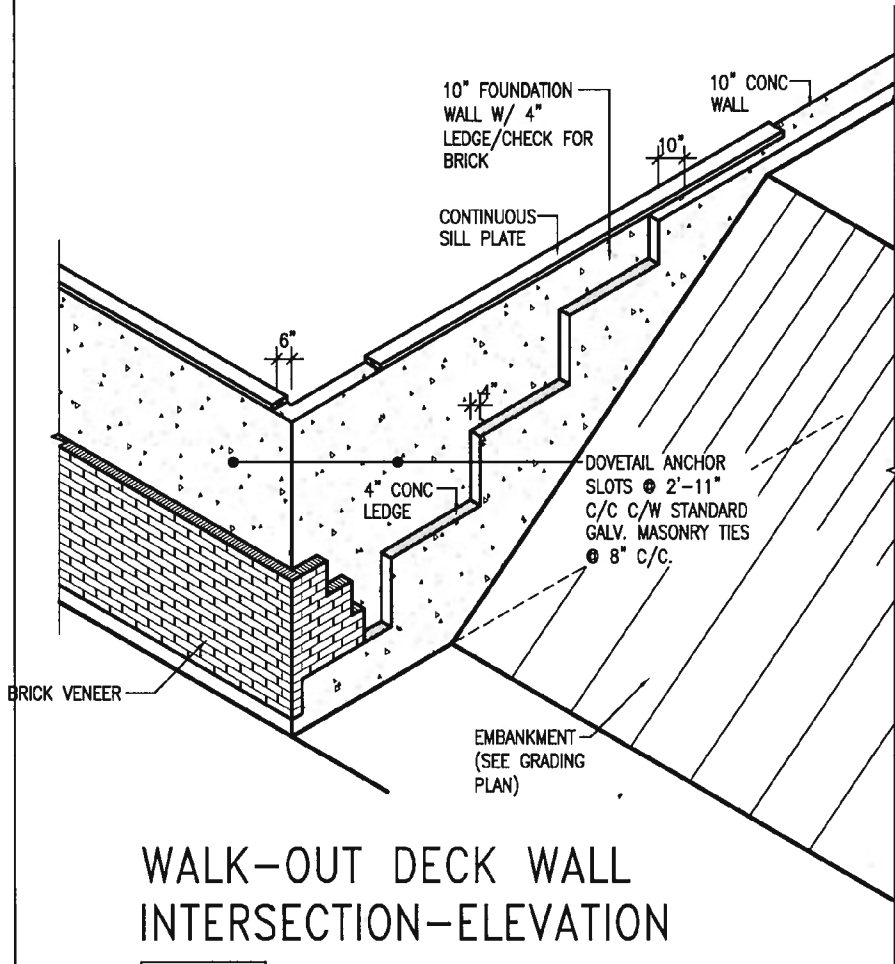


WHEN EXPOSED WALL "A" IS GREATER THAN 50% OF BASEMENT WALL HEIGHT "B" INSULATION VALUE FOR WALL IN SECTION "W" IS NOT LESS THAN IS REQUIRED FOR ABOVE GRADE WALL AS REQUIRED BY TABLE 2.1.1.2A

WHEN EXPOSED WALL "A" IS LESS THAN 50% OF BASEMENT WALL HEIGHT "B" INSULATION VALUE FOR WALL IN SECTION "X" IS NOT LESS THAN BASEMENT WALL AS REQUIRED BY TABLE 2.1.1.2A

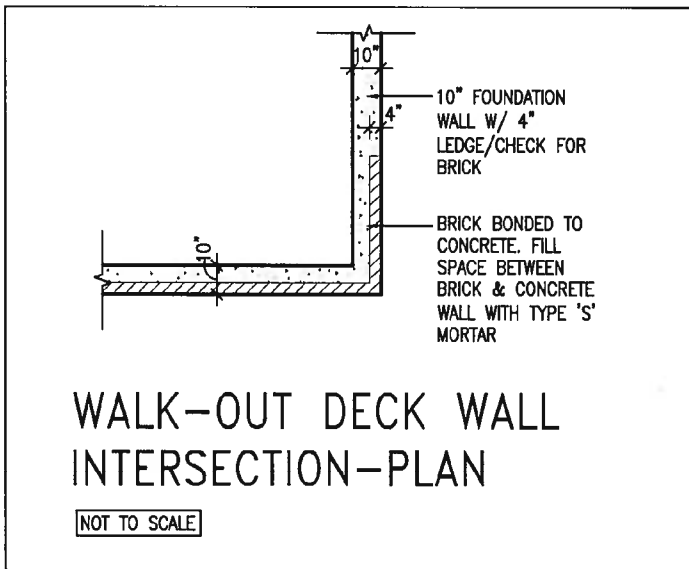
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8.	.	.	qualification information						
7.	.	.	Wellington Jno-Baptiste 25591						
6.	.	.	name registration information VA3 Design Inc. 42658						
5.	.	.	signature						
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no.	description	date	by						





WALK-OUT DECK WALL  
INTERSECTION-ELEVATION

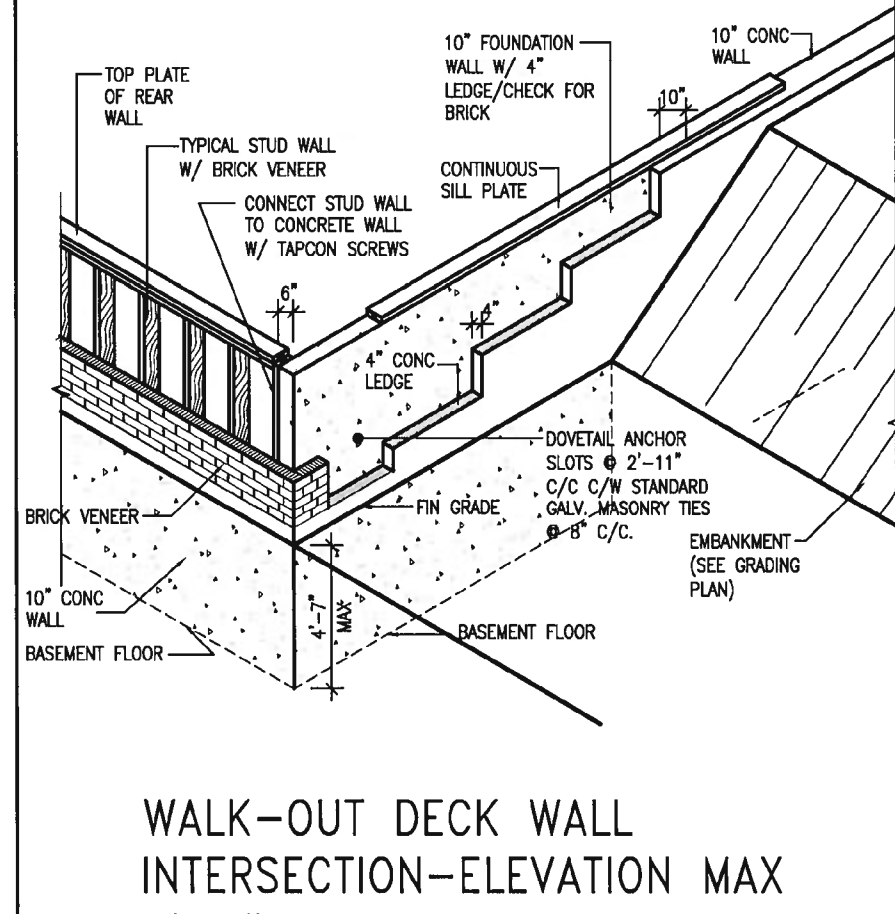
NOT TO SCALE



WALK-OUT DECK WALL  
INTERSECTION-PLAN

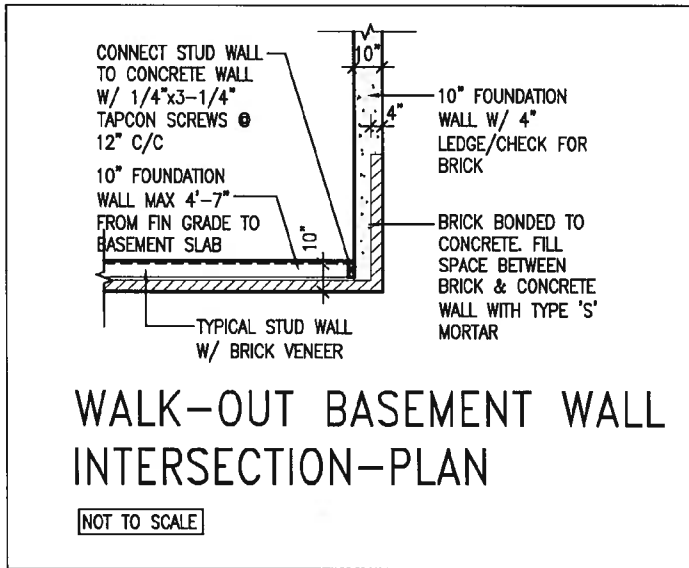
NOT TO SCALE

(10" FOUNDATION WALL)



WALK-OUT DECK WALL  
INTERSECTION-ELEVATION MAX  
4'-7" BACKFILL

NOT TO SCALE



WALK-OUT BASEMENT WALL  
INTERSECTION-PLAN

NOT TO SCALE

(10" FOUNDATION WALL)



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6.	.	.	name	BCN
5.	.	.	registration information	42658
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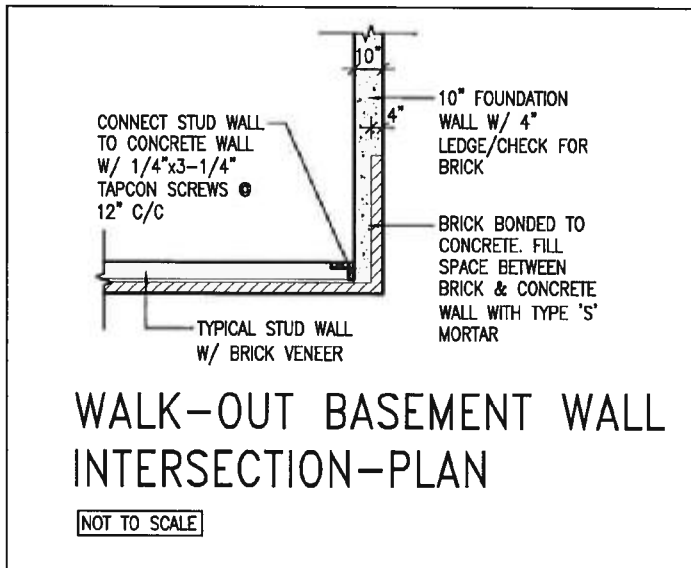
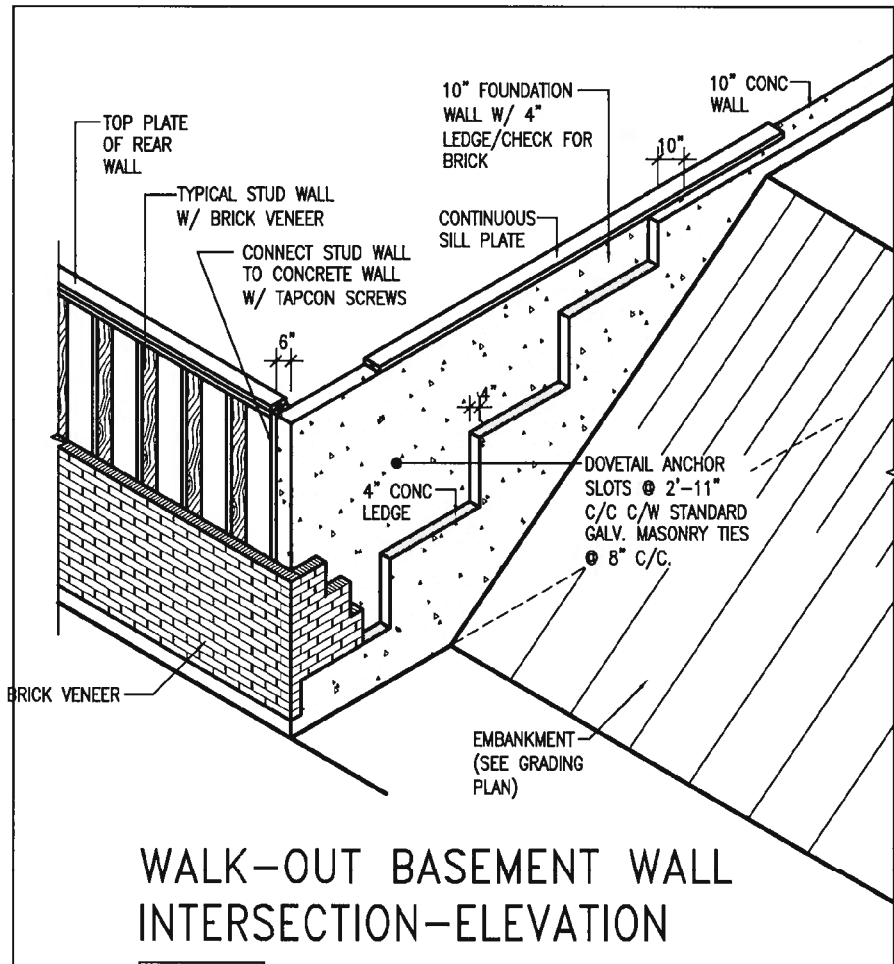
BAYVIEW WELLINGTON

CONST NOTE

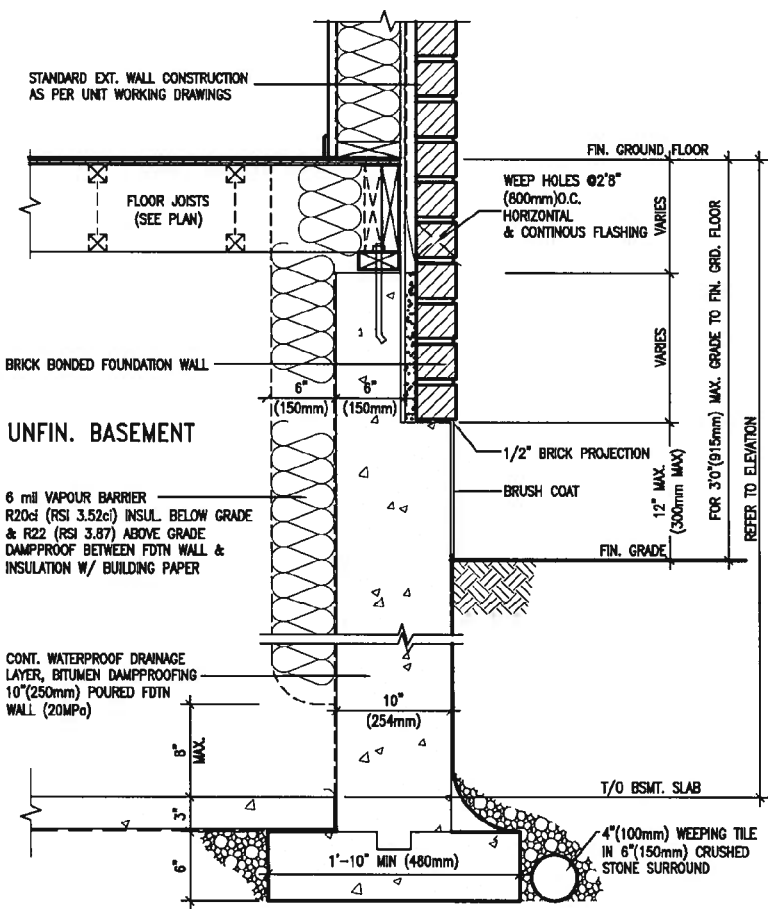
project name	GREEN VALLEY EAST	municipality	BRADFORD	project no.	16023
date	MAY 2016	scale	3/16" = 1'-0"	file name	16023-CN-A1
drawn by	RC	checked by		drawing no.	CN10
CONSTRUCTION NOTES					
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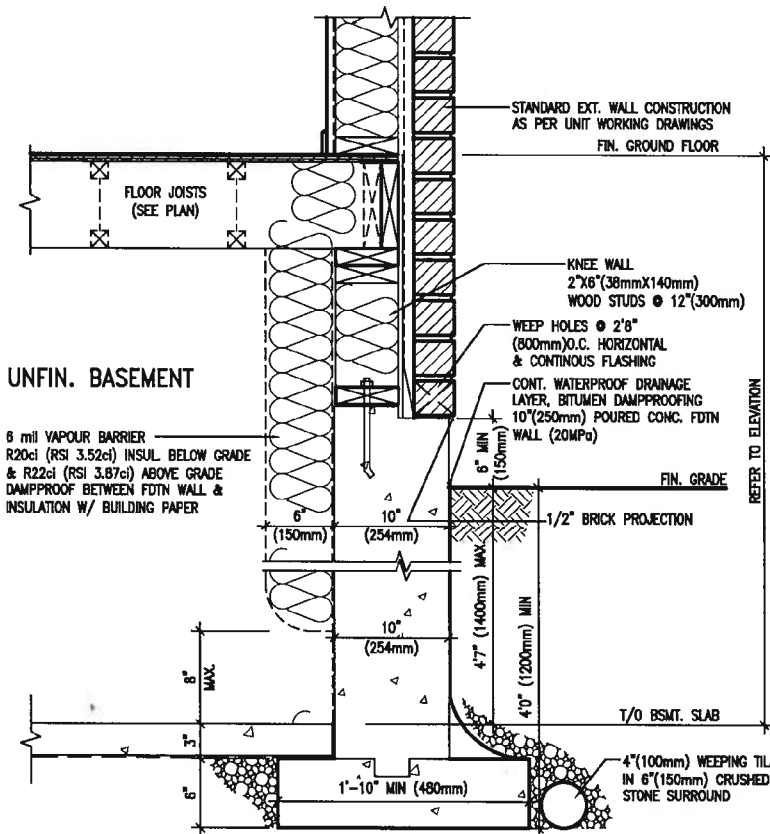




(10" FOUNDATION WALL)



EW3.06x  
PKG A1  
SCALE: N.T.S.



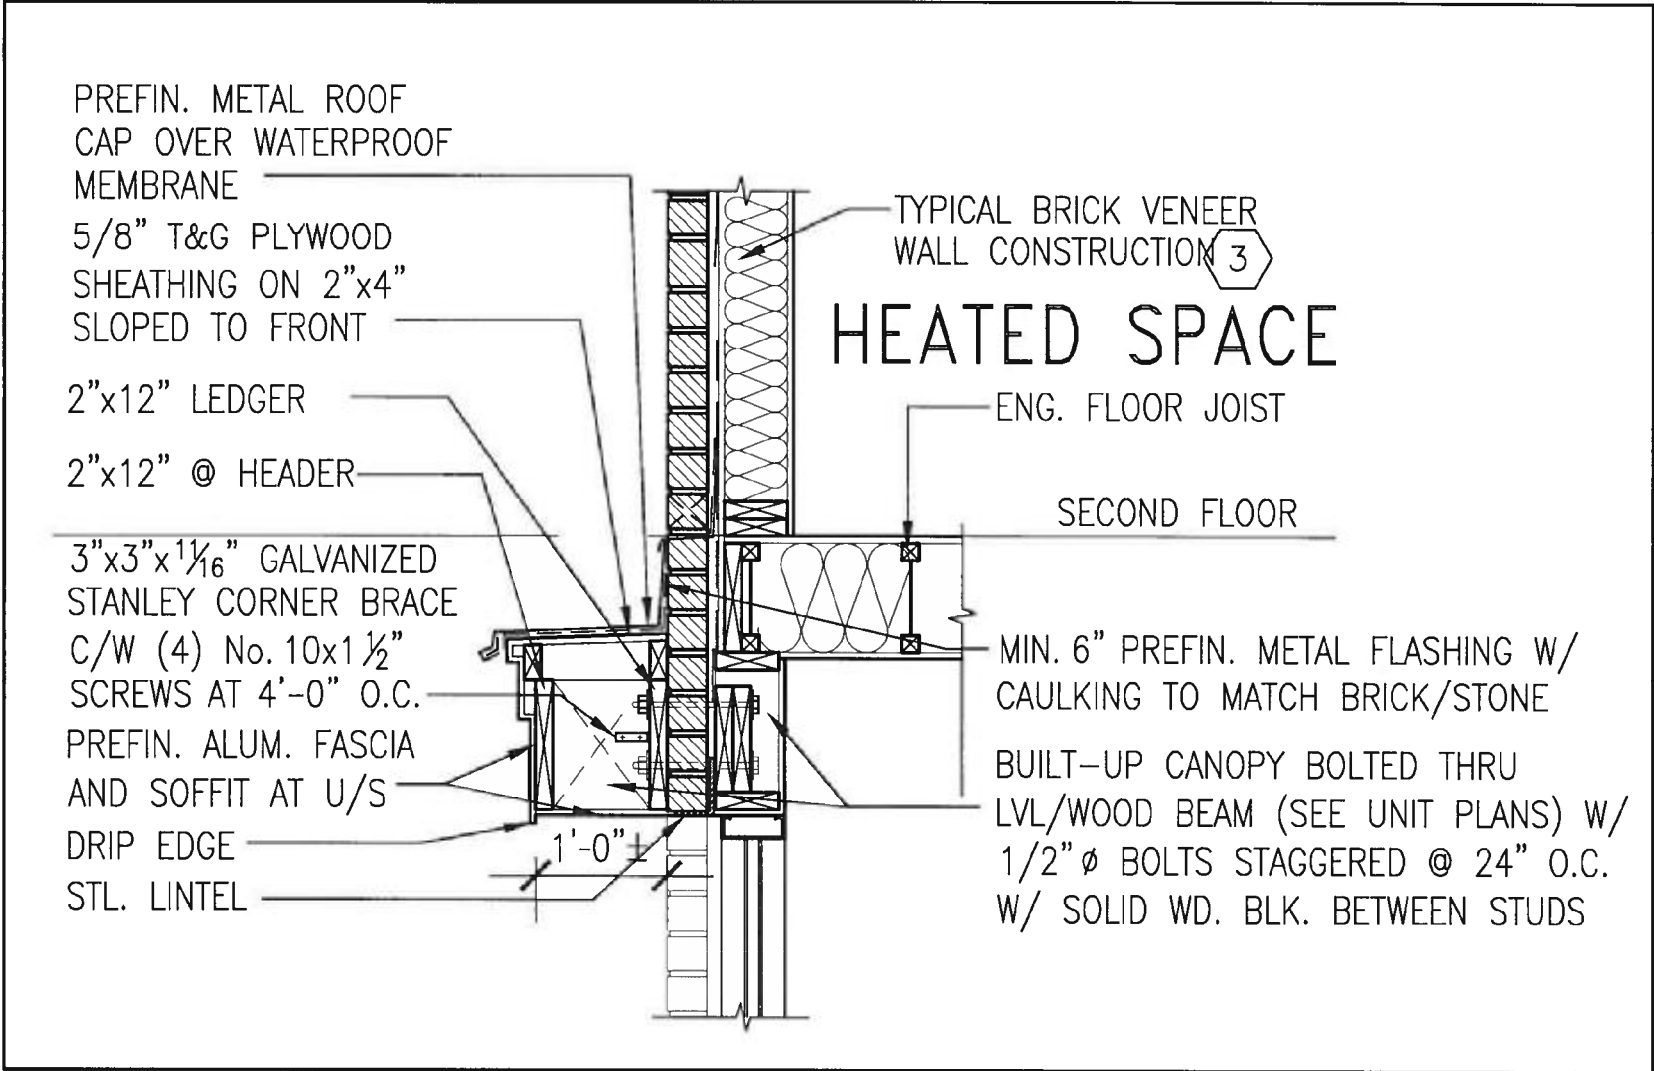
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PKG A1  
SCALE: N.T.S.



JAN 11, 2018

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1  
CN12

# SECTION THROUGH CANOPY

SCALE 1/2" = 1'-0"



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7	.	.	.	Wellington Jno-Baptiste		GREEN VALLEY EAST	BRADFORD	16023	
6	.	.	.	name		date	CONSTRUCTION NOTES		
5	.	.	.	registration information		MAY 2016	drawing no.		
4	.	.	.	VA3 Design Inc.	RC	CN12			
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3/16"x4"x4" PREFIN.  
METAL PLATE  
3/8" DIA. DECORATIVE  
PREFIN. METAL ROD  
WELDED TO ANCHOR  
PLATE  
PREFIN. METAL ROOF  
CAP OVER WATERPROOF  
MEMBRANE

5/8" T&G PLYWOOD  
SHEATHING ON 2"x4"  
SLOPED TO FRONT

2"x12" LEDGER  
3/16"x4"x4" PREFIN.  
METAL PLATE SCREWED  
TO TOP OF CANOPY  
2"x12" @ HEADER

3"x3"x1 1/8" GALVANIZED  
STANLEY CORNER BRACE  
C/W (4) No. 10x1 1/2"  
SCREWS AT 4'-0" O.C.  
PREFIN. ALUM. FASCIA  
AND SOFFIT AT U/S  
DRIP EDGE  
STL. LINTEL

## HEATED SPACE

TYPICAL BRICK VENEER  
WALL CONSTRUCTION 3

8" GALV. METAL SCREWS INTO  
3-2"x6" BLOCKING

ENG. FLOOR JOIST

SECOND FLOOR

MIN. 6" PREFIN. METAL FLASHING W/  
CAULKING TO MATCH BRICK/STONE

BUILT-UP CANOPY BOLTED THRU  
LVL/WOOD BEAM (SEE UNIT PLANS) W/  
1/2" Ø BOLTS STAGGERED @ 24" O.C.  
W/ SOLID WD. BLK. BETWEEN STUDS

1  
CN13

## SECTION THROUGH CANOPY

W/ DECORATIVE ROD

SCALE 1/2" = 1'-0"



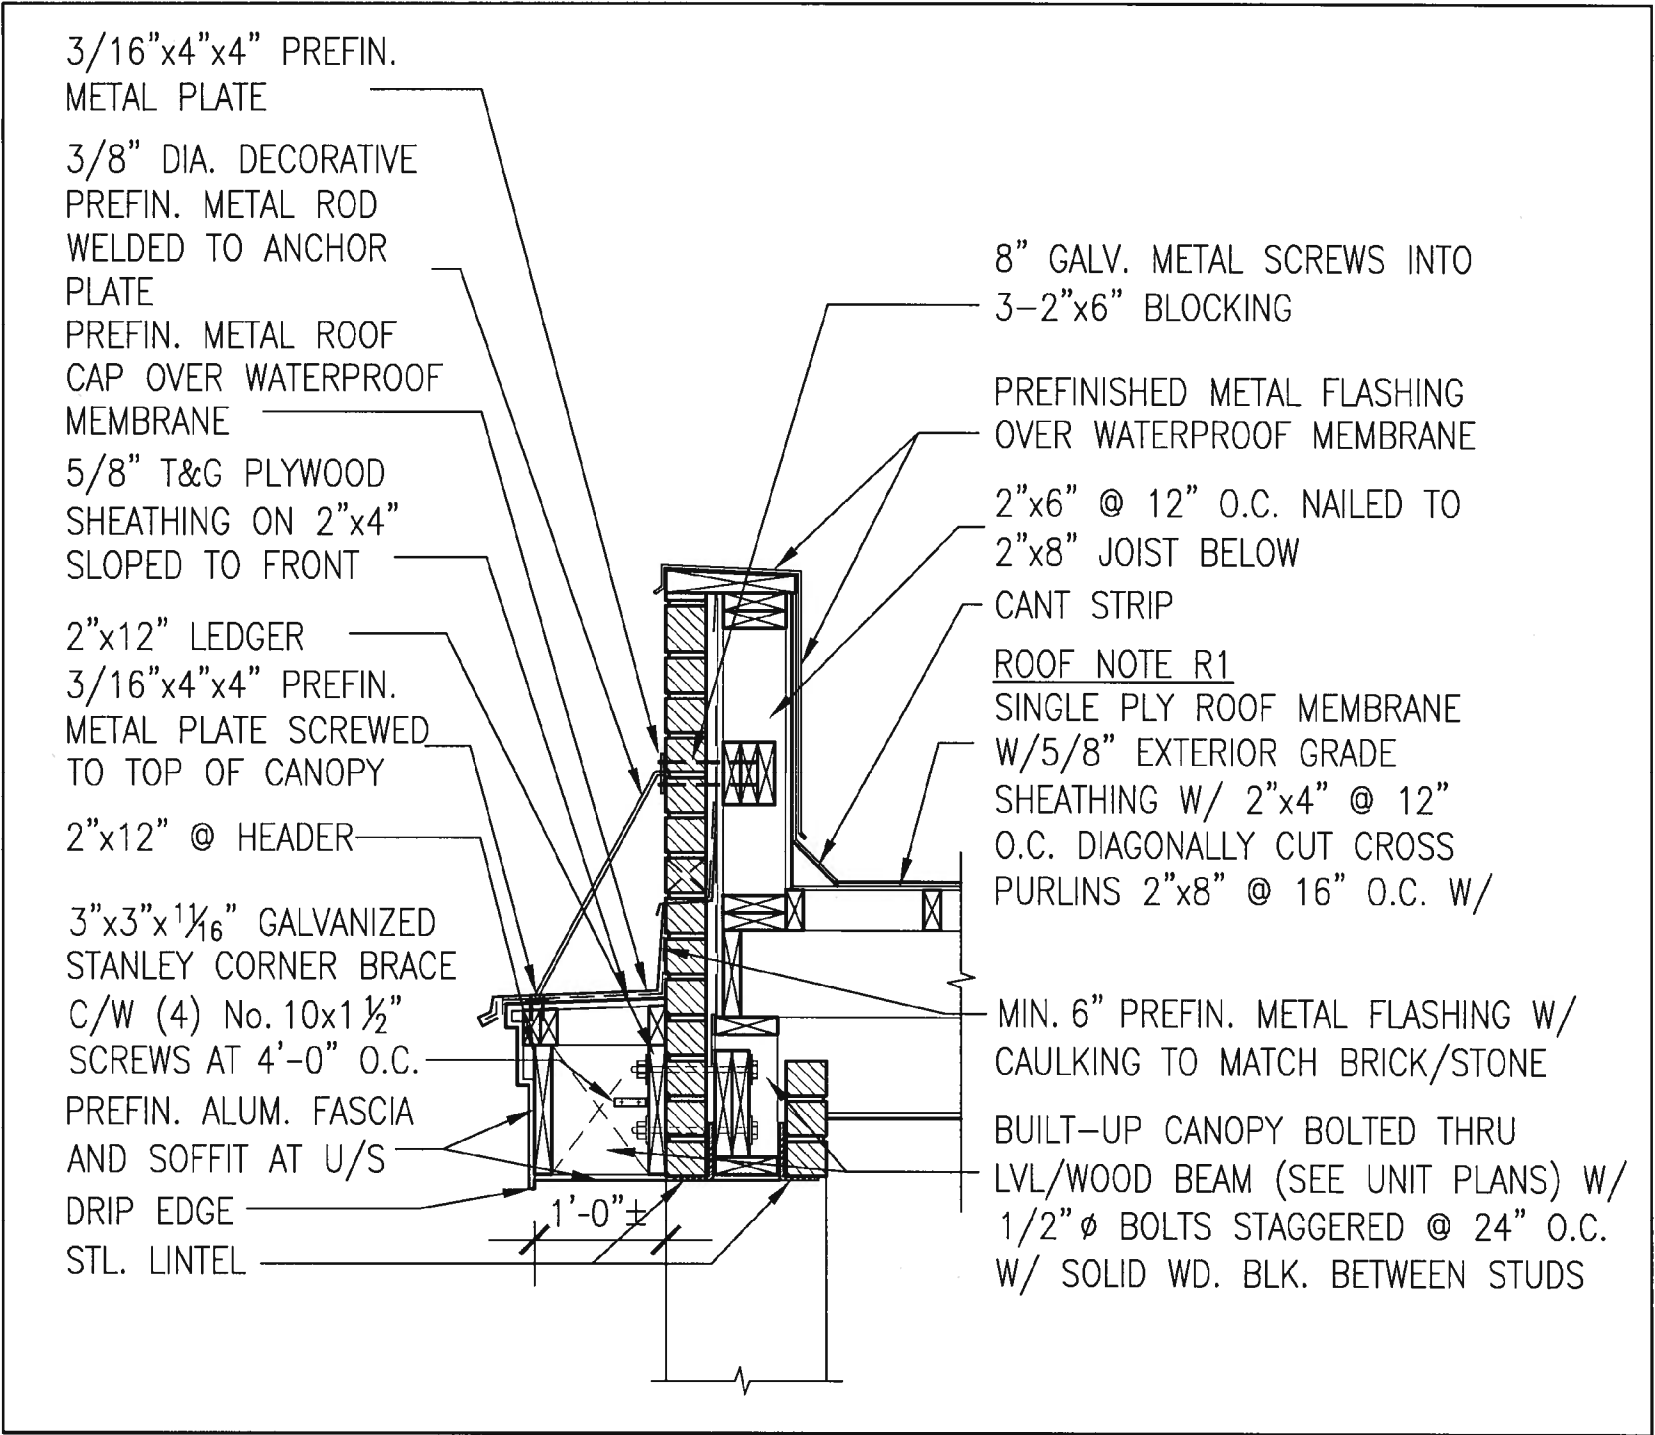
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8.					municipality BRADFORD	
7.					CONSTRUCTION NOTES	
6.					date MAY 2016	drawing no. CN13
5.					drawn by RC	file name 16023-CN-A1
4.					checked by -	scale 3/16" = 1'-0"
3.					R:\CHARP - H:\ARCHIVE\WORKING\2016\16023.BW\Units\CN NOTES\16023-CN-A1.dwg -- Thu -- Jan 11 2018 -- 10:11 AM	
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no.	description	date by				

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1  
CN14

SECTION THROUGH CANOPY  
W/ DECORATIVE ROD  
SCALE 1/2" = 1'-0"



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8.	.	.	qualification information		project name GREEN VALLEY EAST	municipality BRADFORD	project no. 16023	
7.	.	.	Wellington Jno-Baptiste		CONSTRUCTION NOTES			
6.	.	.	name signature		date MAY 2016	checked by RC	scale 3/16" = 1'-0"	file name 16023-CN-A1
5.	.	.	registration information VA3 Design Inc.		drawing no. CN14			
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