

PROVIDE BALANCING DAMPERS ON ALL BRANCHES. ALL R/A PARTITIONS 6" (FIRST FLOOR ONLY) INSULATE DUCTS IN UNCONDITIONED SPACES RI2 UNDERCUT ALL DOORS I" MIN.

CONTRACTOR MUST WORK FROM APPROVED PLANS.
ANY ALTERATIONS TO THIS ORIGINAL PLAN ARE NOT THE RESPONSIBILITY OF GTA DESIGNS.

GTA DESIGNS MUST BE CONSULTED IF KITCHEN EXHAUST FAN EXCEEDS 700 CFM DEPRESSURIZATION MAY OCCUR WITH IN THE DWELLING.

2985 DREW ROAD SUITE 202, MISSISSAUGA, ONT.

L4T 0A4 TEL: 905-671-9800 EMAIL: DAVE@GTADESIGNS.CA WEB: WWW.GTADESIGNS.CA

F 6 377	B I U/HR.
56,377	
UNIT MAKE	OR EQUAL.
AMANA	
UNIT MODEL	OR EQUAL.
AMEC960803BNA	
UNIT HEATING INPUT	BTU/HR.
60,000	
UNIT HEATING OUTPUT	BTU/HR.
57,600	
A/C COOLING CAPACITY	TONS.
3.0	
FAN SPEED	CFM
1170	


0				5	
S	FANS	R/A	S/A	# OF RUNS	
				3RD FLOOR	
	3	4	9	FLOOR	2ND F
٨	3	1	9	IST FLOOR	
		1	5	BASEMENT	
5 15					
FLOOR PLAN: PARTIAL PLAN(S)					
TL	2865			CHECKED:	DRAWN BY:
— г	<u> </u>				


JB-04607


M3

ľ	ARCI	н ZJ,	2010	
CLIENT: BAYV	IEW	WEL	LING	TON
MODEL:		2-2 W DEAU		
PROJECT:				

GREEN VALLEY EAST BRADFORD, ONT. 3/16" = 1'-0"

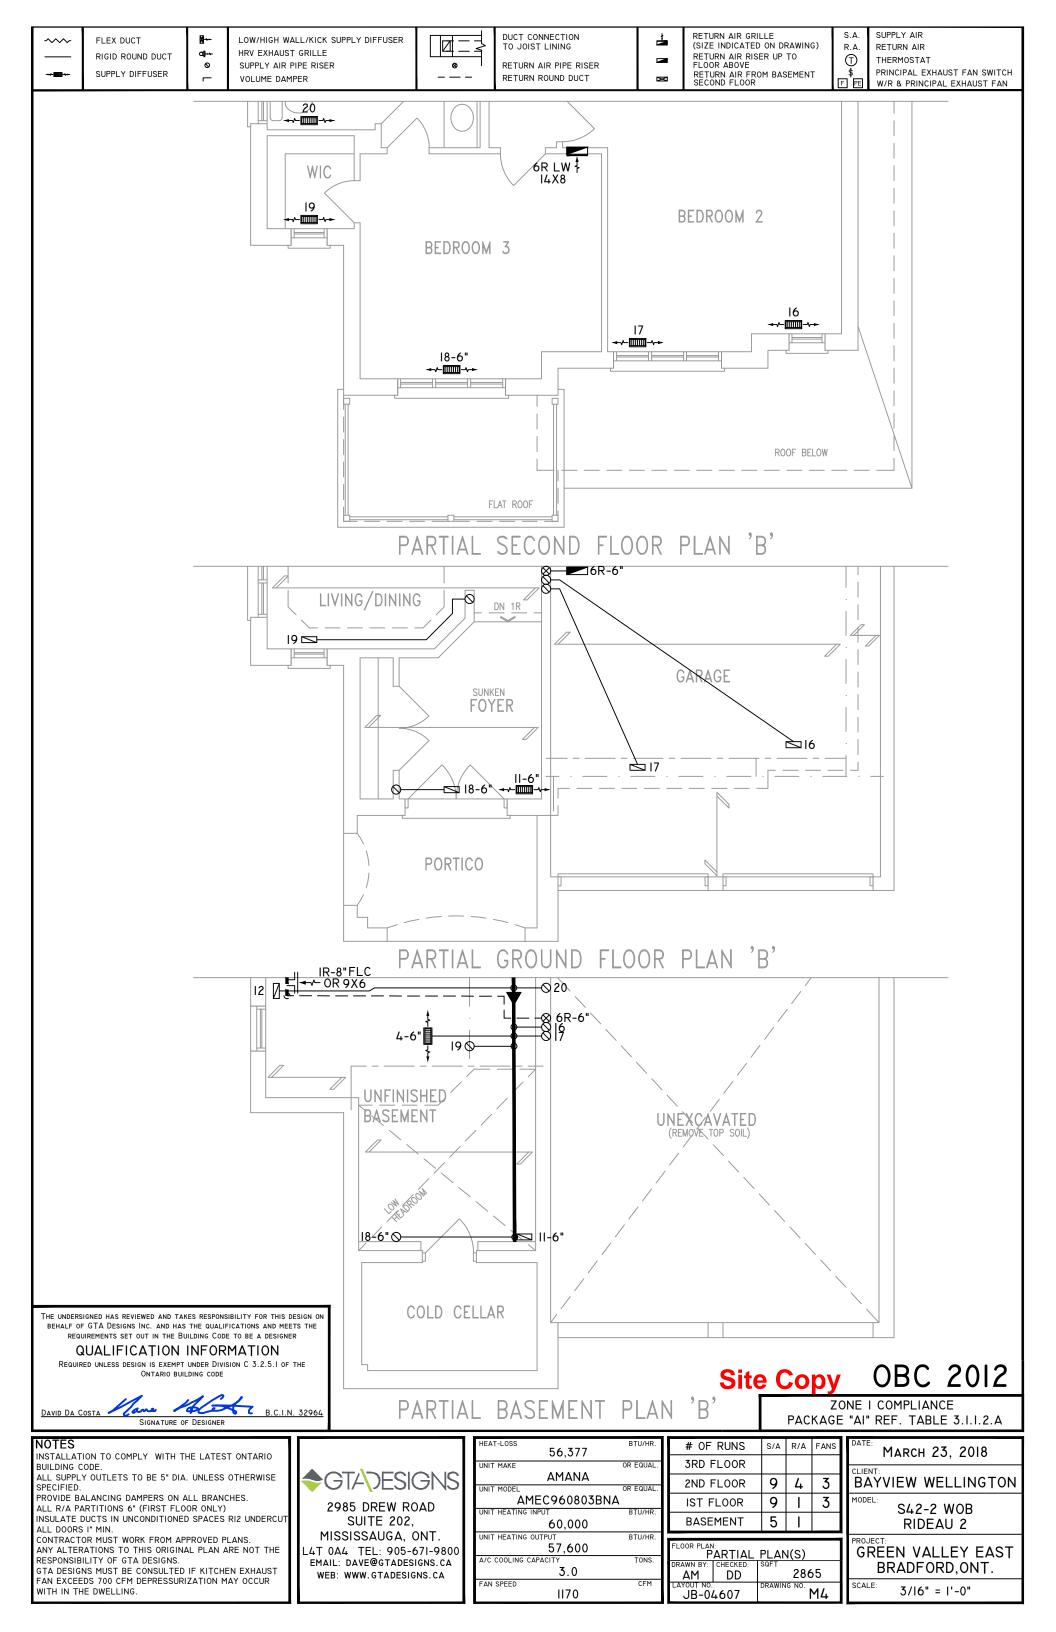

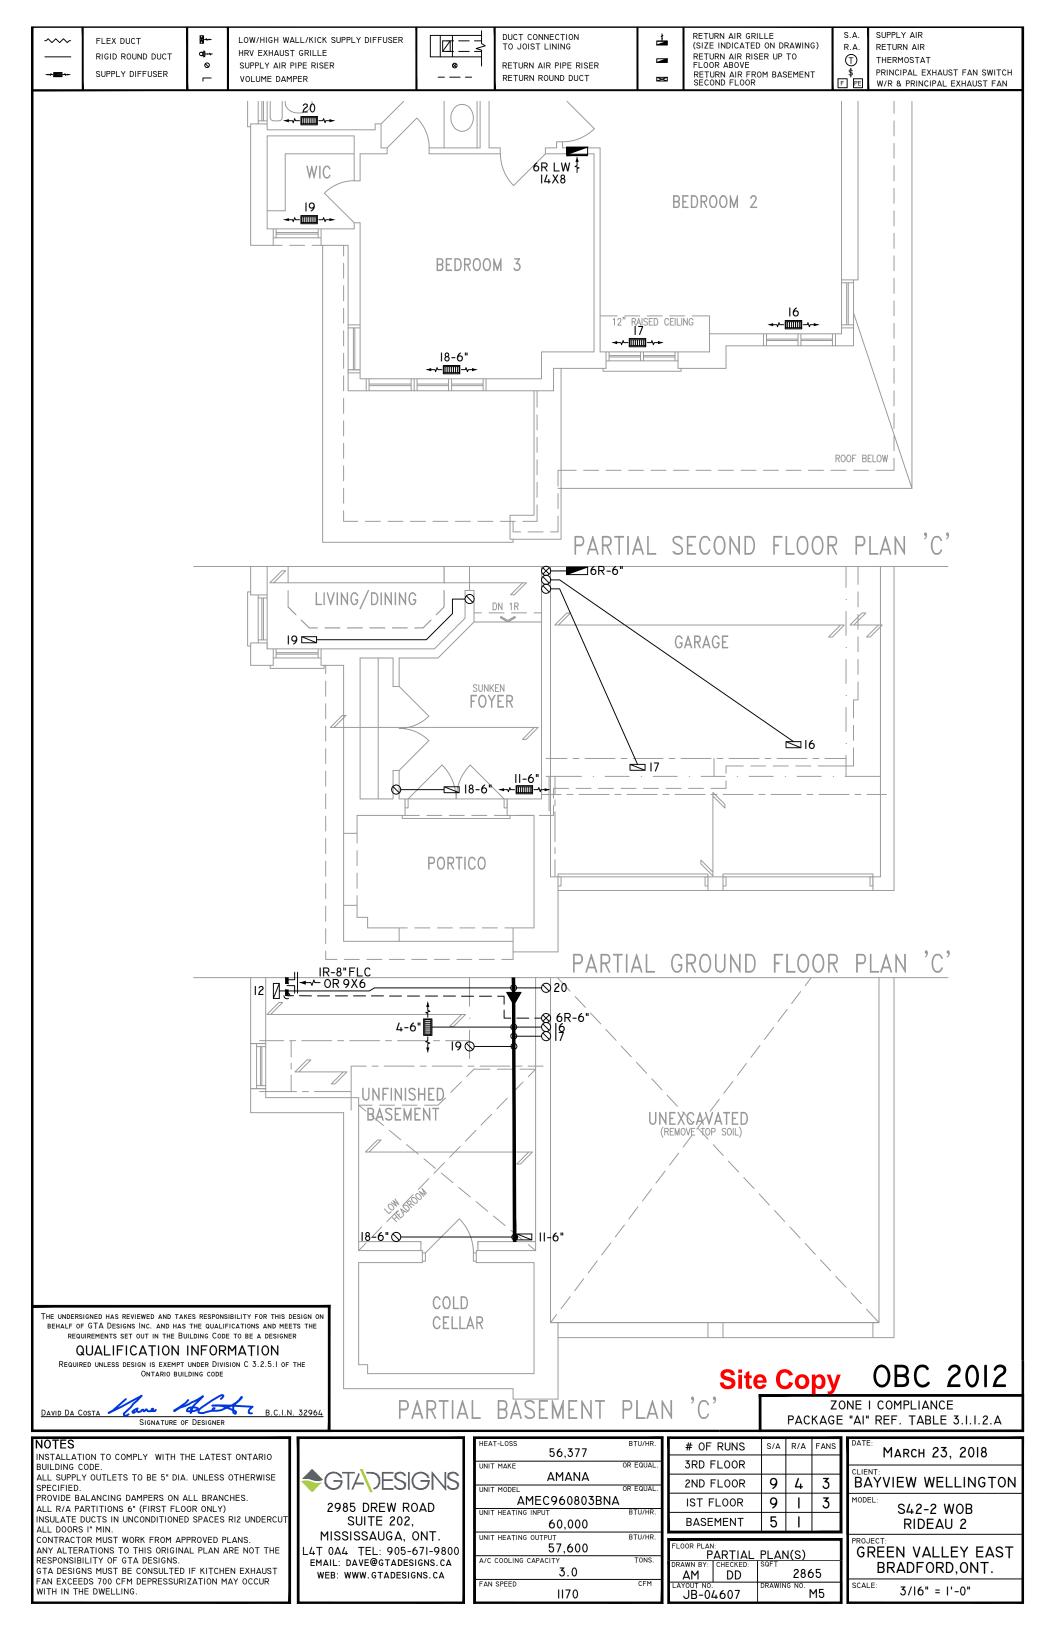

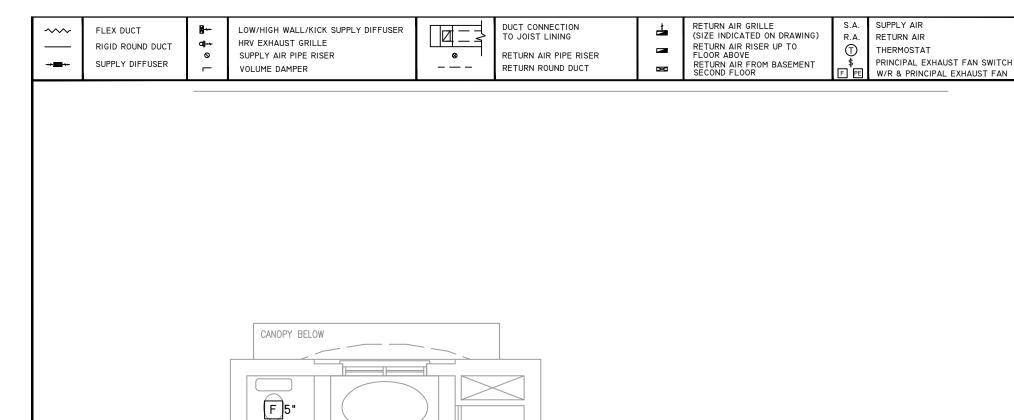


PARTIAL SECOND FLOOR PLAN ELEVATION 'C' REAR UPGRADE

OPT. RAISED TRAY CEILING 44-6"-

MASTER BEDRM

ENSUITE

22-6"

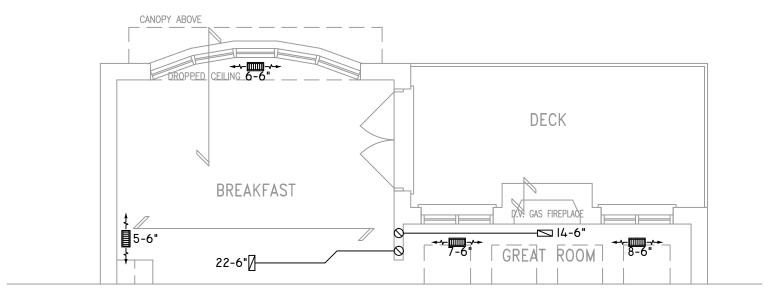

PARTIAL GROUND FLOOR PLAN ELEVATION 'C' REAR UPGRADE



OBC 2012 Site Copy

> ZONE I COMPLIANCE PACKAGE "AI" REF. TABLE 3.1.1.2.A

INSTALLATION TO COMPLY WITH THE LATEST ONTARIO

BUILDING CODE. ALL SUPPLY OUTLETS TO BE 5" DIA. UNLESS OTHERWISE

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HEAT-LOSS 56,377	BTU/HR.
,	00 501141
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FAN SPEED	CFM
1170	

# OF RUNS		S/A	R/A	FANS
3RD FLOOR				
2ND FLOOR		9	4	3
IST FLOOR		9	-	3
BASEMENT		5	_	
FLOOR PLAN: PARTIAL PLAN(S)				
DRAWN BY:	CHECKED: DD	2865		

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RAWING NO. M6

	1arch 23, 2018
CLIENT: BAY	IEW WELLINGTON
MODEL:	S42-2 WOB RIDEAU 2
PROJECT:	

GREEN VALLEY EAST

BRADFORD, ONT.

3/16" = 1'-0"